

City of Madison Fire Department

314 W Dayton Street, Madison, WI 53703-2506

Phone: 608-266-4420 • Fax: 608-267-1100 • E-mail: fire@cityofmadison.com

Project Address: Paragon Place at Bear Cl	aw Way - Lot 6
Contact Name & Phone #: Kevin Burow	608-836-3690

FIRE APPARATUS ACCESS AND FIRE HYDRANT WORKSHEET

1. Is the building completely protected by an NFPA 13 or 13R automatic fire sprinkler system? If non-sprinklered, fire lanes extend to within 150-feet of all portions of the exterior wall? If sprinklered, fire lanes are within 250-feet of all portions of the exterior wall?	Yes Yes Yes Yes	No No No	N/A N/A N/A
 2. Is the fire lane constructed of concrete or asphalt, designed to support a minimum load of 85,000 lbs? a) Is the fire lane a minimum unobstructed width of at least 20-feet? b) Is the fire lane unobstructed with a vertical clearance of at least 13½-feet? c) Is the minimum inside turning radius of the fire lane at least 28-feet? d) Is the grade of the fire lane not more than a slope of 8%? e) Is the fire lane posted as fire lane? (Provide detail of signage.) f) Is a roll-able curb used as part of the fire lane? (Provide detail of curb.) g) Is part of a sidewalk used as part of the required fire lane? (Must support +85,000 lbs.) 	X Yes X Yes X Yes X Yes X Yes Yes Yes Yes Yes Yes	☐ No	 N/A N/A N/A N/A N/A N/A N/A N/A N/A
3. Is the fire lane obstructed by security gates or barricades? If yes:a) Is the gate a minimum of 20-feet clear opening?b) Is an approved means of emergency operations installed, key vault, padlock or key switch?	Yes Yes Yes	No No No	N/A N/A N/A
4. Is the Fire lane dead-ended with a length greater than 150-feet? If yes, does the area for turning around fire apparatus comply with IFC D103?	Yes Yes	X No No	□ N/A ▼ N/A
5. Is any portion of the building to be used for high-piled storage in accordance with IFC Chapter 3206.6 If yes, see IFC 3206.6 for further requirements.	Yes	X No	□ N/A
6. Is any part of the building greater than 30-feet above the grade plane?	X Yes	☐ No	□ N/A
If yes, answer the following questions: a) Is the aerial apparatus fire lane parallel to one entire side of the building and covering at least 25% of the perimeter? b) Is the near edge of the aerial apparatus fire lane between 15' and 30' from the building? c) Are there any overhead power or utility lines located across the aerial apparatus fire lane? d) Are there any tree canopies expected to grow across the aerial fire lane? (Based on mature canopy width of tree species)	X Yes Yes Yes Yes	□ No X No X No X No	N/AN/AN/AN/A
e) Does the aerial apparatus fire lane have a minimum unobstructed width of 26-feet? f) Is the space between the aerial lane and the building free of trees exceeding 20' in heights?	X Yes Yes	☐ No X No	□ N/A □ N/A
7. Are all portions of the required fire lanes within 500-feet of at least (2) hydrants?	X Yes	□ No	□ N/A
 Note: Distances shall be measured along the path of the hose lay as it comes off the fire apparatus. a) Is the fire lane at least 26' wide for at least 20-feet on each side of the hydrants? b) Is there at least 40' between a hydrant and the building? c) Are the hydrant(s) setback no less than 5-feet nor more than 10-feet from the curb or edge of the street or fire lane? 	X Yes X Yes X Yes	☐ No ☐ No ☐ No	□ N/A □ N/A □ N/A
 d) Are hydrants located in parking lot islands a minimum of 3½-feet from the hydrant to the curb? e) Are there no obstructions, including but not limited to: power poles, trees, bushes, fences, posts located, or grade changes exceeding ½-feet, within 5-feet of a fire hydrant? Note: Hydrants shall be installed and in-service prior to combustible construction on the project site. 	☐ Yes X Yes	☐ No	N/A N/A

Attach an additional sheet if further explanation is required for any answers.

This worksheet is based on MGO 34.503 and IFC 2015 Edition Chapter 5 and Appendix D; please see the codes for further information.

























I. THE APPLICANT SHALL REPLACE ALL SIDEWALK AND CURB AND GUTTER THAT ABUTS THE PROPERTY THAT IS DAMAGED BY THE CONSTRUCTION, OR ANY SIDEWALK AND CURB AND GUTTER WHICH THE CITY ENGINEER DETERMINES NEEDS TO BE REPLACED BECAUSE IT NOT AT A DESIRABLE GRADE. REGARDLESS OF WHETHER THE CONDITION EXISTED PRIOR TO BEGINNING CONSTRUCTION.

2.ALL WORK IN THE PUBLIC RIGHT OF WAY SHALI BE PERFORMED BY A CITY-LICENSED CONTRACTOR.

3. ALL DAMAGE TO THE PAVEMENT ON CITY STREETS, AND ADJACENT TO THIS DEVELOPMENT SHALL BE RESTORED IN ACCORDANCE WITH THE CITY OF MADISON'S PAVEMENT PATCHING

4. ALL PROPOSED STREET TREE REMOVALS WITHIN THE RIGHT OF WAY SHALL BE REVIEWED BY CITY FORESTRY BEFORE THE PLAN COMMISSION MEETING. STREET TREE REMOVALS REQUIRE APPROVAL AND A TREE REMOVAL PERMIT ISSUED BY CITY FORESTRY. ANY STREET TREE REMOVALS REQUESTED AFTER THE DEVELOPMENT PLAN IS APPROVED BY THE PLAN COMMISSION OR THE BOARD OF PUBLIC WORKS AND CITY FORESTRY WILL REQUIRE A MINIMUM OF A 72-HOUR REVIEW PERIOD WHICH SHALL INCLUDE THE NOTIFICATION OF THE ALDERPERSON WITHIN WHO'S DISTRICT IS AFFECTED BY THE STREET TRE REMOVAL(S) PRIOR TO A TREE REMOVAL PERMIT

5.AS DEFINED BY THE SECTION 107.13 OF CITY OF MADISON STANDARD SPECIFICATIONS FOR PUBLIC WORKS CONSTRUCTION: NO EXCAVATION IS PERMITTED WITHIN 5 FEET OF THE TRUNK OF TH STREET TREE OR WHEN CUTTING ROOTS OVER 3 INCHES IN DIAMETER. IF EXCAVATION IS NECESSARY, THE CONTRACTOR SHALL CONTACT MADISON CITY FORESTRY (266-4816) PRIOR TO EXCAVATION. CITY OF MADISON FORESTRY PERSONNEL SHALL ASSESS THE IMPACT TO THE TREE AND TO ITS ROOT SYSTEM PRIOR TO WORK COMMENCING. TREE PROTECTION SPECIFICATIONS CAN BE FOUND ON THE FOLLOWING WEBSITE:

HTTPS://WWW.CITYOFMADISON.COM /BUSINESS/PW/SPECS.CFM

BEING ISSUED.

6.CONTRACTOR SHALL TAKE PRECAUTIONS DURING CONSTRUCTION TO NOT DISFIGURE, SCAR, OR IMPAIR THE HEALTH OF ANY STREET TREE. CONTRACTOR SHALL OPERATE EQUIPMENT In a manner as to not damage the branches OF THE STREET TREE(S). THIS MAY REQUIRE USING SMALLER EQUIPMENT AND LOADING AND UNLOADING MATERIALS IN A DESIGNATED SPACE AWAY FROM TREES ON THE CONSTRUCTION SITE ANY DAMAGE OR INJURY TO EXISTING STREET TREES (EITHER ABOVE OR BELOW GROUND) SHALI BE REPORTED IMMEDIATELY TO CITY FORESTRY AT 266-4816. PENALTIES AND REMEDIATION SHALL BE


7.SECTION 107.13(G) OF CITY OF MADISON STANDARD SPECIFICATIONS FOR PUBLIC WORKS CONSTRUCTION ADDRESSES SOIL COMPACTION NEAR STREET TREES AND SHALL BE FOLLOWED BY CONTRACTOR. THE STORAGE OF PARKED VEHICLES, CONSTRUCTION EQUIPMENT, BUILDING MATERIALS, REFUSE, EXCAVATED SPOILS OR DUMPING OF POISONOUS MATERIALS ON OR AROUND TREES AND ROOTS WITHIN FIVE (5) FEET OF THE TREE OR WITHIN THE PROTECTION ZONE IS PROHIBITED.

8.ON THIS PROJECT, STREET TREE PROTECTION ZONE FENCING IS REQUIRED. THE FENCING SHALL BE ERECTED BEFORE THE DEMOLITION, GRADING OR CONSTRUCTION BEGINS. THE FENCE SHALL INCLUDE THE ENTIRE WIDTH OF TERRACE AND, EXTEND AT LEAST 5 FEET ON BOTH SIDES OF THE OUTSIDE EDGE OF THE TREE TRUNK. DO NOT REMOVE THE FENCING TO ALLOW FOR DELIVERIES OR EQUIPMENT ACCESS THROUGH THE TREE PROTECTION ZONE.


9.STREET TREE PRUNING SHALL BE COORDINATED CONSTRUCTION FOR THIS PROJECT. ALL PRUNING SHALL FOLLOW THE AMERICAN NATIONAL STANDARDS INSTITUTE (ANSI) A300 -PART I STANDARDS FOR PRUNING.

APPROVAL OF PLANS FOR THIS PROJECT DOES NOT INCLUDE ANY APPROVAL TO PRUNE, REMOVE, OR PLANT TREES IN THE PUBLIC RIGHT-OF-WAY. PERMISSION FOR SUCH ACTIVITIE MUST BE OBTAINED FROM THE CITY FORESTER

THE PUBLIC RIGHT-OF-WAY IS THE SOLE JURISDICTION OF THE CITY OF MADISON AND IS SUBJECT TO CHANGE AT ANY TIME. NO ITEMS SHOWN ON THIS SITE PLAN IN THE RIGHT-OF-WAY ARE PERMANENT AND MAY NEED TO BE REMOVED AT THE APPLICANTS EXPENSE UPON NOTIFICATION BY THE CITY.

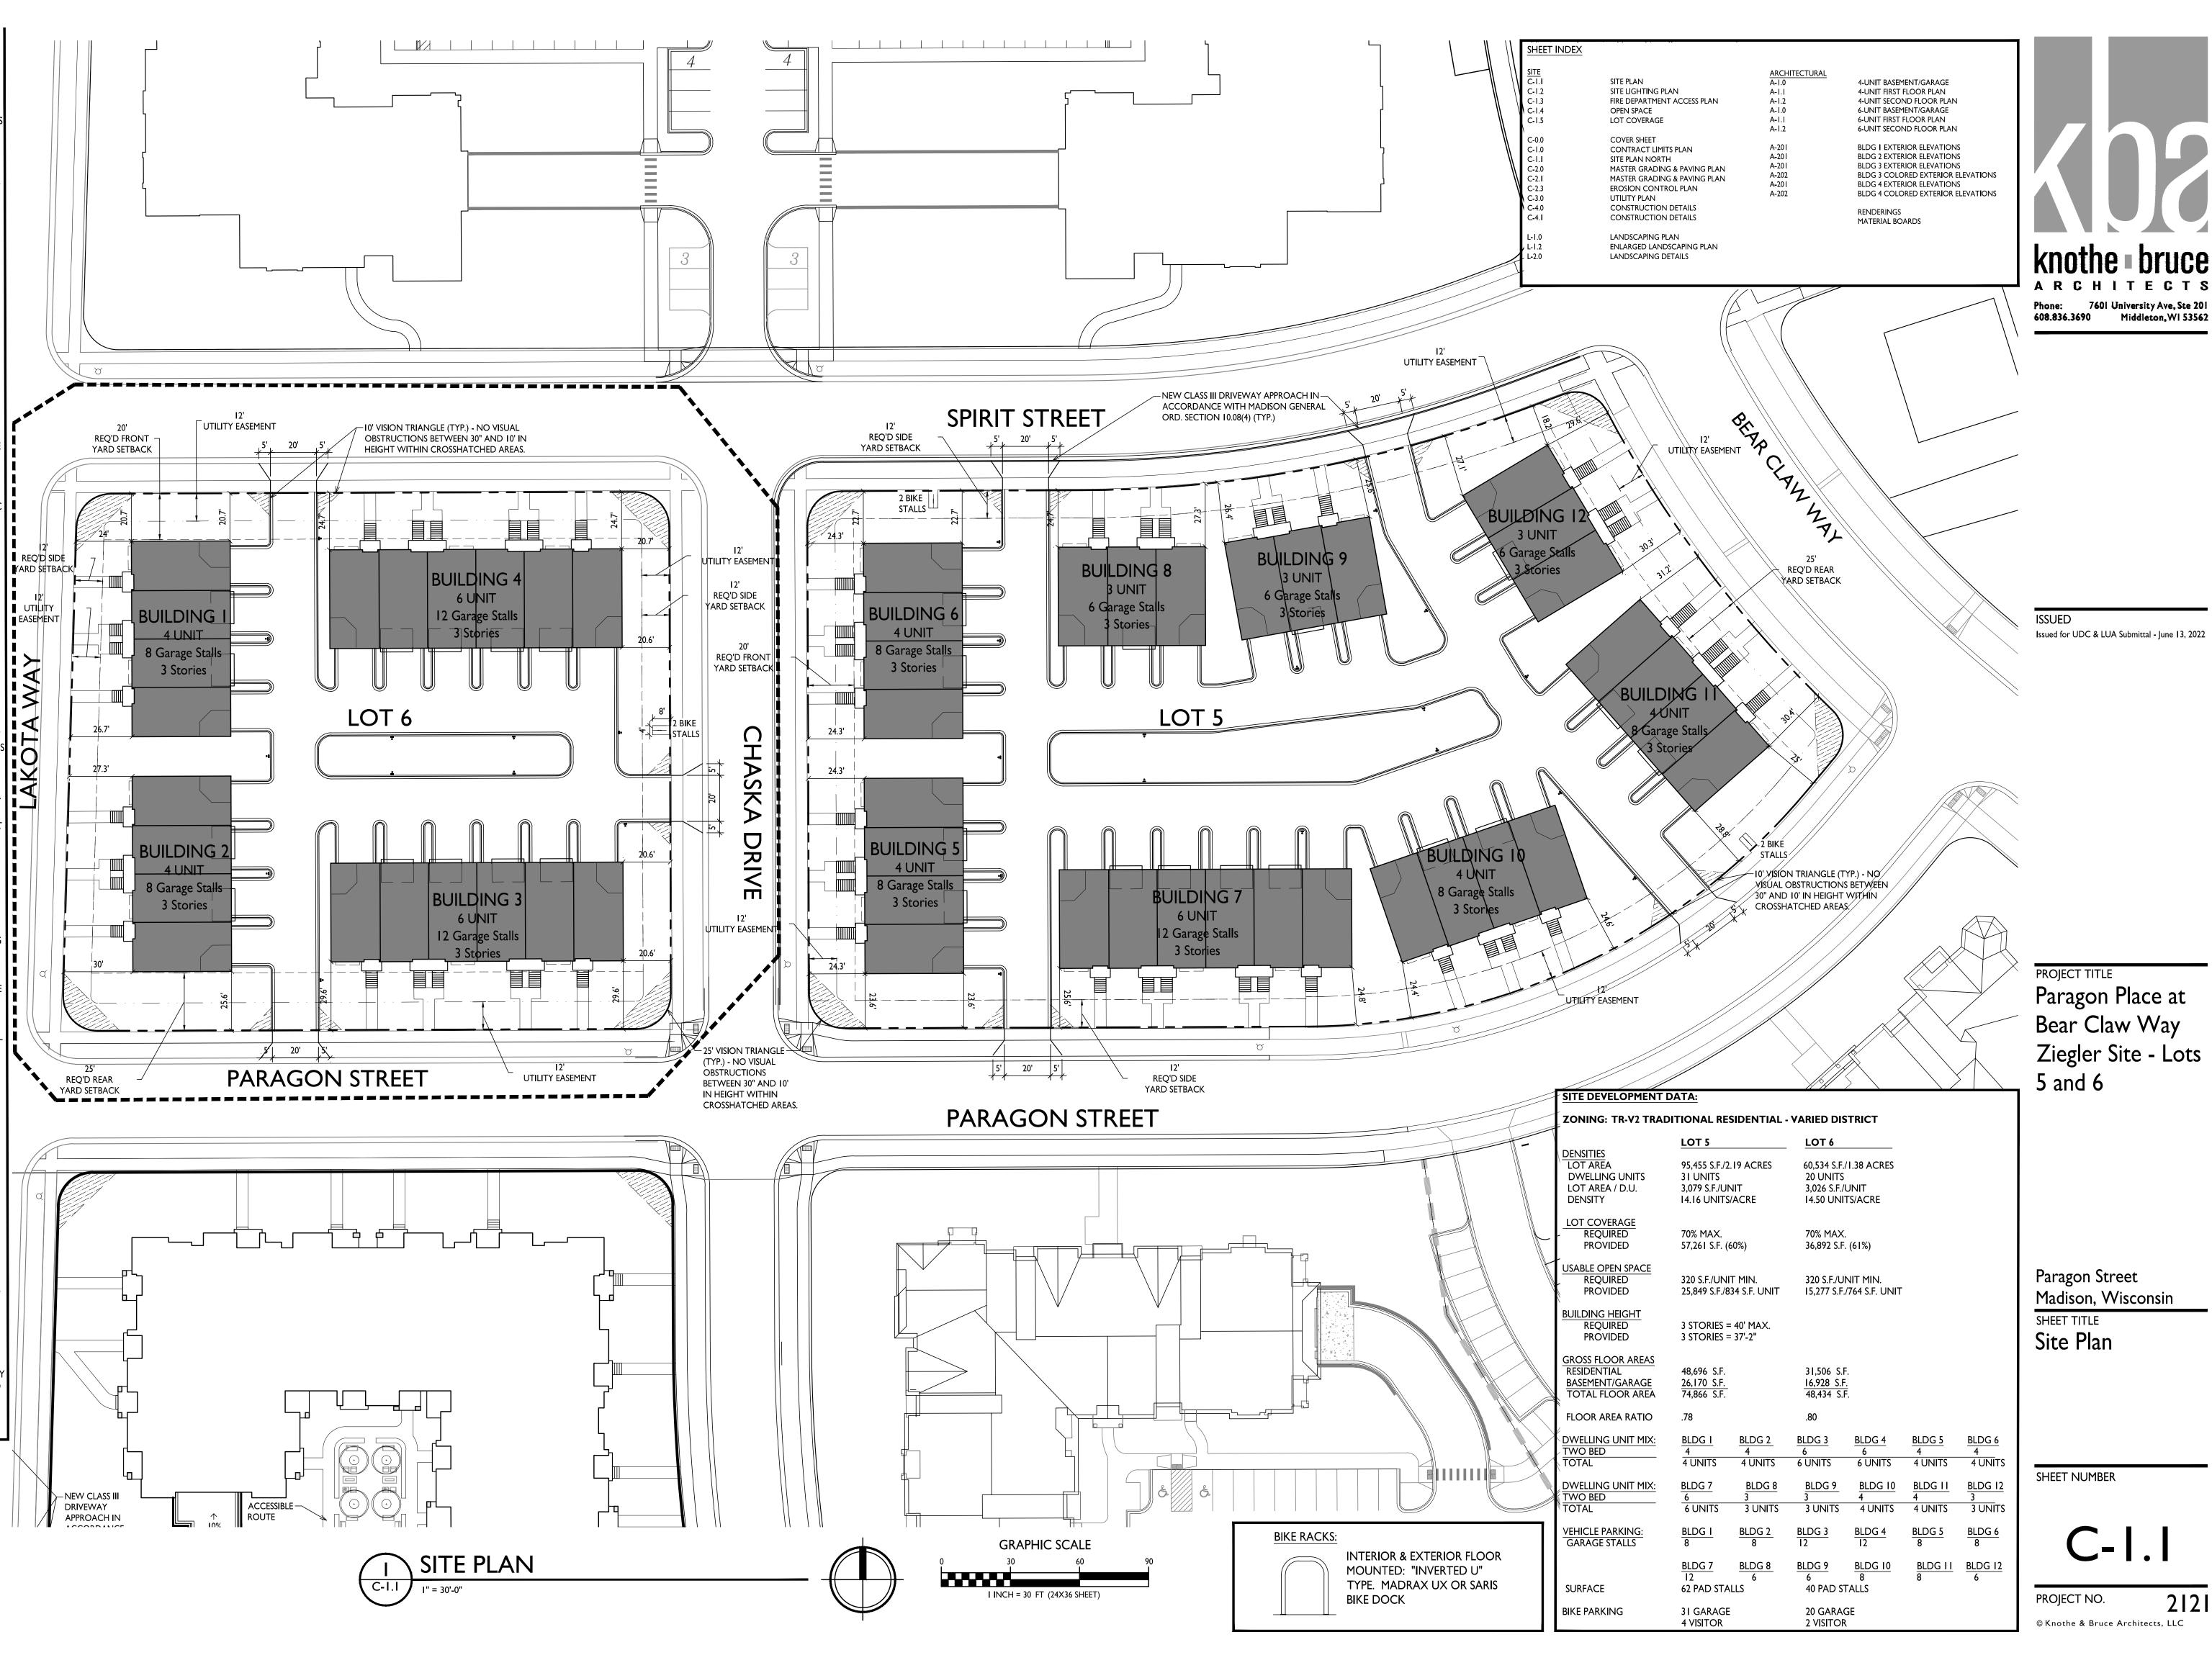

2121

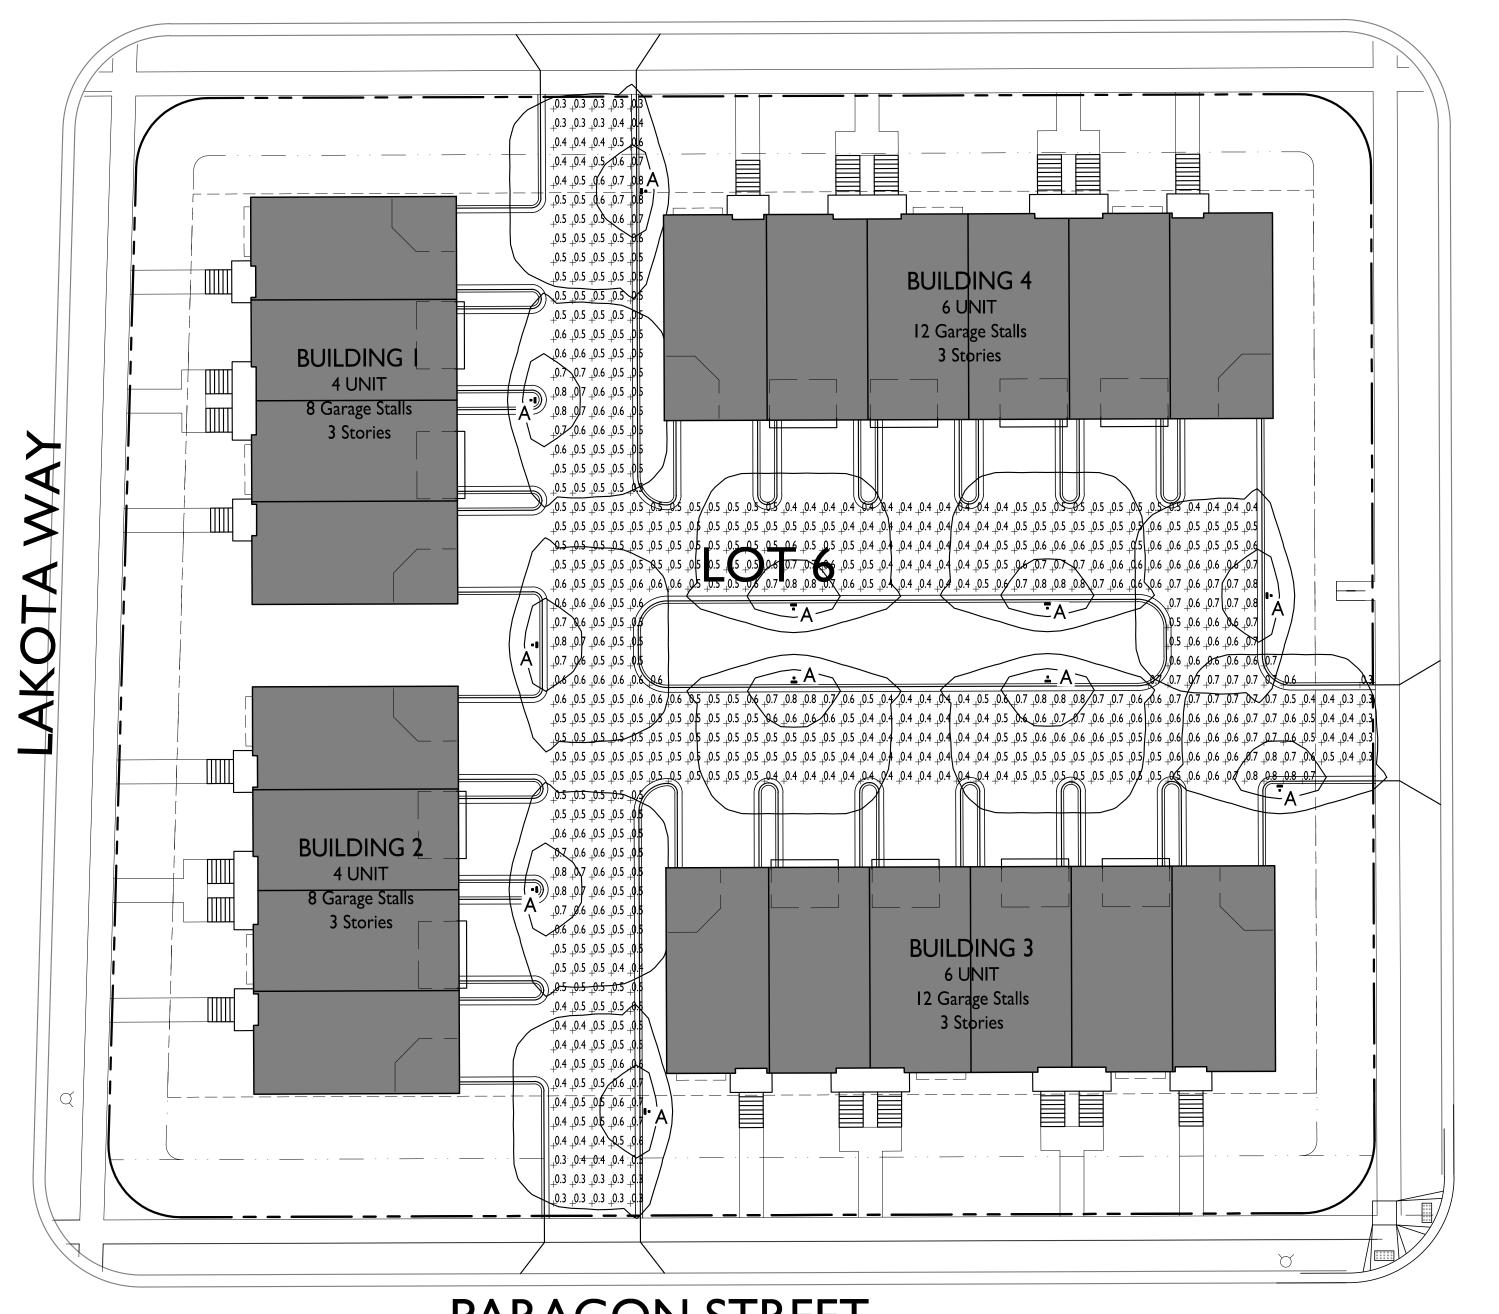

HASKA DRIVE

PARAGON STREET

YMBOL	LABEL	QTY.	MANUF.	CATALOG	DESCRIPTION	FILE	MOUNTING
	A	11	LITHONIA LIGHTING	DSXWPM LED 10C 350 30K T4M MVOLT HS	DSXWPM LED WITH (I) 10 LED LIGHT ENGINE, TYPE T4M OPTIC, 3000K AT 350mA, WITH HOUSE SIDE SHIELD	DSXWPM_LED_I0C _350_30K_T4M _MVOLT_HS.ies	14'-0" POLE ON 2'-0" TALI CONC. BASE
			E	KAMPLE LIGHT FIX	ISOLUX CO	ONTOUR = 0.25 FC ONTOUR = 0.5 FC ONTOUR = 1.0 FC	

LIGHT LEVEL STATISTICS						
DESCRIPTION	SYMBOL	AVG.	MAX.	MIN.	MAX. / MIN.	AVG. / MIN.
Drive Aisle Lighting	+	0.5 fc	0.8 fc	0.3 fc	2.7:1	1.7:1



ISSUED
Issued for UDC & LUA Submittal - June 13, 2022

PROJECT TITLE

Paragon Place at Bear Claw Way Ziegler Site - Lots 5 and 6

Paragon Street

Madison, Wisconsin

SHEET TITLE

Site Lighting Plan


Lot 6

SHEET NUMBER

C-1.2

PROJECT NO. 2121



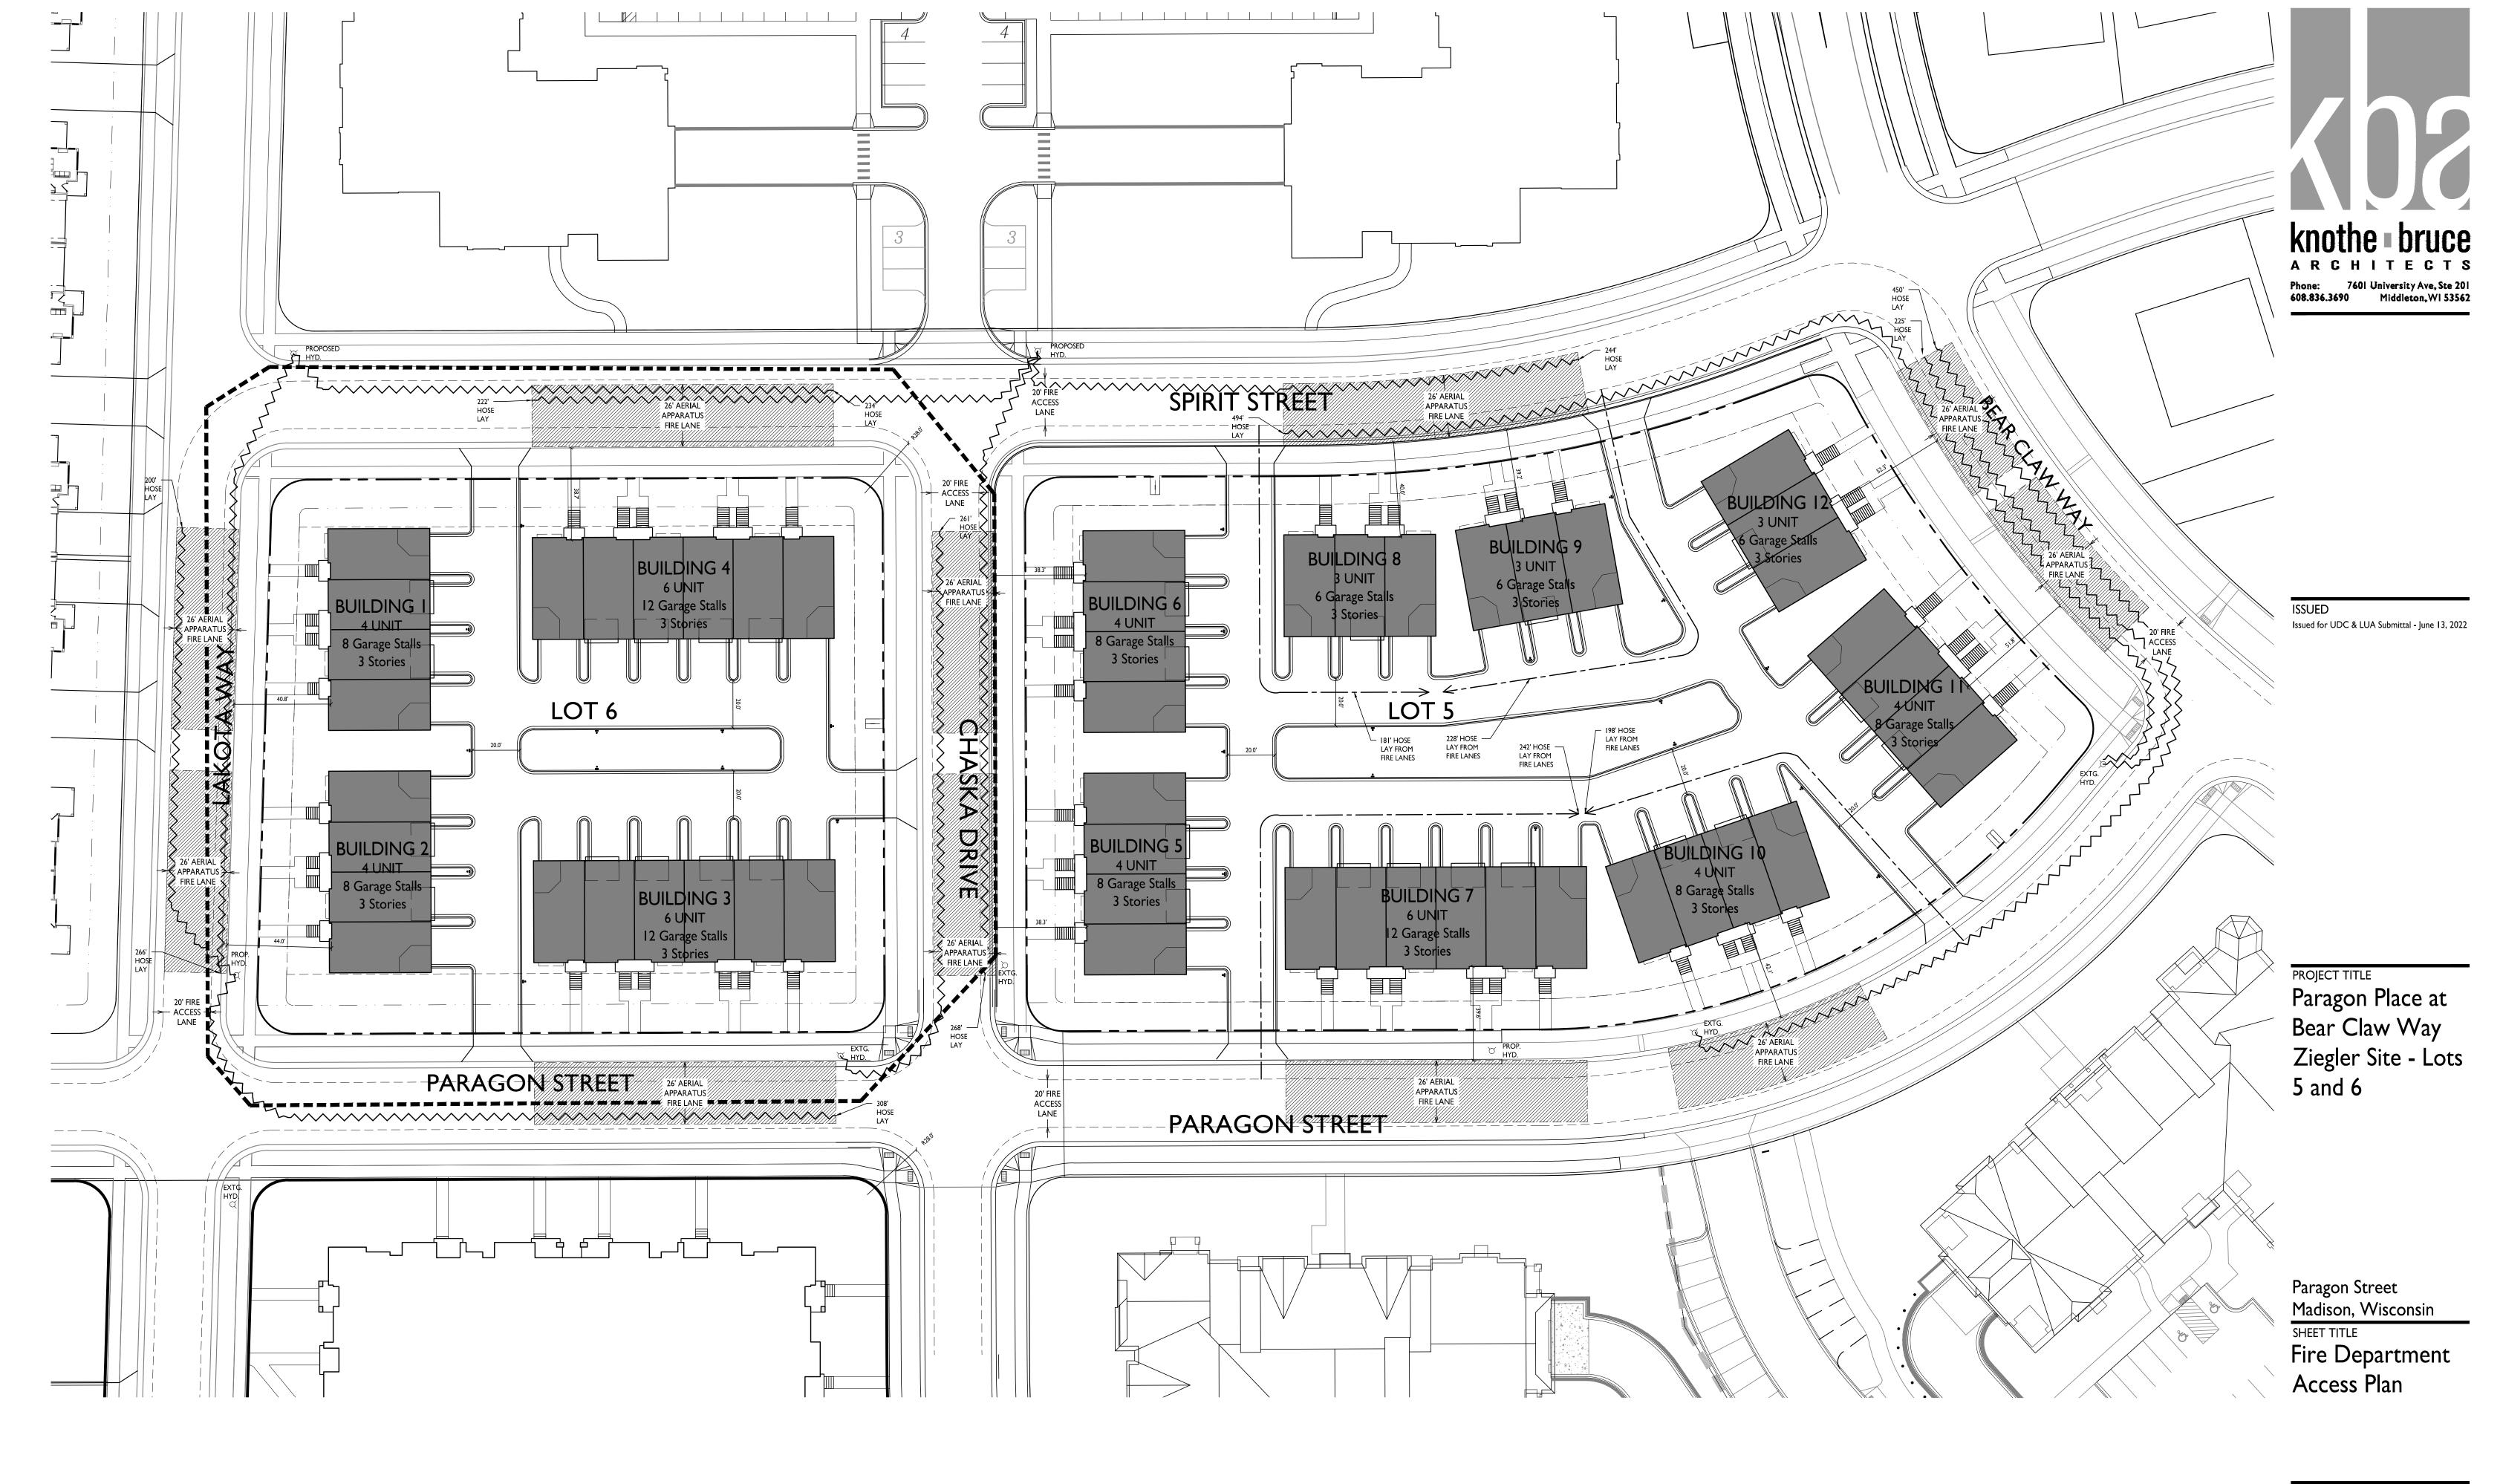

SHEET NUMBER

C-1.3

© Knothe & Bruce Architects, LLC


2121


PROJECT NO.

-0"

INCH = 30 FT (24X36 SHEET)

GRAPHIC SCALE

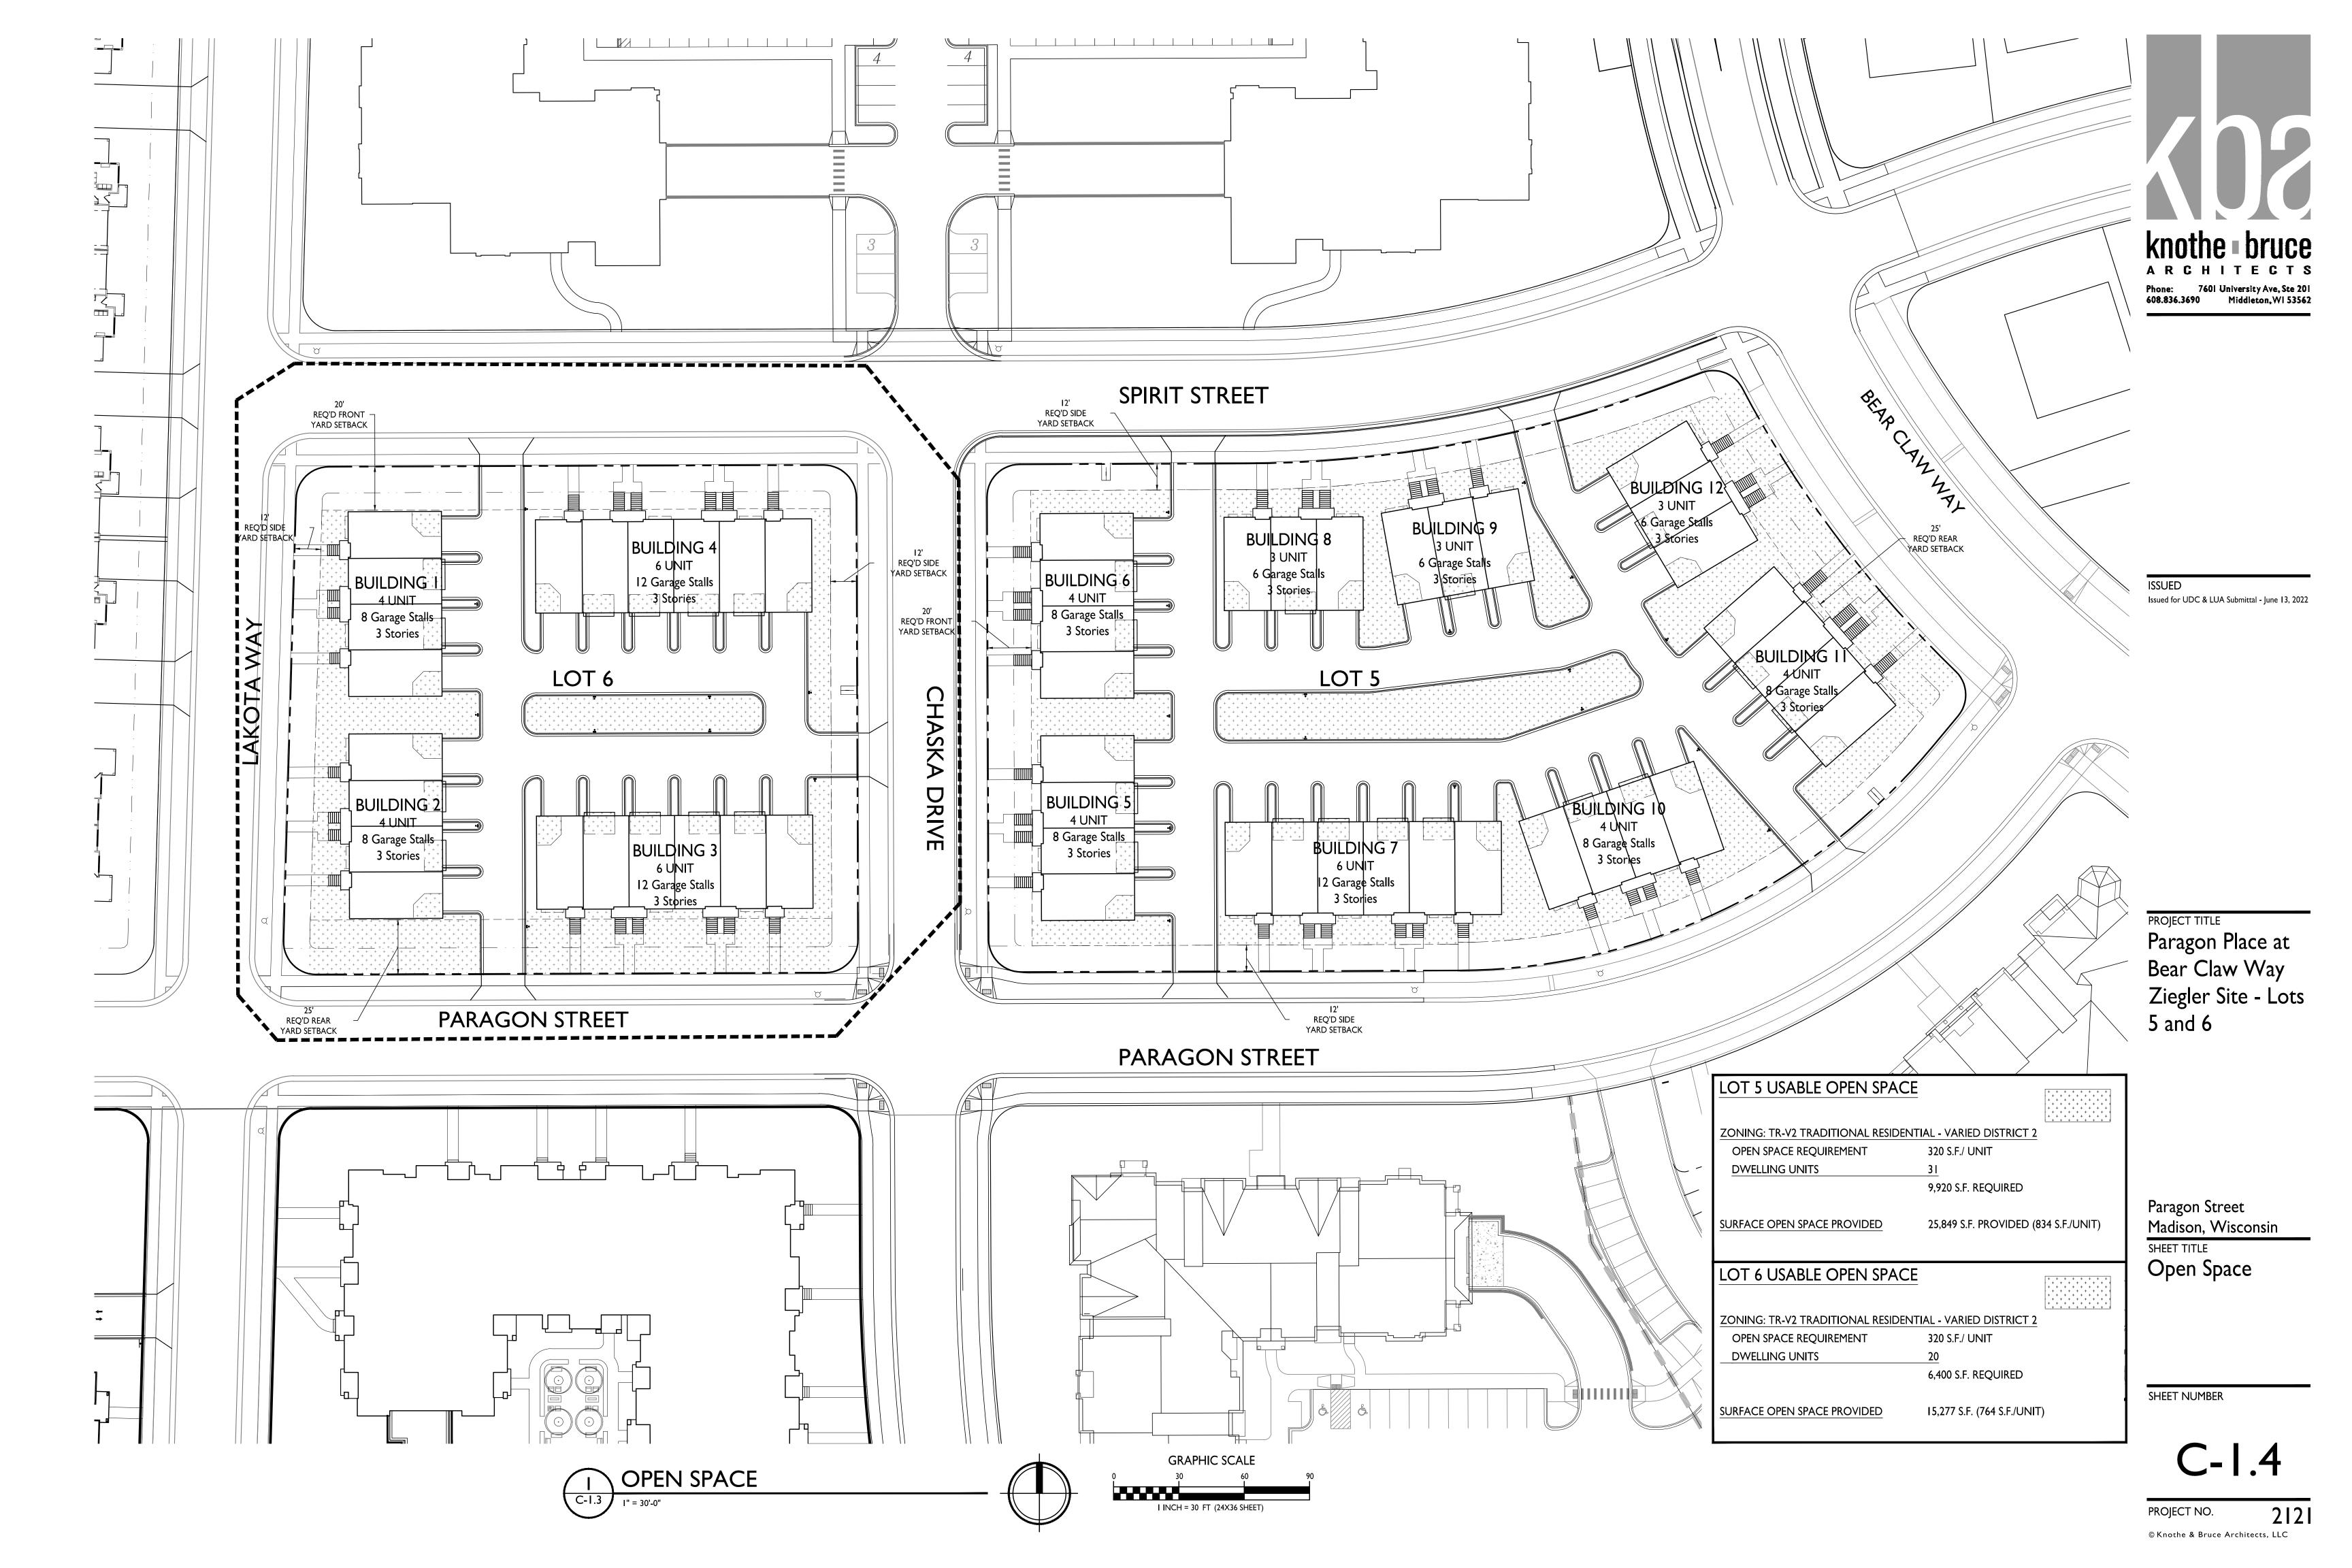

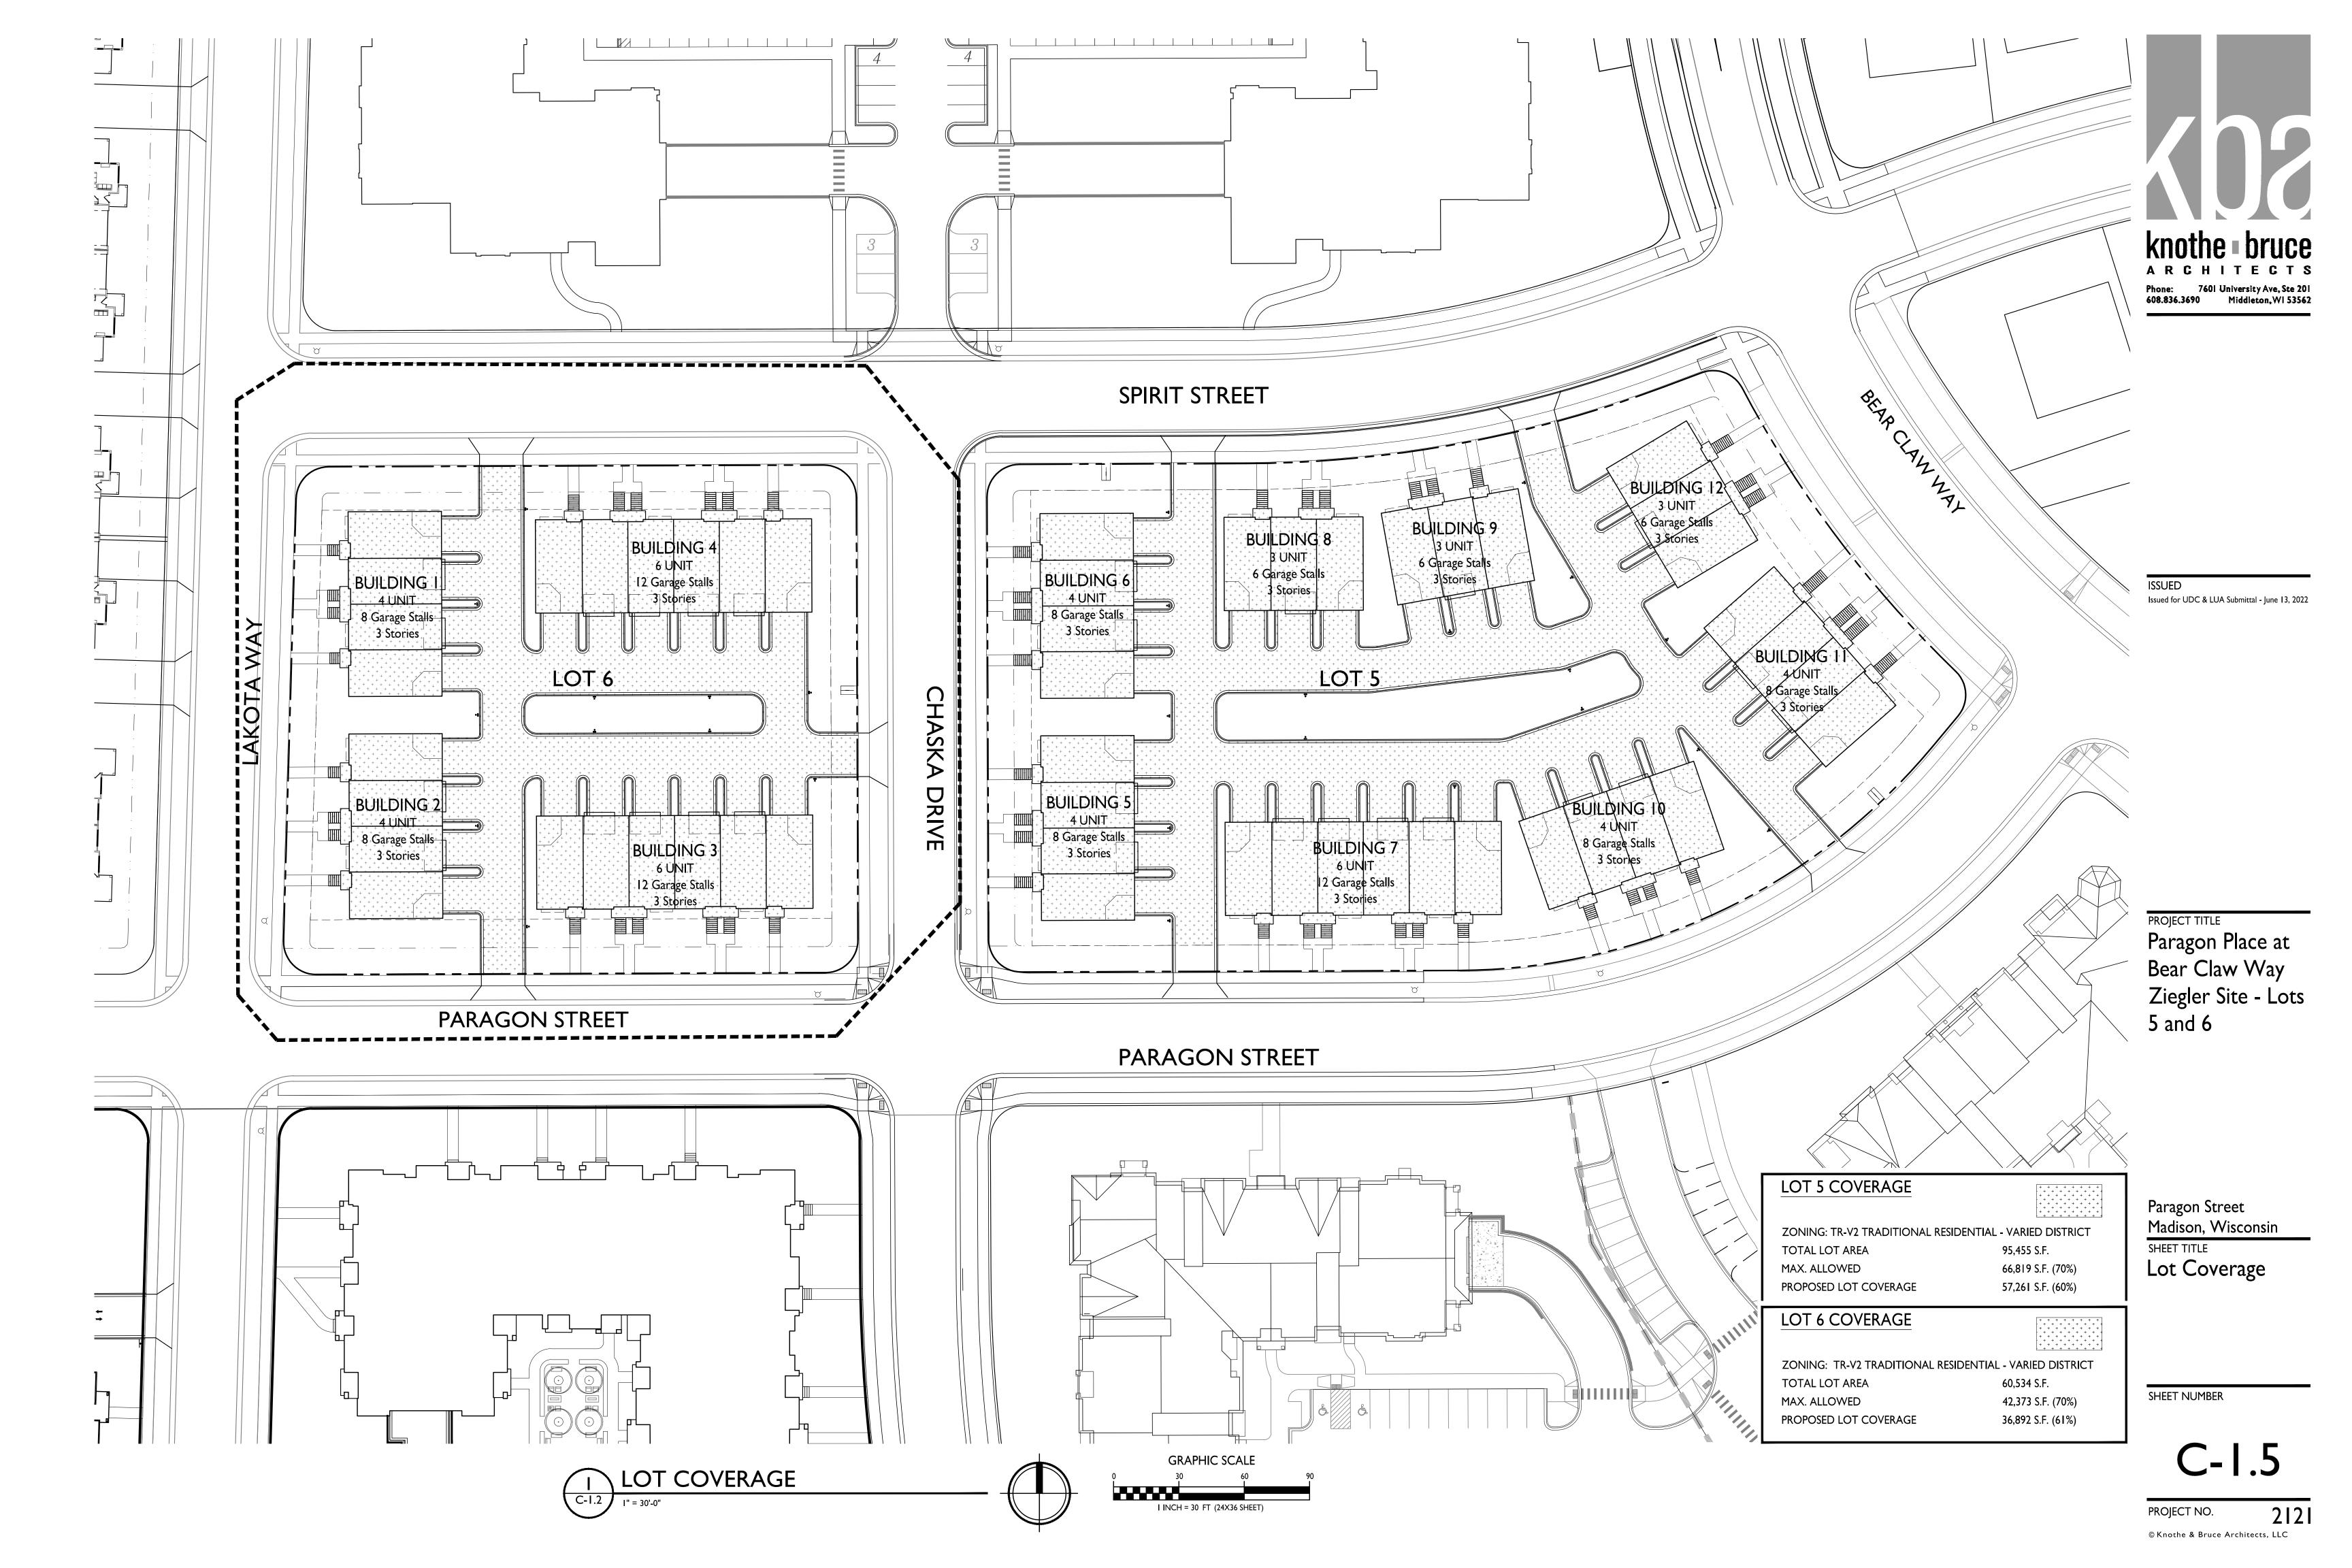


GENERAL NOTES

- 1. THE LATEST EDITIONS OF THE FOLLOWING DOCUMENTS AND ANY SUPPLEMENTS THERETO, SHALL GOVERN ALL CONSTRUCTION ITEMS ON THIS PLAN UNLESS OTHERWISE NOTED.
- -STANDARD SPECIFICATIONS FOR SEWER AND WATER CONSTRUCTION IN WISCONSIN, 6TH EDITION (SSSWCW)
- -THE WISCONSIN D.O.T. STANDARD SPECIFICATIONS FOR HIGHWAY AND STRUCTURE CONSTRUCTION, LATEST EDITION
- -WDNR STORMWATER RUNOFF TECHNICAL STANDARDS.
- -WISDOT PAL APPROVED EROSION CONTROL MEASURES LIST, LATEST EDITION. -CITY OF MADISON DEVELOPMENT STANDARDS, LATEST EDITION.
- 2. THE CONTRACTOR SHALL TAKE ALL MEASURES NECESSARY TO MINIMIZE EROSION, WATER POLLUTION AND SILTATION CAUSED BY CONSTRUCTION OF THIS PROJECT.

EROSION CONTROL MEASURES SHALL BE IN ACCORDANCE WITH WISCONSIN

DEPARTMENT OF NATURAL RESOURCES TECHNICAL STANDARDS.

- 3. EROSION CONTROL PLAN: PRIOR TO BEGINNING WORK, AN APPROVED EROSION CONTROL PLAN WILL BE PROVIDED BY THE ENGINEER. THE CONTRACTOR IS RESPONSIBLE FOR PROPERLY IMPLEMENTING THE APPROVED PLAN.
- 4. THE CONTRACTOR SHALL FIELD VERIFY THE ELEVATIONS OF THE BENCHMARKS PRIOR TO COMMENCING WORK. THE CONTRACTOR SHALL ALSO FIELD VERIFY LOCATION, ELEVATION AND SIZE OF EXISTING UTILITIES, AND VERIFY FLOOR, CURB OR PAVEMENT ELEVATIONS WHERE MATCHING INTO EXISTING WORK. THE CONTRACTOR SHALL FIELD VERIFY HORIZONTAL CONTROL BY REFERENCING SHOWN COORDINATES TO KNOWN PROPERTY LINES. NOTIFY ENGINEER OF DISCREPANCIES IN EITHER VERTICAL OR HORIZONTAL CONTROL PRIOR TO PROCEEDING WITH WORK.
- 5. THE CONTRACTOR SHALL VERIFY THE EXACT LOCATION OF ALL UNDERGROUND UTILITIES PRIOR TO BEGINNING CONSTRUCTION (CALL DIGGERS HOTLINE AT 800-242-8511). COST OF REPLACEMENT OR REPAIR OF EXISTING UTILITIES DAMAGED AS A RESULT OF THE CONTRACTOR'S OPERATION SHALL BE THE CONTRACTOR'S RESPONSIBILITY
- 6. EXISTING UTILITY INFORMATION IS SHOWN FROM SURVEY WORK, FIELD OBSERVATIONS, AVAILABLE PUBLIC RECORDS, AND AS—BUILT DRAWINGS. EXACT LOCATIONS AND ELEVATIONS OF UTILITIES SHALL BE DETERMINED PRIOR TO INSTALLING NEW WORK. EXCAVATE TEST PITS AS REQUIRED.
- 7. PROPERTY CORNERS SHALL BE CAREFULLY PROTECTED UNTIL THEY HAVE BEEN REFERENCED BY A PROFESSIONAL LAND SURVEYOR. PROPERTY MONUMENTS DISTURBED BY THE CONTRACTOR'S OPERATIONS SHALL BE REPLACED AT THE CONTRACTOR'S EXPENSE.
- 8. ENGINEER SHALL BE NOTIFIED 48 HOURS IN ADVANCE OF PERFORMING ANY CONSTRUCTION.
- 9. ALL TRENCHING SHALL BE PERFORMED ACCORDING TO OSHA STANDARDS.
- 10. ALL ITEMS SHALL INCLUDE ALL THE NECESSARY MATERIALS AND LABOR TO COMPLETE THE ITEM IN PLACE.
- 11. THE CONTRACTOR SHALL CLEAN ALL ADJACENT STREETS OF ANY SEDIMENT OR DEBRIS BY SWEEPING BEFORE THE END OF THE WORKING DAY.
- 12. THE RIGHT-OF-WAY IS THE SOLE JURISDICTION OF THE CITY OF MADISON AND IS SUBJECT TO CHANGE AT ANY TIME PER THE RECOMMENDATION/PLAN OF TRAFFIC ENGINEERING AND CITY ENGINEERING DEPARTMENTS

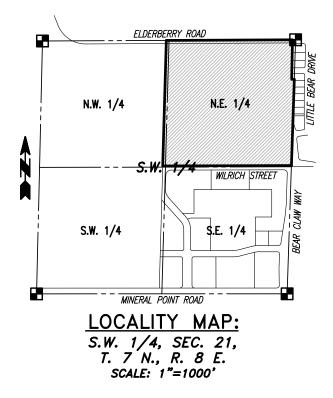


CONTRACTOR IS REQUIRED TO CONTACT DIGGERS HOTLINE TOLL FREE TO OBTAIN LOCATION OF UNDERGROUND UTILITIES PRIOR TO COMMENCING THE WORK. WISCONSIN STATUTE 182.0715 REQUIRES MIN. OF 3 WORK DAYS NOTICE BEFORE YOU EXCAVATE.

CALL DIGGERS HOTLINE 1-800-242-8511

EXISTING UNDERGROUND UTILITY INFORMATION WAS OBTAINED FROM AVAILABLE RECORDS. THE ENGINEER MAKES NO GUARANTEE AS TO THE ACCURACY OF THIS INFORMATION. VERIFICATION TO THE SATISFACTION OF THE CONTRACTOR OF ALL UNDERGROUND UTILITIES, WHETHER OR NOT SHOWN ON THE PLANS, SHALL BE ASSUMED AS A CONDITION OF THE CONTRACT. THE CONTRACTOR SHALL NOTIFY THE ENGINEER OF ANY DISCREPANCIES BETWEEN LOCATION OF UTILITIES IN THE FIELD AND LOCATIONS SHOWN ON THE PLANS.

PARAGON PLACE AT BEAR CLAW WAY LOTS 5 & 6 SITE DEVELOPMENT PLANS

CITY OF MADISON, WISCONSIN

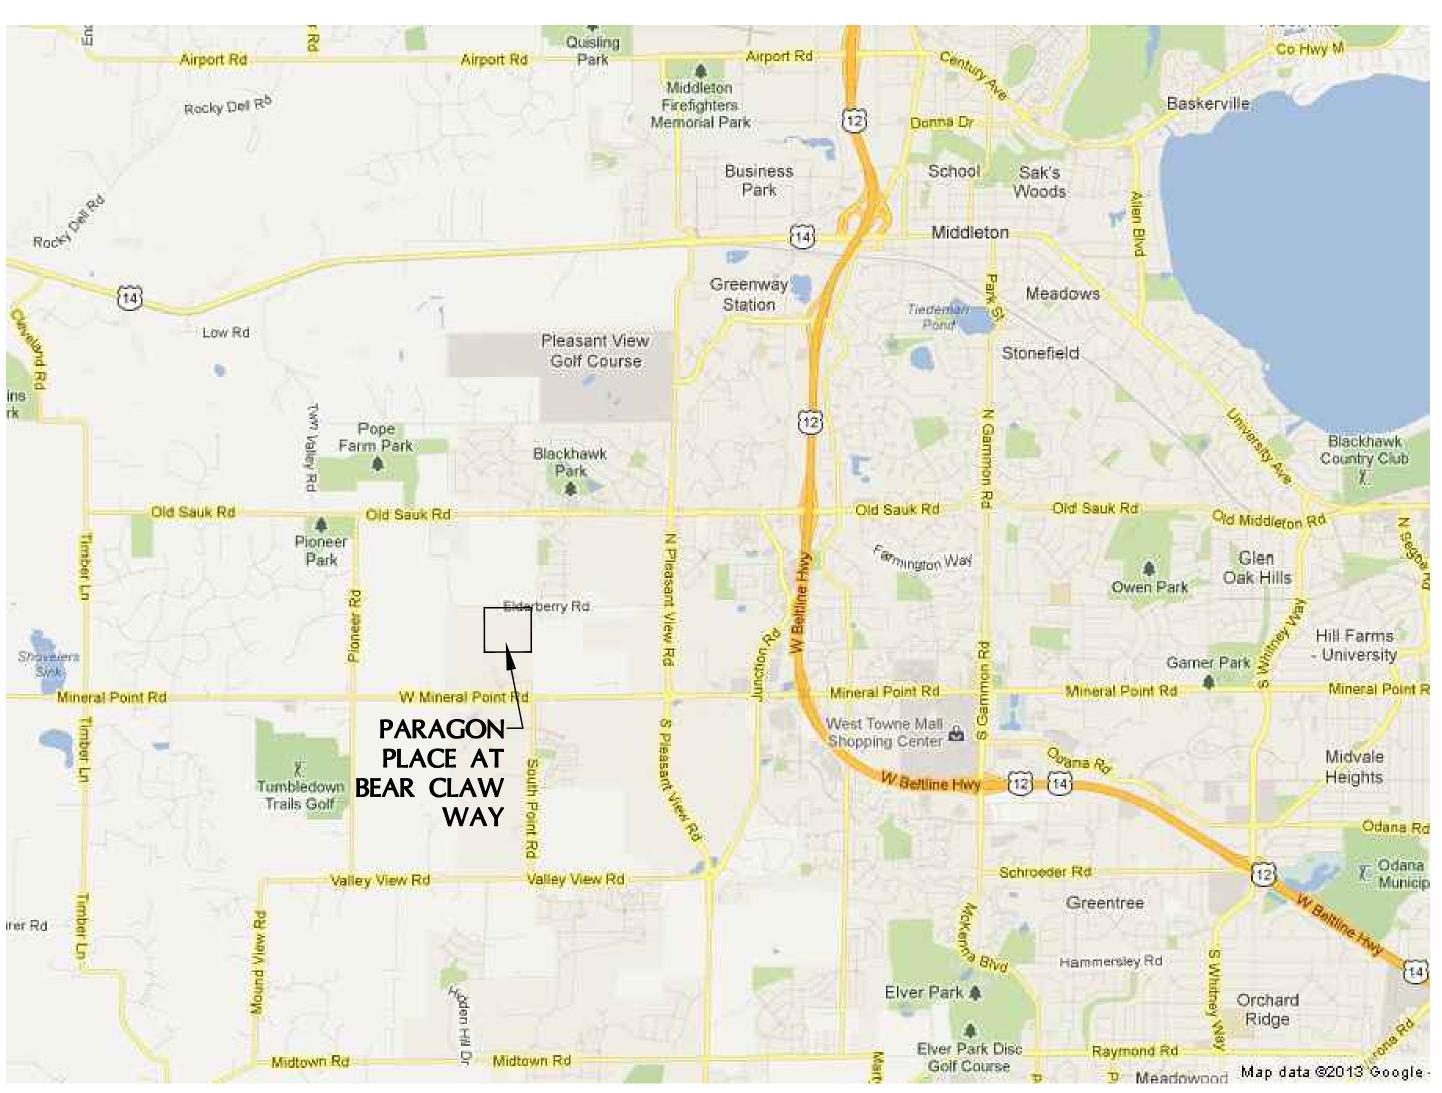


PRELIMINARY SET

VICINITY MAP

NOT TO SCALE

SHEET INDEX

CIVIL		
C0.0	_	COVER SHEET
C1.0	_	CONTRACT LIMITS PLAN
C1.1-C1.2	_	PROPOSED SITE PLANS
C2.0-C2.2	_	MASTER GRADING AND PAVING PLANS
C2.3	_	EROSION CONTROL PLAN
C3.0	_	OVERALL UTILITY PLAN
C3.1	_	BLDGS 6-9 UTILITY PLAN
C4.0-4.1	_	CONSTRUCTION NOTES & DETAILS

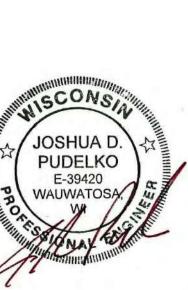





PARAGON PLACE

EMAIL: jpudelko@trioeng.com

knothe bruce

Phone: 7601 University Ave, Ste 201 608.836.3690 Middleton, WI 53562

⋖

PARAGON PLACE AT BEAR CL LOTS 5 & 6 CITY OF MADISON, WI BY: United Financial Group, Inc. 660 W. Ridgeview Drive

BY: Unit STORY

BY: Unit OF Secondary

BY: Unit OF Secondary

BY: Unit OF Secondary

BY: Unit OF Secondary

Appendix Secondary

BY: Unit OF Secondary

DATE:JUNE 8, 2022


JOB NUMBER: 12041

DESCRIPTION:

COVER SHEET

SHEET

CO.0

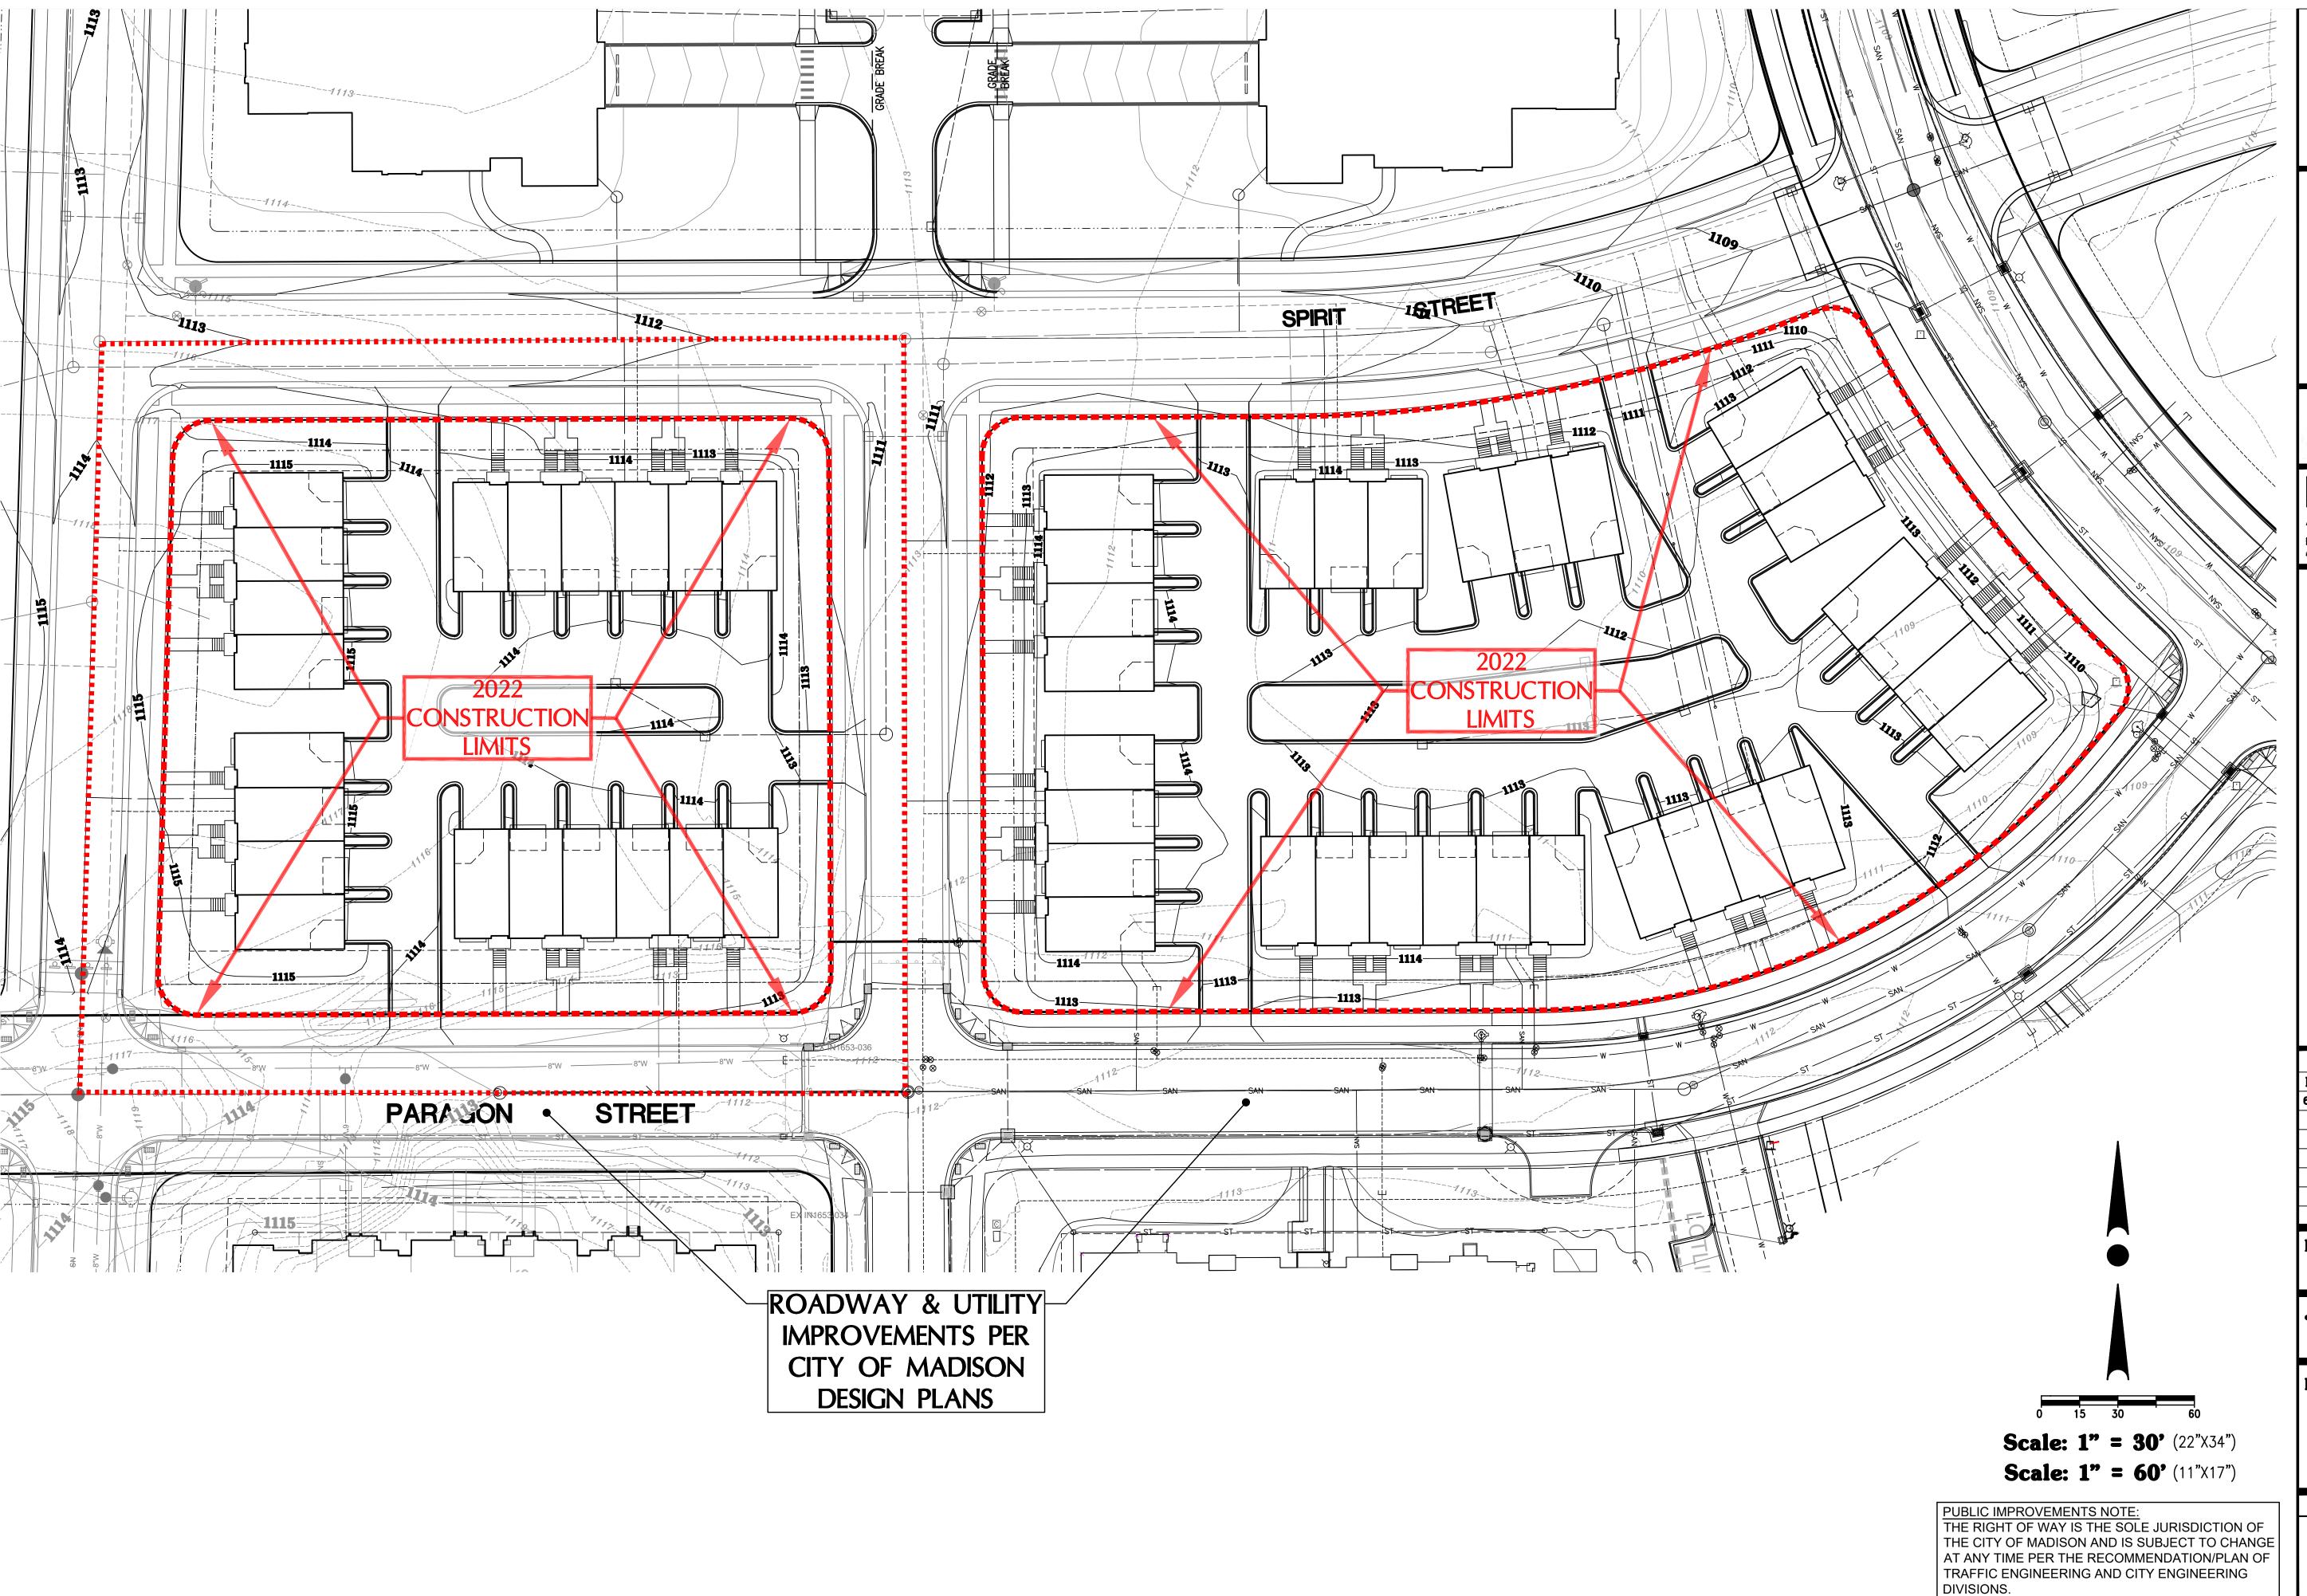





4100 N. CALHOUN ROAD, SUITE BROOKFIELD, WI 53005 PHONE: (262) 790-1480 FAX: (262) 790-1481 EMAIL: jpudelko@trioeng.com



knothe • bruce

Phone: 760| University Ave, Ste 20| 608.836.3690 Middleton, WI 53562

608.836.3690 Middleton, WI 5

PROJECT:
PARAGON PLACE AT BEAR
LOTS 5 & 6
CITY OF MADISON, WI
BY: United Financial Group, Inc.
660 W. Ridgeview Drive
Appleton, WI 54911

REVISION HISTORY
DATE DESCRIPTION
6/8/2021 INITIAL SUBMITTAL

DATE:

JUNE 8, 2022


JOB NUMBER: 12041


DESCRIPTION:

CONTRACT LIMITS PLAN

SHEET

C1.0

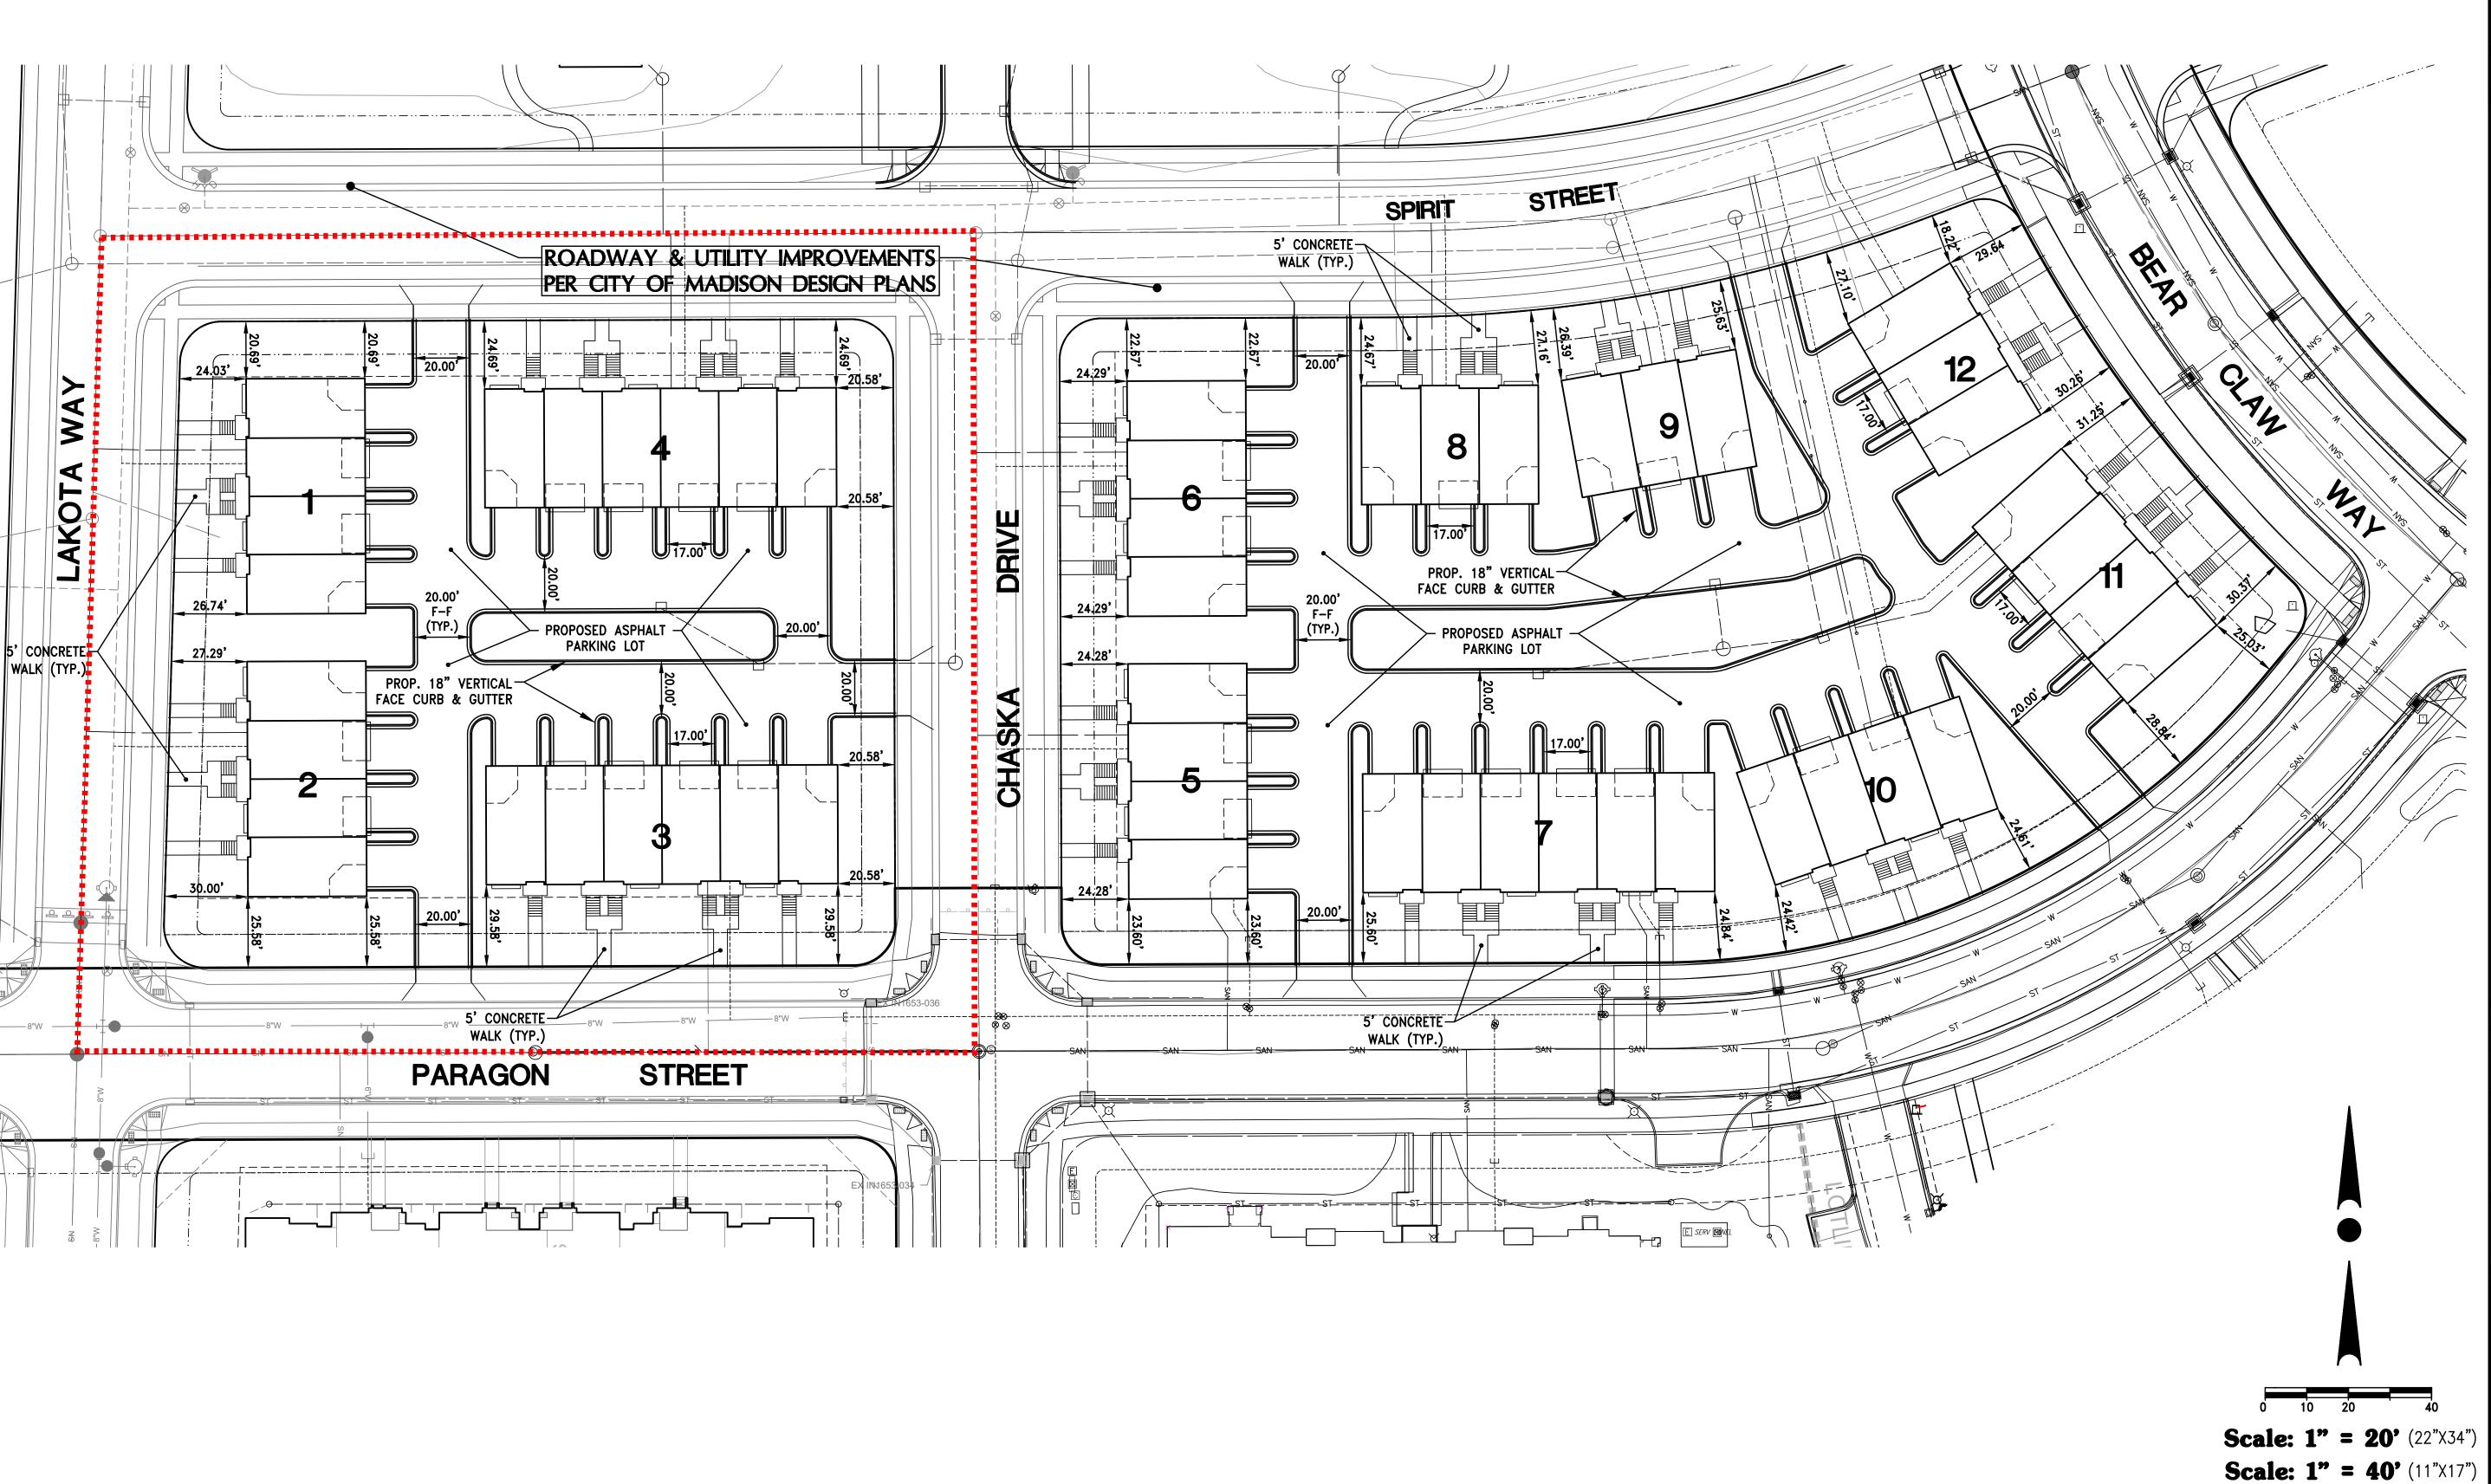

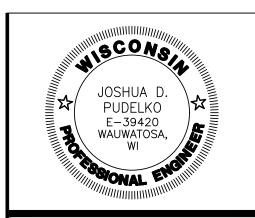



4100 N. CALHOUN ROAD, SUITE 300 BROOKFIELD, WI 53005 PHONE: (262) 790-1480 FAX: (262) 790-1481 EMAIL: jpudelko@trioeng.com

PARAGON PLACE

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Phone: 760| University Ave, Ste 20| 608.836.3690 Middleton, WI 53562

PROJECT:
PARAGON PLACE AT BEAR CLAW W.
LOTS 5 & 6
CITY OF MADISON, WI
BY: United Financial Group, Inc.
660 W. Ridgeview Drive
Appleton, WI 54911

REVISION HISTORY

DATE DESCRIPTION

6/8/2021 INITIAL SUBMITTAL

DATE:

JUNE 8, 2022

JOB NUMBER: 12041

DESCRIPTION:

PUBLIC IMPROVEMENTS NOTE

DIVISIONS.


THE RIGHT OF WAY IS THE SOLE JURISDICTION OF THE CITY OF MADISON AND IS SUBJECT TO CHANGE


AT ANY TIME PER THE RECOMMENDATION/PLAN OF TRAFFIC ENGINEERING AND CITY ENGINEERING

SITE PLAN NORTH

SHEET

C1.1

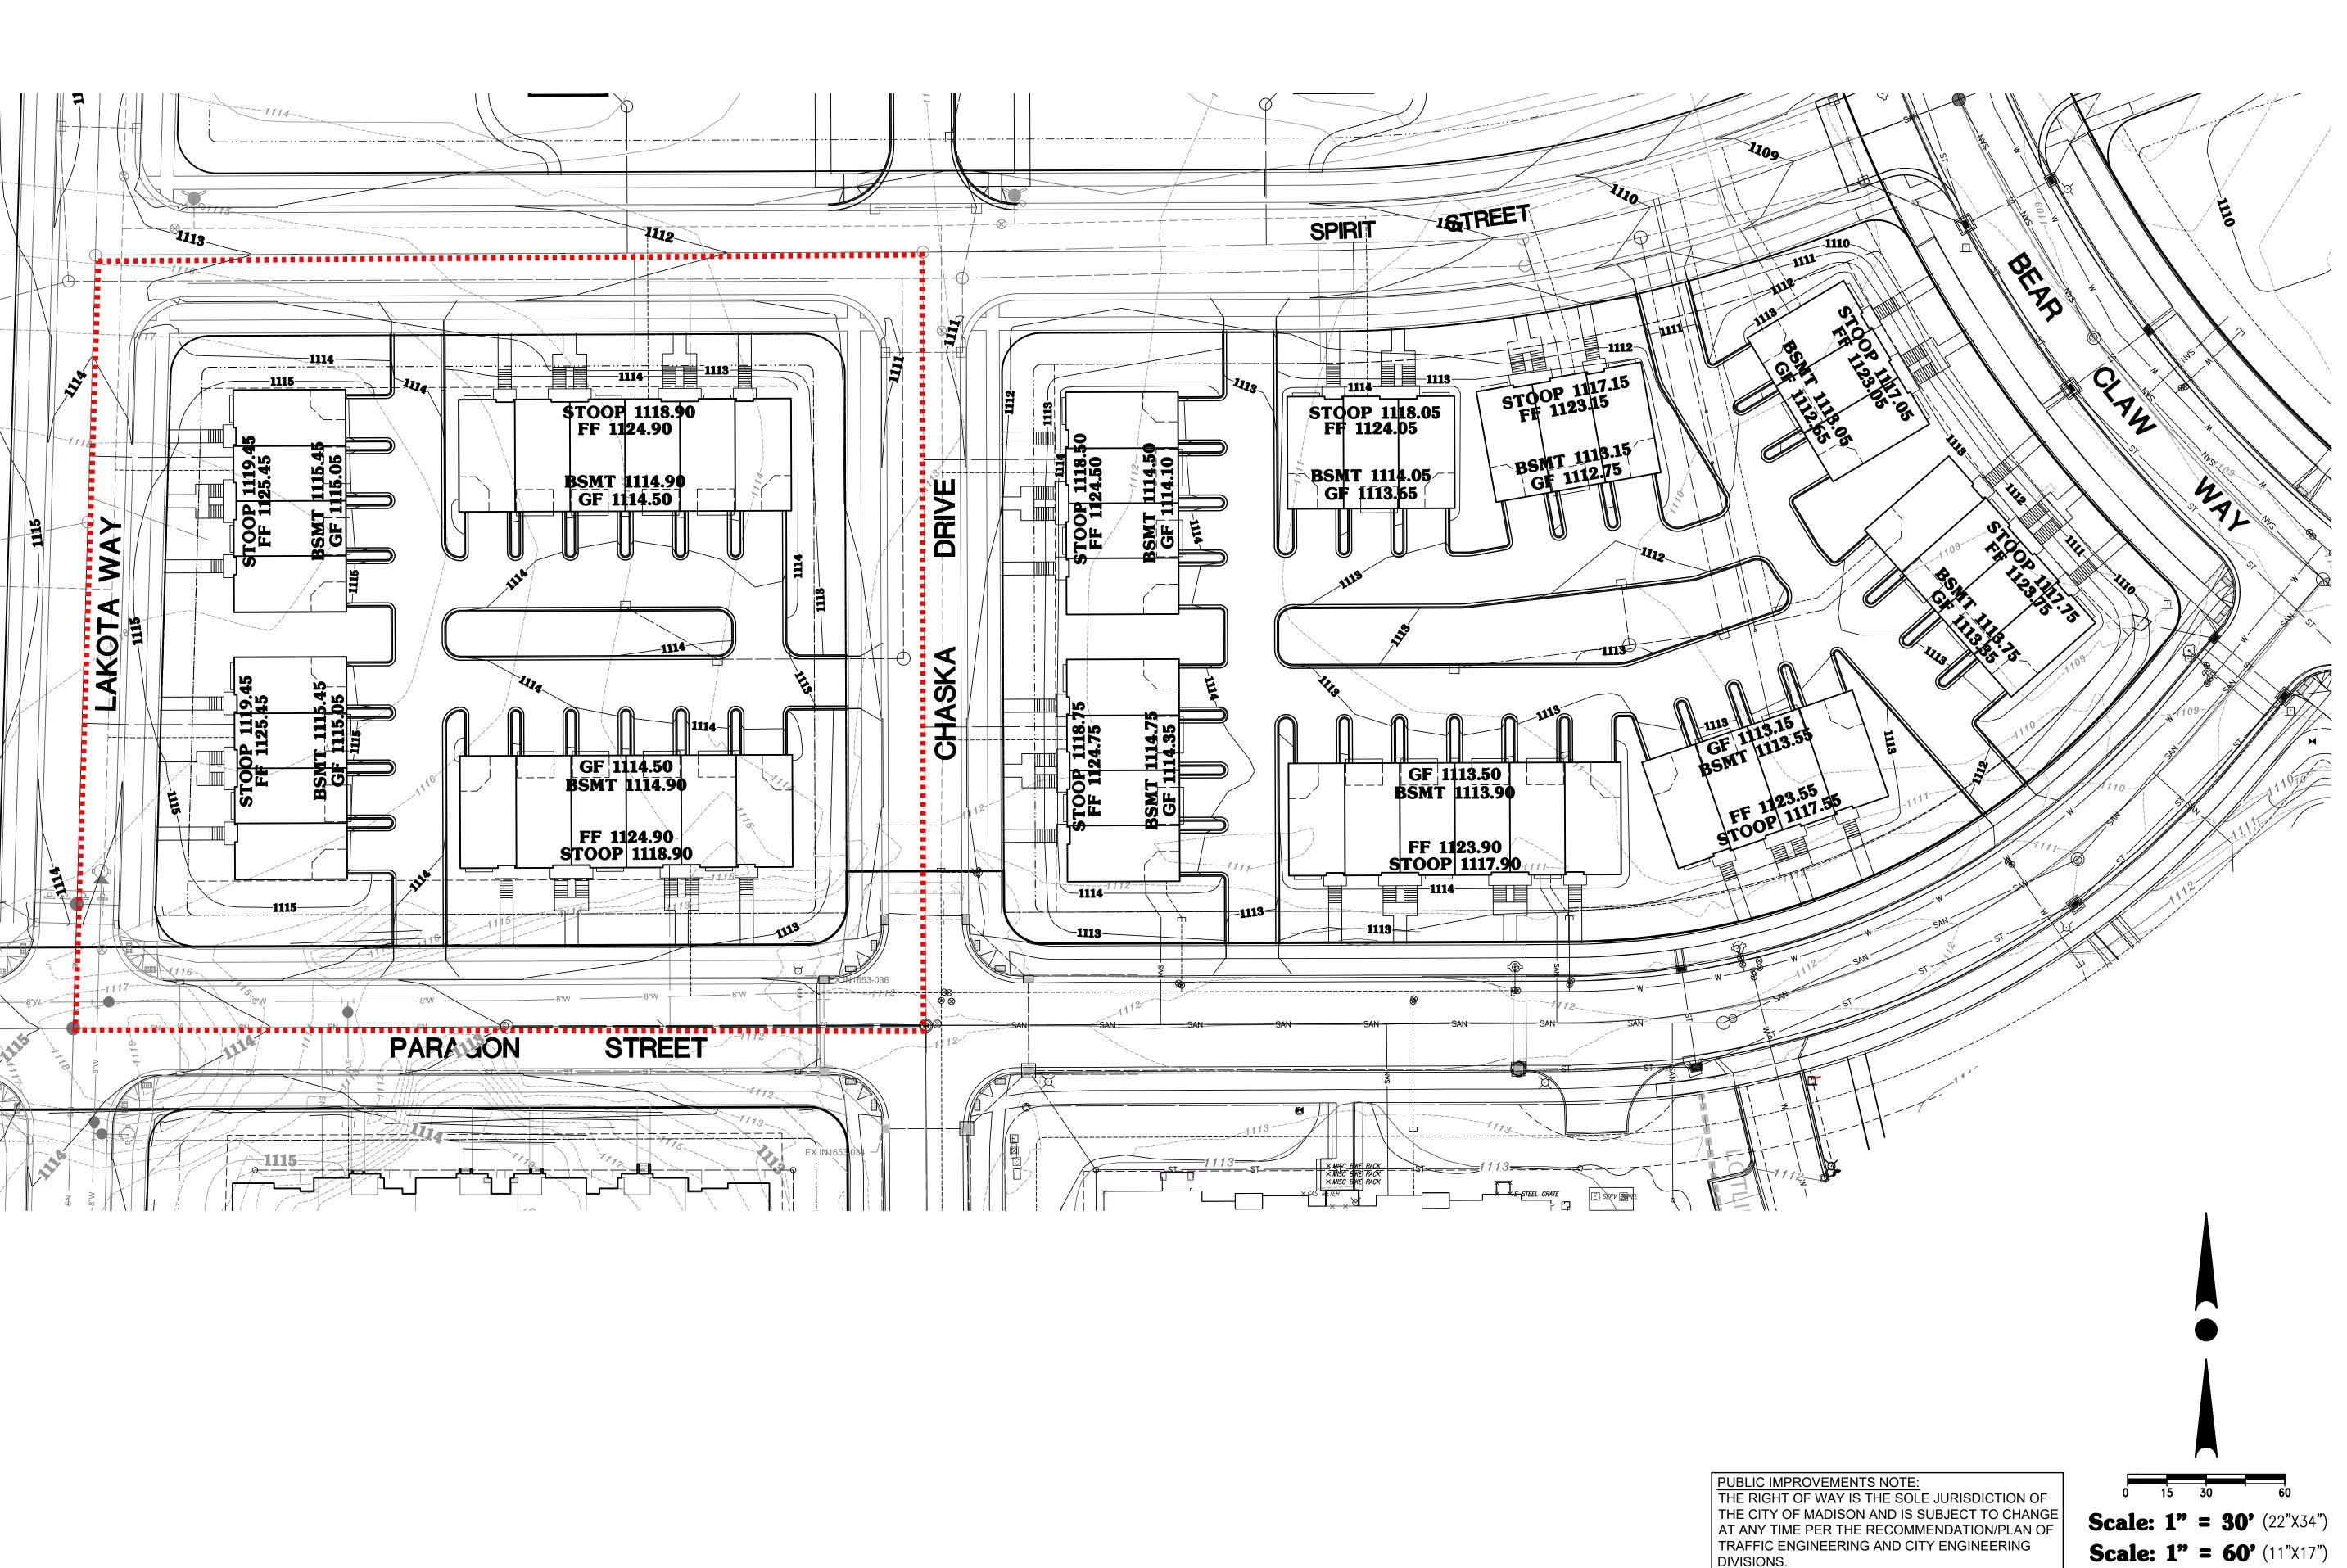

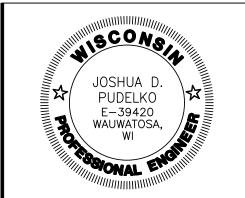



EMAIL: jpudelko@trioeng.com

FAX: (262) 790-1481

PARAGON PLACE

Phone: 7601 University Ave, Ste 201 608.836.3690 Middleton, WI 53562 WAY

CLAW BEAR PLACE PARAGON LOTS 5 & 6 CITY OF N

REVISION HISTORY DATE **DESCRIPTION** 6/8/2021 INITIAL SUBMITTAL

DATE: JUNE 8, 2022


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12041 **DESCRIPTION:**

MASTER GRADING & PAVING PLAN

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C2.0




PUBLIC IMPROVEMENTS NOTE

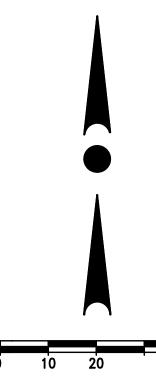THE RIGHT OF WAY IS THE SOLE JURISDICTION OF THE CITY OF MADISON AND IS SUBJECT TO CHANGE AT ANY TIME PER THE RECOMMENDATION/PLAN OF TRAFFIC ENGINEERING AND CITY ENGINEERING DIVISIONS.

Scale: 1" = 20' (22"X34") **Scale: 1" = 40'** (11"X17")

JOSHUA D. PUDELKO E-39420 WAUWATOSA, WI

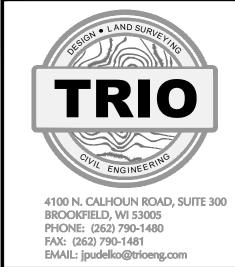

PARAGON PLACE

knothe • bruce

Phone: 7601 University Ave, Ste 201 608.836.3690 Middleton, WI 53562

WAY

PROJECT:
PARAGON PLA
LOTS 5 & 6
CITY OF MAD
BY: United Fina
660 W. Ric
Appleton, V

REVISION HISTORY DATE DESCRIPTION 6/8/2021 INITIAL SUBMITTAL

DATE:

JUNE 8, 2022


JOB NUMBER: 12041

DESCRIPTION: MASTER GRADING &

SHEET

PAVING PLAN

C2.1

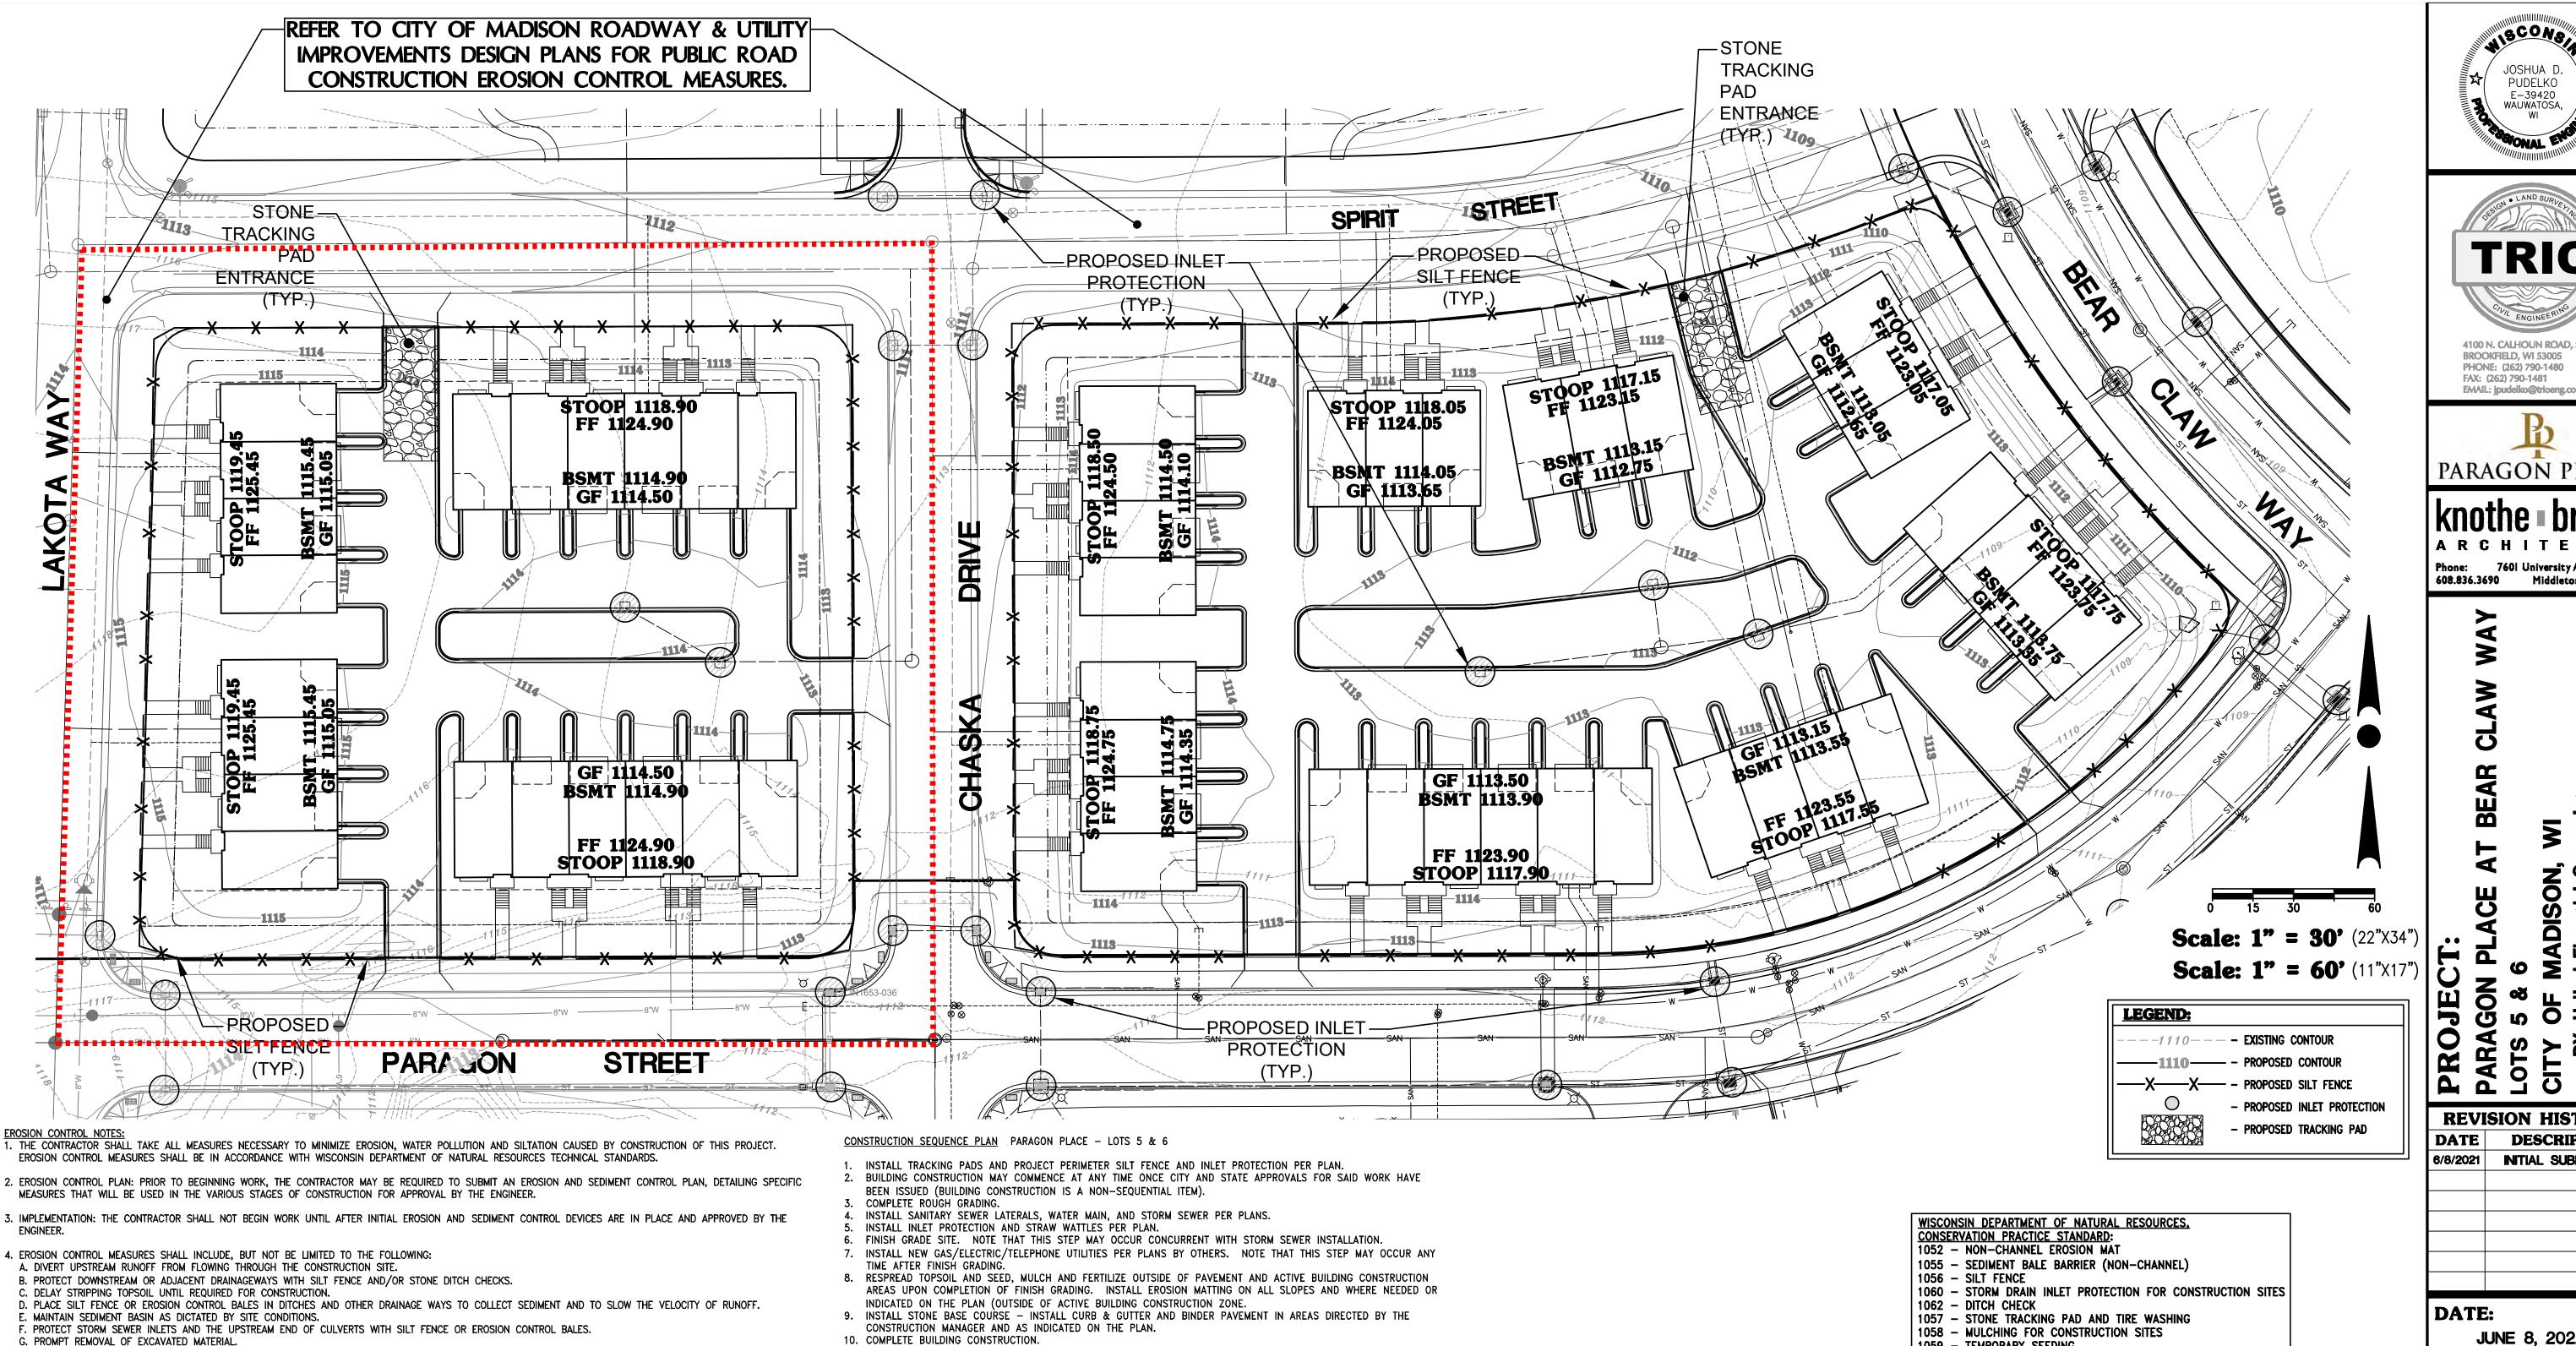

EROSION CONTROL NOTES:

- MEASURES THAT WILL BE USED IN THE VARIOUS STAGES OF CONSTRUCTION FOR APPROVAL BY THE ENGINEER.
- 3. IMPLEMENTATION: THE CONTRACTOR SHALL NOT BEGIN WORK UNTIL AFTER INITIAL EROSION AND SEDIMENT CONTROL DEVICES ARE IN PLACE AND APPROVED BY THE
- H. PROPER STORAGE OF BACKFILL AND BEDDING MATERIALS INCLUDING PLACING SILT FENCE OR EROSION CONTROL BALES ON THE DOWNSLOPE SIDES OF SPOIL PILES. I. CONSTRUCTION OF TRACKING PAD TO CONSTRUCTION SITE TO PREVENT SEDIMENT FROM BEING TRACKED ONTO ROADWAYS.
- J. PROMPT (SAME DAY) CLEANUP OF MATERIAL TRACKED ONTO ADJACENT STREETS. K. TIMELY RESTORATION OF DAMAGE SURFACE AREAS.
- L. ALL AREAS THAT WILL REMAIN DISTURBED AFTER OCTOBER 15, MUST BE TEMPORARY SEEDED AS OF THAT DATE.
- 5. TEMPORARY EROSION CONTROL MEASURES.
- A. THE CONTRACTOR SHALL CONSTRUCT TEMPORARY EROSION CONTROL MEASURES, WHERE EROSION IS LIKELY TO BE A PROBLEM, PRIOR TO BEGINNING WORK ON THOSE SECTION(S) OF THE PROJECT. TEMPORARY EROSION CONTROL MEASURES SHALL BE MAINTAINED UNTIL AFTER PERMANENT EROSION CONTROL, SUCH AS SEEDING OR SODDING, HAS BEEN ESTABLISHED.
- B. IN THE EVENT THE PERMANENT EROSION CONTROL MEASURES ARE NOT FULLY IMPLEMENTED IN CURRENT CONSTRUCTION SEASON, THE CONTRACTOR SHALL BE RESPONSIBLE FOR MAINTAINING ALL NECESSARY TEMPORARY EROSION CONTROL MEASURES UNTIL AFTER PERMANENT MEASURES HAVE BEEN COMPLETED IN THE FOLLOWING YEAR.
- 6. ALL DISTURBANCE AREAS THAT REMAIN INACTIVE FOR SEVEN DAYS OR LONGER SHALL RECEIVE TEMPORARY SEEDING.
- 7. TRENCH DEWATERING SHALL BE IN ACCORDANCE WITH WDNR TECHNICAL STANDARDS.
- 8. INSTALL SILT FENCE IN ACCORDANCE WITH WDNR TECHNICAL STANDARD DETAILS
- 9. ALL RIP RAP AT PIPE OUTLETS SHALL BE 3'x5' MEDIUM RIP RAP OVER TYPE R FABRIC PER WDOT SPECIFICATIONS UNLESS OTHERWISE DESIGNATED.
- 10. EROSION CONTROL INSPECTION AND MAINTENANCE
- A. INSPECT EROSION CONTROL MEASURES WEEKLY AND AFTER SITE RECEIVES 0.5" OF RAIN IN A 24-HOUR PERIOD DURING CONSTRUCTION. B. REPAIR OR REPLACE EROSION CONTROLS THAT ARE DAMAGED OR FAILING.
- 11. ALL AREAS TO BE SEEDED AND MULCHED SHALL USE WDOT SEED MIXTURE NO. 20. MULCH SHALL APPLIED PER WDOT SPECIFICATIONS USING METHOD B FOR PLACEMENT.

- 11. COMPLETE ANY REMAINING CURB & GUTTER AND BINDER COURSE PAVEMENT INSTALLATION.
- 12. INSTALL SIDEWALK AS INDICATED ON THE PLAN, PER CONSTRUCTION MANAGER'S SCHEDULE AND DIRECTION.
- 13. RESPREAD TOPSOIL AND SEED, MULCH AND FERTILIZE BUILDING CONSTRUCTION ZONE AREA. INSTALL LANDSCAPING PER LANDSCAPE PLAN AND CONSTRUCTION MANAGER'S SCHEDULE/DIRECTION.
- 14. REMOVE PERIMETER SILT FENCE ONCE THE AREA IS SUBSTANTIALLY STABILIZED/VEGETATED ANTICIPATED TO BE CONCURRENT WITH COMPLETION OF FINAL LANDSCAPING.

- 1059 TEMPORARY SEEDING
- 1061 DE-WATERING (NOT ANTICIPATED PER SOIL BORINGS)

1064 - SEDIMENT BASIN

CONCRETE WASH AREA NOTE:

CONCRETE MANAGEMENT SHALL INCLUDE A HAY BALE AND PLASTIC WASHOUT PIT AT THE

EDGE OF THE CONSTRUCTION AREA, WHICH WILL BE PROPERLY DISPOSED OF WHEN FULL/COMPLETED, CONC. WASH AREA SHALL NOT BE DISCHARGED TO SED. BASIN.

PUBLIC IMPROVEMENTS NOTE

THE RIGHT OF WAY IS THE SOLE JURISDICTION OF THE CITY OF MADISON AND IS SUBJECT TO CHANGE AT ANY TIME PER THE RECOMMENDATION/PLAN OF TRAFFIC ENGINEERING AND CITY ENGINEERING DIVISIONS.

DEWATERING NOTE:

DEWATERING, IF NECESSARY, SHALL BE DISCHARGED TO THE SEDIMENT BASIN

INLET PROTECTION NOTE:

FRAMED INLET PROTECTION SHALL BE USED ON PUBLIC INLETS PER CITY OF MADISON STANDARDS. STANDARD FILTER BAGS WITH FLAPS MAY BE USED ON PRIVATE PORTIONS OF THE SITE.

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PARAGON PLACE

knothe | bruce ARCHITECTS

608.836.3690 Middleton, WI 53562

ARAGON
OTS 5 & 6
CITY OF N
BY: United
660 V
Apple

REVISION HISTORY

DATE DESCRIPTION 6/8/2021 INITIAL SUBMITTAL


JUNE 8, 2022

JOB NUMBER: 12041


DESCRIPTION:

EROSION CONTROL PLAN

SHEET

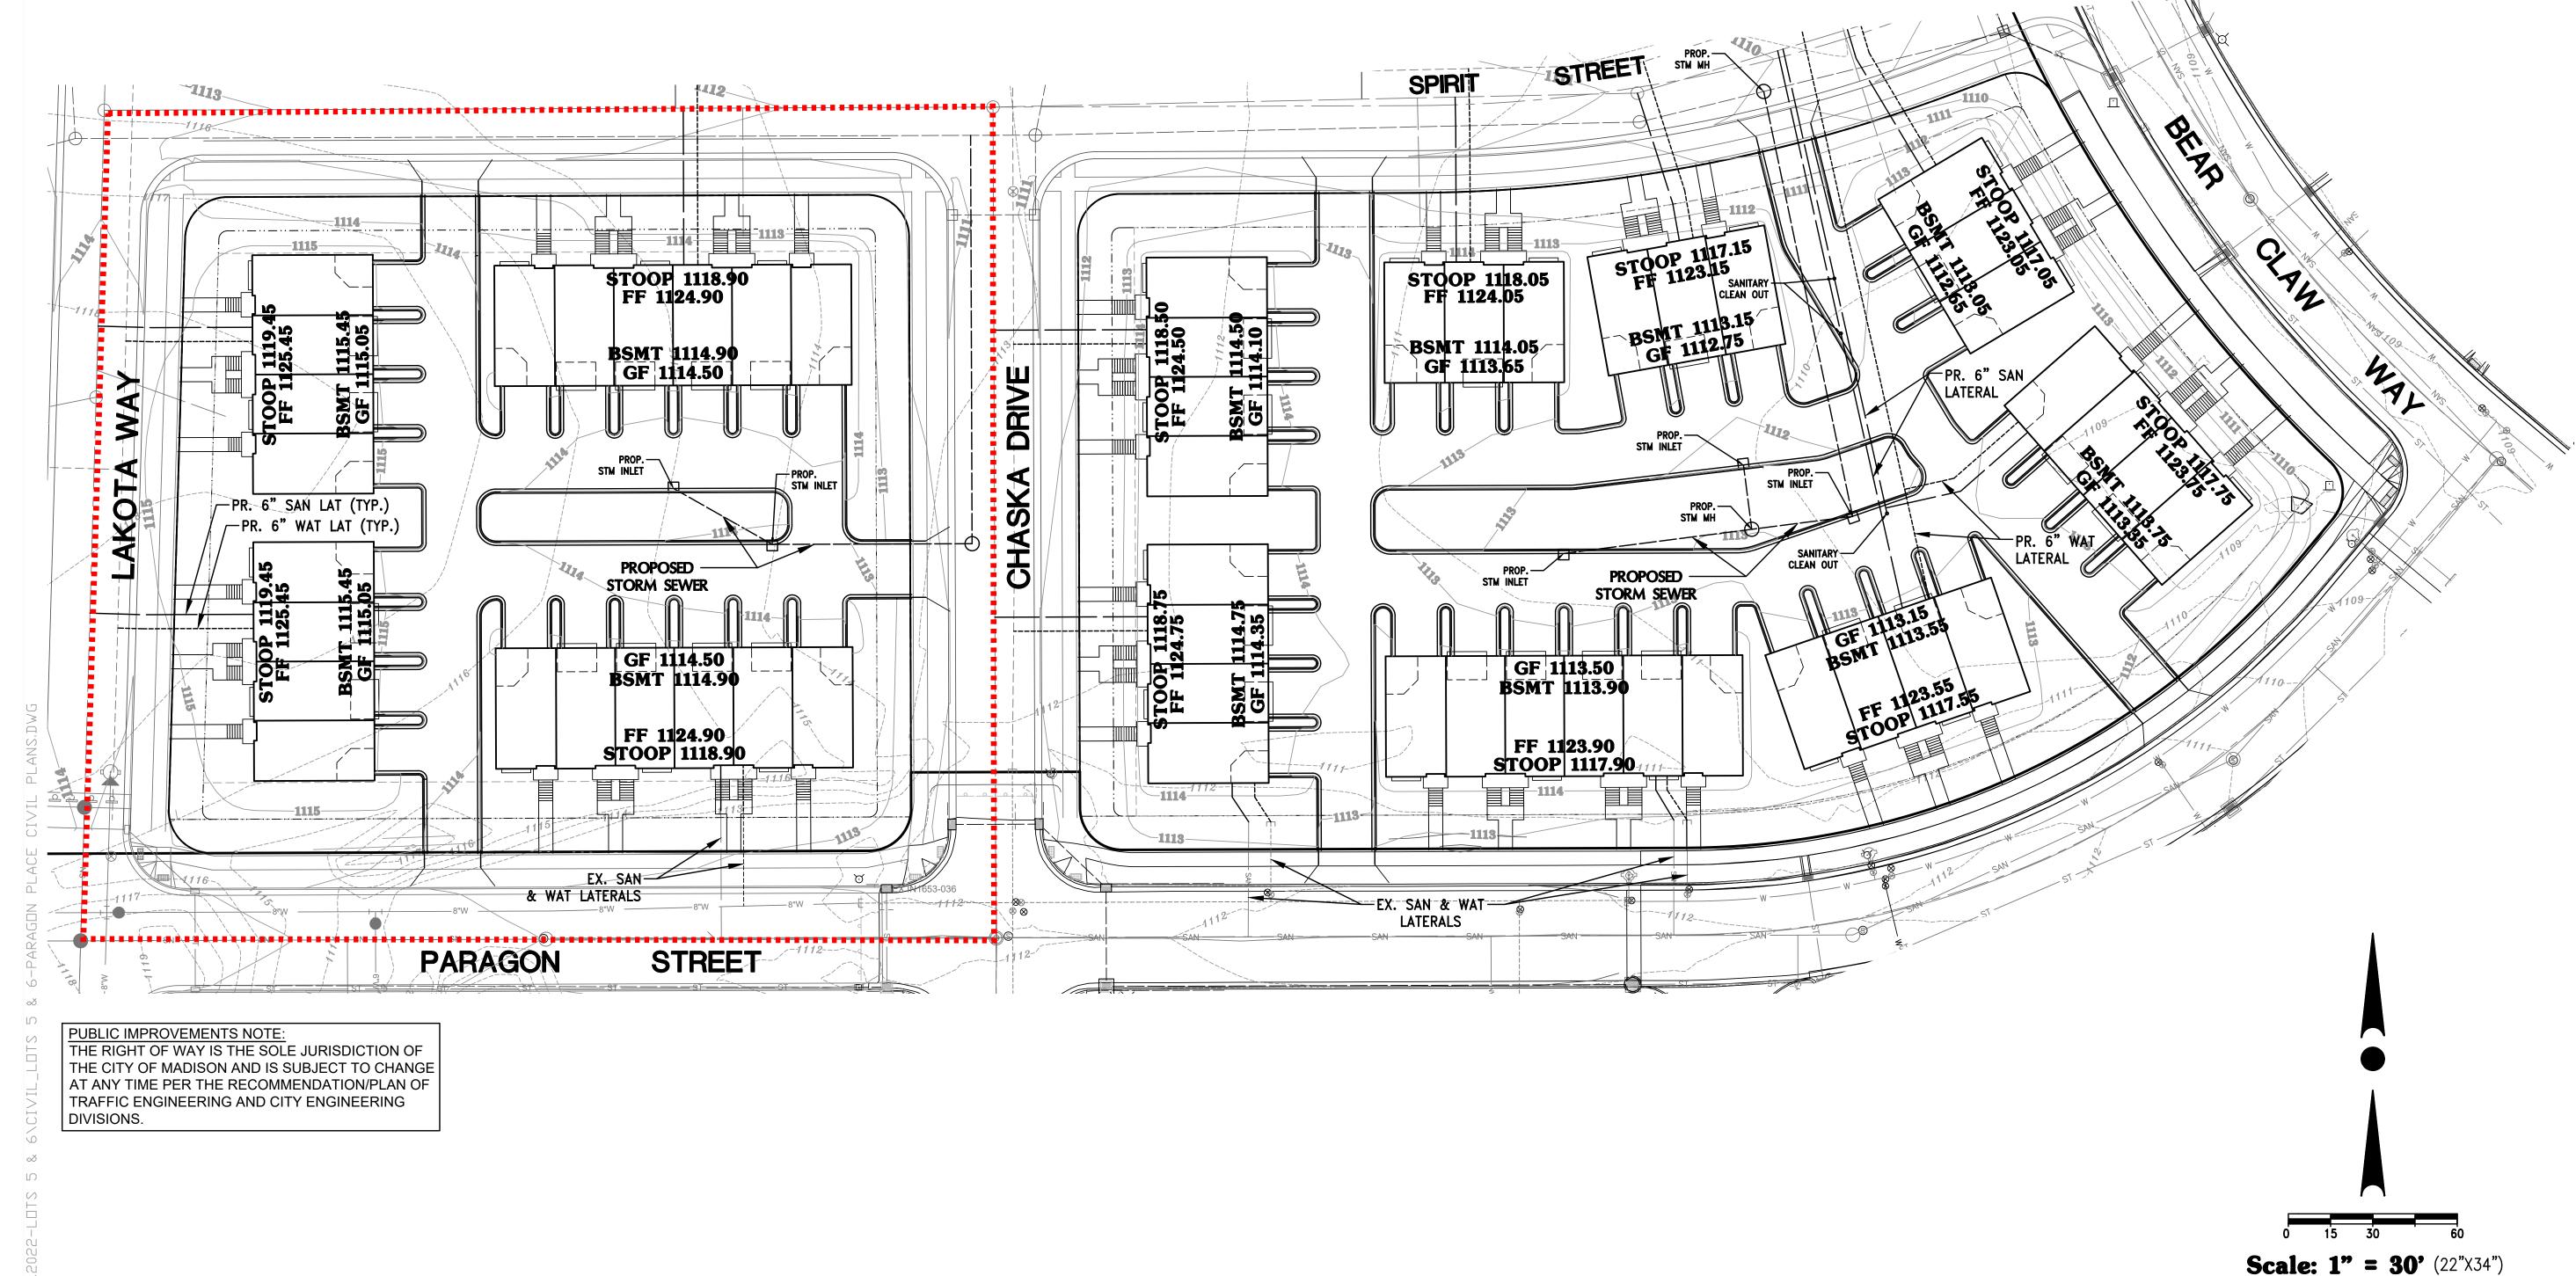

LEGEND: — – PROPOSED SANITARY SEWER - PROPOSED SANITARY MANHOLE - PROPOSED WATER MAIN PROPOSED HYDRANT - PROPOSED WATER VALVE ————— – PROPOSED STORM SEWER - PROPOSED STORM MANHOLE - PROPOSED STORM INLET - PROPOSED STORM END SECTION

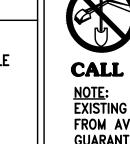


CONTRACTOR IS REQUIRED TO CONTACT DIGGERS
HOTLINE TOLL FREE TO OBTAIN LOCATION OF HOTLINE TOLL FREE TO OBTAIN LOCATION OF UNDERGROUND UTILITIES PRIOR TO COMMENCING THE WORK. WISCONSIN STATUTE 182.0715 REQUIRES MIN. OF 3 WORK DAYS NOTICE BEFORE YOU EXCAVATE.

CALL DIGGERS HOTLINE 1-800-242-8511

Scale: 1" = 60' (11"X17")

EXISTING UNDERGROUND UTILITY INFORMATION WAS OBTAINED FROM AVAILABLE RECORDS. THE ENGINEER MAKES NO GUARANTEE AS TO THE ACCURACY OF THIS INFORMATION. VERIFICATION TO THE SATISFACTION OF THE CONTRACTOR OF ALL UNDERGROUND UTILITIES, WHETHER OR NOT SHOWN ON THE PLANS, SHALL BE ASSUMED AS A CONDITION OF THE CONTRACT. THE CONTRACTOR SHALL NOTIFY THE ENGINEER OF ANY DISCREPANCIES BETWEEN LOCATION OF UTILITIES IN THE FIELD AND LOCATIONS SHOWN ON THE PLANS.

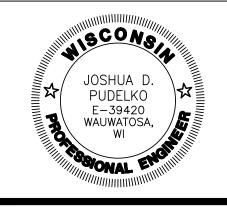



BROOKFIELD, WI 53005 PHONE: (262) 790-1480 FAX: (262) 790-1481 EMAIL: jpudelko@trioeng.com

PARAGON PLACE

Phone: 7601 University Ave, Ste 201 608.836.3690 Middleton, WI 53562

WAY CLAW

BEAR

ACE

PARAGON
LOTS 5 & 6
CITY OF N
BY: United
660 v
660 v **REVISION HISTORY** DATE **DESCRIPTION** 6/8/2021 INITIAL SUBMITTAL

DATE:

JUNE 8, 2022

JOB NUMBER: 12041


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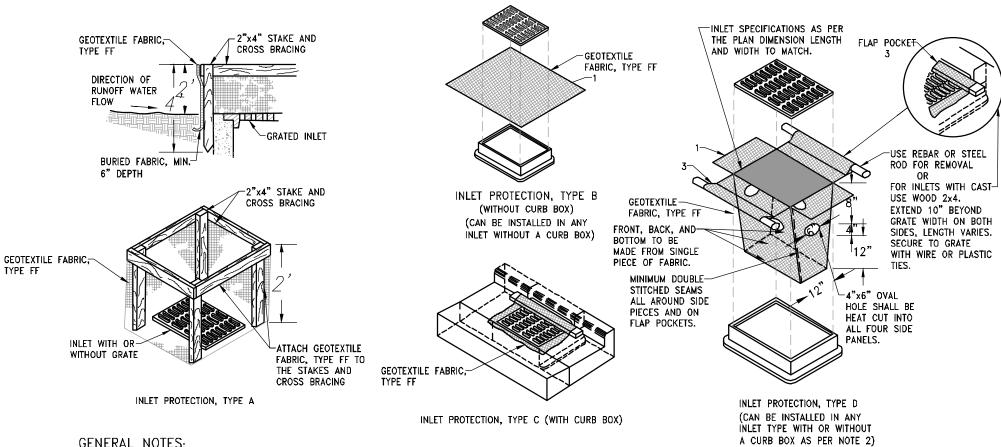
UTILITY **PLAN**

SHEET

C3.0

CONSTRUCTION ENTRANCE DETAIL NO SCALE



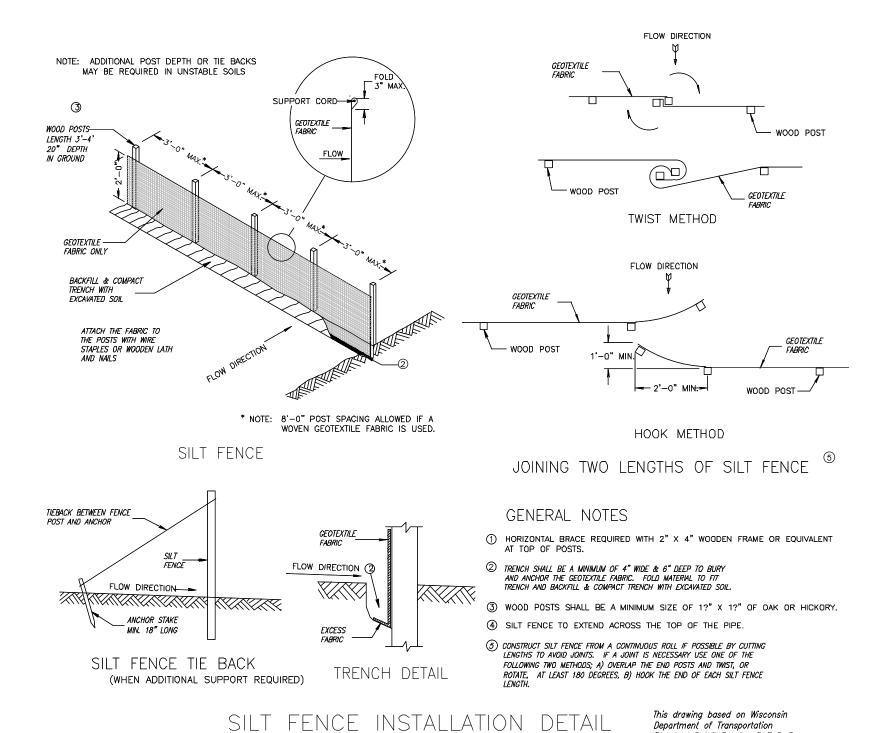

GENERAL NOTES:

MANUFACTURED ALTERNATIVES APPROVED AND LISTED ON THE DEPARTMENT'S EROSION CONTROL PRODUCT ACCEPTABILITY LIST MAY BE SUBSTITUTED.

NO SCALE

WHEN REMOVING OR MAINTAINING INLET PROTECTION, CARE SHALL BE TAKEN SO THAT THE SEDIMENT TRAPPED ON THE GEOTEXTILE FABRIC DOES NOT FALL INTO THE INLET. ANY MATERIAL FALLING INTO THE INLET SHALL BE REMOVED IMMEDIATELY.

1. FINISHED SIZE, INCLUDING FLAP POCKETS WHERE REQUIRED, SHALL EXTEND A MINIMUM OF 10" AROUND THE PERIMETER TO FACILITATE MAINTENANCE OR REMOVAL.

2. FOR INLET PROTECTION, TYPE C (WITH CURB BOX). AN ADDITIONAL 18" OF FABRIC IS WRAPPED AROUND THE WOOD AND SECURED WITH STAPLES. THE WOOD SHALL NOT BLOCK THE ENTIRE HEIGHT OF THE CURB BOX OPENING.

3. FLAP POCKETS SHALL BE LARGE ENOUGH TO ACCEPT WOOD 2X4.

INSTALLATION NOTES:

TYPE B & C TRIM EXCESS FABRIC IN THE FLOW LINE TO WITHIN 3" OF THE GRATE. THE CONTRACTOR SHALL DEMONSTRATE A METHOD OF MAINTENANCE, USING A SEWN FLAP, HAND HOLDS OT OTHER METHOD TO PREVENT ACCUMULATED SEDIMENT FROM ENTERING THE INLET.

Standard Detail Drawing 8 E 9-6

DO NOT INSTALL INLET PROTECTION TYPE D IN INLETS SHALLOWER THAN 30",

MEASURED FROM THE BOTTOM OF THE INLET TO THE TOP OF THE GRATE. TRIM EXCESS FABRIC IN THE FLOW LINE TO WITHIN 3" OF THE GRATE.

THE INSTALLED BAG SHALL HAVE A MINIMUM SIDE CLEARANCE, BETWEEN THE INLET WALLS AND THE BAG, MEASURED AT THE BOTTOM OF THE OVERFLOW HOLES, OF 3". WHERE NECESSARY THE CONTRACTOR SHALL CINCH THE BAG, USING PLASTIC ZIP TIES, TO ACHIEVE THE 3" CLEARANCE. THE TIES SHALL BE PLACED AT A MAXIMUM OF 4" FROM THE BOTTOM OF THE BAG.

-1-1/2" OF BITUMINOUS COMMERCIAL GRADE SURFACE COURSE FINISH GRADE 2-1/2" OF BITUMINOUS COMMERCIAL GRADE BINDER COURSE -12" OF COMPACTED BASE COURSE -6" OF 3/4" T.B. -6" OF 1-1/2" T.B. (RECOMPACT & PROOFROLL PRIOR TO PAVING) UNDISTURBED SOIL OR COMPACTED FILL TO A MIN. NOTE: ALL AGGREGATE PROVIDED MUST COMPLY 95% COMPACTION WITH "SECTION 305 DENSE GRADED BASE" OF THE WISCONSIN STANDARD SPECIFICATIONS FOR HIGHWAY AND STRUCTURE CONSTRUCTION

SW ELEV

SIDEWALK

WHERE CONCRETE

ABUT SIDEWALK, INSTALL 6" WIDE

CURB HEAD

FINISH

NO SCALE

4"---

STANDARD PARKING LOT ASPHALT PAVING DETAIL NO SCALE

-4" COMPACTED GRANULAR BASE

(UNLESS OTHERWISE SPECIFIED)

CONCRETE

CONCRETE GUTTER DETAIL

(SEE GRADES)

4" UNLESS OTHERWISE

INDICATED ON PLANS

CONCRETE SIDEWALK

NO SCALE

UNDISTURBED SOIL OR

95% COMPACTION

COMPACTED FILL TO A MIN.

NOTE: ALL AGGREGATE PROVIDED MUST COMPLY WITH "SECTION 305 DENSE GRADED BASE" OF

THE WISCONSIN STANDARD SPECIFICATIONS FOR

2% TYPICAL

FINISH

GUTTER

GUTTER DOES NOT 0.25"/FT.

(WHERE SIDEWALK ADJOINS DRIVEWAYS/PARKING AREAS)

INTEGRAL SIDEWALK & BARRIER CURB

 $W1.4 \times W1.4 \text{ W.W.F.}$

TRANSITION PVMT 6" @ CURB RAMPS

> -1/8" X 1 1/2" CONTROL

JOINT (TOOLED, NOT SAWED)

 $W1.4 \times W1.4 W.W.F.$

GRANULAR BASE

SPECIFIED)

6" THICK CONCRETE PAD

W/ 10 GAUGE WIRE MESH

-2" OF FOAM INSULATION

-6" OF 3/4" T.B.

PRIOR TO PAVING)


-6" OF 1-1/2" T.B.


(RECOMPACT & PROOFROLL


-12" OF COMPACTED BASE COURSE


(UNLESS OTHERWISE

4" COMPACTED

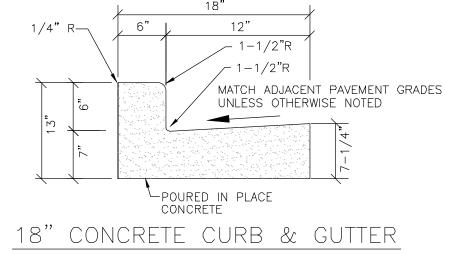


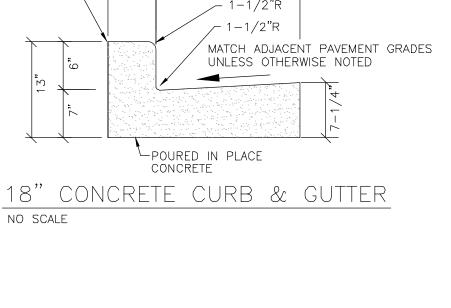

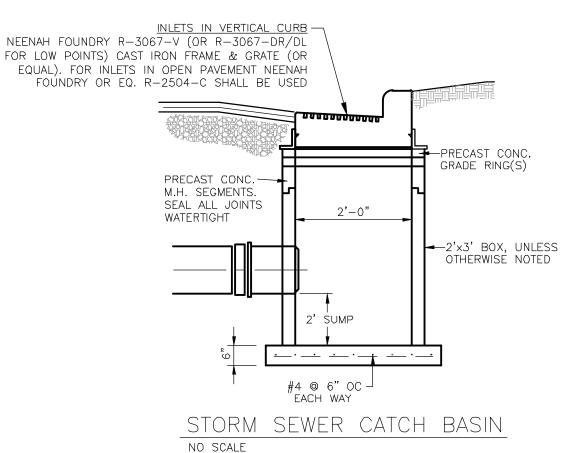


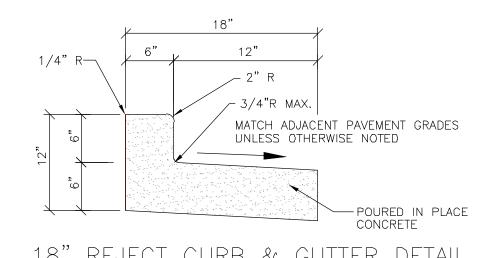


18" REJECT CURB & GUTTER DETAIL NO SCALE

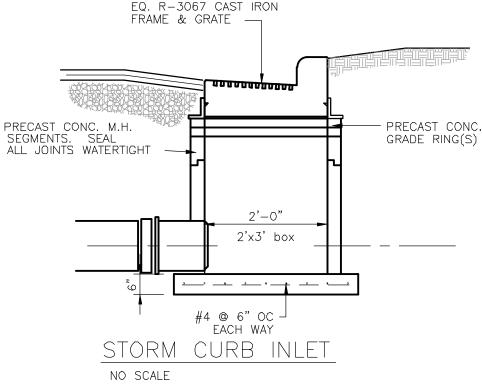

PARKING LOT STORM INLET NOTE: PROPOSED STORM SEWER INLETS WITHIN THE PARKING LOT SHALL HAVE AN OIL AND GREASE FILTER INSTALLED PER MANUFACTURER'S SPECIFICATIONS. ACCEPTABLE PRODUCTS INCLUDE Flexstorm Inlet Filters BY INLET & PIPE PROTECTION, INC.; FloGard+Plus® CATCH BASIN INSERT FILTER BY KRISTAR ENTERPRISES, INC.; Catch—All HR—1 Inlet and Catch Basin Filtration Device BY MARATHON MATERIALS, INC.; OR APPROVED EQUAL.

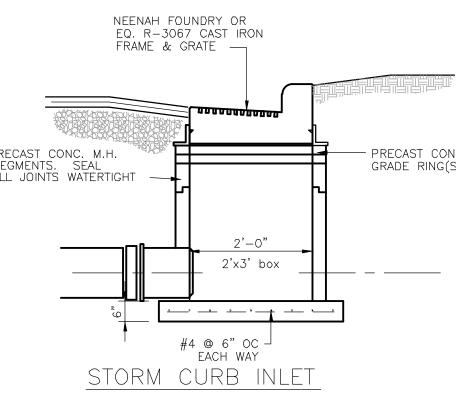

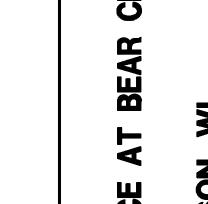

PROJE PARAGON LOTS 5 & 6 CITY OF N BY: United 660

SCONS

JOSHUA D.

PUDELKO

E-39420 WAUWATOSA,

4100 N. CALHOUN ROAD, SUITE 300

PARAGON PLACI

knothe • bruce

ARCHITECTS

608.836.3690 Middleton, WI 53562

⋖

7601 University Ave, Ste 201

BROOKFIELD, WI 53005

PHONE: (262) 790-1480

FAX: (262) 790-1481 EMAIL: jpudelko@trioeng.com

REVISION HISTORY | DATE | DESCRIPTION 6/8/2021 NITIAL SUBMITTAL

DATE: JUNE 8, 2022


JOB NUMBER: 12041

DESCRIPTION:

CONSTRUCTION **DETAILS**


SHEET

C4.0

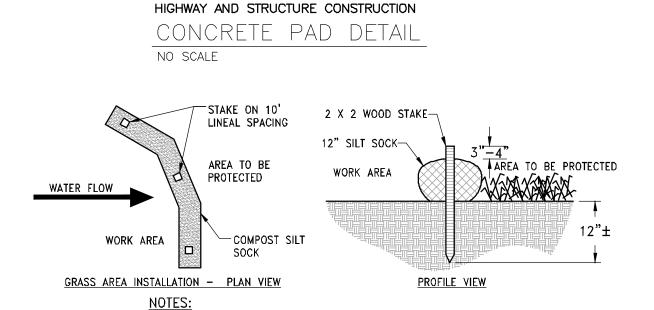


- ALL MATERIAL TO MEET MANUFACTURER'S SPECIFICATIONS
- REFER TO MANUFACTURERS AND/OR SUPPLIERS.
- SPECIFICATIONS FOR INSTALLATION RECOMMENDATIONS. 3. ACTUAL LOCATION MAY BE FIELD ADJUSTED TO MINIMIZE DISTURBANCE TO EXISTING VEGETATION.
 - SILT SOCK DETAIL NO SCALE


INLET PROTECTION DETAIL

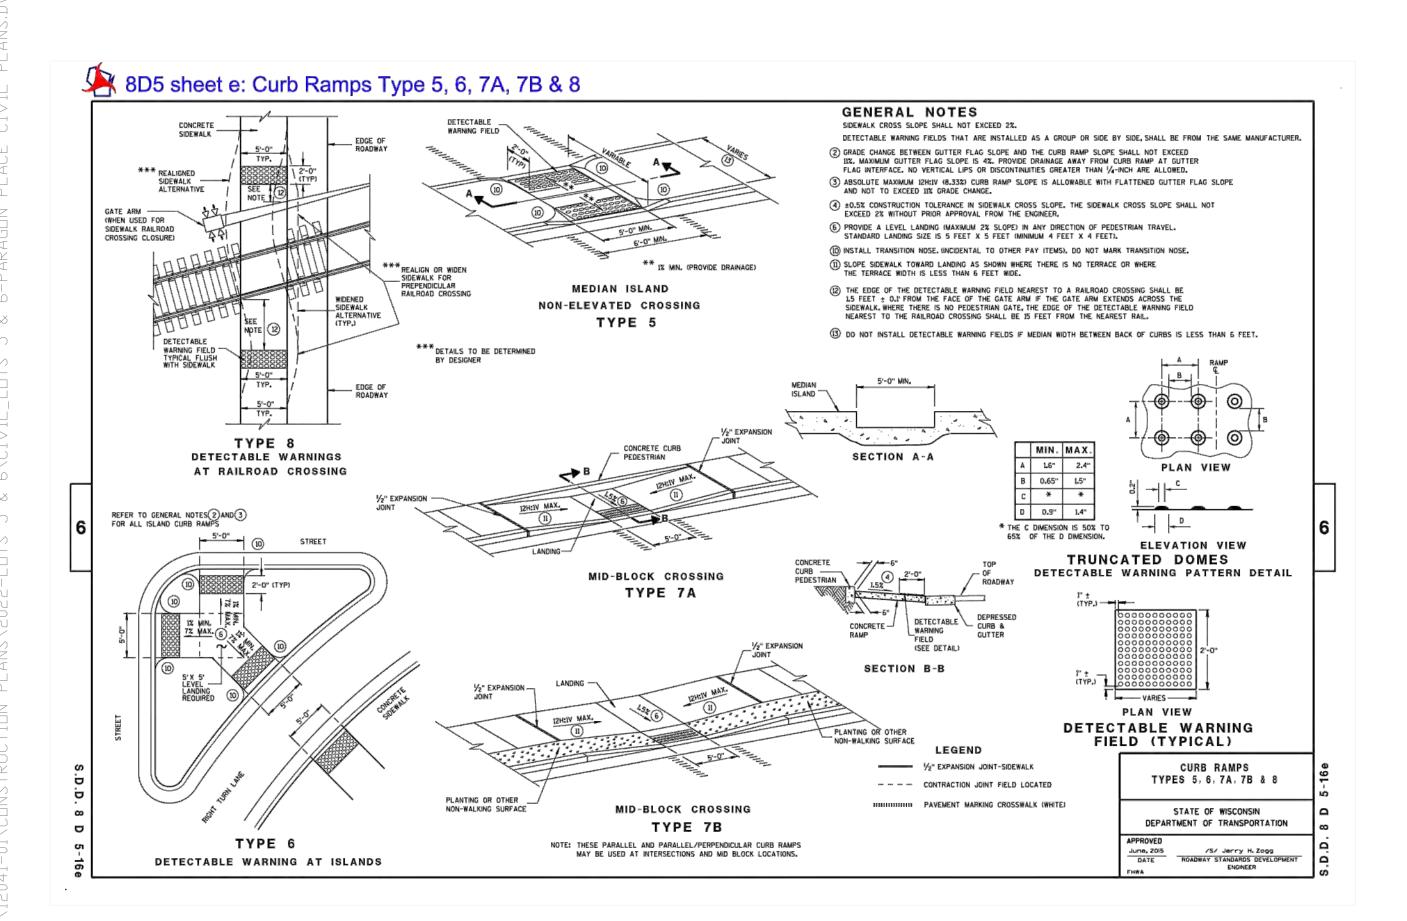


STANDARD CURB RAMP DETAILS

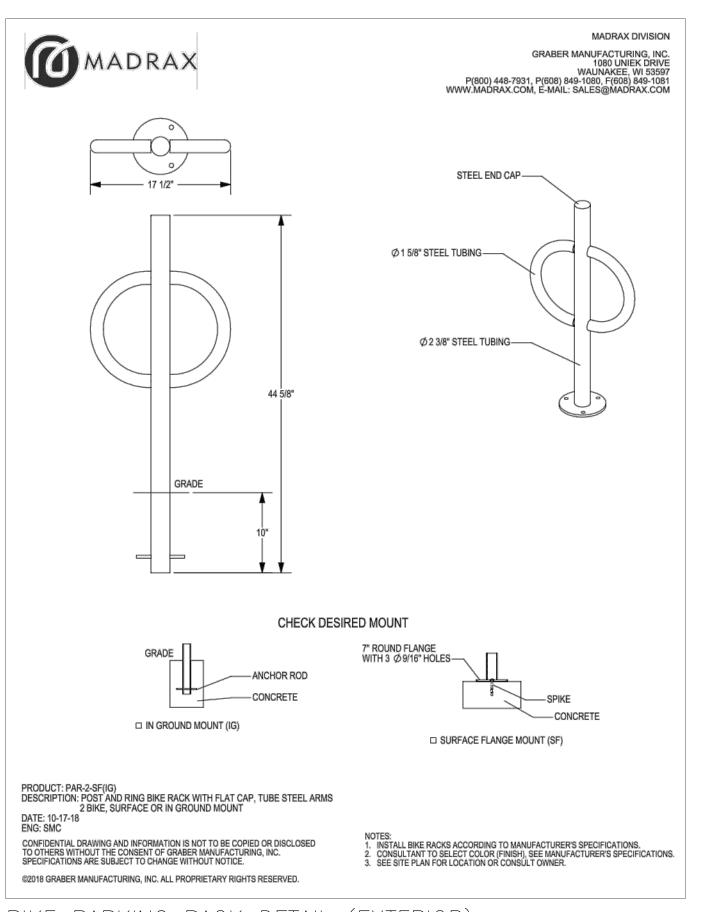

BIKE PARKING RACK DETAIL (EXTERIOR)

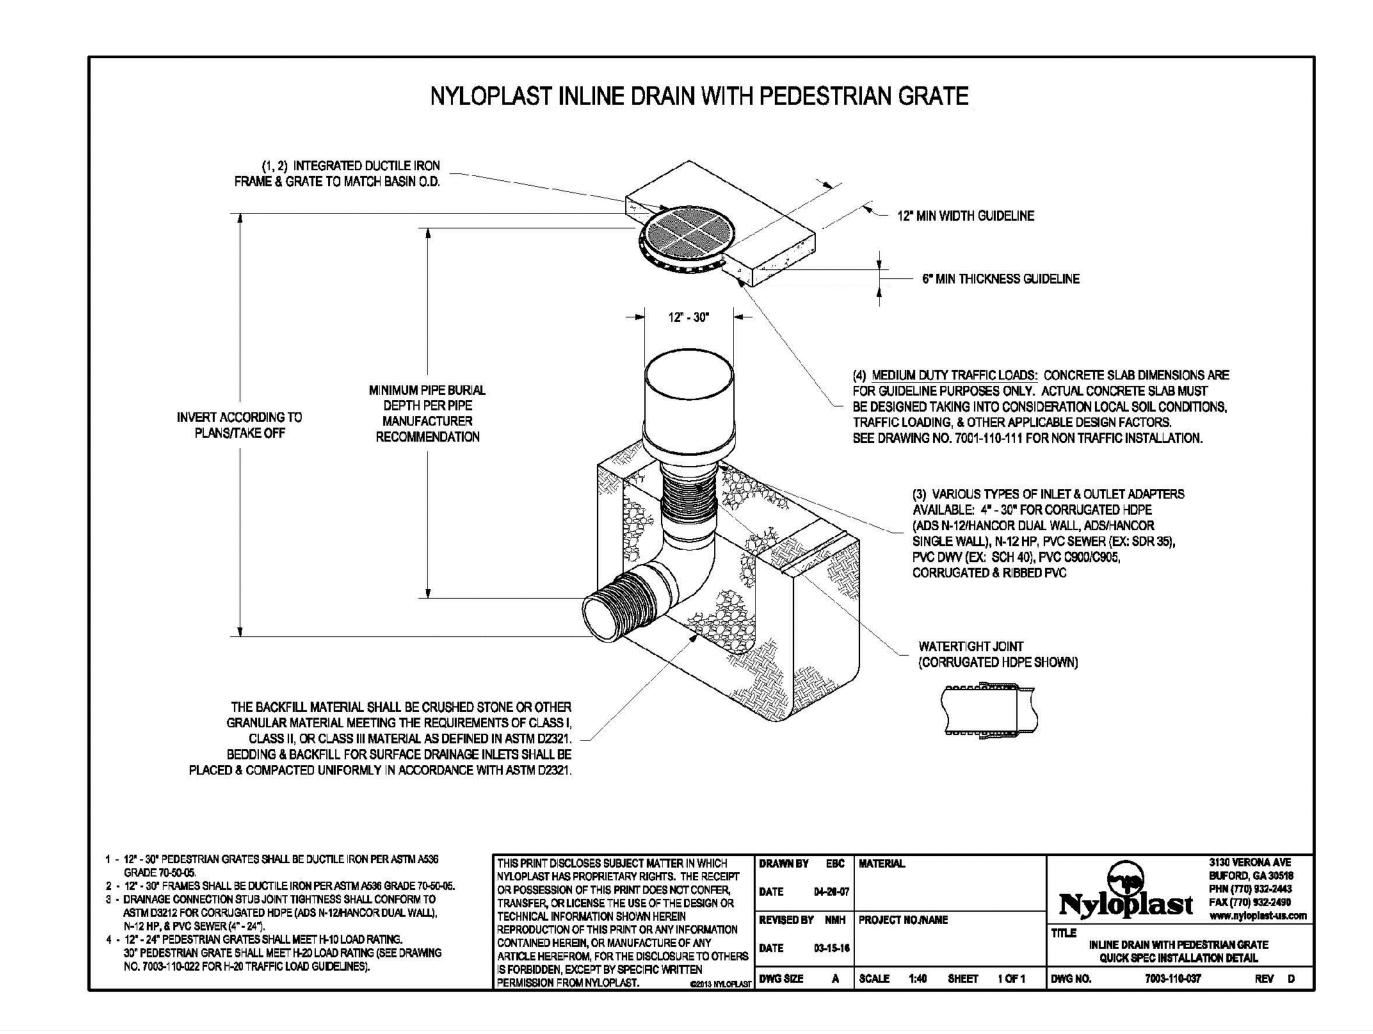

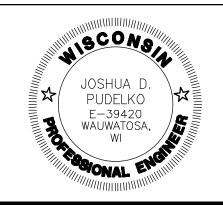



PARAGON PLACE

knothe bruce

Phone: 7601 University Ave, Ste 201 608.836.3690 Middleton, WI 53562

608.836.3690 Middleton, WI 5

OTS 5 & 6
ITY OF MADISON, WI
BY: United Financial Group, Inc.
660 W. Ridgeview Drive

REV	SION HISTORY
DATE	DESCRIPTION
6/8/2021	INITIAL SUBMITTAL

DATE:JUNE 8, 2022

PRO


JOB NUMBER: 12041


DESCRIPTION:

CONSTRUCTION DETAILS

SHEET

C4.1

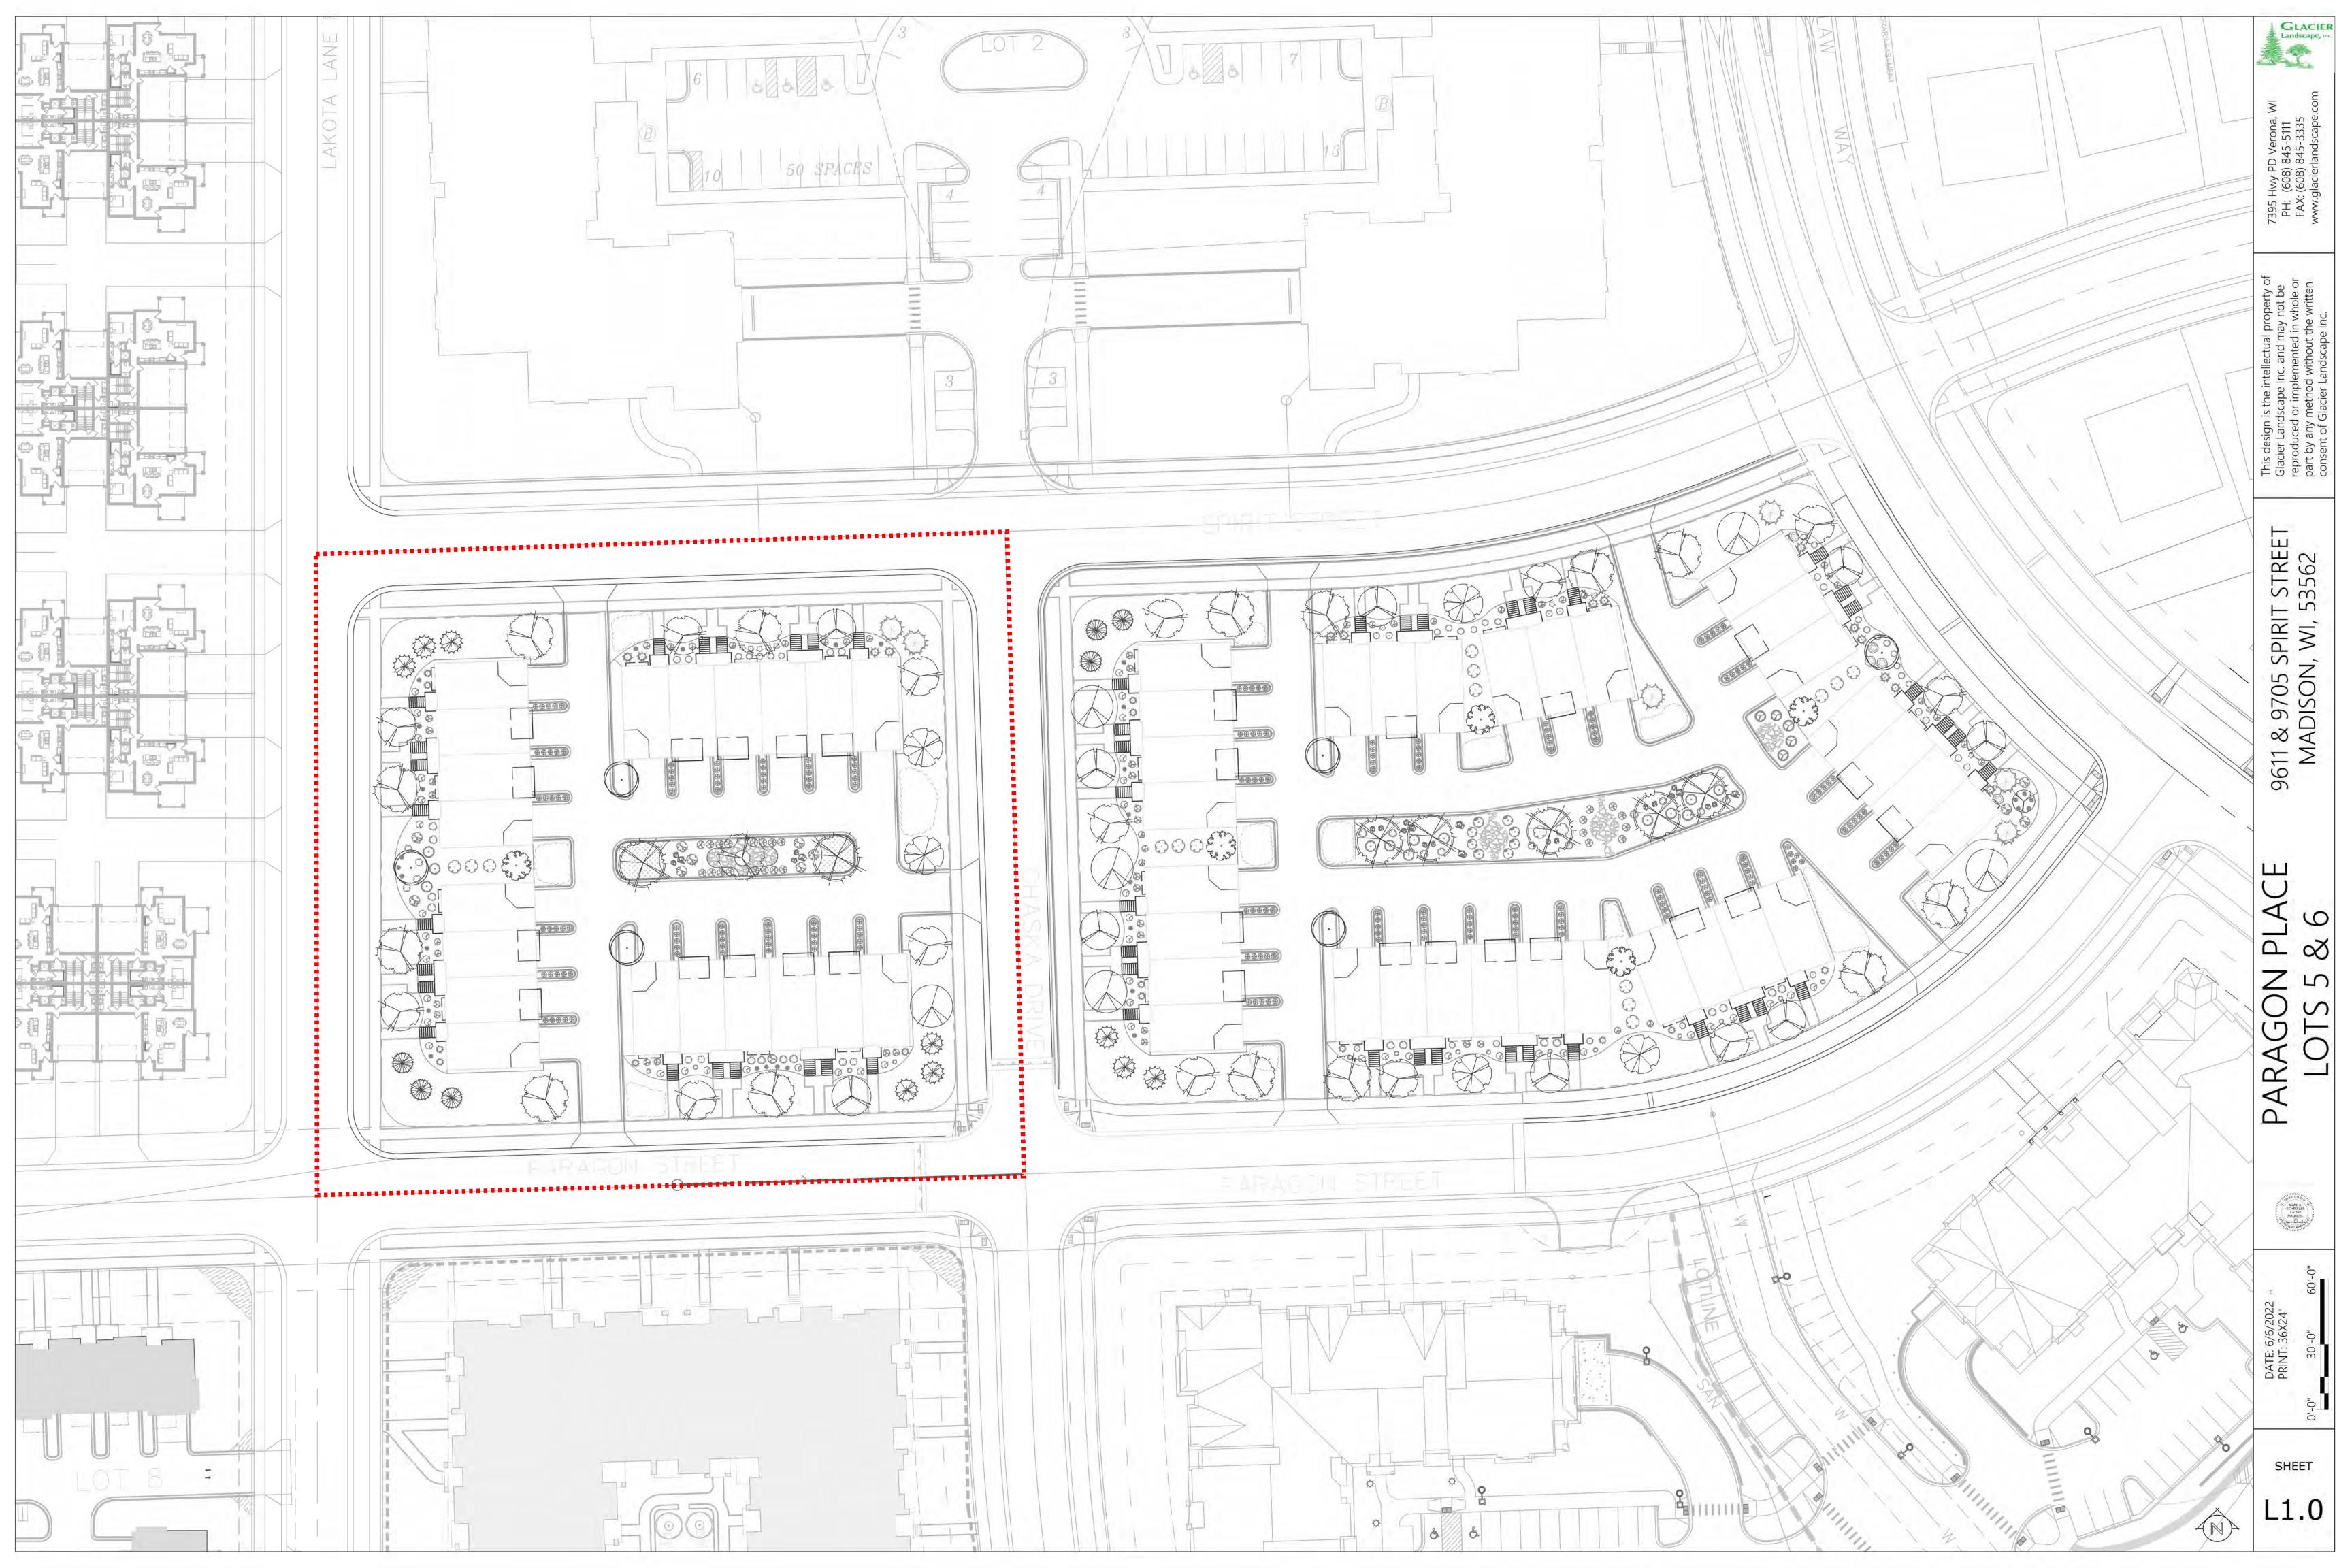

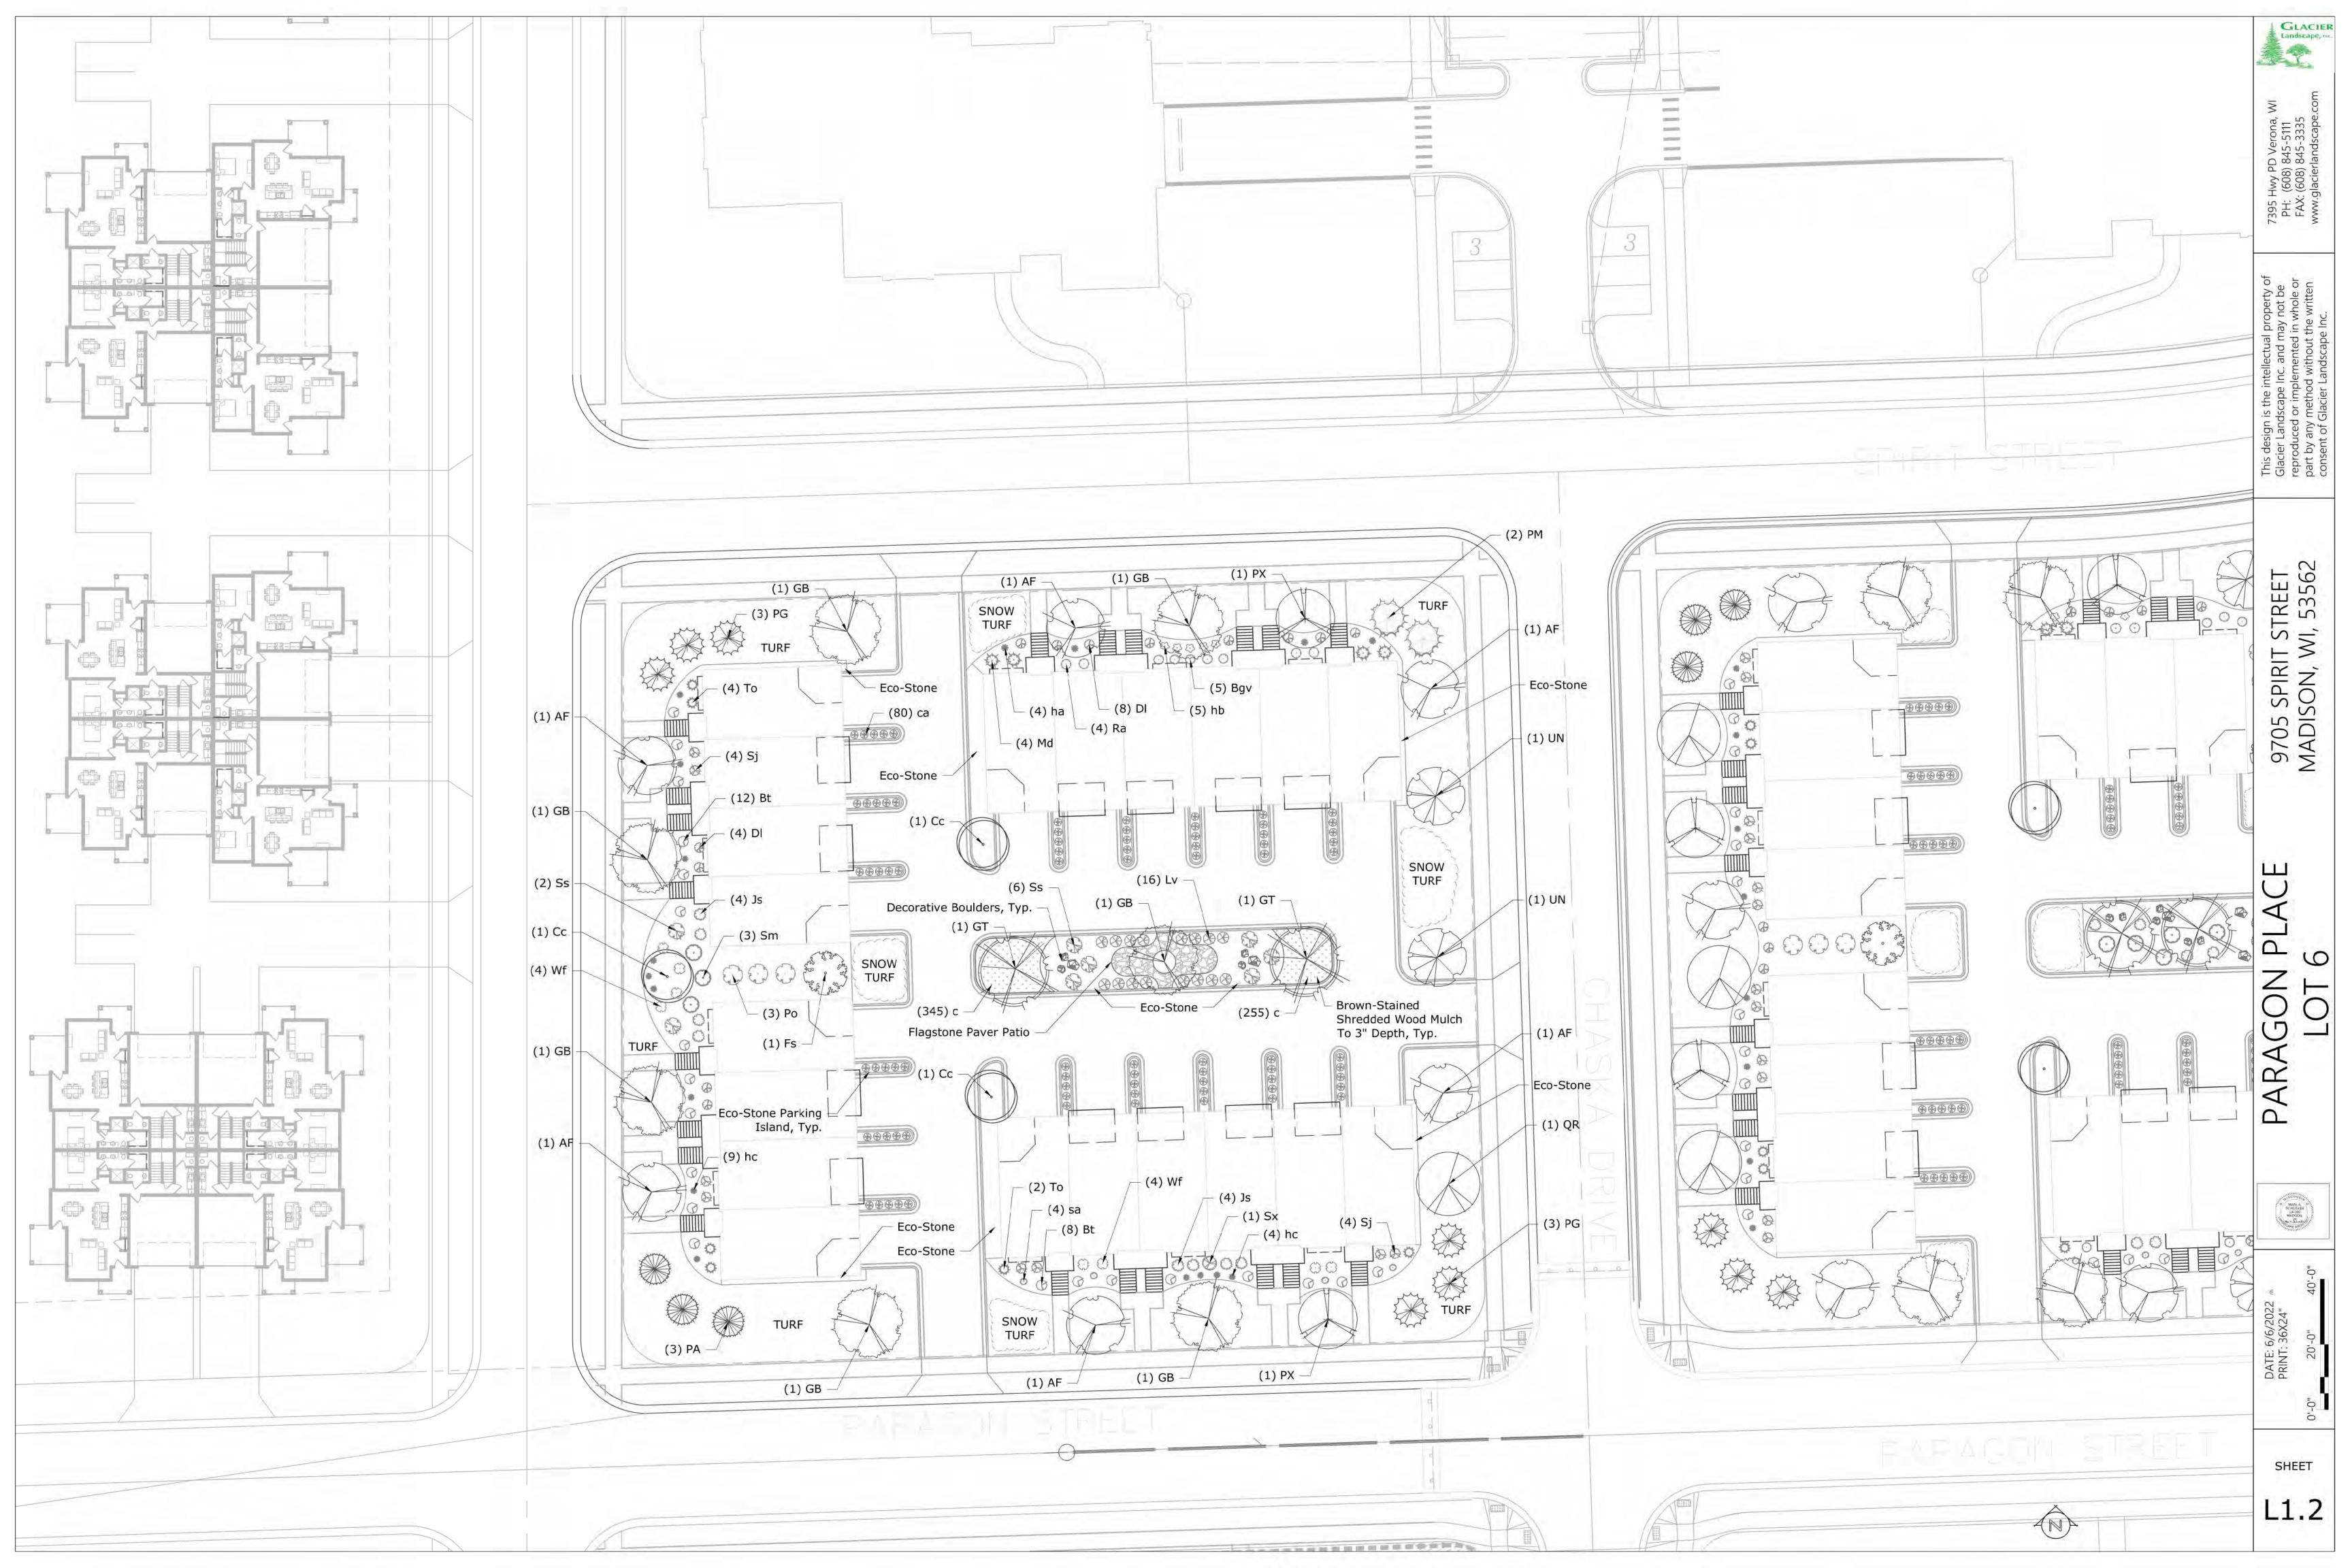

PIRIT WI, 5 S 95 6

5

SHEET



25

14

600

1 Gal.

1 Gal.

Plug

Chicago Apache Daylily

Autumn Fire Sedum

Blue Zinger Sedge

GENERAL PLANTING NOTES

Hemerocallis x 'Chicago Apache'

Sedum spectabile 'Autumn Fire'

Carex flacca 'Blue Zinger'

The landscape contractor shall be responsible for complete coordination of planting operation as well as other contracted work, with the other contractors on the job. Repair of damage to the plants, grade, lawns, etc. during installation shall not be considered as an extra, and not chargeable to the Owner. Damage caused by other contractors shall be the responsibility of said contractor.

The contractor shall, at all times, keep the premises free from accumulation of waste material, soil and/or rubbish caused by his employees or work. Contractor shall clean behind his work immediately, and shall take necessary precautions to keep concrete, brick and other paving material clean of soil.

Materials planted and damaged or destroyed by any phenomena considered as an act of God, e.g., vandalism, wind, fire, flood, frost, theft, rain, hail, etc., shall belong to the Owner and shall be his responsibility. Materials stored on-site as not yet planted are not covered by this clause and are the sole responsibility of the contractor.

All plant material furnished by the contractor, unless otherwise specified, shall be No. 1 grade or better in accordance with GRADED AND STANDARDS FOR NURSERY PLANTS as described in ANSI 260.1 1996. Landscape Architect reserves all right to determine acceptability of plant material submitted for planting.

All plants shall be planted in pits, centered and set on six inches of compacted topsoil to such a depth that the finish grade level, at the plant. after settlement will be the same as that at which the plant was grown. All planting areas shall received adequate fertilization with 'Easy Grow' 3 yr. (1 oz.) fertilizer packets or equivalent. Granular fertilizer will be accepted, but must be approved by Landscape Architect. Please submit specifications.

Application Rates shall be as follows:

hc

sa

C

1-1/2" to 3" cal.: 2 packets, one each side Greater than 3": Add 1 packet per 1" cal. (i.e. 4"- 4 packets)

-NYLON STRAPPING MATERIAL SECURED LOOSELY AROUND TRUNK

STRAPPING ATTACHMENT AND

NYLON STRAPPING MATERIAL -

SAUCER MOUND AROUND TREE

SEE NOTES FOR MULCH-SPECIFICATIONS

REMOVE AIR POCKETS)

SEE NOTES FOR MULCH-SPECIFICATIONS

PROPOSED GRADE -

SAUCER MOUND AROUND SHRUB

REMOVE BURLAP, TWINE AND Y

1. ROOT FLARE TO BE EXPOSED.

ROOT FLARE SHALL BE EXPOSED-

SAUCER MOUND AROUND TREE-

REMOVE BURLAP, TWINE AND WIRE

PLANTING MIXTURE (WATER TAMP

FROM UPPER HALF OF BALL

SEE NOTES FOR MULCH-SPECIFICATIONS

PROPOSED GRADE -

SAUCER MOUND AROUND SHRUB-

REMOVE ENTIRE CONTAINER FROM-

ROOTS AND SPREAD ROOTS OUT

NOTE:

1. ROOT FLARE TO BE EXPOSED

PLANTING MIXTURE (WATER

SEE NOTES FOR MULCH-SPECIFICATIONS

ALUMINUM EDGING

PROPOSED GRADE -

REMOVE AIR POCKETS

SEE NOTES FOR MULCH-

PROPOSED GRADE -

PLANTING MIXTURE (WATER

WOODEN STAKES - 3 PER TREE-

ROOT FLARE SHALL BE EXPOSED-

PLANTING MIXTURE (WATER TAMP TO

NOTE:

1. DIG HOLE NO DEEPER THAN BASE OF ROOT BALL TO FLARE. ROOT BALL TO BE

SET ON UNDISTURBED SOIL UNLESS COMPACTED AGGREGATE STONE REMAINS FROM SITE EXCAVATOR. REMOVE REMAINING AGGREGATE STONE UNTIL SOIL LAYER IS

DECIDUOUS TREE PLANTING DETAIL

SHRUB PLANTING DETAIL

NOTE:

1. DIG HOLE NO DEEPER THAN BASE OF ROOT BALL TO FLARE. ROOT BALL TO BE SET ON UNDISTURBED SOIL UNLESS COMPACTED AGGREGATE STONE REMAINS FROM SITE EXCAVATOR. REMOVE REMAINING AGGREGATE STONE UNTIL SOIL LAYER IS

EVERGREEN TREE PLANTING DETAIL

PERENNIAL/ORNAMENTAL GRASS

PLANTING DETAIL

ALUMINUM LANDSCAPE EDGING

DETAIL

N.T.S.

2. REMOVE NYLON STRAPPING WITHIN 9-18 MONTHS FOLLOWING INSTALLATION

1 packet for every 12" height or spread, (Space evenly if 2 or more packets required)

Perform all work necessary for installing sod and/or seed as shown on the drawings or inferable therefrom and/or as specified, in accordance with the requirements of the contract documents.

Immediately prior to seeding, the ground shall be scarified and raked to a friable fine texture. Lawn areas shall be seeded with applicable erosion mat per specifications. spreader at the rate as recommended for local conditions. After seeding, all areas shall be raked to satisfactorily cover seed, and then thoroughly watered and covered with treated shredded paper mulch or straw mulch. The methods of seeding may be varied by the contractor by his own responsibility to establish a smooth uniform turf. Hydro mulch embankments that exceed 1:4 slopes.

Seed shall be true to specie as called for on the seeding plan. All seed shall be delivered to the job site in sacks plainly marked and certified as to content.

Sod shall be placed when the ground is in workable condition and temperatures are less than 90 degrees Fahrenheit.

Landscape contractor shall water sod immediately after installation to prevent excessive drying during progress of the work. As sodding is completed in any one section, the entire area shall be rolled. It shall then be thoroughly irrigated to a depth sufficient that the underside of the new sod pad and soil immediately below the sod are thoroughly wet.

The landscape contractor shall verify grades established during final soil preparation as being true to finish contours shown, and shall maintain such areas until the effective date to begin sodding and/or seeding operation. In such instances where a split responsibility existing between grading and grassing contractors, it shall be the responsibility of the grassing contractor to maintain a suitable grade for grassing once he has accepted the grade provided to him. In all cases, the ground shall be hand raked immediately prior to being sodded to remove any irregularities in the grade.

2

2

TOTAL POINTS

Points Required

Guarantee period for plant materials shall be as follows:

Lawns (seed & sod)* 3 months **Ground Cover** 3 months Shrubs 12 months Trees 12 months 90 days from installation Perennials, Roses & Japanese Maples

Container

Container

Container

*(If lawn is installed in fall and not given full 90 days of guarantee periods, or if not considered acceptable at that time, continue guarantee the following spring until acceptable lawn is

established.)

All shrub planting beds to be lined with a minimum of 2-3" stained wood mulch (no plastic liners). Place mulch at base of all trees (minimum 4' diameter).

A 10/10/10 fertilizer mixture shall be applied at 20#/1000 SF and worked into the lawn bed before seeding or sodding.

All shrubs to be pocket planted with a 50/50 mix of plant starter and existing soil. Install topsoil into all beds as needed to achieve proper grad. Remove all excessive gravel, clay and stones. Refer to planting details for further information.

Plant all trees slightly higher than finished grade at root flare. Back fill hole with 2/3 existing topsoil and 1/3 peat moss. Avoid any air pockets, discard any gravel, clay or stones. Refer to planting details for further

plant life or germination inhibiting ingredients. Landscape contractor to provide a sample to owner for approval. Contractor to take care with installation not to damage or cover plants. Refer to planting details for further information.

During the initial 30 day maintenance period the landscape contractor is required to provide an on-going pleasant visual environment whereas any plant which is not responding to transplanting or thriving shall immediately be replaced. New lawns shall be watered and repaired and weeds must constantly be removed. No exceptions will be granted.

Landscape/site demolition contractor to verify locations of existing trees and shrubs to be salvaged and clearly tag them with marking tape and construction fence.

Irrigation system to be designed for a overlapping sprinkler head system in all lawn & island areas and a drip system for all foundation planting areas.

Contractor Note:

2: Plant beds to be separated from turf areas w/aluminum edging

3: Plant Beds to be mulched w/brown-stained shredded wood to 3" depth 4: Eco-Strips to be mulched w/1.5" Mississippi River Stone to 3" depth, over fabric

5: Plant Beds to receive pre-emergent per mfg. recommendations

1: Turf areas to be fine graded, seeded, fertilized and straw mulched

6: Plantings in turf areas shall have 4' diameter shredded bark mulch rings

Proposed trees to be staked as required. Verify with Landscape Architect if exposure and wind conditions prevalent.

Any series of trees to be placed in a particular arrangement will be field checked for accuracy. Trees of same species to be matched in growth character and uniformity. Any trees misplaced will be subject to rejection.

Upon acceptance of the landscape installation, the landscape contractor shall supply the Landscape Architect with a complete and adequate maintenance program to be followed during and after the guarantee period. The landscape contractor shall make periodic inspections of the job during the guaranteed period to determine if proper maintenance is being given. It shall be understood that in accordance with the terms of the guarantee that the landscape contractor must promptly inform the Owner if proper maintenance is not being given to the installation. Such notice shall be in writing, outlining corrective measures to be taken, with a copy to Landscape Architect. At any time during the guarantee period, the landscape contractor shall be required to replace all plants that are dead or in unsatisfactory condition of growth. All replacement plants shall be of like size and kind of the plants removed. Any seed areas over one foot square not covered by turf shall be reseeded by the contractor. Any seed areas over one foot square that are dead or dying shall be replacements included within the guarantee and shall be landscape contractor's expense.

Any alteration to the landscape plan will be submitted to the Project Manager for approval by the Landscape Architect.

Landscape contractors are responsible for making sure all tree balls are moist at the core when trees are installed.

Lawn edges that abut parking lots with no curbing shall be double seeded to a width of 5'.

Pre-Emergent Herbicide (Treflan or Equiv.) to be applied to all plant beds prior to planting for noxious weed control.

The quantities indicated on the material schedule are provided for the benefit of the contractor, but should not be assumed to always be correct. In the even of a discrepancy, the planting plan will take precedence over the material schedule. The contractor shall be responsible for his own quantity calculation and the liability pertaining to those quantities and any related contract documents and/or price quotations.

PLANT MATERIAL SHOWN ON LANDSCAPE PLAN IS DEPICTED AT MATURE GROWTH

At least seventy-two hours prior to any excavation, contractor shall verify utility location as given by the electric, gas, telephone, water, sewer, and cable companies, utilities or entities. Review with the owner's representative, site mechanical, site electrical and lighting. Site grading and drainage, site irrigation and all other drawings pertaining to underground utility locations record set of information the same as in possession of owner's representative. Also review owner's "mark sets" of all of these drawings in possession of the contractor or owner. Mark all such utilities on the site prior to commencing. Coordinate with the owner before and during construction. Repair any damage to any system that is caused by landscape contractor at no cost to owner.

Deviations from these plans shall be noted on the record drawing by the contractor and only with prior approval of the landscape architect and owner's representative. Verbal agreements of revisions without a change order will not be recognized by the landscape architect and

All plants must be bid and selected per the species specified on the plans. The sizes of plant material listed herein is a minimum acceptable size. Additionally, if excessive pruning reduces the crown and the plant shall be replaced.

Protect public from construction barrier and barricades.

All areas that are disturbed during construction and areas not covered with pavement, building, planting beds, or tree pits are to be top soiled 4-6" deep (min.) and shall be sodded/seeded with specified lawn grass. Landscape contractor shall include cost per square yard for additional seed operation as may possibly be required to reestablish adjacent turf grass areas which may become damaged during the construction process or to repair damage done by others.

Contractor is responsible for furnishing all materials, tools, equipment, labor and plants necessary for proper planting and installation of all landscape material.

Contractor is responsible for all estimating and bidding. All areas, quantities and materials should be field verified with site conditions.

Where discrepancies occur between the landscape plans and/or architectural and/or civil drawing (and any other site drawings) the discrepancies must be brought to the landscape architect's attention for coordination and resolution.

All diseased, noxious or inappropriate materials shall be removed from the proposed site prior to the start of construction and during the maintenance period.

General contractor shall leave the site free of construction debris.

All lawn and planting areas shall slope to drain a minimum of 2% unless noted otherwise and reviewed with owner's representative for final

Finish grades for shrub and ground cover areas shall be held 1" below top of adjacent pavements and curb, unless noted otherwise on the plans. Refer to planting details for further information.

All perennial, annual, and ground cover areas to receive a blend of organic soil amendments prior to planting. Till the following materials into existing topsoil to a depth of approximately 8". A depth of 12" in tree pits. Proportions and quantities may require adjustment depending on the condition of existing soil. Refer to planting details for further information.

- Per every 100 square feet add: One - 2 Cubic foot bale of peat moss
- 2 pounds of 5-10-5 garden fertilizer
- % cubic yard of composted manure
- Plant starter or other composted, organic material ** Premixed soils will be accepted, i.e. Purple Cow, Soil-Life, etc. Please notify Landscape

Architect of alternatives used.

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28

4330

2487

All trees to be installed, staked or guyed according to details. Refer to planting details for further information.

All planting to be water


Where specified, all plant beds, pits and tree rings are to receive a minimum of 2-3" dressing of shredded brown-stained wood mulch shavings (or brown enviro-mulch) free of growth, weeds, foreign matter detrimental to


Landscape/site demolition contractor to verify locations of existing trees and shrubs to be relocated. All plant materials to be relocated is to be clearly tagged with marking tape and moved before site demolition is to begin.

Before site grading and demolition is to begin for proposed new pavement, the area is to be staked and all trees and shrubs that are to be preserved are to be tagged by landscape architect and relocated by landscape contractor. If required a tree preservation plan will be produced and coordinated with city staff. Demolition contractor to coordinate w/landscape architect, owner and landscape contractor. ed at the time planting throughout construction and upon completion of project as required.

Wear-N-Tear by LaCrosse Seeds 40%: Perennial Ryegrass 40% Kentucky Bluegrass 10% Creeping Red Fescue 10% Chewings Fescue Apply at a rate of 4lbs. per 1000sf Install per Mfg. specifications

Recommended seed mix:

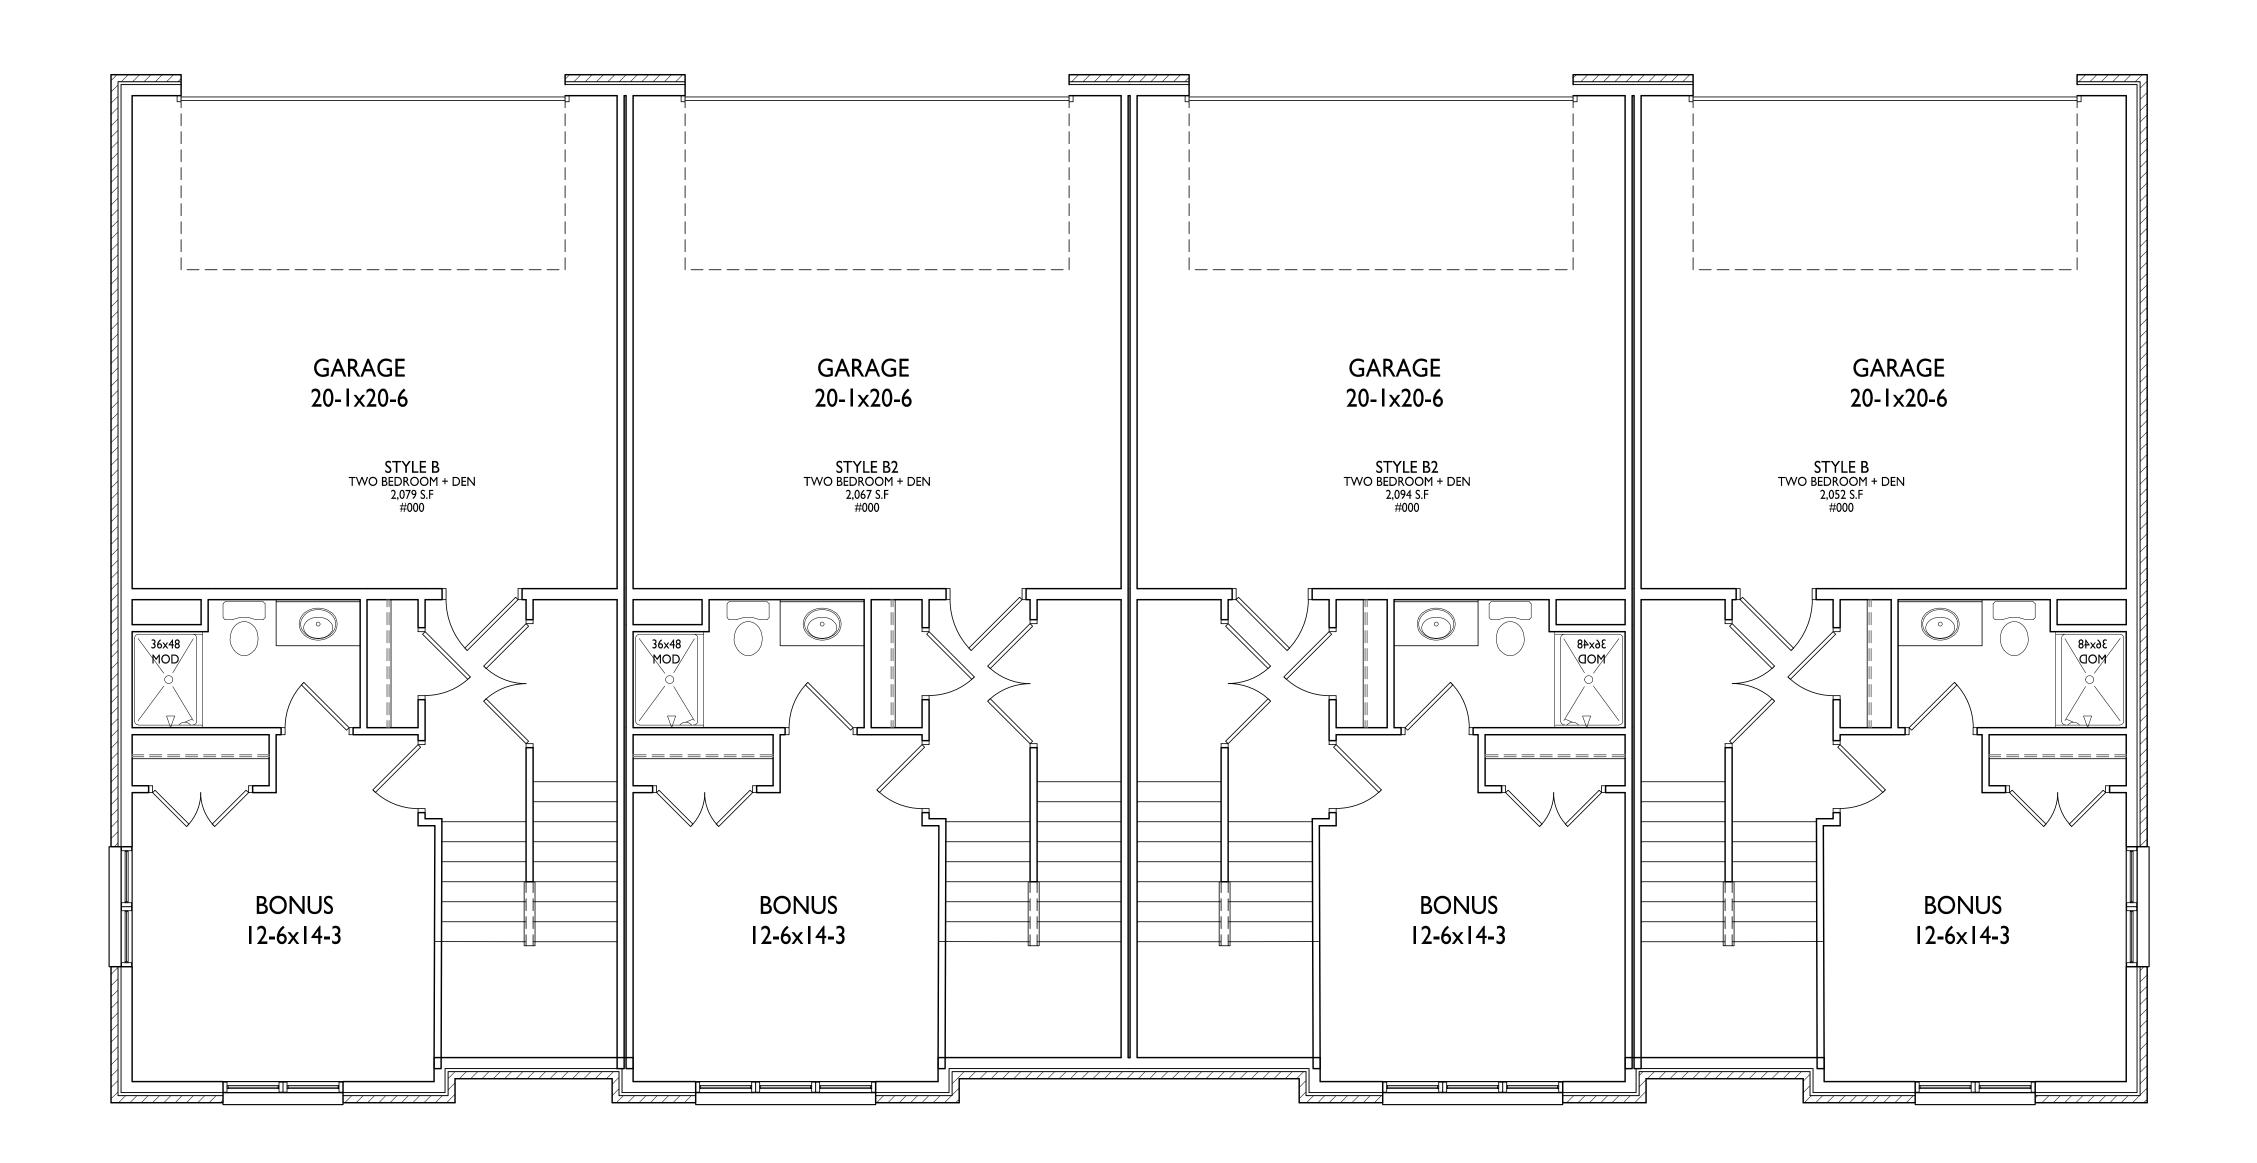

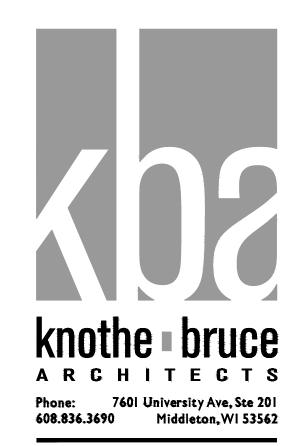

PROJECT TITLE
Paragon Place at
Bear Claw Way
Ziegler Site - Lots
5 and 6

Paragon Street
Madison, Wisconsin


SHEET TITLE
4-Unit
Townhouse
Basement/Garage

SHEET NUMBER


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PROJECT TITLE
Paragon Place at
Bear Claw Way
Ziegler Site - Lots
5 and 6


Paragon Street
Madison, Wisconsin

SHEET TITLE
4-Unit
Townhouse First

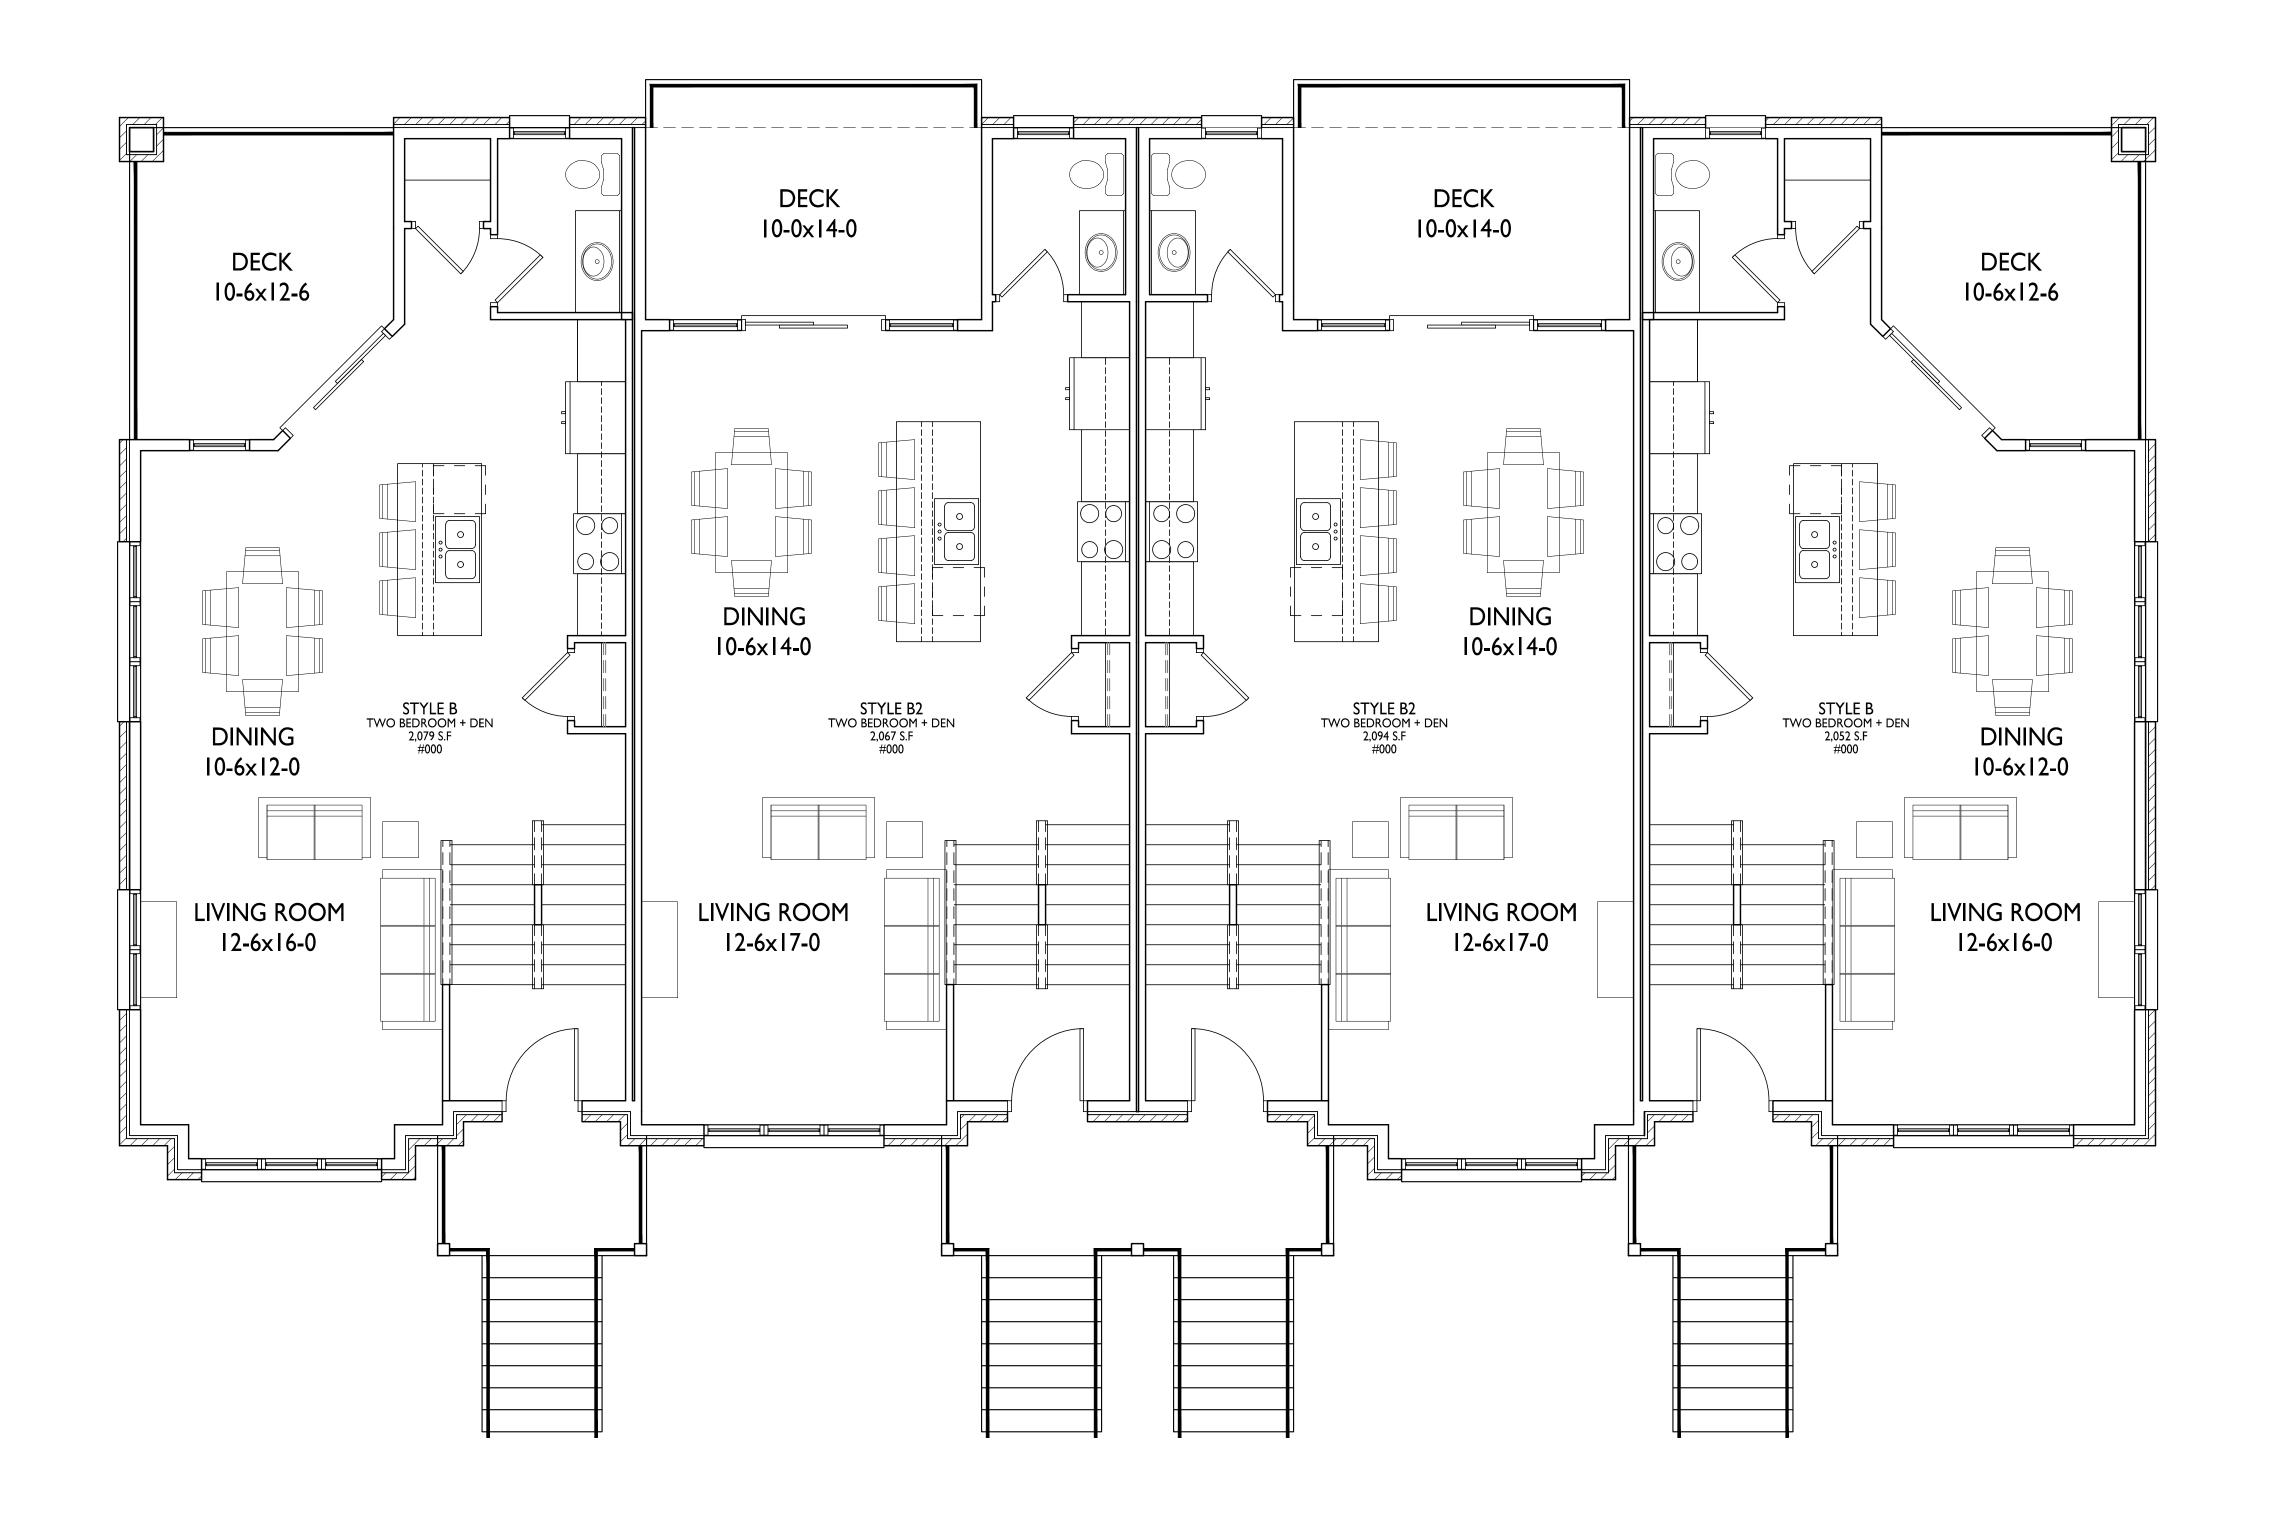SHEET NUMBER


Floor Plan

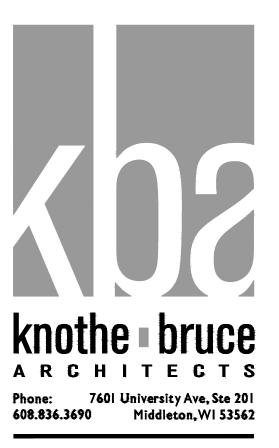

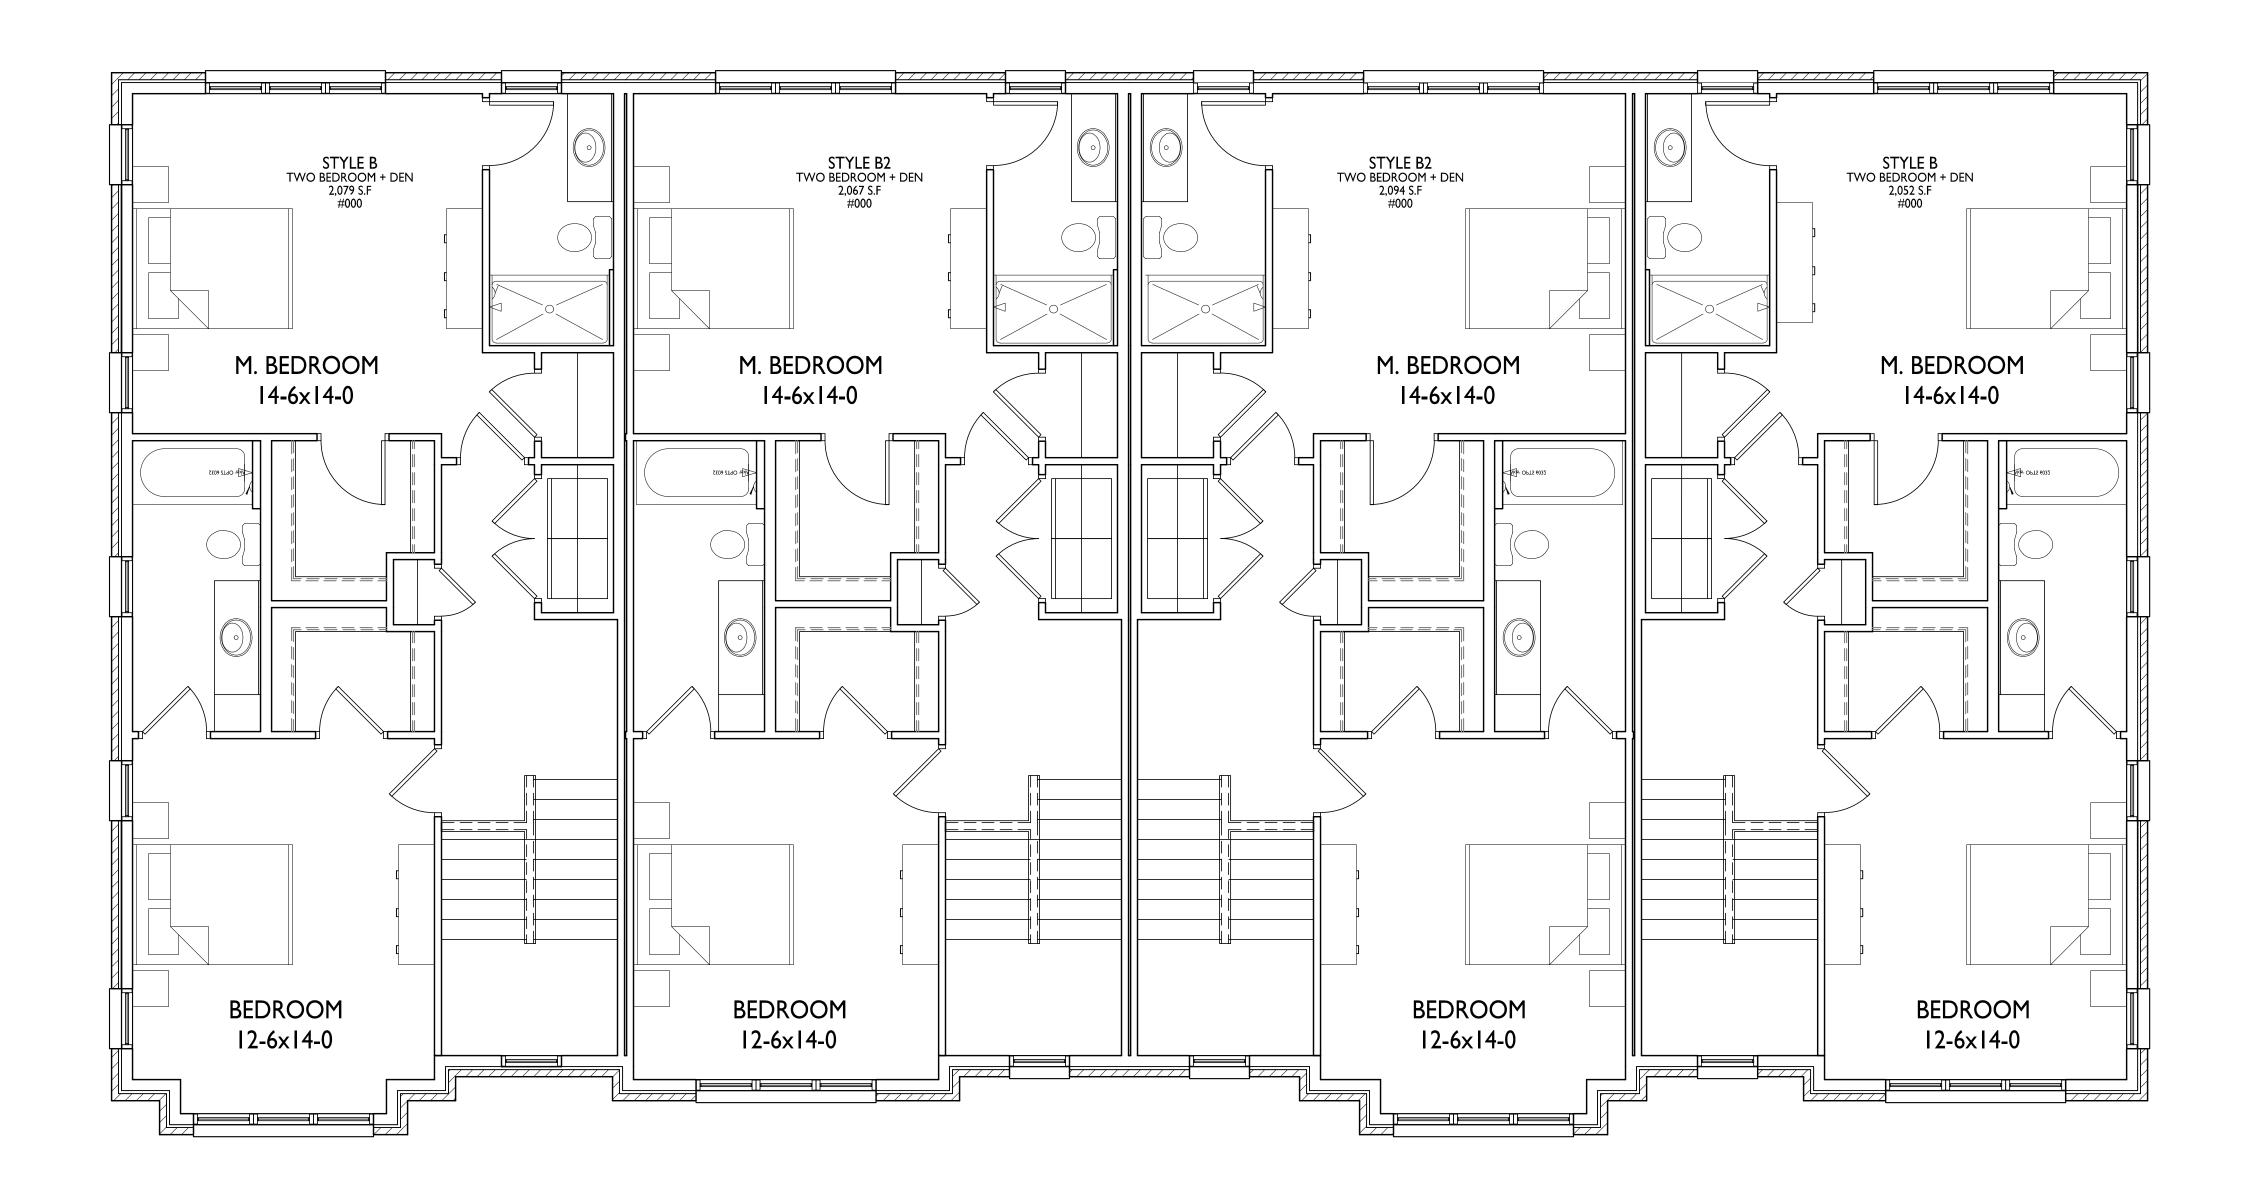





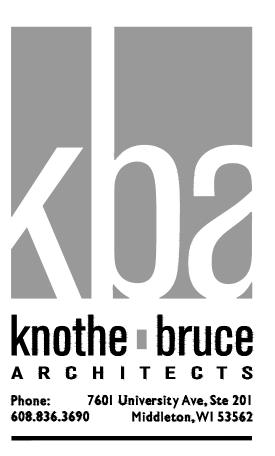

PROJECT TITLE
Paragon Place at
Bear Claw Way
Ziegler Site - Lots
5 and 6

Paragon Street

Madison, Wisconsin

SHEET TITLE


4-Unit


Townhouse

Second Floor Plan

SHEET NUMBER

A-1.2

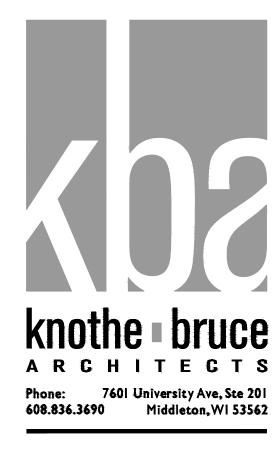

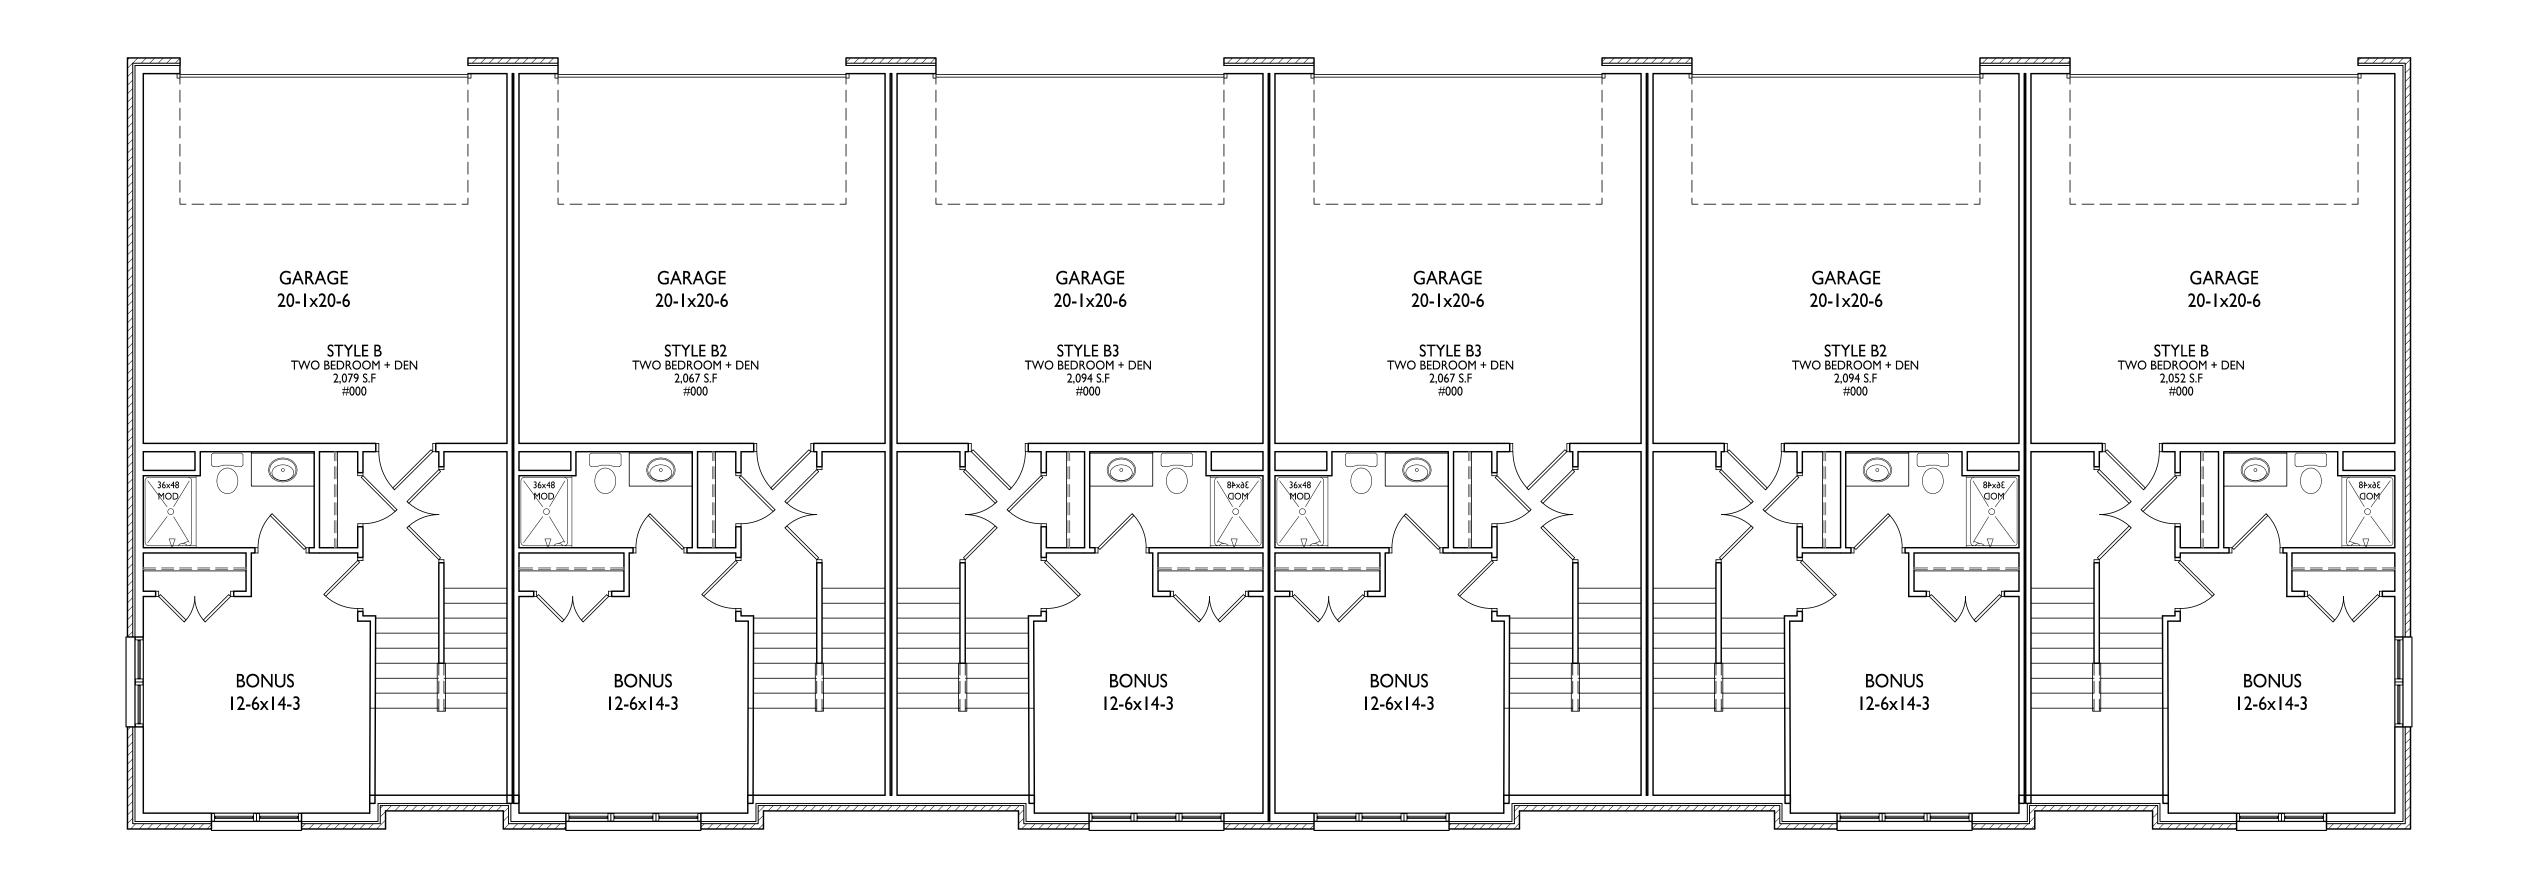

PROJECT TITLE

Paragon Place at
Bear Claw Way
Ziegler Site - Lots
5 and 6

Paragon Street
Madison, Wisconsin

SHEET TITLE
6-Unit
Townhouse
Basement/Garage


SHEET NUMBER


A-1.0

PROJECT NO. #2121 212





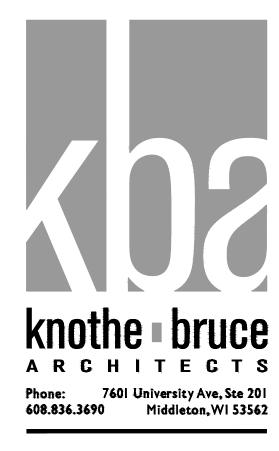

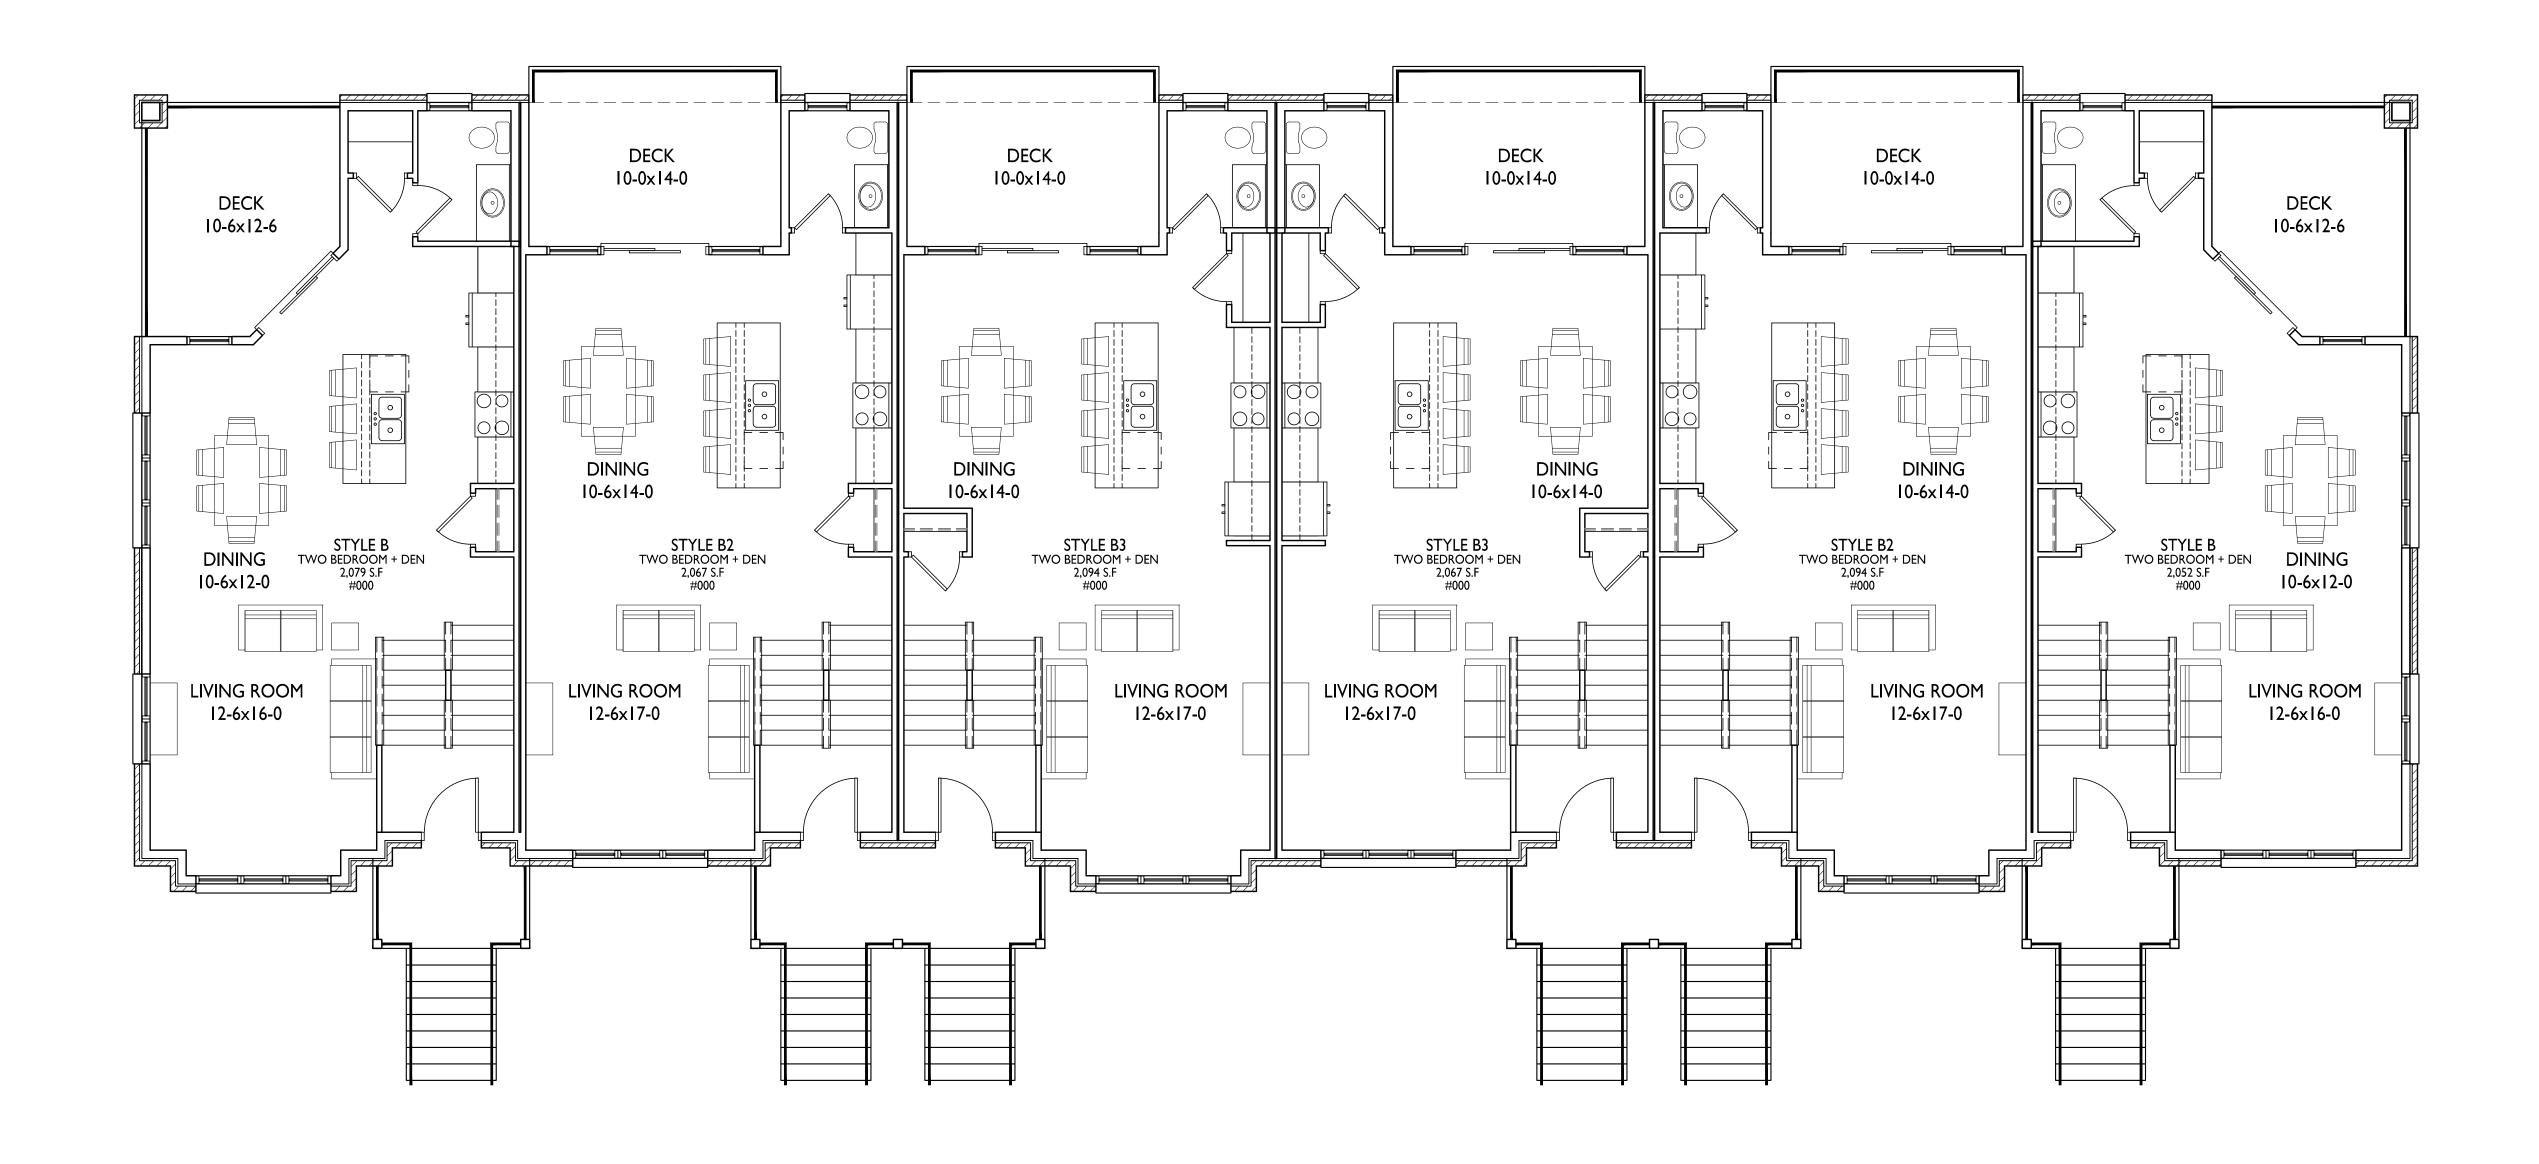

PROJECT TITLE
Paragon Place at
Bear Claw Way
Ziegler Site - Lots
5 and 6


Paragon Street
Madison, Wisconsin


SHEET TITLE
6-Unit
Townhouse First
Floor Plan


SHEET NUMBER





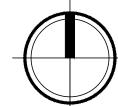

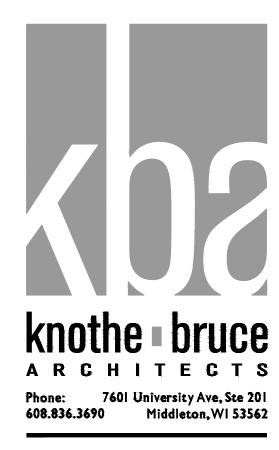

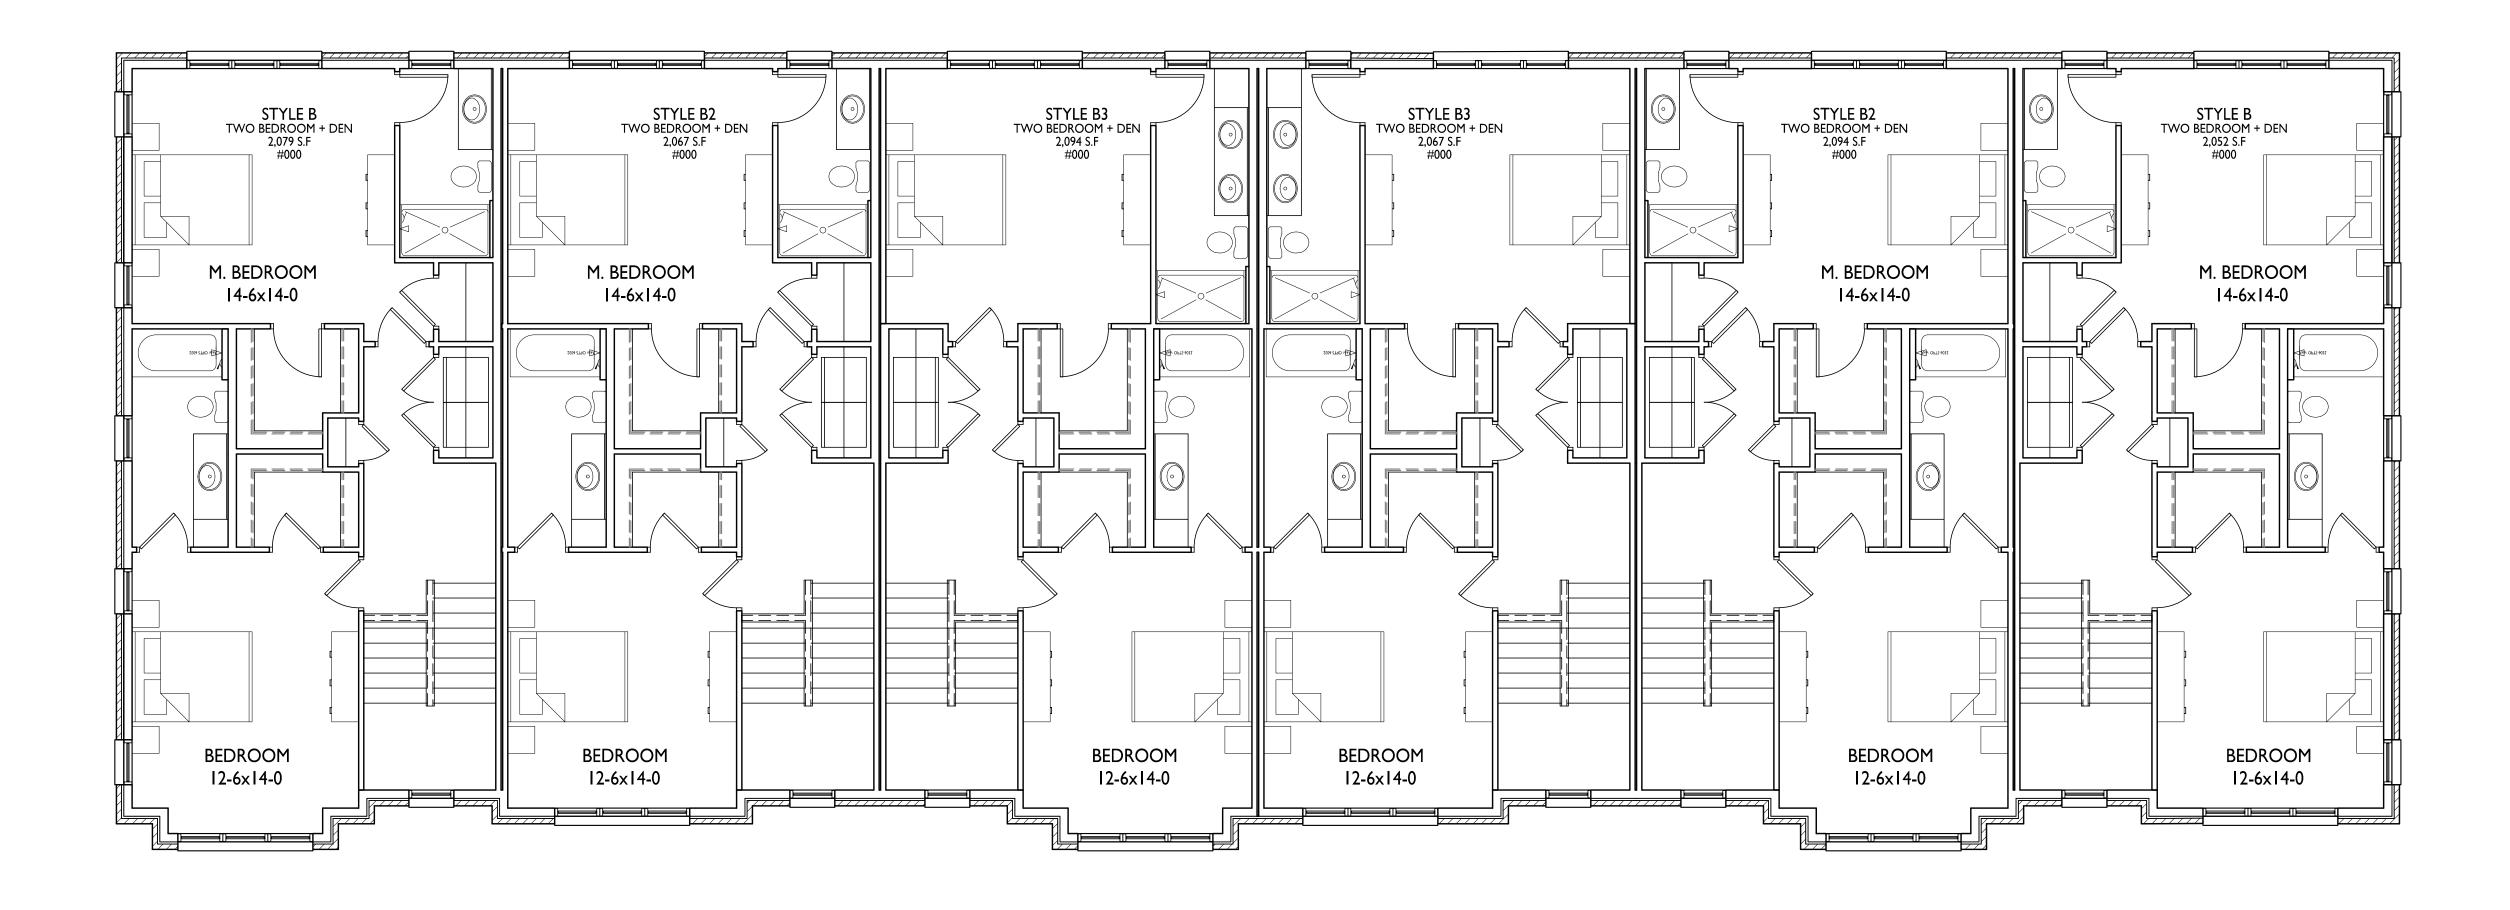

PROJECT TITLE
Paragon Place at
Bear Claw Way
Ziegler Site - Lots
5 and 6

Paragon Street
Madison, Wisconsin


SHEET TITLE
6-Unit
Townhouse
Second Floor Plan

SHEET NUMBER

A-1.2

PROJECT NO. #2121 2121



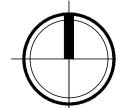



FIRST FLOOR 101'-1 1/4"

ENTRY LANDING

95'-5 1/4"

5 ELEVATION - EAST

A201 1/8" = 1'-0"

BASEMENT 90'-8"

6 COLORED ELEVATION - EAST 1/8" = 1'-0"

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ISSUED

PROJECT TITLE Paragon Place at Bear Claw Way Zielger Site - Lot 6 BLDG #1

Paragon Street Madison, Wisconsin SHEET TITLE **EXTERIOR ELEVATIONS**

SHEET NUMBER

EXTERIOR MATERIAL SCHEDULE

MANUFACTURER

JAMES HARDIE

JAMES HARDIE

JAMES HARDIE

US BRICK

US BRICK

BUILDING ELEMENT

(#1) - BRICK VENEER

(#2) - BRICK VENEER

(#4) - COMPOSITE PANEL

(#5) - COMPOSITE TRIM

(#7) - CAST STONE

(#9) - RAILINGS

(#11) - METAL ROOF

(#3) - COMPOSITE LAP SIDING - 6"

(#6) - COMPOSITE WINDOWS

(#8) - 10" x 10" WRAPPED COLUMN

(#10) - ASPHALT SHINGLE ROOF

FIRST FLOOR 101'-1 1/4"

BASEMENT 90'-8"

ENTRY LANDING 95'-5 1/4"

COLOR

KONA VELOUR

BLACK

PEBBLE BEACH VELOUR


COBBLESTONE - SMOOTH

COLOR TO MATCH ADJ. TRIM/SIDING

COLOR TO MATCH ADJ. TRIM/SIDING

A201

PROJECT NUMBER 2121

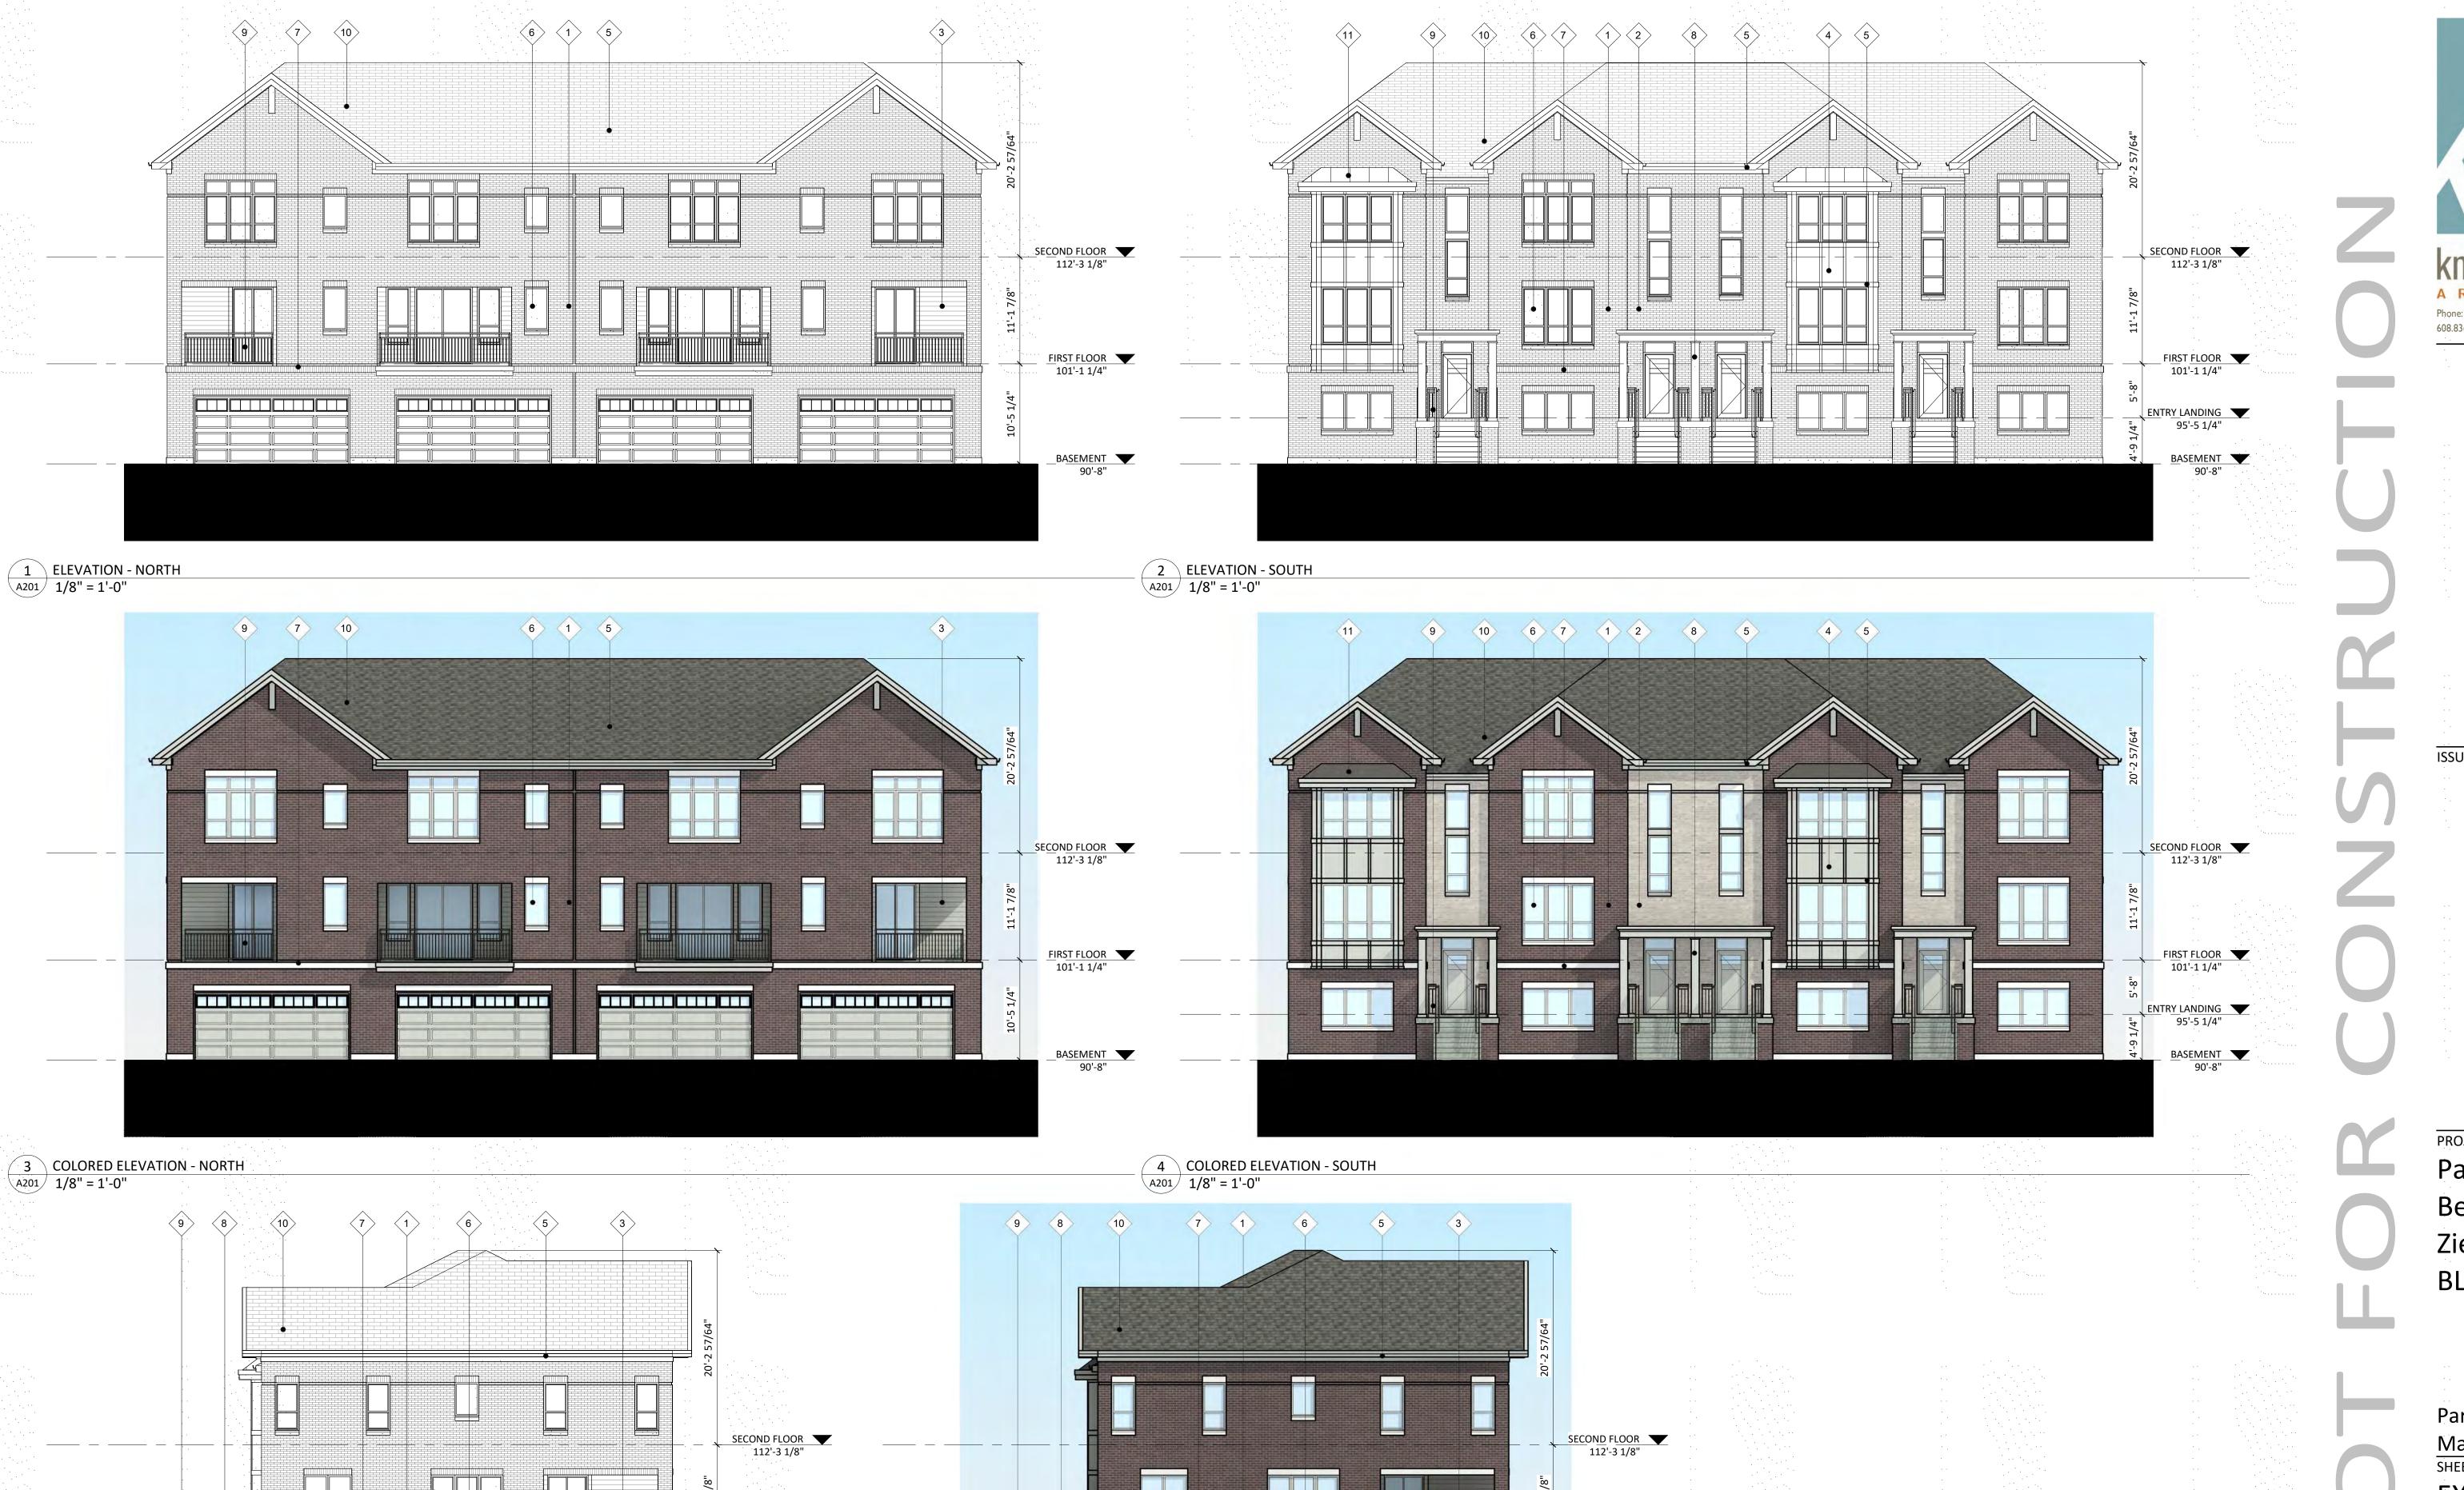

FIRST FLOOR 101'-1 1/4"

ENTRY LANDING

95'-5 1/4"

5 ELEVATION - EAST

A201 1/8" = 1'-0"

BASEMENT V

6 COLORED ELEVATION - EAST 1/8" = 1'-0"

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ISSUED

PROJECT TITLE Paragon Place at Bear Claw Way Zielger Site - Lot 6 BLDG #2

Paragon Street Madison, Wisconsin SHEET TITLE **EXTERIOR**

ELEVATIONS

SHEET NUMBER

EXTERIOR MATERIAL SCHEDULE

COLOR

BURGUNDY VELOUR

SHADOW GRAY VELOUR

COBBLESTONE - SMOOTH

BLACK

COLOR TO MATCH ADJ. TRIM/SIDING

COLOR TO MATCH ADJ. TRIM/SIDING

MANUFACTURER

JAMES HARDIE

JAMES HARDIE

JAMES HARDIE

US BRICK

US BRICK

BUILDING ELEMENT

(#1) - BRICK VENEER

(#2) - BRICK VENEER

(#4) - COMPOSITE PANEL

(#5) - COMPOSITE TRIM

(#7) - CAST STONE

(#9) - RAILINGS

(#11) - METAL ROOF

(#3) - COMPOSITE LAP SIDING - 6'

(#6) - COMPOSITE WINDOWS

(#8) - 10" x 10" WRAPPED COLUMN

(#10) - ASPHALT SHINGLE ROOF

FIRST FLOOR 101'-1 1/4"

BASEMENT 90'-8"

ENTRY LANDING 95'-5 1/4"

A201

PROJECT NUMBER 2121





ISSUED

PROJECT TITLE Paragon Place at

Bear Claw Way Ziegler Site - Lots 6 BLDG #3

Paragon Street Madison, Wisconsin SHEET TITLE

EXTERIOR ELEVATIONS

SHEET NUMBER

A201 PROJECT NUMBER 2121

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2 ELEVATION - SOUTH 1/8" = 1'-0"

EXTERIOR MATERIAL SCHEDULE					
BUILDING ELEMENT	MANUFACTURER	COLOR			
(#1) - BRICK VENEER	US BRICK	KONA VELOUR			
(#2) - BRICK VENEER	US BRICK	PEBBLE BEACH VELOUR			
(#3) - COMPOSITE LAP SIDING - 6"	JAMES HARDIE	COBBLESTONE			
(#4) - COMPOSITE PANEL	JAMES HARDIE	COBBLESTONE - SMOOTH			
(#5) - COMPOSITE TRIM	JAMES HARDIE	COLOR TO MATCH ADJ. TRIM/SIDING			
(#6) - COMPOSITE WINDOWS	N/A	BLACK			
(#7) - CAST STONE	N/A	N/A			
(#8) - 10" x 10" WRAPPED COLUMN	N/A	COLOR TO MATCH ADJ. TRIM/SIDING			
(#9) - RAILINGS	N/A	BLACK			
(#10) - ASPHALT SHINGLE ROOF	N/A	N/A			
(#11) - METAL ROOF	N/A	N/A			



knothe bruce
ARCHITECTS
Phone: 7601 University Ave. #201
608.836.3690 Middleton, WI 53562

1 COLORED ELEVATION - NORTH
A202 1/8" = 1'-0"

SECOND RIOR ▼

112-3 1/8

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117-1

2 COLORED ELEVATION - SOUTH A202 1/8" = 1'-0"

3 COLORED ELEVATION - EAST A202 1/8" = 1'-0"

Paragon Place at Bear Claw Way Ziegler Site - Lot 6 BLDG #3

EXTER	RIOR MATERIAL SC	CHEDULE
BUILDING ELEMENT	MANUFACTURER	COLOR
(#1) - BRICK VENEER	US BRICK	KONA VELOUR
(#2) - BRICK VENEER	US BRICK	PEBBLE BEACH VELOUR
(#3) - COMPOSITE LAP SIDING - 6"	JAMES HARDIE	COBBLESTONE
(#4) - COMPOSITE PANEL	JAMES HARDIE	COBBLESTONE - SMOOTH
(#5) - COMPOSITE TRIM	JAMES HARDIE	COLOR TO MATCH ADJ. TRIM/SIDING
(#6) - COMPOSITE WINDOWS	·N/A	BLACK
(#7) - CAST STONE	N/A	N/A
(#8) - 10" x 10" WRAPPED COLUMN	N/A	COLOR TO MATCH ADJ. TRIM/SIDING
(#9) - RAILINGS	N/A	BLACK
(#10) - ASPHALT SHINGLE ROOF	N/A	N/A
(#11) - METAL ROOF	N/A	N/A
		. "****

Paragon Street

Madison, Wisconsin

SHEET TITLE

COLORED

EXTERIOR

ELEVATIONS

SHEET NUMBER

A202

PROJECT NUMBER 2121





ISSUED

PROJECT TITLE
Paragon Place at
Bear Claw Way
Ziegler Site - Lots
6 BLDG #4

Paragon Street

Madison, Wisconsin

SHEET TITLE

EXTERIOR

ELEVATIONS

SHEET NUMBER

A201

PROJECT NUMBER 2121
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SECOND LOOR ▼

12/3 2/8*

PROT FLOOR ▼

12/3

2 ELEVATION - SOUTH 1/8" = 1'-0"


EXTERIOR MATERIAL SCHEDULE					
BUILDING ELEMENT	MANUFACTURER	COLOR			
(#1) - BRICK VENEER	US BRICK	BURGUNDY VELOUR			
(#2) - BRICK VENEER	US BRICK	SHADOW GRAY VELOUR			
(#3) - COMPOSITE LAP SIDING - 6"	JAMES HARDIE	COBBLESTONE			
(#4) - COMPOSITE PANEL	JAMES HARDIE	COBBLESTONE - SMOOTH			
(#5) - COMPOSITE TRIM	JAMES HARDIE	COLOR TO MATCH ADJ. TRIM/SIDING			
(#6) - COMPOSITE WINDOWS	N/A	BLACK			
(#7) - CAST STONE	N/A	N/A			
(#8) - 10" x 10" WRAPPED COLUMN	N/A	COLOR TO MATCH ADJ. TRIM/SIDING			
(#9) - RAILINGS	N/A	BLACK			
(#10) - ASPHALT SHINGLE ROOF	N/A	N/A			
(#11) - METAL ROOF	N/A	N/A			



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1 COLORED ELEVATION - NORTH
A202 1/8" = 1'-0"

3 COLORED ELEVATION - EAST A202 1/8" = 1'-0"

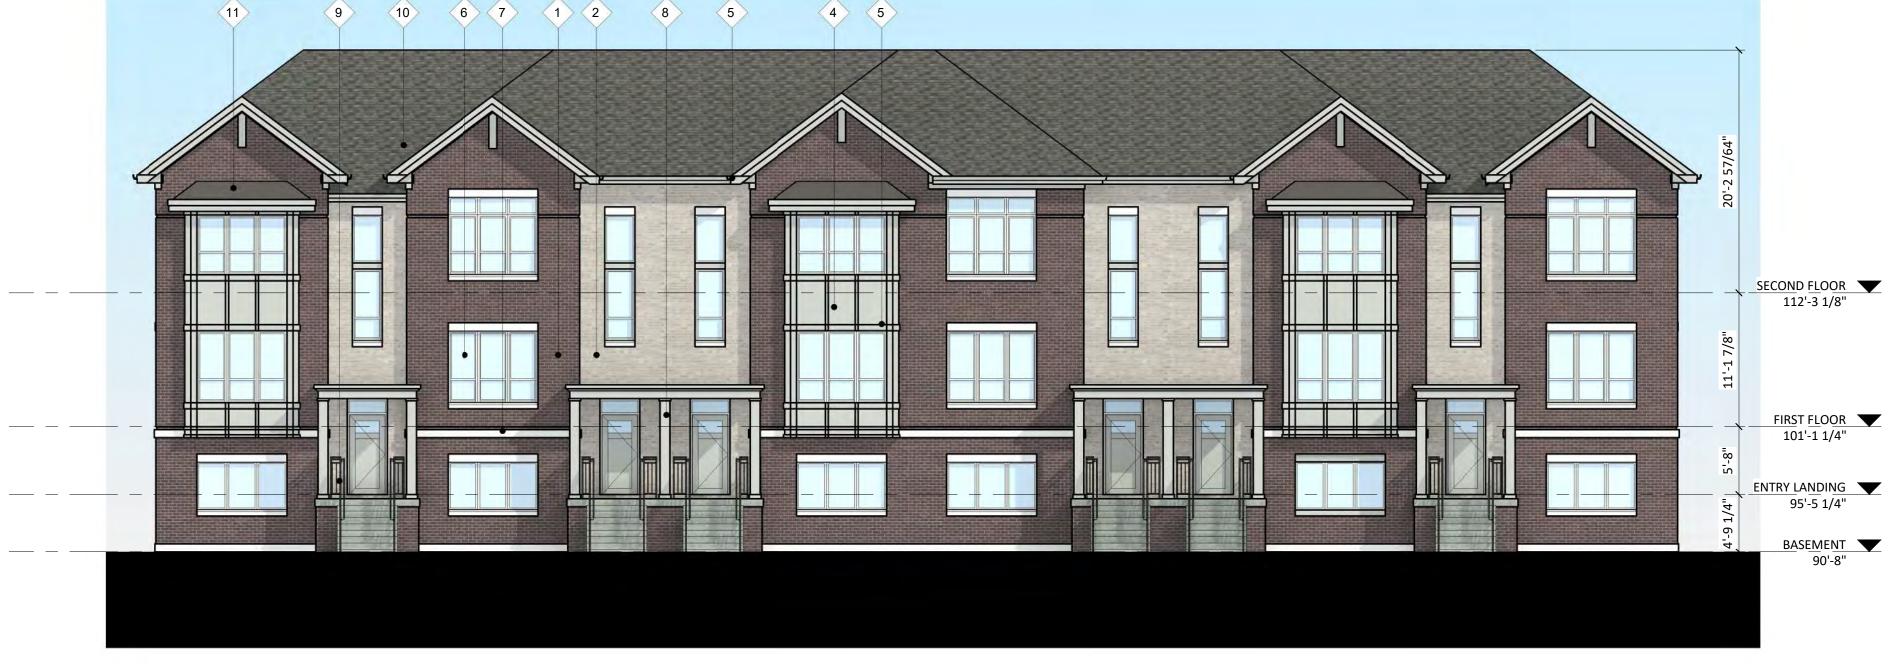

2 COLORED ELEVATION - SOUTH A202 1/8" = 1'-0"

PROJECT TITLE Paragon Place at Bear Claw Way Ziegler Site - Lot 6 BLDG #4

EXTERIOR MATERIAL SCHEDULE							
BUILDING ELEMENT	MANUFACTURER	COLOR					
(#1) - BRICK VENEER	US BRICK	BURGUNDY VELOUR					
(#2) - BRICK VENEER	US BRICK	SHADOW GRAY VELOUR					
(#3) - COMPOSITE LAP SIDING - 6"	JAMES HARDIE	COBBLESTONE					
(#4) - COMPOSITE PANEL	JAMES HARDIE	COBBLESTONE - SMOOTH					
(#5) - COMPOSITE TRIM	JAMES HARDIE	COLOR TO MATCH ADJ. TRIM/SIDING					
(#6) - COMPOSITE WINDOWS	N/A	BLACK					
(#7) - CAST STONE	N/A	N/A					
(#8) - 10" x 10" WRAPPED COLUMN	N/A	COLOR TO MATCH ADJ. TRIM/SIDING					
(#9) - RAILINGS	N/A	BLACK					
(#10) - ASPHALT SHINGLE ROOF	N/A	N/A					
(#11) - METAL ROOF	N/A	N/A					

Paragon Street Madison, Wisconsin SHEET TITLE COLORED

EXTERIOR ELEVATIONS

SHEET NUMBER

PROJECT NUMBER 2121









COLOR SCHEME 1



COMPOSITE SIDING, BAYS & TRIM



EXTERIOR MATERIAL SCHEDULE					
BUILDING ELEMENT	MANUFACTURER	COLOR			
(#1) - BRICK VENEER	US BRICK	BURGUNDY VELOUR			
(#2) - BRICK VENEER	US BRICK	SHADOW GRAY VELOUR			
(#3) - COMPOSITE LAP SIDING - 6"	JAMES HARDIE	COBBLESTONE			
(#4) - COMPOSITE PANEL	JAMES HARDIE	COBBLESTONE - SMOOTH			
(#5) - COMPOSITE TRIM	JAMES HARDIE	COLOR TO MATCH ADJ. TRIM/SIDING			
(#6) - COMPOSITE WINDOWS	N/A	TAN			
(#7) - CAST STONE	N/A	N/A			
(#8) - 10" x 10" WRAPPED COLUMN	N/A	COLOR TO MATCH ADJ. TRIM/SIDING			
(#9) - RAILINGS	N/A	BLACK			
(#10) - ASPHALT SHINGLE ROOF	N/A	N/A			
(#11) - METAL ROOF	N/A	N/A			



STONE SILLS



ALUMINUM RAILINGS



STANDING SEAM METAL ROOF



ASPHALT SHINGLES



FIELD BRICK VENEER



ACCENT BRICK VENEER



COLOR SCHEME 2



COMPOSITE SIDING, BAYS & TRIM





STONE SILLS



ALUMINUM RAILINGS



STANDING SEAM METAL ROOF



Λ	2	ЭЦ	Λ	ΙT	9	ЦΙ	M	CI	FS	



EXTERIOR MATERIAL SCHEDULE



FIELD BRICK VENEER



ACCENT BRICK VENEER

