URBAN DESIGN COMMISSION APPLICATION

UDC

City of Madison
Planning Division
Madison Municipal Building, Suite 017
215 Martin Luther King, Jr. Blvd.
P.O. Box 2985
Madison, WI 53701-2985
(608) 266-4635
(008) 200-4035



Complete all sections of this application, including the desired meeting date and the action requested.

If you need an interpreter, translator, materials in alternate formats or other accommodations to access these forms, please call the phone number above immediately.

FOR OFFICE USE ONLY:	
Paid	Receipt #
Date received	
Received by	
Aldermanic District	5/2/22
Zoning District	5/2/22 4:56 p.m.
Urban Design District	
Submittal reviewed by	
Legistar #	

1. Project Information

	Address:					
	Title:					
2	Application Type (check all that					
2.						
	New development			usly-approved development		
	Informational	Initial approval	•	Final approval		
	mormational		•			
3.	Project Type					
	Project in an Urban Design Dis	strict	Signa	ge		
	Project in the Downtown Core			Comprehensive Design Review (CDR)		
	Mixed-Use District (UMX), or Mi			Signage Variance (i.e. modification of signage height,		
	Project in the Suburban Emplo Campus Institutional District (area, and setback)		
	District (EC) Planned Development (PD) General Development Plan (GDP)		Signage Exception			
			Other			
			Please specify			
Specific Implementation Plan (SIP)						
	Planned Multi-Use Site or Resi	idential Building Complex				
4.	Applicant, Agent, and Property	Owner Information				
	Applicant name		Com	pany		
	Street address		City/State/Zip			
	Telephone					
	Project contact person					
Street address		City/State/Zip				
Telephone		E				
	Property owner (if not applicant		-			
	Street address		City	State/7in		
				State/Zip		
	Telephone		Emai	l		

5. Required Submittal Materials

Application Form

Letter of Intent

- If the project is within an Urban Design District, a summary of how the development proposal addresses the district criteria is required
- For signage applications, a summary of how the proposed signage is consistent with the applicable CDR or Signage Variance review criteria is required.

Development Plans (Refer to checklist on Page 4 for plan details)

Filing fee

Electronic Submittal*

Notification to the District Alder

• Please provide an email to the District Alder notifying them that you are filing this UDC application. Please send this as early in the process as possible and provide a copy of that email with the submitted application.

Both the paper copies and electronic copies <u>must</u> be submitted prior to the application deadline before an application will be scheduled for a UDC meeting. Late materials will not be accepted. A completed application form is required for each UDC appearance.

For projects also requiring Plan Commission approval, applicants must also have submitted an accepted application for Plan Commission consideration prior to obtaining any formal action (initial or final approval) from the UDC. All plans must be legible when reduced.

*Electronic copies of all items submitted in hard copy are required. Individual PDF files of each item submitted should be compiled on a CD or flash drive, or submitted via email to <u>udcapplications@cityofmadison.com</u>. The email must include the project address, project name, and applicant name. Electronic submittals via file hosting services (such as Dropbox.com) are not allowed. Applicants who are unable to provide the materials electronically should contact the Planning Division at (608) 266-4635 for assistance.

6. Applicant Declarations

- 1. Prior to submitting this application, the applicant is required to discuss the proposed project with Urban Design Commission staff. This application was discussed with ______ on
- 2. The applicant attests that all required materials are included in this submittal and understands that if any required information is not provided by the application deadline, the application will not be placed on an Urban Design Commission agenda for consideration.

Name of applicant ______ Relationship to property ______

Authorizing signature of property owner ______ Date _____ Date _____

7. Application Filing Fees

Fees are required to be paid with the first application for either initial or final approval of a project, unless the project is part of the combined application process involving the Urban Design Commission in conjunction with Plan Commission and/or Common Council consideration. Make checks payable to City Treasurer. Credit cards may be used for application fees of less than \$1,000.

Please consult the schedule below for the appropriate fee for your request:

Urban Design Districts: \$350 (per §35.24(6) MGO).

Minor Alteration in the Downtown Core District (DC) or Urban Mixed-Use District (UMX) : \$150 (per §33.24(6)(b) MGO)

Comprehensive Design Review: \$500 (per §31.041(3)(d)(1)(a) MGO)

Minor Alteration to a Comprehensive Sign Plan: \$100 (per §31.041(3)(d)(1)(c) MGO)

All other sign requests to the Urban Design Commission, including, but not limited to: appeals from the decisions of the Zoning Administrator, requests for signage variances (i.e. modifications of signage height, area, and setback), and additional sign code approvals: \$300 (*per §31.041(3)(d)(2) MGO*) A filing fee is not required for the following project applications if part of the combined application process involving both Urban Design Commission and Plan Commission:

- Project in the Downtown Core District (DC), Urban Mixed-Use District (UMX), or Mixed-Use Center District (MXC)
- Project in the Suburban Employment Center District (SEC), Campus Institutional District (CI), or Employment Campus District (EC)
- Planned Development (PD): General Development
 Plan (GDP) and/or Specific Implementation Plan (SIP)
- Planned Multi-Use Site or Residential Building Complex

Each submittal must include fourteen (14) 11" x 17" <u>collated</u> paper copies. Landscape and Lighting plans (if required) must be <u>full-sized and legible</u>. Please refrain from using plastic covers or spiral binding.

Introduction

The City of Madison's Urban Design Commission (UDC) has been created to:

- Encourage and promote high quality in the design of new buildings, developments, remodeling, and additions so as to maintain and improve the established standards of property values within the City.
- Foster civic pride in the beauty and nobler assets of the City, and in all other ways possible assure a functionally efficient and visually attractive City in the future.

Types of Approvals

There are three types of requests considered by the UDC:

- <u>Informational Presentation</u>. Applicants may, at their discretion, request to make an Informational Presentation to the UDC prior to seeking any approvals to obtain early feedback and direction before undertaking detailed design. Applicants should provide details on the context of the site, design concept, site and building plans, and other relevant information to help the UDC understand the proposal and provide feedback. (Does not apply to CDR's or Signage Variance requests)
- <u>Initial Approval</u>. Applicants may, at their discretion, request initial approval of a proposal by presenting preliminary design information. As part of their review, the Commission will provide feedback on the design information that should be addressed at Final Approval stage.
- <u>Final Approval</u>. Applicants may request Final Approval of a proposal by presenting all final project details. Recommendations or concerns expressed by the UDC in the initial approval must be addressed at this time.

Presentations to the Commission

Primarily, the UDC is interested in the appearance and design quality of projects. Emphasis should be given to the site plan, landscape plan, lighting plan, building elevations, exterior building materials, color scheme, and graphics.

When presenting projects to the UDC, applicants must fill out a registration slip provided in the meeting room and present it to the Secretary. Presentations should generally be limited to 5 minutes or as extended by motion by consent of the Commission. The Commission will withhold questions until the end of the presentation.

Applicants are encouraged to consider the use of various graphic presentation material including a locator map, photographs, renderings/model, scale drawings of the proposal in context with adjacent buildings/uses/signs, etc., as may be deemed appropriate to describe the project and its surroundings. Graphics should be mounted on rigid boards so that they may be easily displayed. Applicants/presenters are responsible for all presentation materials, AV equipment and easels.

URBAN DESIGN DEVELOPMENT PLANS CHECKLIST

The items listed below are minimal application requirements for the type of approval indicated. Please note that the UDC and/ or staff may require additional information in order to have a complete understanding of the project.

Providing additional

information beyond these

minimums may generate

from the Commission.

a greater level of feedback

1. Informational Presentation

- Locator Map
- □ Letter of Intent (If the project is within an Urban Design District, a summary of <u>how</u> the development proposal addresses the district criteria is required)
- Contextual site information, including photographs and layout of adjacent buildings/structures
- Site Plan
- □ Two-dimensional (2D) images of proposed buildings or structures.

2. Initial Approval

- Locator Map
- □ Letter of Intent (If the project is within a Urban Design District, a summary of <u>how</u> the development proposal addresses the district criteria is required)
- □ Contextual site information, including photographs and layout of adjacent buildings/ structures
- □ Site Plan showing location of existing and proposed buildings, walks, drives, bike lanes, bike parking, and existing trees over 18" diameter
- □ Landscape Plan and Plant List (*must be legible*)
- Building Elevations in both black & white and color for all building sides (include material callouts)
- D PD text and Letter of Intent (if applicable)

3. Final Approval

All the requirements of the Initial Approval (see above), plus:

- □ Grading Plan
- □ Proposed Signage (if applicable)
- Lighting Plan, including fixture cut sheets and photometrics plan (*must be legible*)
- Utility/HVAC equipment location and screening details (with a rooftop plan if roof-mounted)
- D PD text and Letter of Intent (if applicable)
- □ Samples of the exterior building materials (presented at the UDC meeting)

4. Comprehensive Design Review (CDR) and Variance Requests (Signage applications only)

- Locator Map
- Letter of Intent (a summary of how the proposed signage is consistent with the CDR or Signage Variance criteria is required)
- □ Contextual site information, including photographs of existing signage both on site and within proximity to the project site
- □ Site Plan showing the location of existing signage and proposed signage, dimensioned signage setbacks, sidewalks, driveways, and right-of-ways
- Proposed signage graphics (fully dimensioned, scaled drawings, including materials and colors, and night view)
- □ Perspective renderings (emphasis on pedestrian/automobile scale viewsheds)
- □ Illustration of the proposed signage that meets Ch. 31, MGO compared to what is being requested.
- Graphic of the proposed signage as it relates to what the Ch. 31, MGO would permit

Requirements for All Plan Sheets

- 1. Title block
- 2. Sheet number
- 3. North arrow
- 4. Scale, both written and graphic
- 5. Date
- Fully dimensioned plans, scaled at 1"= 40' or larger

** All plans must be legible, including the full-sized landscape and lighting plans (if required)

> Providing additional information beyond these minimums may generate a greater level of feedback from the Commission.

UDC



Cedar Rapids

200 Fifth Avenue SE Ste. 201 Cedar Rapids, Iowa 52401 (319) 363-6018

Des Moines

100 Court Avenue Ste. 100 Des Moines, Iowa 50309 (515) 309-0722

lowa City

24 ½ S. Clinton Street Ste. 1 Iowa City, Iowa 52240 (319) 363-6018

Madison

301 N. Broom Street Ste. 100 Madison, Wisconsin 53703 (608) 819-0260

Minneapolis

323 N. Washington Avenue Ste. 200 Minneapolis, Minnesota 55401 (612) 468-6851

opnarchitects.com

Concerning:

Proposed Rooftop Terrace Redrock Saloon 222 W Gorham St. Madison, WI 53703

To whom it may concern,

I am writing on behalf of ULI property management and Drew Deuster of Red Rock Saloon regarding the proposed addition of rooftop terrace to their existing bar and nightclub venue. We are intending to file for a conditional use application to accommodate the rooftop patio space at Redrock Saloon, 222 W Gorham Street.

Project specifics consist of adding two overhead doors and two man doors in the existing exterior wall to allow access to the existing unoccupied roof that will support the proposed rooftop terrace. The proposed patio space consists of 1,338 sf and will have maximum occupant load of 90 that will be added to the building total. This new occupant load is calculated by using a ratio of 1/15 nsf for occupancy type A-2 Assembly (Unconcentrated tables and chairs) per Table 1004.1.2 IBC. All exiting width requirements are being met to accommodate the increased occupant load, detailed code information as well as a proposed seating plan can be found on Sheet AG001. Most of the space will house tables and chairs, with shade structure at one end covering lounge style seating.

The Red Rock Saloon is open until "bar time" 2:30 AM on Friday and Saturday. No new patrons are allowed in the building after 2:00 AM. The saloon is open until 2:00 AM Tuesday – Thursday. The management of Red Rock Saloon intends to close the overhead doors that connect the patio to the indoor bar area by 11:00 PM and have all patrons off the patio by 1:30 am nightly. There will be no amplified or live music on the patio.

Notification letters were sent out to the community on 3/16 and 3/18 of our intentions for this project. We had a neighborhood meeting with Alderman Heck on 4/12, there were no attendees from the community.



Our intent is to submit our application on May16th for UDC review on June 29th and Plan Commission on July 11th.

Any questions regarding our intent can be directed to me.

Thank you,

Michael Booth AIA | EDAC Project Architect

OPN Architects o: (608) 819-0260 | c: (612) 804-9586 | d: (608) 819-0849 | <u>mbooth@opnarchitects.com</u> 301 N. Broom St., Suite 100, Madison, WI, 53703 <u>www.opnarchitects.com</u>

REDROCK SALOON CODE ANALYSIS

PERMIT SET

DRAWING SHEET INDEX:

ARCHITECT OF RECORD:

OPN ARCHITECTS


GENERAL

AG001 COVER, DRAWING SHEET INDEX, CODE SUMMARY

ARCHITECTURAL

A101


1ST LEVEL FLOOR PLAN & SECTIONAL ELEVATION

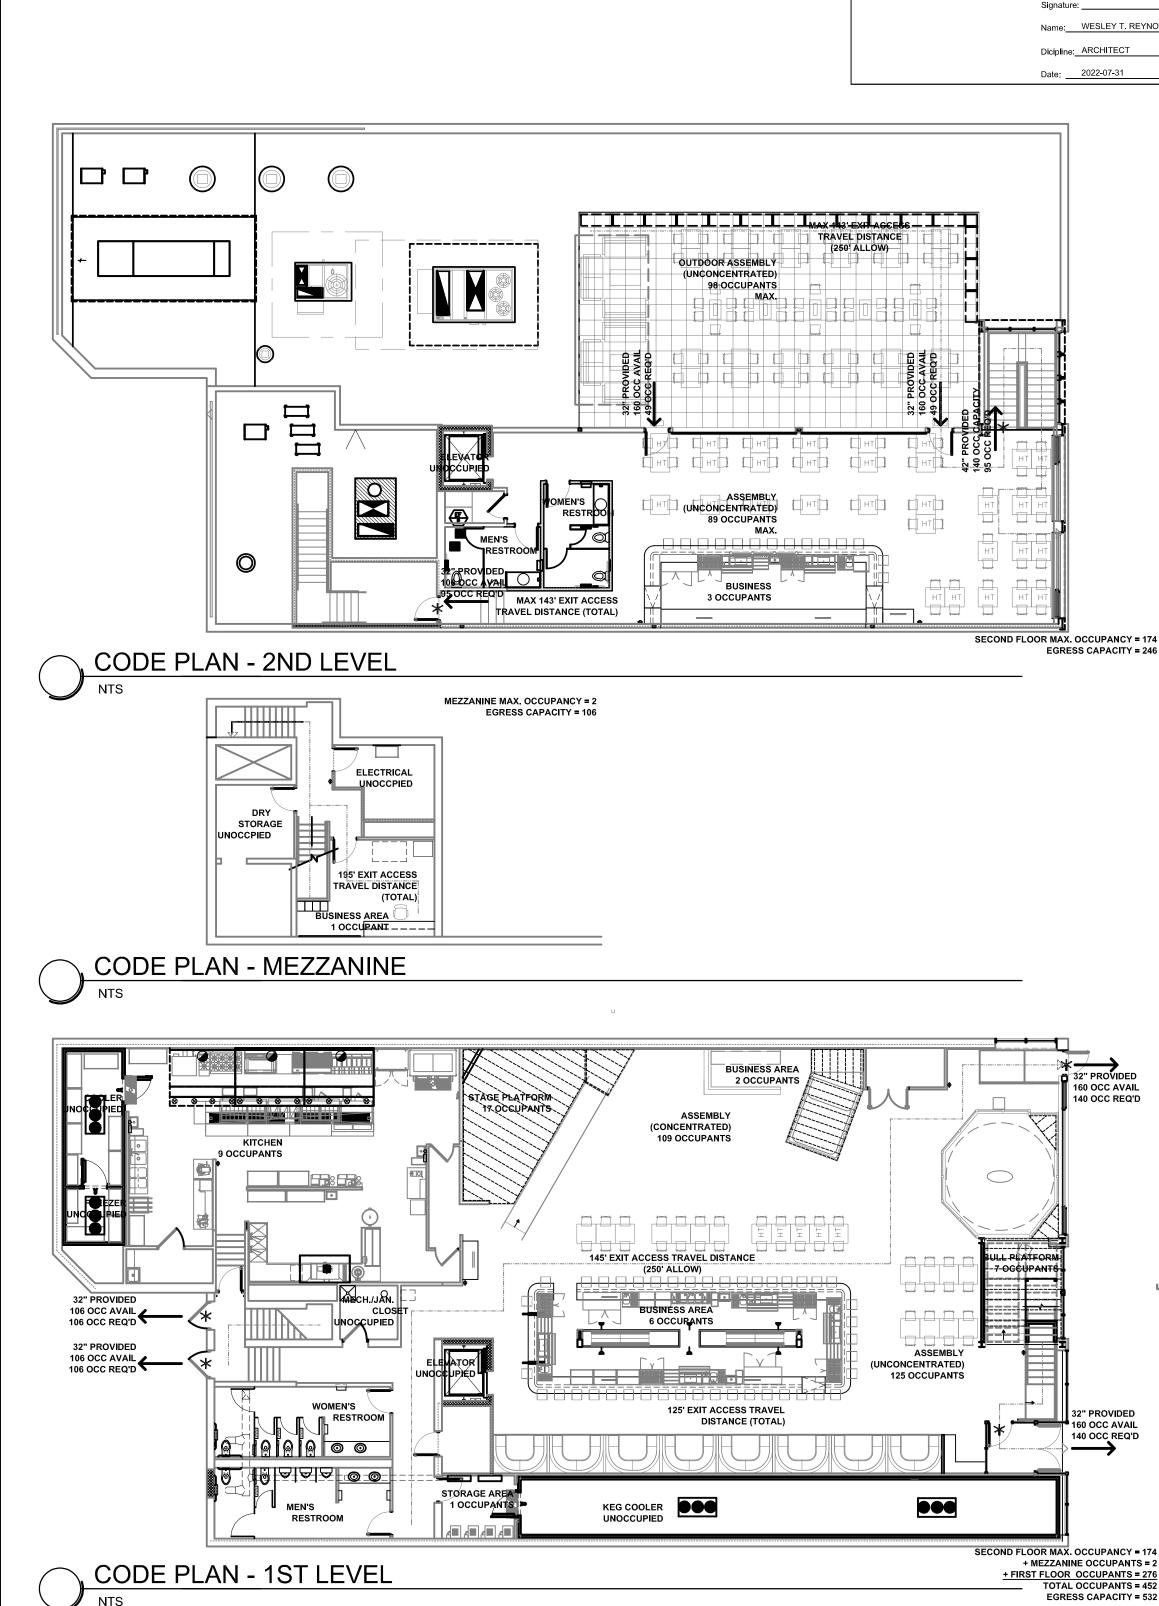


This project consists of remodeling of second flor restrooms and adding an outdoor roof terrace to the existing Redrock Saloon eating and entertainment facility. I hereby certify these plans and specifications APPLICABLE CODES were prepared by me or under my direct personal WISCONSIN COMMERCIAL BUILDING CODE- Wisconsin Department of Safety and supervision and that I am a duly Registered Professional Services (SPS) Chapters 361 to 366, incorporating: Architect under the laws of the State of Wisconsin. • International Building Code (IBC) 2015 • International Energy Conservation Code (IECC) 2015 • International Existing Building Code (IEBC) 2015 • International Fuel Gas Code (IFGC) 2015 Name WESLEY T REYNOLDS • International Mechanical Code (IMC) 2015 • Adopted portions of the International Fire Code (IFC) 2015 _ Registration # 11709-5 • ICC/ANSI A117.1 (2009): Standard for Accessibility and Usable Buildings and Facilities SPS Chapters 380-387; Plumbing City of Madison Municipal Code CODE REVIEW SUMMARY - OCCUPANCY CLASSIFICATION, A-2 ASSEMBLY & B BUSINESS CONSTRUCTION CLASSIFICATION: TYPE IIA (Assumed/Existing) FULLY SPRINKLERED PER NFPA 13 OCCUPANCY LOAD FACTOR (per chapter 10): 452 occupants (Total) MIN NUMBER OF EXITS: 360>49 = 2 EXITS REQUIRED IBC CHAPTER 6: Types of Construction Existing Construction Type IIA (no change proposed) Existing Building is Fully Sprinklered Per NFPA 13. IBC CHAPTER 7: Fire and Smoke Protection Features Requirements: The fire-resistance ratings of structural members and assemblies shall comply with this section and the requirements for the type of construction as specified in Table 601. The fire-resistance ratings shall not be less than the ratings required for the fire-resistance-rated assemblies supported by the structural members. IBC CHAPTER 10: Means of Egress 1004 Occupant Load The occupant load of the remodeled area has been calculated based on the following, per Table 1004.1.2 First Floor: Seating Shown: Occupants: Assembly (Unconcentrated): 1/15 nsf 2,580 sf = 172 125 Assembly (Standing Concentrated): 1/5 nsf 302 sf = 61 1/100 gsf 600 sf = Business: 1/200 qsf 1,720 sf = Kitchen: Storage: 1/300 gsf 85 sf = EGRESS CAPACITY = 246 Stages/Platforms: 1/15 nsf 403 SF = Subtotal: 276 Maximum Occupants Mezzanine: 1/100 gsf 97sf = Business: Storage: 1/300 gsf 250 sf = Second Floor Assembly (Indoor) (Unconcentrated): 1/15 nsf 1,099 sf 73 Assembly (Outndoor) (Unconcentrated): 1/15 nsf 1,338 sf 98 1/100 gsf 276 sf Business: Subtotal: 174 Maximum Occupants Total: 452 occupants 1005 Egress Width 1005.1 Total width of means of egress in inches shall not be less than the total occupant load served by the means of egress multiplied by 0.3 inch per occupant for stairways and by 0.2 inch (5.08 mm) per occupant for other egress components. The width shall not be less than specified elsewhere in this code. Multiple means of egress shall be sized such that the loss of any one means of egress shall not reduce the available capacity to less than 50 percent of the required capacity. Refer to Code Plans at left for egress capacities. 1016 Exist Access Travel Distance 1016.1 Per Table 1016.1, An Occupancy with sprinkler system allows a maximum of 250' Travel Distance. 32" PROVIDED 160 OCC AVAIL IBC CHAPTER 11: Accessibility 140 OCC REQ'D 1103.2.2 Employee work areas. Spaces and elements within employee work areas shall only be required to comply with Sections 907.5.2.3.2, 1007 and 1104.3.1 and shall be designed and constructed so that individuals with disabilities can approach, enter and exit the work area. Work areas, or portions of work areas, other than raised courtroom stations in accordance with Section 1108.4.1.4, that are less than 300 square feet (30 m) in area and located 7inches (178 mm) or more above or below the ground or finished floor where the change in elevation is essential to the function of the space shall be exempt from all requirements. 1104.3.1 Employee work areas. Common use circulation paths within employee work areas shall be accessible routes. Exceptions: 1. Common use circulation paths, located within employee work areas that are less than 1,000 square feet (93 m) in size and defined by permanently installed partitions, counters, casework or furnishings, shall not be required to be accessible routes. **IBC CHAPTER 29: PLUMBING SYSTEMS** Table 2902.1 Minimum Number of Required Plumbing Fixtures NO. WC Required Provided LAV Required Provided DRINKING SERVICE FOUNTAI<u>NS</u>SINKS OCCUPANTS MEN 1:500** 226 1:40 7* 1:75 3 1 6 3 32" PROVIDED WOMEN 226 1:40 6 6 1:75 3 3 * 3 WC and 4 Urinals Provided. ** Service Sink provided in Kitchen Area. **CODE REVIEW**


PROJECT DESCRIPTION

10 / 08 / 2021

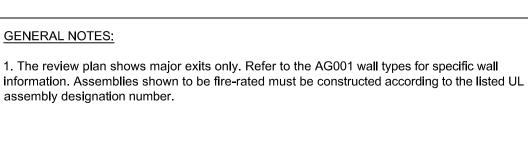

1-HOUR FIRE RATED WALL

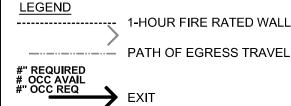

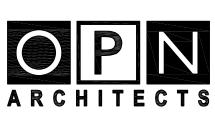

CEDAR RAPIDS • DES MOINES • MADISON

OPN ARCHITECTS, INC. 301 N. BROOM ST., SUITE 100 MADISON, WI 53703 608/819-0260 PHONE www.opnarchitects.com opn@opnarchitects.com

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Building Owner Urban Land Interests

10 East Doty Street, Suite 300 Madison, WI 53703

Architect of Record **OPN ARCHITECTS** 301 N. Broom Street, Suite 100 Madison, WI 53703

Project

REDROCK SALOON CODE ANALYSIS 222 West Gorham Street Madison, WI 53703

OCCUPANCY REVIEW 04/01/2022

FOR REVIEW

Issue & Revision Dates

Drawing COVER, DRAWING SHEET INDEX, CODE SUMMARY

OPN Project No. 22608000



Red Rock Saloon

C

The P

Rooftop Patio Design



Patio Axon

SPACE A

and a

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OPN ARCHITECTS

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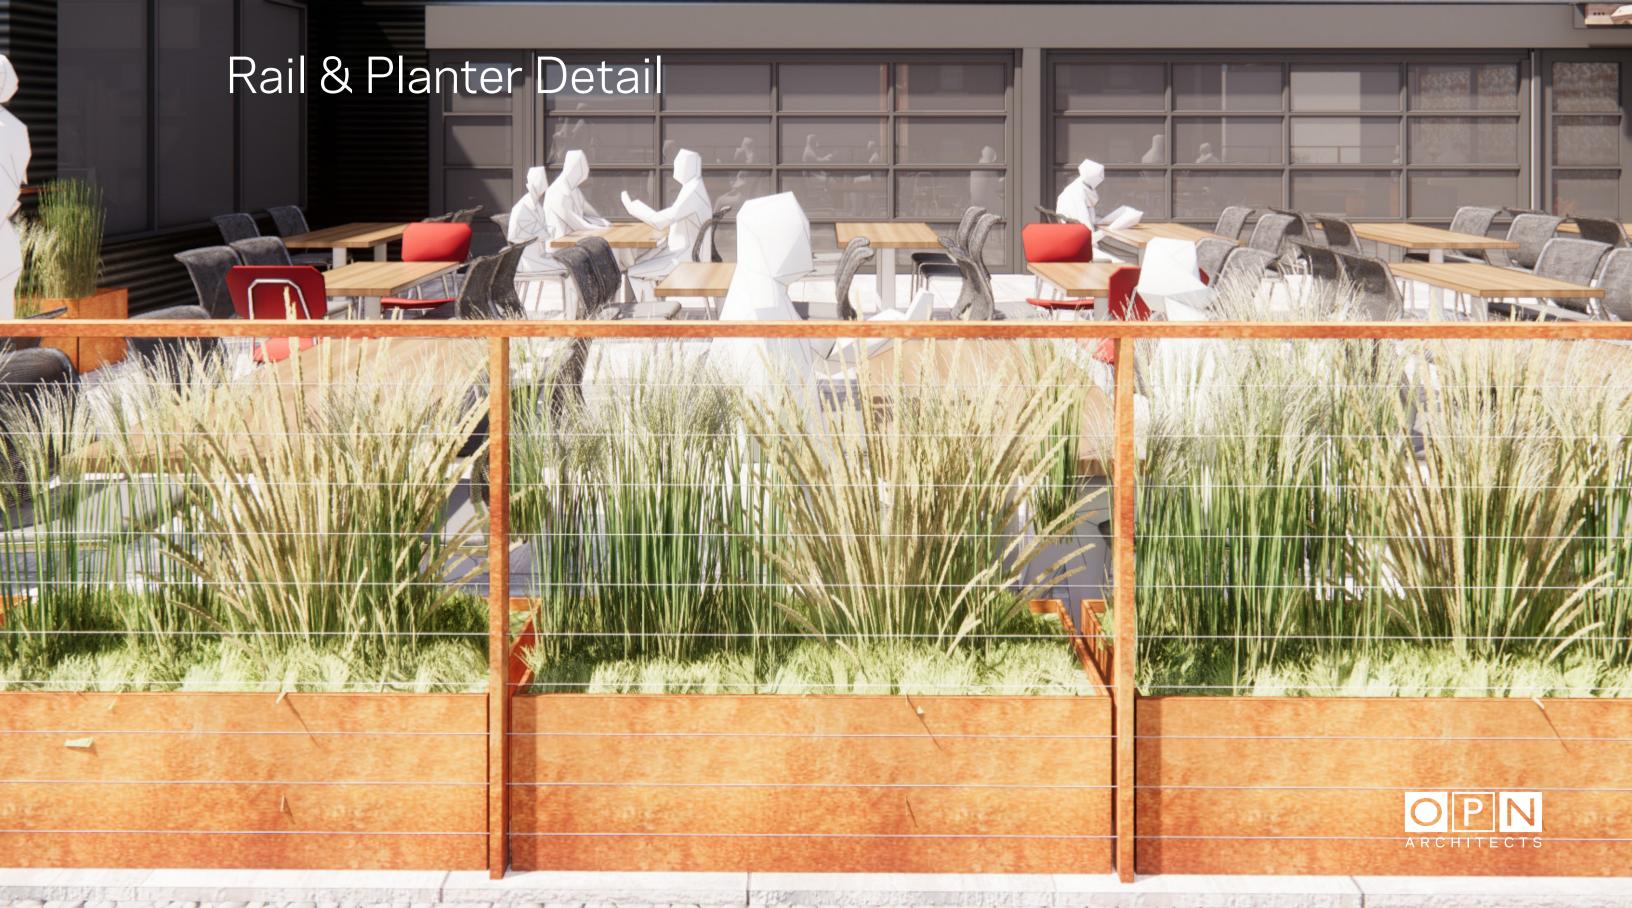


Street Perspective

1




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Proposed Planter








COR-TEN Steel Planter Box

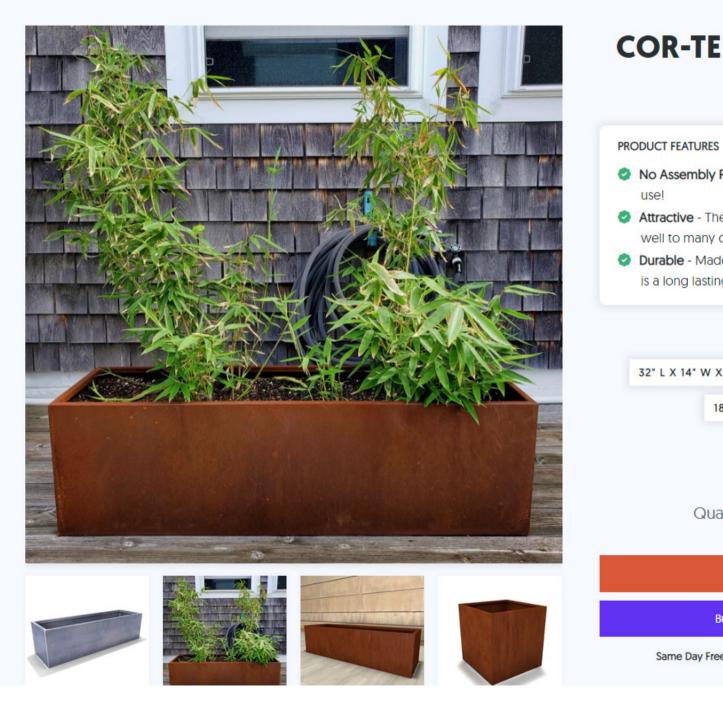No Assembly Required - Planters arrive ready to

Attractive - The clean, modern, aesthetic pairs well to many different décor styles.

Ourable - Made of marine-grade Cor-Ten steel, it is a long lasting investment.

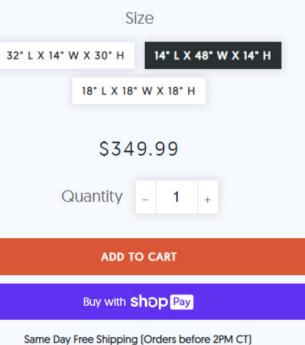

Paver Install



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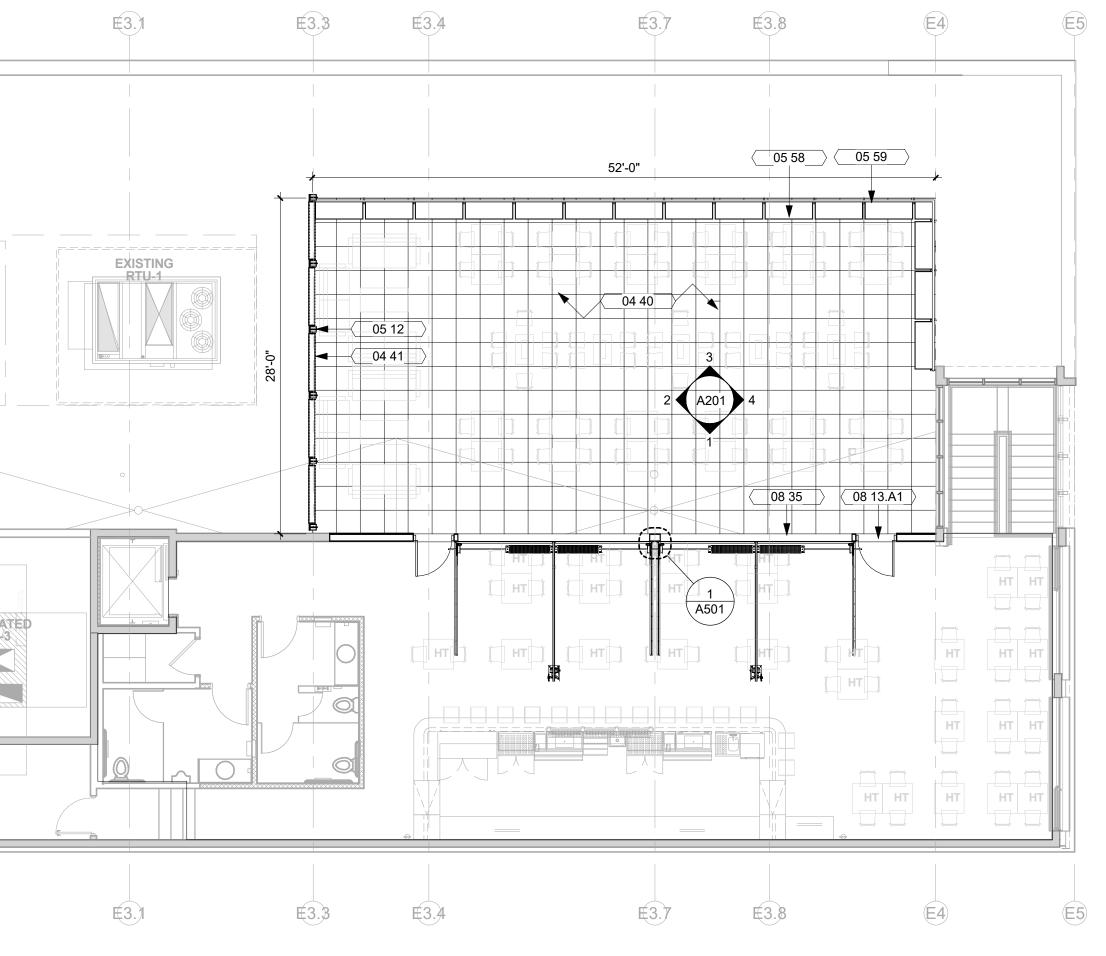
1 2 3 4 5

A17 FIRST FLOOR PLAN 1/8" = 1'-0"


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6

- G17 SECOND FLOOR PLAN 1/8" = 1'-0"
- $\langle \rangle$ \bigcirc EXISTING RTU-2 MUA 1 RELOCATE RTU-3



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10 11 12 13 14 15 16 9

ARCHITECTS

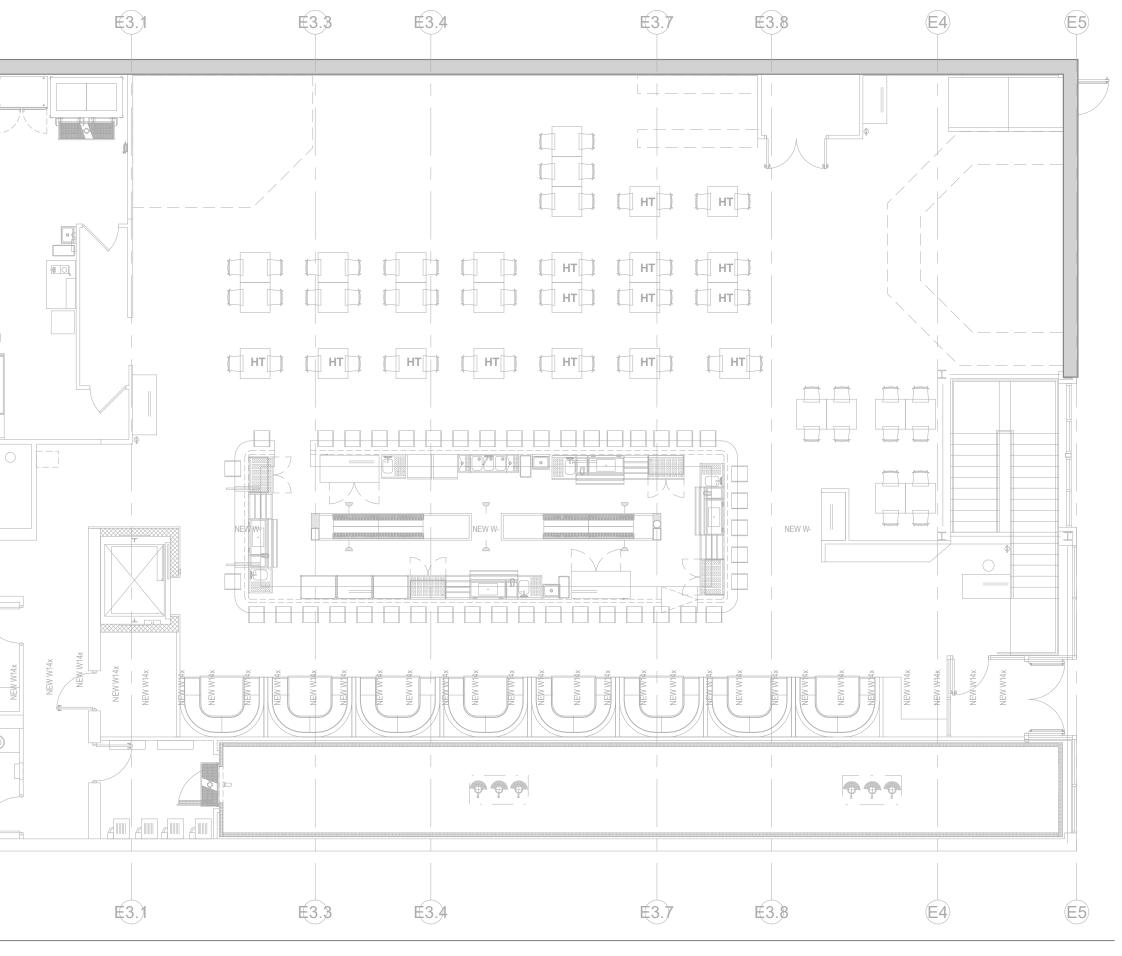301 N Broom St., Suite 100 Madison, WI 53703 P: 608-819-0260

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Owner ULI

Project RED ROCK SALOON ROOF TERRACE

General Contractor Contractor Name

Civil Engineer Contractor Name

Structural Engineer Contractor Name

Mechanical Engineer Contractor Name

Electrical Engineer Contractor Name

Revision Descriptio

Key Plan

22608000

Sheet Issue Date

Sheet Name

Sheet Number

05/05/20

FLOOR PLANS

PRELIMINARY. NOT FOR CONSTRUCTION.

OPN Project No.

A101

KEYNOTE LEGEND STONE PAVER ON PEDESTAL 04 40 SYSTEM 04 41 GABION WALL WITH CORTEN STEEL CAGE 05 12

GENERAL NOTES

1. DIMENSIONS ARE MEASURED FACE-

2. FIELD VERIFY ALL DIMENSIONS AND

3. IN THE EVENT OF A DISCREPANCY

BETWEEN ARCHITECTURAL AND

CONSULTANT DRAWINGS, NOTIFY

4. ALL PENETRATIONS IN FIRE RATED

ARCHITECT IMMEDIATELY PRIOR TO

FLOORS AND WALLS MUST BE SEALED

WITH APPROPRIATE FIRESTOPPING

5. PATCH AND REPAIR EXISTING FLOOR SLABS AND WALL SURFACES

DAMAGED FROM DEMOLITION.

COMMENCING WORK - TYPICAL FOR

DRAWINGS.

ALL DRAWINGS.

ALL DRAWINGS.

SYSTEM.

OF-FINISH TO FACE-OF-FINISH OR

ROUGH MASONRY OPENING UNLESS

NOTED OTHERWISE - TYPICAL FOR ALL


EXISTING CONDITIONS - TYPICAL FOR


STEEL AND WOOD COLUMN 05 58 CORTEN STEEL PLANTER 05 59 CORTEN STEEL RAIL W/ STAINLESS STEEL AIRCRAFT CABLE 08 13.A1 ALUMINUM AND GLASS ENTRY DOOR 08 35 OVERHEAD GLASS DOOR


ACCESSORIES LEGEND

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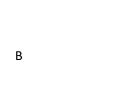
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2 ELVEVATION 2 3/16" = 1'-0"

5'-6"

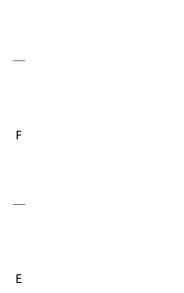TYP.

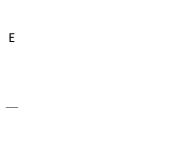


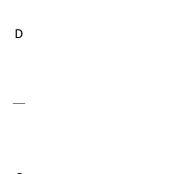28'-0" (04 41) (05 13) (05 51.E4)

05 12 -<<u>05 58</u>


10'-6"

4 ELEVATION 4 3/16" = 1'-0"

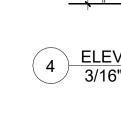


1 2 3 4 5 6 7 8 9 10 11 12 13 14 15 16 19 20 21

1 ELEVATION 1 3/16" = 1'-0"

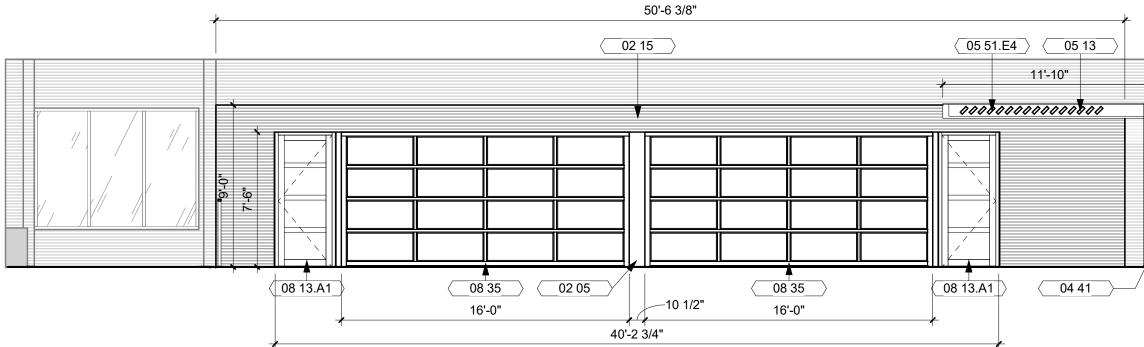





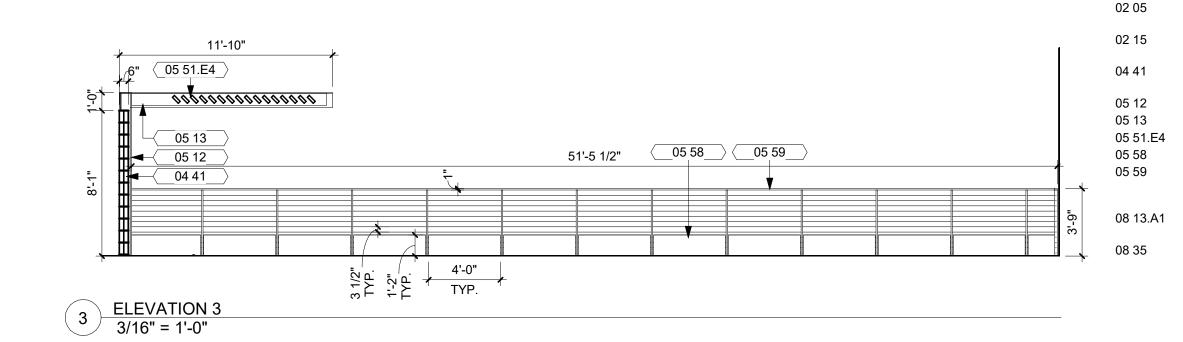



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_____ Owner ULI

F.

Project RED ROCK SALOON ROOF TERRACE

General Contractor Contractor Name

Civil Engineer Contractor Name

Structural Engineer Contractor Name

Mechanical Engineer Contractor Name

Electrical Engineer Contractor Name

Key Plan

Revision Description

OPN Project No. 22608000

Sheet Issue Date

Sheet Name

02/28/22

EXTERIOR ELEVATIONS

Sheet Number


KEYNOTE LEGEND

BREAK METAL - MATCH BLACK DOOR FRAME CORRUGATED METAL SIDING -MATCH EXISTING 04 41 GABION WALL WITH CORTEN STEEL CAGE 05 12 STEEL AND WOOD COLUMN STEEL AND WOOD BEAM 05 51.E4 WOOD SUN SHADE 05 58 CORTEN STEEL PLANTER 05 59 CORTEN STEEL RAIL W/ STAINLESS STEEL AIRCRAFT CABLE 08 13.A1 ALUMINUM AND GLASS ENTRY DOOR OVERHEAD GLASS DOOR

_____05 12____

PRELIMINARY. NOT FOR CONSTRUCTION.

A201

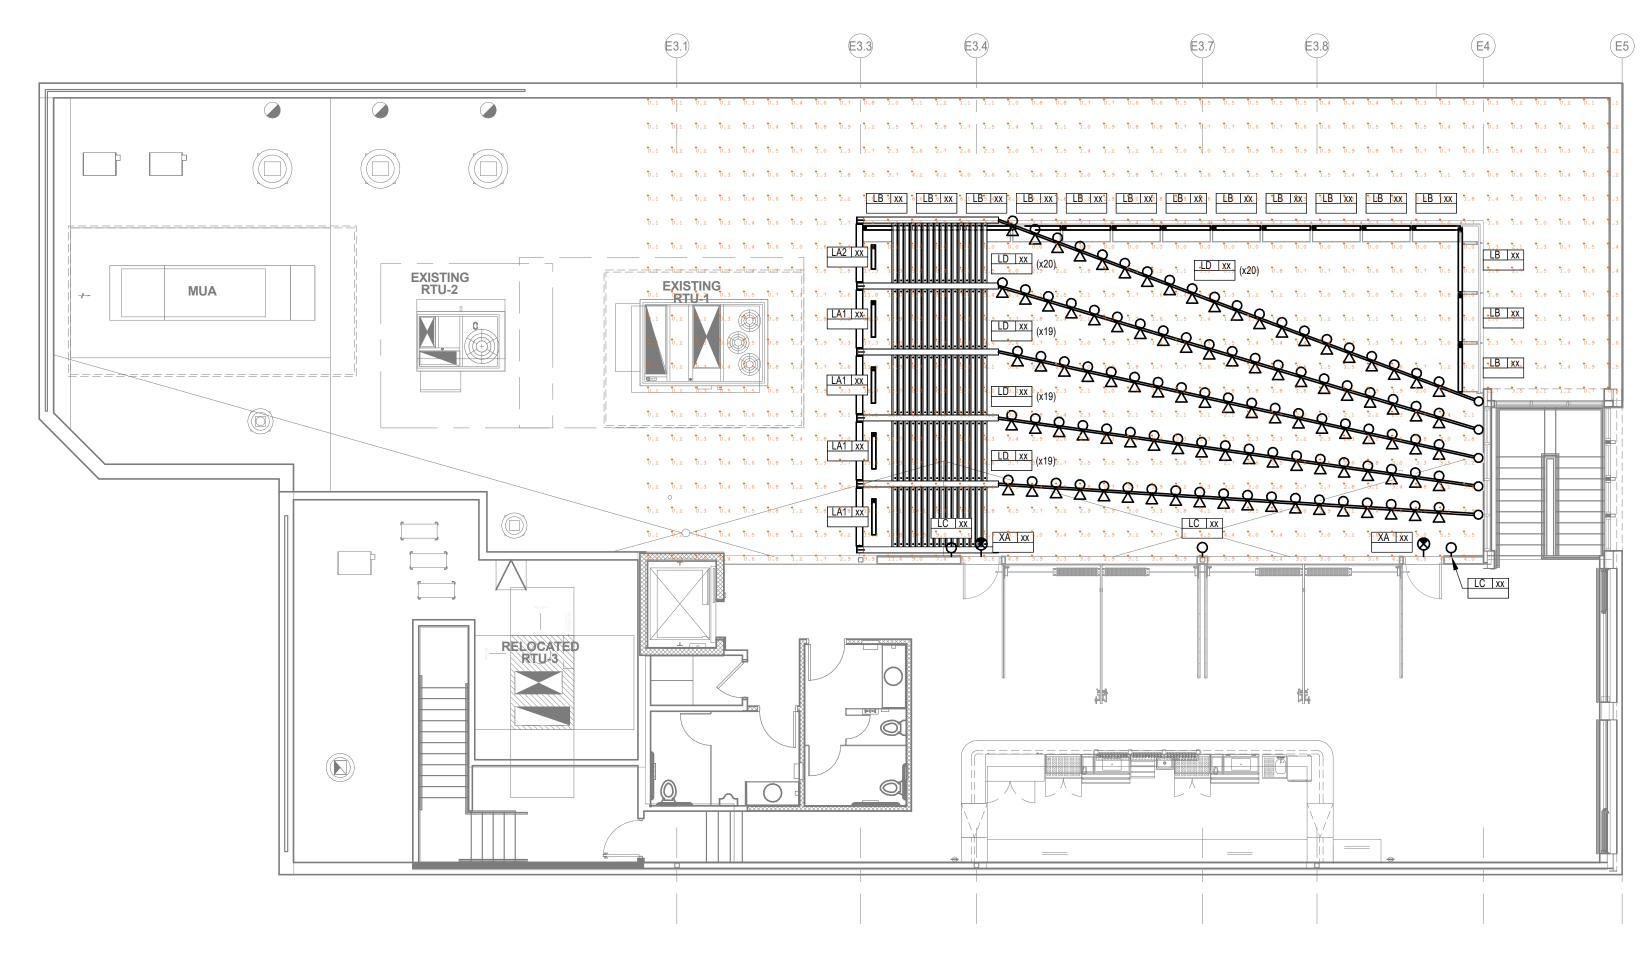


11 12

13

14

15

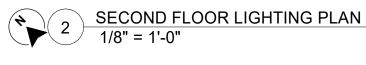

		LI
PLAN	MANUFACTURERS AND	
MARK	MODEL NUMBERS	DESCRIPTION
LA1	TARGETTI JE-C-O-10-FL-36-2700-L-1E3304	LINEAR WALL WAS
		IP67
LA2	TARGETTI JE-C-O-10-FL-24-2700-L-1E3304	LINEAR WALL WAS
		IP67
LB	TARGETTI JE-C-O-10-FL-48-2700-L-1E3304	LINEAR WALL WAS
		IP67
LC	LUMINIS EC610-L1W18R1-120-BKT-K27-EC6PS	EXTERIOR SCON
LD	TIVOLI LSL2-B-24-H-2700K-F-12	GLOBE STRING
XA	ISOLITE RWL-EM-G-1-BK-MTEBP	EXTERIOR EXIT
KEY:		
3W	=THREE WIRE DIMMING	
0-10	=0-10V DIMMED	
GENER	AL NOTES:	
	A. REFER TO SPECIFICATION 265000 FOR ADDITIONAL	REQUIREMENTS.
	B. PROVIDE A MINIMUM 5 YEAR WARRANTY ON ALL LE	D PRODUCTS 20W AND GR
	C. EQUIVALENT MANUFACTURERS LISTED SHALL MEE	T PERFORMANCE REQUIRE
	EQUIVALENTS SHALL NOT CONSUME MORE THAN 10% I	N WATTAGE OR BE LESS T

1 2 3 4 5 6 7 8 9 10

- E. COORDINATE FIXTURES LOCATED IN NON-ACCESSABLE CEILINGS ARE ACCESSIBLE FROM BELOW THROUGH THE FIXTURE, PRIOR TO SUBMITTAL PROCESS. F. COORDINATE DRIVER TYPE WITH THE LIGHTING CONTROL SYSTEM, PRIOR TO SUBMITTAL PROCESS. SPECIFIC NOTES:

 - CATENARY MOUNTED LIGHT FIXTURES
- 1. PROVIDE WITH INTEGRAL BATTERY PACK.

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LIGHT FIXTURE SCHEDULE									
LED DETAILS		DRIVER		INPUT		FIXTURE			
COLOR (K)	LUMEN OUTPUT	QTY.	TYPE	DIM MIN.	WATTS	VOLTS	MOUNTING	NOTES	
2700	3,600	1	0-10	1%	40	120	SURFACE		
2700	2,400	1	0-10	1%	28	120	SURFACE		
2700	4,800	1	0-10	1%	53	120	SURFACE		
2700	1163	1	0-10	1%	15	120	WALL SURFACE		
2700	7 LM/FT	1	0-10	1%	0.12W/FT	120	CATENARY	NOTE 2	
NA	NA	NA	NA	NA	3.4	120	WALL		
DA =DIGITAL ADDRESSABLE SD =STEP DIMMED ND =NON-DIMMED DMX =DMX ENABLED									
	LE COLOR (K) 2700 2700 2700 2700 2700 NA 	LED DETAILS COLOR (K) LUMEN OUTPUT 2700 3,600 2700 2,400 2700 4,800 2700 1163 2700 7 LM/FT NA NA =DIGITAL ADDRESSABLE	LED DETAILS COLOR (K) LUMEN OUTPUT QTY. 2700 3,600 1 2700 2,400 1 2700 4,800 1 2700 1163 1 2700 7 LM/FT 1 NA NA NA =DIGITAL ADDRESSABLE SD *	LED DETAILS DRIVE COLOR (K) LUMEN OUTPUT QTY. TYPE 2700 3,600 1 0-10 2700 2,400 1 0-10 2700 4,800 1 0-10 2700 1163 1 0-10 2700 7 LM/FT 1 0-10 NA NA NA NA =DIGITAL ADDRESSABLE SD =STEP DI SD =STEP DI	LED DETAILS DRIVER COLOR (K) LUMEN OUTPUT QTY. TYPE DIM MIN. 2700 3,600 1 0-10 1% 2700 2,400 1 0-10 1% 2700 4,800 1 0-10 1% 2700 1163 1 0-10 1% 2700 7 LM/FT 1 0-10 1% 2700 7 LM/FT 1 0-10 1% NA NA NA NA NA NA SD SD SD SD	LED DETAILS DRIVER INPUT COLOR (K) LUMEN OUTPUT QTY. TYPE DIM MIN. WATTS 2700 3,600 1 0-10 1% 40 2700 2,400 1 0-10 1% 28 2700 2,400 1 0-10 1% 28 2700 4,800 1 0-10 1% 53 2700 1163 1 0-10 1% 53 2700 7 LM/FT 1 0-10 1% 0.12W/FT NA NA NA NA 3.4 =DIGITAL ADDRESSABLE SD =STEP DIMMED	LED DETAILS DRIVER INPUT VOLTS COLOR (K) LUMEN OUTPUT QTY. TYPE DIM MIN. WATTS VOLTS 2700 3,600 1 0-10 1% 40 120 2700 2,400 1 0-10 1% 28 120 2700 4,800 1 0-10 1% 53 120 2700 4,800 1 0-10 1% 53 120 2700 1163 1 0-10 1% 53 120 2700 7 LM/FT 1 0-10 1% 0.12W/FT 120 2700 7 LM/FT 1 0-10 1% 0.12W/FT 120 NA NA NA NA NA 3.4 120 EDIGITAL ADDRESSABLE SD =STEP DIMMED Image: State Sta	LED DETAILS DRIVER INPUT VOLTS FIXTURE MOUNTING 2700 3,600 1 0-10 1% 40 120 SURFACE 2700 2,400 1 0-10 1% 28 120 SURFACE 2700 4,800 1 0-10 1% 53 120 SURFACE 2700 4,800 1 0-10 1% 53 120 SURFACE 2700 7 LM/FT 1 0-10 1% 53 120 SURFACE 2700 7 LM/FT 1 0-10 1% 15 120 WALL SURFACE 2700 7 LM/FT 1 0-10 1% 0.12W/FT 120 CATENARY NA NA NA NA NA 3.4 120 WALL = DIGITAL ADDRESSABLE SD =STEP DIMMED Image: Step dimed Image: Step dimed Image: Step dimed Image: Step dimed	

REATER.

EMENTS OF THE BASE FIXTURE SPECIFIED.

HAN 5% IN LUMENS. D. COORDINATE WITH ARCHITECTURAL CEILING PLANS FOR CEILING TYPES PRIOR TO SUBMITTAL PROCESS, VERIFY PLANNED CEILING TYPES COORDINATE WITH SPECIFIED FIXTURES.

2. PROVIDE WITH GALVANIZED CABLE IN LENGTHS NOTED ON PLANS. PROVIDE LOCKABLE FASTENERS AND INSTALL WITH CATENARY TENSIONING TOOL TO ENSURE MINIMAL DROOP OF

ELECTRICAL LIGHTING SYMBOLS (NOTE: ALL SYMBOLS SHOWN MAY NOT BE REQUIRED FOR THIS PROJECT)

(NOTE: +##" INDICATES DIMENSION HEIGHT TO CENTER OF DEVICE ABOVE FINISHED FLOOR)

*** LIGHTING FIXTURES ***

	-
· · · · · · · · · · · · · · · · · · ·	INDICATES DAYLIGHT HARVEST ZONE
\bigcirc	CEILING FIXTURE - PENDANT MOUNTED
0	CEILING FIXTURE
	CEILING FIXTURE - RECESSED
0-	FIXTURE - WALL MOUNTED
0	LINEAR FIXTURE
	LINEAR FIXTURE - RECESSED
└ ┍	LINEAR FIXTURE - WALL MOUNTED
$\vdash \rightarrow$	STRIP FIXTURE
⊢∽⊣	STRIP FIXTURE - WALL MOUNTED
O +	DIRECT / INDIRECT FIXTURE - SUSPENDED O = FEED/SUSPENSION POINT + = SUSPENSION POINT
	LED STRIP FIXTURE ■ = FEED POINT
⊗	EXIT SIGN - CEILING MOUNTED
€-	EXIT SIGN - WALL MOUNTED
Š	EXIT / EMERGENCY SIGN - CEILING MOUNT
₫-	EXIT / EMERGENCY SIGN - WALL MOUNTED
ğ	EMERGENCY LIGHT - CEILING MOUNTED
Ĕ	EMERGENCY LIGHT - WALL MOUNTED
ΔΔΟ	LIGHT TRACK O= FEED POINT A = HEAD
ΟÐ	POLE AND LUMINAIRE, ARROW INDICATES
⊴⊖⋻	POLE AND TWO LUMINAIRE, ARROWS INDI
Ø	POST TOP LUMINAIRE
₽	FLOOD LIGHT - GROUND MOUNTED
\odot	BOLLARD ON CONCRETE BASE
Ο	FLOOD LIGHT - IN GROUND

19	20	21

KEYED NOTES



301 N Broom St., Suite 100 Madison, WI 53703 P: 608-819-0260

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_____ Owner ULI

Project RED ROCK SALOON ROOF TERRACE

General Contractor Contractor Name

XXX 1ST STREET DES MOINES, IA 50309 P. 515-309-XXXX F. 515-309-XXXX

Civil Engineer Contractor Name XXX 1ST STREET DES MOINES, IA 50309

P. 515-309-XXXX F. 515-309-XXXX Structural Engineer

Contractor Name XXX 1ST STREET DES MOINES, IA 50309 P. 515-309-XXXX F. 515-309-XXXX

Mechanical Engineer Contractor Name XXX 1ST STREET DES MOINES, IA 50309 P. 515-309-XXXX F. 515-309-XXXX

Electrical Engineer Contractor Name XXX 1ST STREET DES MOINES, IA 50309 P. 515-309-XXXX F. 515-309-XXXX

Key Plan

Revision Description

16 17

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(SOLID FILL) -INDICATES EXIT FACE NTED (ARROWS) -ÌNDICATEŚ CHEVRON ED DIRECTION

ES AIMING DICATE AIMING

	NE	W WORK KEY	
		- EXISTING	
		- NEW / REVISED	
		EXISTING EQUIPMENT	
		NEW / REVISED EQUIPMENT	
	LIGHTING	G/SWITCHING KEY	
		LIGHTING	
XTURE ER SCH		LIGHTING CONTROLS OF SEQUENCE (0,1,2,) PER SHEETS SWITCHING	

CIRCUIT NUMBER (XXXX-###) OR CIRCUIT NOTE (E-#)

NL: NIGHT LIGHT COORDINATE CEILING MOUNTED DEVICES WITH ARCHITECTURAL REFLECTED CEILING PLAN SWITCHING

#X(x,x) - LIGHTING CONTROL STATION

CONTROL STATION CONFIGURATION DETAIL

x) - INDICATES SWITCHING ZONE(S)

- INDICATES SWITCH CONTROLS, REFER TO LIGHTING

+##" - DIMENSION INDICATES HEIGHT TO CENTER OF SWITCH ABOVE FINISH FLOOR (+46" TO CENTER IF NOT SHOWN)

EM: EMERGENCY FIXTURE

XXXX ##x

OPN Project No. 22608000

Sheet Issue Date

05/30/17

Sheet Name SECOND FLOOR LIGHTING PLAN Sheet Number

PRELIMINARY. NOT FOR CONSTRUCTION.

REDROCK SALOON CODE ANALYSIS

PERMIT SET

DRAWING SHEET INDEX:

ARCHITECT OF RECORD:

OPN ARCHITECTS

GENERAL

AG001 COVER, DRAWING SHEET INDEX, CODE SUMMARY


ARCHITECTURAL

A101

1ST LEVEL FLOOR PLAN & SECTIONAL ELEVATION

CODE PLAN - 1ST LEVEL

NTS

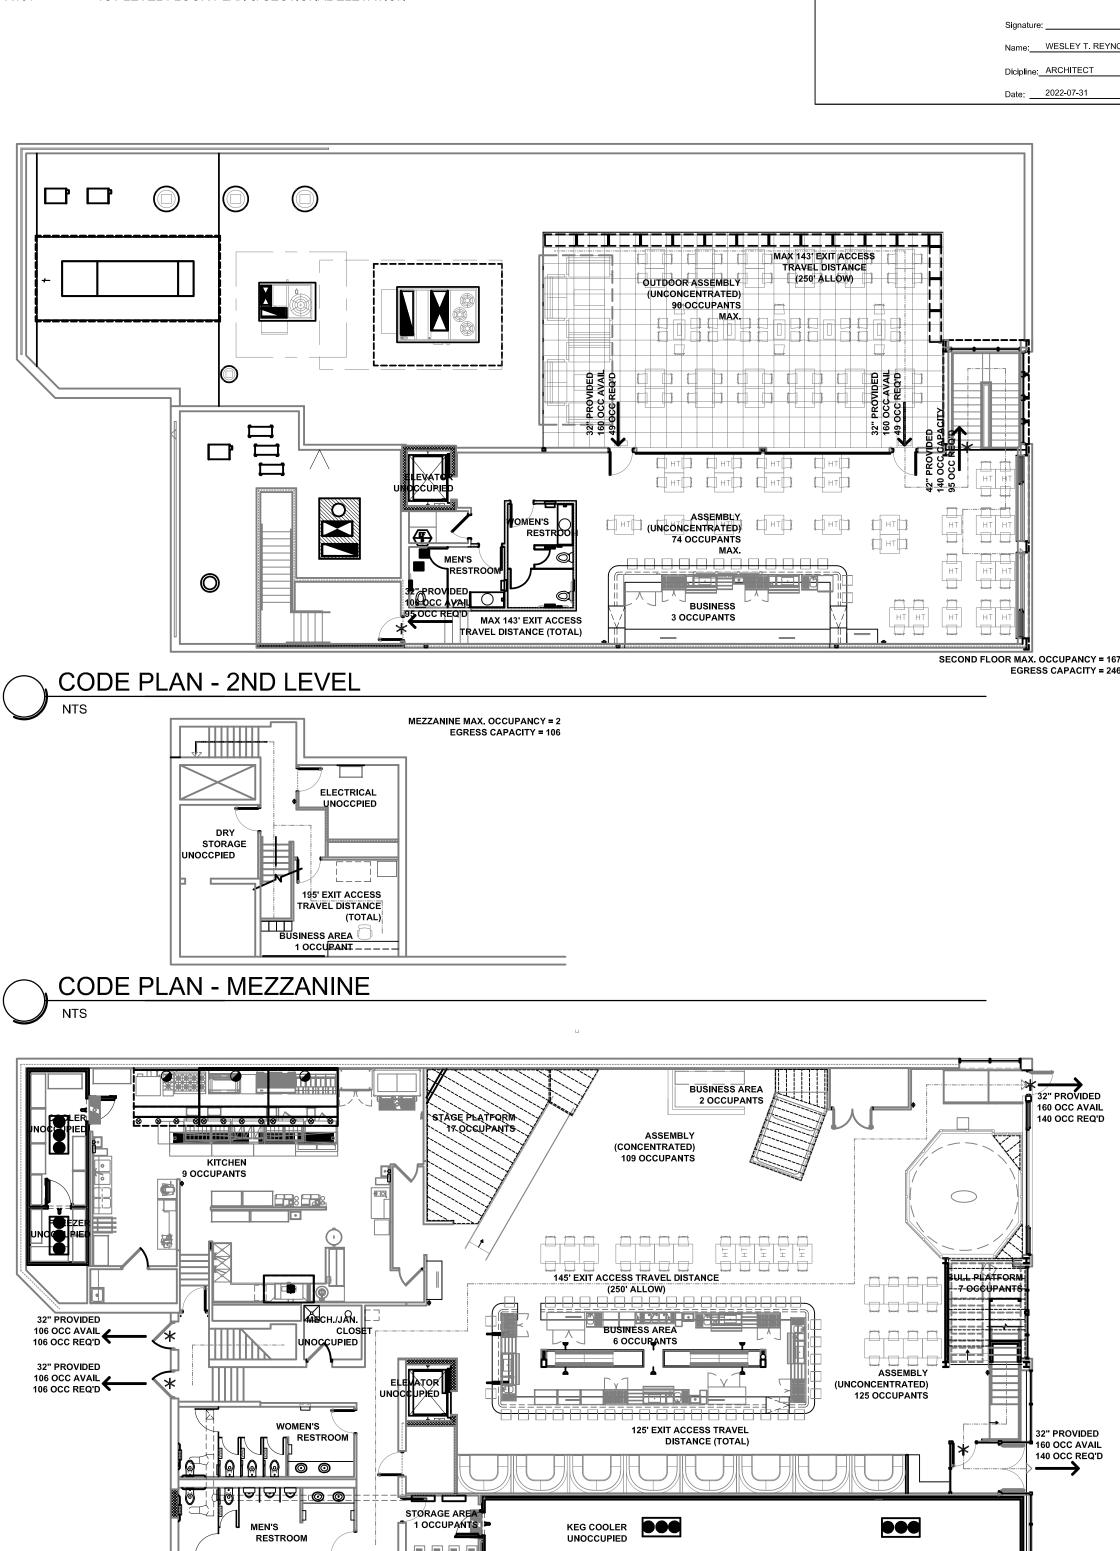


Dicipline ARCHITECT


PROJECT DESCRIPTION This project consists of remodeling of second flor restrooms and adding an outdoor roof terrace to the existing Redrock Saloon eating and entertainment facility. I hereby certify these plans and specifications APPLICABLE CODES were prepared by me or under my direct personal WISCONSIN COMMERCIAL BUILDING CODE- Wisconsin Department of Safety and supervision and that I am a duly Registered Professional Services (SPS) Chapters 361 to 366, incorporating: Architect under the laws of the State of Wisconsin. • International Building Code (IBC) 2015 • International Energy Conservation Code (IECC) 2015 • International Existing Building Code (IEBC) 2015 • International Fuel Gas Code (IFGC) 2015 Name WESLEY T REYNOLDS • International Mechanical Code (IMC) 2015 • Adopted portions of the International Fire Code (IFC) 2015 _ Registration # 11709-5 • ICC/ANSI A117.1 (2009): Standard for Accessibility and Usable Buildings and Facilities SPS Chapters 380-387; Plumbing City of Madison Municipal Code CODE REVIEW SUMMARY - OCCUPANCY CLASSIFICATION, A-2 ASSEMBLY & B BUSINESS CONSTRUCTION CLASSIFICATION: TYPE IIA (Assumed/Existing) FULLY SPRINKLERED PER NFPA 13 OCCUPANCY LOAD FACTOR (per chapter 10): 452 occupants (Total) MIN NUMBER OF EXITS: 360>49 = 2 EXITS REQUIRED IBC CHAPTER 6: Types of Construction Existing Construction Type IIA (no change proposed) Existing Building is Fully Sprinklered Per NFPA 13. IBC CHAPTER 7: Fire and Smoke Protection Features Requirements: The fire-resistance ratings of structural members and assemblies shall comply with this section and the requirements for the type of construction as specified in Table 601. The fire-resistance ratings shall not be less than the ratings required for the fire-resistance-rated assemblies supported by the structural members. IBC CHAPTER 10: Means of Egress 1004 Occupant Load The occupant load of the remodeled area has been calculated based on the following, per Table 1004.1.2 First Floor: Occupants: Assembly (Unconcentrated): 1/15 nsf 2,580 sf = 172 Assembly (Standing Concentrated): 1/5 nsf 302 sf = 61 1/100 gsf 600 sf = Business: 1/200 qsf 1,720 sf = Kitchen: Storage: 1/300 gsf 85 sf = EGRESS CAPACITY = 246 Stages/Platforms: 1/15 nsf 403 SF = Subtotal: 276 Maximum Occupants Mezzanine: 1/100 gsf 97sf = Business: Storage: 1/300 gsf 250 sf = Second Floor Assembly (Indoor) (Unconcentrated): 1/15 nsf 1,099 sf 74 Assembly (Outdoor) (Unconcentrated): 1/15 nsf 1,338 sf 90 1/100 gsf 276 sf Business: Subtotal: 167 Maximum Occupants Total: 445 occupants 1005 Egress Width 1005.1 Total width of means of egress in inches shall not be less than the total occupant load served by the means of egress multiplied by 0.3 inch per occupant for stairways and by 0.2 inch (5.08 mm) per occupant for other egress components. The width shall not be less than specified elsewhere in this code. Multiple means of egress shall be sized such that the loss of any one means of egress shall not reduce the available capacity to less than 50 percent of the required capacity. Refer to Code Plans at left for egress capacities. 1016 Exist Access Travel Distance 1016.1 Per Table 1016.1, An Occupancy with sprinkler system allows a maximum of 250' Travel Distance. 32" PROVIDED 160 OCC AVAIL IBC CHAPTER 11: Accessibility 140 OCC REQ'D 1103.2.2 Employee work areas. Spaces and elements within employee work areas shall only be required to comply with Sections 907.5.2.3.2, 1007 and 1104.3.1 and shall be designed and constructed so that individuals with disabilities can approach, enter and exit the work area. Work areas, or portions of work areas, other than raised courtroom stations in accordance with Section 1108.4.1.4, that are less than 300 square feet (30 m) in area and located 7inches (178 mm) or more above or below the ground or finished floor where the change in elevation is essential to the function of the space shall be exempt from all requirements. 1104.3.1 Employee work areas. Common use circulation paths within employee work areas shall be accessible routes. Exceptions: 1. Common use circulation paths, located within employee work areas that are less than 1,000 square feet (93 m) in size and defined by permanently installed partitions, counters, casework or furnishings, shall not be required to be accessible routes. **IBC CHAPTER 29: PLUMBING SYSTEMS** Table 2902.1 Minimum Number of Required Plumbing Fixtures NO. WC Required Provided LAV Required Provided DRINKING SERVICE FOUNTAINS SINKS OCCUPANTS MEN 1:500** 223 1:40 7* 1:75 3 6 3 32" PROVIDED 6 1:75 WOMEN 223 1:40 6 3 3 160 OCC AVAIL 140 OCC REQ'D * 3 WC and 4 Urinals Provided. ** Service Sink provided in Kitchen Area. SECOND FLOOR MAX. OCCUPANCY = 167

CODE REVIEW

+ MEZZANINE OCCUPANTS = 2 + FIRST FLOOR OCCUPANTS = 276 TOTAL OCCUPANTS = 44 EGRESS CAPACITY = 532

5 / 15 / 2022

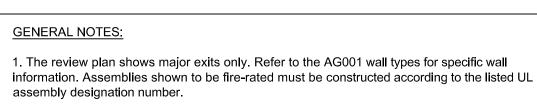

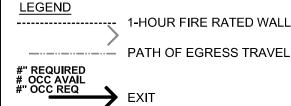


Seating Shown:

125

70

1

1-HOUR FIRE RATED WALL

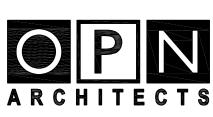

CEDAR RAPIDS • DES MOINES • MADISON

OPN ARCHITECTS, INC. 301 N. BROOM ST., SUITE 100 MADISON, WI 53703 608/819-0260 PHONE www.opnarchitects.com opn@opnarchitects.com

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Building Owner Urban Land Interests

10 East Doty Street, Suite 300 Madison, WI 53703

Architect of Record **OPN ARCHITECTS** 301 N. Broom Street, Suite 100 Madison, WI 53703

Project

REDROCK SALOON CODE ANALYSIS 222 West Gorham Street Madison, WI 53703

OCCUPANCY REVIEW 04/01/2022

FOR REVIEW

Issue & Revision Dates

Drawing COVER, DRAWING SHEET INDEX, CODE SUMMARY

OPN Project No. 22608000



TARGETTI LA1, LA2, LB

JEDI COMPACT IP67 INTEGRAL

Linear LED Projector with Integral Driver

Concept: Powerful adjustable linear LED projector.

Materials: Extruded anodized aluminum 15µ body. 5mm thick extra-clear flat glass. The body of the fixture is adjustable and can be installed away from the mounting surface using accessory snap brackets.

^AFixture suitable for use in marine grade environments.

Optic: Internal optical system composed of a primary cylindrical glass lens, a high reflectance anodized aluminum reflector and an integrated holographic filter. Available in three versions: Spot, Flood, Grazing and Wall Washer.

Source: High Power High Efficiency LED board.

Mounting: Multiple stainless steel mounting brackets available for fixture rotation and mounting, specified separately.

Driver: Integral electronic driver with non dimmable and 0-10V dimmable versions.

Installation: To be completed with stainless steel adjustable brackets, see page 2. Pre-wired with SJ00W 18-3 cable and input/output watertight IP68 Quick Disconnect connectors. Lead and Solo configurations provided with 10ft lead cable. See page 3 for inline connection configurations.

Wattage: 28W / 40W / 53W

Color Temperature: 2700K / 3000K / 3500K / 4000K

CRI: Ra84, Ra90 available upon request

Without Louver	22.68" (28W)	33.70" (40W)	44.73" (53W)
Spot 12° =	2371 - 2744Lm	3557 - 4116Lm	4743 - 5489Lm
Wall Washer $59^{\circ} \times 115^{\circ} =$	2428 - 2706Lm	3643 - 4061Lm	4858 - 5414Lm
Wall Grazer 15° × 76° =	2684 - 2991Lm	4026 - 4487Lm	5385 - 5983Lm
Flood 32° × 85°	2413 - 2690Lm	3620 - 4035Lm	4827 - 5380Lm
With Louver	22.68" (28W)	33.70" (40W)	44.73" (53W)
With Louver Wall Washer 59° × 115° =	. ,	33.70" (40W) 2747 - 3062Lm	44.73" (53W) 3663 - 4082Lm
	1831 - 2041Lm		. ,
Wall Washer 59° x 115° =	1831 - 2041Lm 1712 - 1908Lm	2747 - 3062Lm	3663 - 4082Lm

Refer to pages 4-9 for complete fixture data information.

Lumen Maintenance (L70): 50,000hrs

Calculation for LED fixtures are based on measurements that comply with IES LM-80.

Voltage: Universal Voltage 120-277V AC 50/60Hz

Weight: 5lbs (22.68"), 7.5lbs (3370"), 10lbs (44.73")

IK: IK08

IP Rating: IP67

Certifications: cULus listed Wet Location Listed

Tested in accordance with LM-79-08


Warranty: 5 year limited warranty

^ANot to be in direct contact with salt for extended periods of time or used with corrosive agents.






Integrated Louver Option Integrated anti-glare louver option pre-installed inside the fixture.

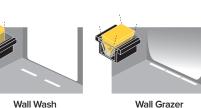



Flood


LENGTH MOUNTING PRODUCT CODE TYPE LOCATION INTEGRAL DRIVER OPTICS COLOR TEMP CABLE LOUVER OPTION **24** - 22.68" **27** - 2700K Required JE — JEDI C – Compact O – Outdoor IP67 10 – 0-10V SP — Spot 12° L1 — Lead LV³- Integrated (See Pg 2) Louver Option Wall Wash ND - Non-Dimming ww -**36** - 33.70" **30** - 3000K C1 - Center 59°x115° Wall Grazer **48** - 44.73" **35** - 3500K WG -E¹ - End 15°x76° Flood **40** - 4000K FL _ Solo 32°x85° Permapost P² -Mount Cable ¹ See Page 3 for inline cable configurations ² To be used with Permapost mounting only, see Page 4 for installation details

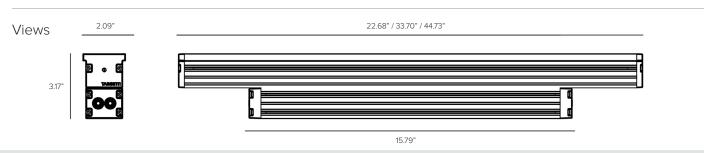

τΛRGEΤΤΙ

JEDI COMPACT IP67 INTEGRAL

INSTALLATION ACCESSORIES (REQUIRED)					
1E3304 Short bracket kit for surface installation (set of two).					
1E3306 Long bracket kit for surface installation (set of two).					
JECOPP24	Aluminum Permapost with long mounting bracket (set of two), Deep Black finish. Demensions: 24"L x 2"Dia.				

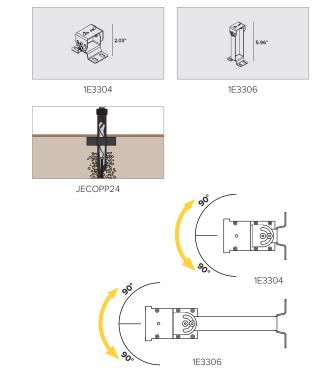


JEDI COMPACT IP67 INTEGRAL

Standard Connection Cable Configurations

CABLE OPTION	DESCRIPTION
L — Lead	10ft lead cable with IP68 female connector. Inline lead fixture with 1ea IP68 male connector and 1ea IP68 female connector.
C — Center	Inline center fixture with 1ea IP68 male connector and 1ea IP68 female connector. Included with outdoor jumper cable.
E — End	Inline end fixture with 1ea IP68 male connector. Included with outdoor jumper cable.
S — Solo	10ft lead cable with IP68 female connector. Solo fixture with 1ea IP68 male connector.
P — Perma-Post	2ft cable supplied on both ends of fixture, no connectors attached for Perma-post mounting configuration. To be used with Perma-post installation accessory only. See page 4 for installation diagram.


NOTE: (2) cables provided for 0-10V dimmable versions.

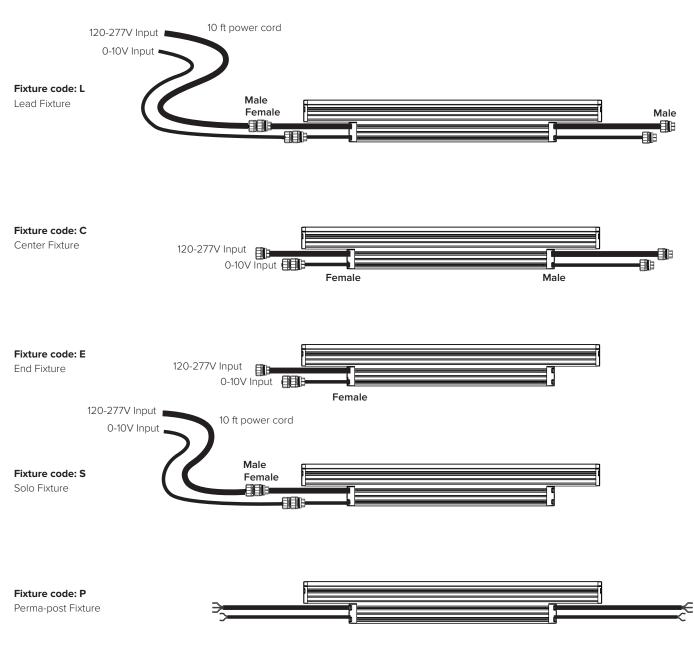


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JEDI COMPACT IP67 INTEGRAL

PERMAPOST INSTALLATION DIAGRAM



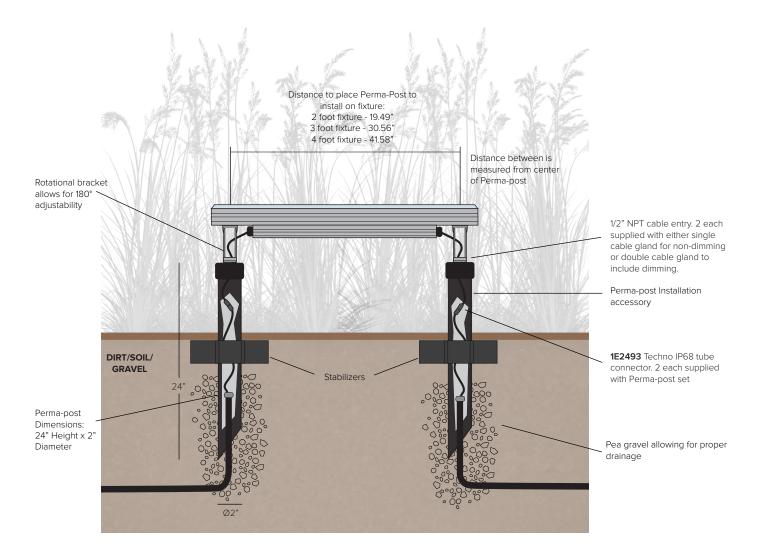

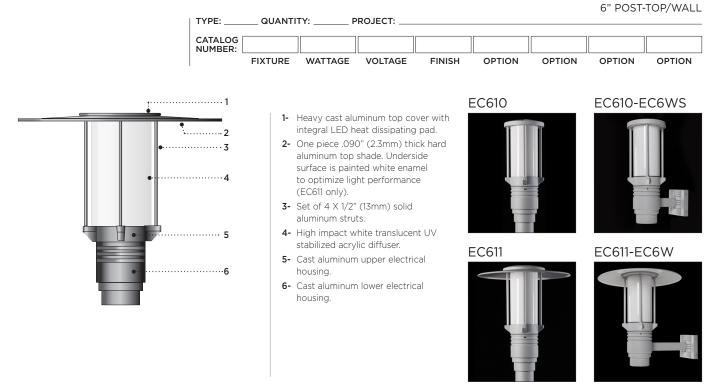

MATERIALS

Eclipse Mini is made of corrosion resistant 356 aluminum alloy with a copper (CU) content of less than 0.1%.

Light source is enclosed in a high impact white translucent UV stabilized acrylic sealed diffuser.

The lower cast aluminum housing fits with a 4" or 5" (102mm or 127mm) pole and contains all electrical controls on a removable tray.

ELECTRICAL

LED

DRIVER Standard driver is 0-10V dimming-ready (dims to 10%) with: 120-277 multi-volt compatibility (50-60Hz), optional 347V on request, minimum operating temperature of -30°C/-22°F, output over voltage protection, output over current protection, output short circuit protection with auto-recovery, and over temperature protection (110°C).

LED Standard 4000K/80CRI. Optional 2700K, 3000K and 3500K. Removable modular LED platform.

LIFE

60,000hrs $L_{g6}B_{s0}$ (based on IESNA TM-21 Test Method and LM-80 data). 139,000hrs $L_{\gamma0}B_{s0}$ (calculated projection from LM-80 data).

FINISH

Five-stage preparation process includes preheating of cast aluminum parts for air extraction. Polyester powder coating is applied through an electrostatic process, and oven cured for long term finish.

MOUNTING

Maximum weight: 16 lbs (7 kg)

Standard luminaire mounts on a 4" or 5" (102mm or 127mm) pole. Alternate wall and pole attachments are proposed with high quality components to meet multiple installation conditions.

CERTIFICATION

Tested to UL1598 and CSA 22.2 #250. cULus listed wet location. Photometric testing performed by an independent laboratory in accordance with IES LM-79-08 standards at 25°C. Lumen depreciation in accordance with IESNA LM80 standards. Rated IP65.



EPA: 0.86

(508mm) 22" (564mm) EC611

20"

LC


ECLIPSE MINI - LED

EC610/EC611 SERIES

EPA: 0.92

LUMINIS.COM

TYPICAL PHOTOMETRY SUMMARY

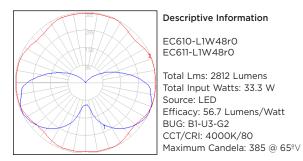

Please visit our web site www.luminis.com for complete I.E.S. formatted download data.

LUMINAIRE SELECTION

MODEL#	LED LIGHT SELECTION (4000K/80CRI)			VOL	LTAGE 1	FINISH
	SUFFIX	INPUT WATTS	DELIVERED LUMENS			STANDARD COLORS
EC610	□ L1W18r1 □ L1W30r1 □ L1W48r0	15W 24W 33W	1163 2011 2812	□ : Op	120V 277V ptional 347V	 WHT Snow white BKT Jet black BZT Bronze MST Matte silver GRT Titanium gray DGT Gun metal CHT Champagne SGT Steel gray BGT English cream OPTIONAL COLORS CS Custom color RAL RAL# color

OPTIONS

ELECTRICA	L	MOUNTING		ACCESSORIES				
□ FS	Fuse ²	□ AC6 □ 2AC6	Pole mount attachment with 45° support Double pole mount attachments with 45° support	🗆 HS6	House side shield			
□ PH □ 347L	Photocell ² 347V input power driver		at 180°	CONTROL				
LIGHT		□ AW6 □ EC6P	Wall mount attachment with 45° support Pole mount attachment with arm	□ NLTAIR2	nLight AIR Control gen2, Pole mounted black			
Alternate	CCT ºK LED (LCF: Lumen conversion	□ 2EC6P □ EC6W	Double pole mount attachment with arms at 180° Wall mount attachment with arm		sensor. ^{5, 6, 7}			
	Apply multiplier to listed values for utput reference).		Pole mount attachment with short arm (EC610 only) Double pole mount attachment with short arms at					
□ K27 □ K3	2700K CCT 80 CRI (LCF: 0.91) 3000K CCT 80 CRI (LCF: 0.94)		180° (EC610 only) Wall mount attachment with short arm (EC610 only)					
□ K35	3500K CCT 80 CRI (LCF: 0.98)	ECM5T						
	ther CCT & higher CRI available, onsult factory.	□ TN3 □ PR6	3" Tenon pole adaptor ³ Pedestal mount adaptor					

NOTES

If no voltage is specified, luminaires are factory prewired by default for 120V. For other voltages, please specify with catalog number, or consult factory.
 Fuse and photocell options are normally installed with poles when specified with Luminis luminaires. (Except for other types of mounting.)
 3" tenon pole adaptor only required for 3" O.D. poles by others.

- 4- For 1/8" wall thickness. For other wall thickness contact factory.
 5- Not compatible with PH, Wall mounts, Double Pole Mounts, TN3, PR6.
- 6-Only available with PAA5xx (Ø5" poles).
- 7-White sensor available upon request.





LUMINIS | Toll free: 866.586.4647 Fax: 514.683.8872 Email: info@luminis.com 260 Labrosse, Pointe-Claire (QC) Canada H9R 5L5

Luminaires may be altered for design improvement or discontinued without prior notice.


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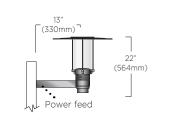
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EC610/EC611 SERIES ECLIPSE MINI - LED


POLE MOUNT




1" X 2" (25mm X 51mm) extruded aluminum extended arm pole mounting adaptor designed to fit with Ø 4" poles. Ø 1/2" X 45° standard natural stainless steel rod support. (EPA: 0.7)

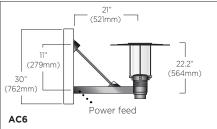


EC6P (Applicable for EC610 and EC611) 1" X 2" (25mm X 51mm) extruded aluminum side pole straight mounting. Pole mounting adaptor fits with Ø 4" poles. (EPA: 0.97)

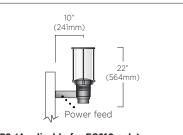

EC6PS (Applicable for EC610 only) 1" X 2" (25mm X 51mm) extruded aluminum side pole straight mounting. Pole mounting adaptor fits with Ø 4" poles. (EPA: 0.72)

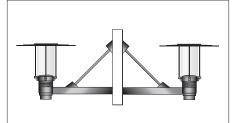

2AC6 Double pole mount attachments with 45° support at 180°

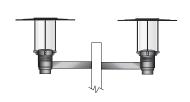


2EC6P

Double pole mount attachment with arms at 180°



2EC6PS Double pole mount attachment with short arms at 180° (EC610 only)

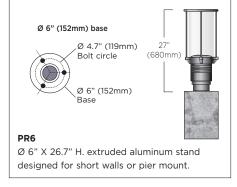



ECM4T To be installed on Ø 4" (102mm) pole



ECM5T To be installed on Ø 5" (127mm) pole. For 1/8" wall thickness. For other wall thickness contact factory.



NLTAIR2 🛜 Control gen2, Pole mounted black sensor. 270° coverage. Installed at 180° from hand hole. Only available with PAA5xx (Ø5" poles).




LUMINIS | Toll free: 866.586.4647 Fax: 514.683.8872 Email: info@luminis.com 260 Labrosse, Pointe-Claire (QC) Canada H9R 5L5 \sim

Rev.

LUMINIS.COM

Luminaires may be altered for design improvement or discontinued without prior notice.

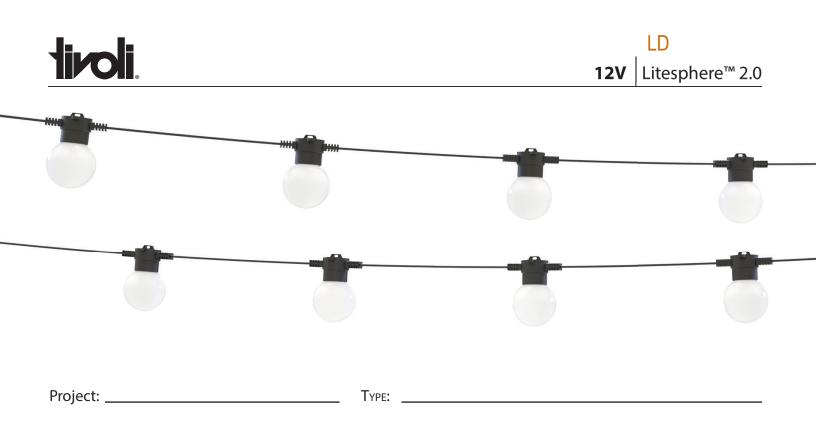


Product Features

- Tivoli's next evolution of Litesphere delivers a robust specification-grade strand with factory molded standard spacing for consistent quality from start to finish
- Litesphere 2.0 design provides optional suspended mounting or a twist-off cap for surface applications
- 12V DC Low voltage system for long runs
- IP67
- cULus
- 3 Year warranty


Dimensions



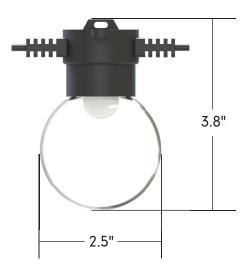



System Configuration Example

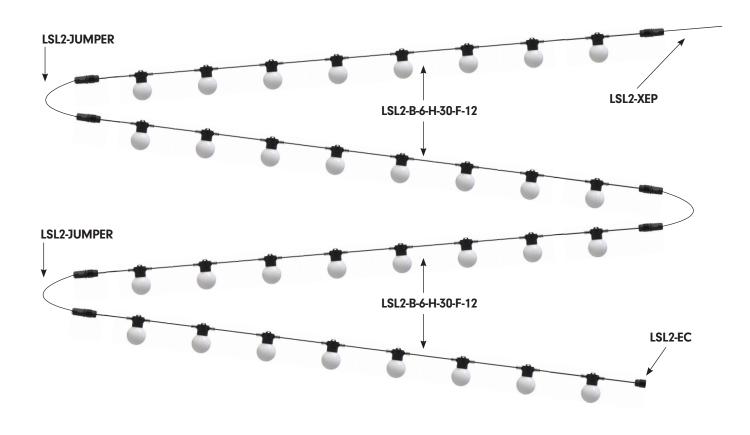

Strand Order Guide

Note: For suspension application, a catenary cable is required for proper installation. Please contact Tivoli for recommendations on unique mounting applications.

*Available in VHO LED only

Product Wire			/ire		Spacing			LED Type				l	LED Color			Globe			Voltage
LSL2 -				-].] _]-].		
Litesphere 2.0		В	Black		06	6″ OC	_		۷	Very High Output	-	19	1900K	_	С	Clear	_	12	12V DC
		w	White		12	12″ OC			н	High Output		27	2700K		F	Frosted			
					18	18″ OC			S	Standard Output		30	3000K		0	Opal			
					24	24″ OC						35	3500K						
												40	4000K						
												50	5000K*						
												AM	Amber*						
												RB	Royal Blue*						
												RD	Red*						
												GN	Green*						
												YL	Yellow*						



Power Lead Order Guide

Figure A - All Litesphere 2.0 are evenly cut between globes according to specified spacing. Figure B - Power leads are added to the end cut, extending the total length of the power lead.

LSL2-XEP-X-XX

X = B (Black), W (White)
 XX = 05 (5'), 10 (10'), 15 (15'), 20 (20'), 25 (25')
 For custom length consult factory

Figure A

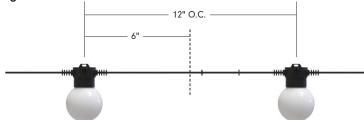


Figure B

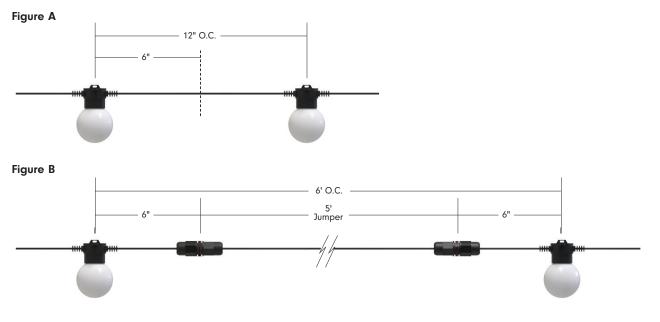




Figure A - All Litesphere 2.0 are evenly cut between globes according to specified spacing. Figure B - Jumpers are added between the cuts, extending the total length of wire between globes.

LSL2-JUMPER-X-XX

X = B (Black), W (White) **XX** = 05 (5'), 10 (10') For custom length, consult factory





Mounting Options

SURFACE/FLUSH

For surface mount applications, remove the top suspension-plate by turning counter-clockwise until off. Place socket flush against the desired surface and mount using proper screws according to substrate.



SUSPENDED

Suspended mounting will use a combination of LS-Cable, LS-Locks with LS-UVZP. Tension the cable wire with our LS-TT (Tension Tool) for desired sag (Please adhere to local city code for suspended application).

Note: For suspension application, a catenary cable is required for proper installation. Please contact Tivoli for recommendations on unique mounting applications.



Mounting Accessories



LS-CABLE-60 Catenary Cable Kit - 60' (1/8" galvanized cable includes 2 cable locks for use with loads up to 200lbs)

LS-CABLE-110 Catenary Cable Kit - 110' (1/8" galvanized cable includes 2 cable locks for use with loads up to 200lbs)

LS-CABLE-500 Catenary Cable Kit - 500' (1/8" galvanized cable for use with loads up to 200lbs)



LS-UVZP-XX-50 X = BK (Black), WH (White) 50 pc Bag set. UV resistant, heavy duty ties. Maximum weight up to 100 lbs./per tie.



LS-LOCK-4 Cable Lock for 1/8th inch cable, Heavy-duty lockable fasteners support loads up to 200 lbs. Can be easily adjusted without the use of tools. Includes (2) Locks, (1) cable release key.



LS-TT Catenary Cable Tensioning Tool up to 880lbs with minimal effort due to the 6:1 gear drive mechanism. Integral torque gauge controls the load applied to the wire, giving consistent tension every time and optimizing the life of the wire.




LS-UVZP-XX-30 X = BK (Black), WH (White) 30 pc Bag set. UV resistant, heavy duty ties. Maximum weight up to 100 lbs./per tie.




Light Shades



HAT

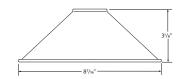

SHADE-HT-BK-BK-8 Light Shade - HAT 8.3" Black Top, Black Bottom Weight: 0.38 lb

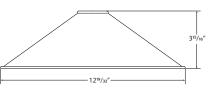

SHADE-HT-BK-BK-13* Light Shade - HAT 12.6"Black Top, Black Bottom Weight: 1.06 lb SHADE-HT-BK-CO-13 *

Light Shade - HAT 12.6" Black Top, Copper Bottom Weight: 1.06 lb

*Consult factory for lead time and MOQ







SHADE-DS-BK-BK-10 Light Shade - DISH 10.2" Black Top, Black Bottom Weight: 0.72 lb

FLOWER



213/32 Q13/16

SHADE-FL-BK-BK-10 Light Shade - FLOWER 9.8" Light Shade , Black Top, Black Bottom Weight: 0.54 lb

1313/16

SHADE-FL-BK-BK-13 Light Shade - FLOWER 13.8" Light Shade, Black Top, Black Bottom Weight: 1.1 lb

Accessories

SHADE-ADP-LSL2-XX-01 2.0 Light Shade Adapter **X** = BK (Black), WH (White) PVC Black Adapter - Sold individually.

SHADE-ADP-LSL2-XX-25 2.0 Light Shade Adapter

X = BK (Black), WH (White) PVC Black Adapter Kit - Sold in packs of 25

SHADE-ADP-LSL2-XX-50 2.0 Light Shade Adapter

X = BK (Black), WH (White) PVC Black Adapter Kit - Sold in packs of 50

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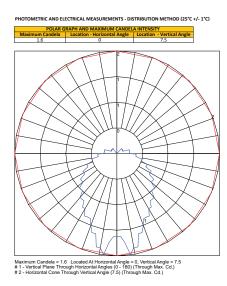
sold each

Replacement Parts Very High Output Standard & High Output **HIGH OUTPUT** LST-CG LST-OG LSL-19-V-12 LSL-AM-V-12 **STANDARD** 12V Wedge base 12V Wedge base LSL-19-S-12 LSL-19-H-12 Litesphere 2.0 Litesphere 2.0 12V Wedge base 12V Wedge base Clear globe Opal globe 1900K Amber LSL-27-V-12 LSL-RD-V-12 sold each sold each 1900K 1900K LSL-27-S-12 12V Wedge base 12V Wedge base LSL-27-H-12 12V Wedge base 2700K 12V Wedge base Red LSL-30-V-12 LSL-RB-V-12 2700K 2700K 12V Wedge base LSL-30-S-12 LSL-30-H-12 12V Wedge base 3000K **Royal Blue** 12V Wedge base 12V Wedge base LSL-35-V-12 LSL-GN-V-12 3000K 3000K LSL-35-S-12 12V Wedge base 12V Wedge base LSL-35-H-12 3500K Green 12V Wedge base 12V Wedge base LSL-40-V-12 LSL-YL-V-12 3500K 3500K LSL-40-S-12 LSL-40-H-12 12V Wedge base 12V Wedge base 4000K 12V Wedge base 12V Wedge base Yellow LSL-50-V-12 4000K 4000K LST-FG LSL2-EC-X 12V Wedge base Litesphere 2.0 X = B (black), W (white) 5000K Frosted globe Litesphere 2.0 End-Cap sold each Weight: 0.0375 lb


Photometrics

Frosted Globe - Based on 3000K LED


Standard Brightness



High Output

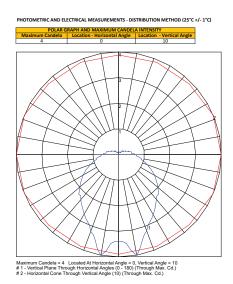

Very High Output

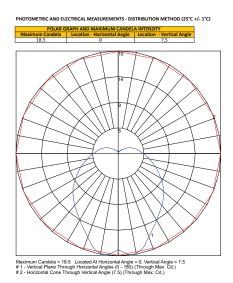



Controls



TVOQ-1-WH WH (White only) 512 DMX channel, 16 scene, 4 zone, glass touch screen



TVOQ-10-XX-7 XX = BK (Black), WH (White) 1024 DMX channel, 500 scene, 10 zone, glass touch screen



TVOQ-2-XX XX = BK (Black), WH (White) 512 DMX channel, 99 scene, 1 zone, glass touch screen



RWI

Wet Location Thermoplastic LED Exit Sign



COMMENTS:

PROJECT:

DATE:



FEATURES

- Suitable for NEMA 4X applications
- Super-bright, long-life LEDs
- Quick-connect components
- Snap-on canopy for easy installation
- Nickel cadmium battery provides a minimum of 90 minute minimum operation
- Sealed External Momentary test switch and dual diagnostic LED indicator displays AC presence and Hi-Charge status
- Self-Test / Self-Diagnostic monitoring available
- Low voltage cut-off prevents battery damage and ensures positive charge acceptance following an extended discharge
- Line-latch prevents unnecessary discharge of battery during installation. Loads will not illuminate until after application of utility power
- 120/277 VAC field-selectable inputs (with the exception of the C1/C2 (dual circuit) option which requires voltage specification upon ordering)

ORDERING INFORMATION RWL-AC-G-1-BK-MTEBP

1. SERIES	2. OPERATION	3. ILLUMINATION	4. FACE COUNT				
RWL		-	-	5. FRAME COLOR			
	AC AC Only EM Ni-Cad Battery Backup	G Green R Red	1 Single 2 Double	- BK Black GY Gray WH White			
6. MOUNTING MTEBP	7. OPTIONS -						
MTEBP Universal Mount	BLANK = NO OPTION C1 Dual Circuit - 120 VAC (AC C2 Dual Circuit - 277 VAC (AC						

ORDERING NOTES

1. This dual circuit option should only be used for exits which are intended to be connected simultaneously to normal and emergency power circuits, but cannot support two hot inputs. Only one of the normal or emergency circuits can be powered at any given time. Energizing both normal and emergency circuits simultaneously will result in damage to the exit sign.

ACCESSORIES; ORDER SEPARATELY

- WG 2 = Wire guard 14.0" X 10.0" X 4.5"
- WG 3 = Wire guard 14.5" X 6.0" X 10.5"
- WG 10 = Wire guard 13.5" X 12.0" X 16.5"

isolite

RWL Wet Location Thermoplastic LED Exit Sign



CONSTRUCTION

- UV Stabilized Polycarbonate housing
- Stainless steel captive screws secure lens cover to housing

ELECTRICAL

Input Power: 3.4W Max

LETTERS

• 6.0" high; 0.75" stroke

ARROWS

• NFPA-Type, field selectable chevrons

TEMPERATURE RATING

From -4°F to 122°F

APPROVALS

- UL 924 Listed for Wet Location
- NFPA Life Safety Code 101
- NFPA 70- NEC
- OSHA

WARRANTY

Isolite offers a 3-year limited warranty.
 For further details, refer to General
 Warranty and Obligations in the Isolite
 manual or on our website

DIMENSIONS

