

City of Madison Fire Department

314 W Dayton Street, Madison, WI 53703-2506

Phone: 608-266-4420 • Fax: 608-267-1100 • E-mail: fire@cityofmadison.com

Project Address: 519-547 West Washington Avenue	
Contact Name & Phone #: Kevin Burow (608) 836-3690	

FIRE APPARATUS ACCESS AND FIRE HYDRANT WORKSHEET

1. Is the building completely protected by an NFPA 13 or 13R automatic fire sprinkler system? If non-sprinklered, fire lanes extend to within 150-feet of all portions of the exterior wall? If sprinklered, fire lanes are within 250-feet of all portions of the exterior wall?	X Yes Yes Yes	No No X No	N/AN/AN/A
2. Is the fire lane constructed of concrete or asphalt, designed to support a minimum load of 85,000 lbs? a) Is the fire lane a minimum unobstructed width of at least 20-feet? b) Is the fire lane unobstructed with a vertical clearance of at least 13½-feet? c) Is the minimum inside turning radius of the fire lane at least 28-feet? d) Is the grade of the fire lane not more than a slope of 8%? e) Is the fire lane posted as fire lane? (Provide detail of signage.) f) Is a roll-able curb used as part of the fire lane? (Provide detail of curb.) g) Is part of a sidewalk used as part of the required fire lane? (Must support +85,000 lbs.)		No No No No No No No No	 N/A N/A N/A N/A N/A N/A N/A N/A N/A
3. Is the fire lane obstructed by security gates or barricades? If yes: a) Is the gate a minimum of 20-feet clear opening? b) Is an approved means of emergency operations installed, key vault, padlock or key switch?	☐ Yes ☐ Yes ☐ Yes	X No No No	N/A N/A N/A N/A
4. Is the Fire lane dead-ended with a length greater than 150-feet? If yes, does the area for turning around fire apparatus comply with IFC D103?	Yes Yes	X No No	N/A N/A
5. Is any portion of the building to be used for high-piled storage in accordance with IFC Chapter 3206.6 If yes, see IFC 3206.6 for further requirements.	Yes	X No	□ N/A
6. Is any part of the building greater than 30-feet above the grade plane?	X Yes	☐ No	N/A
If yes, answer the following questions: a) Is the aerial apparatus fire lane parallel to one entire side of the building and covering at least 25% of the perimeter? b) Is the near edge of the aerial apparatus fire lane between 15' and 30' from the building? c) Are there any overhead power or utility lines located across the aerial apparatus fire lane? d) Are there any tree canopies expected to grow across the aerial fire lane? (Based on mature canopy width of tree species) e) Does the aerial apparatus fire lane have a minimum unobstructed width of 26-feet?	X YesYesYesYesX Yes	No No No No No No	 N/A N/A N/A N/A N/A
If yes, answer the following questions: a) Is the aerial apparatus fire lane parallel to one entire side of the building and covering at least 25% of the perimeter? b) Is the near edge of the aerial apparatus fire lane between 15' and 30' from the building? c) Are there any overhead power or utility lines located across the aerial apparatus fire lane? d) Are there any tree canopies expected to grow across the aerial fire lane? (Based on mature canopy width of tree species) e) Does the aerial apparatus fire lane have a minimum unobstructed width of 26-feet? f) Is the space between the aerial lane and the building free of trees exceeding 20' in heights?	 X Yes Yes Yes Yes X Yes Yes 	No No No No No No No No No	 N/A N/A N/A N/A N/A N/A N/A
If yes, answer the following questions: a) Is the aerial apparatus fire lane parallel to one entire side of the building and covering at least 25% of the perimeter? b) Is the near edge of the aerial apparatus fire lane between 15' and 30' from the building? c) Are there any overhead power or utility lines located across the aerial apparatus fire lane? d) Are there any tree canopies expected to grow across the aerial fire lane? (Based on mature canopy width of tree species) e) Does the aerial apparatus fire lane have a minimum unobstructed width of 26-feet?	X YesYesYesYesX Yes	No No No No No No	 N/A N/A N/A N/A N/A

Attach an additional sheet if further explanation is required for any answers.

This worksheet is based on MGO 34.503 and IFC 2015 Edition Chapter 5 and Appendix D; please see the codes for further information.



Name: Stopple – W. Washington Development

Number: 2143

knothe bruce Address: 519 – 547 W. Washington Avenue

Exterior















Name: Stopple – W. Washington Development

Number: 2143


knothe bruce Address: 519 – 547 W. Washington Avenue









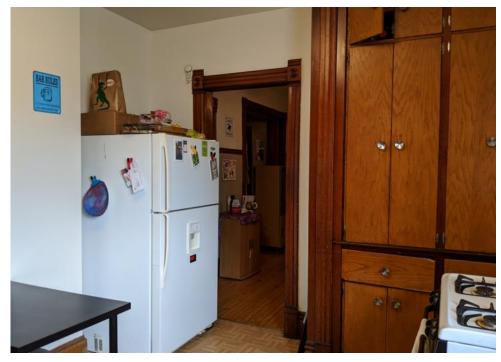





Name: Stopple – W. Washington Development

Number: 2143

knothe bruce Address: 519 – 547 W. Washington Avenue

521 – Unit 1
















Name: Stopple – W. Washington Development

Number: 2143

knothe bruce Address: 519 – 547 W. Washington Avenue

523 – Unit 2

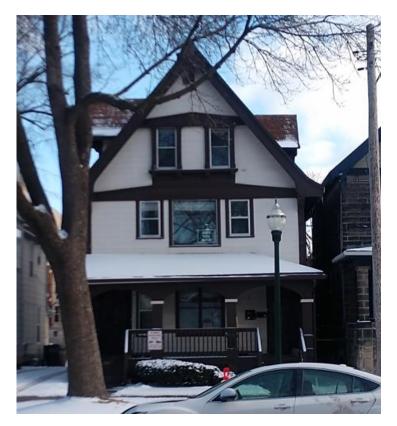














Name: Stopple – W. Washington Development


Number: 2143

knothe bruce Address: 519 – 547 W. Washington Avenue

523 – Unit 3

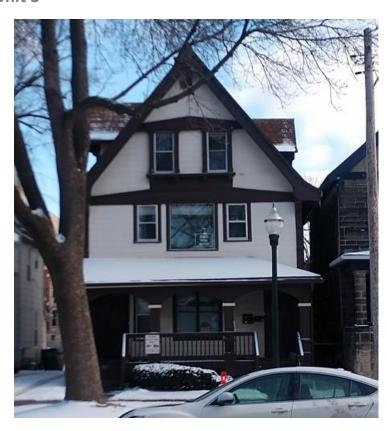



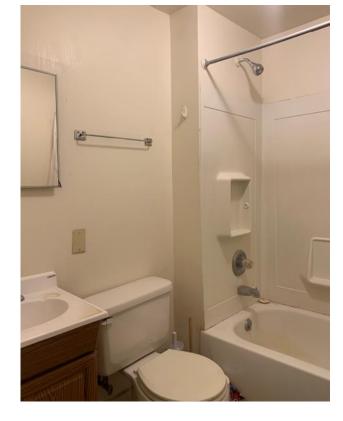









Name: Stopple – W. Washington Development

Number: 2143

knothe bruce Address: 519 – 547 W. Washington Avenue















Name: Stopple – W. Washington Development

Number: 2143

knothe bruce Address: 519 – 547 W. Washington Avenue

527-529



















Name: Stopple – W. Washington Development

Number: 2143

knothe bruce Address: 519 – 547 W. Washington Avenue















Name: Stopple – W. Washington Development

Number: 2143

knothe bruce Address: 519 – 547 W. Washington Avenue















Name: Stopple – W. Washington Development

Number: 2143

knothe bruce Address: 519 – 547 W. Washington Avenue















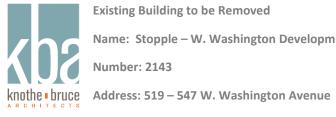

Name: Stopple – W. Washington Development

Number: 2143

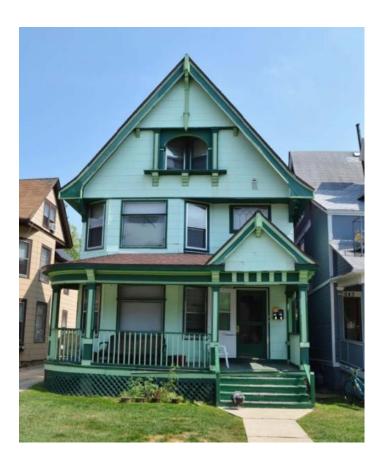













Name: Stopple – W. Washington Development

Number: 2143

knothe bruce Address: 519 – 547 W. Washington Avenue

543-547






















519-547 W Washington Ave MADISON, WI





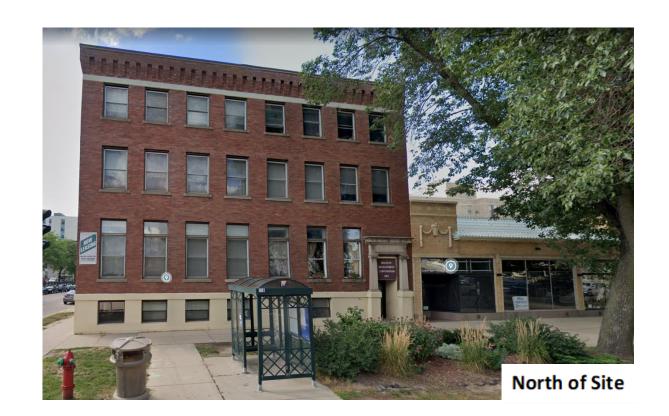







519-547 W Washington Ave MADISON, WI















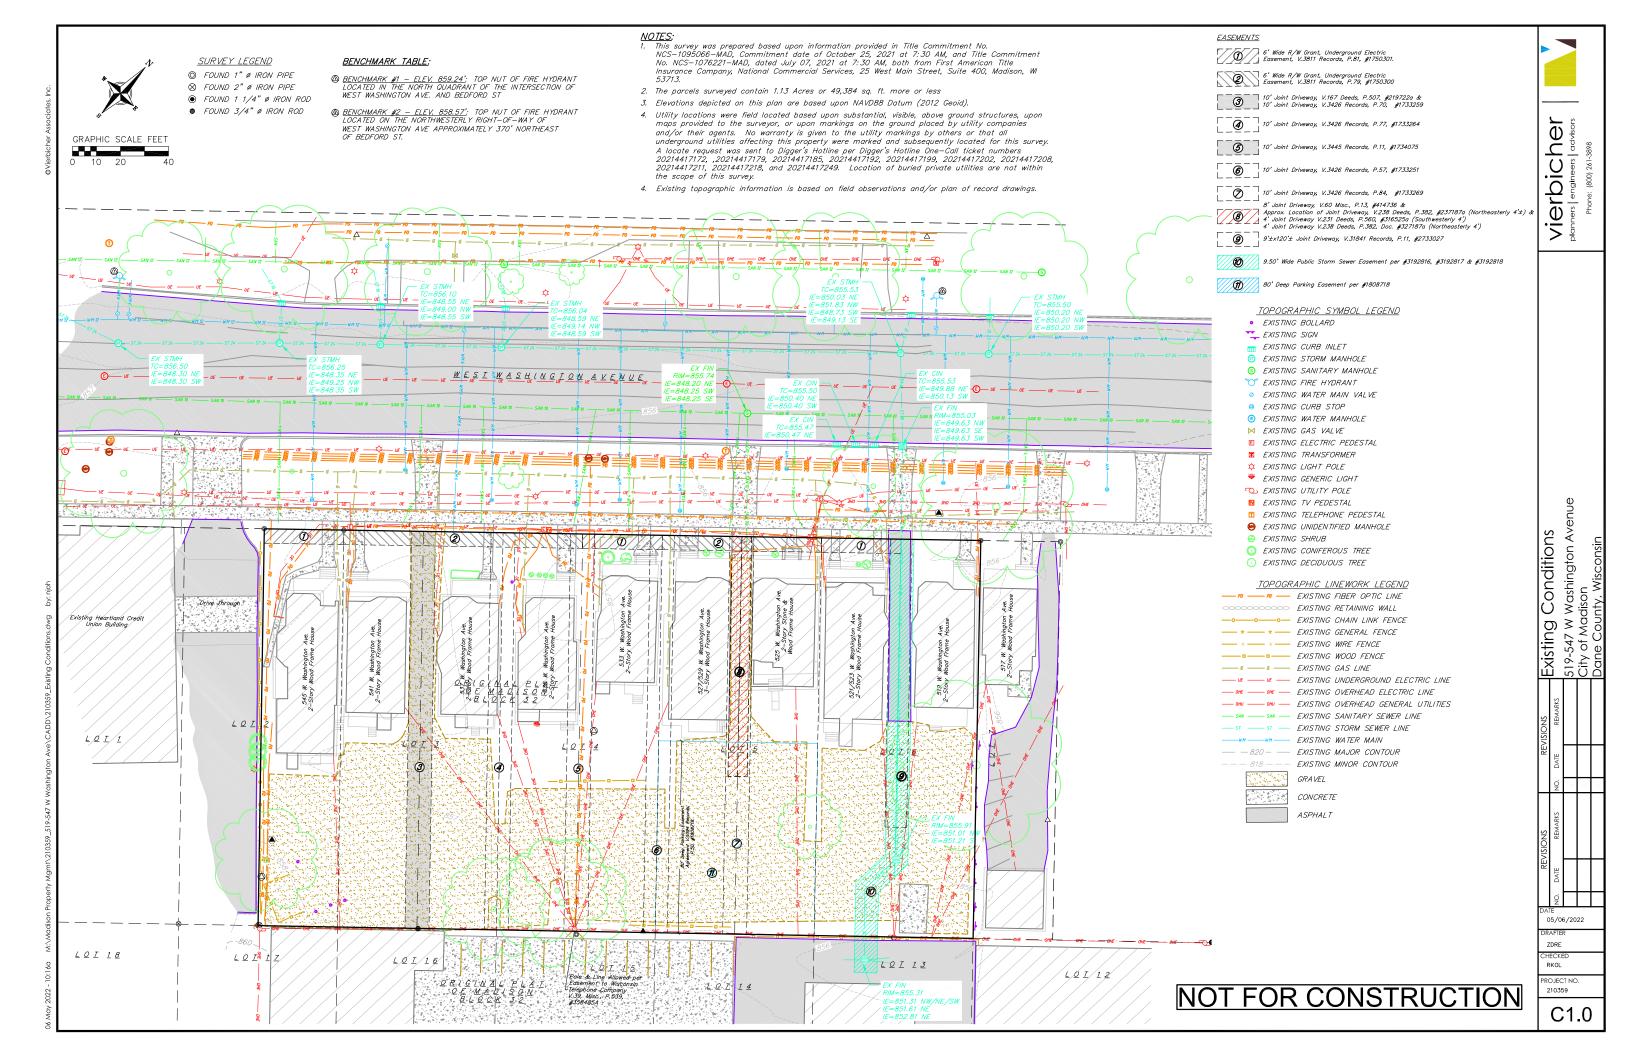

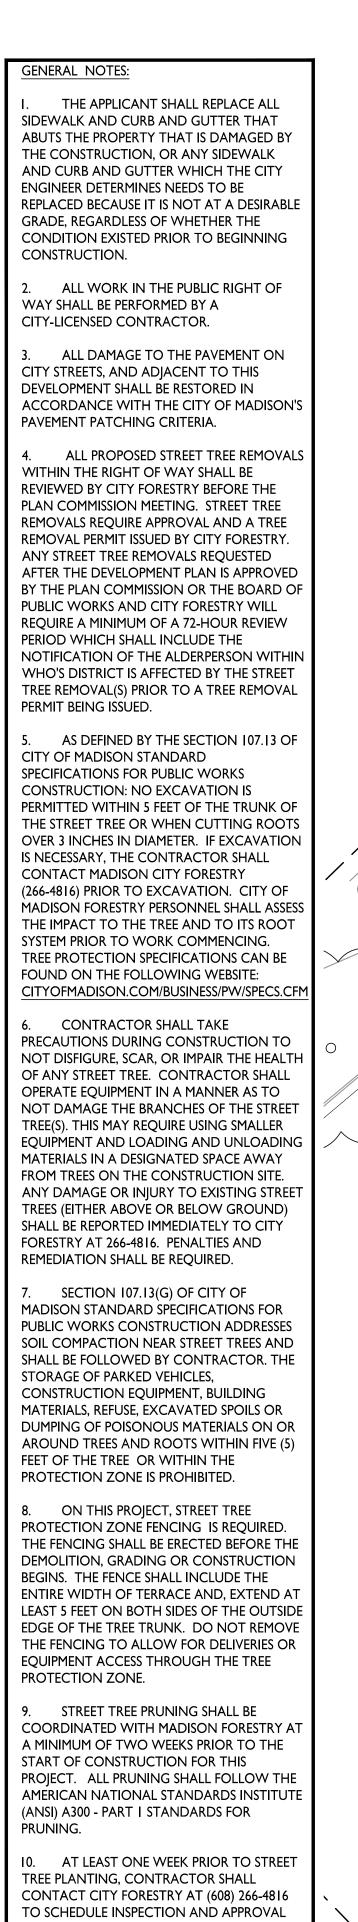


OF NURSERY TREE STOCK AND REVIEW PLANTING SPECIFICATIONS WITH THE

II. APPROVAL OF PLANS FOR THIS PROJECT DOES NOT INCLUDE ANY APPROVAL TO PRUNE, REMOVE, OR PLANT TREES IN THE PUBLIC RIGHT-OF-WAY. PERMISSION FOR SUCH ACTIVITIES MUST BE OBTAINED FROM THE CITY FORESTER (266-4816).

LANDSCAPER.

12. THE PUBLIC RIGHT-OF-WAY IS THE SOLE JURISDICTION OF THE CITY OF MADISON AND IS SUBJECT TO CHANGE AT ANY TIME. NO ITEMS SHOWN ON THIS SITE PLAN IN THE RIGHT-OF-WAY ARE PERMANENT AND MAY NEED TO BE REMOVED AT THE APPLICANTS EXPENSE UPON NOTIFICATION BY THE CITY.

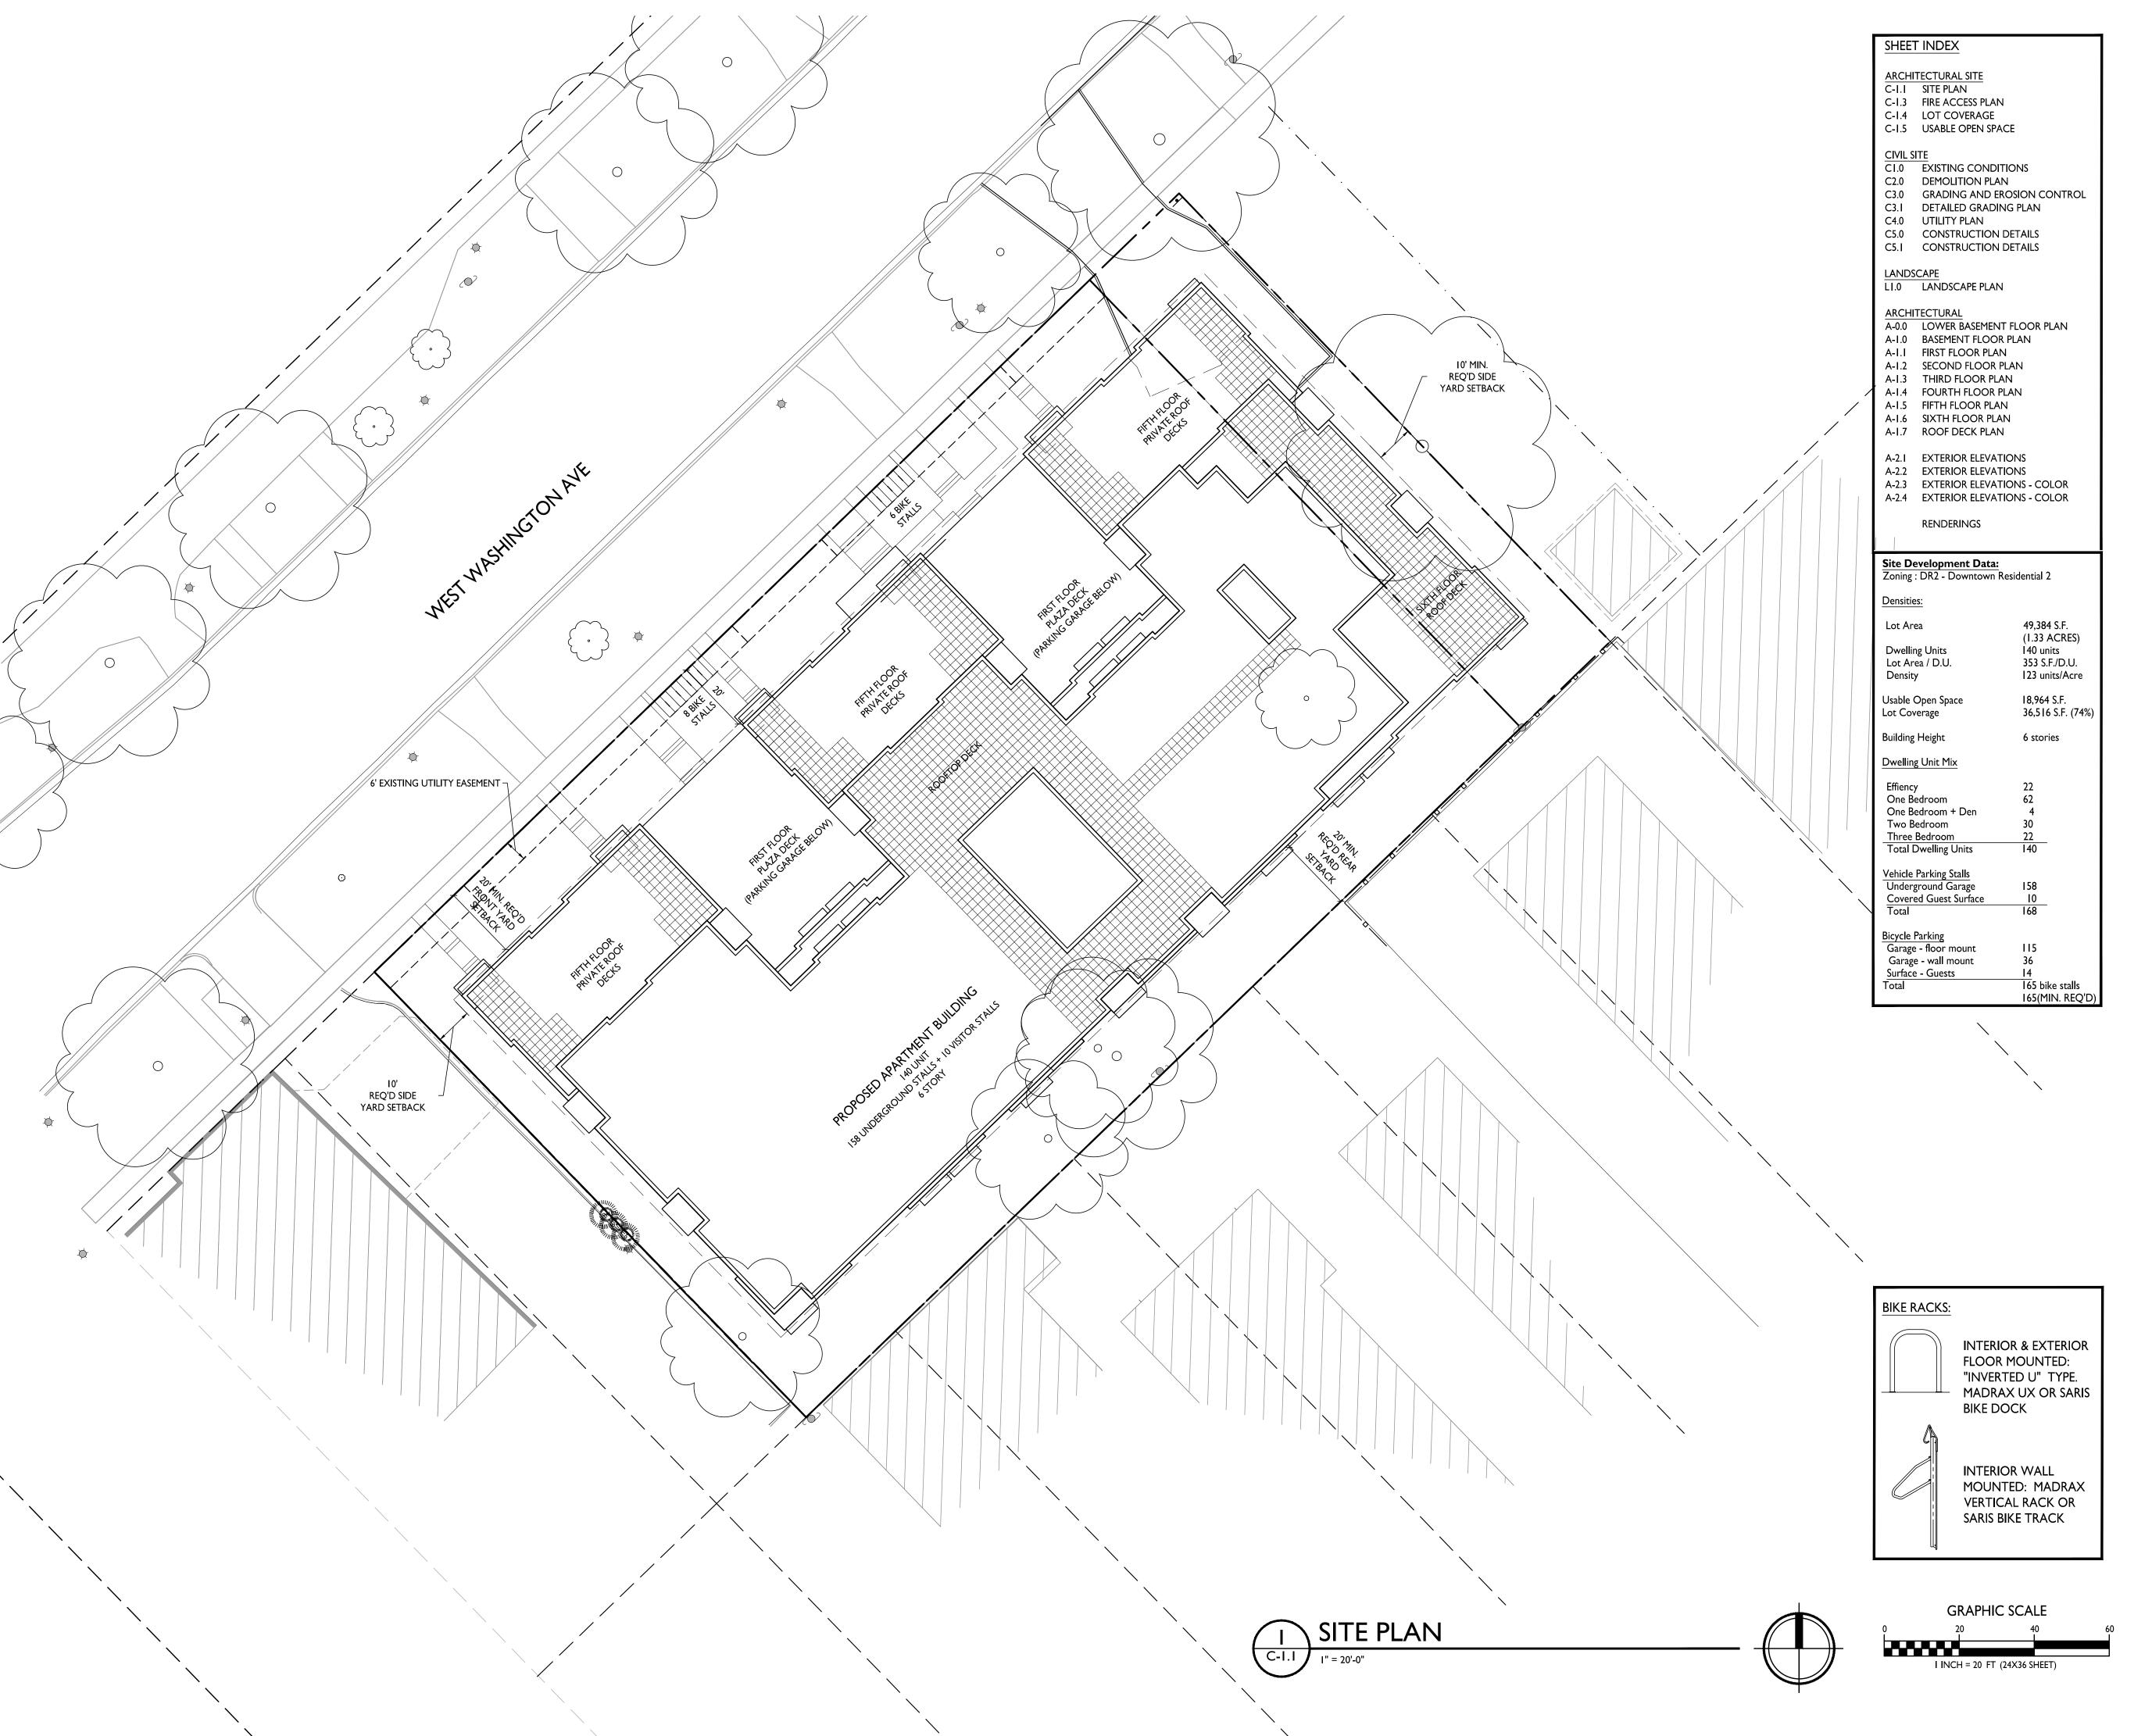



ISSUED

Issued for Review - January 10, 2022 Issued for LUA & UDC Submittal - Feb. 28, 2022 Revised - May 4, 2022

PROJECT TITLE West Washington Development

519-547 W Washington Ave.

Madison, Wisconsin


SHEET TITLE


Site Plan

SHEET NUMBER

PROJECT NO.

2143

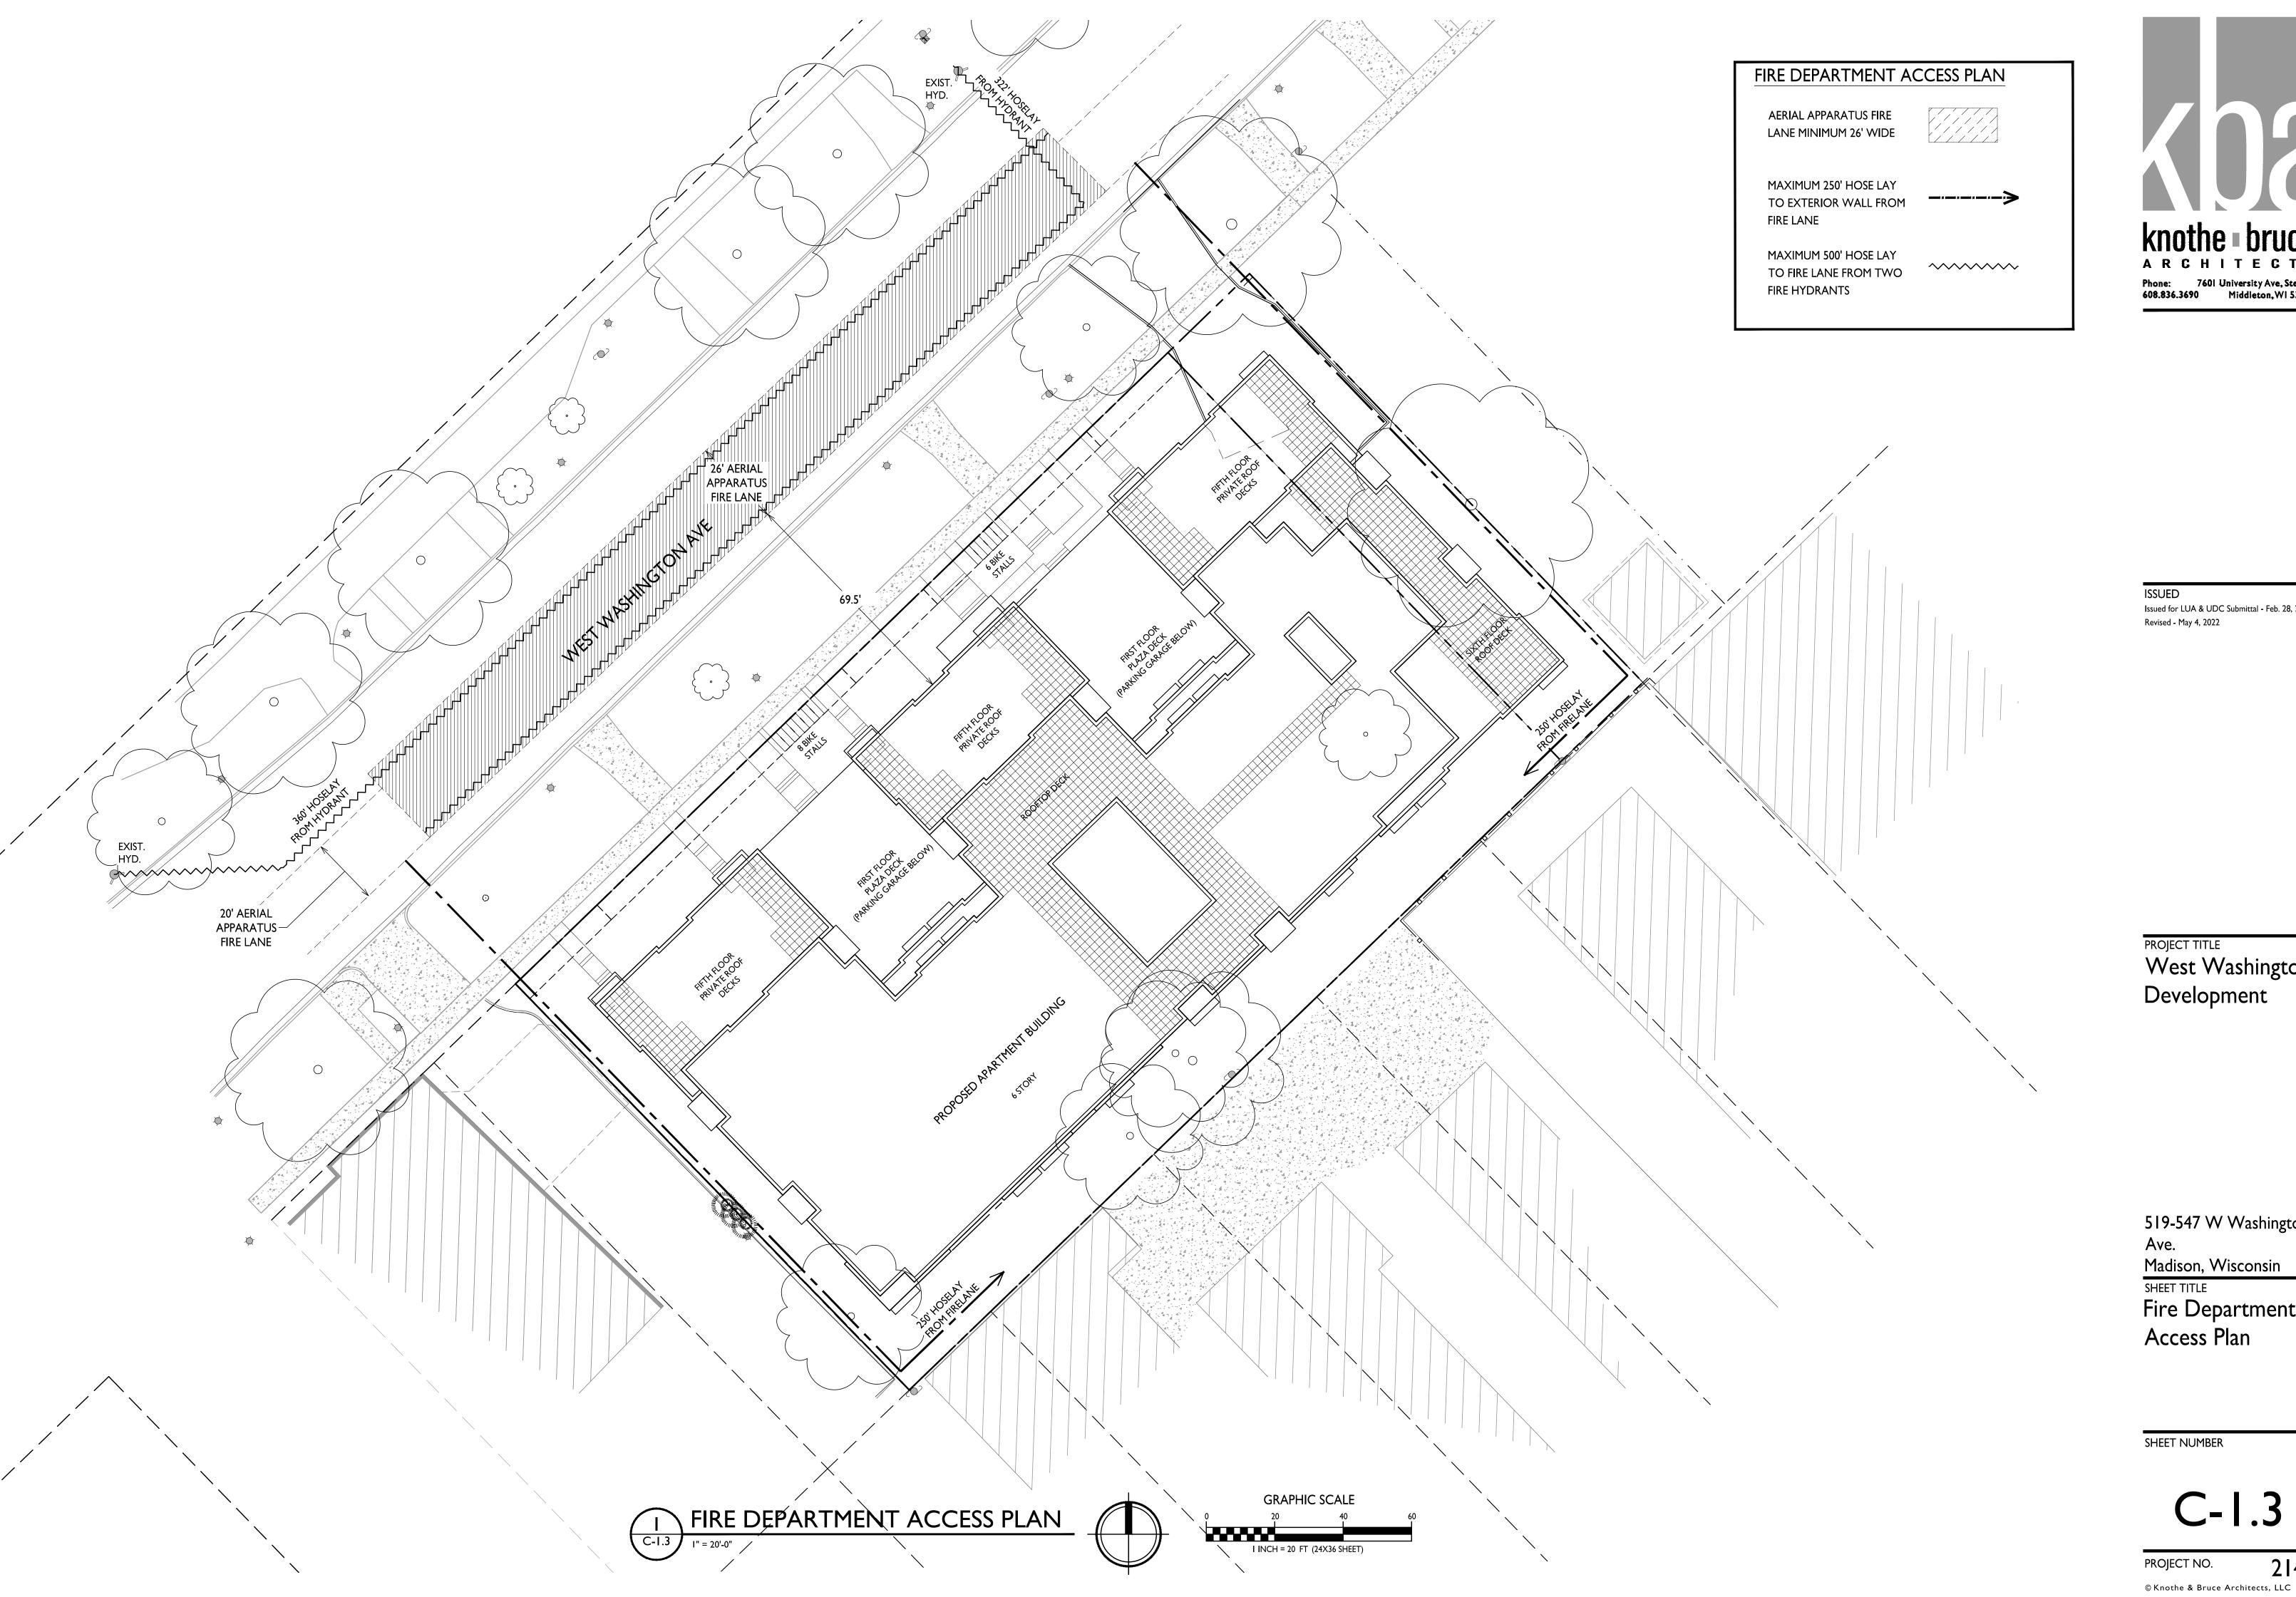

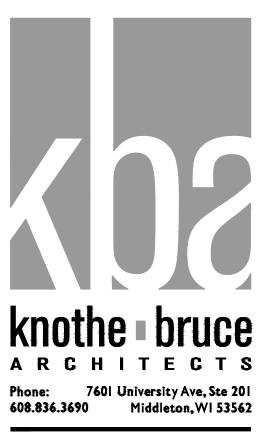

Issued for LUA & UDC Submittal - Feb. 28, 2022

PROJECT TITLE


West Washington


519-547 W Washington Ave.

Madison, Wisconsin

Fire Department

C-1.3

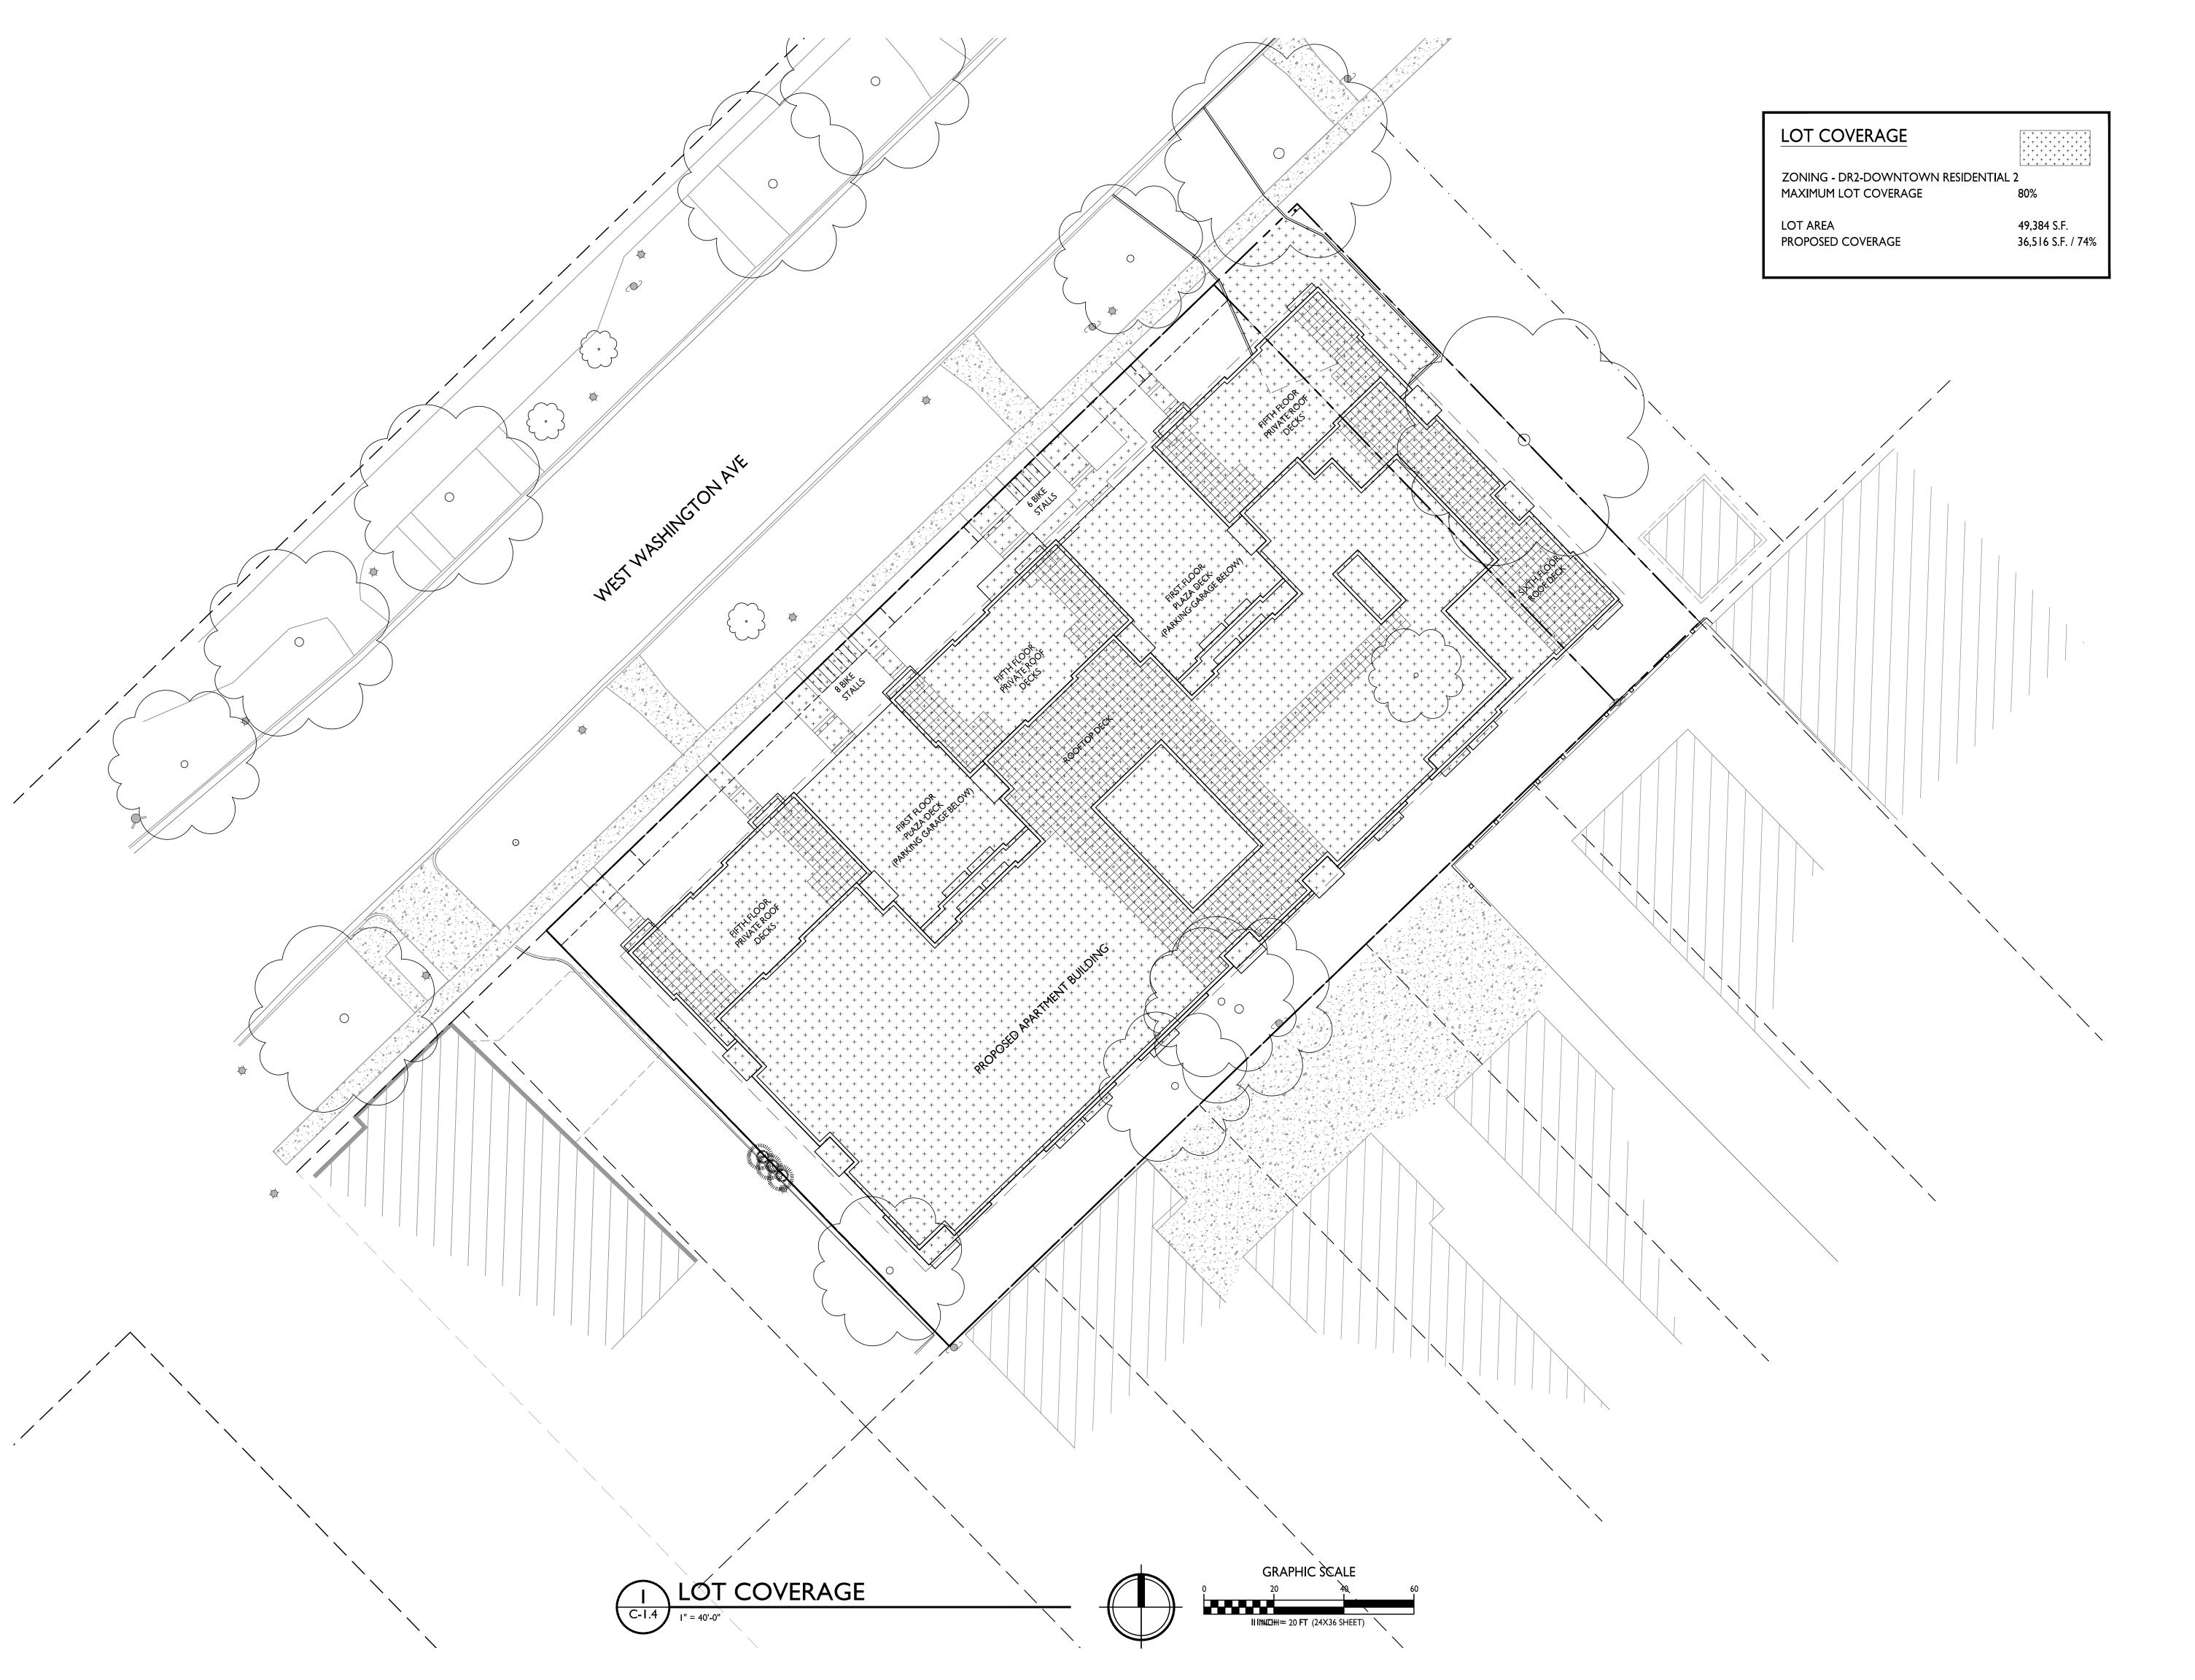

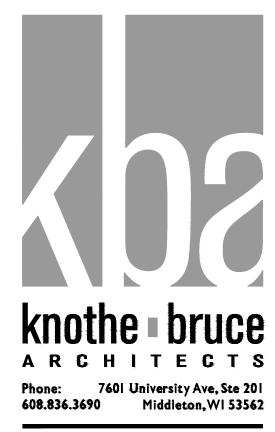

Issued for LUA & UDC Submittal - Feb. 28, 2022 Revised - May 4, 2022

PROJECT TITLE

West Washington Development

519-547 W Washington

Ave.

Madison, Wisconsin

SHEET TITLE


Lot Coverage

SHEET NUMBER

C-1.4

PROJECT NO.

2143

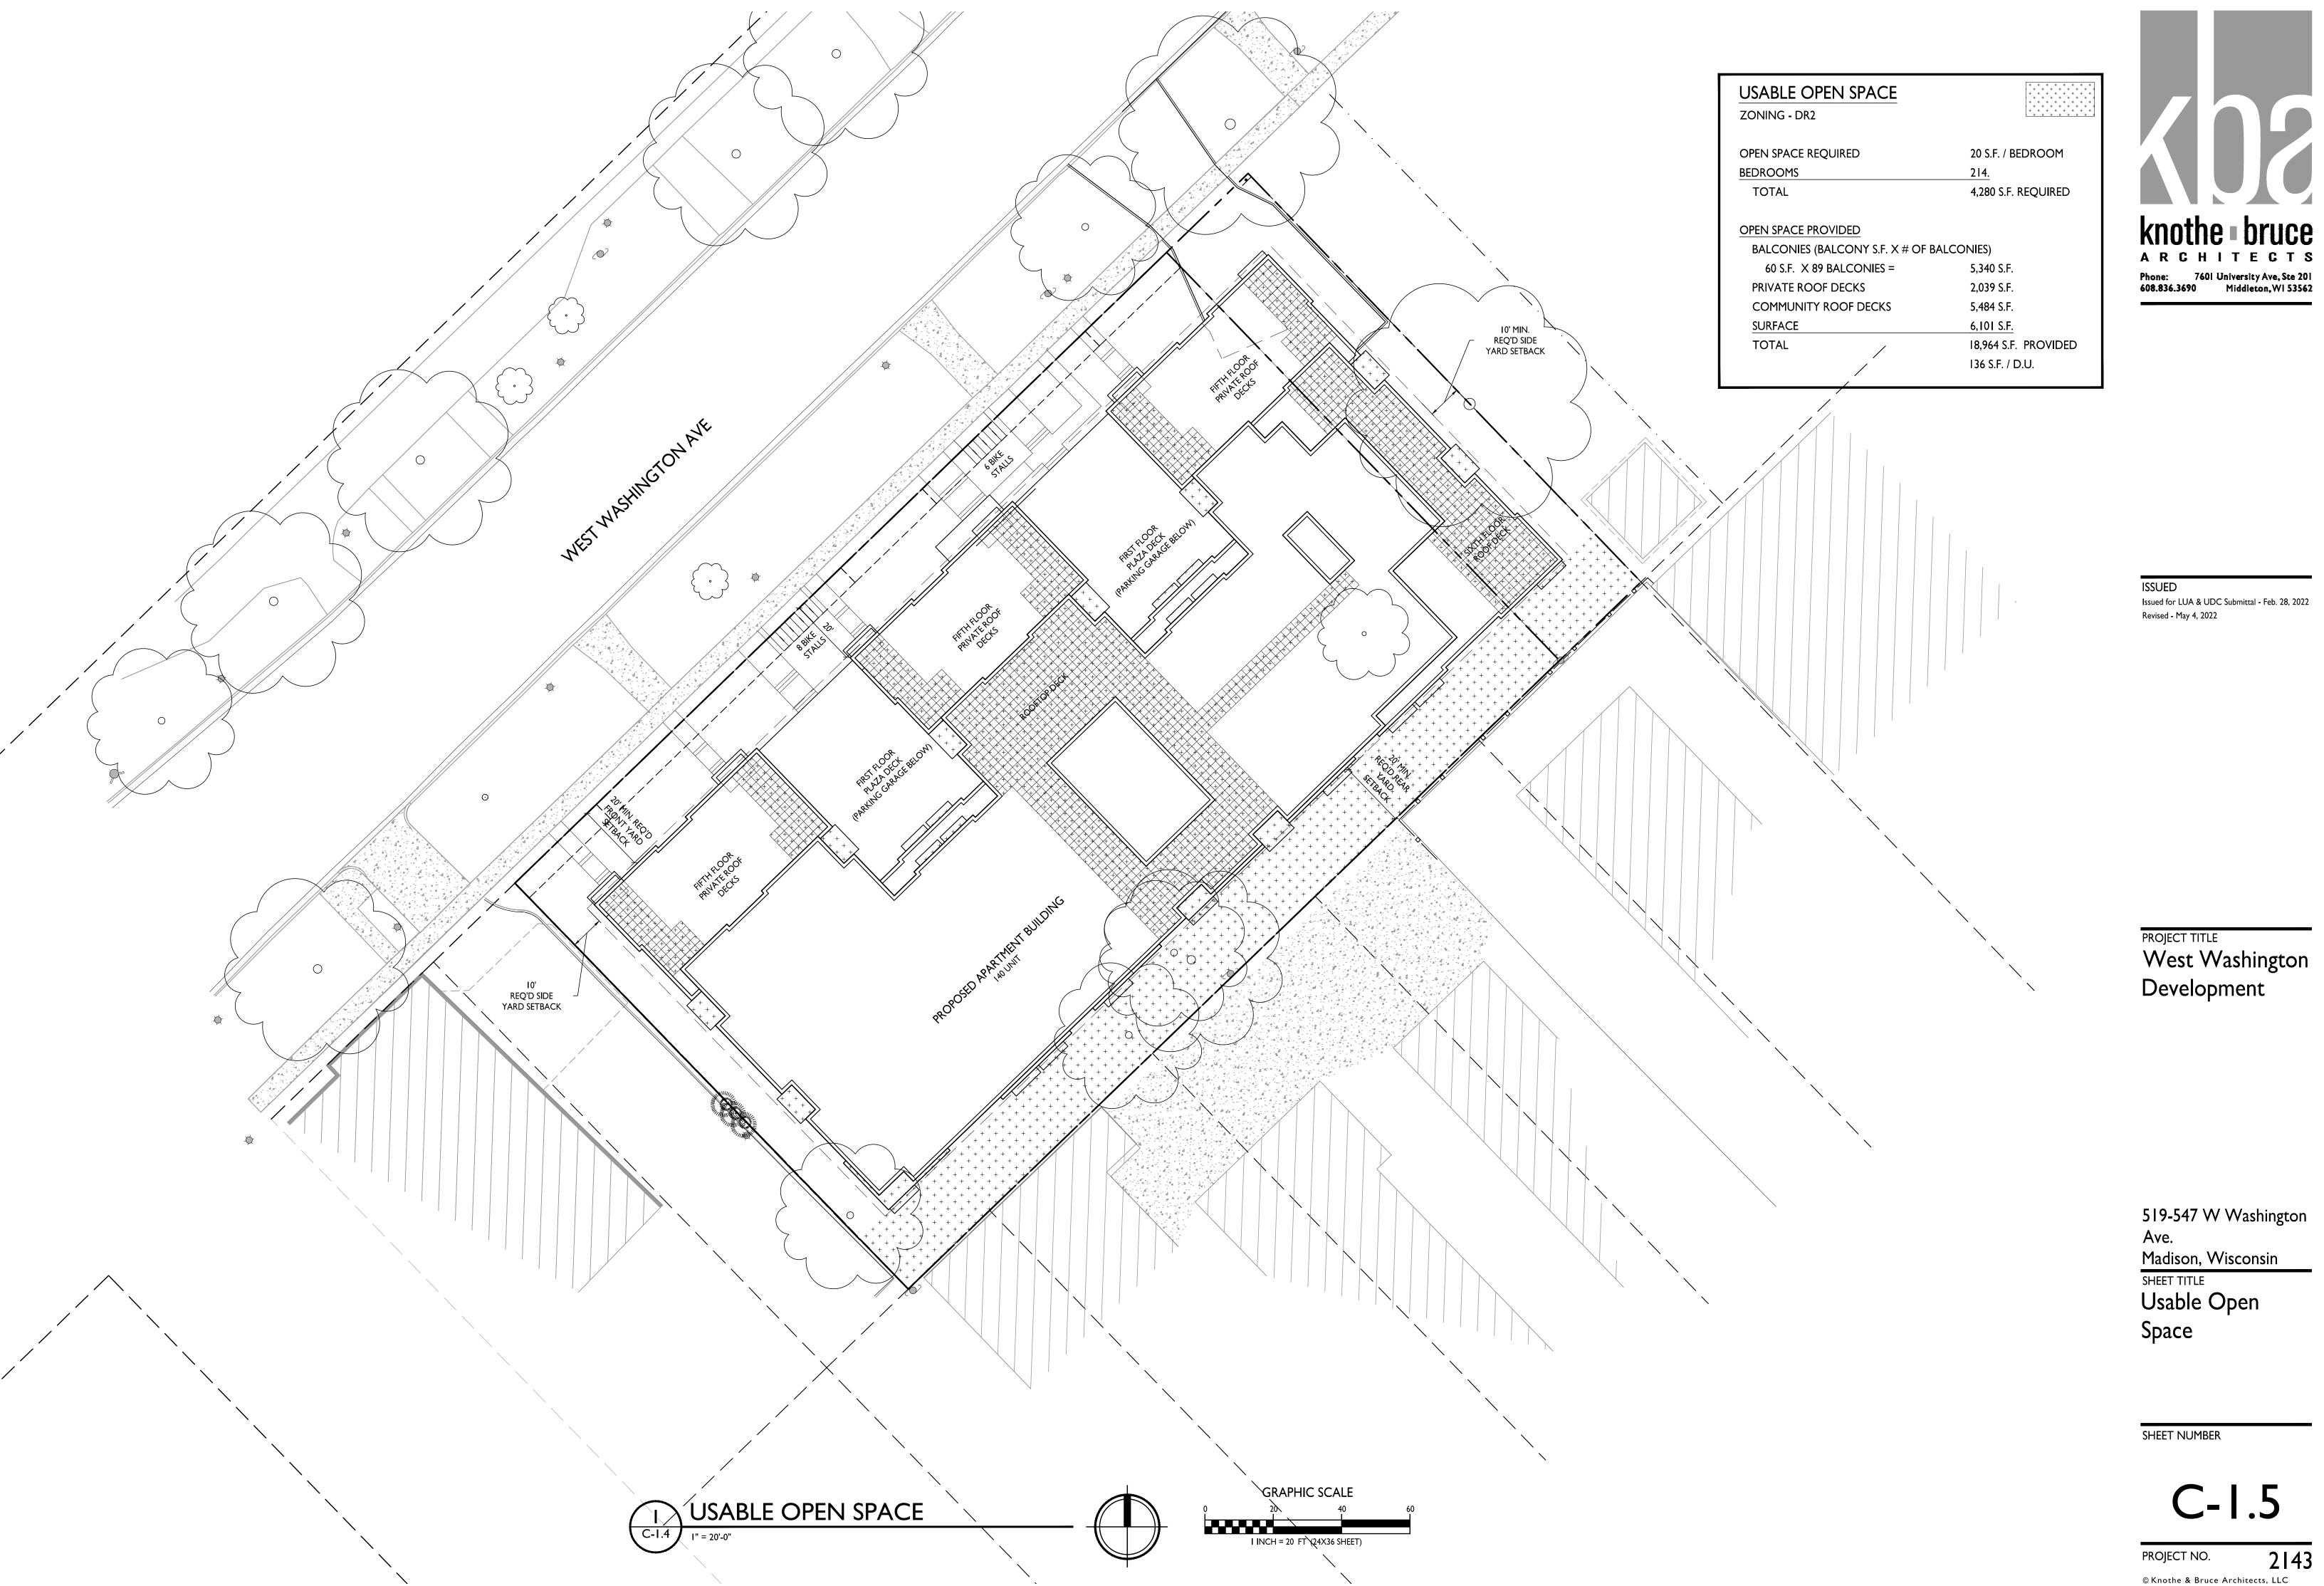


Phone: 7601 University Ave, Ste 201 608.836.3690 Middleton, WI 53562


Issued for LUA & UDC Submittal - Feb. 28, 2022

Development

519-547 W Washington


Usable Open

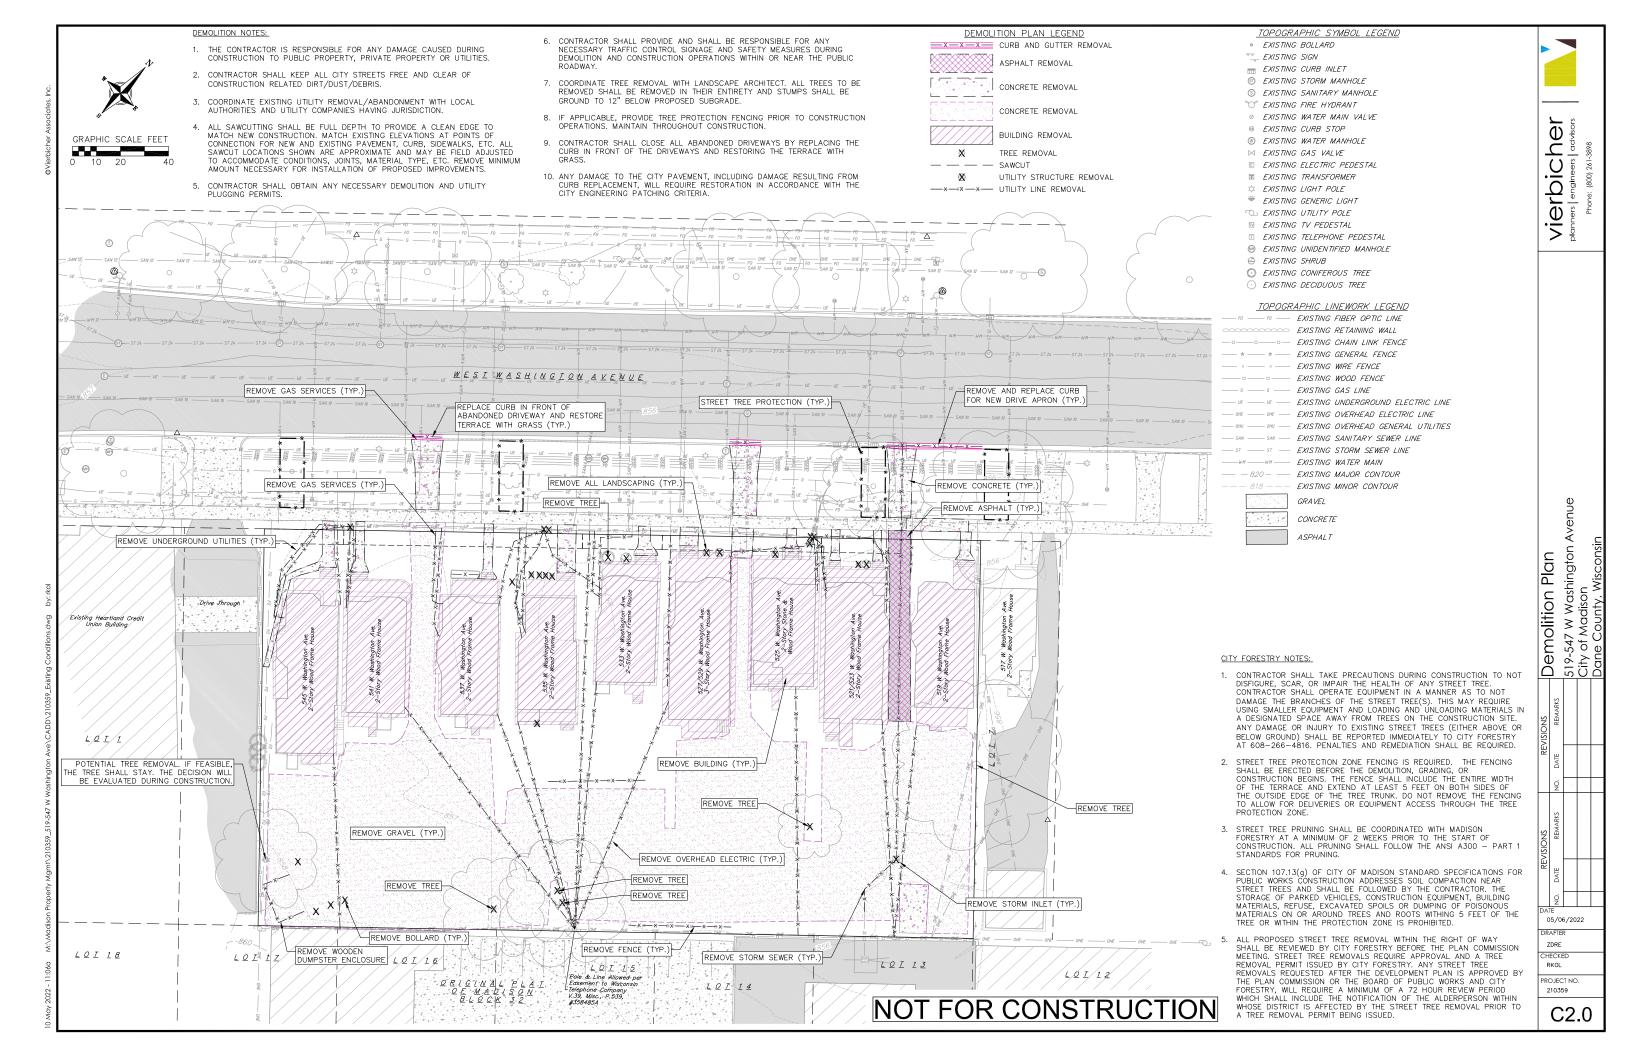


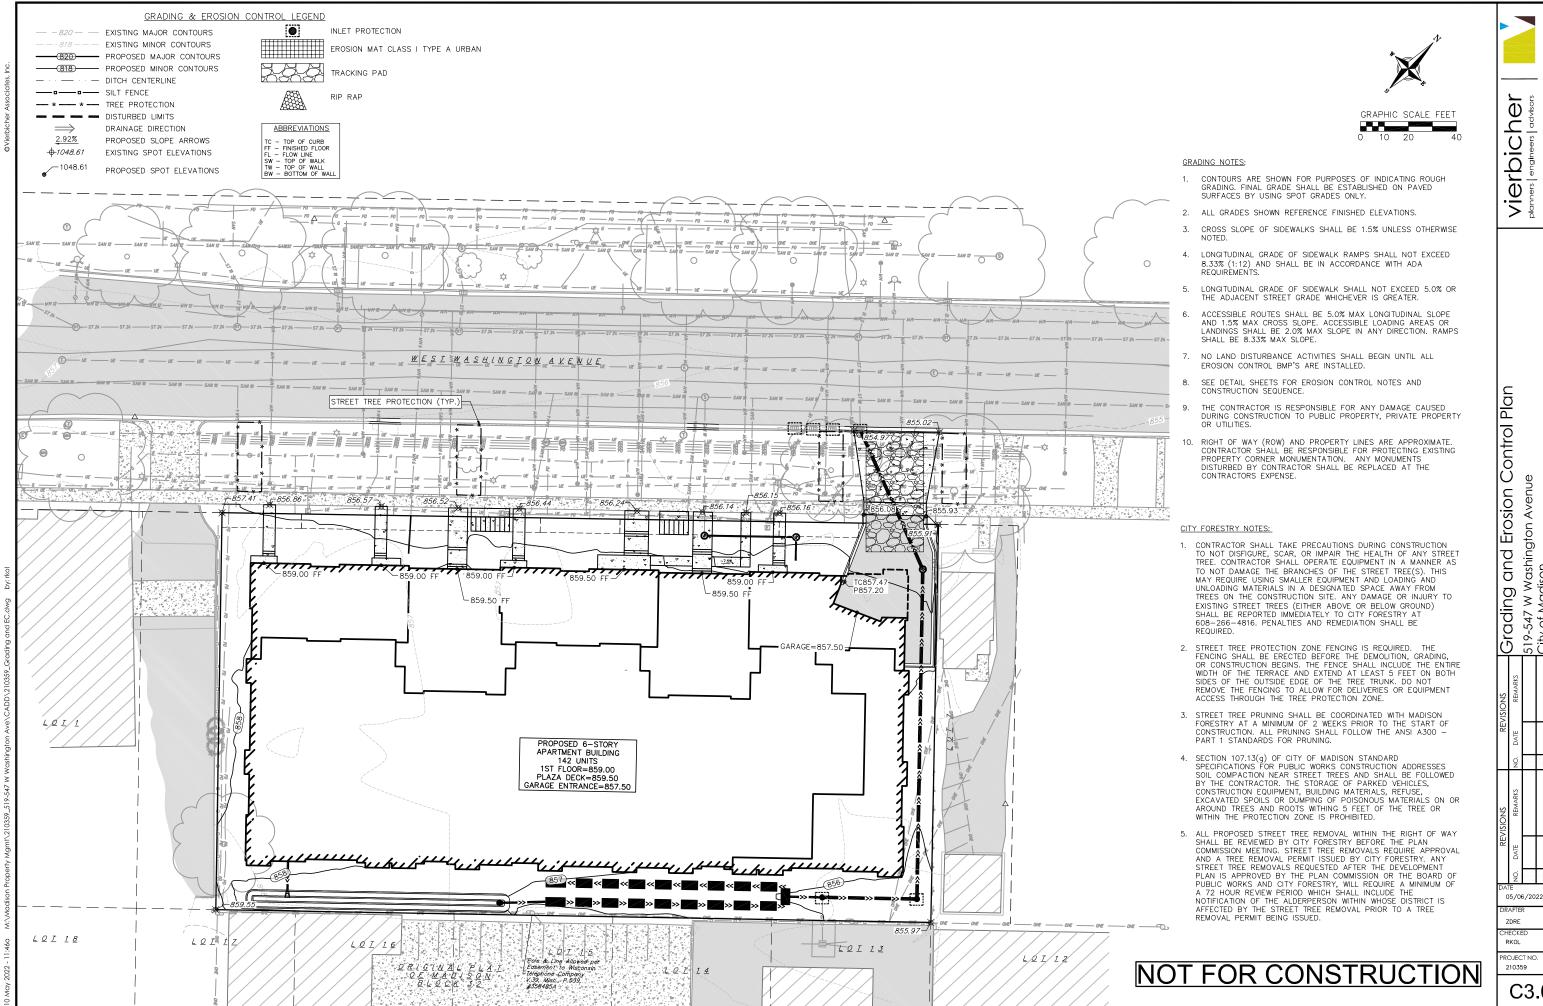

Avenu 7-547 W Washington A y of Madison ne County, Wisconsin 519. City

C3.0

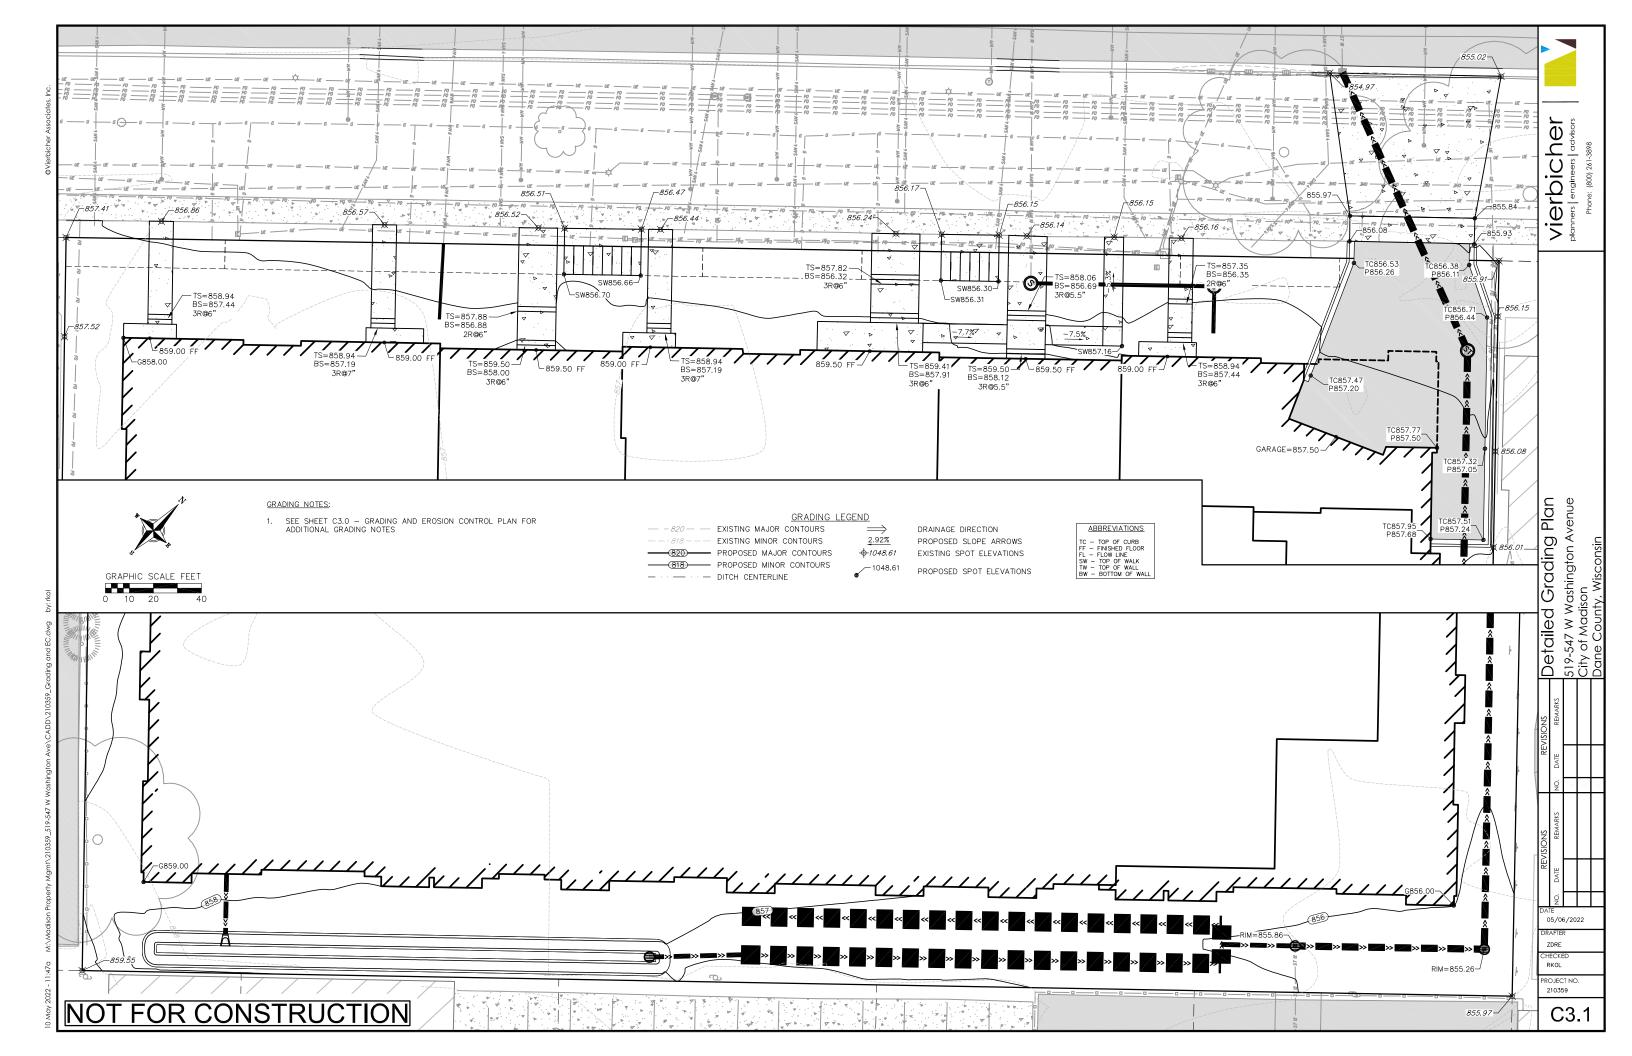

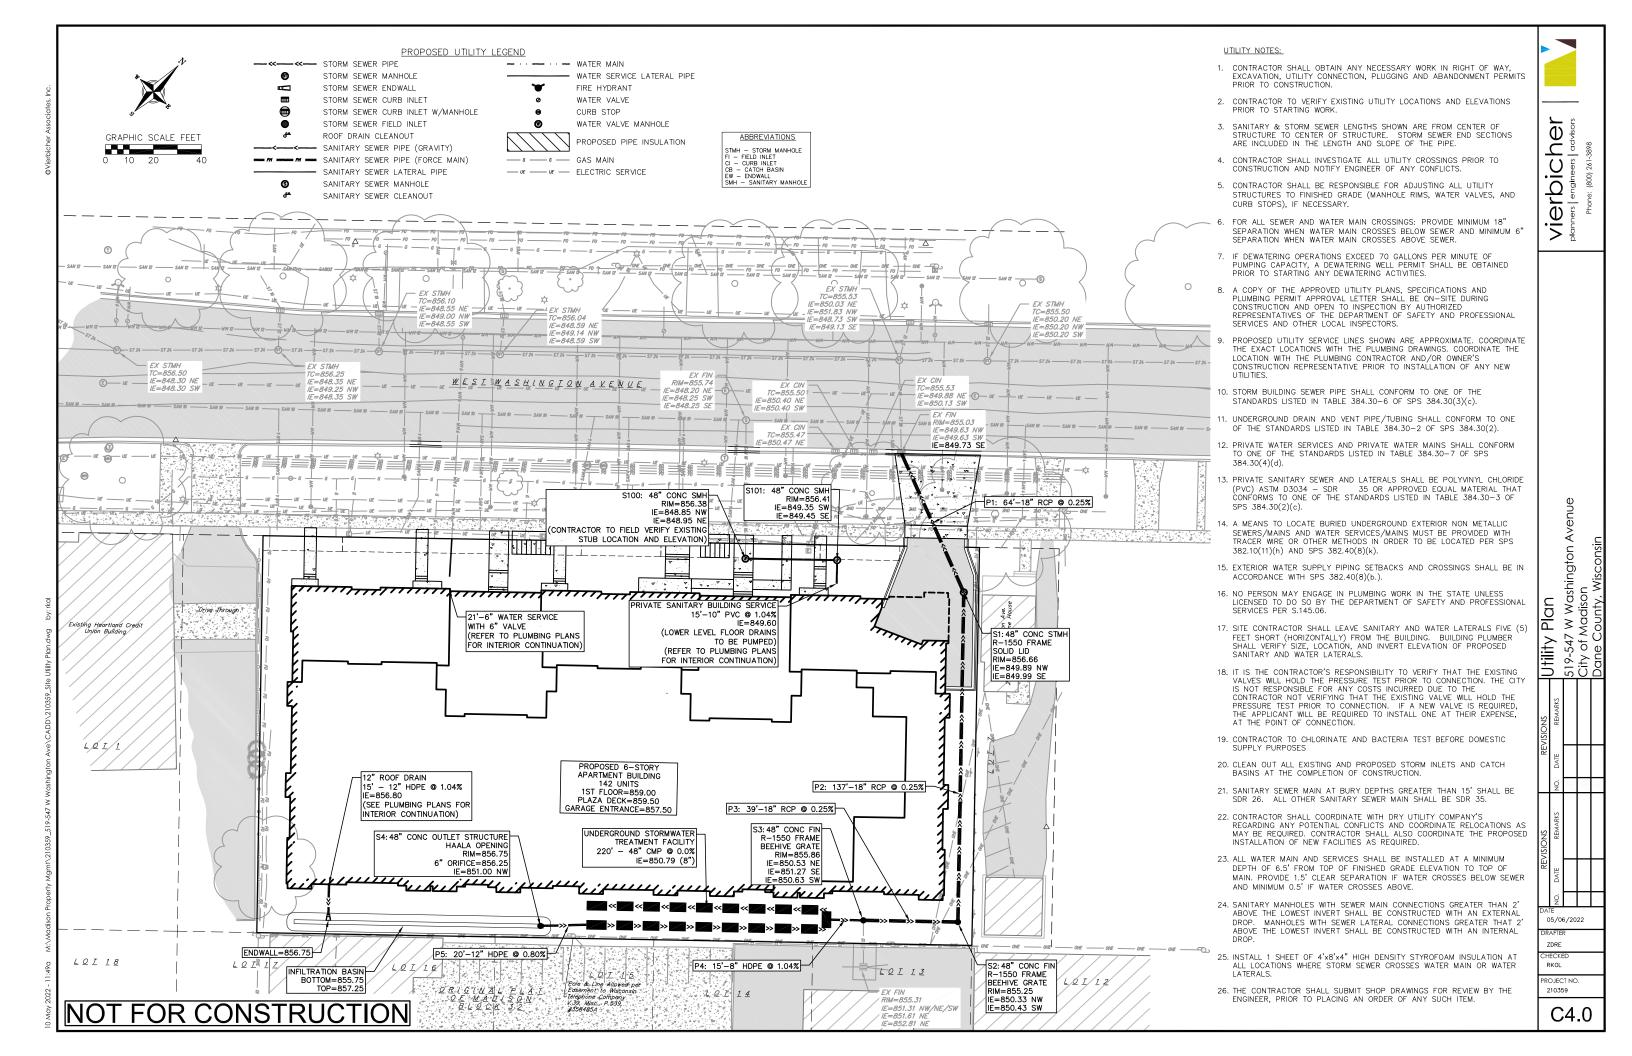

EROSION CONTROL MEASURES

- EROSION CONTROL SHALL BE IN ACCORDANCE WITH THE CITY OF MADISON EROSION CONTROL ORDINANCE AND CHAPTER NR 216 OF THE WISCONSIN ADMINISTRATIVE CODE.
- 2. CONSTRUCT AND MAINTAIN ALL EROSION AND SEDIMENT CONTROL MEASURES IN ACCORDANCE WITH WISCONSIN DNR TECHNICAL STANDARDS (http://dnr.wi.gov/runoff/stormwater/techstds.htm) AND WISCONSIN CONSTRUCTION SITE BEST MANAGEMENT PRACTICE HANDBOOK.
- 3. INSTALL SEDIMENT CONTROL PRACTICES (TRACKING PAD, PERIMETER SILT FENCE, ETC.) PRIOR TO INITIATING OTHER LAND DISTURBING CONSTRUCTION ACTIVITIES.
- THE CONTRACTOR IS REQUIRED TO MAKE EROSION CONTROL INSPECTIONS AT THE END OF EACH WEEK AND WHEN 0.5 INCHES OF RAIN FALLS WITHIN 24 HOURS. INSPECTION REPORTS SHALL BE PREPARED AND FILED AS REQUIRED BY THE DNR AND/OR CITY. ALL MAINTENANCE WILL FOLLOW AN INSPECTION WITHIN 24
- 5. EROSION CONTROL IS THE RESPONSIBILITY OF THE CONTRACTOR UNTIL ACCEPTANCE OF THIS PROJECT. EROSION CONTROL MEASURES AS SHOWN SHALL BE THE MINIMUM PRECAUTIONS THAT WILL BE ALLOWED.

 ADDITIONAL EROSION CONTROL MEASURES, AS REQUESTED IN WRITING BY THE STATE OR LOCAL INSPECTORS, OR THE DEVELOPER'S ENGINEER, SHALL BE INSTALLED WITHIN 24 HOURS.
- A 3" CLEAR STONE TRACKING PAD SHALL BE INSTALLED AT THE END OF ROAD CONSTRUCTION LIMITS TO PREVENT SEDIMENT FROM BEING TRACKED ONTO THE ADJACENT PAVED PUBLIC ROADWAY. SEDIMENT TRACKING PAD SHALL CONFORM TO WISDNR TECHNICAL STANDARD 1057. SEDIMENT REACHING THE PUBLIC ROAD SHALL BE REMOVED BY STREET CLEANING (NOT HYDRAULIC FLUSHING) BEFORE THE END OF EACH
- 7. CHANNELIZED RUNOFF: FROM ADJACENT AREAS PASSING THROUGH THE SITE SHALL BE DIVERTED AROUND
- 8. <u>STABILIZED DISTURBED GROUND:</u> ANY SOIL OR DIRT PILES WHICH WILL REMAIN IN EXISTENCE FOR MORE THAN 7-CONSECUTIVE DAYS, WHETHER TO BE WORKED DURING THAT PERIOD OR NOT, SHALL NOT BE LOCATED WITHIN 25-FEET OF ANY ROADWAY, PARKING LOT, PAVED AREA, OR DRAINAGE STRUCTURE OR CHANNEL (UNLESS INTENDED TO BE USED AS PART OF THE EROSION CONTROL MEASURES). STABILIZATION AND CONTROL MEASURES (SEEDING, MULCHING, TARPING, EROSION MATTING, BARRIER FENCING, ETC.) ARE REQUIRED FOR THE PROTECTION OF DISTURBED AREAS AND SOIL PILES, WHICH WILL REMAIN UN-WORKED FOR A PERIOD OF MORE THAN 7-CONSECUTIVE CALENDAR DAYS. THESE MEASURES SHALL REMAIN IN PLACE UNTIL SITE HAS STABILIZED.
- SITE DE-WATERING: WATER PUMPED FROM THE SITE SHALL BE TREATED BY TEMPORARY SEDIMENTATION BASINS OR OTHER APPROPRIATE CONTROL MEASURES. SEDIMENTATION BASINS SHALL HAVE A DEPTH OF AT LEAST 3 FEET, BE SURROUNDED BY SNOWFENCE OR EQUIVALENT BARRIER AND HAVE SUFFICIENT SURFACE AREA TO PROVIDE A SURFACE SETTLING RATE OF NO MORE THAN 750 GALLONS PER SQUARE FOOT PER DAY AT THE HIGHEST DEWATERING PUMPING RATE. WATER MAY NOT BE DISCHARGED IN A MANNER THAT CAUSES EROSION OF THE SITE, A NEIGHBORING SITE, OR THE BED OR BANKS OF THE RECEIVING WATER. POLYMERS MAY BE USED AS DIRECTED BY DNR TECHNICAL STANDARD 1061
- 10. RESTORATION (SEED, FERTILIZE AND MULCH) SHALL BE PER SPECIFICATIONS ON THIS SHEET UNLESS SPECIAL RESTORATION IS CALLED FOR ON THE LANDSCAPE PLAN OR THE DETENTION BASIN DETAIL SHEET.
- 11. TERRACES SHALL BE RESTORED WITH 6" TOPSOIL, PERMANENT SEED, FERTILIZER AND MULCH. LOTS SHALL BE RESTORED WITH 6" TOPSOIL, TEMPORARY SEED, FERTILIZER AND MULCH.
- 12. SEED, FERTILIZER AND MULCH SHALL BE APPLIED WITHIN 7 DAYS AFTER FINAL GRADE HAS BEEN ESTABLISHED. IF DISTURBED AREAS WILL NOT BE RESTORED IMMEDIATELY AFTER ROUGH GRADING, TEMPORARY SEED SHALL BE PLACED.
- 13. FOR THE FIRST SIX WEEKS AFTER RESTORATION (E.G. SEED & MULCH, EROSION MAT, SOD) OF A DISTURBED AREA, INCLUDE SUMMER WATERING PROVISIONS OF ALL NEWLY SEEDED AND MULCHED AREAS WHENEVER 7 DAYS FLAPSE WITHOUT A RAIN EVENT
- 14. SOIL STABILIZERS SHALL BE APPLIED TO DISTURBED AREAS WITH SLOPES BETWEEN 10% AND 3:1 (DO NOT USE IN CHANNELS). SOIL STABILIZERS SHALL BE TYPE B, PER WISCONSIN D.O.T. P.A.L. (PRODUCT ACCEPTABILITY LIST), OR EQUAL. APPLY AT RATES AND METHODS SPECIFIED PER MANUFACTURER/THIS SHEET. SOIL STABILIZERS SHALL BE RE—APPLIED WHENEVER VEHICLES OR OTHER EQUIPMENT TRACK ON
- 15. SILT FENCE OR EROSION MAT SHALL BE INSTALLED ALONG THE CONTOURS AT 100 FOOT INTERVALS DOWN THE SLOPE ON THE DISTURBED SLOPES STEEPER THAN 5% AND MORE THAN 100 FEET LONG THAT SHEET FLOW TO THE ROADWAY UNLESS SOIL STABILIZERS ARE USED.
- 16. SILT FENCE TO BE USED ACROSS AREAS OF THE LOT THAT SLOPE TOWARDS A PUBLIC STREET OR WATERWAY, SEE DETAILS.
- 17. SEDIMENT SHALL BE CLEANED FROM CURB AND GUTTER AFTER EACH RAINFALL AND PRIOR TO PROJECT
- 18. ALL CONSTRUCTION ENTRANCES SHALL HAVE TEMPORARY ROAD CLOSED SIGNS THAT WILL BE IN PLACE WHEN THE ENTRANCE IS NOT IN USE AND AT THE END OF EACH DAY.
- 19. ANY PROPOSED CHANGES TO THE EROSION CONTROL PLAN MUST BE SUBMITTED AND APPROVED BY ENGINEER OR PERMITTING MUNICIPALITY.
- 20. THE CITY, OWNER AND/OR ENGINEER MAY REQUIRE ADDITIONAL EROSION CONTROL MEASURES AT ANY TIME DURING CONSTRUCTION.

CONSTRUCTION SEQUENCE:

- 1. INSTALL SILT FENCE, TRACKING PAD. INLET PROTECTION
- 2. DEMOLISH EXISTING BUILDINGS
- 3. ROUGH GRADE SITE
- 4. EXCAVATE AND CONSTRUCT BUILDING FOUNDATION
- 5. CONSTRUCT UNDERGROUND UTILITIES
- 6. INSTALL INLET PROTECTION ON NEW
- 7. CONSTRUCT BUILDING
- 8. CONSTRUCT PAVEMENT (STONE BASE, CURB & GUTTER, AND SIDEWALK)
- 9. RESTORE TERRACES
- 10 REMOVE TRACKING PAD AND SILT FENCE AFTER DISTURBED AREAS ARE
 RESTORED

SEEDING RATES:

- USE ANNUAL OATS AT 3.0 LB./1,000 S.F. FOR SPRING AND SUMMER PLANTINGS
- 2. USE WINTER WHEAT OR RYE AT 3.0 LB./1,000 SF FOR FALL PLANTINGS STARTED

AFTER SEPTEMBER 15.

PERMANENT:

USE WISCONSIN D.O.T. SEED MIX #40 AT 2 LB./1,000 S.F.

FERTILIZING RATES


TEMPORARY AND PERMANENT:

USE WISCONSIN D.O.T. TYPE A OR B AT 7 LB./1,000 S.F.

MULCHING RATES:

TEMPORARY AND PERMANENT:


USE ½" TO 1-½" STRAW OR HAY MULCH, CRIMPED PER SECTION 607.3.2.3, OR OTHER RATE AND METHOD PER SECTION 627, WISCONSIN D.O.T. STANDARD SPECIFICATIONS FOR HIGHWAY AND STRUCTURE CONSTRUCTION

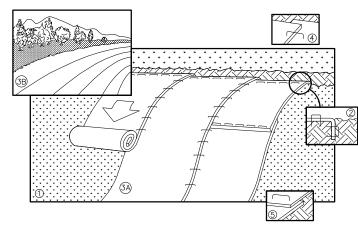


NOTE: REFER TO GENERAL STAPLE PATTERN GUIDE FOR CORRECT STAPLE PATTERN RECOMMENDATIONS FOR SLOPE INSTALLATIONS.

- 1. PREPARE SOIL BEFORE INSTALLING BLANKETS, INCLUDING APPLICATION OF FERTILIZER AND SEED.
 NOTE: WHEN USING CELL-O-SEED, DO NOT SEED PREPARED AREA.
- CELL-O-SEED MUST BE INSTALLED WITH PAPER SIDE DOWN.
 BEGIN AT THE TOP OF THE SLOPE BY ANCHORING THE BLANKET IN 6" DEEP
- BY 6" WIDE TRENCH. BACKFILL AND COMPACT THE TRENCH AFTER STAPLING. ROLL THE BLANKETS <A.> DOWN, OR <B.> HORIZONTALLY ACROSS THE SLOPE 4. THE EDGES OF PARALLEL BLANKETS MUST BE STAPLED WITH APPROXIMATELY
- 2" OVERLAP WHEN BLANKETS MUST BE SPLICED DOWN THE SLOPE, PLACE BLANKETS END OVER END (SHINGLE STYLE) WITH APPROXIMATELY 4" OVERLAP. STAPLE
- THROUGH OVERLAPPED AREA, APPROXIMATELY 12" APART.
 ALL BLANKETS MUST BE SECURELY FASTENED TO THE SLOPE BY PLACING STAPLES/STAKES IN APPROPRIATE LOCATIONS AS RECOMMENDED BY THE MANUFACTURER

EROSION MAT NOT TO SCALE

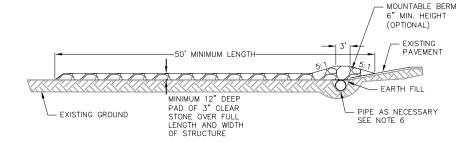

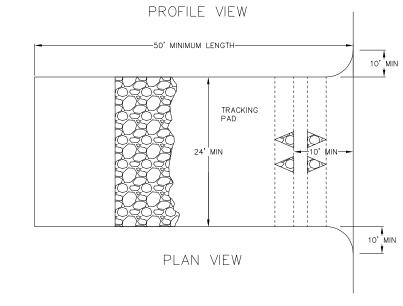


- 1. FOLLOW WISCONSIN DNR TECHNICAL STANDARD 1057 FOR FURTHER DETAILS AND INSTALLATION
- 2. LENGTH MINIMUM OF 50'
- 3. WIDTH 24' MINIMUM, SHOULD BE FLARED AT THE EXISTING ROAD TO PROVIDE A TURNING RADIUS.

TRACKING PAD

NOT TO SCALE

C5.0

- 4. ON SITES WITH A HIGH GROUND WATER TABLE OR WHERE SATURATED CONDITIONS EXIST, GEOTEXTILE FABRIC SHALL BE PLACED OVER EXISTING GROUND PRIOR TO PLACING STONE. FABRIC SHALL BE WISDOT TYPE—HR GEOTEXTILE FABRIC.
- 5. STONE CRUSHED 3" CLEAR STONE SHALL BE PLACED AT LEAST 12" DEEP OVER THE ENTIRE LENGTH AND WIDTH OF ENTRANCE.
- 6. SURFACE WATER ALL SURFACE WATER FLOWING TO OR DIVERTED TOWARDS CONSTRUCTION ENTRANCES SHALL BE PIPED THROUGH THE ENTRANCE. MAINTAINING POSITIVE DRAIMAGE. PIPE INSTALLED THROUGH THE STABILIZED CONSTRUCTION ENTRANCE SHALL BE PROTECTED WITH A MOUNTABLE BERM WITH 5:1 SLOPES AND MINIMIUM OF 6" STONE OVER THE PIPE. PIPE SHALL BE SIZED ACCORDING TO THE DRAIMAGE REQUIREMENTS. WHEN THE ENTRANCE IS LOCATED AT A HIGH SPOT AND HAS NO DRAIMAGE TO CONVEY A PIPE SHALL NOT BE NECESSARY. THE MINIMUM PIPE DIAMETER SHALL BE 6". CONTRACTOR SHALL BE RESPONSIBLE
- 7. LOCATION A STABILIZED CONSTRUCTION ENTRANCE SHALL BE LOCATED WHERE CONSTRUCTION TRAFFIC ENTERS AND/OR LEAVES THE CONSTRUCTION SITE. VEHICLES LEAVING THE SITE MUST TRAVEL OVER THE ENTIRE LENGTH OF THE TRACKING PAD.

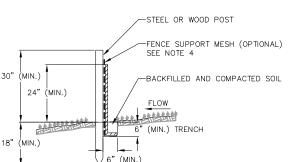


- INSTALL SILT FENCE TO FOLLOW THE GROUND CONTOURS AS CLOSELY AS POSSIBLE.
- 2. CURVE THE SILT FENCE UP THE SLOPE TO PREVENT WATER FROM RUNNING AROUND THE ENDS.
- 3. POST SPACING WITH FENCE SUPPORT MESH = 10 FT. (MAX.)

POST SPACING WITHOUT FENCE SUPPORT MESH = 6 FT. (MAX.)

4. SILT FENCE SUPPORT MESH CONSISTS OF 14-GAUGE STEEL WIRE WITH A MESH SPACING OF 6 IN. X 6 IN. OR PREFABRICATED
POLYMERIC MESH OF EQUIVALENT STRENGTH





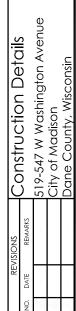

05/06/2022

7DRF

RKOL PRO JECT NO

210359

C5.0

he

Vier


WHEN REMOVING OR MAINTAINING INLET
PROTECTION, ANY TRAPPED MATERIAL THAT
FALLS INTO THE INLET SHALL BE
IMMEDIATELY REMOVED BY THE CONTRACTOR.

CURB BACK
EXTENSION

REPLACEABLE FILTER BAG
W/STAINLESS CLAMPING BAND

FLEXSTORM CATCH-IT INLET FITLERS FOR ROLLED CURB

FLEXSTORM CATCH-IT INLET FITLERS FOR CURB BOX OPENINGS (MAGNETIC CURB FLAP)

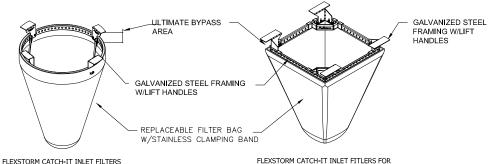


FLEXSTORM CATCH-IT INLET FITLERS FOR SQUARE/RECTANGULAR OPENINGS

NEENAH CASTING	INLET TYPE	GRATE SIZE	OPENING SIZE	ADS P/N
1040/1642/1733	ROUND	26	24	62MRDFX
3067 W/FLAP	CURB BOX	35.25 X 17.75	33.0 X 15.0	62LCBEXTFX
3067 EXTENDED BACK	CURB BOX	35.25 X 17.75	33.0 X 15.0	62LCBEXTFX
3246A	CURB BOX	35.75 X 23.875	33.5 X 21.0	62LCBFX
3030	SQUARE/RECT	23 X 16	20.5 X 13.5	62MCBFX
3067-C	SQUARE/RECT	35.25 X 17.75	33 X 15	62LSQFX

1 FF

FRAMED INLET PROTECTION


C5.1 NOT TO SCALE

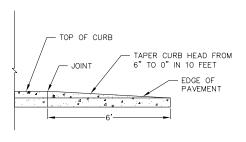

PROFILE VIEW


CURB & GUTTER TERMINATION


CS.1 NOT TO SCALE

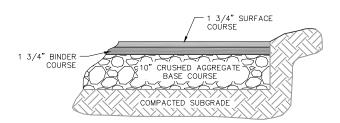


BITUMINOUS PAVEMENT

3 SITE PAVEMENT

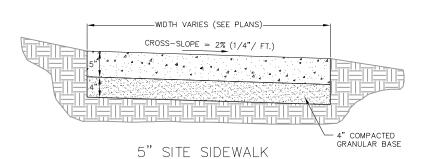

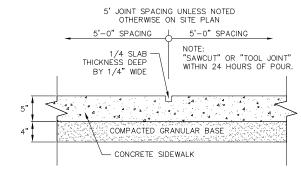


SIDEWALK CONTROL JOINT

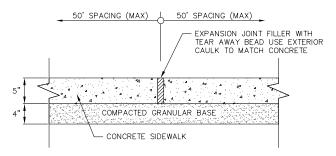


SIDEWALK EXPANSION JOINT


4 5" SIDEWALK
cs.1 NOT TO SCALE

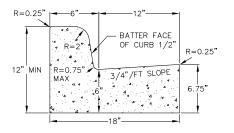


CURB AND GUTTER CROSS SECTION

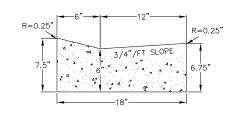

DRIVEWAY GUTTER CROSS SECTION

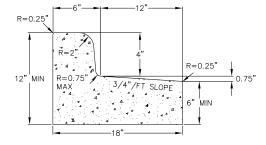

CURB AND GUTTER REJECT SECTION

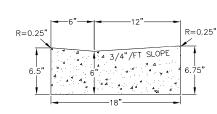

HANDICAP RAMP GUTTER CROSS SECTION



18" CONCRETE CURB AND GUTTER

NOT TO SCALE

POST STATE REMARKS NO. DATE REMARKS CONSTRUCTION Details


TO DATE REMARKS NO. DATE REMARKS STORY Washington Avenue City of Madison Dane County, Wisconsin

Vierbicher planners | advisors

NOT FOR CONSTRUCTION

C5.1

PROJECT NO.

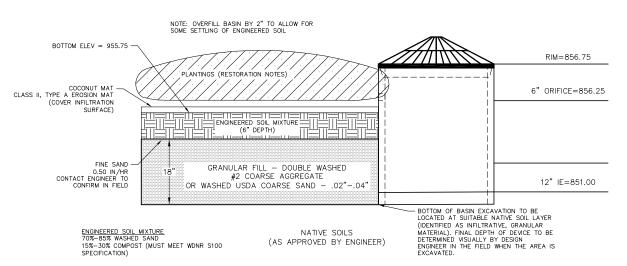

- RESTORATION OF THE INFILITRATION AREA (NOT INCLUDING SIDE SLOPES):


 1. OVER-EXCAVATE THE AREA TO INFILITRATIVE LAYER TO BE DETERMINED IN THE FIELD, DURING EXCAVATION, BY DESIGN ENGINEER.


 2. CONTRACTOR SHALL CHISEL PLOW OR ROTO—TILL THE BOTTOM OF THE INFILITRATION FACILITY TO BREAK UP ANY HARDPAN IN THE NATIVE SOIL LAYER AFTER REMOVAL OF CONSTRUCTION SEDIMENT AND OVER EXCAVATION OF BASIN AREA.
- OF BASIN AREA.

 3. PLACE WASHED SAND (FREE OF P200 PARTICLES) TO DEPTH OF SUITABLE NATIVE SOIL LAYER (IF REQUIRED).

 4. PLACE 6 INCHES OF ENGINEERED SOIL, COMPRISED OF:

 70-85% WASHED SAND
- 15-30% COMPOST (MUST MEET WONR SIDO SPECIFICATION
 5. INFILTRATION FACILITY INTERIOR SIDE SLOPES AND TOP OF ACCESS BERM SHALL BE SEEDED WITH SHORT GRASS PRAIRIE SEED MIX BY AGRECOL (OR APPROVED EQUAL). APPLICATION RATES PER MANUFACTURER'S RECOMMENDATIONS.
- 6. BOTTOM OF INFILTRATION FACILITY TO BE RESTORED WITH INFILTRATION SWALE SEED MIX BY AGRECOL (OR APPROVED EQUAL). APPLICATION RATES PER MANUFACTURER'S RECOMMENDATIONS.

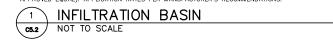

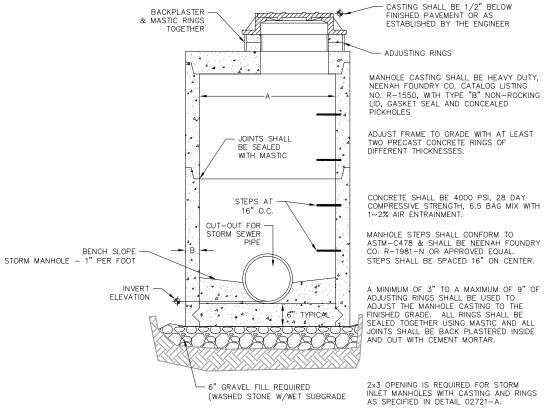


STORM MANHOLE DIMENSIONS

MANHOLE	DIMENSION				
SIZE	Α	B (MIN.)			
48"	48"	5"			
60"	60"	6"			
72"	72"	7"			
84"	84"	7"			
96"	96"	9"			


STORM SEWER MANHOLE


NOT TO SCALE

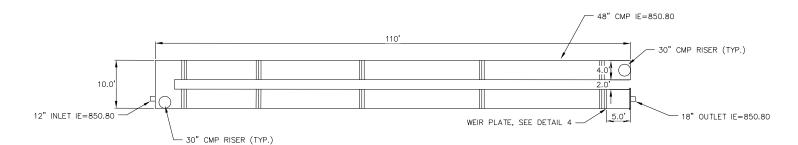

PLAN VIEW

REFER TO PLANS FROM CONTECH FOR FINAL LAYOUT AND CONSTRUCTION & INSTALLATION DETAILS

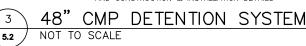

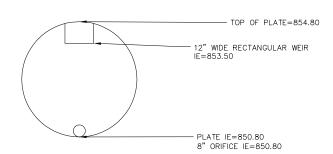



' DIAMETER WEIR PLATE

NOT TO SCALE

NOT FOR CONSTRUCTION

Construction Details
519-547 w washington Avenue
City of Madison
Dane County, Wisconsin 05/06/2022 ZDRE CHECKED RKOL PROJECT NO. 210359

Vierbicher planners | advisors

C5.2

PLANT MATERIAL NOTES:

- 1. ALL PLANTINGS SHALL CONFORM TO QUALITY REQUIREMENTS AS PER ANSI 760.1.
- 2. ALL PLANT MATERIAL SHALL BE TRUE TO SPECIES, VARIETY AND SIZE SPECIFIED, NURSERY GROWN IN ACCORDANCE WITH GOOD HORTICULTURAL PRACTICES, AND UNDER CLIMATIC CONDITIONS SIMILAR TO THOSE OF THE PROJECT SITE.
- 3. CONTACT LANDSCAPE ARCHITECT, IN WRITING, TO REQUEST ANY PLANT MATERIAL SUBSTITUTIONS DUE TO AVAILABILITY ISSUES.
- 4. ALL PLANTS SHALL BE GUARANTEED TO BE IN HEALTHY AND FLOURISHING CONDITION DURING THE GROWING SEASON FOLLOWING INSTALLATION. ALL PLANT MATERIAL SHALL BE GUARANTEED FOR ONE YEAR FROM THE TIME OF INSTALLATION.

LANDSCAPE MATERIAL NOTES:


- 1. CONTRACTOR SHALL PROVIDE A SUITABLE AMENDED TOPSOIL BLEND FOR ALL PLANTING AREAS WHERE SOIL CONDITIONS ARE UNSUITABLE FOR PLANT GROWTH. TOPSOIL SHALL CONFORM TO QUALITY REQUIREMENTS AS PER SECTION 625.2(1) OF THE "STANDARD SPECIFICATIONS FOR HIGHWAY CONSTRUCTION." PROVIDE A MINIMUM OF 18" OF TOPSOIL IN ALL PLANTING AREAS AND 6" OF TOPSOIL IN AREAS TO BE SEEDED/SODDED.
- 2. LANDSCAPE BEDS TO BE MULCHED WITH UNDYED SHREDDED HARDWOOD BARK MULCH TO 3" DEPTH MIN. AND EDGED WITH COMMERCIAL GRADE ALUMINUM LANDSCAPE EDGING, PERMALOC CLEANLINE $\frac{3}{16}$ "X4" OR EQUAL, COLOR BLACK ANODIZED.
- 3. ALL TREES AND/OR SHRUBS PLANTED IN LAWN AREAS TO BE INSTALLED WITH A 5' DIAMETER MULCH RING AND SHOVEL CUT EDGE. A PRE-EMERGENT GRANULAR HERBICIDE WEED-PREVENTER SHOULD BE MIXED WITH MULCH AS WELL AS TOPICALLY APPLIED TO TREE RING.

SEEDING NOTES:

- 1. ALL DISTURBED AREAS, UNLESS OTHERWISE NOTED, TO BE SEEDED WITH 'MADISON PARKS' MIX BY 'LACROSSE SEED COMPANY' OR EQUIVALENT, PER MANUFACTURER'S SPECIFIED APPLICATION RATES. ALL SEEDED AREAS ARE TO BE WATERED DAILY TO MAINTAIN ADEQUATE SOIL MOISTURE FOR PROPER GERMINATION. AFTER VIGOROUS GROWTH IS ESTABLISHED, APPLY $\frac{1}{2}$ WATER TWICE WEEKLY UNTIL FINAL ACCEPTANCE.
- 2. ALL AREAS NOTED ON PLAN AS STORMWATER BASIN SEEDING, INSTALL 'DETENTION BASIN BIOSWALE' SEED MIX BY 'PRAIRIE NURSERY'. INSTALL PER MANUFACTURER'S SPECIFIED APPLICATION RATES. ALL SEEDED AREAS ARE TO BE WATERED DAILY TO MAINTAIN ADEQUATE SOIL MOISTURE FOR PROPER GERMINATION. AFTER VIGOROUS GROWTH IS ESTABLISHED, APPLY 1 WATER TWICE WEEKLY UNTIL FINAL ACCEPTANCE.

City of Madison Lands	cape Worksheet									
Address: 525-547 W Washington		ngton	Date:	5.10.2022						
Total Square Footage of Developed Area:		(Site Area)	49,384	-	(Building Footprint at Grade)		33,919	=	15465	s
Total Landscape Points Required (<5 ac):		15,465	/ 300 =	52	x 5 =	258	258			
Lansdcape Points Requried >5 ac:		0	/ 100 =	0	x 1 =	-				
				s/ Existing Iscaping	g New/ Proposed Landscaping					
Plant Type/ Element	Min. Size at Installation	Points	Quantity	Points Achieved	Quantity	Points Achieved				
Overstory deciduous tree	2.5" cal	35	1	35		0				
Tall Evergreen Tree	5-6 feet tall	35		0		0				
Ornamental tree	1.5" cal	15		0	5	75				
Upright evergreen shrub	3-4 feet tall	10		0	8	80				
Shrub, deciduous	#3 gallon container size, Min. 12-24"	3		0	77	231				
Shrub, evergreen	#3 gallon container size, Min. 12-24"	4		0	44	176				
Ornamental grasses/perennials	#1 gallon container size, Min. 8-18"	2		0	147	294				T
Ornamental/decorative fencing or wall	n/a	4 per 10 LF		0		0				T
Existing significant specimen tree	Min. Size 2.5" cal. Trees must be within developed area and cannot comprise more than 30% of total required points.	14 per caliper inch. Max. points per tree: 200		0		0				
Landscape Furniture for public seating and/or transit connections	Furniture must be within developed area, publicly accessible, and cannot comprise more than 5% of total required points	5 points per "seat"		0		0				
Sub Totals				35		856				T
			Total Poi	nts Provided:	891					Т

NOT FOR CONSTRUCTION

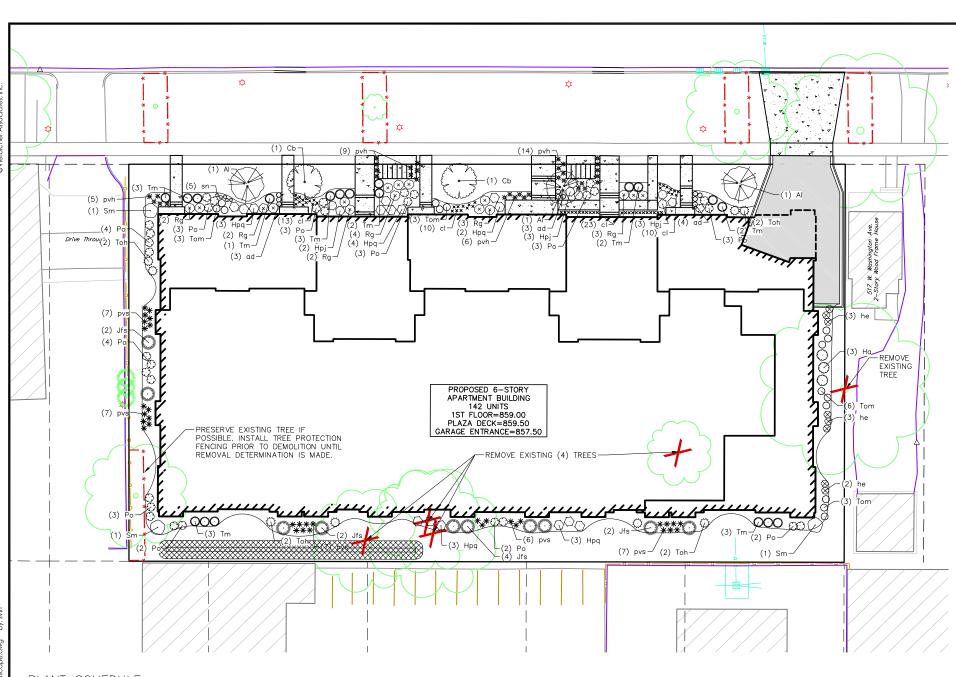

PLANT SCHEDULE

UNDERSTORY TREES AI Cb	BOTANICAL / COMMON NAME Amelanchier laevis / Allegheny Serviceberry Carpinus caroliniana 'J.N. Globe' TM / Ball O' Fire American Hornbeam	ROOT COND. B & B B & B	<u>SIZE</u> 7'ht. 2"Cal	<u>NOTES</u> Multi-Stem	<u>QTY</u> 3 2
DECIDUOUS SHRUBS Ha Hpj Hpq Po Rg Sm	BOTANICAL / COMMON NAME Hydrangea arborescens 'Incrediball' / Incrediball White Hydrangea Hydrangea paniculata 'Jane' TM / Little Lime Hydrangea Hydrangea paniculata 'Little Quick Fire' / Little Quick Fire Hydrangea Physocarpus opulifolius 'Donna May' TM / Little Devil Ninebark Ribes alpinum 'Green Mound' / Green Mound Alpine Currant Syringa meyeri 'Palibin' / Dwarf Korean Lilac	ROOT COND. Cont. Cont. Cont. Cont. Cont. Cont. Cont. Cont.	SIZE 5 Gal. 5 Gal. 5 Gal. 5 Gal. 5 Gal. 7 Gal.	NOTES	QTY 3 8 15 32 16 3
EVERGREEN SHRUBS Jfs Tm Tom Toh	BOTANICAL / COMMON NAME Juniperus chinensis 'Sea Green' / Sea Green Juniper Taxus x media 'Everlow' / Everlow Yew Thuja occidentalis 'Hetz Midget' / Hetz Midget Arborvitae Thuja occidentalis 'Holmstrup' / Holmstrup Cedar	ROOT COND. Cont. Cont. Cont. B & B	<u>SIZE</u> 5 Gal. 5 Gal. 5 Gal. 5' ht.	<u>NOTES</u>	QTY 10 19 15 8
PERENNIALS ad cl he pvh pvs sn	BOTANICAL / COMMON NAME Astilbe x 'Delft Lace' / Delft Lace Astilbe Chasmanthium latifolium / Northern Sea Oats Hosta x 'Earth Angel' / Earth Angel Hosta Panicum virgatum 'Heavy Metal' / Heavy Metal Switch Grass Panicum virgatum 'Shenandoah' / Shenandoah Red Switch Grass Salvia nemorosa 'Blue Hill' / Woodland Sage	ROOT COND. Cont. Cont. Cont. Cont. Cont. Cont. Cont. Cont.	SIZE 1 Gal. 1 Gal. 1 Gal. 1 Gal. 1 Gal. 1 Gal.	NOTES	QTY 10 56 8 34 34 5

BASIN SEED SCHEDULE



STORMWATER BASIN SEED MIX 835 sf

vierbiche


47 W Washington / f Madison Plan andscape -547 of N

PRO JECT NO 210359

SVIN CHECKE RKOL

5/10/2022

L1.0

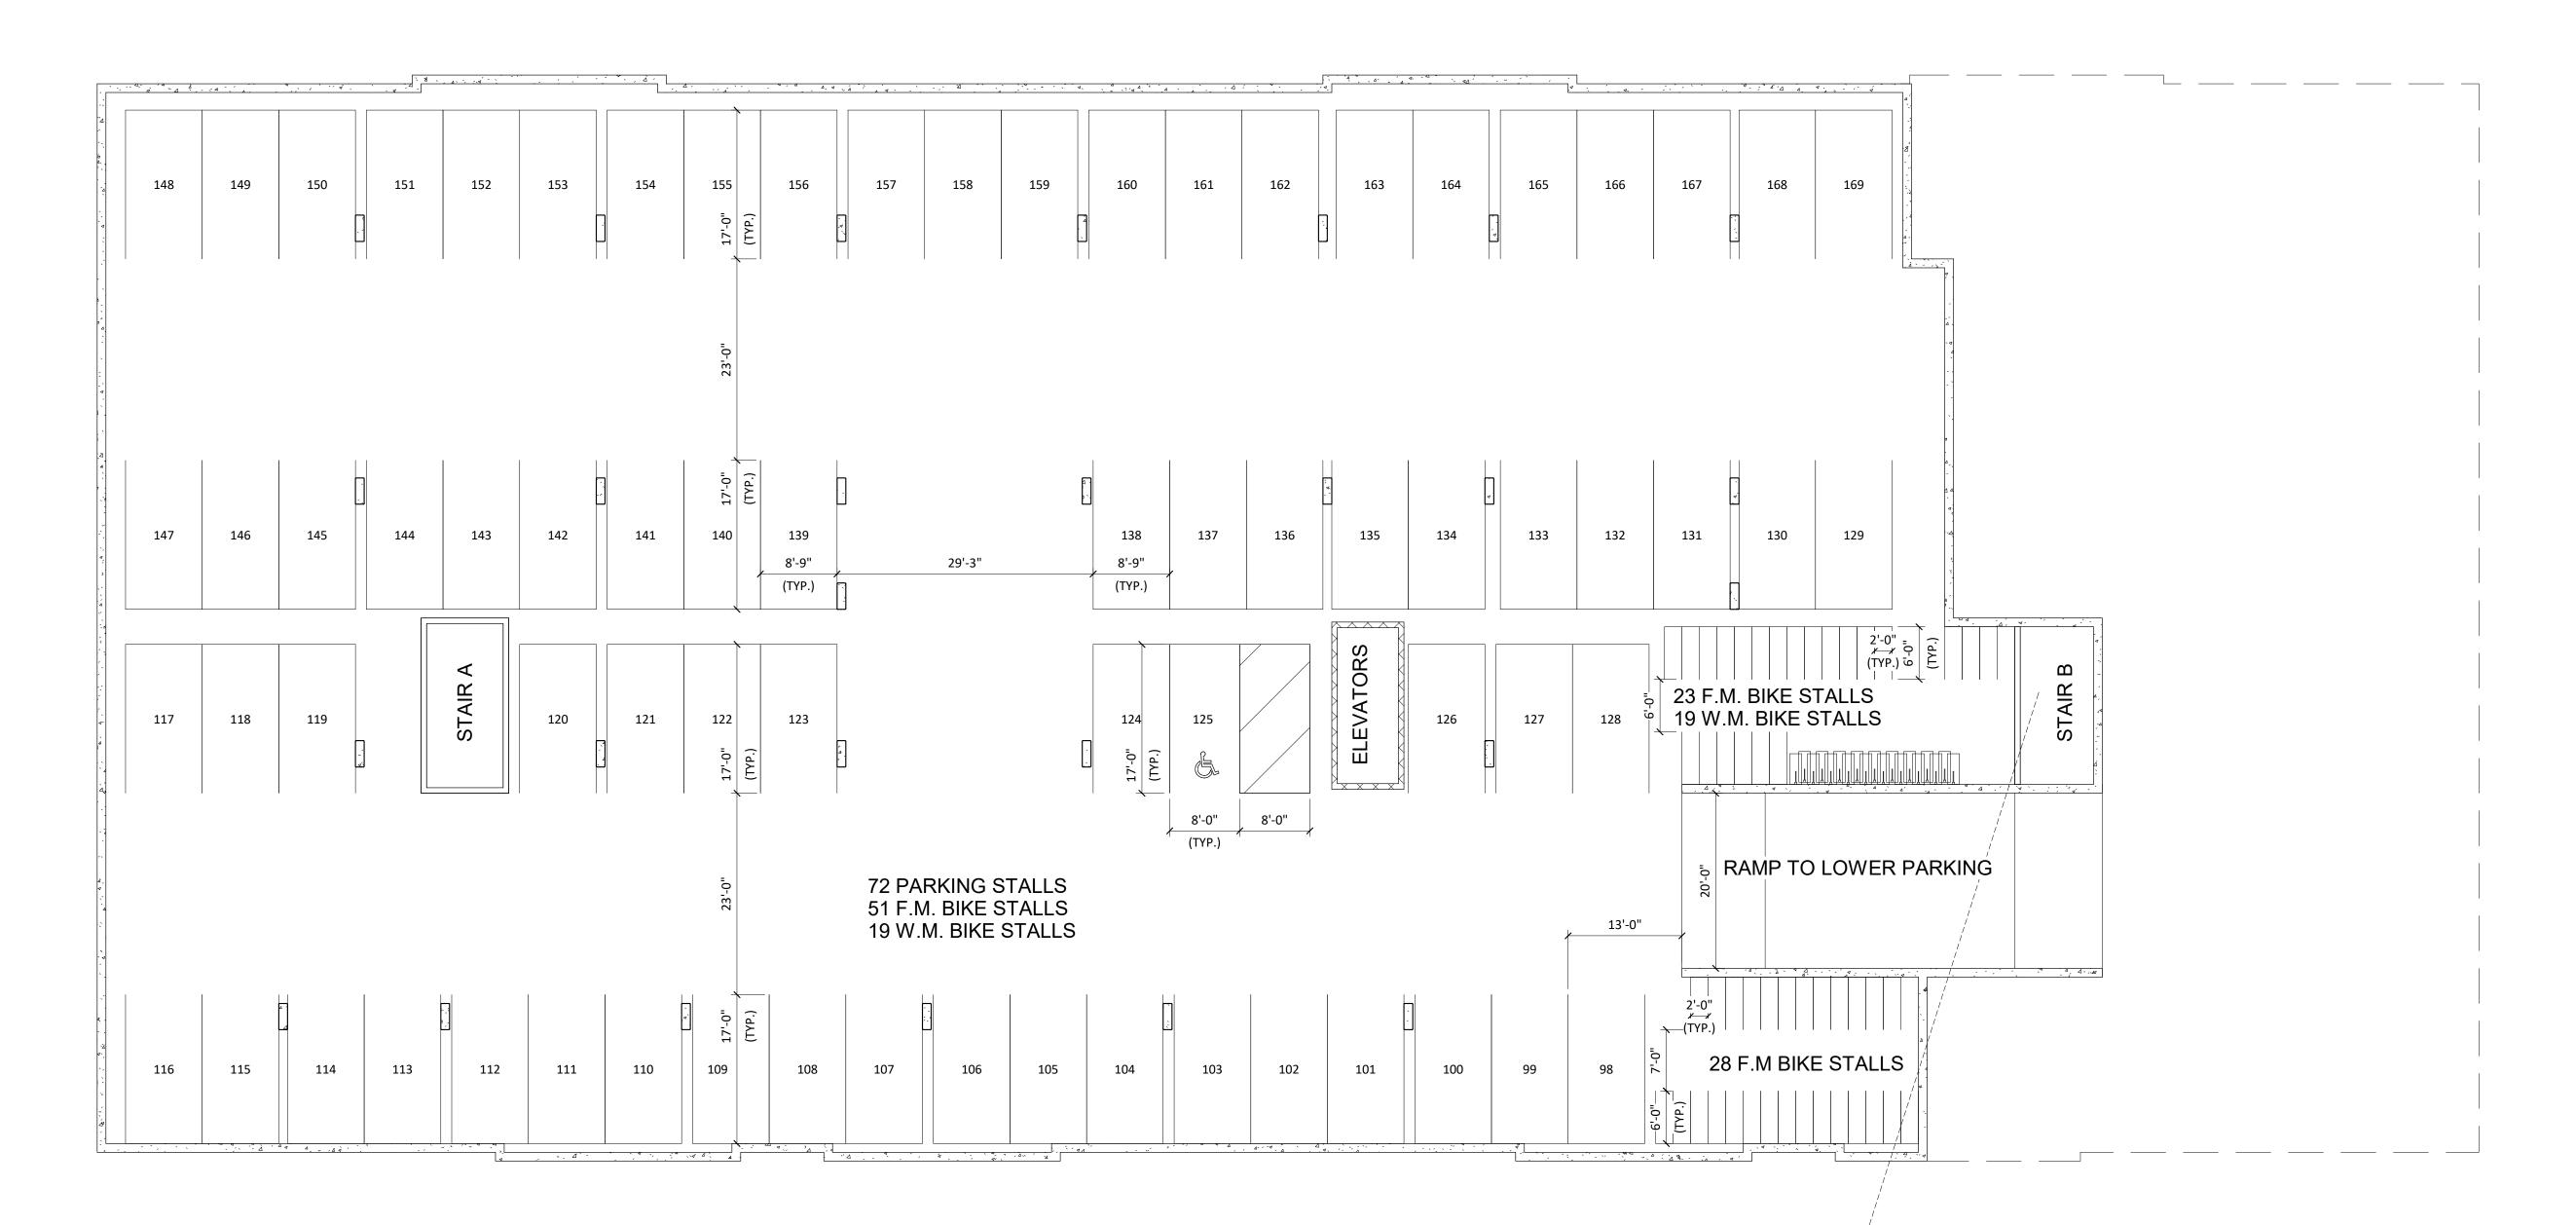

1 -00 - LOWER BASEMENT A-0.0 3/32" = 1'-0"

PROJECT TITLE

West Washington Development

608.836.3690 Middleton, WI 53562

TRUE NORTH

KEY PLAN

525-547 W Washington Ave.


Madison, Wisconsin
SHEET TITLE

LOWER

BASEMENT FLOOR PLAN

SHEET NUMBER

A-0.0PROJECT NUMBER 2143

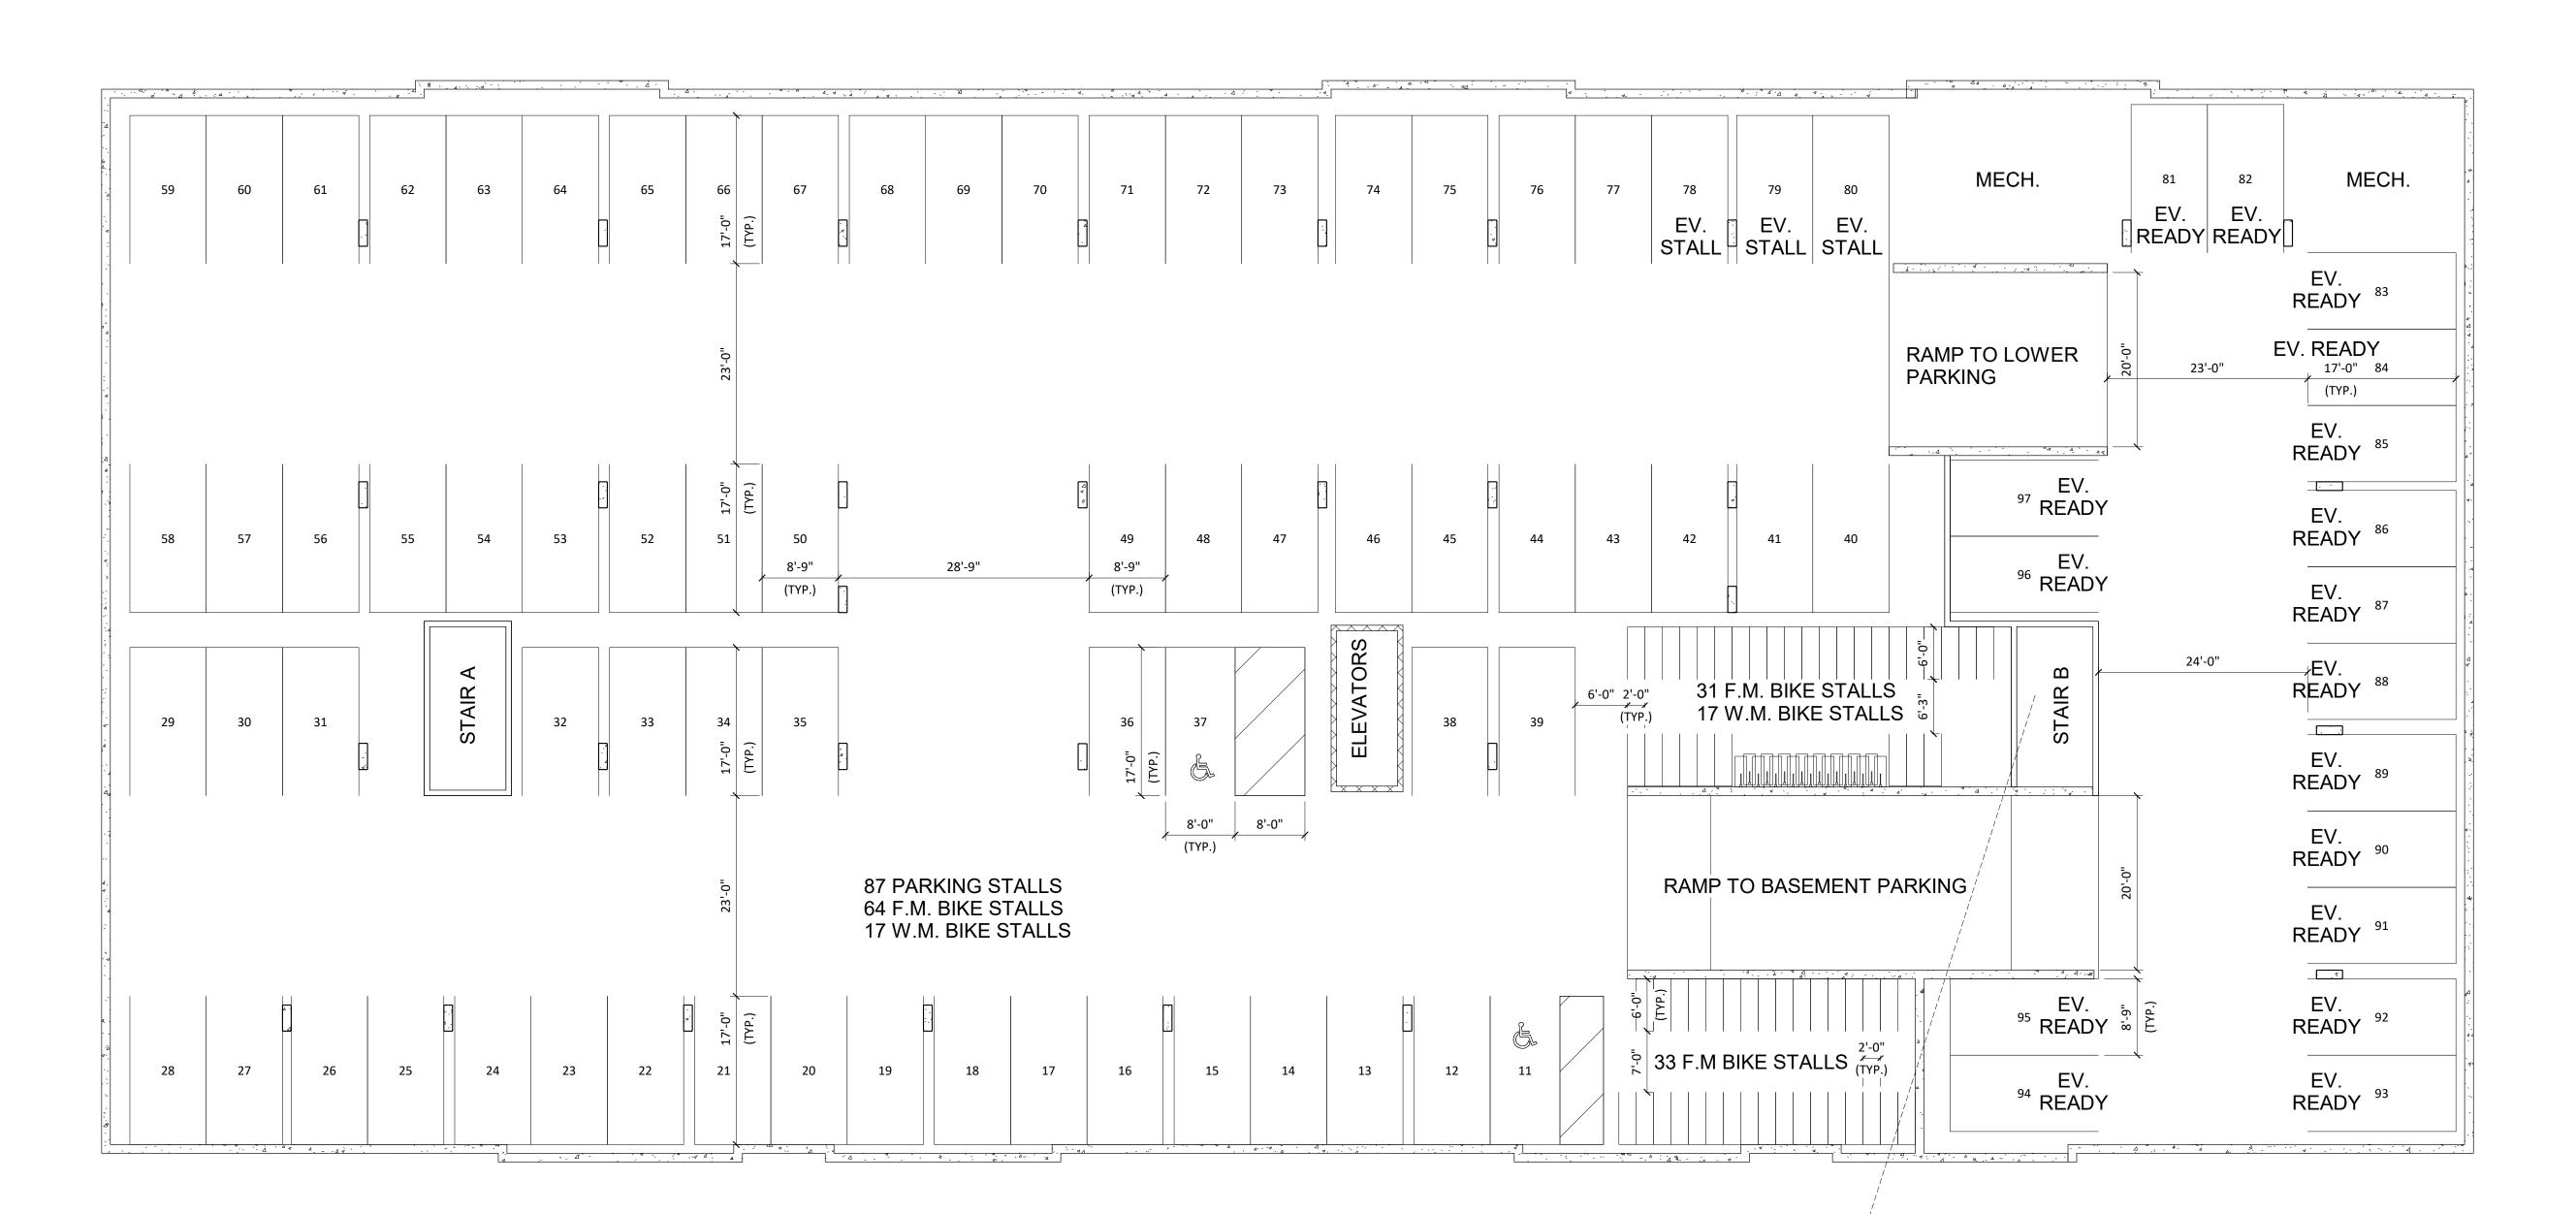

1 00 - BASEMENT A-1.0 3/32" = 1'-0"

knothe ARCHI Phone: 76 608.836.3690 TRUE NORTH KEY PLAN

ISSUED

West Washington
Development

525-547 W Washington Ave.

Madison, Wisconsin

SHEET TITLE


BASEMENT

FLOOR PLAN

SHEET NUMBER

A-1.0

PROJECT NUMBER 2143

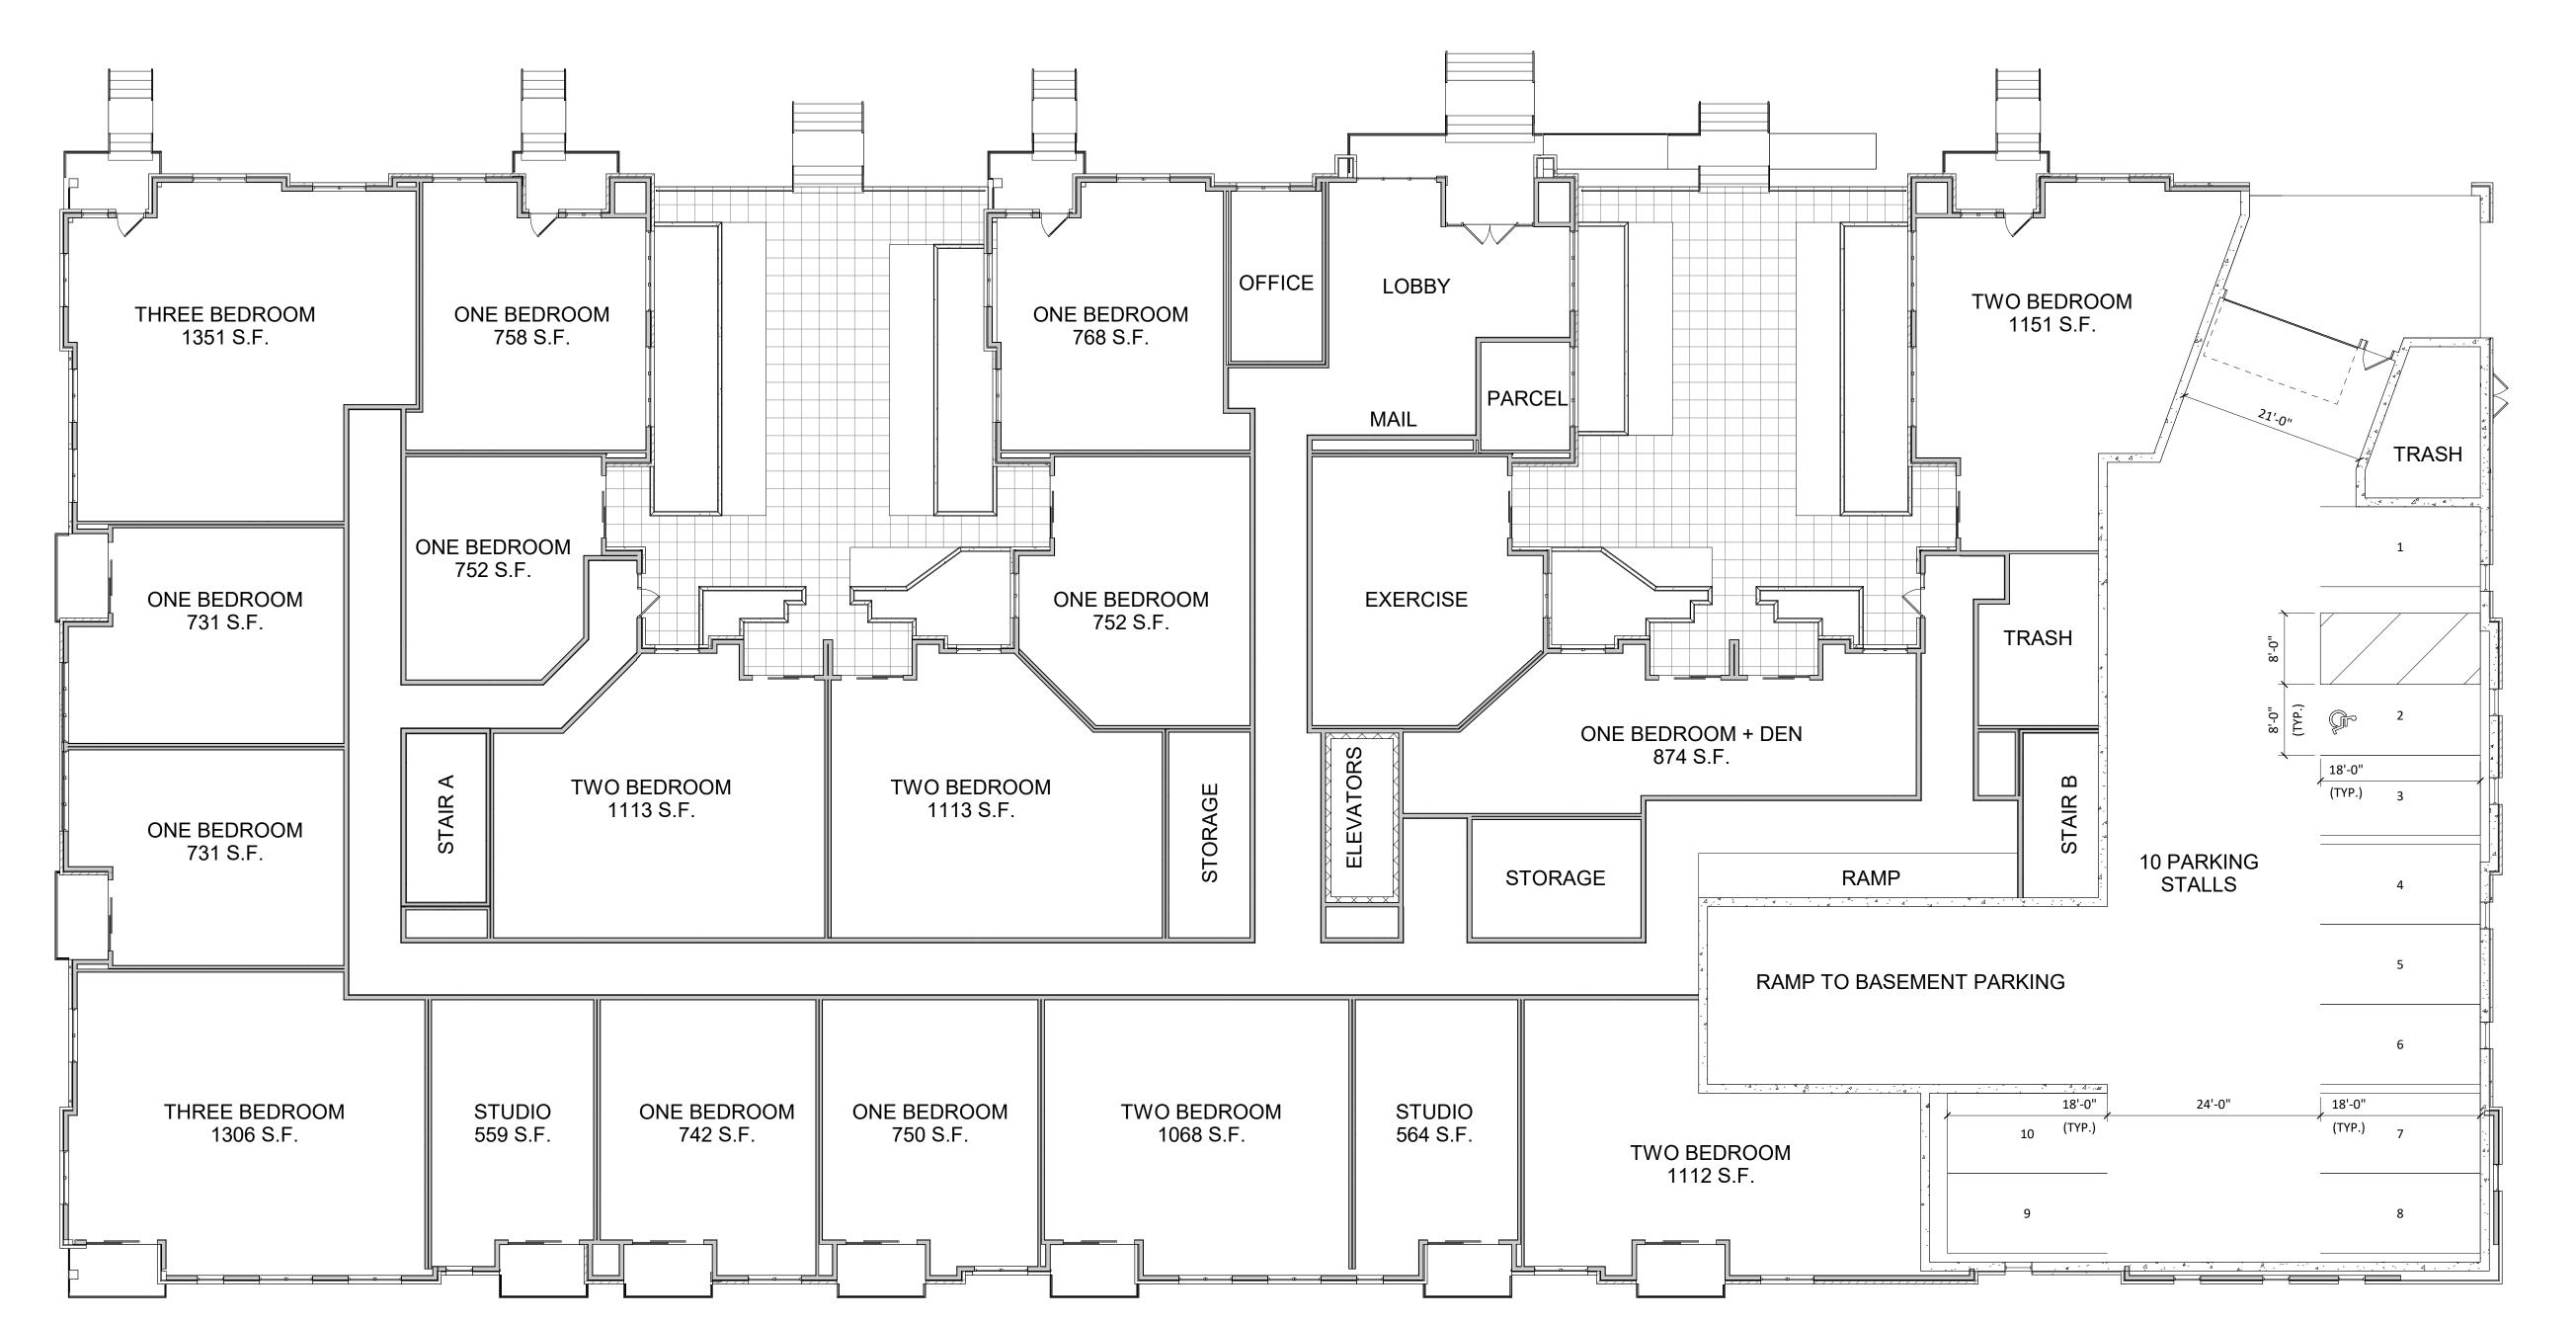

1 01 - FIRST FLOOR A-1.1 3/32" = 1'-0"

knothe bruce
ARCHITECTS
Phone:
7601 University Ave. #201
608.836.3690
Middleton, WI 53562

TRUE NORTH



KEY PLAN

ISSUED

PROJECT TITLE

West Washington Development

525-547 W Washington Ave.

Madison, Wisconsin


SHEET TITLE

FIRST FLOOR PLAN

SHEET NUMBER

A-1.1

PROJECT NUMBER 2143

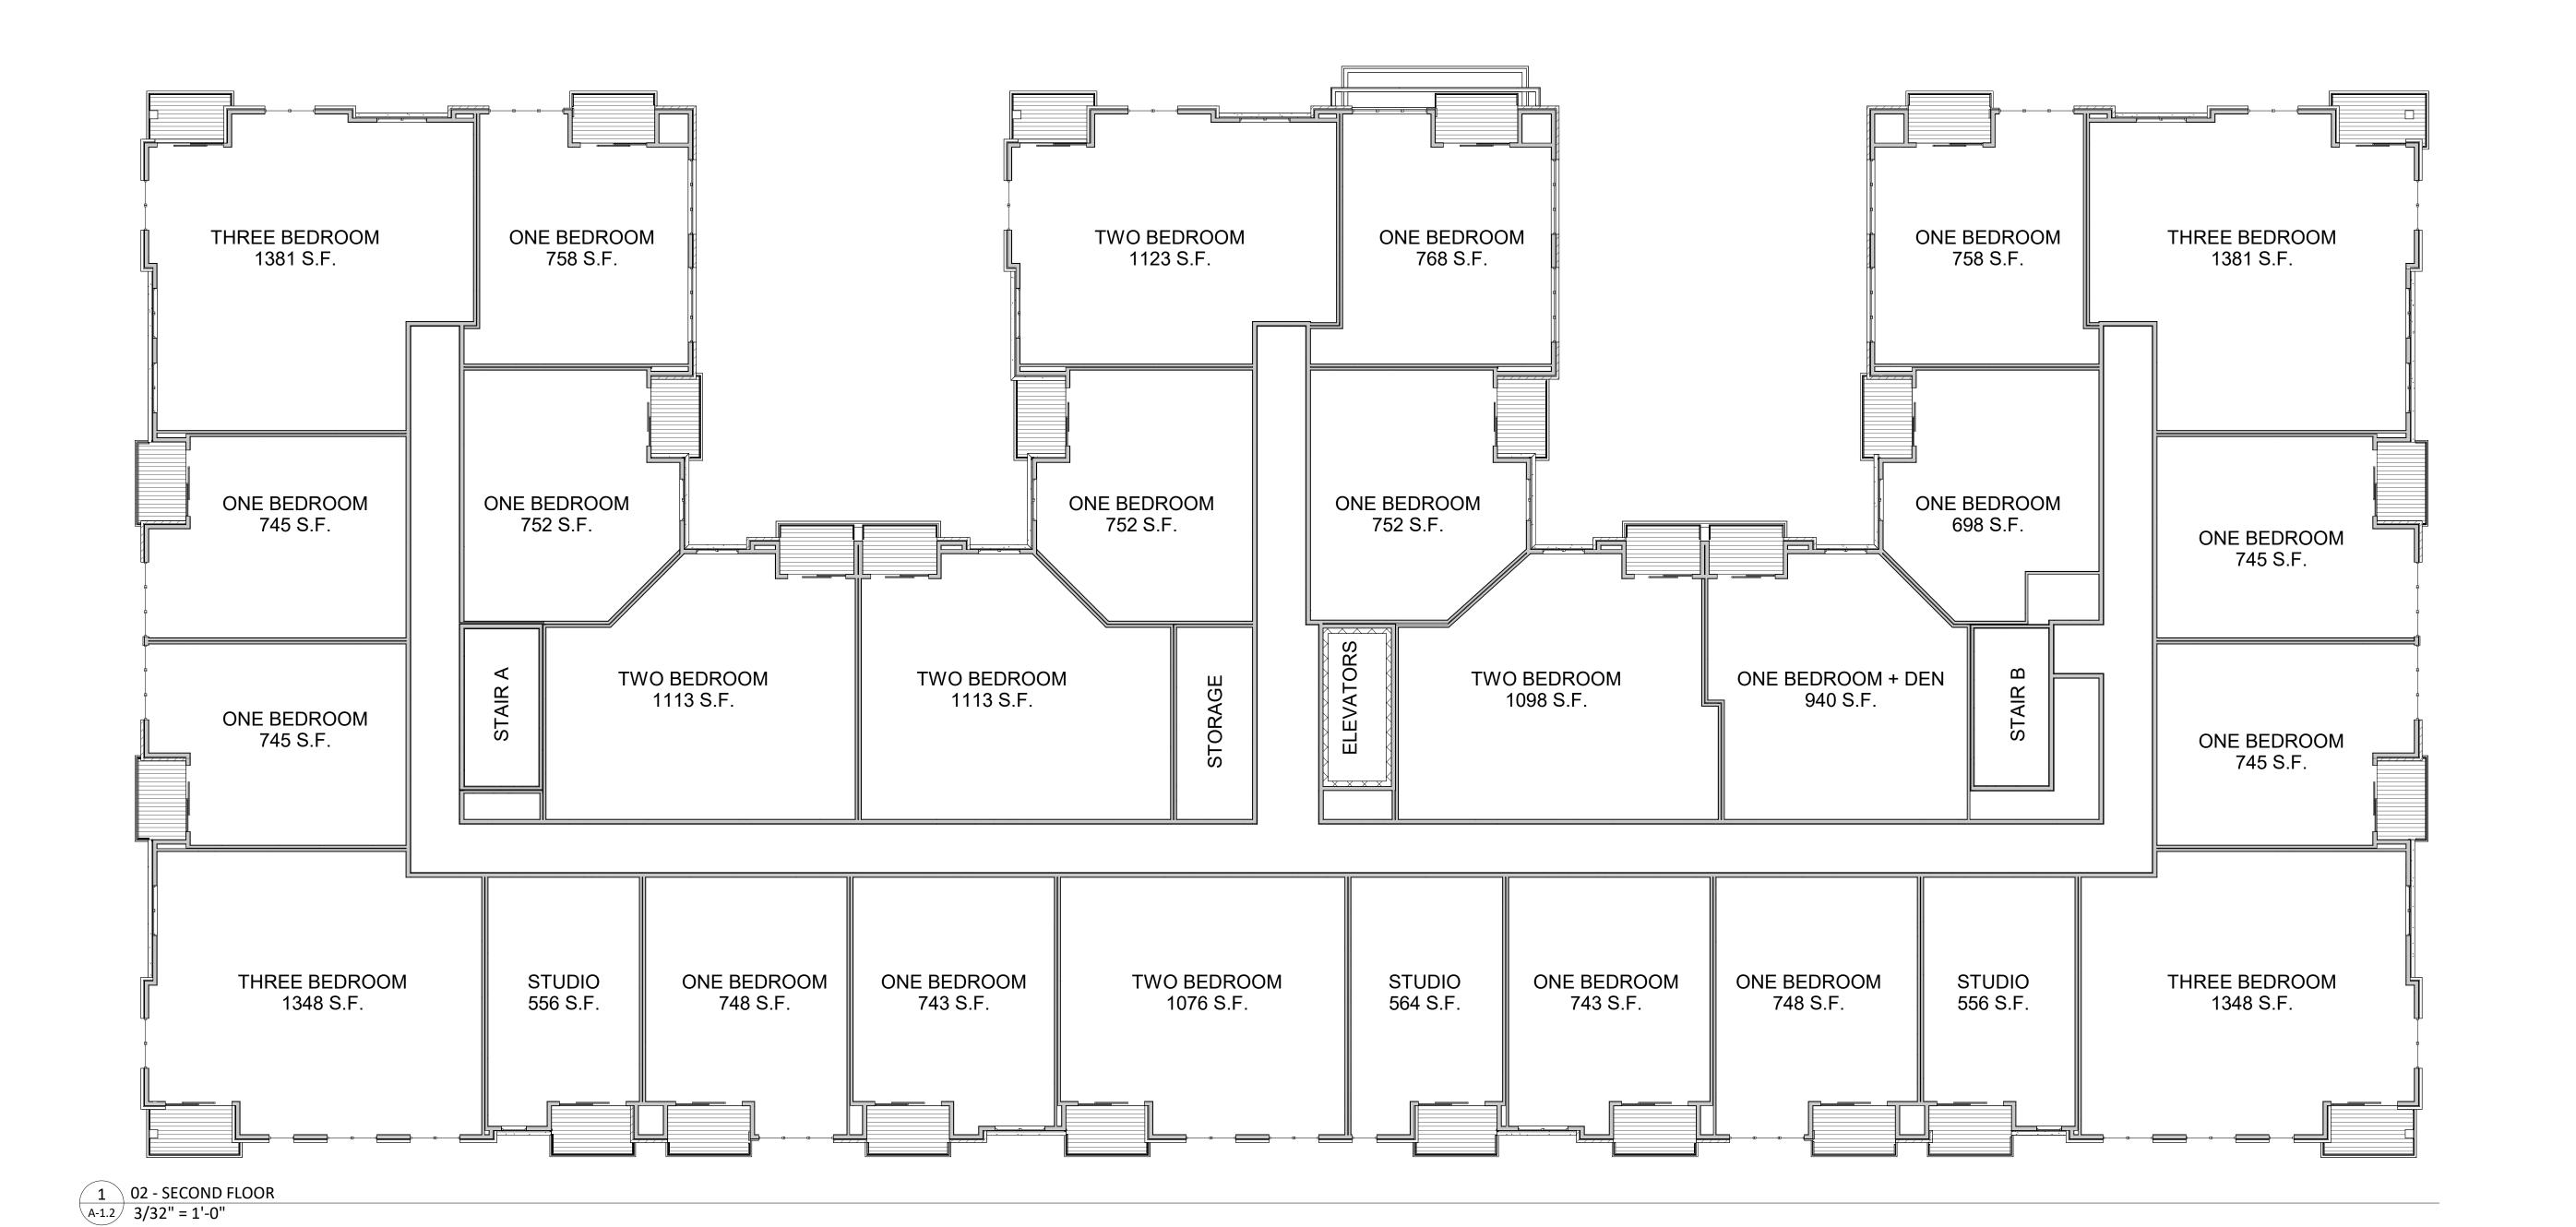

PROJECT TITLE

608.836.3690

KEY PLAN

ISSUED

TRUE NORTH

Middleton, WI 53562

West Washington Development

525-547 W Washington Ave.

Madison, Wisconsin

SHEET TITLE

SECOND FLOOR PLAN

SHEET NUMBER

A-1.2

PROJECT NUMBER 2143



1 03 - THIRD FLOOR A-1.3 3/32" = 1'-0"

PROJECT TITLE

608.836.3690

KEY PLAN

ISSUED

TRUE NORTH

Middleton, WI 53562

West Washington Development

525-547 W Washington Ave.

Madison, Wisconsin

SHEET TITLE

THIRD FLOOR PLAN

SHEET NUMBER

A-1.3

PROJECT NUMBER 2143



1 04 - FOURTH FLOOR A-1.4 3/32" = 1'-0"

PROJECT TITLE

608.836.3690

KEY PLAN

ISSUED

TRUE NORTH

Middleton, WI 53562

West Washington Development

525-547 W Washington Ave.


Madison, Wisconsin

SHEET TITLE

FOURTH FLOOR PLAN

SHEET NUMBER

A-1.4 PROJECT NUMBER 2143

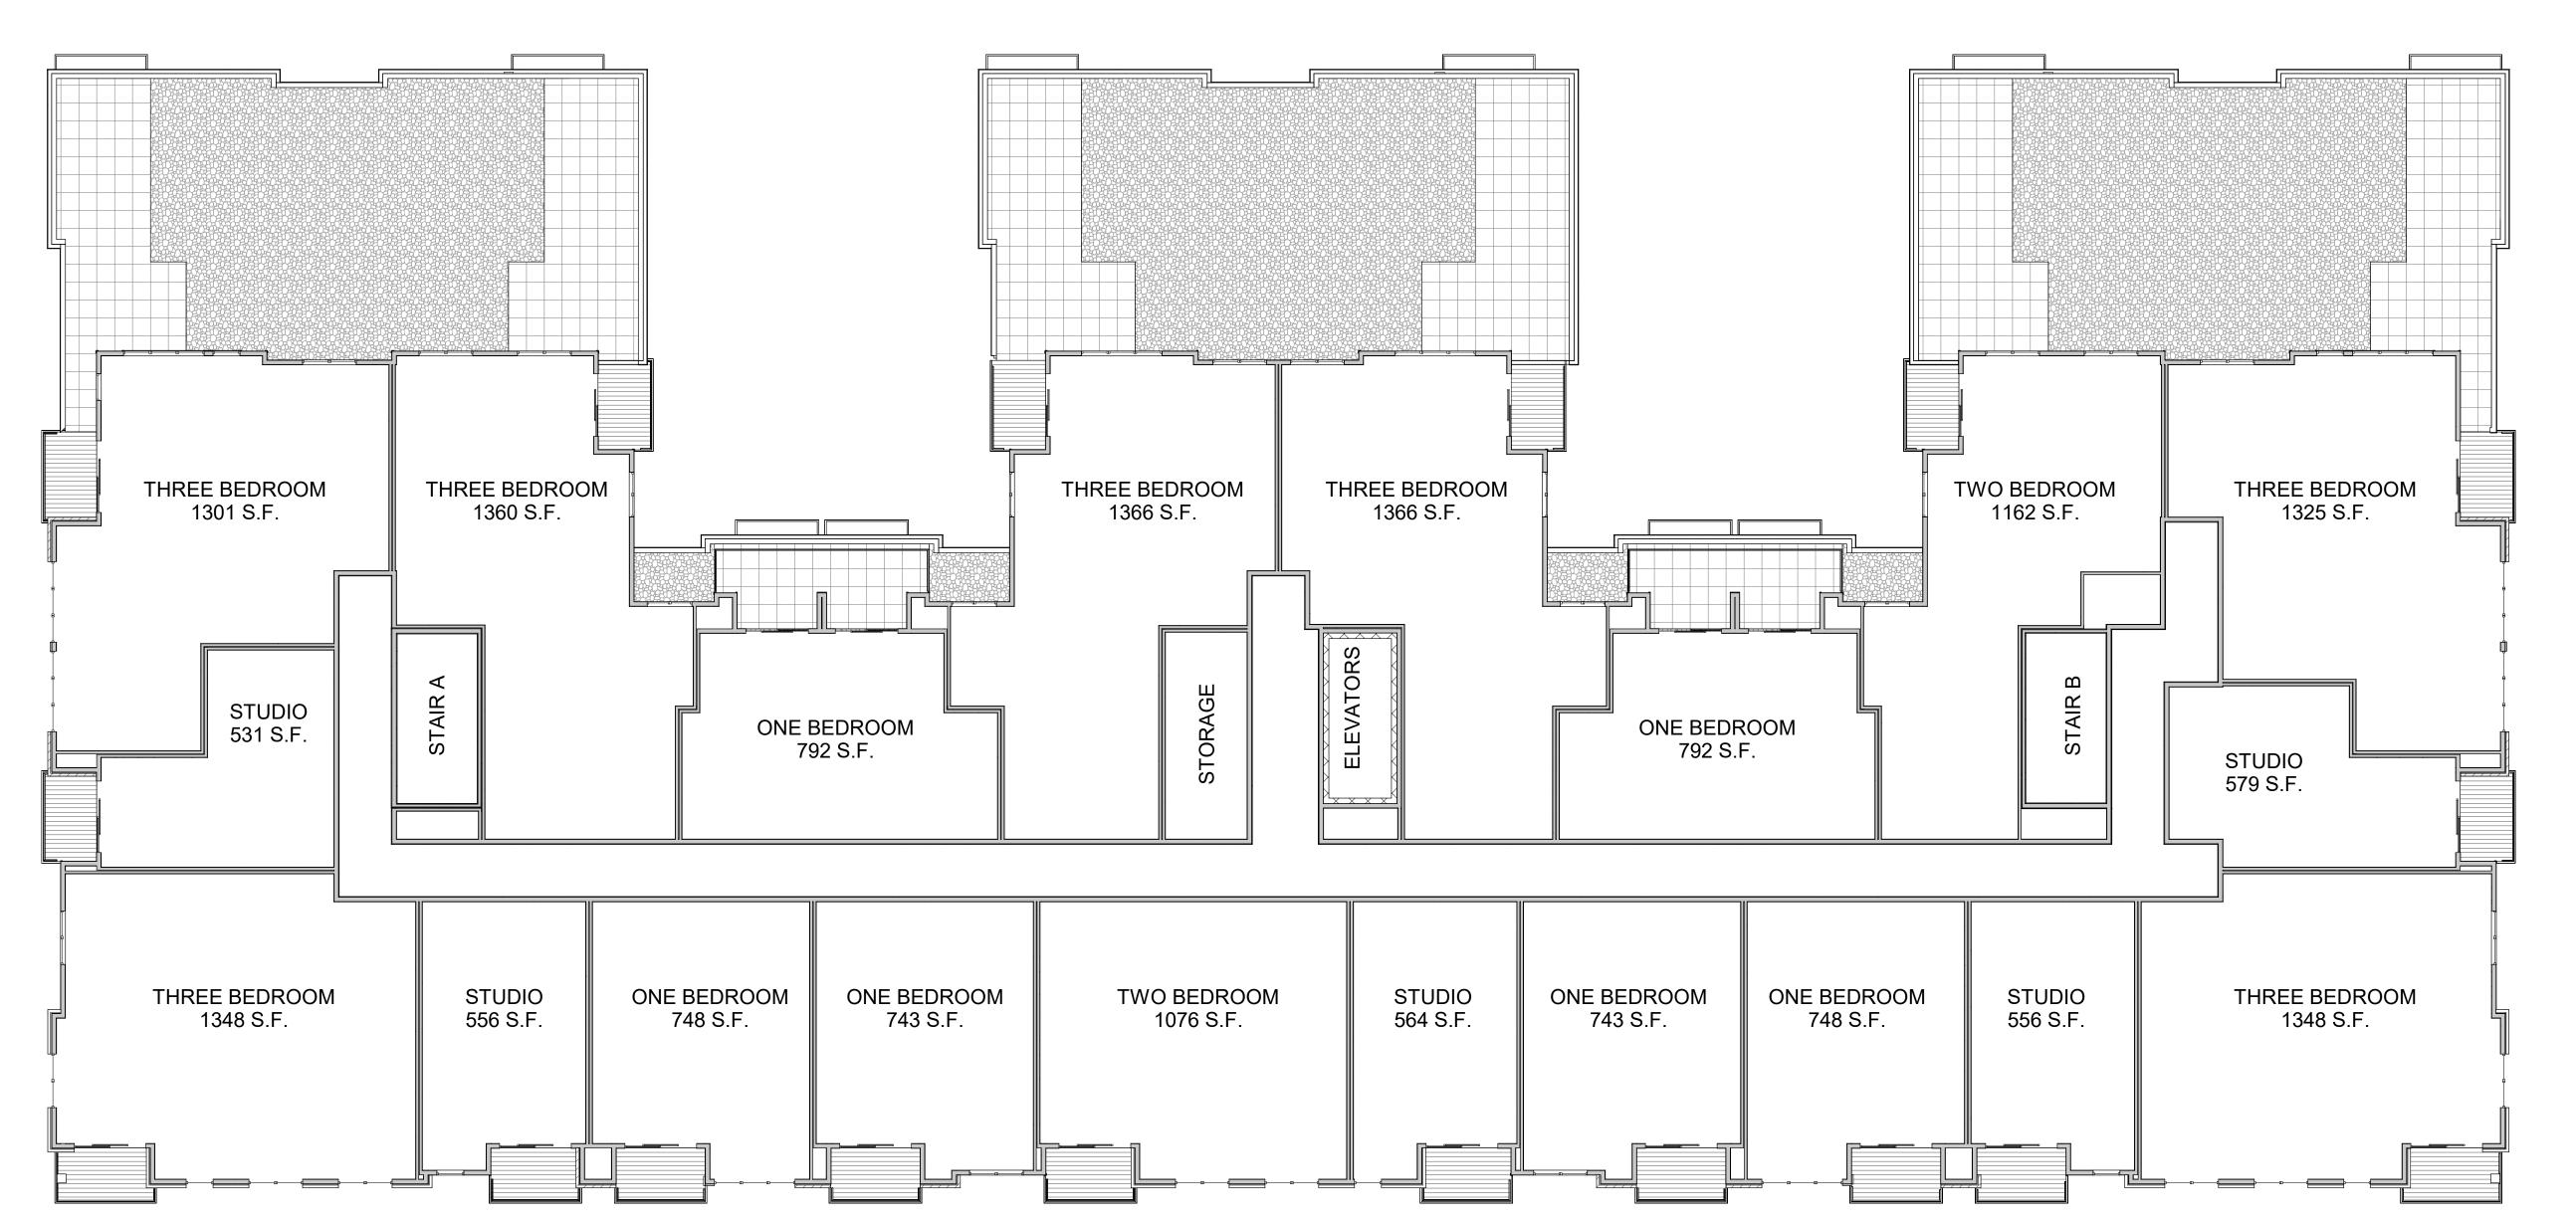

1 05 - FIFTH FLOOR A-1.5 3/32" = 1'-0"

608.836.3690

KEY PLAN

ISSUED

TRUE NORTH

Middleton, WI 53562

PROJECT TITLE

West Washington Development

525-547 W Washington Ave.

Madison, Wisconsin


SHEET TITLE

FIFTH FLOOR PLAN

SHEET NUMBER

A-1.5

PROJECT NUMBER 2143

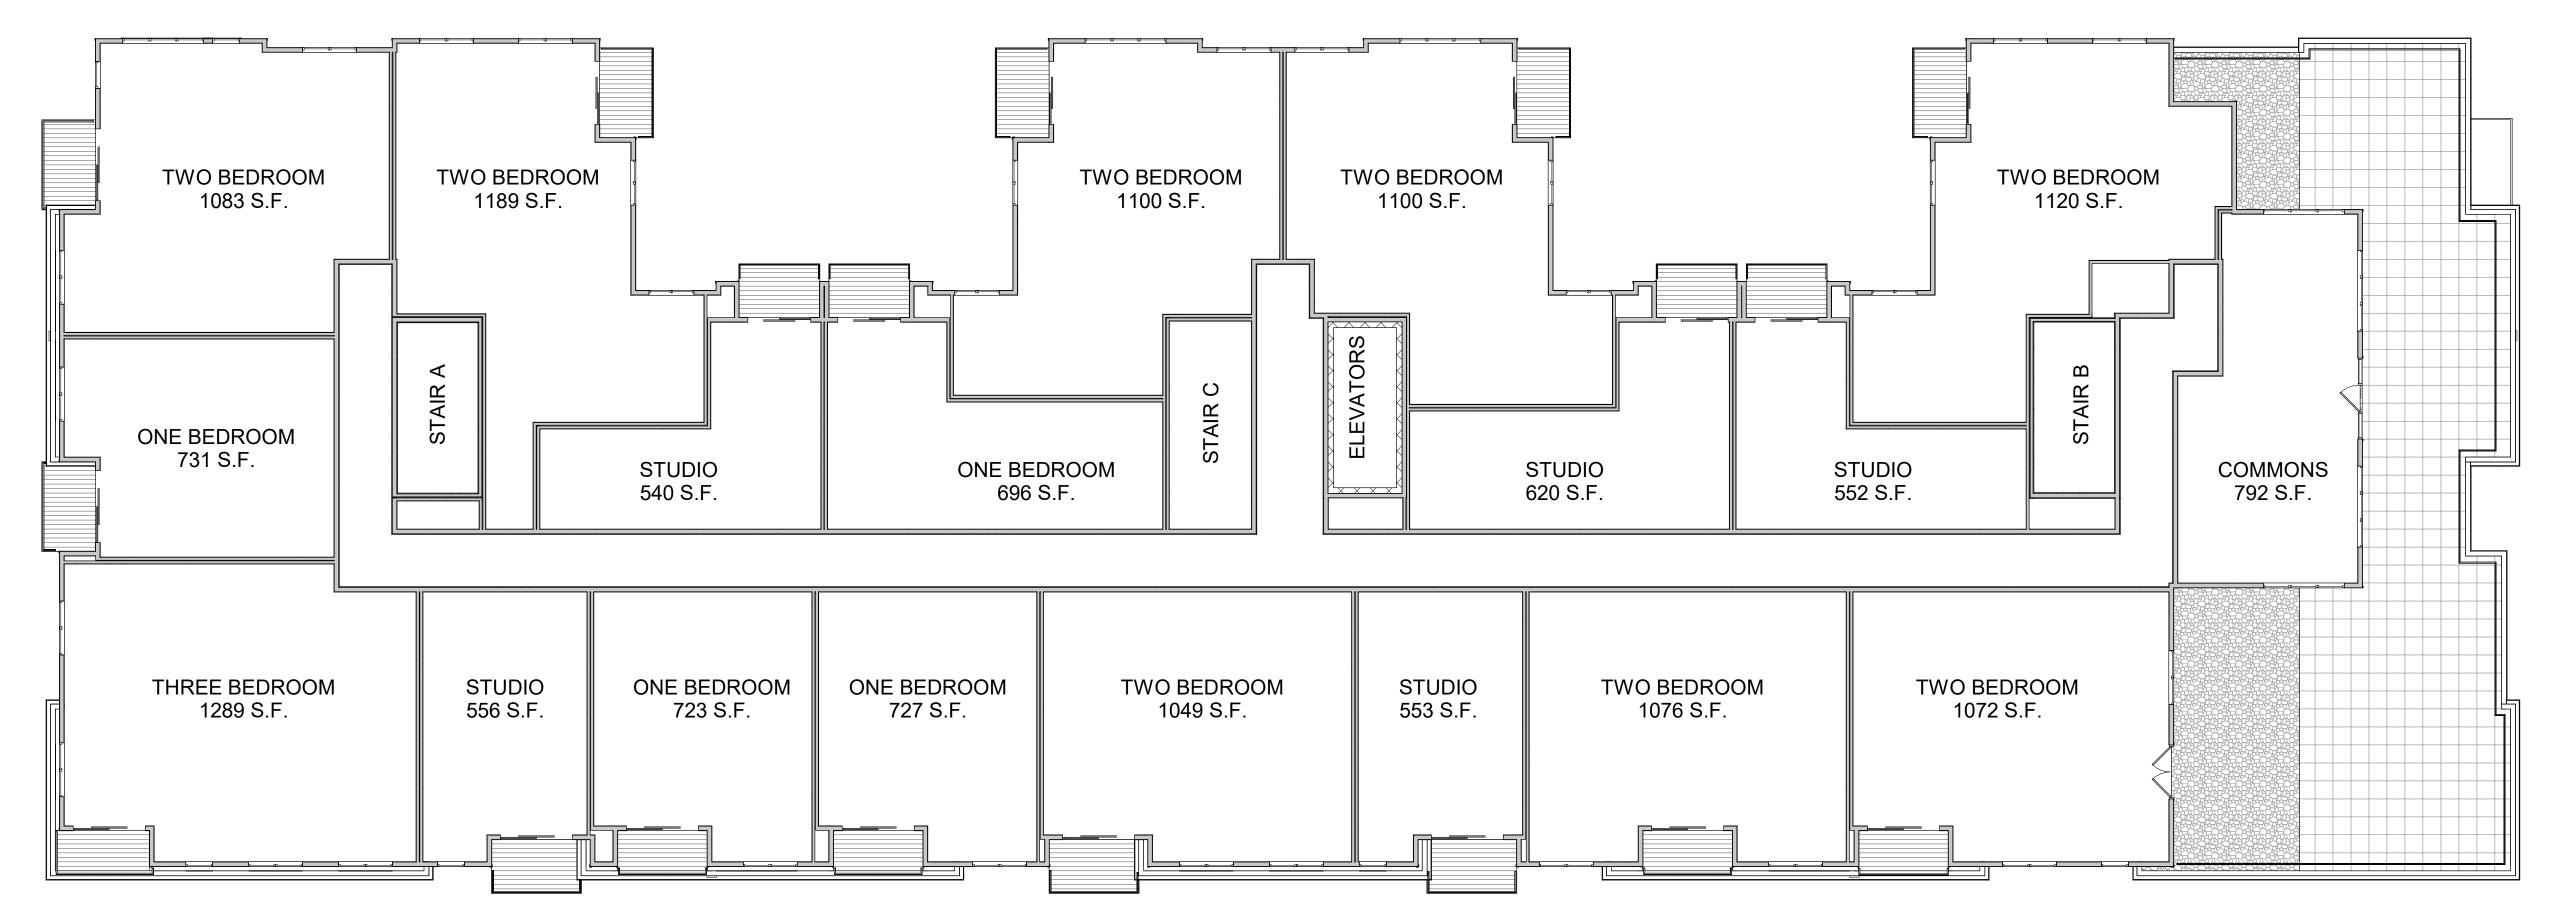

1 06 - SIXTH FLOOR A-1.6 3/32" = 1'-0"

608.836.3690

TRUE NORTH

KEY PLAN

ISSUED

Middleton, WI 53562

PROJECT TITLE

West Washington Development

525-547 W Washington Ave.

Madison, Wisconsin


SHEET TITLE

SIXTH FLOOR PLAN

SHEET NUMBER

A-1.6

PROJECT NUMBER 2143

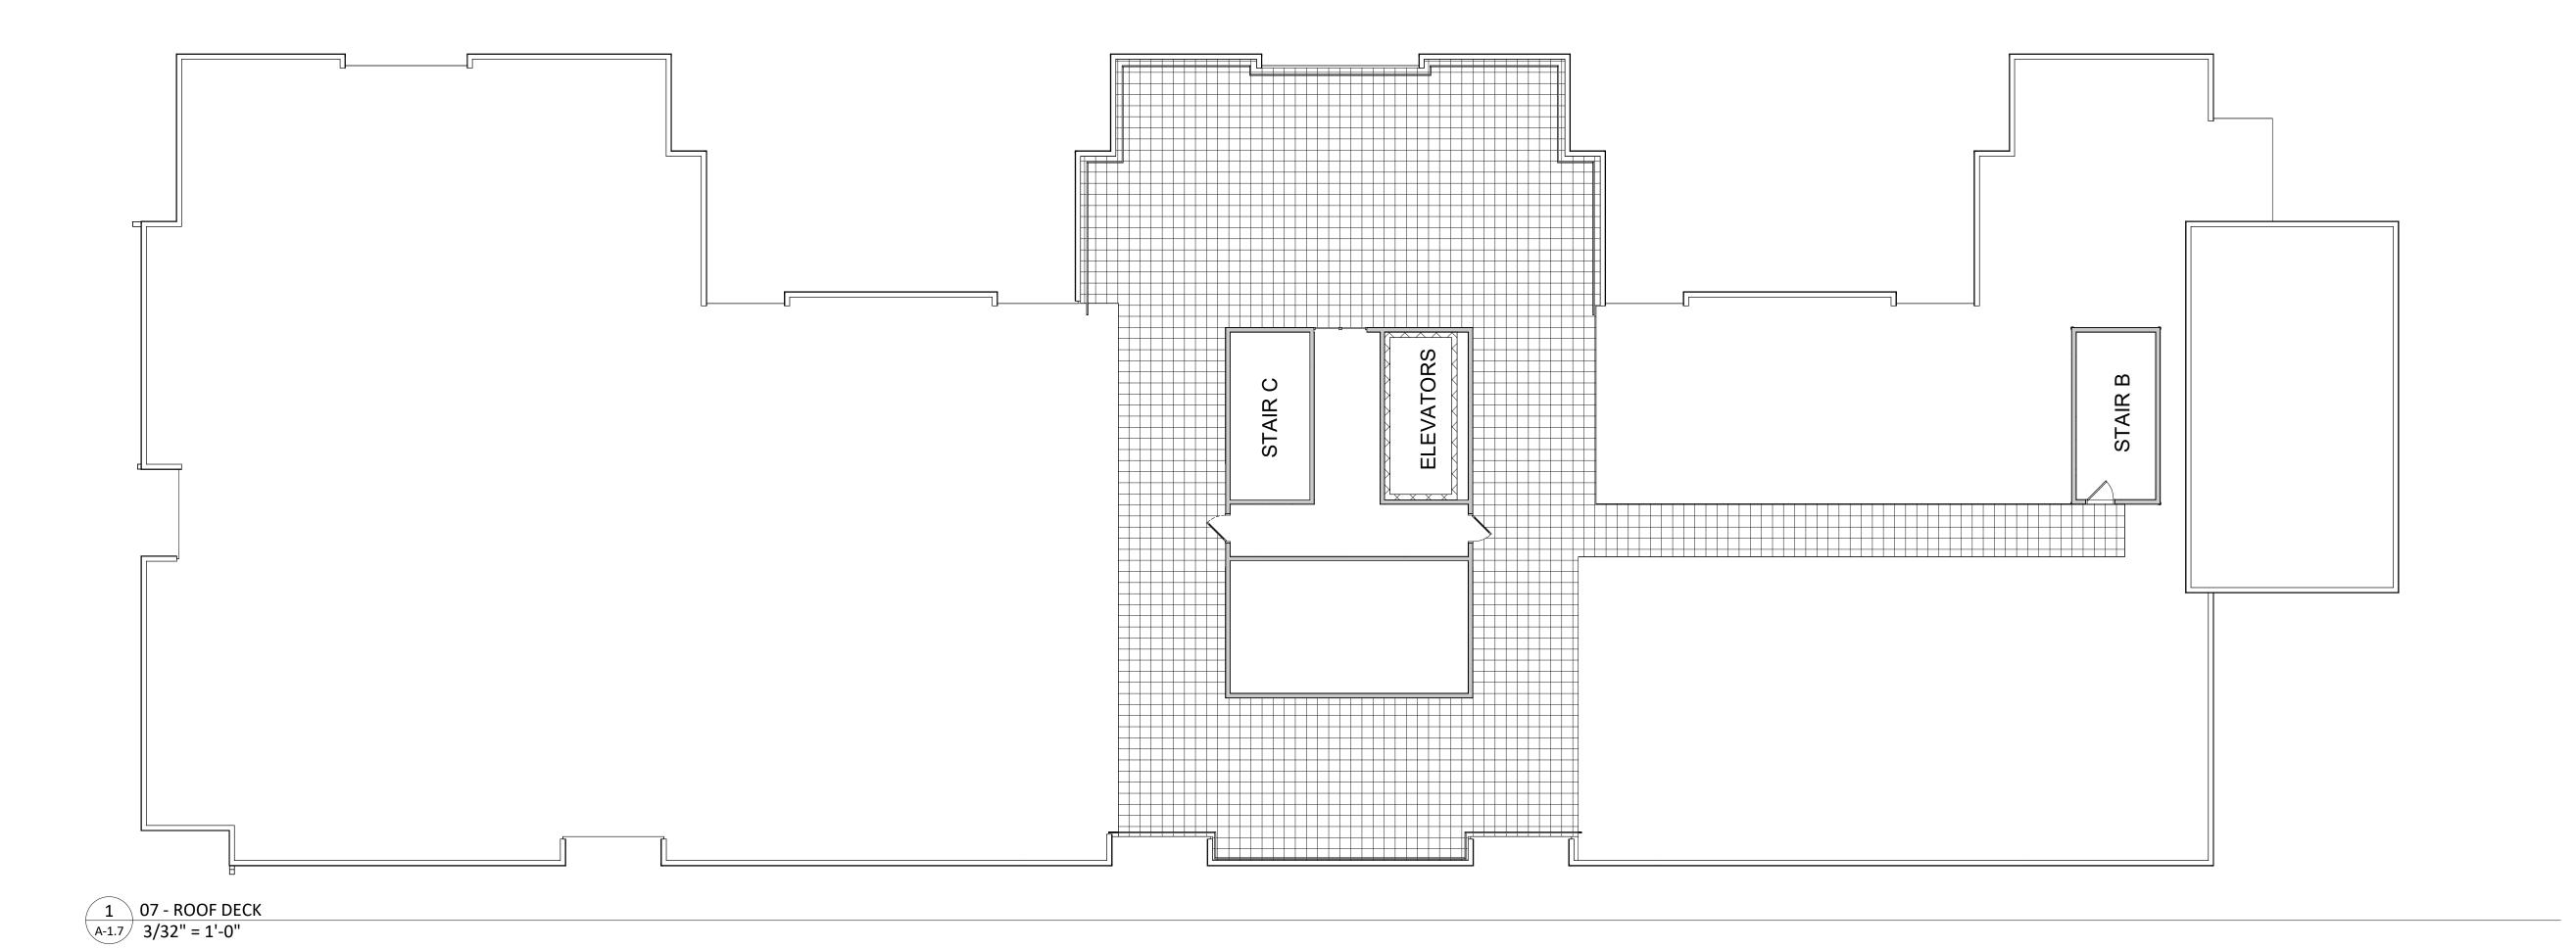

PROJECT TITLE

West Washington Development

608.836.3690 Middleton, WI 53562

TRUE NORTH

KEY PLAN

ISSUED

525-547 W Washington Ave.

Madison, Wisconsin

SHEET TITLE **ROOF DECK PLAN**

SHEET NUMBER

A-1.7 PROJECT NUMBER 2143



knothe bruce
ARCHITECTS
Phone: 7601 University Ave. #201
608.836.3690 Middleton, WI 53562

ISSUED

PROJECT TITLE

West Washington Development

525-547 W Washington Ave.

Madison, Wisconsin

SHEET TITLE

EXTERIOR

ELEVATIONS

SHEET NUMBER

A-2.1

PROJECT NUMBER 2143

© Knothe & Bruce Architects, LLC


EXTERIOR MATERIAL SCHEDULE BUILDING ELEMENT MANUFACTURER COLOR **BUILDING ELEMENT** MANUFACTURER COLOR ALMOND TBD METAL SIDING (#1) CAST STONE BANDS & SILLS **EDWARDS CAST STONE** CMG DARK BRONZE METAL SIDING (#2) COMPOSITE WINDOWS ANDERSEN 100 BLACK **COMPOSITE PANEL** JAMES HARDIE **IRON GRAY** BLACK ALUM. STOREFRONT MATCH ADJ. SIDING COLOR JAMES HARDIE COMPOSITE TRIM INSULATED METAL DOORS/FRAMES ALMOND JAMES HARDIE COLOR TO MATCH ADJ. TRIM/SIDING **BRICK VENEER (#1)** INTERSTATE BRICK CANOPY & BAY SOFFITS BLACK TUMBLEWEED RAILINGS & HANDRAILS SUPERIOR BRICK VENEER (#2) INTERSTATE BRICK TREATED-EXPOSED DECK BEAMS N/A **BROWN TREATED** SUNSET MASONRY BASE VENEER ARRISCRAFT

1 ELEVATION - NORTH 3/32" = 1'-0"

COMPOSITE TRIM METAL SIDING (#1) BRICK VENEER (#2) SIXTH FLOOR 154'-0" **ALUMINIUM RAILINGS** COMPOSITE PANEL FIFTH FLOOR 142'-8" COMPOSITE WINDOWS BRICK VENEER (#1) FOURTH FLOOR 131'-4" THIRD FLOOR 121'-0" CAST STONE SILLS/BANDS/HEADERS SECOND FLOOR 110'-8" CAST STONE FIRST FLOOR 100'-0" BASEMENT OWER BASEMENT 81'-4"

2 ELEVATION - SOUTH 3/32" = 1'-0"



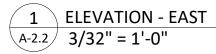



EXTERIOR MATERIAL SCHEDULE BUILDING ELEMENT MANUFACTURER COLOR BUILDING ELEMENT MANUFACTURER COLOR ALMOND METAL SIDING (#1) CAST STONE BANDS & SILLS EDWARDS CAST STONE METAL SIDING (#2) CMG DARK BRONZE COMPOSITE WINDOWS ANDERSEN 100 BLACK **COMPOSITE PANEL** JAMES HARDIE IRON GRAY BLACK ALUM. STOREFRONT MATCH ADJ. SIDING COLOR JAMES HARDIE COMPOSITE TRIM INSULATED METAL DOORS/FRAMES ALMOND JAMES HARDIE COLOR TO MATCH ADJ. TRIM/SIDING BRICK VENEER (#1) INTERSTATE BRICK CANOPY & BAY SOFFITS BLACK TUMBLEWEED RAILINGS & HANDRAILS SUPERIOR BRICK VENEER (#2) INTERSTATE BRICK **BROWN TREATED** SUNSET TREATED-EXPOSED DECK BEAMS MASONRY BASE VENEER ARRISCRAFT



ISSUED

PROJECT TITLE

West Washington Development

525-547 W Washington Ave.

Madison, Wisconsin


SHEET TITLE

EXTERIOR ELEVATIONS

SHEET NUMBER

A-2.2

PROJECT NUMBER 2143

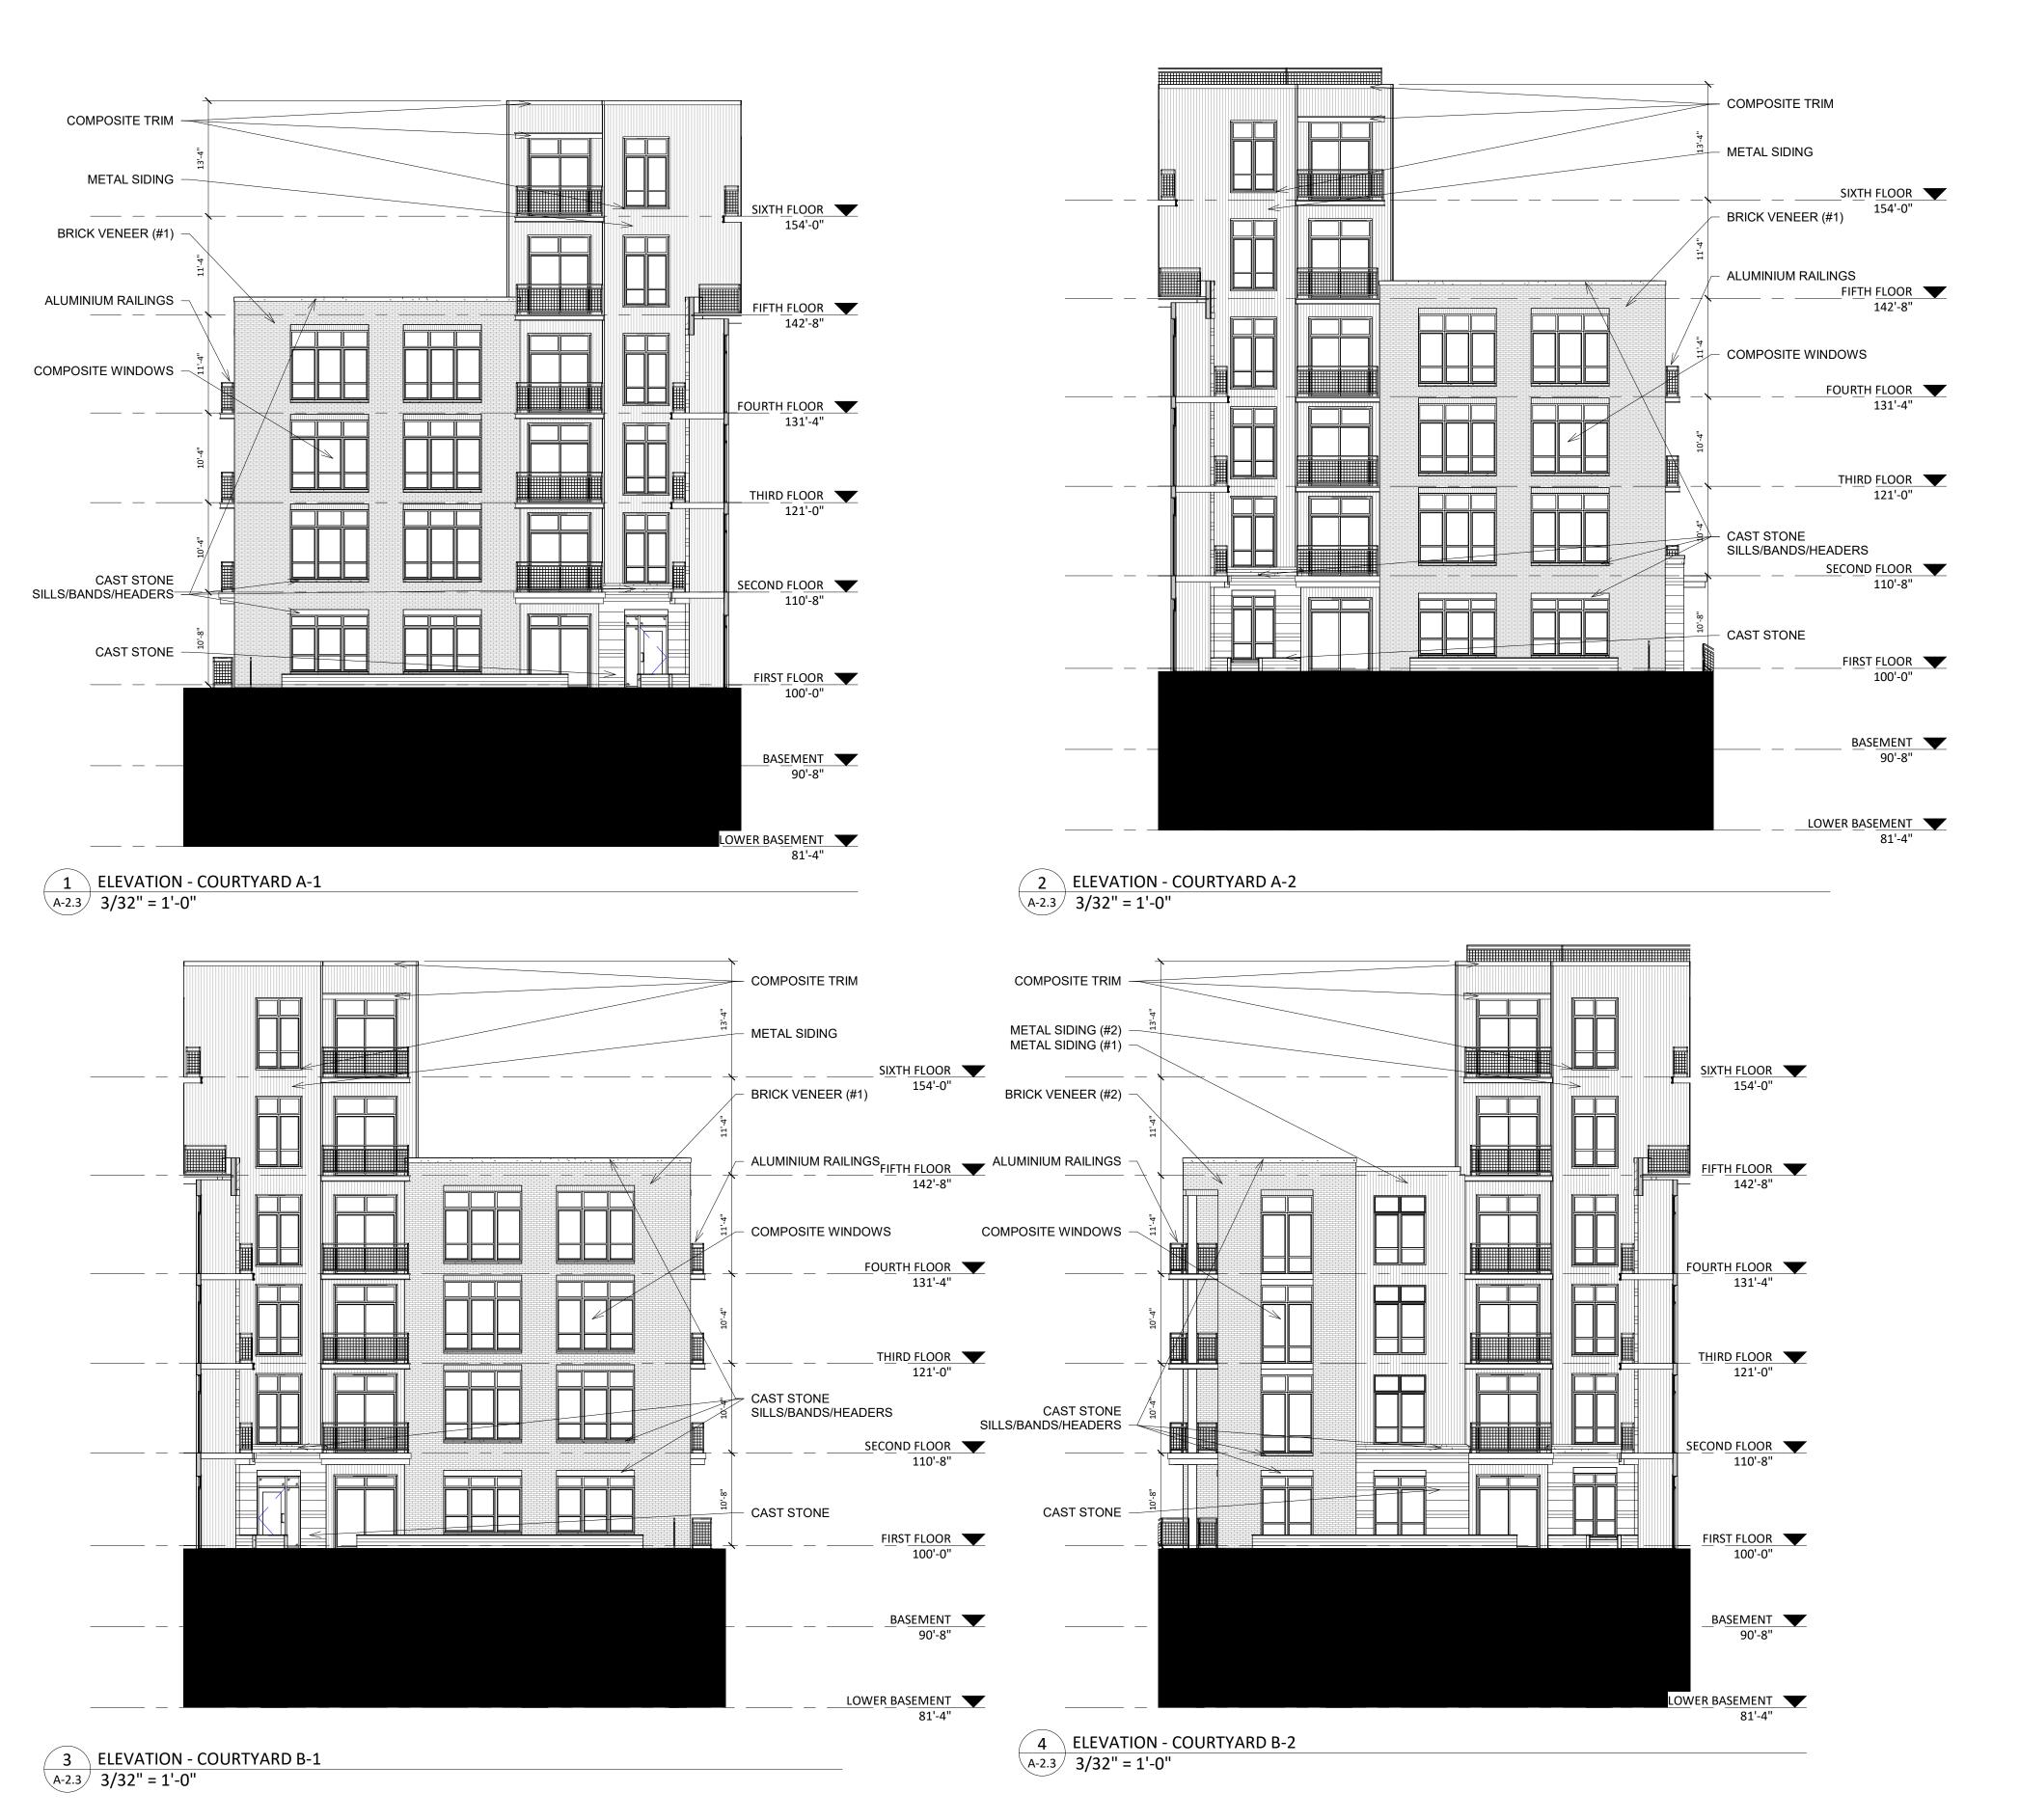

		EXTERIO	R MATERIAL SCHEDULE		
BUILDING ELEMENT	MANUFACTURER	COLOR	BUILDING ELEMENT	MANUFACTURER	COLOR
METAL SIDING (#1)	CMG	ALMOND	CAST STONE BANDS & SILLS	EDWARDS CAST STONE	TBD
METAL SIDING (#2)	CMG	DARK BRONZE	COMPOSITE WINDOWS	ANDERSEN 100	BLACK
COMPOSITE PANEL	JAMES HARDIE	IRON GRAY	ALUM. STOREFRONT	N/A	BLACK
COMPOSITE TRIM	JAMES HARDIE	MATCH ADJ. SIDING COLOR	INSULATED METAL DOORS/FRAMES	N/A	TBD
BRICK VENEER (#1)	INTERSTATE BRICK	ALMOND	CANOPY & BAY SOFFITS	JAMES HARDIE	COLOR TO MATCH ADJ. TRIM/SIDING
BRICK VENEER (#2)	INTERSTATE BRICK	TUMBLEWEED	RAILINGS & HANDRAILS	SUPERIOR	BLACK
MASONRY BASE VENEER	ARRISCRAFT	SUNSET	TREATED-EXPOSED DECK BEAMS	N/A	BROWN TREATED



ISSUED

PROJECT TITLE

West Washington Development

525-547 W Washington Ave.

Madison, Wisconsin

SHEET TITLE

EXTERIOR

ELEVATIONS

SHEET NUMBER

A-2.3

PROJECT NUMBER 2143



knothe bruce
ARCHITECTS
Phone: 7601 University Ave. #201
608.836.3690 Middleton, WI 53562

ISSUED

PROJECT TITLE

West Washington Development

525-547 W Washington Ave.

Madison, Wisconsin

COLORED EXTERIOR ELEVATIONS

SHEET NUMBER

Λ_7

PROJECT NUMBER 2143

© Knothe & Bruce Architects, LLC

······

COMPOSITE TRIM — METAL SIDING (#1) BRICK VENEER (#2) SIXTH FLOOR 154'-0" ALUMINIUM RAILINGS COMPOSITE PANEL FIFTH FLOOR 142'-8" \blacksquare COMPOSITE WINDOWS BRICK VENEER (#1) FOURTH FLOOR H 131'-4" THIRD FLOOR 121'-0" H CAST STONE SILLS/BANDS/HEADERS SECOND FLOOR 110'-8" CAST STONE FIRST FLOOR 100'-0" BASEMENT \ LOWER BASEMENT 81'-4"

2 COLORED - ELEVATION - SOUTH 3/32" = 1'-0"

			EXTERIO	R MATERIAL SCHEDULE		
JILDING ELEMENT		MANUFACTURER	COLOR	BUILDING ELEMENT	MANUFACTURER	COLOR
ETAL SIDING (#1)		CMG	ALMOND	CAST STONE BANDS & SILLS	EDWARDS CAST STONE	TBD
ETAL SIDING (#2)		CMG	DARK BRONZE	COMPOSITE WINDOWS	ANDERSEN 100	BLACK
OMPOSITE PANEL		JAMES HARDIE	IRON GRAY	ALUM. STOREFRONT	N/A	BLACK
OMPOSITE TRIM		JAMES HARDIE	MATCH ADJ. SIDING COLOR	INSULATED METAL DOORS/FRAMES	N/A	TBD
RICK VENEER (#1)		INTERSTATE BRICK	ALMOND	CANOPY & BAY SOFFITS	JAMES HARDIE	COLOR TO MATCH ADJ. TRIM/SIDING
RICK VENEER (#2)		INTERSTATE BRICK	TUMBLEWEED	RAILINGS & HANDRAILS	SUPERIOR	BLACK
ASONRY BASE VENEER	***************************************	ARRISCRAFT	SUNSET	TREATED-EXPOSED DECK BEAMS	N/A······	BROWN TREATED



1 COLORED - ELEVATION - EAST A-2.5 3/32" = 1'-0"



			EXTERIO	R MATERIAL SCHEDULE		
JILDING ELEMENT		MANUFACTURER	COLOR	BUILDING ELEMENT	MANUFACTURER	COLOR
ETAL SIDING (#1)		CMG	ALMOND	CAST STONE BANDS & SILLS	EDWARDS CAST STONE	TBD
ETAL SIDING (#2)		CMG	DARK BRONZE	COMPOSITE WINDOWS	ANDERSEN 100	BLACK
OMPOSITE PANEL		JAMES HARDIE	IRON GRAY	ALUM. STOREFRONT	N/A	BLACK
OMPOSITE TRIM		JAMES HARDIE	MATCH ADJ. SIDING COLOR	INSULATED METAL DOORS/FRAMES	N/A	TBD
ICK VENEER (#1)		INTERSTATE BRICK	ALMOND	CANOPY & BAY SOFFITS	JAMES HARDIE	COLOR TO MATCH ADJ. TRIM/SIDING
ICK VENEER (#2)	1.1.1	INTERSTATE BRICK	TUMBLEWEED	RAILINGS & HANDRAILS	SUPERIOR	BLACK
ASONRY BASE VENEER		ARRISCRAFT	SUNSET	TREATED-EXPOSED DECK BEAMS	N/A	BROWN TREATED

knot
A R C
Phone:
608.836.3690

PROJECT TITLE

West Washington Development

525-547 W Washington Ave.

Madison, Wisconsin

SHEET TITLE
COLORED

EXTERIOR ELEVATIONS

SHEET NUMBER

A-2.5

PROJECT NUMBER 2143



1 COLORED - ELEVATION - COURTYARD A-1 A-2.6 3/32" = 1'-0"



3 COLORED - ELEVATION - COURTYARD B-1 3/32" = 1'-0"



2 COLORED - ELEVATION - COURTYARD A-2
A-2.6 3/32" = 1'-0"



4 COLORED - ELEVATION - COURTYARD B-2
A-2.6 3/32" = 1'-0"

		EXTERIO	R MATERIAL SCHEDULE		
ILDING ELEMENT	MANUFACTURER	COLOR	BUILDING ELEMENT	MANUFACTURER	COLOR
TAL SIDING (#1)	CMG	ALMOND	CAST STONE BANDS & SILLS	EDWARDS CAST STONE	TBD
TAL SIDING (#2)	CMG	DARK BRONZE	COMPOSITE WINDOWS	ANDERSEN 100	BLACK
MPOSITE PANEL	JAMES HARDIE	IRON GRAY	ALUM. STOREFRONT	N/A	BLACK
MPOSITE TRIM	JAMES HARDIE	MATCH ADJ. SIDING COLOR	INSULATED METAL DOORS/FRAMES	N/A	TBD
ICK VENEER (#1)	INTERSTATE BRICK	ALMOND	CANOPY & BAY SOFFITS	JAMES HARDIE	COLOR TO MATCH ADJ. TRIM/SIDING
ICK VENEER (#2)	INTERSTATE BRICK	TUMBLEWEED	RAILINGS & HANDRAILS	SUPERIOR	BLACK
ASONRY BASE VENEER	ARRISCRAFT	SUNSET	TREATED-EXPOSED DECK BEAMS	N/A	BROWN TREATED

608.836.3690

PROJECT TITLE

ISSUED

West Washington Development

525-547 W Washington Ave.

Ave. Madison, Wisconsin

SHEET TITLE

COLORED

EXTERIOR ELEVATIONS

SHEET NUMBER

A-2.6

PROJECT NUMBER 2143























Metal Siding #1 CMG Almond



Metal Siding #2 CMG Dark Bronze



Composite Panel James Hardie Iron Gray



Masonry Base Veneer Arriscraft Sunset

Window Trim - Black



Brick Veneer #1 Interstate Brick Almond



Brick Veneer #2 Interstate Brick Tumbleweed



Cast Stone Elements Edwards Cast Stone



EXTERIOR M			TER
BUILDING ELEMENT	MANUFACTURER	COLOR	
METAL SIDING (#1)	CMG	ALMOND	
METAL SIDING (#2)	CMG	DARK BRONZE	
COMPOSITE PANEL	JAMES HARDIE	IRON GRAY	
COMPOSITE TRIM	JAMES HARDIE	MATCH ADJ. SIDING COLOR	
BRICK VENEER (#1)	INTERSTATE BRICK	ALMOND	
BRICK VENEER (#2)	INTERSTATE BRICK	TUMBLEWEED	
MASONRY BASE VENEER	ARRISCRAFT	SUNSET	

ER	RIAL SCHEDULE					
\neg	BUILDING ELEMENT	MANUFACTURER	COLOR			
	CAST STONE BANDS & SILLS	EDWARDS CAST STONE	TBD			
	COMPOSITE WINDOWS	ANDERSEN 100	BLACK			
	ALUM. STOREFRONT	N/A	BLACK			
	INSULATED METAL DOORS/FRAMES	N/A	TBD			
	CANOPY & BAY SOFFITS	JAMES HARDIE	COLOR TO MATCH ADJ. TRIM/SIDING			
	RAILINGS & HANDRAILS	SUPERIOR	BLACK			
	TREATED-EXPOSED DECK BEAMS	N/A	BROWN TREATED			
	RAILINGS & HANDRAILS	SUPERIOR	BLACK			

