LANDMARKS COMMISSION APPLICATION

Complete all sections of this application, making sure to note the requirements on the accompanying checklist (reverse).

If you need an interpreter, translator, materials in alternate formats or other accommodations to access these forms, please call (608) 266-4635

1. LOCATION

2. PROJECT

Project Address:

City of Madison **Planning Division** 215 Martin Luther King Jr Blvd, Ste 017 PO Box 2985 Madison, WI 53701-2985 (608) 266-4635



Aldermanic District:

Project Title/Description:					
This is an application for: (c	heck all that apply)				
New Construction/Alto District or Designated	eration/Addition in a Local Hist	oric		Legistar #:	
□ Mansion Hill	☐ Third Lake Ridge	First Settlement		DATE STA	MP
University Heights	Marquette Bungalows	Landmark		DEGE	MEW
or to Designated Landı			LY		
□ Mansion Hill	Third Lake Ridge	First Settlement	E ON	4/14/2	
University Heights	Marquette Bungalows	Landmark	DPCED USE ONLY	1:31 pr	n
□ Demolition			DPC		
□ Alteration/Addition to	a building adjacent to a Desigr	nated Landmark			
\Box Variance from the Hist	oric Preservation Ordinance (C	hapter 41)			
	/Rescission or Historic District I istoric Preservation Planner for spe	-		Preliminary Zoning	
3. <u>APPLICANT</u>				Date: /	/
Applicant's Name:		Company:			
Address:					
Talanhana	Street	Emoile	City	State	Zip
	icant):				
Address:	Street		City	State	Zip
Property Owner's Signature	2:			ie:	·

NOTICE REGARDING LOBBYING ORDINANCE: If you are seeking approval of a development that has over 40,000 square feet of non-residential space, or a residential development of over 10 dwelling units, or if you are seeking assistance from the City with a value of \$10,000 (including grants, loans, TIF or similar assistance), then you likely are subject to Madison's lobbying ordinance (Sec. 2.40, MGO). You are required to register and report your lobbying. Please consult the City Clerk's Office for more information. Failure to comply with the lobbying ordinance may result in fines.

4. <u>APPLICATION SUBMISSION REQUIREMENTS</u> (see checklist on reverse)

All applications must be filed by 12:00 pm on the submission date with the Preservation Planner. Applications submitted after the submission date or incomplete applications will be postponed to the next scheduled filing time. Submission deadlines can be viewed here: https://www.cityofmadison.com/dpced/planning/documents/LC Meeting Schedule Dates.pdf



P.O. Box 628155 Middleton Wisconsin 53562

Jelephone 608 320 8070 Cmail milissa@turkehomes.com

April 14, 2022

Landmarks Commission Madison Municipal Building Department of Planning + Community + Economic Development Planning Division 215 Martin Luther King, Jr. Boulevard; Suite 017 P.O. Box 2985 Madison, Wisconsin 53701-2985

Dear Landmarks Commission Members,

I'm the architect and general contractor working on the house renovation; garage demolition and new construction at 1709 Regent Street in Madison. Since the house is in the University Heights historic district, I am seeking your approval for the exterior modifications to the house and for the demolition of the existing garage and construction of a new garage.

The following is a summary of the scope of work for the house:

Building Element	Description of Work	Notes	
Foundation Stucco	Paint		
House Siding and Trim	Remove and replace the existing siding and trim with smooth finish LP Smartside lap siding and trim.	There is wood lap siding under the aluminum siding. ¹	
Front Porch and Chimney Brick	Tuckpoint all existing mortar and install new mortar.	Currently there are multiple mortar colors because of various patches over the years. We are going to install one mortar color at all brick areas.	
Front Porch Windows Units Remove and replace the existing front porch window units; which are not original to the house, with screens between the columns		A screened-in porch will be less stuffy in summer than the current porch with window units.	
Front Porch Floor	Remove and replace the existing front porch floor framing and flooring.	The front porch floor is sagging and not in good condition. We are using Dekorators tongue and groove porch flooring over new floor framing.	



Back Porch / Deck	Remove and replace the existing back porch / deck.	The back porch in not in good condition. We are installing a new porch, railing and steps. Using smooth finish LP Smartside the railing and trim; and Dekorators decking. ²
Exterior Doors	Remove and replace the existing exterior doors.	We are installing Therma Tru Craftsman style exterior doors. The doors will be painted.
Cellar Bulkhead Doors	Remove and replace existing plywood cover at exterior cellar steps.	We are installing a new Bilco metal door unit over the cellar bulkhead.
House Roofing	Remove and replace the existing asphalt roofing with new asphalt roofing.	We are installing Owens Corning Duration architectural shingles.

- For energy efficiency and comfort, we are upgrading the HVAC system and insulating the roof and exterior walls. Because we are keeping (and repairing) the original interior lath and plaster walls, the wall insulation will be installed from the outside of the house after re-sheathing the house. The existing sheathing is in bad condition and would not provide a proper backing for the blown-in wall insulation. To re-sheath and insulate, we need to reside the house.
- ² LP Smartside trim is similar in size and profile to flat cedar trim. We are using 1x3 trim for the top and bottom porch rails; 1x6 trim for the balusters; and 1x10 trim for the front face of the deck.

After demolishing the existing garage, the following is a summary of the scope of work for the new garage:

Building Element	Notes
Garage Foundation	We will excavate and pour concrete footings and foundation.
Garage Siding and Trim	We are installing smooth finish LP Smartside lap siding and trim.
Garage Door	We are installing an 18'-0" \times 8'-0" Clopay Classic steel garage door with flush panels. The door will be painted.
Garage Roofing	We are installing Owens Corning Duration architectural shingles.
Garage Floor	We will pour a concrete slab floor.



Building Element	Description of Work	Notes
Driveway and Apron	Remove and replace existing asphalt driveway and concrete apron.	We are installing a concrete driveway and apron.
City Sidewalk	Remove and replace the existing city sidewalk.	The sidewalk is uneven posing tripping hazards, so we are installing a new sidewalk.
Front Yard Sidewalk and Steps	Remove and replace the existing front yard sidewalk and steps	The sidewalk and steps will be in the same layout / configuration as the existing.
Front Porch Steps	Remove and replace existing wood and concrete steps.	We are installing new concrete steps because the existing steps are in poor condition.
Fence	Install privacy fence along driveway.	We are installing a 6'-0" high cedar alternating board fence, similar to the neighbor on the west side of the house.

The following is a summary of the scope of work for the concrete flatwork, stairs and fence:

Please let me know if you have any questions, or need additional information.

Thank-you for your consideration.

Sincerely,

hilin

Milissa Turke Architect and General Contractor











1709 Regent Street - Existing Conditions











1709 Regent Street - Existing Conditions













1709 Regent Street - Existing Context

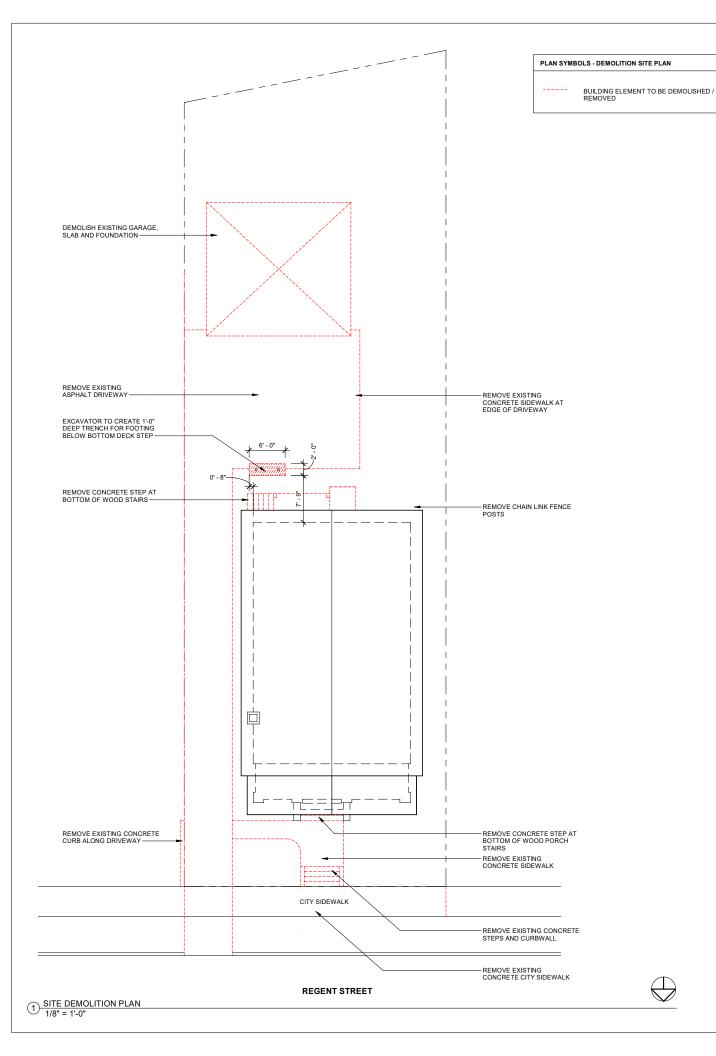

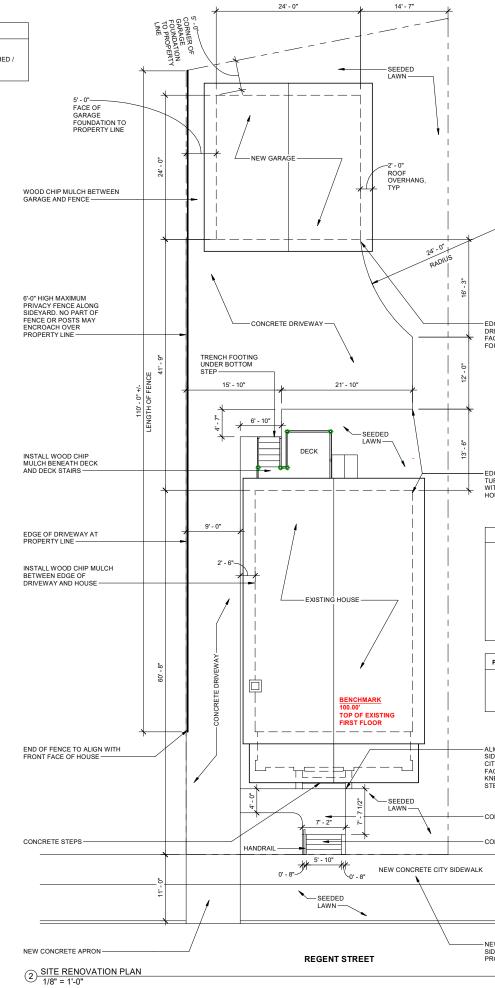

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SHEET INDEX

D/S1	SITE DEMOLITION PLAN AND SITE RENOVATION PLAN	
D2	BASEMENT AND FIRST FLOOR DEMOLITION PLAN	
D3	SECOND FLOOR DEMOLITION PLAN	
A1	EXTERIOR ELEVATIONS AND GARAGE ROOF PLAN	
A2	BASEMENT AND FIRST FLOOR RENOVATION PLANS	
A3	SECOND FLOOR AND ROOF RENOVATION	
A4	GARAGE PLANS, ELEVATIONS AND WALL SECTIONS	
A6	SECOND FLOOR CABINET AND FINISH PLANS	
A8	INTERIOR ELEVATIONS	

- EDGE OF CONCRETE DRIVEWAY TO ALIGN WITH FACE OF GARAGE FOUNDATION

- EDGE OF CONCRETE TURNAROUND TO ALIGN WITH FACE OF EXISTING HOUSE FOUNDATION

GENERAL NOTES - SITE PLAN

1. PRIOR TO CONSTRUCTION, SURVEYOR TO VERIFY PROPERTY LINE LOCATIONS AND STAKE LOCATION OF NEW GARAGE AND DRIVEWAY AS SHOWN IN THIS DRAWING.

2. FINISH ROUGH GRADE TO SLOPE AWAY FROM THE BUILDINGS IN ALL LOCATIONS SO THAT WATER DRAINS AWAY FROM THE BUILDINGS.

3. SUBCONTRACTORS AND/OR SUPPLIERS TO CONFIRM DIMENSIONS BY FIELD MEASURING PRIOR TO BIDDING WORK AND/OR MATERIALS

PLAN SYMBOLS - DEMOLITION SITE PLAN

SONOTUBE POST FOOTING 0

ALIGN EDGE OF SIDEWALK AND STEPS TO CITY SIDEWALK WITH FACE OF BRICK PORCH KNEE WALLS AT FRONT STEPS


CONCRETE SIDEWALK

- CONCRETE STEPS AND CURB


- NEW CONCRETE CITY SIDEWALK (PROPERTY LINE TO PROPERTY LINE)

\bigcap	\square
Ø	Ζ

Milissa Turke HOMES <i>uc</i> (608)320-8070				
SPRINKMAN DESIGN COLLECTIVE MADISON				
The house design depicted in these drawings are copyright protected. These drawings may not be reproduced and the house design may not be constructed without prior consent of Milissa Turke Homes LLC.				
Project Square Footage				
Project Name:				
Project Name: Goetzke House Renovation Phase 2 Fred Goetzke				
1709 Regent Street Madison, Wisconsin 53726				
Date April 17 2022				
Sheet Title Site Demolition Plan and Site Renovation Plan				
D/S1				

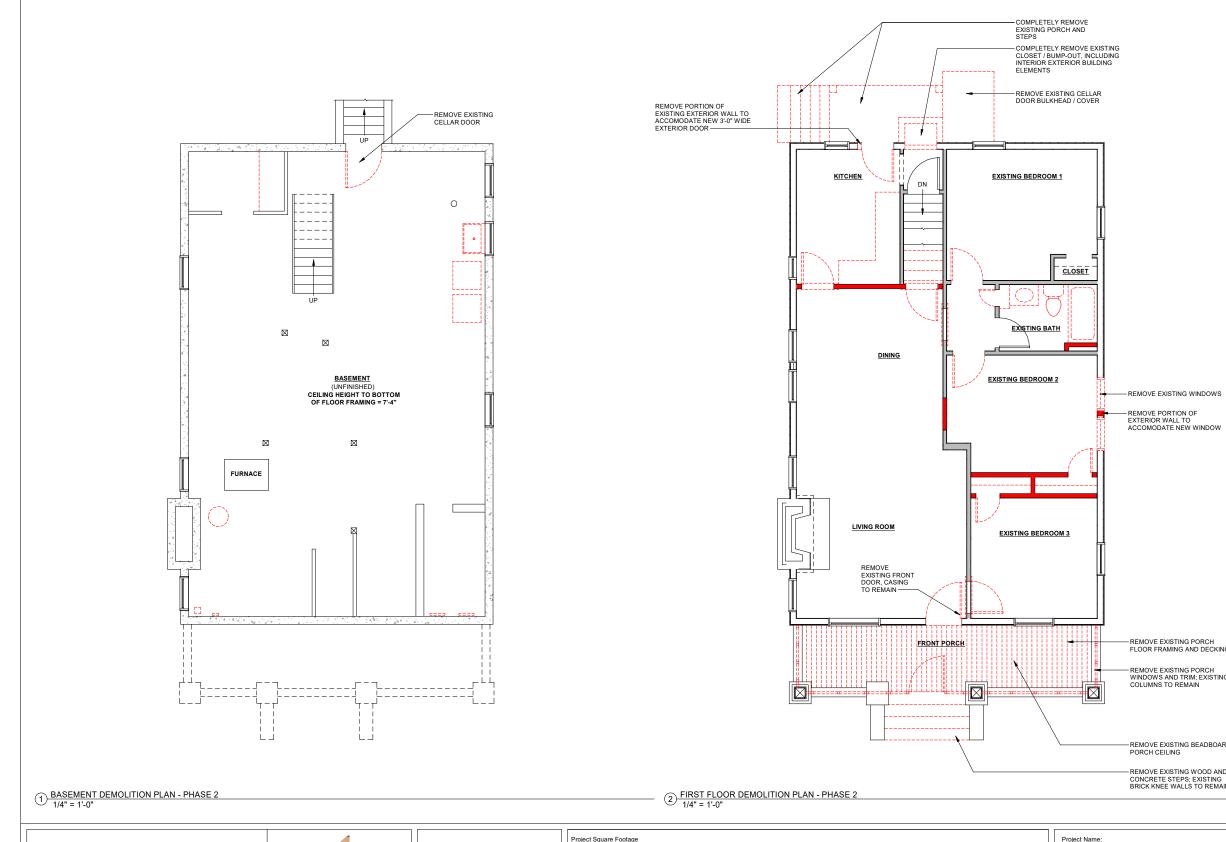

Milissa Turke HOMES <i>u</i> c	SPRINKMAN	The house design depicted in these drawings are copyright protected. These drawings may not be reproduced and the house	Project Square Footage	Project Name: Goetzke House Renovation Phase 2 Fred Goetzke	Sheet Title Basement and First Floor Demolition Plans	ר2
	DESIGN	design may not be constructed without prior consent of Milissa		1709 Regent Street Madison, Wisconsin 53726	Fians	
(608)320-8070	COLLECTIVE	Turke Homes LLC.		,		
	MADISON				Date April 17 2022	

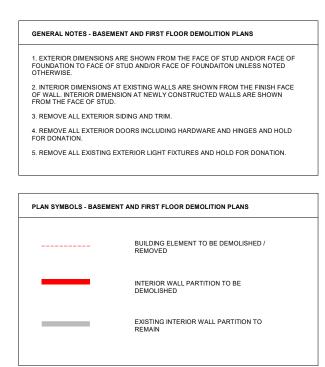


REMOVE EXISTING WINDOWS

- REMOVE EXISTING PORCH FLOOR FRAMING AND DECKING


- REMOVE EXISTING PORCH WINDOWS AND TRIM; EXISTING COLUMNS TO REMAIN

- REMOVE EXISTING BEADBOARD PORCH CEILING

-REMOVE EXISTING WOOD AND CONCRETE STEPS; EXISTING BRICK KNEE WALLS TO REMAIN

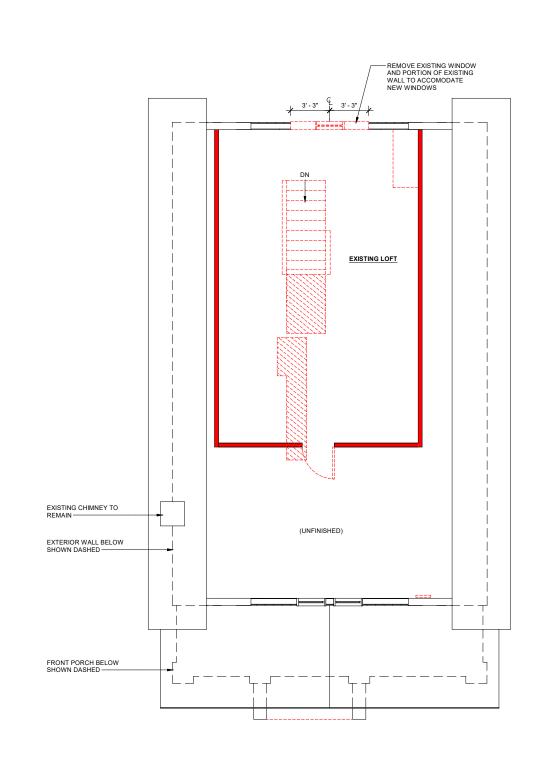

1 SECOND FLOOR DEMOLITION PLAN - PHASE 2

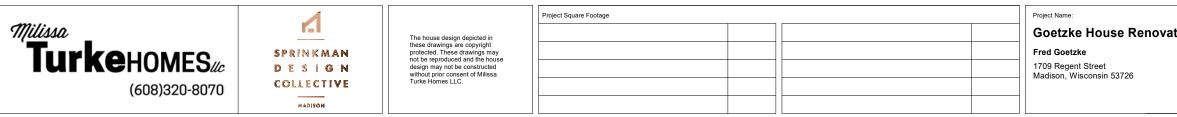

 GENERAL NOTES - SECOND FLOOR DEMOLITION PLANS

 1. EXTERIOR DIMENSIONS ARE SHOWN FROM THE FACE OF STUD AND/OR FACE OF FOUNDATION TO FACE OF STUD AND/OR FACE OF FOUNDAITON UNLESS NOTED OTHERWISE.

 2. INTERIOR DIMENSIONS AT EXISTING WALLS ARE SHOWN FROM THE FINISH FACE OF WALL. INTERIOR DIMENSION AT NEWLY CONSTRUCTED WALLS ARE SHOWN FROM THE FACE OF STUD.

 3. REMOVE ALL EXTERIOR SIDING AND TRIM.


 4. REMOVE ALL INTERIOR DOORS INCLUDING HARDWARE AND HINGES AND HOLD FOR DONATION.

5. REMOVE ALL EXISTING INTERIOR LIGHT FIXTURES ON THE FIRST FLOOR AND HOLD FOR DONATION.


6. REMOVE ALL CARPET AND CARPET PADDING FROM SECOND FLOOR.


7. REMOVE ALL WALL BASE TRIM FROM SECOND FLOOR.

8. SEE STRUCTURAL ENGINEERING NOTES AND DRAWINGS FOR ADDITIONAL INFORMATION.

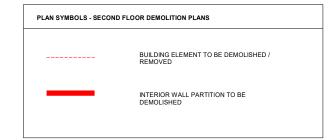


	Sheet Title	
vation Phase 2	Second Floor Demolition Plan	D3
	Date April 17 2022	

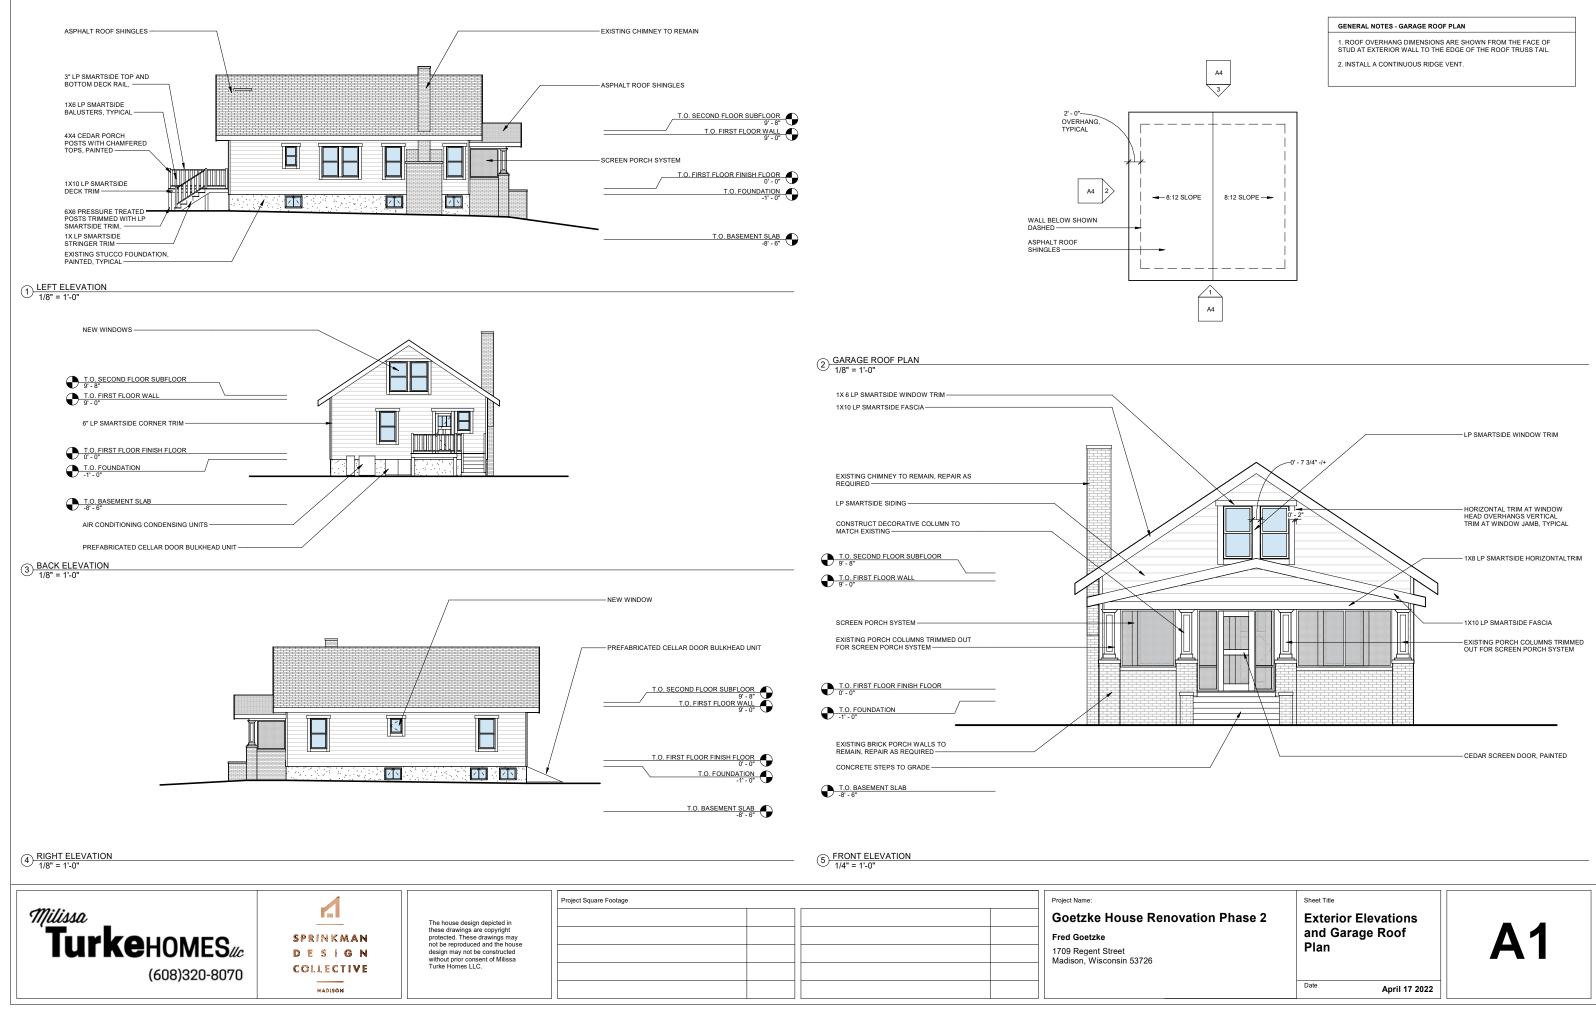


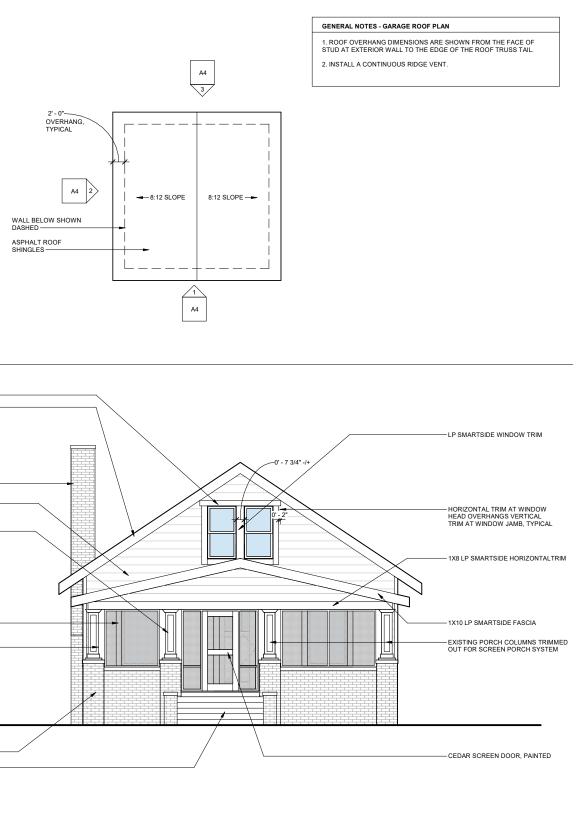

	Sheet Title	
ation Phase 2	Exterior Elevations and Garage Roof Plan	A1
	Date April 17 2022	


goetzke 21004 WackHome/OneDrive - Milissa Turke Homes LLCWillissa Turke construction/phase 2goetzke_1709 regent street_phase_02.nd

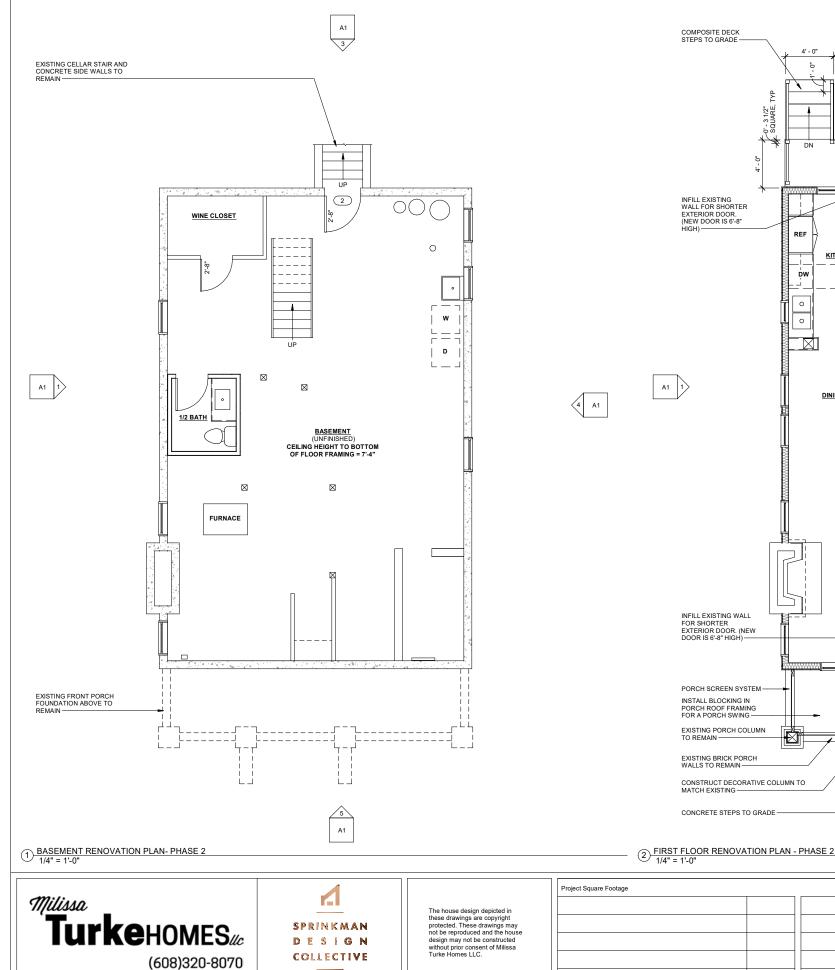


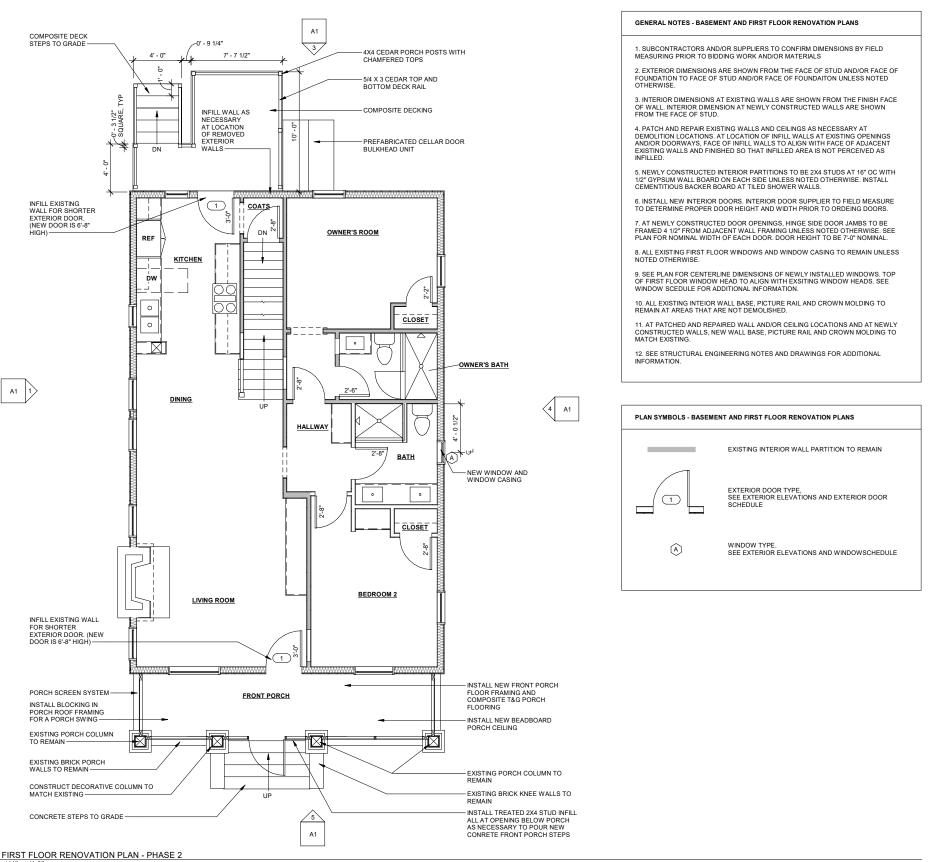


Project Name Goetzke House Renov The house design depicted in these drawings are copyright protected. These drawings may not be reproduced and the house design may not be constructed without prior consent of Milissa Turke Homes LLC. Fred Goetzke 1709 Regent Street Madison, Wisconsin 53726 COLLECTIVE MADISON

ation Phase 2	Sheet Title Basement and First Floor Renovation Plans Date April 17 2022	A2

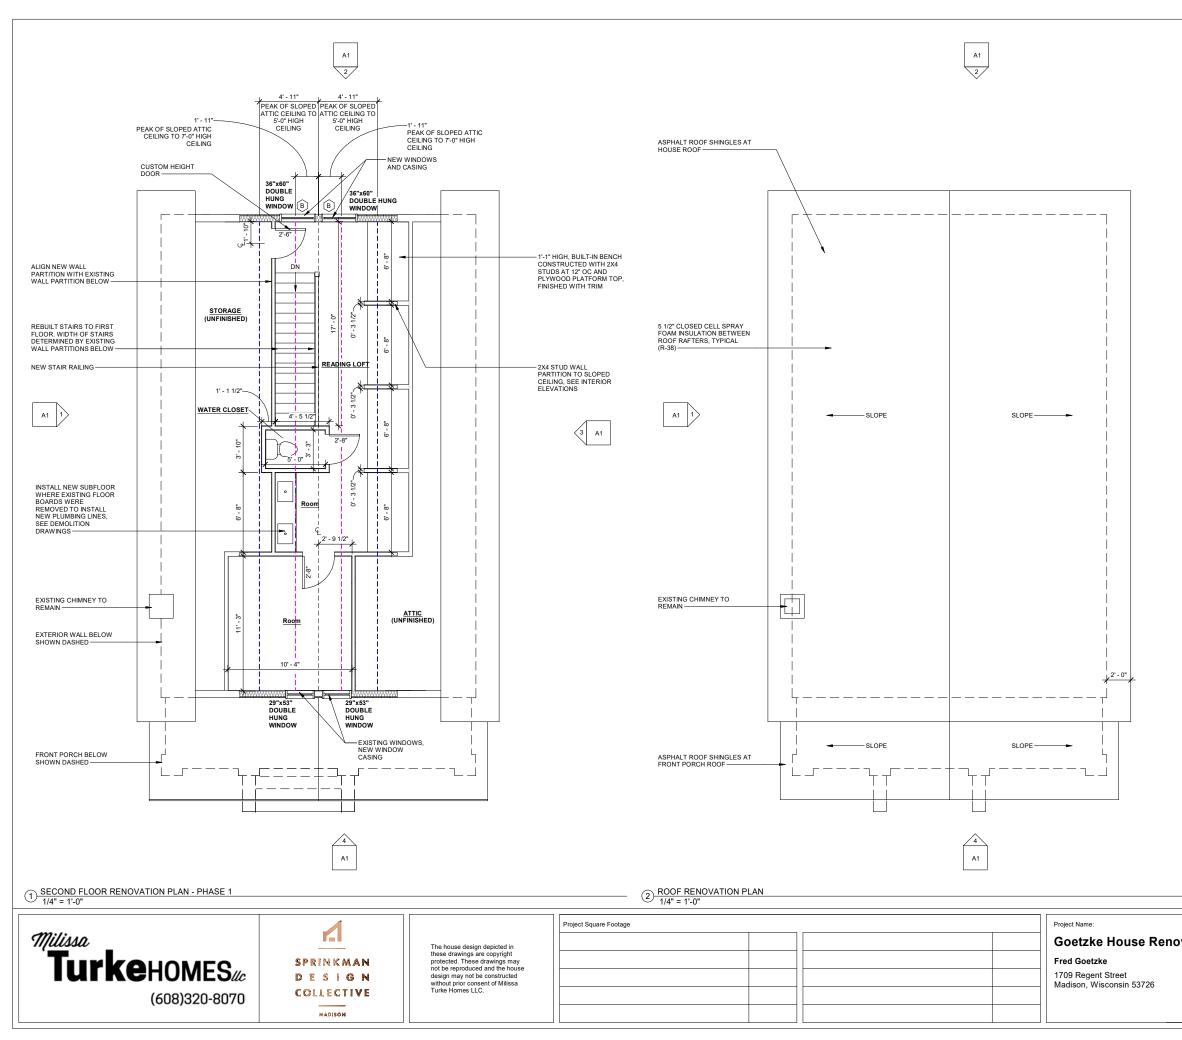

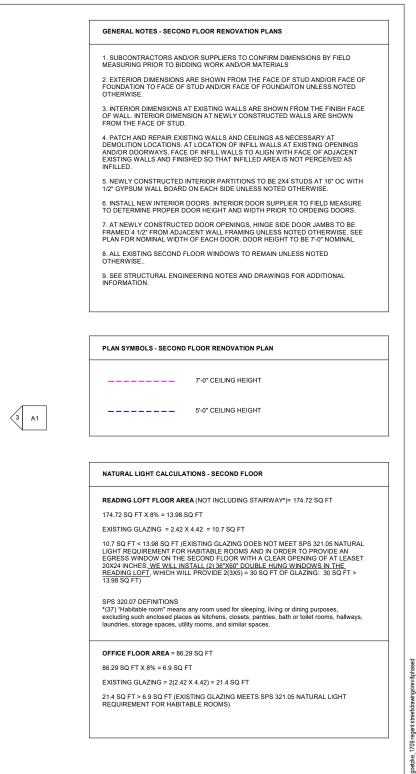


	Sheet Title	
vation Phase 2	Second Floor and Roof Renovation Plans and Garage Roof Plan	A3
	Date April 17 2022	

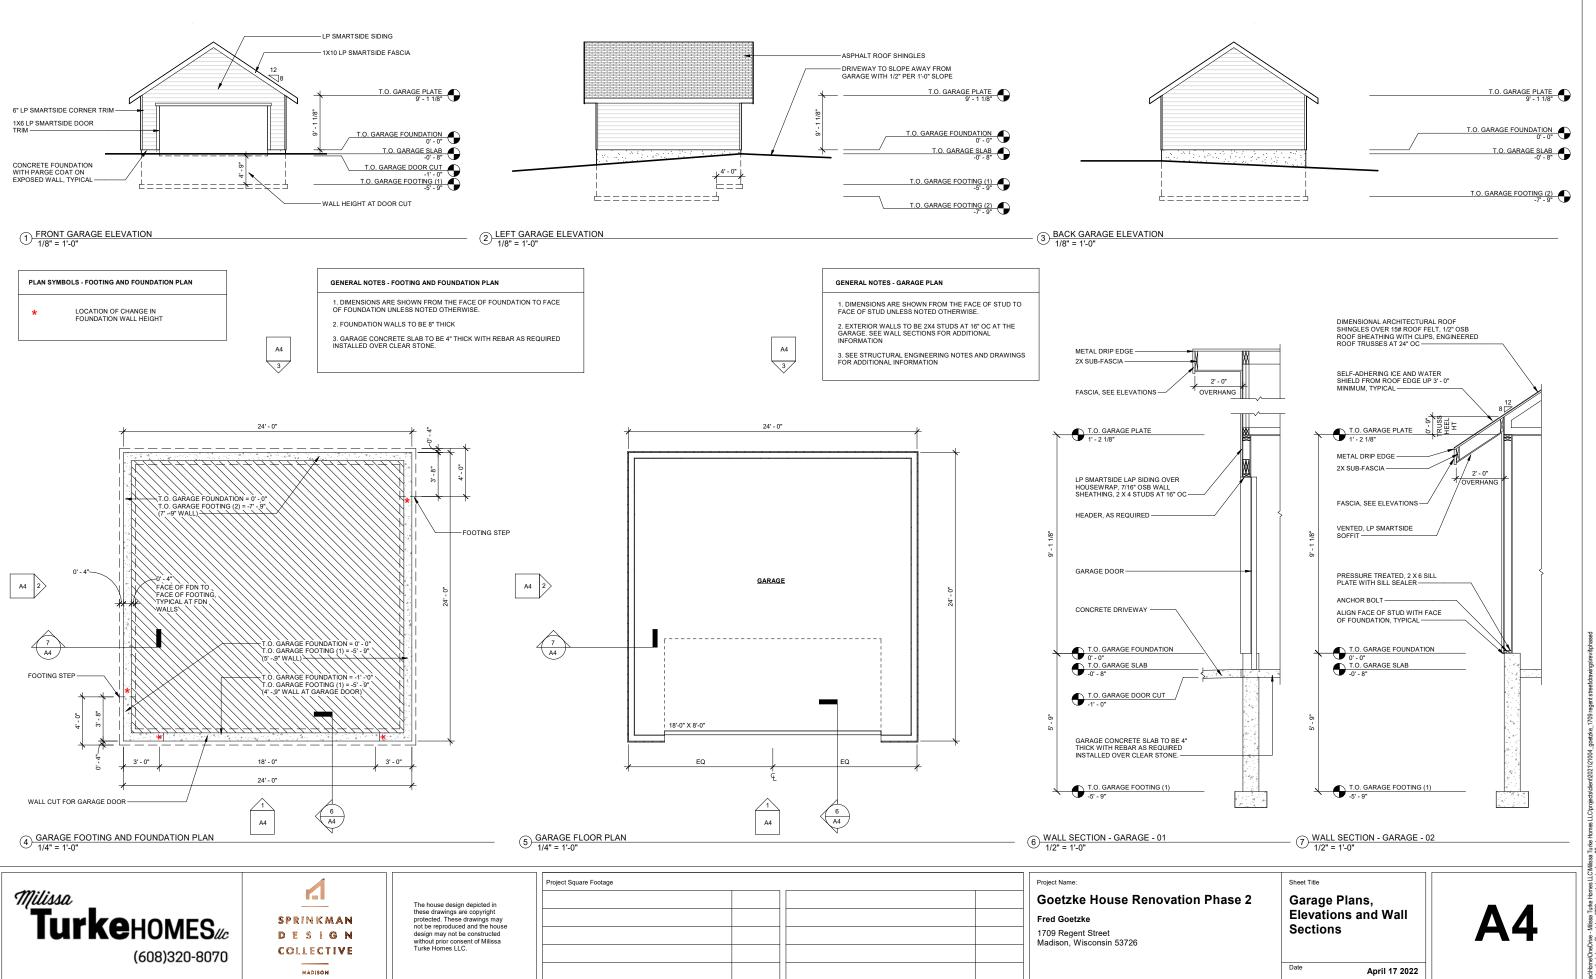


GENERAL NOTES - FIRST FLOOR CABINET AND FINISH PLAN

1. DIMENSIONS SHOWN ARE FROM FACE OF DRYWALL; NOT THE FACE OF STUDS.

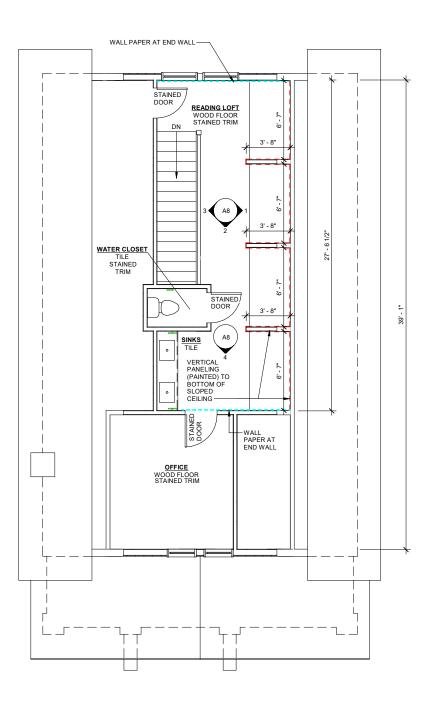


PLAN SYMBOLS - FIRST FLOOR CABINET AND FINISH PLAN					
-	WALL HOOK				
-	TOWEL RING				
1	TOILET PAPER HOLDER				
	TOWEL BAR				
	SHIPLAP / PANELING				
	WALL PAPER				

(1) SECOND FLOOR CABINET AND FINISH PLAN - PHASE 2 1/4" = 1'-0"

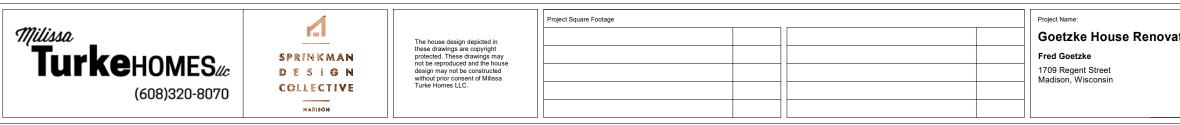

ation - Phase 2	Sheet Title Second Floor Cabinet and Finish Plan	A6
	Date April 17, 2022	

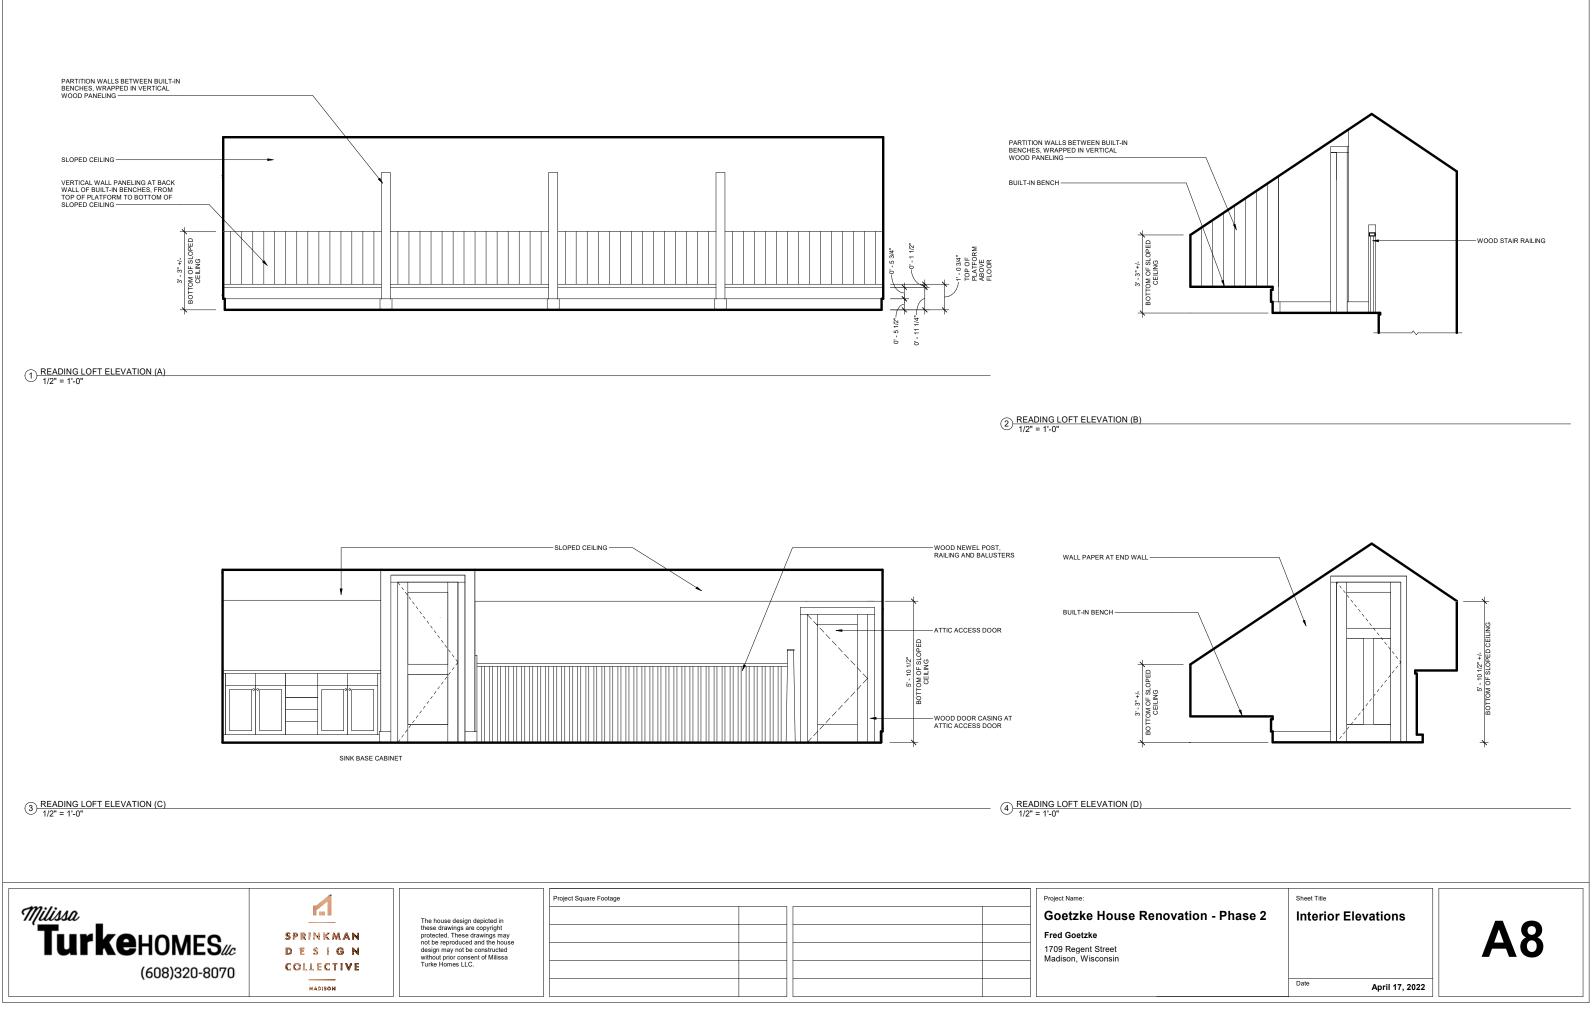

WackborneDneDne- Missa Turke Hornes LLCWilssa Turke Hornes LLCWrigedsclient2021/21004_goedxle_1709 regent streetdrawingstrevitiphased constructioniohaes 2, interior descrin phase 2 occides interior descrin phase 02.01










100 SERIES

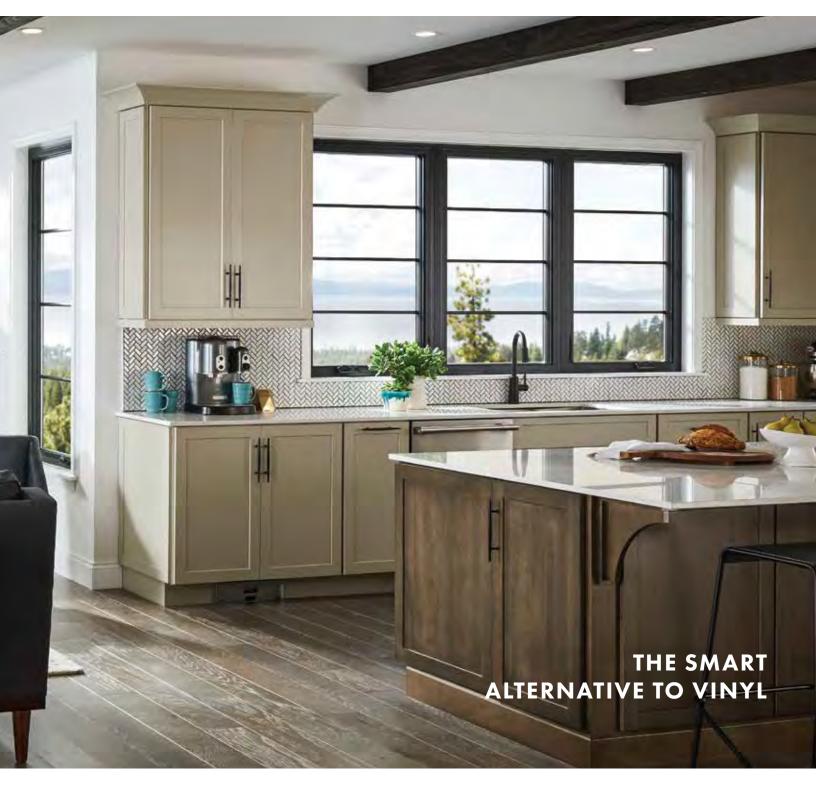

A BETTER CHOICE FOR YOUR HOME

Whether you're replacing, remodeling or building new, Andersen[®] 100 Series windows and patio doors offer many advantages over vinyl. They offer superior strength and performance because they're made of innovative Fibrex[®] composite material, which is 2X stronger and more durable than vinyl. They're also available in a variety of rich dark colors with finishes that are made to last and they're designed to retain their stability and rigidity in all climates. Plus, 100 Series windows and doors are environmentally responsible and energy efficient, making them a better choice for your home.







*When 100 Series products were tested against five leading competitors' painted vinyl window products.



STRENGTH & PERFORMANCE

Fibrex[®] material is **2X stronger than vinyl** and it retains its stability and rigidity in all climates so weathertight seals stay weathertight.

100 Series products can **withstand temperatures up to 150°F**, even in dark colors, meaning they won't warp due to sun exposure.

ENERGY EFFICIENT

Our weather-resistant construction seals out drafts, wind and water so well, you can relax in comfort whatever the weather. Plus, Fibrex material **blocks thermal transfer nearly 700 times better** than aluminum to help reduce heating and cooling bills.

COLORS THAT LAST

Durable, factory-finished interiors and exteriors feature a premium matte finish that isn't shiny like vinyl plus they **never need painting and won't fade, flake, blister or peel**.

On 100 Series products, **the finish is 12X thicker than that of painted vinyl windows**^{**} resulting in superior scratch resistance so they'll look beautiful for years to come.

ADVANCED CRAFTSMANSHIP

100 Series products feature **virtually seamless corners** for a cleaner, more contemporary look.



100 Series sash corner seam



ENVIRONMENTALLY RESPONSIBLE

Our exclusive Andersen® Fibrex composite material is composed of **40% reclaimed wood fiber by weight**, most of which is reclaimed from the manufacturing of Andersen wood windows.



See how Andersen created Fibrex material at andersenwindows.com/fibrex



Most other window and door warranties end when a home is sold, but our coverage – 20 years on glass, 10 years on non-glass parts – transfers from each homeowner to the next. And, because it's not prorated, the coverage offers **full benefits, year after year, owner after owner**. So it can add real value when you decide to sell your home.



*Visit andersenwindows.com/warranty for details. **When 100 Series products were tested against five leading competitors' painted vinyl window products.

WINDOW & DOOR TYPES

Choose the product style and frame type needed to complete your replacement, remodeling or new construction project and bring your vision to life.





SINGLE-HUNG

Single-hung windows feature a stationary upper sash and operable lower sash that slides up and down.



Casement windows are hinged on the side and open outward to the left or right, while awning windows are hinged at the top and open outward.



GLIDING WINDOWS

Gliding windows have one stationary sash and one operating sash that glides horizontally. A three-sash configuration, where two sash glide past a fixed center sash is also available.



GLIDING PATIO DOORS

Patio doors feature one stationary panel and one that glides smoothly on adjustable rollers. Add character and light with a sidelight or transom.

SPECIALTY WINDOWS

Specialty windows are stationary (non-operable) windows characterized by their special shapes, including curves and dramatic angles. A variety of shapes are available to complement your home's architecture.

Windows and doors are available in custom sizes to fit all projects.





COLOR OPTIONS


100 Series windows and patio doors come in five exterior colors, including dark bronze and black — colors that are darker and richer than those of most vinyl windows. They also feature a premium matte finish inside for an attractive appearance.



INTERIOR COLORS



HARDWARE OPTIONS

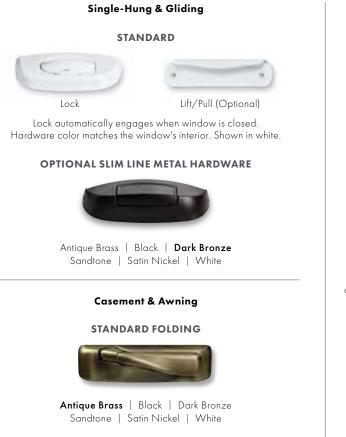

Folding handle avoids interference with window treatments.

TULSA **OPTIONAL AFTON** Exterior Interior Exterior Interior Exterior handle Interior handle Antique Brass | Bright Brass matches exterior matches interior Black | Satin Nickel door color. Shown door color. in dark bronze. Shown in white.

Patio Doors

Gliding patio doors features a multi-point locking systems for enhanced security. Optional auxiliary foot lock is available to secure the gliding panel and provides an extra measure of security when the door is in a locked position. Exterior keyed lock also available.

Bold names denotes finish shown.

GLASS OPTIONS

Andersen has the glass you need to get the performance you want with options for every climate, project and customer. Check with your Andersen supplier for the selections that meet ENERGY STAR® requirements in your area.

		ENERGY						LIGHT									
	GLASS	How we		rodu	o r ct prevents aping.	Gai How w	n Co rell a	produ	at cient ct blocks unlight.	Tr How m	ansı uch vi		ight comes	How	/ wel	otect a pro aviole	
SmartSun™	Thermal control similar to tinted glass, with visible light transmittance similar to Low-E glass.	•		•	0	•	•	•	•	•		0	0	•		•	•
SmartSun with HeatLock® Coating	Applied to the room-side surface, it reflects heat back into the home and improves U-Factor values.	•		•	O	•	•		•			0	0	•	•	•	•
Low-E	Outstanding overall performance for climates where both heating and cooling costs are a concern.	•		•	0	•	•	•	0			•	0	•	•	•	0
Low-E with HeatLock Coating	Applied to the room-side surface, it reflects heat back into the home and improves U-Factor values.	•		•	0	•	•	•	0			O	0	•	•		0
Sun	Outstanding thermal control in southern climates where less solar heat gain is desired.	•		•	0	•			•		0	0	0	•	•		0
Clear Dual-Pane	High visibility with basic thermal performance.	•	0	0	0	0	0	0	0			•	•	0	0	0	0

Center of glass performance only. Ratings based on glass options as of May 2021. Visit andersenwindows.com/energystar for ENERGY STAR® map and NFRC total unit performance data.

ADDITIONAL GLASS OPTIONS

Tempered safety glass, standard on patio doors. Sound reducing glass options are also available.

Patterned glass lets in light while obscuring vision and adds a unique, decorative touch.



Cascade and Reed patterns can be ordered with either a vertical or horizontal orientation.

GLASS SPACER OPTIONS

Choose from stainless steel or black glass spacers to create a customized look.



For more details on glass options, visit **andersenwindows.com/glass**.



INSECT SCREEN OPTIONS

Insect screens for windows and patio doors have a fiberglass screen mesh. Optional TruScene® insect screens for windows are made with a micro-fine stainless steel mesh, providing 50% more clarity and letting in 25% more fresh air^{*} than our conventional insect screens.





Insect screens are available for all venting windows.

Gliding insect screens are available for two-panel doors.

*TruScene insect screens let in over 25% more fresh air than standard Andersen fiberglass insect screens.

GRILLE OPTIONS

Customize the look of your windows and patio doors with a variety of grille options to complement virtually any style of home.

CONVENIENT CLEANING OPTIONS

Finelight[™] grilles-between-the-glass are installed between the glass panes to make glass easy to clean. With an elegant, sculpted profile and a twosided color scheme, they match both the interior and exterior of the window or door. Finelight grillesbetween-the-glass with exterior grilles make interior glass easier to clean, while permanent exterior grilles provide architectural style and detail.



Finelight grillesbetweenthe-glass

Finelight grillesbetweenthe-glass Permanent exterior


FULL DIVIDED LIGHT

Permanently applied to the interior and exterior of your window with a spacer between the glass for an authentic look.

SIMULATED DIVIDED LIGHT

Permanent grilles on the exterior and interior with no spacer between the glass.

Permanent exterior Permanent interior with spacer

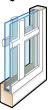

Permanent exterior Permanent interior


Grille Bar Widths



Grille width for windows is ¾". Grille width for patio doors is 1". A 2 ¼" simulated meeting rail is available for casement windows to replicate the look of single-hung windows. Actual size shown.

Grille Patterns




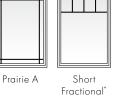

Victorian

Tall

Fractional

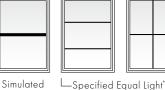

└─Specified Equal Light**─┘



Single-Hung



THE ENVIRONMENT HAS A BUSINESS PARTNER

Respect for the environment is nothing new at Andersen. For more than a century, it's been part of who we are. Our commitment to recycle and reclaim materials began simply because it was good business. Now it's part of our broader commitment to sustainability and responsible stewardship of all our resources. Andersen is committed to providing you with long-lasting, energy-efficient windows and doors. Visit andersenwindows.com/sustainability for more information.




Andersen makes windows and doors with options that make them ENERGY STAR[®] v. 6.0 certified throughout the U.S.



Andersen is a charter member of the **U.S. Green Building Council** and a strong supporter of its LEED® (Leadership in Energy and Environmental Design) National Green Building Standard rating system.



*Visit andersenwindows.com/warranty for details. All trademarks where denoted are marks of their respective owners. ©2021 Andersen Corporation. All rights reserved. 07/21 Part #9122169

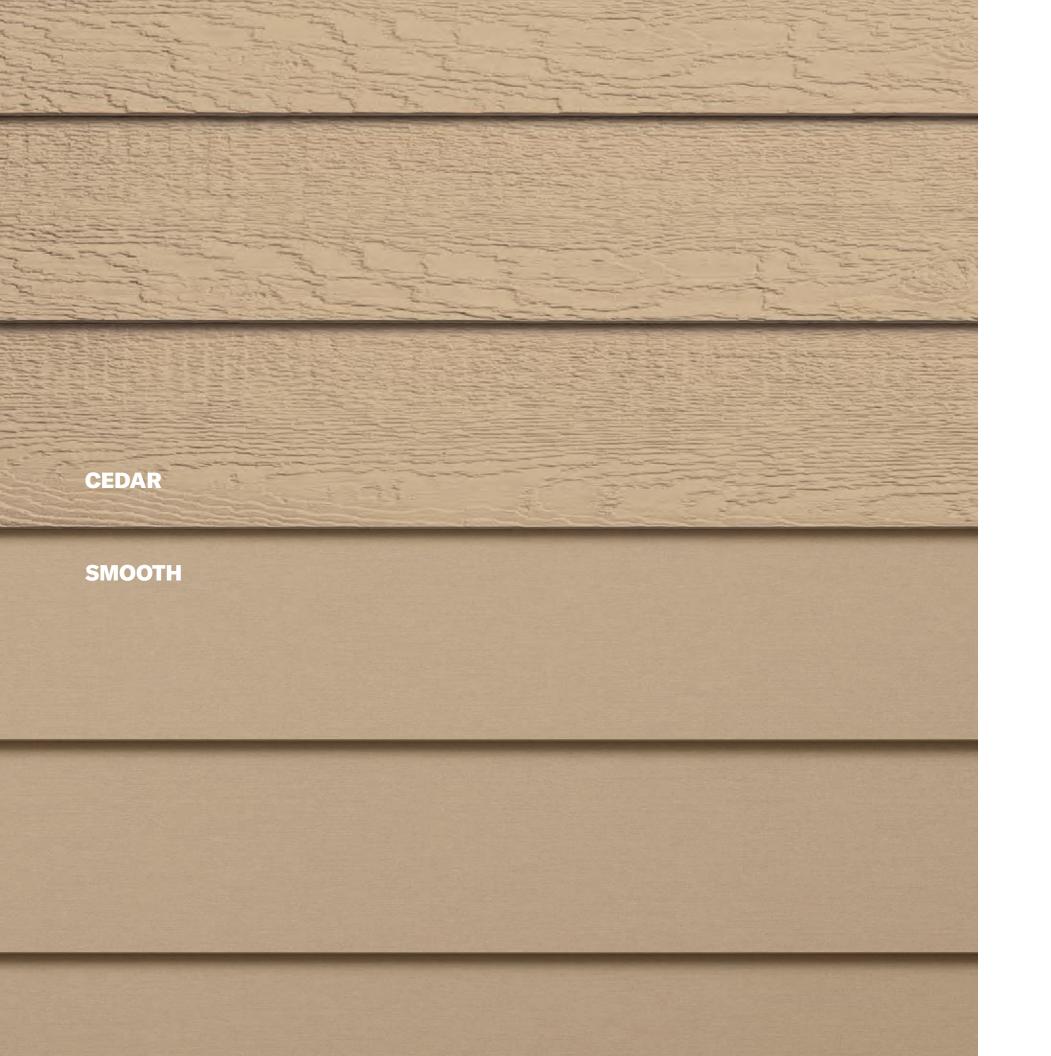

ADVANCED DURABILITY FOR LONGER LASTING BEAUTY®

Siding plays a big role in a home's curb appeal. That's why LP® SmartSide® Trim & Siding is built to last and designed to make any home's design vision come to life. Because of its engineered wood strand technology and variety of textures, styles and colors, LP SmartSide products elevate any structure, from traditional homes to modern masterpieces. LP SmartSide products are also available in ExpertFinish® color to add another element of versatile design to your projects.



CEDAR TEXTURE LAP



SMOOTH FINISH LAP



CREATE A LASTING IMPRESSION WITH A FINISHING TOUCH

LP® SmartSide® Trim & Fascia are the finishing touch that's the first to get noticed. With its smooth finish or deep cedar-grain texture and variety of widths and thicknesses, you can add custom design accents that take curb appeal to the next level. LP SmartSide Trim is a must-have product for when you want your craftsmanship to stand out on any home or shed.



CEDAR TEXTURE TRIM



SMOOTH FINISH TRIM



NEW OUTSIDE CORNER (PRIMED)

AN INNOVATIVE WAY TO COVER EVERY DETAIL

When you use LP[®] SmartSide[®] Soffit on your projects, people will notice your attention to every detail. You'll get the same woodgrain or smooth look that matches other LP SmartSide products in a soffit that's pre-cut to the width you need. Vented soffits are also available with precisely cut, bug-resistant vents.





CEDAR TEXTURE SOFFIT



SMOOTH FINISH SOFFIT

VENTED SOFFIT

Specifications: LP® SmartSide® Lap Siding

CEDAR TEXTURE LAP

THE BOLD LOOK OF CEDAR WITHOUT MANY OF THE WORRIES

- One of the most durable lap siding options on the market today
- 16' length can result in faster installation
- May create fewer seams than traditional 12' siding
- Pre-primed for exceptional paint adhesion
- Self-aligning SmartLock[™] option eliminates the need to measure and set lap reveal; eliminating this step in the process is likely to speed up the installation process
- APA-certified lap siding
- Treated engineered wood strand substrate






Cedar Texture

Specifications: LP[®] SmartSide[®] Lap Siding

SMOOTH FINISH LAP

SMOOTH APPEARANCE, ADVANCED DURABILITY OF ENGINEERED WOOD

- Holds up in extreme weather, including moisture, hail, freeze/thaw cycles, and up to 200 mph wind gusts
- Treated with the SmartGuard[®] process for superior protection against the weather, fungal decay and termites
- 16' length can result in faster installation and fewer seams
- Pre-primed for exceptional paint adhesion
- Backed by an industry-leading 5/50-year limited warranty
- APA-certified lap siding
- Treated engineered wood strand substrate

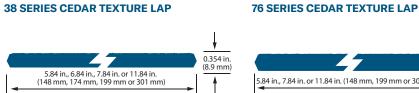







38 SERIES SMOOTH FINISH LAP



DESCRIPTION	LENGTH	ACTUAL WIDTH	THICKNESS	PID NUMBER	WEIGHT
38 Series Cedar Texture Lap	12 ft. (144 in.)(3.7 m)	7.84 in. (199 mm)	0.354 in. (8.9 mm)	28869	1.5 PSF
	16 ft. (192 in.)(4.9 m)	5.84 in. (148 mm)	0.354 in. (8.9 mm)	25796	1.5 PSF
	16 ft. (192 in.)(4.9 m)	6.84 in. (174 mm)	0.354 in. (8.9 mm)	40610	1.5 PSF
	16 ft. (192 in.)(4.9 m)	7.84 in. (199 mm)	0.354 in. (8.9 mm)	25797	1.5 PSF
	16 ft. (192 in.)(4.9 m)	11.84 in. (301 mm)	0.354 in. (8.9 mm)	25799	1.5 PSF
76 Series Cedar Texture Lap	16 ft. (192 in.)(4.9 m)	5.84 in. (148 mm)	0.418 in. (10.6 mm)	25785 (Discontinued)	1.5 PSF
	16 ft. (192 in.)(4.9 m)	7.84 in. (199 mm)	0.418 in. (10.6 mm)	25786	1.5 PSF
	16 ft. (192 in.)(4.9 m)	11.84 in. (301 mm)	0.418 in. (10.6 mm)	25787	1.5 PSF
76 Series SmartLock Cedar Texture Lap	16 ft. (192 in.)(4.9 m)	7.84 in. (199 mm)	0.418 in. (10.6 mm)	30317	1.5 PSF

 DESCRIPTION	LENGTH
38 Series Smooth Finish Lap	16 ft. (192 in.)(4.9 m)
	16 ft. (192 in.)(4.9 m)
	16 ft. (192 in.)(4.9 m)



Smooth Finish

ACTUAL WIDTH	THICKNESS	PID NUMBER	WEIGHT
5.84 in. (148 mm)	0.354 in. (8.9 mm)	41338	1.5 PSF
7.84 in. (199 mm)	0.354 in. (8.9 mm)	41339	1.5 PSF
11.84 in. (301 mm)	0.354 in. (8.9 mm)	41340	1.5 PSF

Specifications: LP[®] SmartSide[®] Lap Siding Coverage

Lap Siding 12' Length	Reveal (size)
Area (sq. ft.)	6-7/8″ (8″)
100	15 pcs.
200	30 pcs.
300	44 pcs.
400	59 pcs.
500	73 pcs.
600	88 pcs.
700	102 pcs.
800	117 pcs.
900	131 pcs.
1000	146 pcs.
1500	219 pcs.
2000	291 pcs.
2500	364 pcs.
3000	437 pcs.
3500	510 pcs.
4000	582 pcs.
4500	655 pcs.
5000	728 pcs.

Specifications: LP® SmartSide® Cedar Texture Shakes Coverage

Cedar Texture Shakes 4´ Length	Reve	Reveal (size)		
Area (sq. ft.)	6-7/8″ (12″)	9-7/8″ (12″)		
100	44 pcs.	31 pcs.		
200	88 pcs.	61 pcs.		
300	131 pcs.	92 pcs.		
400	175 pcs.	122 pcs.		
500	219 pcs.	152 pcs.		
600	262 pcs.	183 pcs.		
700	306 pcs.	213 pcs.		
800	350 pcs.	244 pcs.		
900	393 pcs.	274 pcs.		
1000	437 pcs.	304 pcs.		
1500	655 pcs.	456 pcs.		
2000	873 pcs.	608 pcs.		
2500	1091 pcs.	760 pcs.		
3000	1310 pcs.	912 pcs.		
3500	1528 pcs.	1064 pcs.		
4000	1746 pcs.	1216 pcs.		
4500	1964 pcs.	1368 pcs.		
5000	2182 pcs.	1519 pcs.		

Disclaimer: The above Tables do not account for waste factors. Remember to include your expected jobsite waste. It is up to the purchaser to determine the appropriate waste factor to add to the material estimate. LP takes no responsibility for estimates, including overages or underage of material based on the above Coverage Chart.

Cedar texture shakes offer more options for the designer and craftsman.

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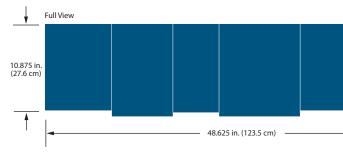
We've included coverage for the minimum shake reveal of 6-7/8" and the maximum shake reveal of 9-7/8".


CEDAR TEXTURE SHAKES

THE LUXURIOUS APPEAL OF CEDAR

- The look of traditional cedar with easier maintenance over time
- Staggered edges offer a lively, textured effect
 - Can be used on all exterior walls or as a decorative accent
 - Shiplap ends for seamless appearance
 - Reversible staggered or straight edge offers exceptional design versatility
 - Treated engineered wood strand substrate

38 SERIES CEDAR TEXTURE SHAKES



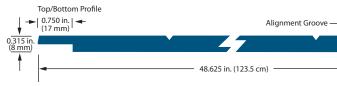

DESCRIPTION	LENGTH	ACTUAL WIDTH	THICKNESS	PID NUMBER	WEIGHT
38 Series Cedar Texture Shakes	4ft. (48.63 in.)(1.2 m)	11.625 in. (295 mm)	0.354 in. (8.9 mm)	42092	2 PSF





Staggered





Straight

Specifications: LP[®] SmartSide[®] Panel and Vertical Siding Coverage

Panel Siding		Reveal (size)			
Area (sq. ft.)	4´x 8´	4´x 9´	4´x 10´	4´x 12´	
100	4 pcs.	3 pcs.	3 pcs.	3 pcs.	
200	7 pcs.	6 pcs.	5 pcs.	5 pcs.	
300	10 pcs.	9 pcs.	8 pcs.	7 pcs.	
400	13 pcs.	12 pcs.	10 pcs.	9 pcs.	
500	16 pcs.	14 pcs.	13 pcs.	11 pcs.	
600	19 pcs.	17 pcs.	15 pcs.	13 pcs.	
700	22 pcs.	20 pcs.	18 pcs.	15 pcs.	
800	25 pcs.	23 pcs.	20 pcs.	17 pcs.	
900	29 pcs.	25 pcs.	23 pcs.	19 pcs.	
1000	32 pcs.	28 pcs.	25 pcs.	21 pcs.	
1500	47 pcs.	42 pcs.	38 pcs.	32 pcs.	
2000	63 pcs.	56 pcs.	50 pcs.	42 pcs.	
2500	79 pcs.	70 pcs.	63 pcs.	53 pcs.	
3000	94 pcs.	84 pcs.	75 pcs.	63 pcs.	
3500	110 pcs.	98 pcs.	88 pcs.	73 pcs.	
4000	125 pcs.	112 pcs.	100 pcs.	84 pcs.	
4500	141 pcs.	125 pcs.	113 pcs.	94 pcs.	
5000	157 pcs.	139 pcs.	125 pcs.	105 pcs.	

Vertical Siding	Reveal (size)
Area (sq. ft.)	15-15/16″ (16″)
100	5 pcs.
200	10 pcs.
300	15 pcs.
400	19 pcs.
500	24 pcs.
600	29 pcs.
700	33 pcs.
800	38 pcs.
900	43 pcs.
1000	48 pcs.
1500	71 pcs.
2000	95 pcs.
2500	118 pcs.
3000	142 pcs.
3500	165 pcs.
4000	189 pcs.
4500	212 pcs.
5000	236 pcs.

Disclaimer: The above Tables do not account for waste factors. Remember to include your expected jobsite waste. It is up to the purchaser to determine the appropriate waste factor to add to the material estimate. LP takes no responsibility for estimates, including overages or underage of material based on the above Coverage Chart.

VERTICAL SIDING

CHARMING STYLE FOR AMERICAN HOMES

- Re-creates the stylish appearance of board & batten
- I6' lengths can eliminate horizontal joints
 - Coordinates with LP SmartSide Trim
 - Pre-primed for exceptional paint adhesion
 - Not rated for structural use
 - Treated engineered wood strand substrate

VERTICAL SIDING

4	———— 15.94 in. (405 mm)		0.354 in. (8.9 mm)		
DESCRIPTION	LENGTH	ACTUAL WIDTH	THICKNESS	PID NUMBER	WEIGHT
38 Series Cedar Texture Vertical Siding	16 ft. (192 in.)(4.9 m)	15.94 in. (405 mm)	0.354 in. (8.9 mm)	40503	1.5 PSF
38 Series Smooth Finish Vertical Siding	16 ft. (192 in.) (4.9 m)	15.94 in. (405 mm)	0.354 in. (8.9 mm)	42126	1.5 PSF

Specifications: LP® SmartSide® Outside Corners

NEW OUTSIDE CORNERS

ENGINEERED TO CREATE A SEAMLESS CORNER LOOK

- Pre-primed for exceptional paint adhesion
- Designed to help prevent water intrusion or seam separation
- One-piece trim corners eliminate the need to build corners on the jobsite
- Faster and easier installation

DESCRIPTION	LENGTH	ACTUAL WIDTH	THICKNESS	PID NUMBER	WEIGHT
540 Series Cedar Texture Outside Corner Trim	10 ft. (120 in.)(3.0 m)	3.50 in. (89 mm)	0.970 in. (24.6 mm)	42098	-
	10 ft. (120 in.)(3.0 m)	5.50 in. (140 mm)	0.970 in. (24.6 mm)	42099	-



Cedar Texture







NEW OUTSIDE CORNERS

CEDAR TEXTURE TRIM

THE CLASSIC APPEARANCE OF CEDAR

- Interior or exterior use, including corner boards, windows and doors
- Narrow widths save cutting time
- Pre-primed for exceptional paint adhesion
- 16' length can result in faster installation and fewer seams
- Treated engineered wood strand substrate






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440 SERIES CEDAR TEXTURE PLOUGHED FASCIA



DESCRIPTION	LENGTH	ACTUAL WIDTH	THICKNESS	PID NUMBER	WEIGHT
190 Series Cedar Texture Trim	16 ft. (192 in.)(4.9 m)	2.50 in. (64 mm)	0.578 in. (14.6 mm)	28448	2 PSF
	16 ft. (192 in.)(4.9 m)	3.50 in. (89 mm)	0.578 in. (14.6 mm)	28450	2 PSF
	16 ft. (192 in.)(4.9 m)	5.50 in. (140 mm)	0.578 in. (14.6 mm)	28452	2 PSF
440 Series Cedar Texture Trim	16 ft. (192 in.)(4.9 m)	1.50 in. (38 mm)	0.675 in. (17.1 mm)	25877	2 PSF
	16 ft. (192 in.)(4.9 m)	2.50 in. (64 mm)	0.675 in. (17.1 mm)	25878	2 PSF
	16 ft. (192 in.)(4.9 m)	3.50 in. (89 mm)	0.675 in. (17.1 mm)	25880	2 PSF
	16 ft. (192 in.)(4.9 m)	5.50 in. (140 mm)	0.675 in. (17.1 mm)	25882	2 PSF
	16 ft. (192 in.)(4.9 m)	7.21 in. (183 mm)	0.675 in. (17.1 mm)	25883	2 PSF
	16 ft. (192 in.)(4.9 m)	9.21 in. (234 mm)	0.675 in. (17.1 mm)	25884	2 PSF
	16 ft. (192 in.)(4.9 m)	11.21 in. (285 mm)	0.675 in. (17.1 mm)	25885	2 PSF
540 Series Cedar Texture Trim	16 ft. (192 in.)(4.9 m)	1.50 in. (38 mm)	0.970 in. (24.6 mm)	25886 *	3 PSF
	16 ft. (192 in.)(4.9 m)	2.50 in. (64 mm)	0.970 in. (24.6 mm)	25887 *	3 PSF
	16 ft. (192 in.)(4.9 m)	3.50 in. (89 mm)	0.970 in. (24.6 mm)	25888	3 PSF
	16 ft. (192 in.)(4.9 m)	4.50 in. (114 mm)	0.970 in. (24.6 mm)	25889 *	3 PSF
	16 ft. (192 in.)(4.9 m)	5.50 in. (140 mm)	0.970 in. (24.6 mm)	25890	3 PSF
	16 ft. (192 in.)(4.9 m)	7.21 in. (183 mm)	0.970 in. (24.6 mm)	25891	3 PSF
	16 ft. (192 in.)(4.9 m)	9.21 in. (234 mm)	0.970 in. (24.6 mm)	25892	3 PSF
	16 ft. (192 in.)(4.9 m)	11.21 in. (285 mm)	0.970 in. (24.6 mm)	25893	3 PSF
440 Series Cedar Texture Ploughed Fascia	16 ft. (192 in.)(4.9 m)	5.50 in. (140 mm)	0.675 in. (17.1 mm)	27240 *	2 PSF
	16 ft. (192 in.)(4.9 m)	7.21 in. (183 mm)	0.675 in. (17.1 mm)	27819 *	2 PSF

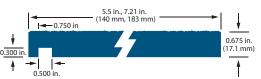

Cedar Texture

Specifications: LP® SmartSide® Trim

SMOOTH FINISH TRIM

SMOOTH APPEARANCE, ADVANCED DURABILITY OF ENGINEERED WOOD

- Holds up in extreme weather, including moisture, hail, freeze/thaw cycles, and up to 200 mph wind gusts
- Treated with the SmartGuard[®] process for superior protection against the weather, fungal decay and termites
- 16' length can result in faster installation and fewer seams
- Pre-primed for exceptional paint adhesion
- Backed by an industry-leading 5/50-year limited warranty
- Treated engineered wood strand substrate



540 SERIES SMOOTH FINISH TRIM



DESCRIPTION	LENGTH	ACTUAL WIDTH	THICKNESS	PID NUMBER	WEIGHT
440 Series Smooth Finish Trim	16 ft. (192 in.)(4.9 m)	1.50 in. (38 mm)	0.675 in. (17.1 mm)	41640	2 PSF
	16 ft (192 in.) (4.9 m)	2.50 in. (64 mm)	0.675 in. (17.1 mm)	41627	2 PSF
	16 ft. (192 in.)(4.9 m)	3.50 in. (89 mm)	0.675 in. (17.1 mm)	41420	2 PSF
	16 ft. (192 in.)(4.9 m)	5.50 in. (140 mm)	0.675 in. (17.1 mm)	41422	2 PSF
	16 ft. (192 in.)(4.9 m)	7.21 in. (183 mm)	0.675 in. (17.1 mm)	41423	2 PSF
	16 ft. (192 in.)(4.9 m)	9.21 in. (234 mm)	0.675 in. (17.1 mm)	41492	2 PSF
	16 ft. (192 in.)(4.9 m)	11.21 in. (285 mm)	0.675 in. (17.1 mm)	41490	2 PSF
540 Series Smooth Finish Trim	16 ft. (192 in.)(4.9 m)	1.50 in. (38 mm)	0.970 in. (24.6 mm)	41629	3 PSF
	16 ft. (192 in.)(4.9 m)	2.50 in. (64 mm)	0.970 in. (24.6 mm)	41628	3 PSF
	16 ft. (192 in.)(4.9 m)	3.50 in. (89 mm)	0.970 in. (24.6 mm)	41342	3 PSF
	16 ft. (192 in.)(4.9 m)	5.50 in. (140 mm)	0.970 in. (24.6 mm)	41343	3 PSF
	16 ft. (192 in.)(4.9 m)	7.21 in. (183 mm)	0.970 in. (24.6 mm)	41344	3 PSF
	16 ft. (192 in.)(4.9 m)	9.21 in. (234 mm)	0.970 in. (24.6 mm)	41345	3 PSF
	16 ft. (192 in.)(4.9 m)	11.21 in. (285 mm)	0.970 in. (24.6 mm)	41494	3 PSF





Smooth Finish

SMOOTH AND CEDAR TEXTURE SOFFIT

THE FINISHING TOUCH

- The perfect alternative to MDO and plywood soffits
- Cut-to-width eliminates time spent ripping full sheets
- 38 Series engineered for closed soffit applications
- 76 Series and 190 Series are ideal for use as the starter course for roofs with exposed eaves
- Treated engineered wood strand substrate
- Pre-primed for exceptional paint adhesion
- Comes in Cedar Texture and Smooth Finish

Smooth Finish



Cedar Texture

38 SERIES 4' x 8' CEDAR TEXTURE SOFFIT








190 SERIES 4' x 8' CEDAR TEXTURE SOFFIT

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DESCRIPTION	LENGTH	ACTUAL WIDTH	THICKNESS	PID NUMBER	WEIGHT
38 Series 4´x 8´ Cedar Texture Soffit	8 ft. (96 in.)(2.4 m)	47.88 in. (1 216 mm)	0.354 in. (8.9 mm)	25813	-
38 Series 4´x 8´ Cedar Texture Siding and Soffit Panel No Groove	8 ft. (96 in.)(2.4 m)	47.88 in. (1 216 mm)	0.354 in. (8.9 mm)	41044	1.5 PSF
76 Series 4´x 8´ Cedar Texture Soffit	8 ft. (96 in.)(2.4 m)	47.88 in. (1 216 mm)	0.418 in. (10.6 mm)	25814	-
190 Series 4' x 8' Cedar Texture Soffit	8 ft. (96 in.)(2.4 m)	47.88 in. (1 216 mm)	0.578 in. (14.6 mm)	25816 *	-
38 Series Cedar Texture Soffit - Cut-to-Width	16 ft. (192 in.)(4.9 m)	11.94 in. (303 mm)	0.354 in. (8.9 mm)	25805	-
	16 ft. (192 in.)(4.9 m)	15.94 in. (405 mm)	0.354 in. (8.9 mm)	25806	-
	16 ft. (192 in.)(4.9 m)	23.94 in. (608 mm)	0.354 in. (8.9 mm)	25807	-
76 Series Cedar Texture Soffit – Cut-to-Width	16 ft. (192 in.)(4.9 m)	11.94 in. (303 mm)	0.418 in. (10.6 mm)	25808 (Discontinued)	-
38 Series Smooth Finish Soffit - Cut-to-Width	16 ft. (192 in.) (4.96 m)	15.94 in. (405 mm)	0.354 in. (8.9 mm)	42127	-

38 SERIES SMOOTH FINISH SOFFIT - CUT-TO-WIDTH



38 SERIES CEDAR TEXTURE SOFFIT -CUT-TO-WIDTH

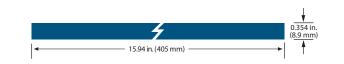

76 SERIES CEDAR TEXTURE SOFFIT -**CUT-TO-WIDTH**




VENTED SOFFIT

ENGINEERED TO CUT OUT PROBLEMS

- The perfect alternative to MDO, plywood or hand-installed metal vents
- Precisely cut vents offer 10 square inches of ventilation per linear foot, making it easier to meet code requirements while adding architectural beauty
- Designed to minimize paint buildup and promote continuous airflow
- 1/8" vents to help keep hornets and bees out
- Eliminates time spent ripping full sheets
- Treated engineered wood strand substrate

38 SERIES VENTED CEDAR TEXTURE SOFFIT - CUT-TO-WIDTH

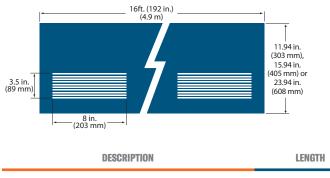




16 ft. (192 in.)(4.9







Cedar Texture

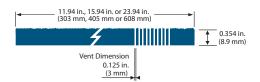

	ACTUAL WIDTH	THICKNESS	PID NUMBER	WEIGHT	
9 m)	11.94 in. (303 mm)	0.354 in. (8.9 mm)	25822	-	
9 m)	15.94 in. (405 mm)	0.354 in. (8.9 mm)	25823	-	
9 m)	23.94 in. (608 mm)	0.354 in. (8.9 mm)	25824	-	

Wisconsin Building Supply

Customer Information Name: Turke Homes



Image is viewed from Exterior!

Job Name:

Contact:

Address:

Phone 1: Phone 2:

— Specifications -

Fax:

U.D. = 37-1/2" x 81-5/8";	R.O. = 38-1/4"	x 82"
· · · · · · · · · · · · · · · · · · ·		
O.M. of Exterior Trim = 3	8-5/8" x 82-3/16	5''

Lead Time: Stock (Call to verify)

Comment: Back Door

Item Description	Qty	Price	Extended
3' 0" x 6' 8" CCA210-LE Classic Craft Fir Grain Fiberglass Door w/Low E Glass - Left	1	1,568.77	\$1,568.77
Hand Inswing			
2-3/8" Backset - Double Bore (2-1/8" Dia. Bore w/Standard 5-1/2" Spacing) w/Deadbolt	1	9.49	\$9.49
Deadbolt 1 (Schlage) 1-1/8´´ x 2-3/4´´ x 3/16´´ depth Strike Prep			
Set of Ball Bearing - Black Nickel Hinges	1	6.57	\$6.57
White Aluminum Clad Frame w/Primed DuraFrame Interior - 6-9/16" Jamb w/Crown	1	288.35	\$288.35
Line Exterior Trim (Applied) w/(1)Oil Rubbed Bronze Adjustable Security Strike Plate			
(for Lockset only)			
Compression Weatherstrip	1	0.00	\$0.00
Composite Adjustable - Mill Finish Sill	1	0.00	\$0.00
Sill Cover	1	8.03	\$8.03
Item Total			\$1,881.21



Customer Information

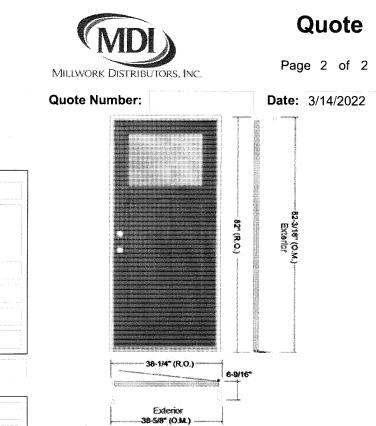


Image is viewed from Exterior!

 Name:
 Turke Homes

 Address:
 Image: Contact:

 Job Name:
 Image: Contact:

____ Specifications _

U.D. = 37-1/2" x 81-5/8"; R.O. = 38-1/4" x 82"
O.M. of Exterior Trim = 38-5/8" x 82-3/16"

Lead Time: Stock (Call to verify)

Comment: Entry Door

Item Description	Qty	Price	Extended
3' 0" x 6' 8" CCA210-LE Classic Craft Fir Grain Fiberglass Door w/Low E Glass - Right	1	1,568.77	\$1,568.77
Hand Inswing			
2-3/8" Backset - Double Bore (2-1/8" Dia. Bore w/Standard 5-1/2" Spacing) w/Deadbolt	1	9.49	\$9.49
Deadbolt 3 (2-1/4 '' lipped for Security Strike) 1/8 '' depth Strike Prep			
Set of Ball Bearing - Black Nickel Hinges	1	6.57	\$6.57
White Aluminum Clad Frame w/Primed DuraFrame Interior - 6-9/16" Jamb w/Crown	1	294.92	\$294.92
Line Exterior Trim (Applied) w/(2)Oil Rubbed Bronze Adjustable Security Strike Plates			
(for Lockset and Deadbolt)			
Compression Weatherstrip	1	0.00	\$0.00
Composite Adjustable - Mill Finish Sill	1	0.00	\$0.00
Sill Cover	1	8.03	\$8.03
Item Total			\$1,887.78

Order Sub Total:	\$3,768.99
Tax:	\$207.29
Order Total:	\$3,976.28
Version #: 3.45 Version Date: 2/23	3/2022

REE	DOORS
Cross Plains, 707	GARAGE DOOR SPECIALISTS

1205 Bourbon Rd. #1 Cross Plains, WI 53528

Proposal

Date Estimate # 3/15/2022 25253

Project

1709 Regent St, Madison (Goetzke)

Contact Information

608-320-8070

Name / Address Milissa Turke Homes LLC PO Box 628155

WEB SITE: www.randrdoors.com

Middleton, WI 53562

PHONE: 608-798-3581

FAX: 608-798-4685

	Description		Qty	Cost	Total	
 1 3/8" thick, steel both Panel Design Options Flush Panel Color Options: (Please Chocolate Brown, Hunt 12" radius track 	e Choose) White, Almond, D	n (R-Value=6.5) ed Panel, Long Raised Panel, or Desert Tan, Sandstone, Bronze,	1	2,479.00	2,479.00	
			1	470.00	470.00	
controls; installed	1/2np AC Belt Drive WI-FI O	perator with 8' rail and two remote	1	470.00	470.00	
877LM Keyless Entry			1	50.00	50.00	
*New construction						
		payable on receipt. Invoices over thirty days will t of collection, all costs and reasonable attorne				
All finish painting, finish jamb preparations, and all electrical wiring by others. We are fully covered by Workers Comp Ins.			Total		\$2,999.00	
Submitted By:	NC-R		is Proposal is subject to acceptance within 5 days. If you wish to roceed please sign and return a copy.			
		Accepted By:				

As required by the Wisconsin Construction Lien Law, builder hereby notifies owner that companies furnishing labor or materials for the construction on owners land may have Lien rights on owners land and buildings if not paid. Those entitled to Lien rights, in addition to the abovesigned builder, are those who contract directly with the owner or who give the owner notice within 60 days after they furnish labor or material for the construction. Builder agrees to co-operate with the owner and his lender, if any, to see that all potential Lien claimants are duly paid. All material is guaranteed to be as specified. All work is to be completed in a workmanlike manner according to standard practices. Any alteration or deviation from above specifications involving extra costs will be executed only upon written orders and will become an extra charge over and above the estimate. All agreements contingent upon delays beyond our control.

insulation technology

Clopay Classic[™] Steel Premium garage doors featuring Intellicore[®] insulation technology represent the ultimate smart choice for homeowners. Clopay's Intellicore[®] insulation is a proprietary polyurethane foam that is injected into our Premium doors, expanding to fill the entire structure. The result is a door with incredible strength and durability. Its dense insulation also produces a quieter door, and with one of the industry's leading R-values of 18.4, it provides year-round comfort and improved energy efficiency.



WARMER Energy efficiency provides year-round comfort



QUIETER Dense insulation reduces noise by up to 16 decibels



STRONGER Enhanced strength resists everyday wear and tear



RUST-PREVENTION SYSTEM



Steel skins are protected through a tough, layered coating system, including a hot-dipped galvanized layer, a protective metal oxide pretreatment and a bakedon primer and top coat.

GREATER ENERGY EFFICIENCY



Thermal break* separates the interior from the exterior skin to improve energy efficiency and comfort.

ENVIRONMENTAL ASSURANCE

Clopay doors are compliant with environmental laws and regulations. Clopay doors do not contain HFCs. All Clopay doors are compliant with:

- California SB 1013
- New Jersey A-5583/S-3919 Greenhouse Gas Bill
- Washington HB 1112 Hydrofluorocarbon Greenhouse Gas Emissions
- Canadian regulations amending the ozone-depleting substances and halocarbon alternatives regulations

WARRANTIES



*Thermal break is not present on Models 4050 and 4053.