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# SALVATION ARMY SITE REDEVELOPMENT

MADISON, WI



UDC FINAL

MARCH 1, 2022

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## PROJECT TEAM:




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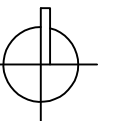



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# SALVATION ARMY DANE COUNTY – 630 E. WASHINGTON AVE.

SITE LOCATOR MAP

MARCH 1, 2022

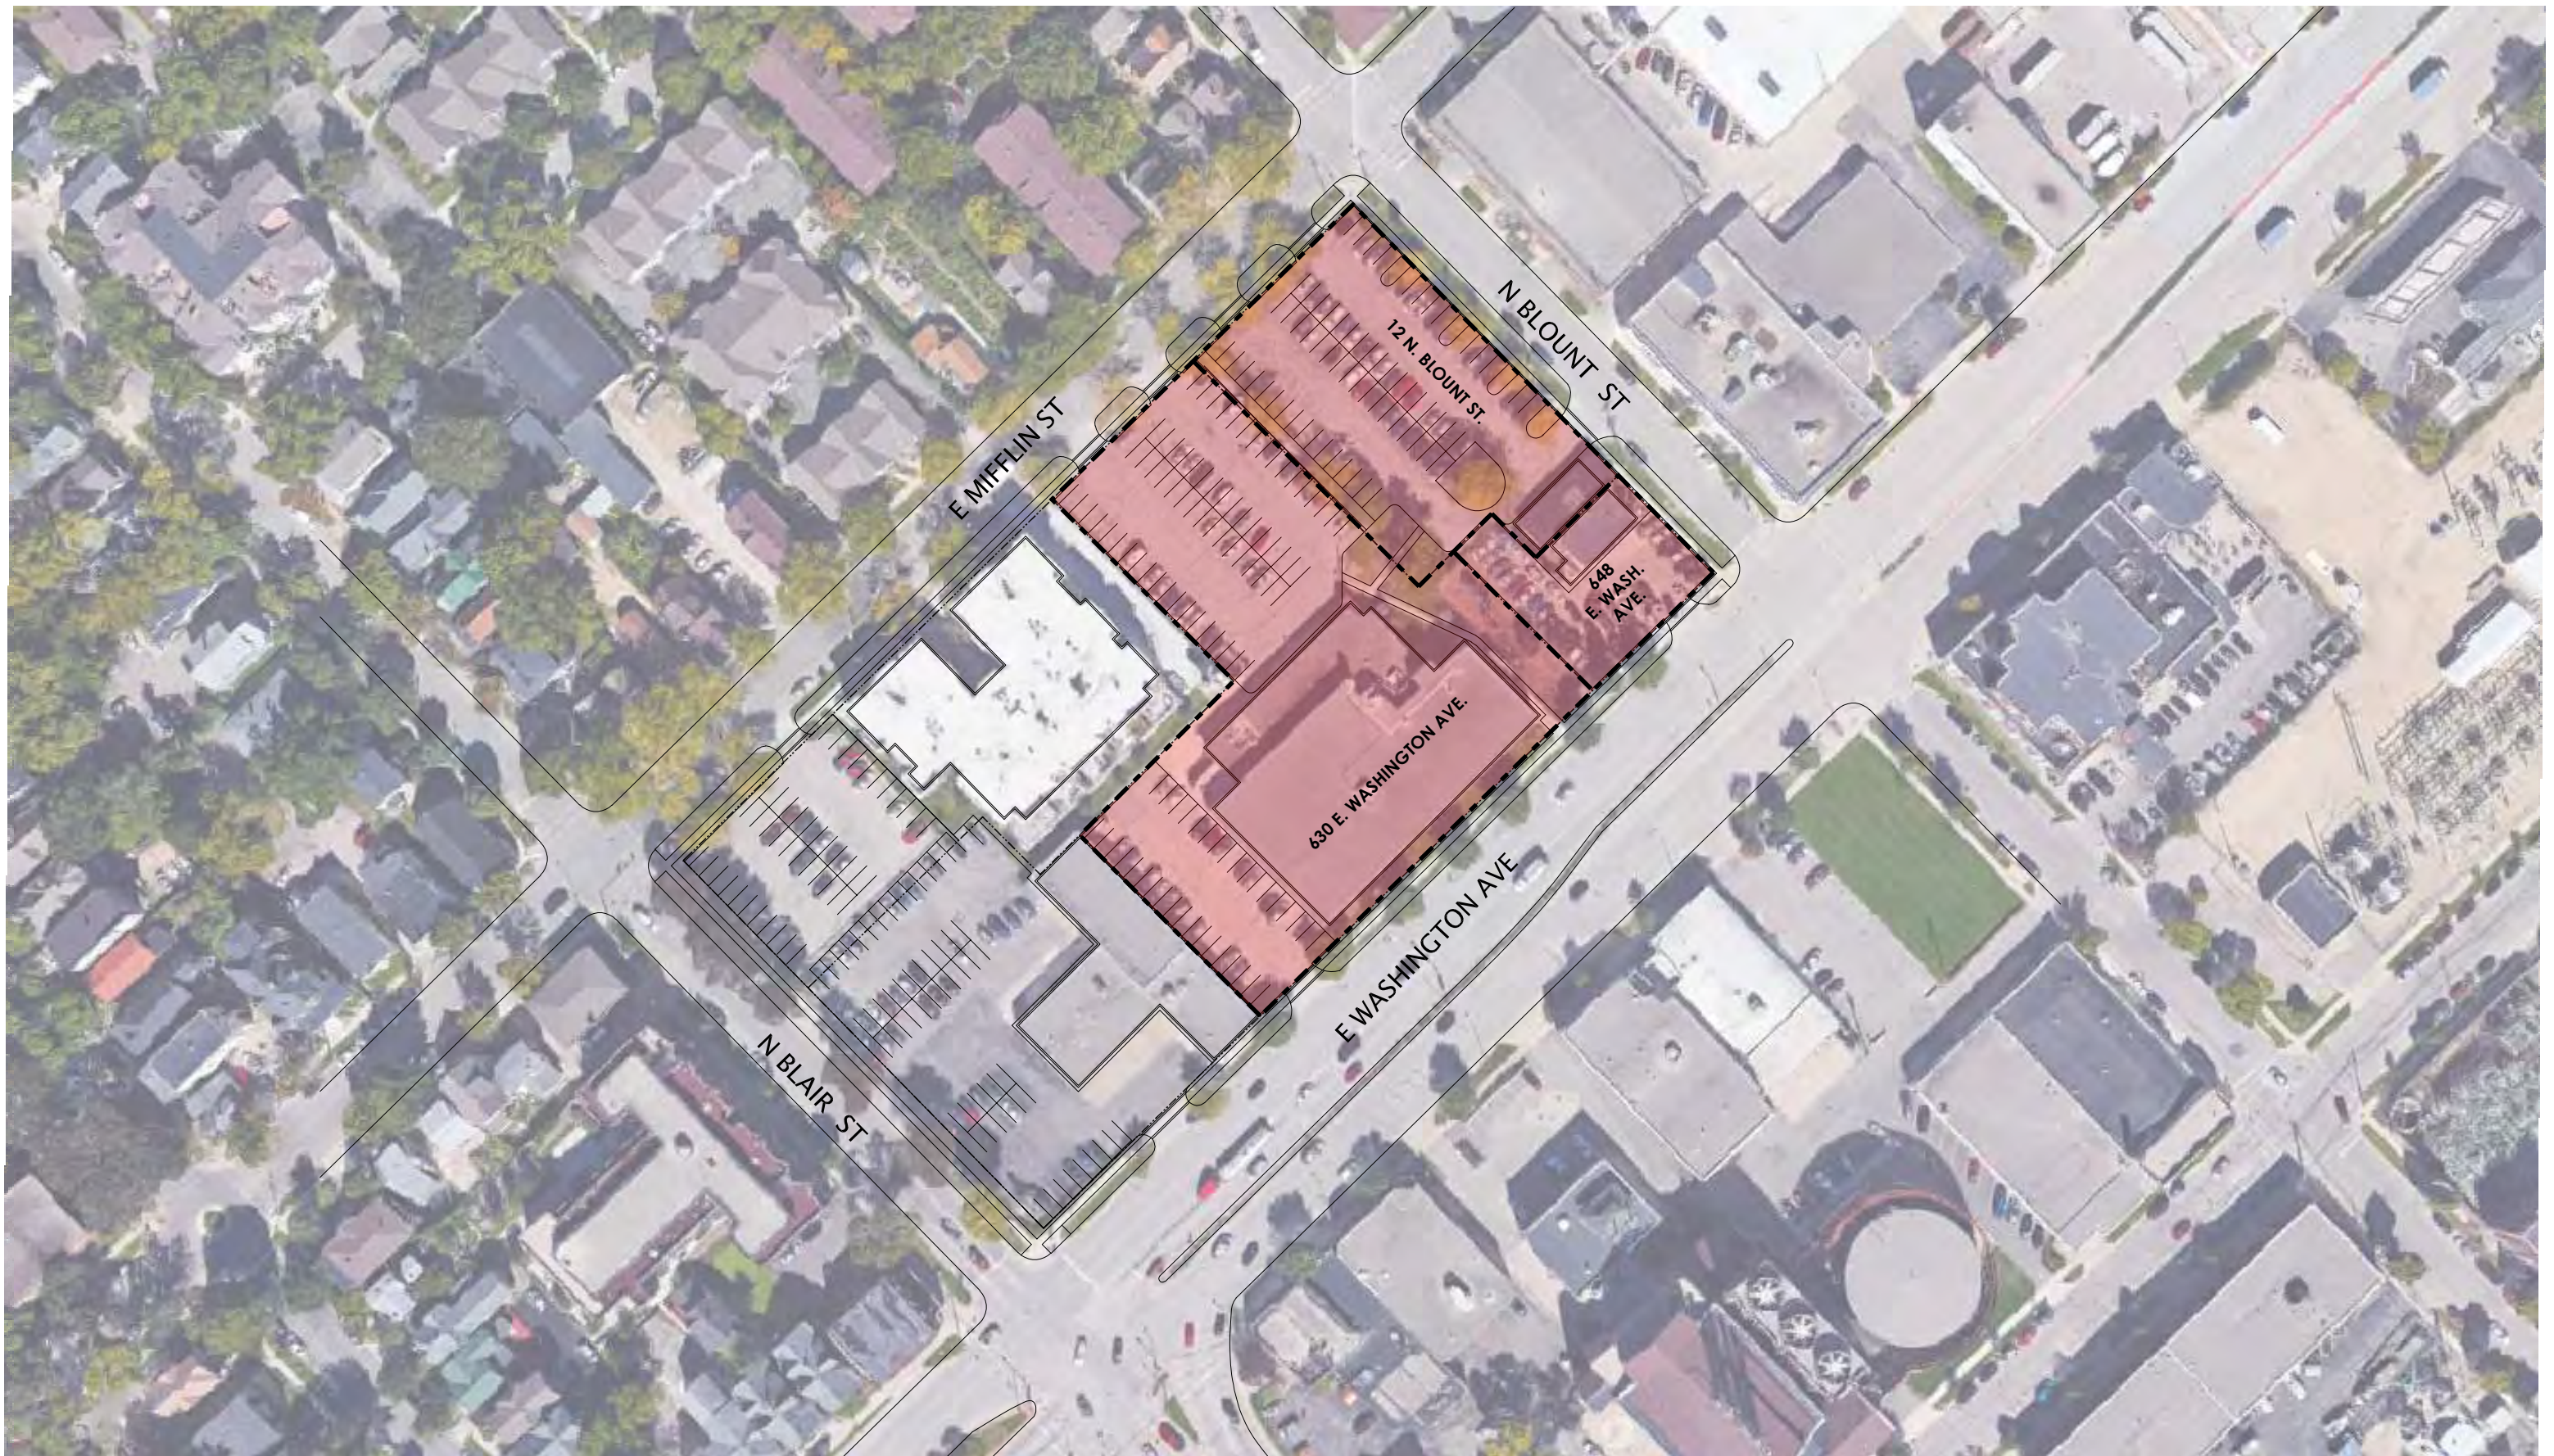

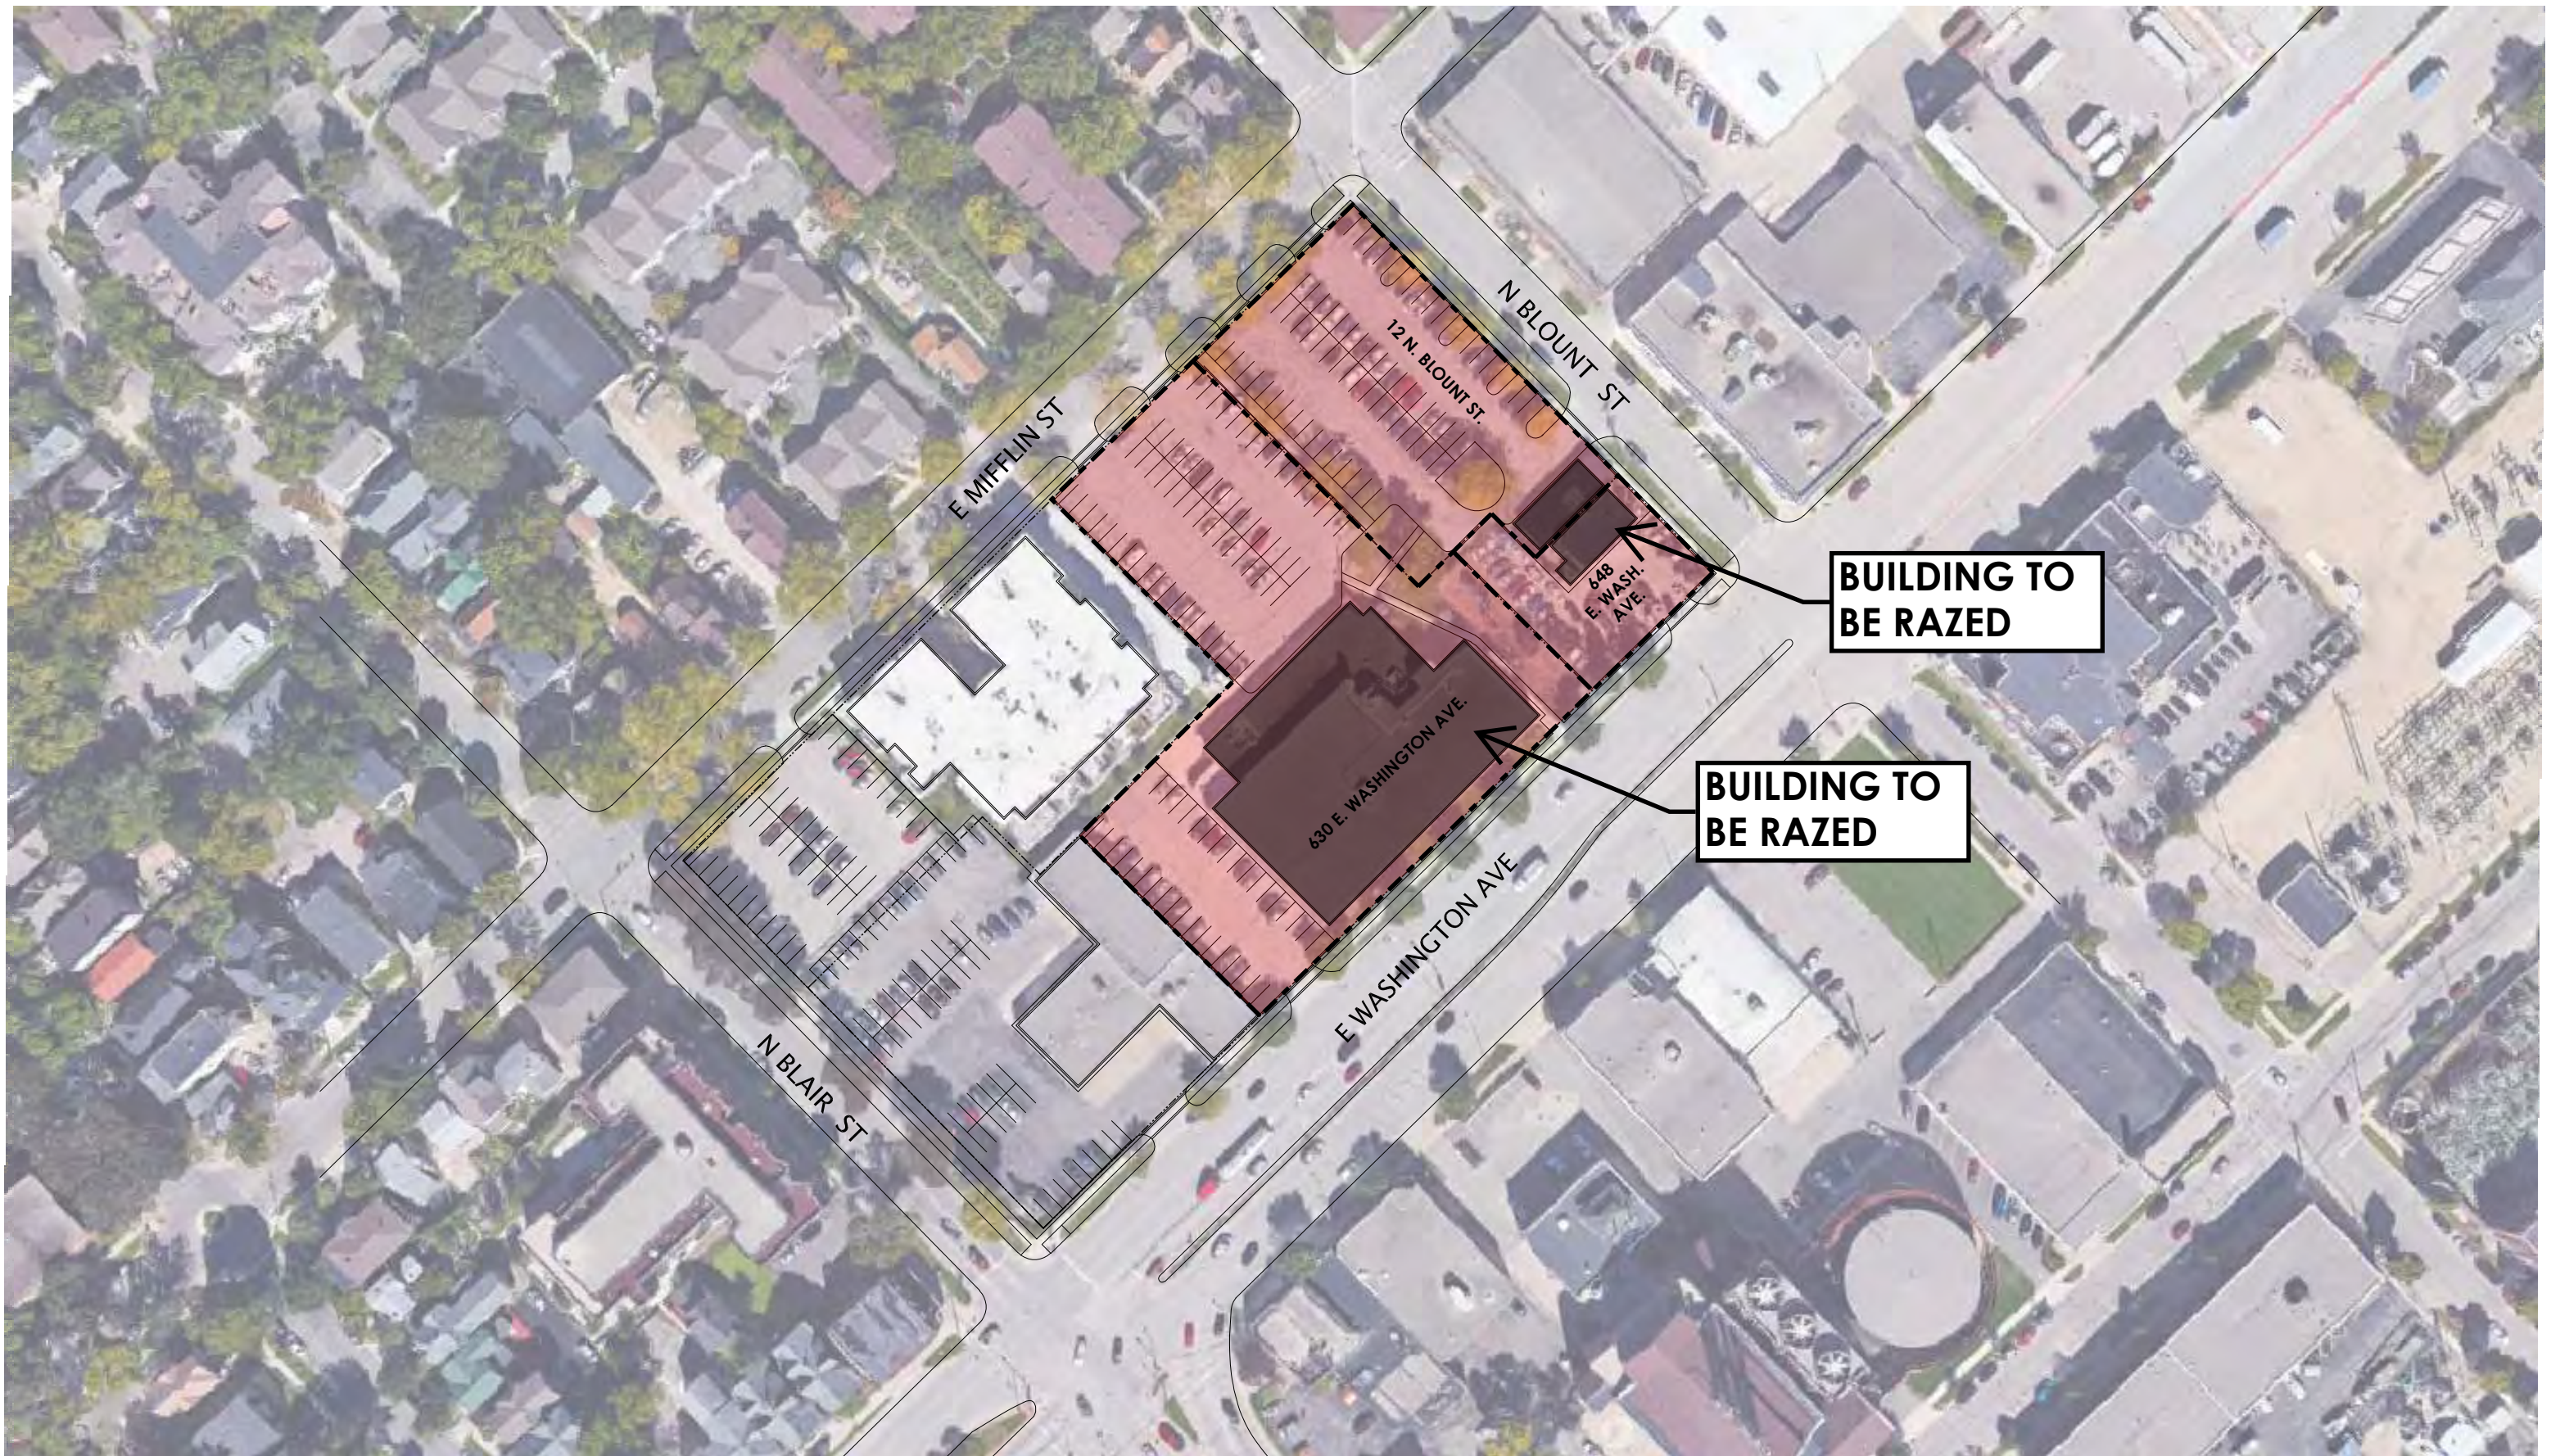

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# SALVATION ARMY DANE COUNTY – 630 E. WASHINGTON AVE.

DEMOLITION - SITE LOCATOR MAP

MARCH 1, 2022



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# SALVATION ARMY DANE COUNTY – 630 E. WASHINGTON AVE.

CONTEXTUAL SITE INFO

MARCH 1, 2022






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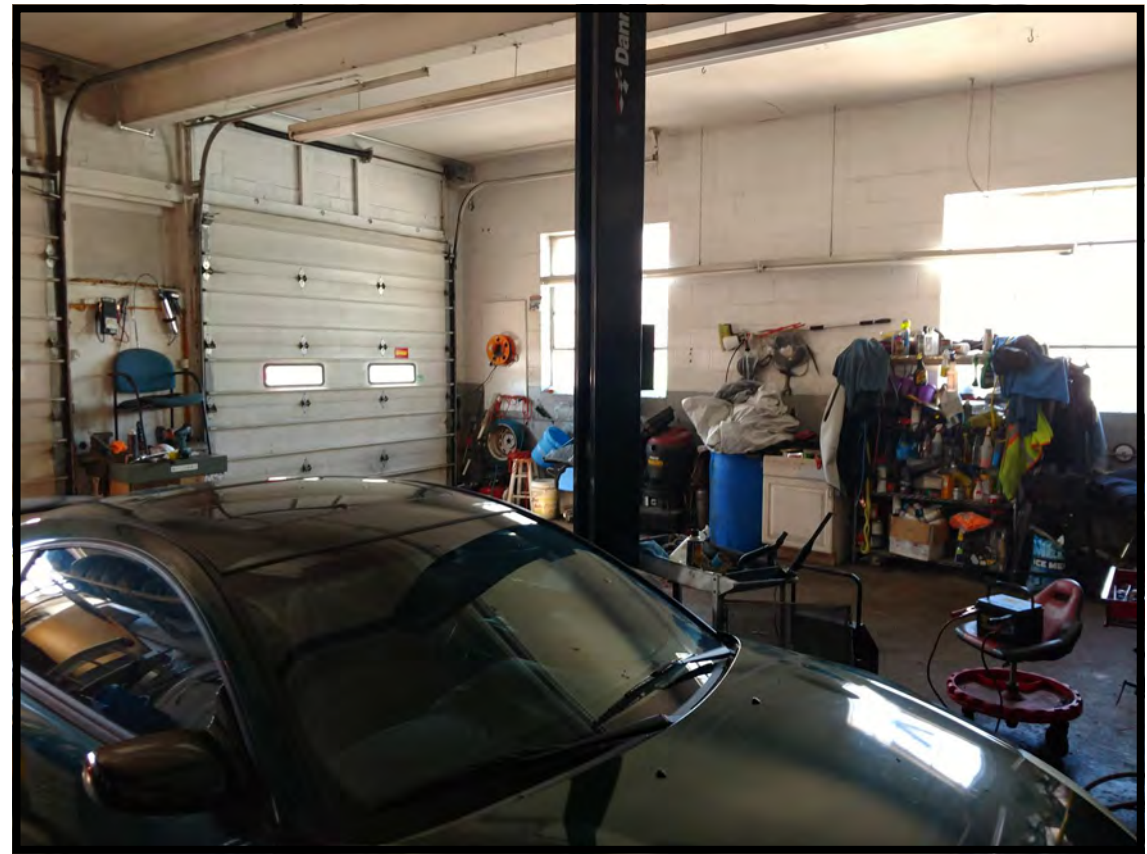
# SALVATION ARMY DANE COUNTY – 630 E. WASHINGTON AVE.

CONTEXTUAL SITE INFO

MARCH 1, 2022



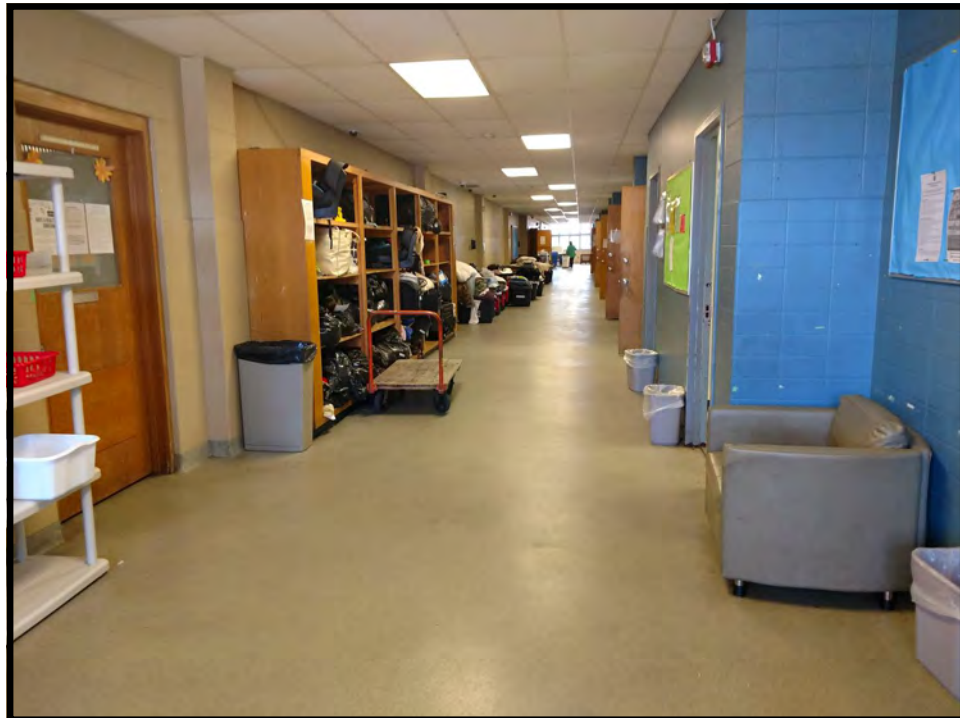



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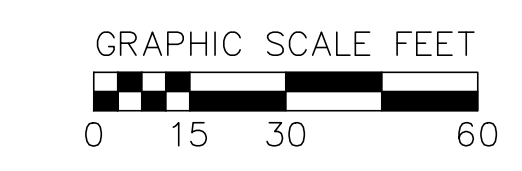
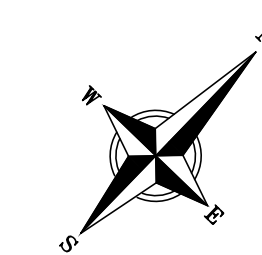
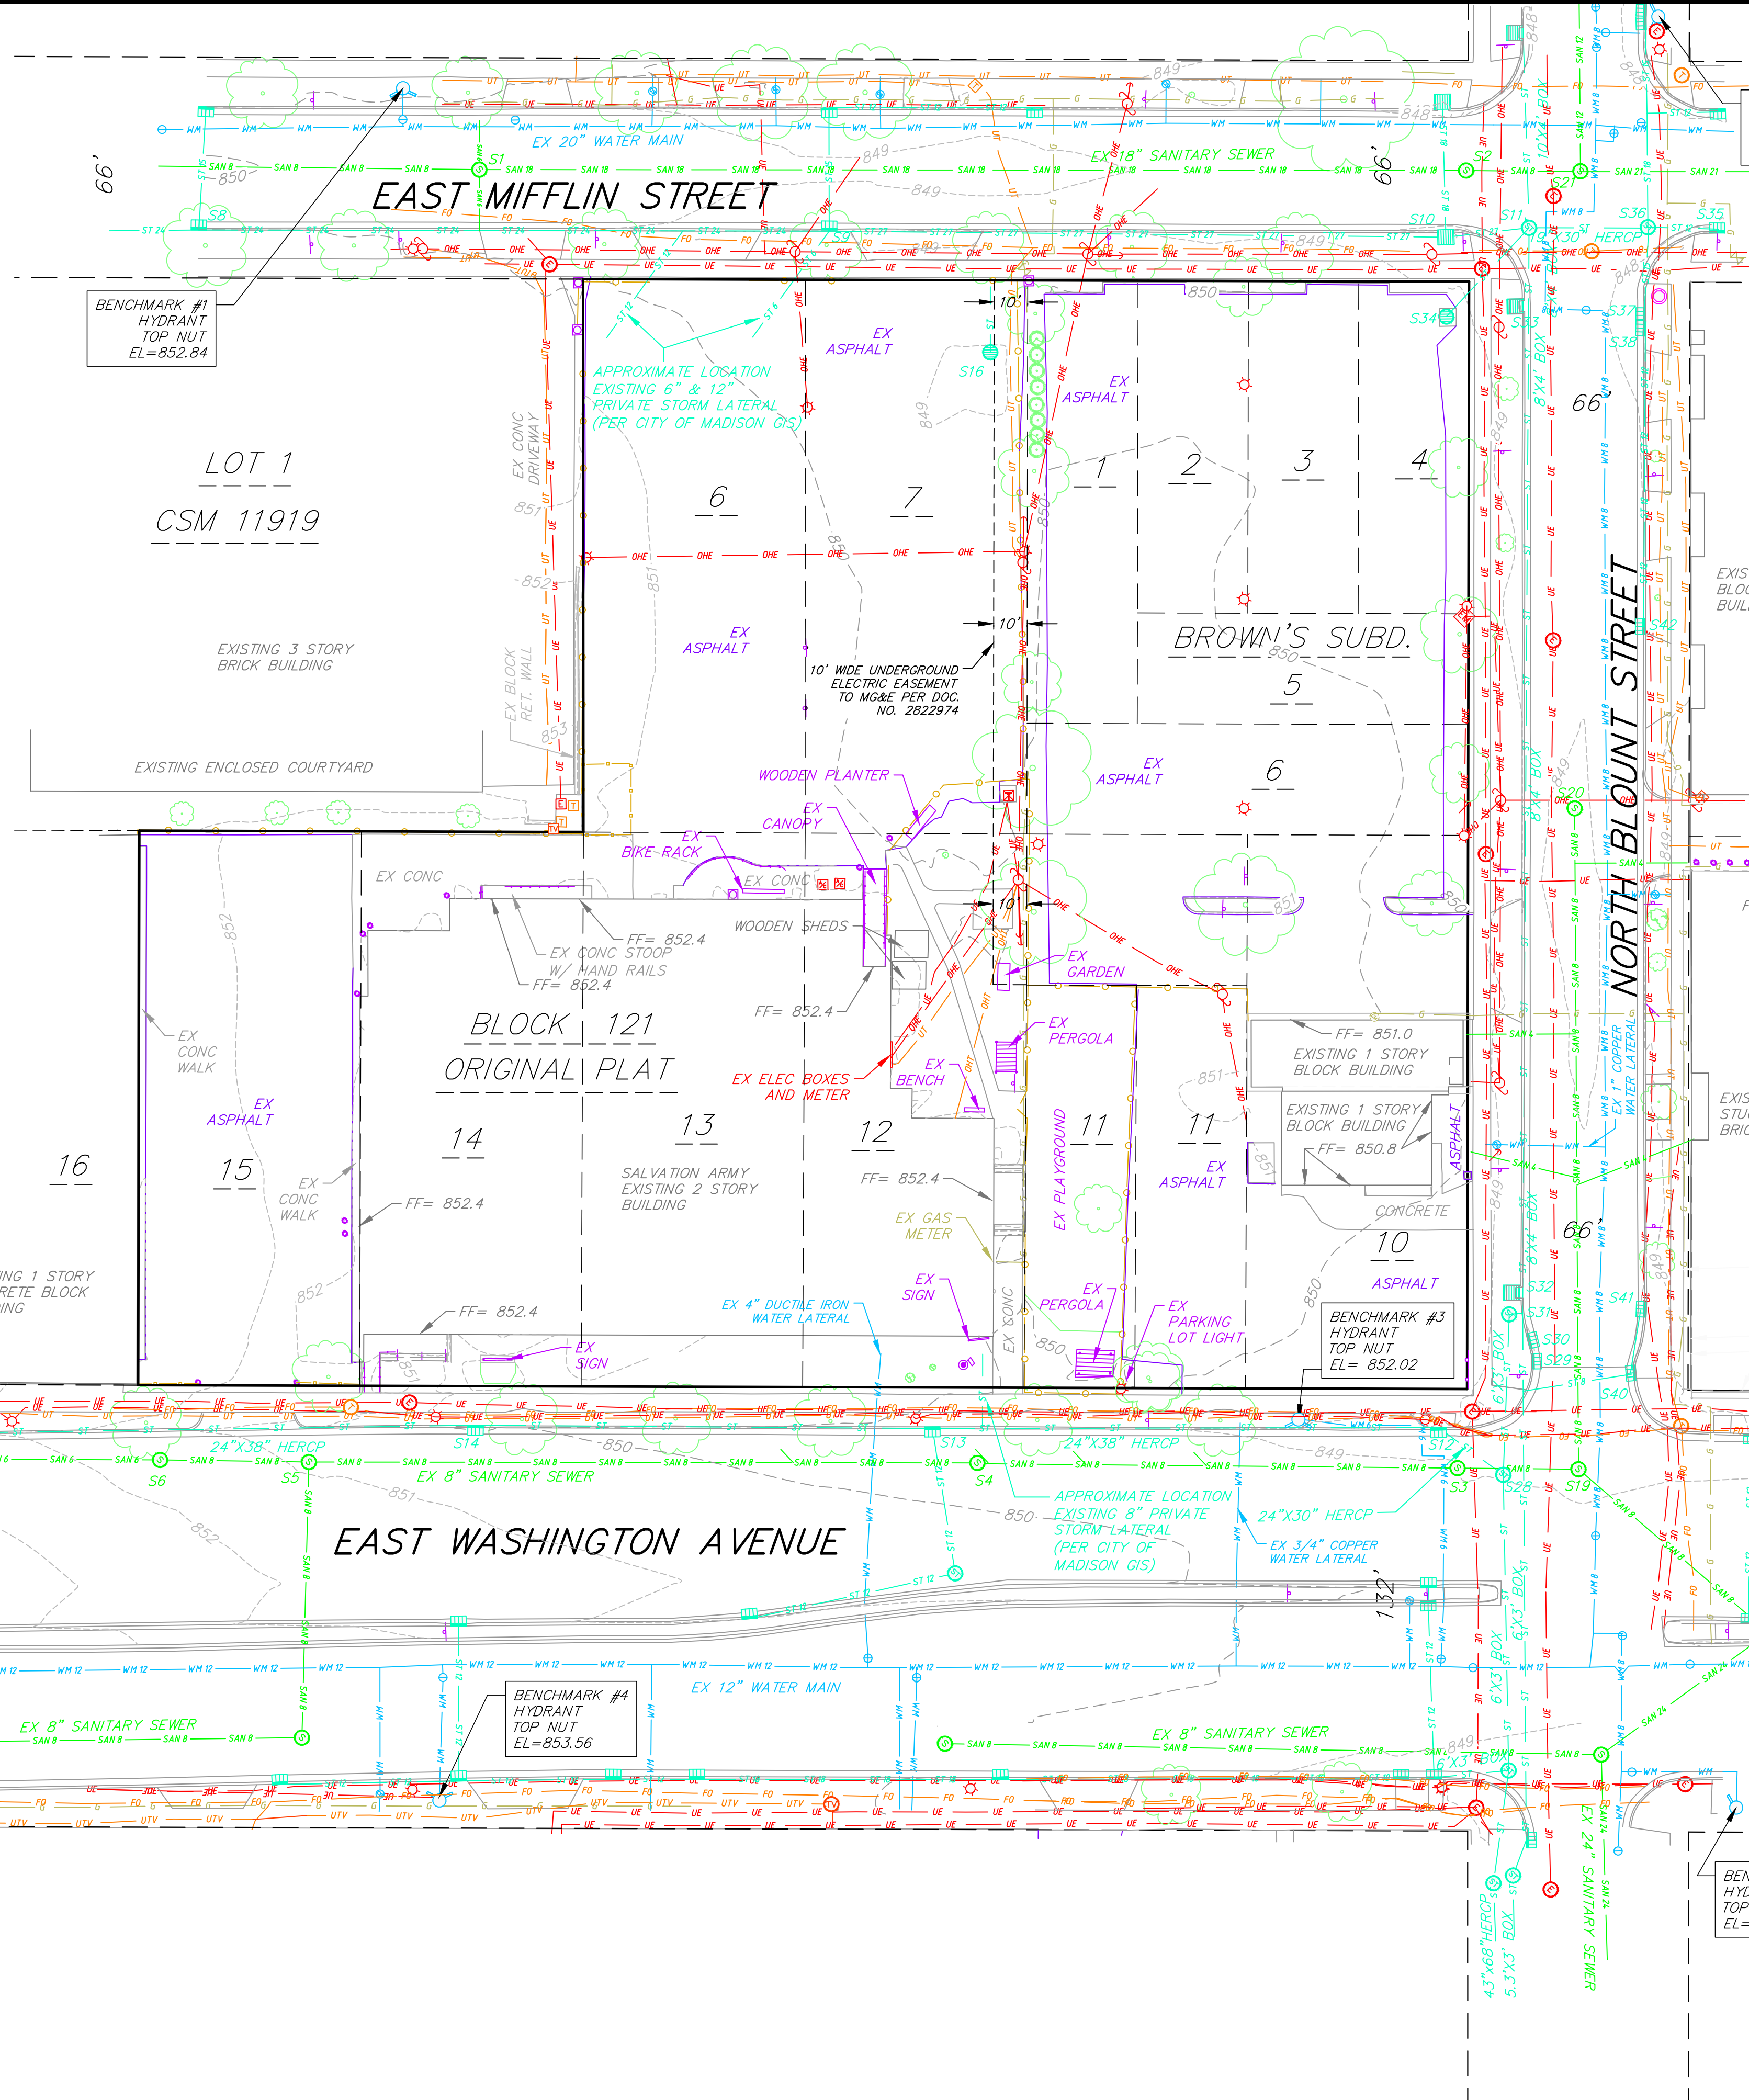
## SALVATION ARMY DANE COUNTY – 630 E. WASHINGTON AVE.

CONTEXTUAL SITE INFO

MARCH 1, 2022

NOTES:

1. AREA OF PARCEL SURVEYED IS 91,077 SQUARE FEET MORE OR LESS.
2. THIS SURVEY IS BASED UPON FIELD SURVEY WORK PERFORMED IN AUGUST 2016, AND REVISED IN APRIL 2019. ANY CHANGES IN SITE CONDITIONS AFTER APRIL 2019 ARE NOT REFLECTED BY THIS SURVEY.
3. UTILITY LOCATIONS WERE FIELD LOCATED BASED UPON SUBSTANTIAL, VISIBLE, ABOVE GROUND STRUCTURES, UPON MAPS PROVIDED TO THE SURVEYOR, OR UPON MARKINGS ON THE GROUND PLACED BY UTILITY COMPANIES AND/OR THEIR AGENTS. NO WARRANTY IS GIVEN TO THE UTILITY MARKINGS BY OTHERS OR THAT ALL UNDERGROUND UTILITIES AFFECTING THIS PROPERTY WERE MARKED AND SUBSEQUENTLY LOCATED FOR THIS SURVEY. THE SIZE OF WATER MAIN AND SANITARY SEWER HAS BEEN NOTED PER MAPS PROVIDED TO THE SURVEYOR.
4. NO ATTEMPT HAS BEEN MADE AS A PART OF THIS SURVEY TO OBTAIN OR SHOW DATA CONCERNING CONDITION, OR CAPACITY OF ANY UTILITY OR MUNICIPAL/PUBLIC SERVICE FACILITY. FOR INFORMATION REGARDING THESE UTILITIES CONTACT THE APPROPRIATE AGENCIES.
5. SURVEYOR HAS MADE NO INVESTIGATION OR INDEPENDENT SEARCH FOR EASEMENTS OF RECORD, ENCUMBRANCES, RESTRICTIVE COVENANTS, OR OWNERSHIP TITLE EVIDENCE.
6. CONTOURS AND ELEVATIONS DEPICTED HEREON ARE BASED UPON THE NAVD88 DATUM.



- TOPOGRAPHIC LINEWORK LEGEND**
- FO — FO — EXISTING FIBER OPTIC LINE
  - CL — CL — EXISTING CHAIN LINK FENCE
  - GF — GF — EXISTING GENERAL FENCE
  - WF — WF — EXISTING WOOD FENCE
  - G — G — EXISTING GAS LINE
  - UE — UE — EXISTING UNDERGROUND ELECTRIC LINE
  - OHU — OHU — EXISTING OVERHEAD GENERAL UTILITIES
  - SAN — SAN — EXISTING SANITARY SEWER LINE (SIZE NOTED)
  - ST — ST — EXISTING STORM SEWER LINE (SIZE NOTED)
  - WM — WM — EXISTING WATER MAIN (SIZE NOTED)
  - 820 - - EXISTING MAJOR CONTOUR
  - 818 - - EXISTING MINOR CONTOUR

- TOPOGRAPHIC SYMBOL LEGEND**
- EXISTING BOLLARD
  - ↑ EXISTING SIGN
  - EXISTING POST
  - ▤ EXISTING CURB INLET
  - ⊕ EXISTING FIELD INLET
  - ⊕ EXISTING STORM MANHOLE
  - ⊕ EXISTING STORM MANHOLE RECTANGULAR
  - ⊕ EXISTING SANITARY MANHOLE
  - ⊕ EXISTING FIRE HYDRANT
  - ⊕ EXISTING WATER MAIN VALVE
  - ⊕ EXISTING GAS METER
  - ↑ EXISTING DOWN GUY
  - ⊕ EXISTING ELECTRIC MANHOLE
  - ⊕ EXISTING ELECTRIC PEDESTAL
  - ⊕ EXISTING TRANSFORMER
  - ⊕ EXISTING ELECTRIC METER
  - ⊕ EXISTING LIGHT POLE
  - ⊕ EXISTING UTILITY POLE
  - ⊕ EXISTING TELEPHONE MANHOLE
  - ⊕ EXISTING TELEPHONE PEDESTAL
  - ⊕ EXISTING HANDICAP PARKING
  - EXISTING DECIDUOUS TREE
  - EXISTING SHRUB
  - EXISTING CONIFEROUS TREE

**DIGGERS HOTLINE**  
 Dial 811 or (800) 242-8511  
 www.DiggersHotline.com

THE LOCATION OF EXISTING UTILITIES, BOTH UNDERGROUND AND OVERHEAD ARE APPROXIMATE ONLY AND HAVE NOT BEEN INDEPENDENTLY VERIFIED BY THE OWNER OR ITS REPRESENTATIVE. THE CONTRACTOR SHALL BE RESPONSIBLE FOR DETERMINING THE EXACT LOCATION OF ALL EXISTING UTILITIES WHETHER SHOWN ON THESE PLANS OR NOT, BEFORE COMMENCING WORK, AND SHALL BE FULLY RESPONSIBLE FOR ANY AND ALL DAMAGES WHICH MIGHT BE CAUSED BY THE CONTRACTOR'S FAILURE TO EXACTLY LOCATE AND PRESERVE ANY AND ALL UTILITIES.

CALL DIGGER'S HOTLINE  
 1-800-242-8511

**Existing Conditions Plan**  
 622 and 630 East Washington  
 City of Madison  
 Dane County, Wisconsin


REVISIONS	NO.	DATE	REMARKS

SCALE	AS SHOWN
DATE	3/2/2022
DRAFTER	CKNA
CHECKED	JKAS
PROJECT NO.	160245
SHEET	1 OF 5
DWG. NO.	C2.0

**vierbicher**  
 planners | engineers | advisors  
 Phone: (800) 261-3898

DEMOLITION NOTES:

- CONTRACTOR TO CONFIRM CONCRETE WALK/CURB IS NOT TIED TO ADJACENT BUILDING AND REMOVE. PROTECT ADJACENT BUILDING AND RESTORE GRADE TO EXISTING CONDITIONS.
- ALL BUILDINGS ON SITE TO BE RAZED. UTILITY ABANDONMENTS TO BE COORDINATED WITH APPROPRIATE CITY DEPARTMENTS AND UTILITY PROVIDERS.
- REMOVE EXISTING CONCRETE DRIVEWAY ENTRANCE INCLUDING CURB AND GUTTER ON EAST WASHINGTON AVENUE. MAINTAIN CONCRETE PAVEMENT.
- RAMPS, RAILINGS, AND STEPS TO EXISTING BUILDING TO BE REMOVED.
- COORDINATE REMOVAL OF EXISTING SIGNS, SIGN FOUNDATIONS, AND ELECTRIC SERVICE FOR SIGNS WITH ARCHITECTURAL PLANS.
- EXISTING SITE FEATURES INCLUDING FENCING, POLES, TREES, SHRUBS, BOLLARDS, PERGOLAS, SHEDS, PLANTERS, AND GARDENS SHALL BE REMOVED AND DISPOSED.
- PLAYGROUND EQUIPMENT, BENCHES, AND BIKE RACKS TO BE SALVAGED AND DELIVERED TO STORAGE AS DIRECTED BY OWNER.
- CONCRETE OR ASPHALT CURBS, SIDEWALKS, AND PAVEMENTS AND ASSOCIATED BASE COURSE TO BE REMOVED.
- COORDINATE TREE REMOVAL WITH LANDSCAPE ARCHITECT. ALL TREES TO BE REMOVED SHALL BE REMOVED IN THEIR ENTIRETY AND STUMPS SHALL BE GROUND TO 12" BELOW PROPOSED SUBGRADE. ALL BRUSH SHALL BE CLEARED/REMOVED WITHIN DISTURBANCE LIMITS.
- ALL LIGHT POLES TO BE REMOVED FROM PRIVATE PROPERTY SHALL BE REMOVED IN THEIR ENTIRETY, INCLUDING BASE AND ALL APPURTENANCES. COORDINATE ABANDONMENT OF ELECTRICAL LINES WITH ELECTRICAL ENGINEER AND OWNER PRIOR TO DEMOLITION.
- ABANDON EXISTING UTILITY CONNECTIONS THAT WILL NOT BE RE-USED WITH PROPOSED CONSTRUCTION. ABANDONMENTS SHALL BE AS DIRECTED BY UTILITY PROVIDER.

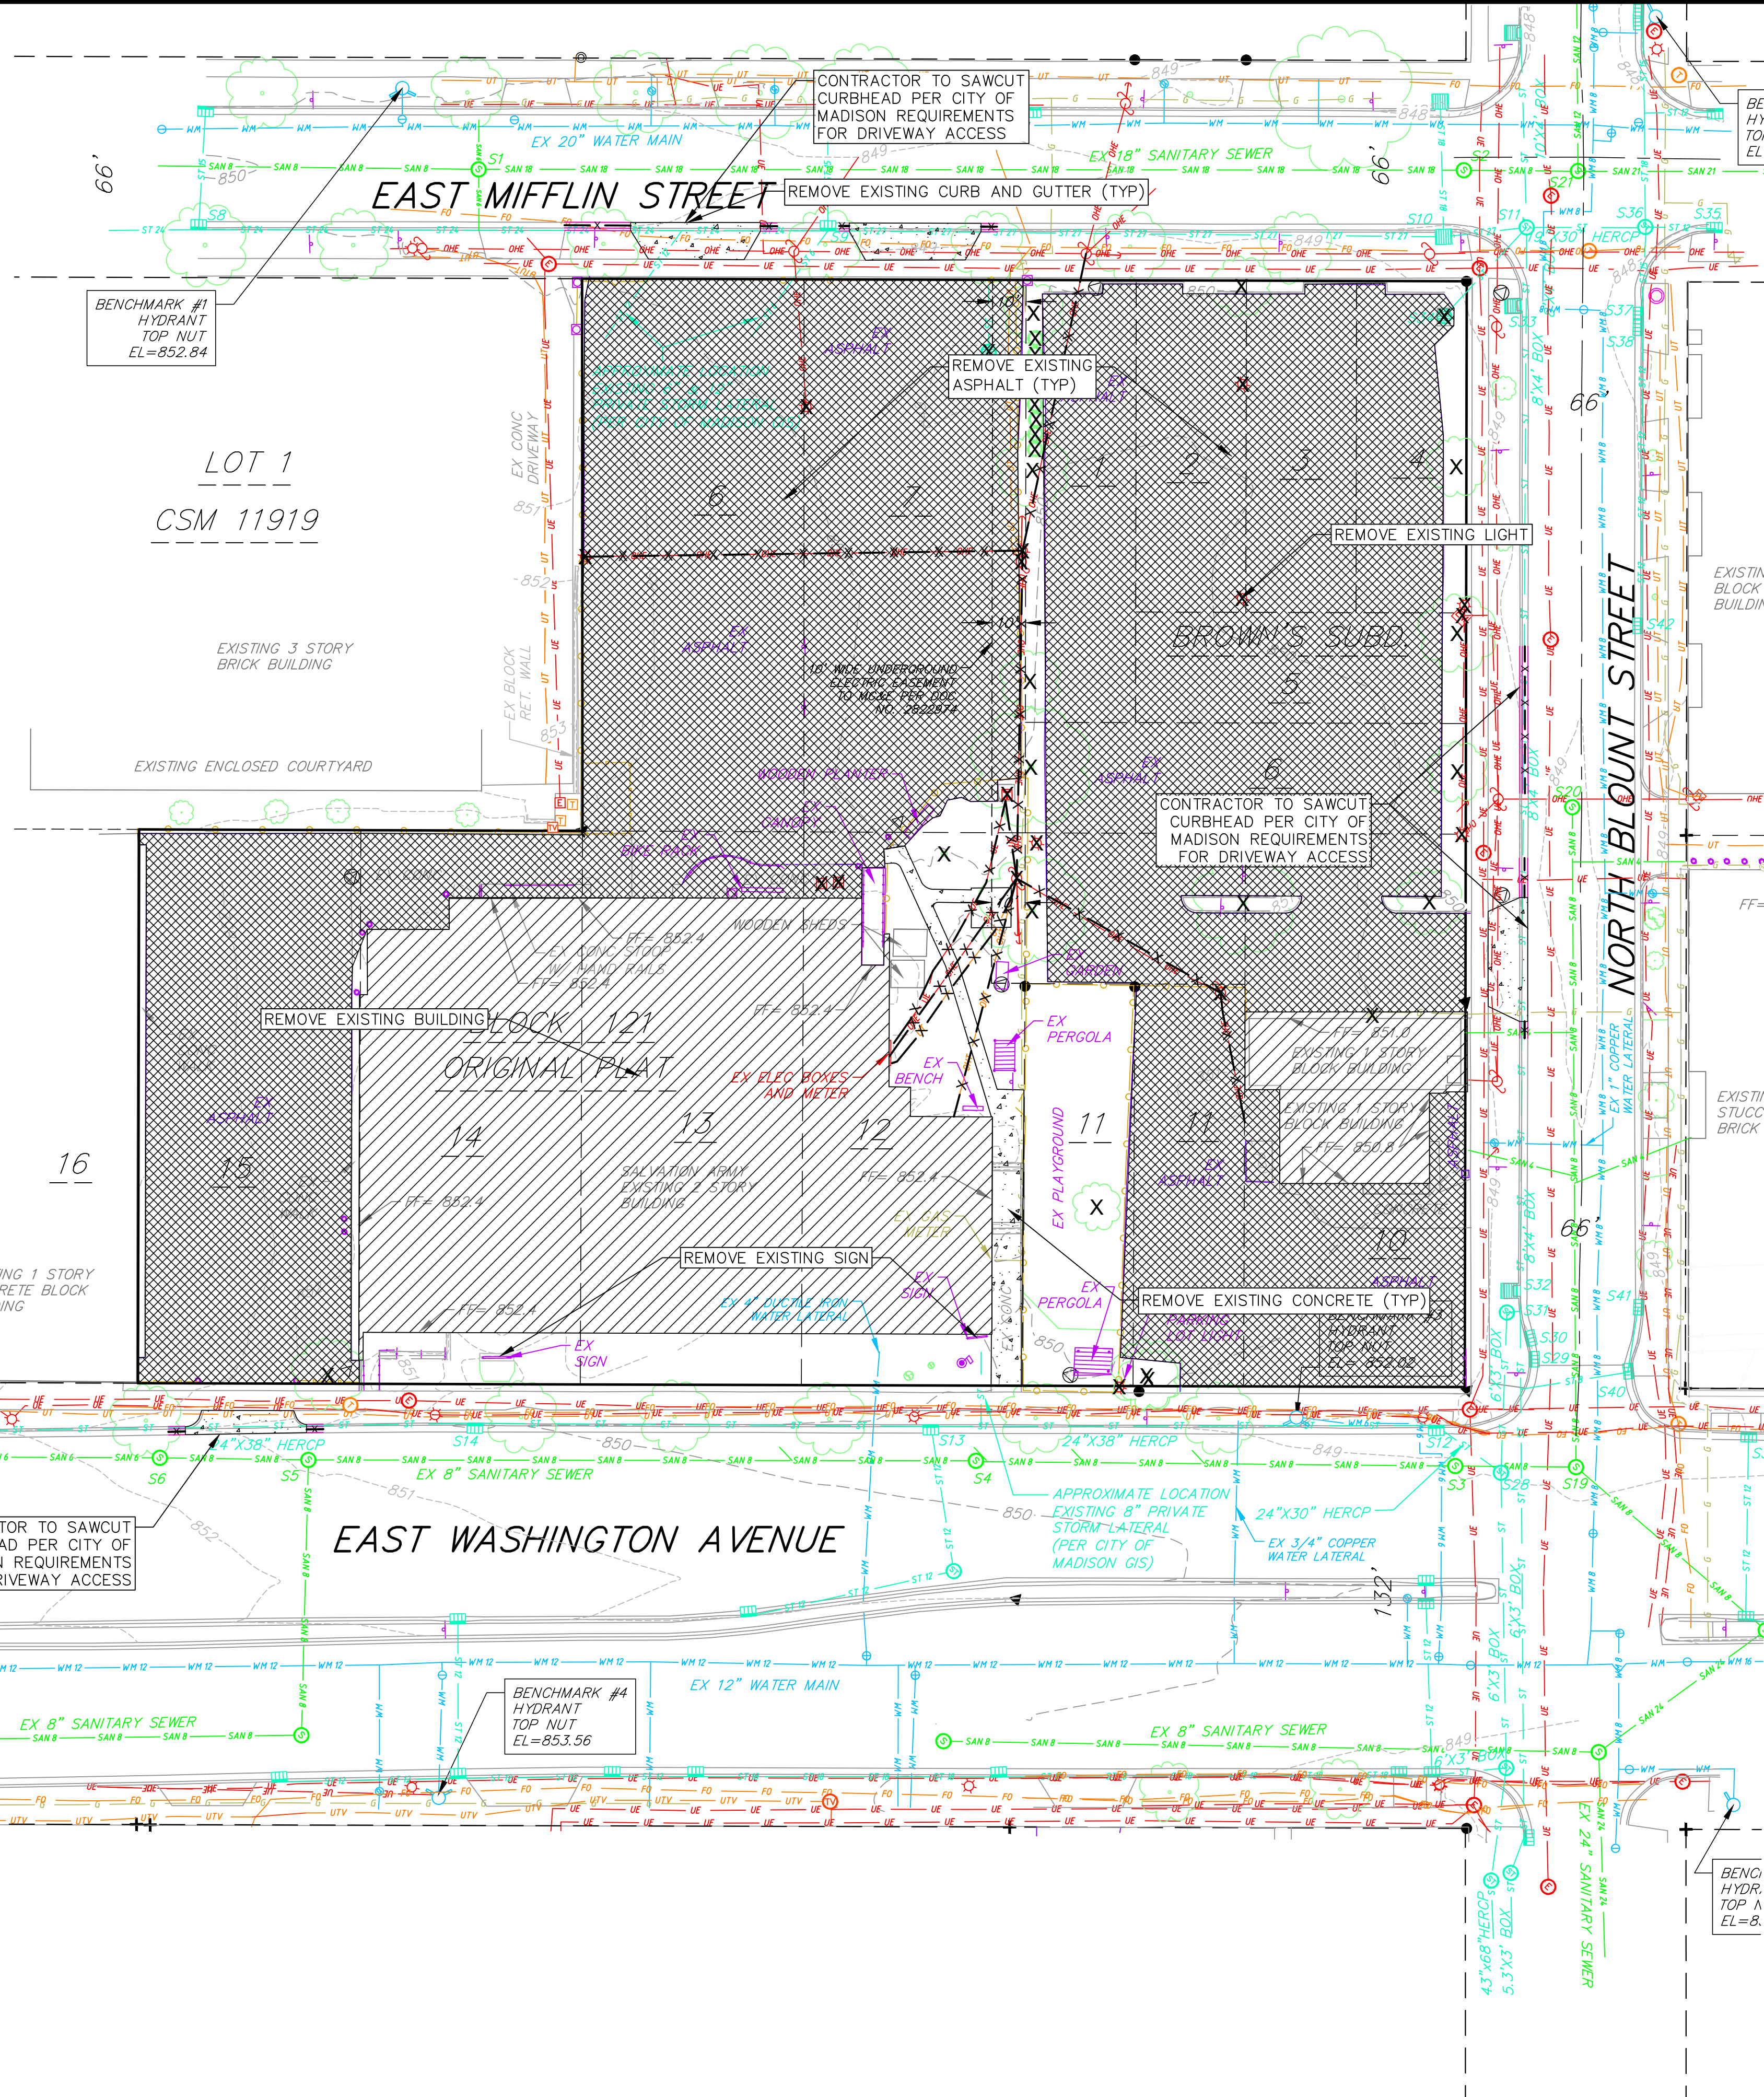

**DEMOLITION PLAN LEGEND**

- X-X-X-X CURB AND GUTTER REMOVAL
- ASPHALT REMOVAL
- CONCRETE REMOVAL
- BUILDING REMOVAL
- X TREE REMOVAL
- - - SAWCUT
- X UTILITY STRUCTURE REMOVAL
- - - UTILITY LINE REMOVAL

- GENERAL DEMOLITION NOTES:**
- CONTRACTOR SHALL KEEP ALL CITY STREETS FREE AND CLEAR OF CONSTRUCTION RELATED DIRT/DUST/DEBRIS.
  - COORDINATE EXISTING UTILITY REMOVAL/ABANDONMENT WITH LOCAL AUTHORITIES AND UTILITY COMPANIES HAVING JURISDICTION.
  - ALL SAWCUTTING SHALL BE FULL DEPTH TO PROVIDE A CLEAN EDGE TO MATCH NEW CONSTRUCTION. MATCH EXISTING ELEVATIONS AT POINTS OF CONNECTION FOR NEW AND EXISTING PAVEMENT, CURB, SIDEWALKS, ETC. ALL SAWCUT LOCATIONS SHOWN ARE APPROXIMATE AND MAY BE FIELD ADJUSTED TO ACCOMMODATE CONDITIONS, JOINTS, MATERIAL TYPE, ETC. REMOVE MINIMUM AMOUNT NECESSARY FOR INSTALLATION OF PROPOSED IMPROVEMENTS.
  - CONTRACTOR SHALL PROVIDE AND SHALL BE RESPONSIBLE FOR ANY NECESSARY TRAFFIC CONTROL SIGNAGE AND SAFETY MEASURES DURING DEMOLITION AND CONSTRUCTION OPERATIONS WITHIN OR NEAR THE PUBLIC ROADWAY.
  - THE RIGHT-OF-WAY IS THE SOLE JURISDICTION OF THE CITY OF MADISON AND IS SUBJECT TO CHANGE AT ANY TIME PER THE RECOMMENDATION/PLAN OF TRAFFIC ENGINEERING AND CITY ENGINEERING DEPARTMENTS.
  - CONTRACTOR SHALL OBTAIN ANY NECESSARY DEMOLITION AND UTILITY ABANDONMENT/PLUGGING PERMITS FROM THE LOCAL MUNICIPALITY/UTILITY AGENCY.
  - ANY DAMAGE TO THE CITY PAVEMENT, INCLUDING DAMAGE RESULTING FROM CURB REPLACEMENT, WILL REQUIRE RESTORATION IN ACCORDANCE WITH THE CITY ENGINEERING PATCHING CRITERIA.
  - ALL WORK IN THE RIGHT-OF-WAY SHALL BE CONSTRUCTED IN ACCORDANCE WITH CITY OF MADISON ISSUED PLANS.

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REVISIONS	NO.	DATE	REMARKS

SCALE AS SHOWN

DATE: 3/2/2022



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PROJECT NO.: 160245

SHEET: 2 OF 5

DWG. NO.: C2.1



- SITE PLAN LEGEND**
- PROPERTY BOUNDARY
  - CURB AND GUTTER (REVERSE CURB HATCHED)
  - PROPOSED CHAIN LINK FENCE
  - PROPOSED WOOD FENCE
  - PROPOSED CONCRETE
  - PROPOSED LIGHT-DUTY ASPHALT
  - PROPOSED PERVIOUS PAVEMENT
  - PROPOSED SIGN
  - PROPOSED LIGHT POLE
  - PROPOSED BOLLARD
  - PROPOSED ADA DETECTABLE WARNING FIELD
  - PROPOSED HANDICAP PARKING
  - HANDICAP ACCESS ROUTE
- ABBREVIATIONS**
- TC - TOP OF CURB
  - FF - FINISHED FLOOR
  - FL - FLOW LINE
  - SW - TOP OF WALK
  - TW - TOP OF WALL
  - BW - BOTTOM OF WALL

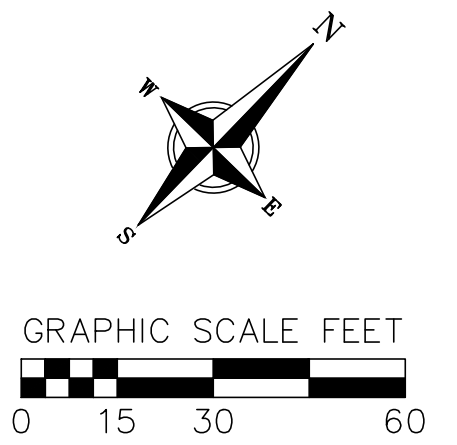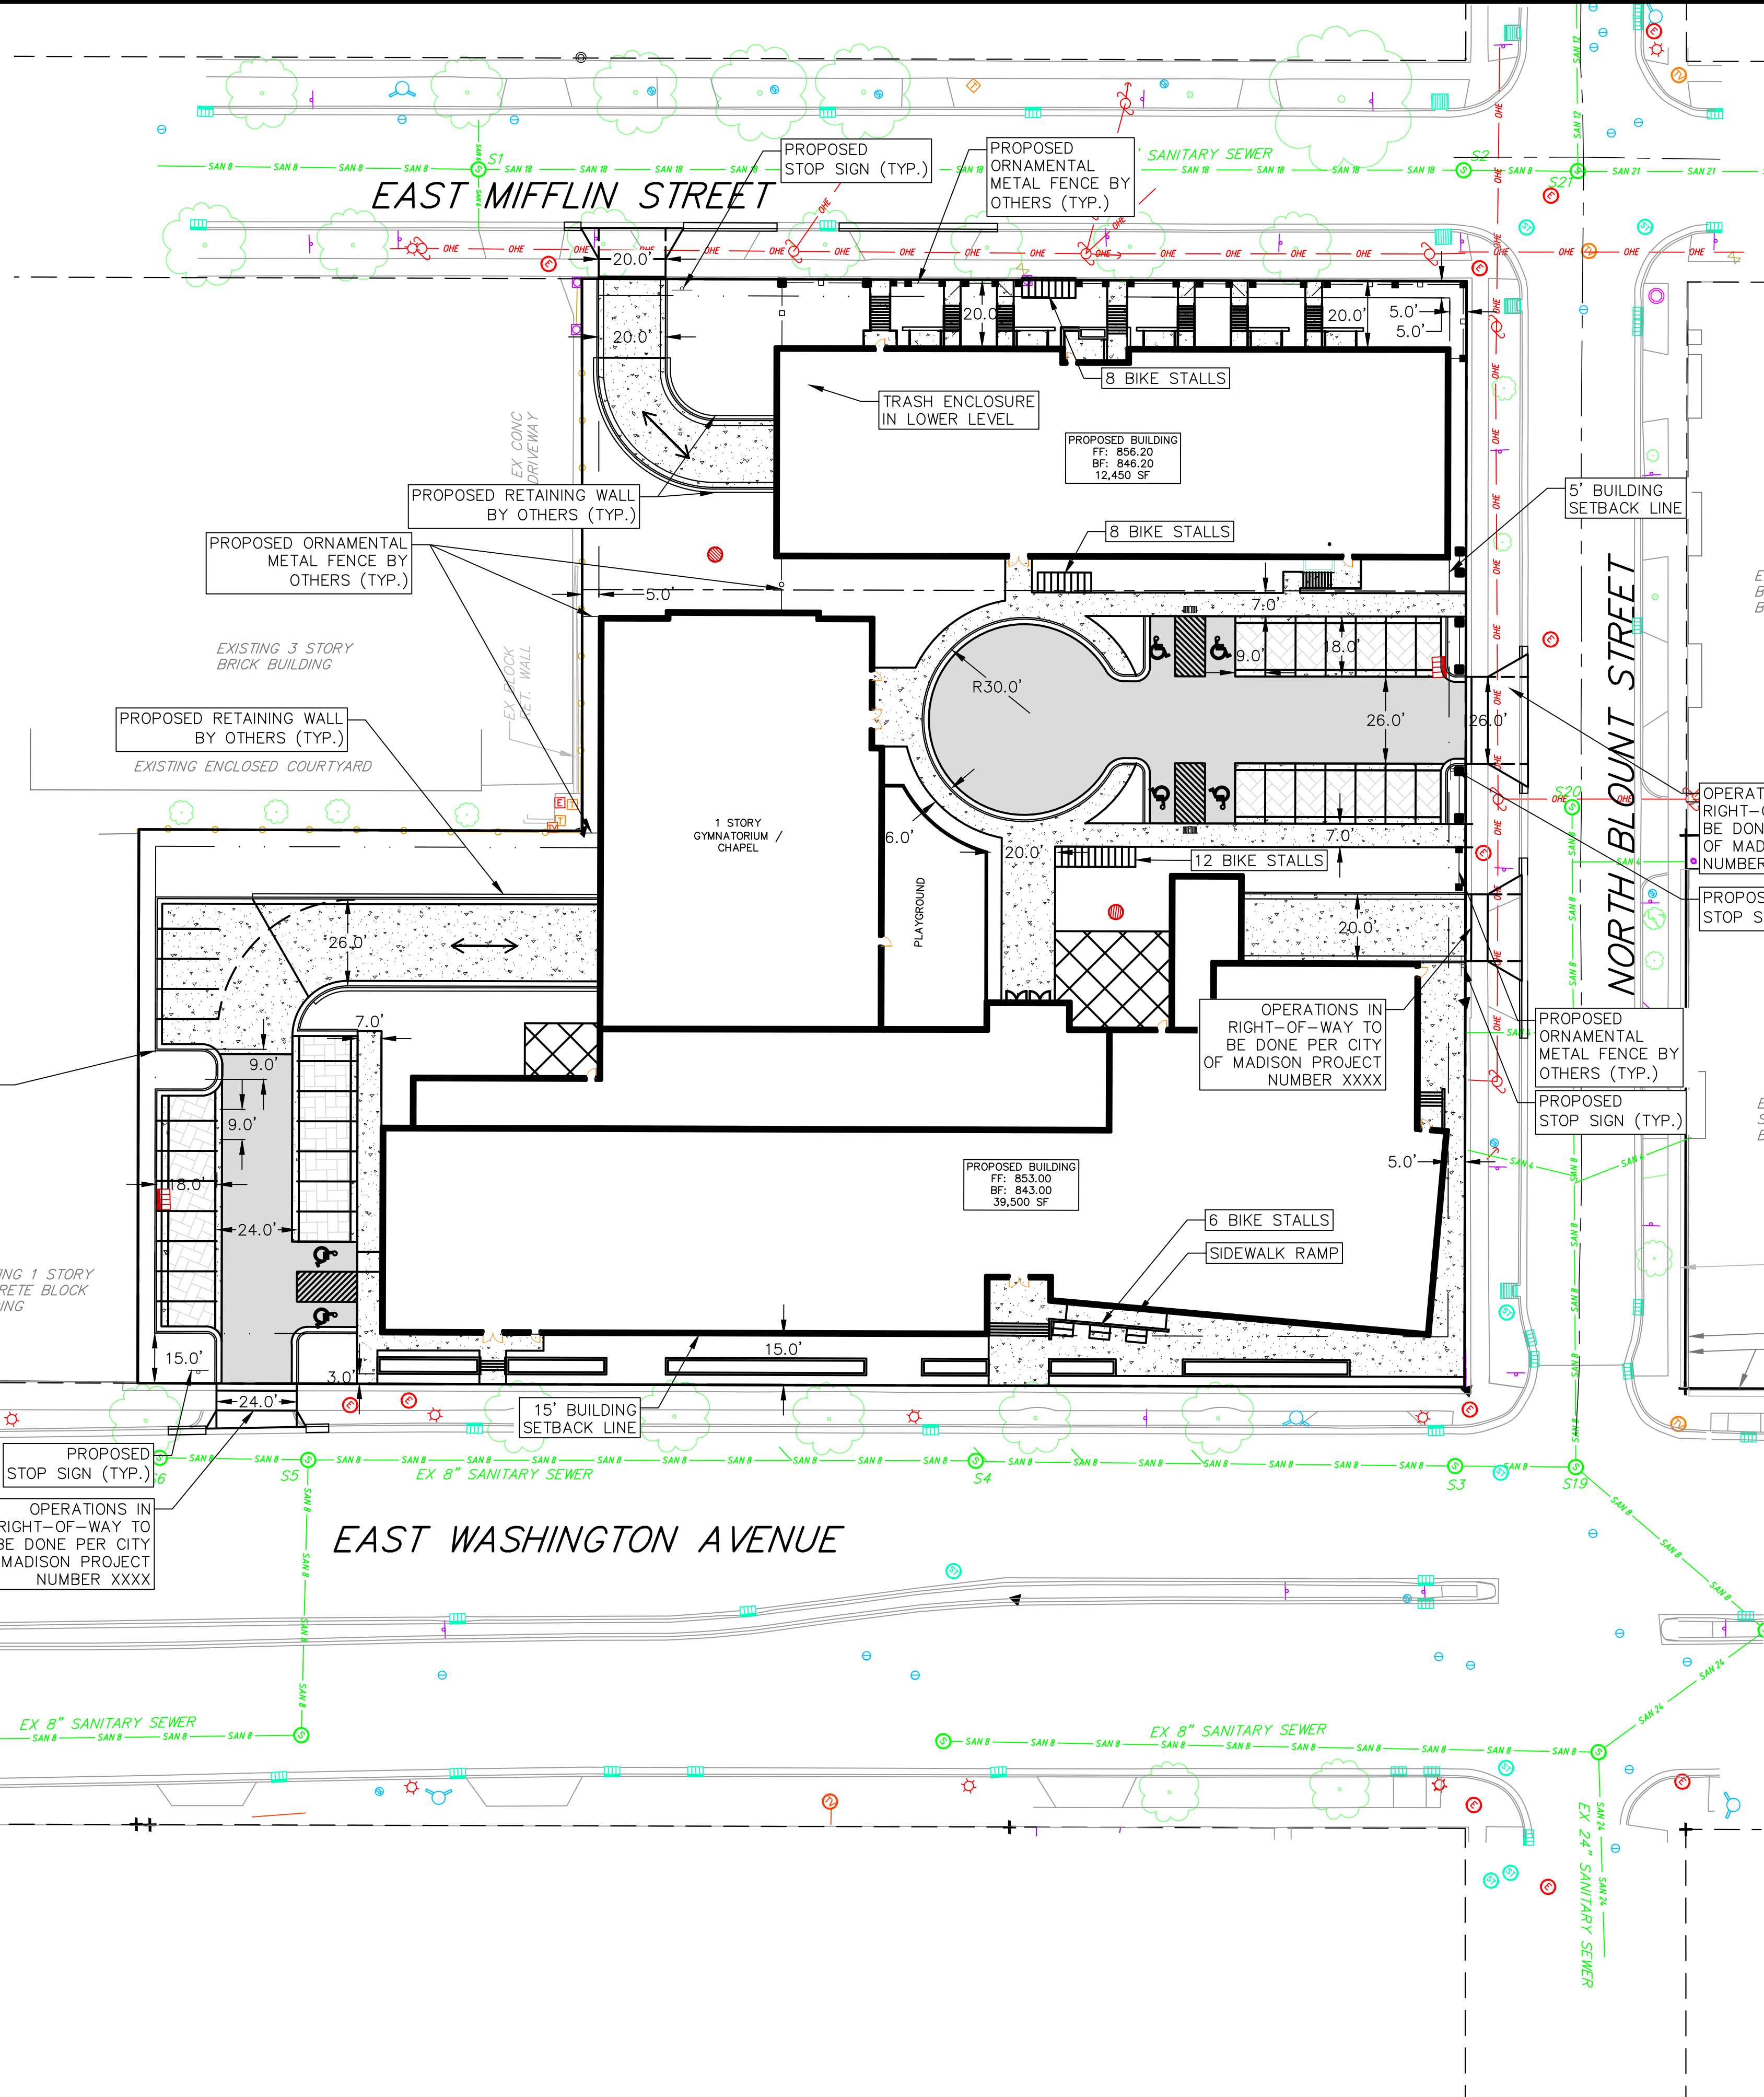- SITE CONSTRUCTION NOTES:**
- CONTRACTOR TO OBTAIN ANY NECESSARY UTILITY CONNECTION, DEMOLITION, OR RIGHT-OF-WAY PERMITS.
  - CONTRACTOR SHALL OBTAIN ANY NECESSARY DRIVEWAY CONNECTION, WORK IN RIGHT-OF-WAY AND EXCAVATION PERMITS PRIOR TO CONSTRUCTION.
  - ANY SIDEWALK AND CURB & GUTTER ABUTTING THE PROPERTY SHALL BE REPLACED IF IT IS DAMAGED DURING CONSTRUCTION OR IF THE CITY ENGINEERING DEPARTMENT DETERMINES THAT IT IS NOT AT A DESIRABLE GRADE, REGARDLESS OF WHETHER THE CONDITION EXISTED PRIOR TO BEGINNING CONSTRUCTION.
  - ALL WORK IN THE PUBLIC RIGHT-OF-WAY SHALL BE PERFORMED BY A CITY-LICENSED CONTRACTOR.
  - CROSS ACCESS EASEMENTS/AGREEMENTS SHALL BE PROVIDED FOR SHARED DRIVE AISLES BETWEEN PROPERTIES.

**Site Plan**  
622 and 630 East Washington  
City of Madison  
Dane County, Wisconsin

REVISIONS	NO.	DATE	REMARKS

SCALE AS SHOWN

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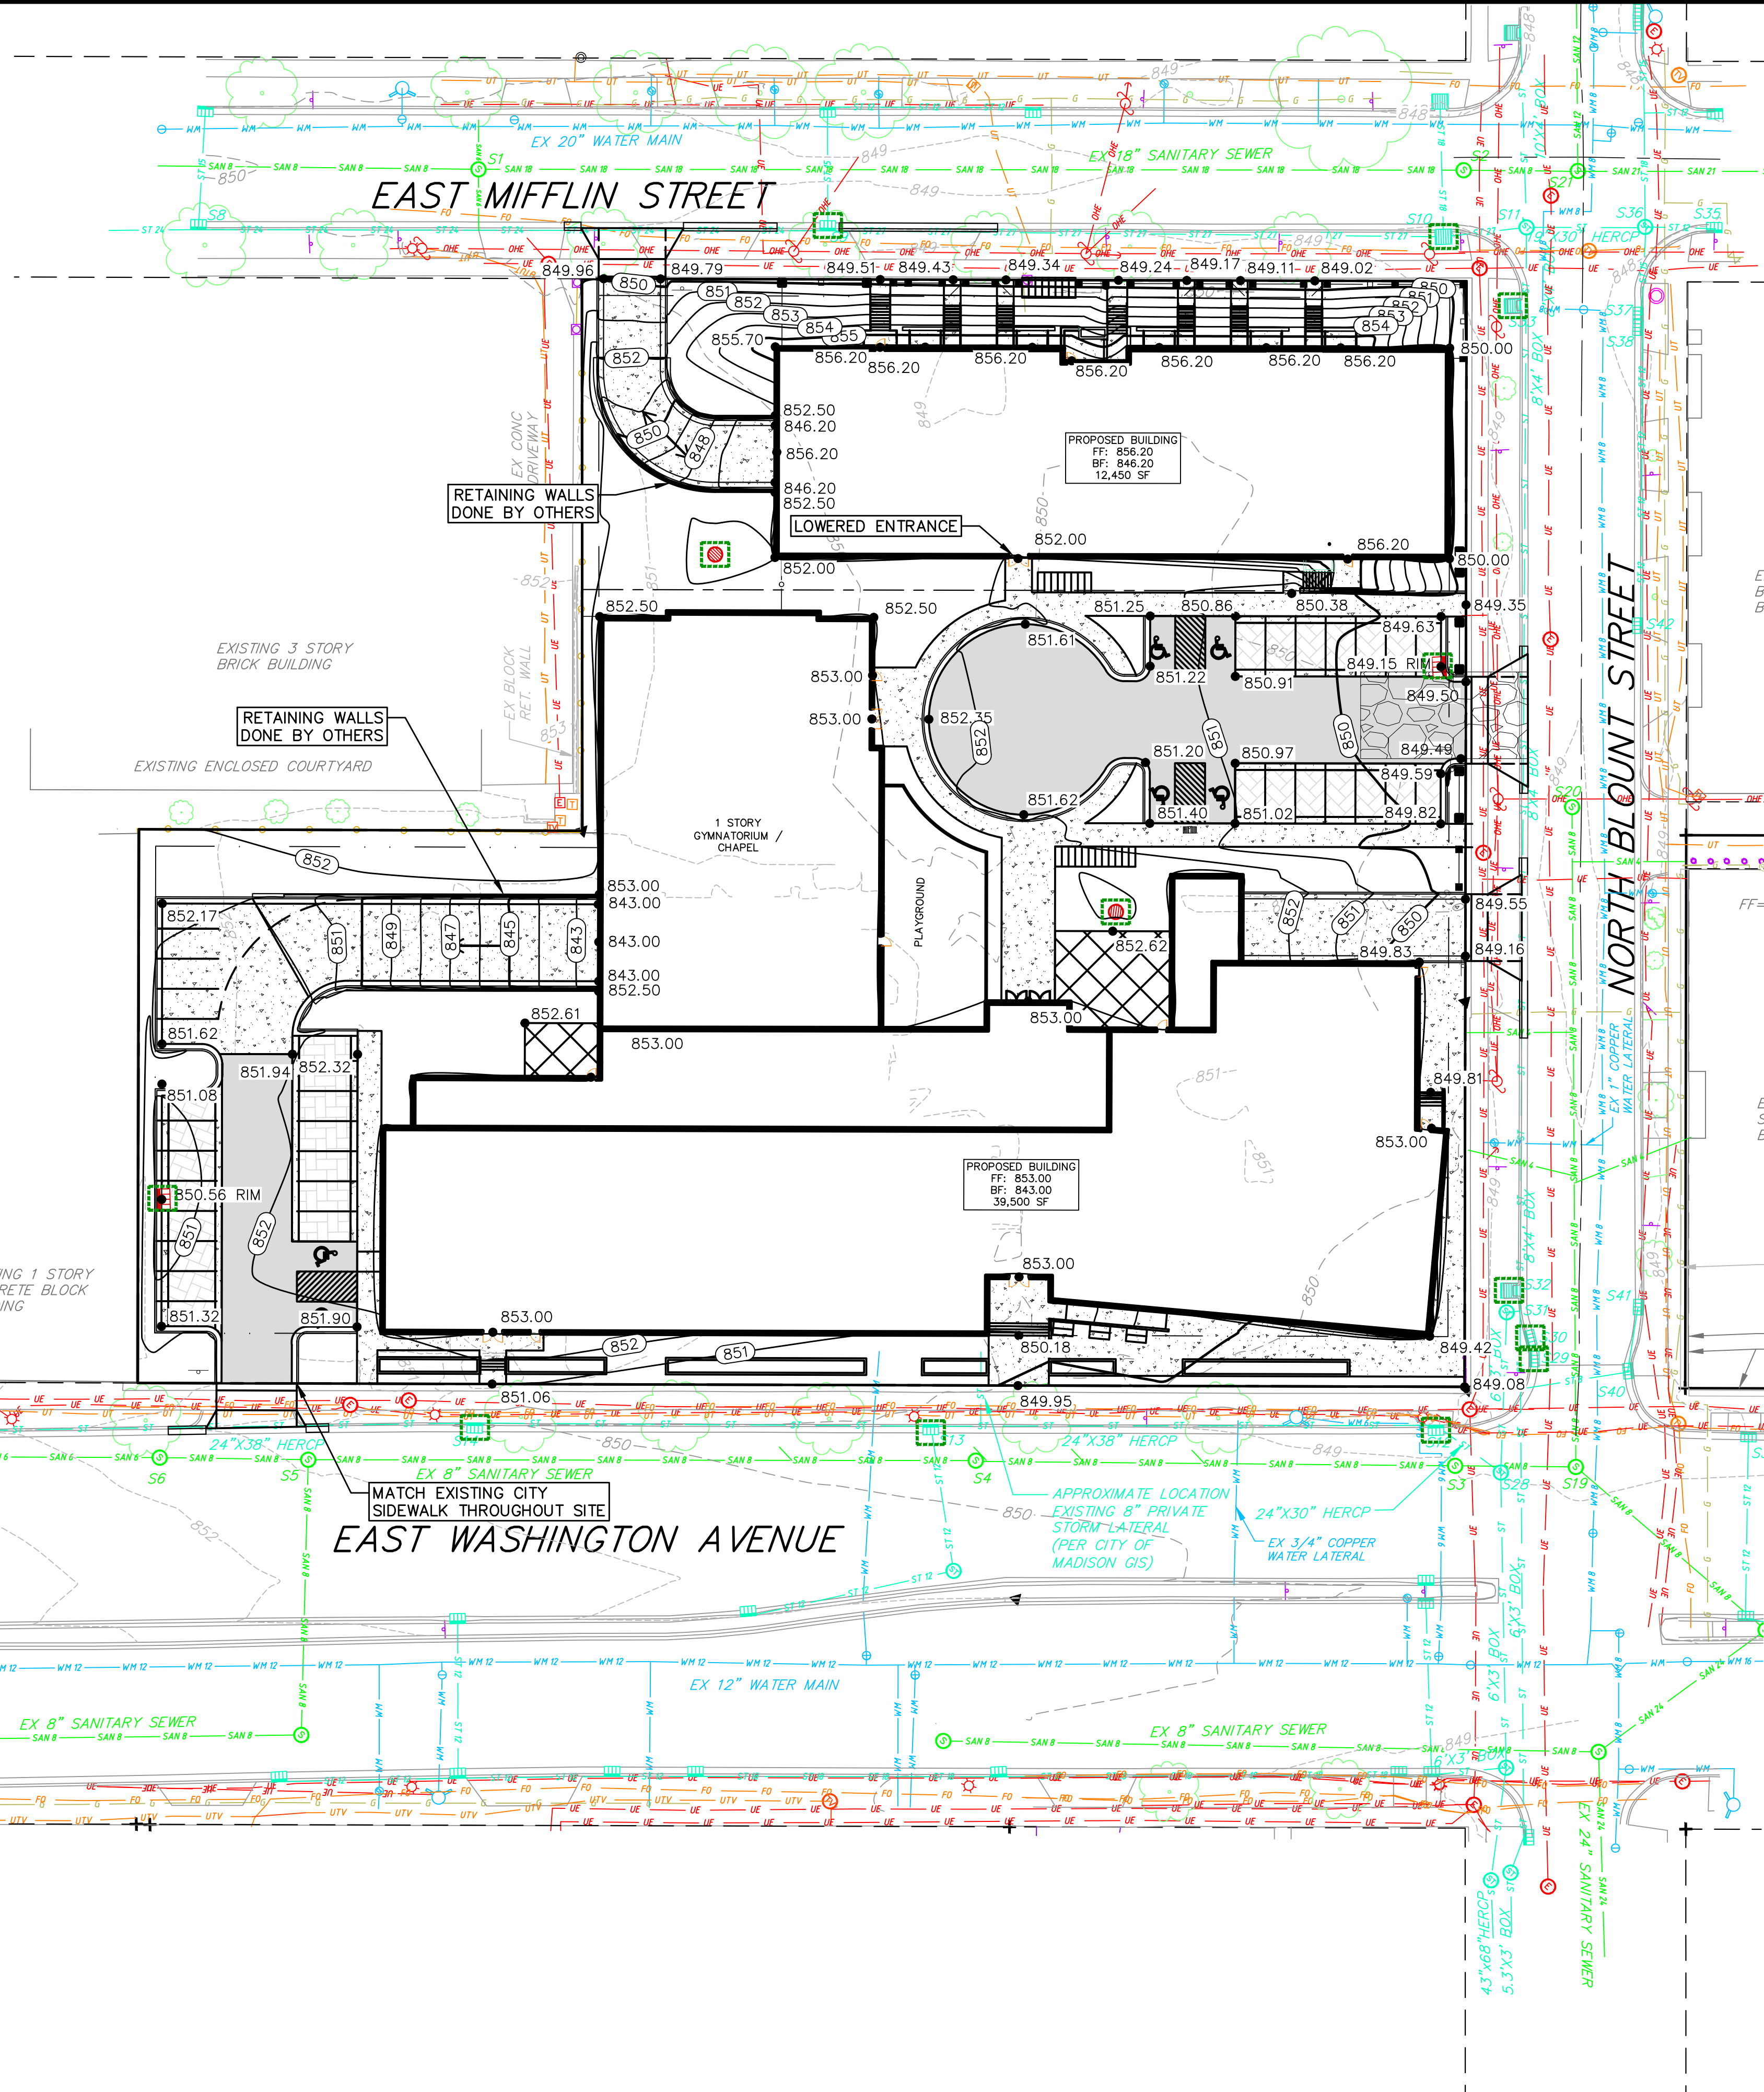
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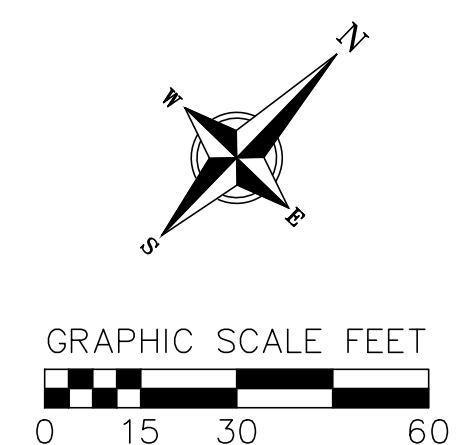
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DWG. NO.: C2.2



**ABBREVIATIONS**

TC	- TOP OF CURB
FF	- FINISHED FLOOR
FL	- FLOW LINE
SW	- TOP OF WALK
T/W	- TOP OF WALL
B/W	- BOTTOM OF WALL



**GRADING LEGEND**

---	820	EXISTING MAJOR CONTOURS
---	818	EXISTING MINOR CONTOURS
---	820	PROPOSED MAJOR CONTOURS
---	818	PROPOSED MINOR CONTOURS
---		SILT FENCE
---		DRAINAGE DIRECTION
---	2.92%	PROPOSED SLOPE ARROWS
---	1048.61	EXISTING SPOT ELEVATIONS
---	1048.61	PROPOSED SPOT ELEVATIONS
---		RIDGE LINE
---		INLET PROTECTION
---		EROSION MAT CLASS I TYPE A
---		EROSION MAT CLASS II TYPE B
---		TRACKING PAD
---		DISTURBED LIMITS

- GENERAL NOTES:**
- CONTRACTOR SHALL KEEP ALL CITY STREETS FREE AND CLEAR OF CONSTRUCTION RELATED DIRT/DUST/DEBRIS.
  - COORDINATE EXISTING UTILITY REMOVAL/ABANDONMENT WITH LOCAL AUTHORITIES AND UTILITY COMPANIES HAVING JURISDICTION.
  - CONTRACTOR SHALL PROVIDE AND SHALL BE RESPONSIBLE FOR ANY NECESSARY TRAFFIC CONTROL SIGNAGE AND SAFETY MEASURES DURING DEMOLITION AND CONSTRUCTION OPERATIONS WITHIN OR NEAR THE PUBLIC ROADWAY.
  - PROVIDE TREE PROTECTION FENCING PRIOR TO CONSTRUCTION OPERATIONS. MAINTAIN THROUGHOUT CONSTRUCTION.
  - THE LOCATION OF EXISTING UNDERGROUND UTILITIES AS SHOWN ON THE PLANS HAS BEEN DETERMINED FROM THE BEST AVAILABLE INFORMATION AND IS GIVEN FOR THE CONVENIENCE OF THE CONTRACTOR. THE OWNER AND THE ENGINEER DO NOT ASSUME RESPONSIBILITY IN THE EVENT THAT DURING CONSTRUCTION, UTILITIES OTHER THAN THOSE SHOWN MAY BE ENCOUNTERED, AND THAT THE ACTUAL LOCATION OF THOSE WHICH ARE SHOWN MAY BE DIFFERENT FROM THE LOCATION AS SHOWN ON THE PLANS.
  - ANY DAMAGE TO THE CITY PAVEMENT, INCLUDING DAMAGE RESULTING FROM CURB REPLACEMENT, WILL REQUIRE RESTORATION IN ACCORDANCE WITH THE CITY ENGINEERING PATCHING CRITERIA.
  - CROSS-SLOPE OF SIDEWALKS SHALL BE 1.5% UNLESS OTHERWISE NOTED.
  - LONGITUDINAL GRADE OF SIDEWALK RAMP SHALL NOT EXCEED 8.33 (1:12) AND SHALL BE IN ACCORDANCE WITH ADA REQUIREMENTS.
  - LONGITUDINAL GRADE OF SIDEWALK SHALL NOT EXCEED 5.0% OR THE ADJACENT STREET GRADE WHICHEVER IS GREATER.
  - ACCESSIBLE ROUTES SHALL BE 5% MAX LONGITUDINAL SLOPE AND 2% MAX CROSS SLOPE. ACCESSIBLE LOADING AREAS OR LANDINGS SHALL BE 2% MAX SLOPE IN ANY DIRECTION. RAMPS SHALL BE 8.33% MAX SLOPE.
  - ADJUST ALL EXISTING MANHOLE AND VALVE RIMS TO FINAL GRADE.

**vierbicher**  
planners | engineers | advisors  
Phone: (608) 261-3898

**Grading and Erosion Control Plan**  
622 and 630 East Washington  
City of Madison  
Dane County, Wisconsin

REVISIONS	NO.	DATE	REMARKS

SCALE AS SHOWN



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 PROJECT NO.: 160245  
 SHEET: 4 OF 5  
 DWG. NO.: C2.3

**PROPOSED UTILITY LEGEND**

- STORM SEWER PIPE
- ⊕ STORM SEWER MANHOLE
- ⊕ STORM SEWER ENDWALL
- ⊕ STORM SEWER CURB INLET
- ⊕ STORM SEWER CURB INLET W/MANHOLE
- ⊕ STORM SEWER FIELD INLET
- SANITARY SEWER LATERAL PIPE
- ⊕ SANITARY SEWER MANHOLE
- ⊕ SANITARY SEWER CLEANOUT
- ⊕ WATER VALVE
- WATER SERVICE LATERAL PIPE

**ABBREVIATIONS**

- STMH - STORM MANHOLE
- FI - FIELD INLET
- CI - CURB INLET
- CB - CATCH BASIN
- EW - ENDWALL
- SMH - SANITARY MANHOLE

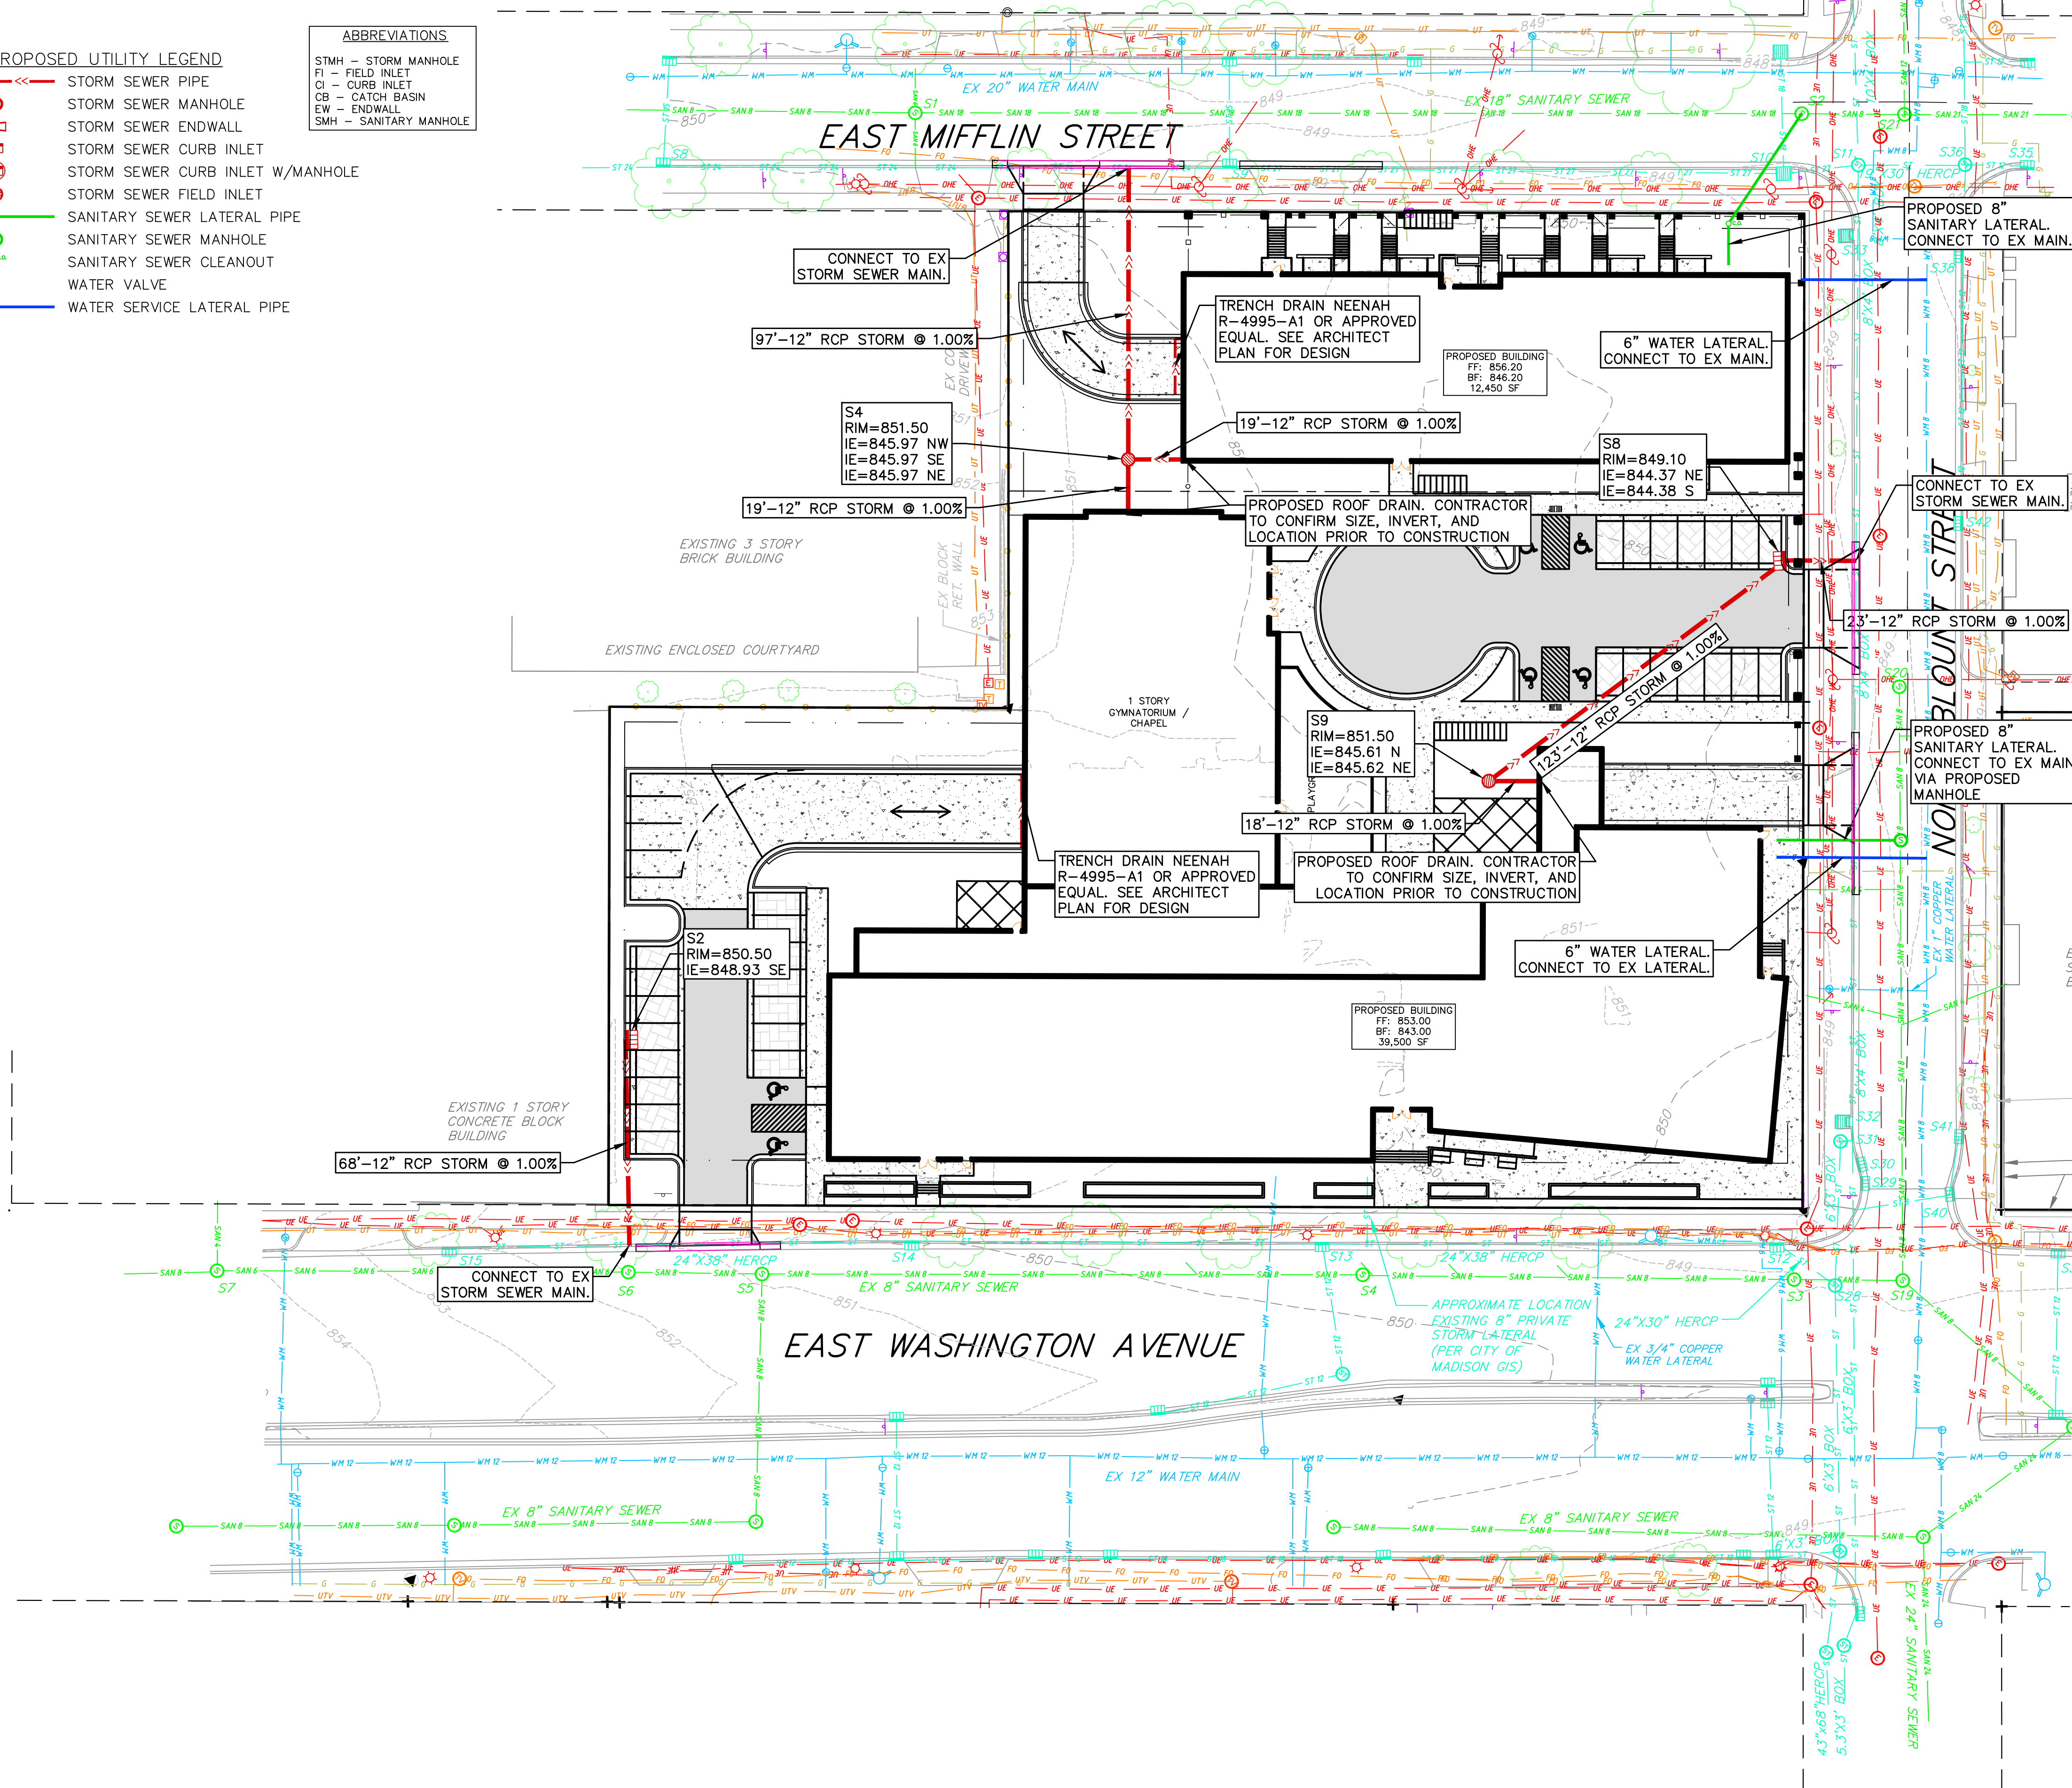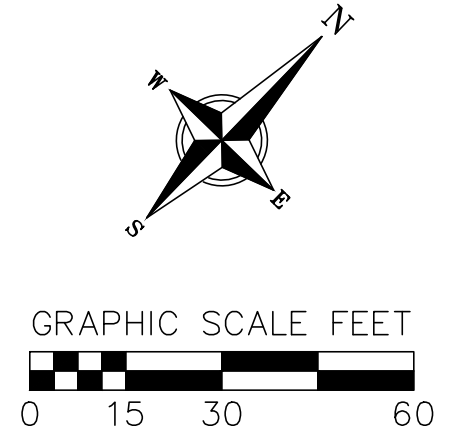

- UTILITY NOTES:**
- CONTRACTOR SHALL INVESTIGATE ALL UTILITY CROSSINGS PRIOR TO CONSTRUCTION AND NOTIFY ENGINEER OF ANY CONFLICTS.
  - CONTRACTOR SHALL BE RESPONSIBLE FOR ADJUSTING ALL UTILITY STRUCTURES (MANHOLE RIMS, WATER VALVES, AND CURB STOPS), IF NECESSARY.
  - CONTRACTOR SHALL OBTAIN ANY NECESSARY WORK IN RIGHT-OF WAY, EXCAVATION, UTILITY CONNECTION, PLUGGING, ABANDONMENT, AND DRIVEWAY CONNECTION PERMITS PRIOR TO CONSTRUCTION.
  - FOR ALL SEWER AND WATER MAIN CROSSINGS: PROVIDE MINIMUM 18" SEPARATION WHEN WATER MAIN CROSSES BELOW SEWER AND MINIMUM 6" SEPARATION WHEN WATER MAIN CROSSES ABOVE SEWER.
  - IF DEWATERING OPERATIONS EXCEED 70 GALLONS PER MINUTE OF PUMPING CAPACITY, A DEWATERING WELL PERMIT SHALL BE OBTAINED PRIOR TO STARTING ANY DEWATERING ACTIVITIES.
  - A COPY OF THE APPROVED UTILITY PLANS, SPECIFICATIONS AND PLUMBING PERMIT APPROVAL LETTER SHALL BE ON-SITE DURING CONSTRUCTION AND OPEN TO INSPECTION BY AUTHORIZED REPRESENTATIVES OF THE DEPARTMENT OF SAFETY AND PROFESSIONAL SERVICES AND OTHER LOCAL INSPECTORS.
  - STORM BUILDING SEWER PIPE SHALL CONFORM TO ONE OF THE STANDARDS LISTED IN TABLE 384.30-6 OF SPS 384.30(3)(c).
  - PRIVATE WATER SERVICES AND PRIVATE WATER MAINS SHALL CONFORM TO ONE OF THE STANDARDS LISTED IN TABLE 384.30-7 OF SPS 384.30(4)(d).
  - PRIVATE SANITARY SEWER AND LATERALS SHALL BE POLYVINYL CHLORIDE (PVC) ASTM D3034 - SDR 35 OR APPROVED EQUAL MATERIAL THAT CONFORMS TO ONE OF THE STANDARDS LISTED IN TABLE 384.30-3 OF SPS 384.30(2)(c).
  - A MEANS TO LOCATE BURIED UNDERGROUND EXTERIOR NON METALLIC SEWERS/MAINS AND WATER SERVICES/MAINS MUST BE PROVIDED WITH TRACER WIRE OR OTHER METHODS IN ORDER TO BE LOCATED PER SPS 382.10(11)(h) AND SPS 382.40(8)(k).
  - EXTERIOR WATER SUPPLY PIPING SETBACKS AND CROSSINGS SHALL BE IN ACCORDANCE WITH SPS 382.40(8)(b.).
  - NO PERSON MAY ENGAGE IN PLUMBING WORK IN THE STATE UNLESS LICENSED TO DO SO BY THE DEPARTMENT OF SAFETY AND PROFESSIONAL SERVICES PER S.145.06.
  - SITE CONTRACTOR SHALL LEAVE SANITARY AND WATER LATERALS FIVE (5) FEET SHORT (HORIZONTALLY) FROM THE BUILDING. BUILDING PLUMBER SHALL VERIFY SIZE, LOCATION, AND INVERT ELEVATION OF PROPOSED SANITARY AND WATER LATERALS.
  - CONTRACTOR SHALL FIELD VERIFY THE SIZE, TYPE, LOCATION, AND ELEVATION OF EXISTING UTILITIES PRIOR TO INSTALLING ANY ON-SITE UTILITIES OR STRUCTURES. CONTACT ENGINEER PRIOR TO INSTALLATION IF DISCREPANCY EXISTS WITHIN THESE PLANS.
  - PROPOSED UTILITY SERVICE LINES SHOWN ARE APPROXIMATE. COORDINATE THE EXACT LOCATIONS WITH THE PLUMBING DRAWINGS. COORDINATE THE LOCATIONS WITH THE PLUMBING CONTRACTOR AND/OR OWNER'S CONSTRUCTION REPRESENTATIVE PRIOR TO INSTALLATION OF ANY NEW UTILITIES.
  - ALL WATER MAIN AND SERVICES SHALL BE INSTALLED AT A MINIMUM DEPTH OF 6.5' FROM TOP OF FINISHED GROUND ELEVATION TO TOP OF MAIN.
  - IT IS THE CONTRACTOR'S RESPONSIBILITY TO VERIFY THAT THE EXISTING VALVES WILL HOLD THE PRESSURE TEST PRIOR TO CONNECTION. THE CITY IS NOT RESPONSIBLE FOR ANY COSTS INCURRED DUE TO THE CONTRACTOR NOT VERIFYING THAT THE EXISTING VALVE WILL HOLD THE PRESSURE TEST PRIOR TO CONNECTION. IF A NEW VALVE IS REQUIRED, THE APPLICANT WILL BE REQUIRED TO INSTALL ONE AT THEIR EXPENSE, AT THE POINT OF CONNECTION.
  - CLEAN OUT ALL EXISTING AND PROPOSED STORM INLETS AND CATCH BASINS AT THE COMPLETION OF CONSTRUCTION.
  - THE LOCATION OF EXISTING UTILITIES AS SHOWN ON THE PLANS HAS BEEN DETERMINED FROM THE BEST AVAILABLE INFORMATION AND IS GIVEN FOR THE CONVENIENCE OF THE CONTRACTOR. THE OWNER AND THE ENGINEER DO NOT ASSUME RESPONSIBILITY IN THE EVENT THAT DURING CONSTRUCTION, UTILITIES OTHER THAN THOSE SHOWN MAY BE ENCOUNTERED, AND THAT THE ACTUAL LOCATION OF THOSE WHICH ARE SHOWN MAY BE DIFFERENT FROM THE LOCATION AS SHOWN ON THE PLANS. CONTRACTOR SHALL BE RESPONSIBLE FOR CONTACTING DIGGERS HOTLINE AND LOCATING ALL EXISTING UTILITIES AND ENSURING PROPER CLEARANCE OF NEW UTILITIES.

**vierbicher** engineers | advisors  
Phone: (608) 261-3898



**Utility Plan**  
622 and 630 East Washington  
City of Madison  
Dane County, Wisconsin

REVISIONS	NO.	DATE	REMARKS

SCALE AS SHOWN

DATE: 3/2/2022  
DRAFTER: CKNA  
CHECKED: UKAS

PROJECT NO.: 160245  
SHEET: 5 OF 5  
DWG. NO.: C2.4

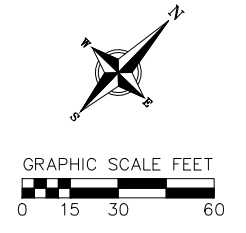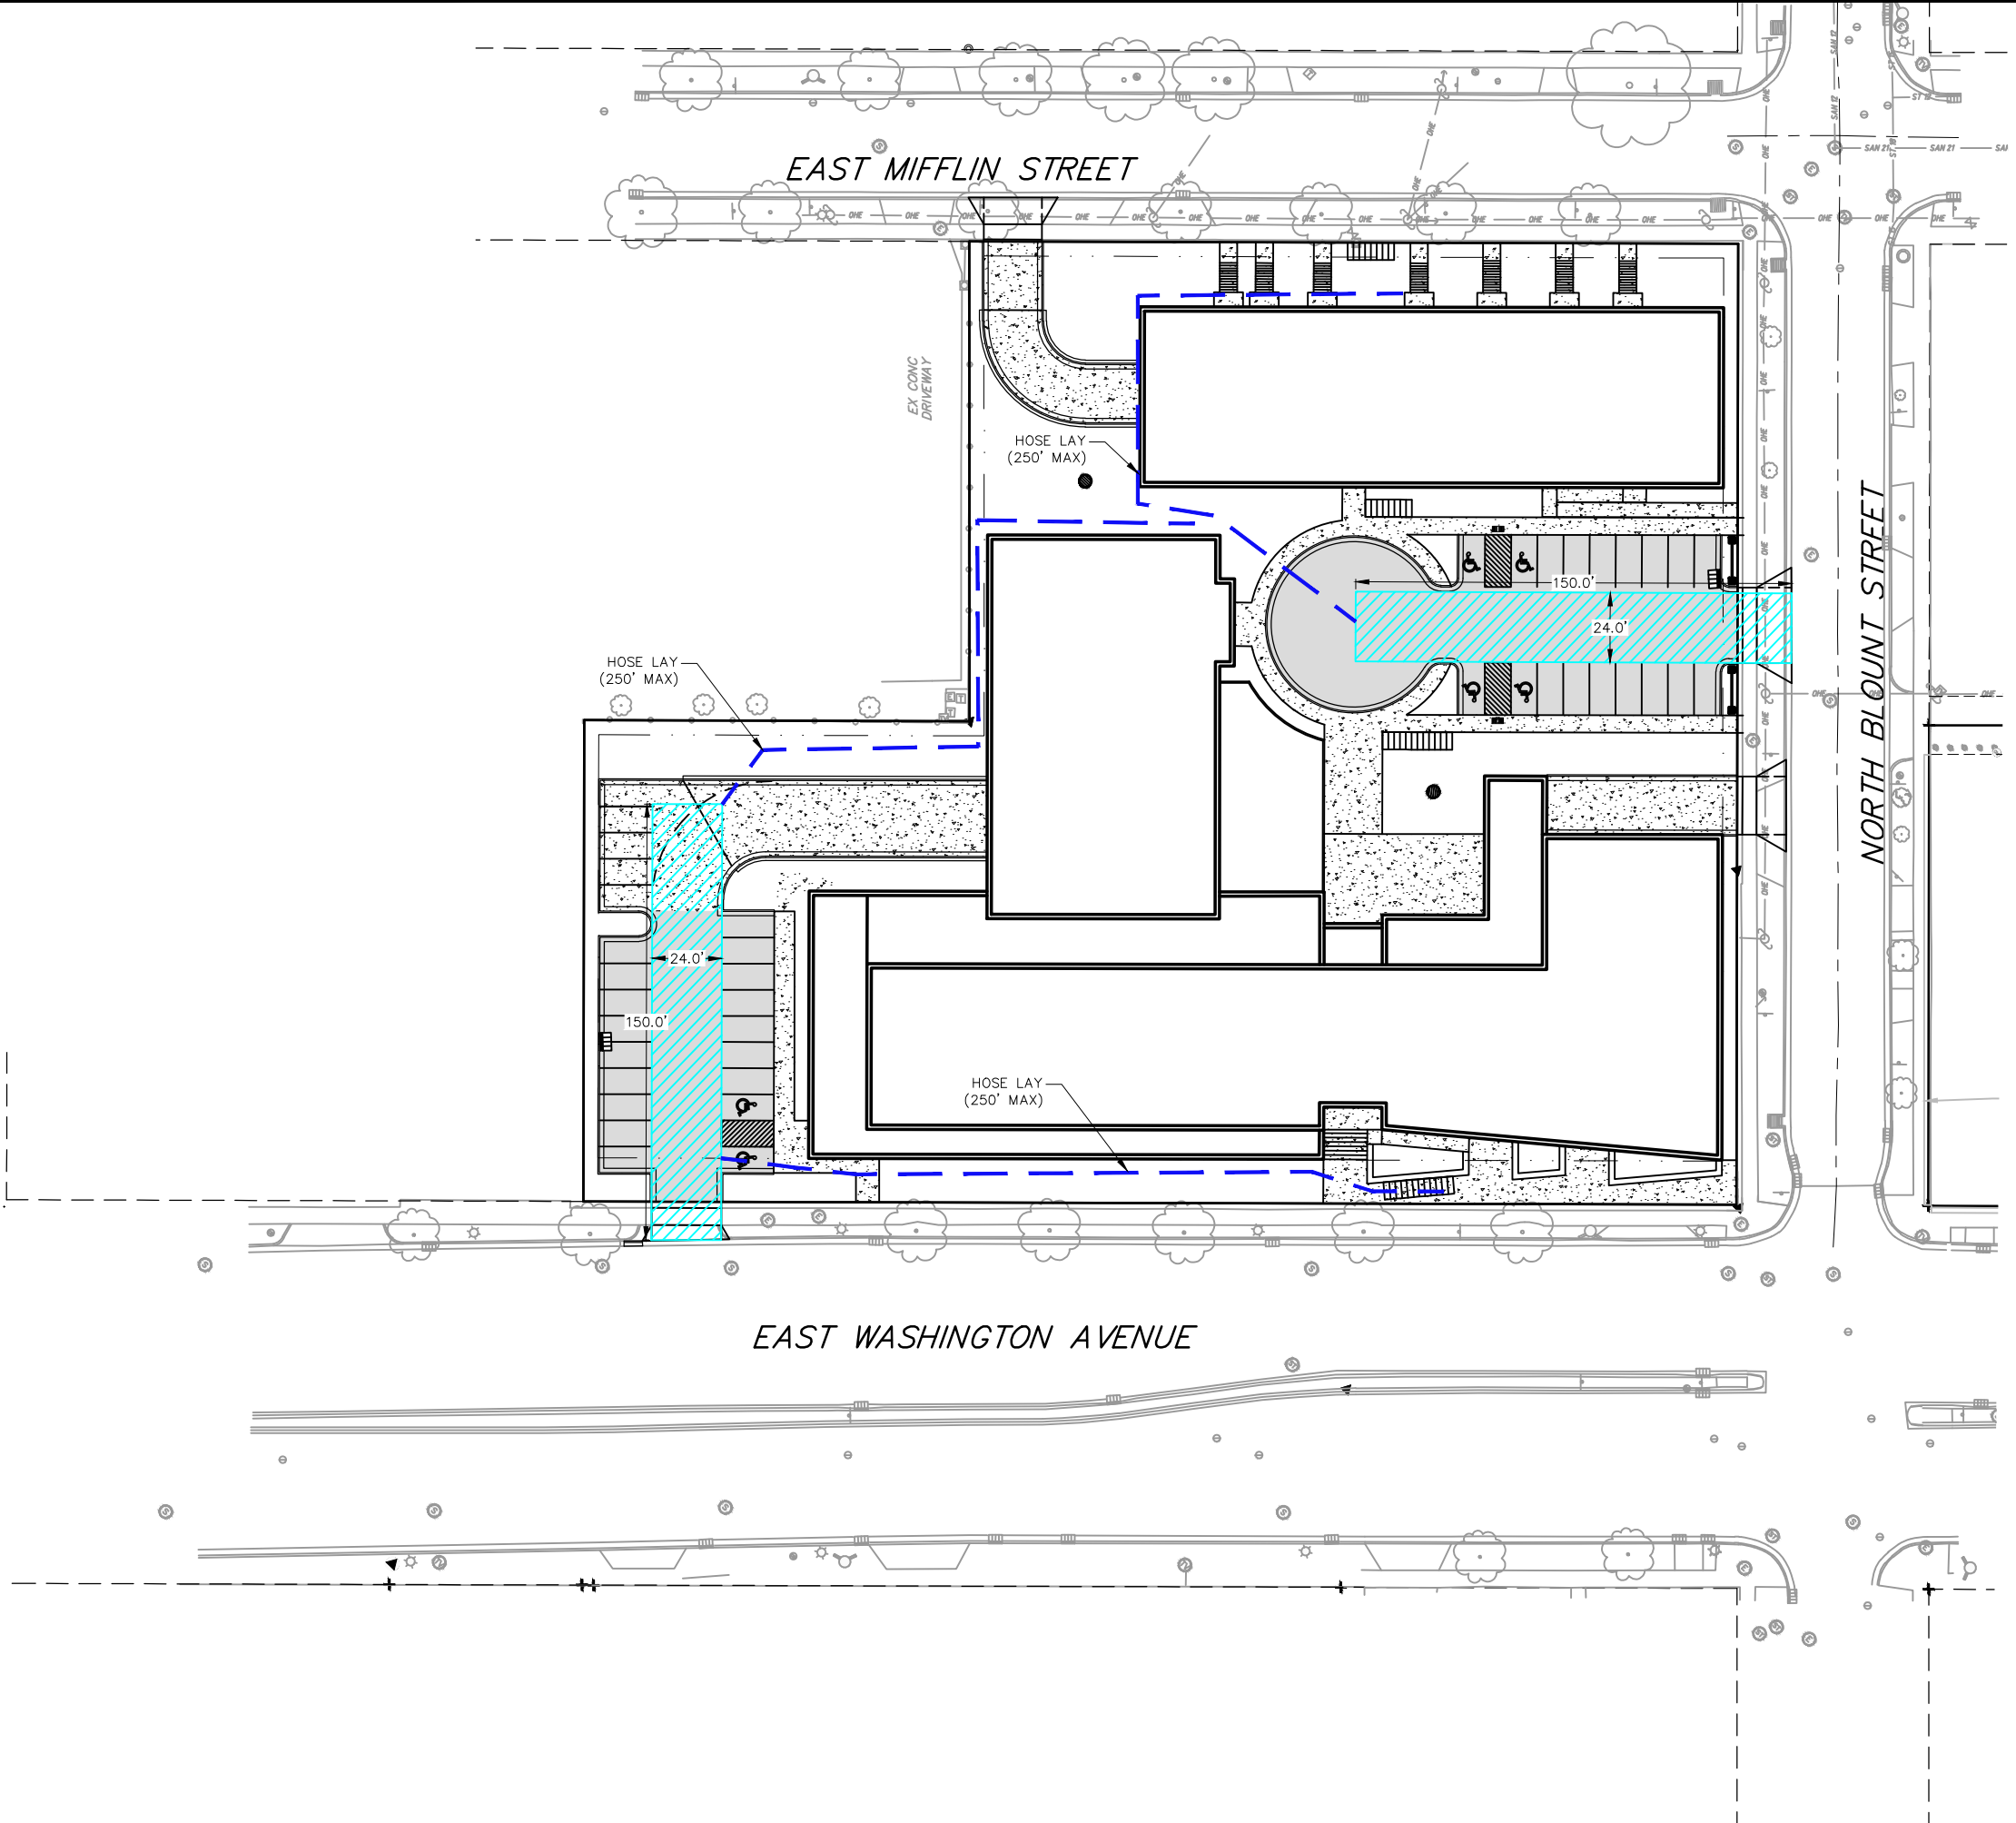

**FIRE ACCESS LEGEND**

HOSE LAY

FIRE ACCESS ZONE

**Fire Apparatus Exhibit**  
622 and 630 East Washington  
City of Madison  
Dane County, Wisconsin

NO.	DATE	REVISIONS	REMARKS

SCALE: AS SHOWN

DATE: 8/8/2019

DRAFTER: JMAH

CHECKED: JKAS

PROJECT NO.: 160245

SHEET: 1 OF 1

DWG. NO.:

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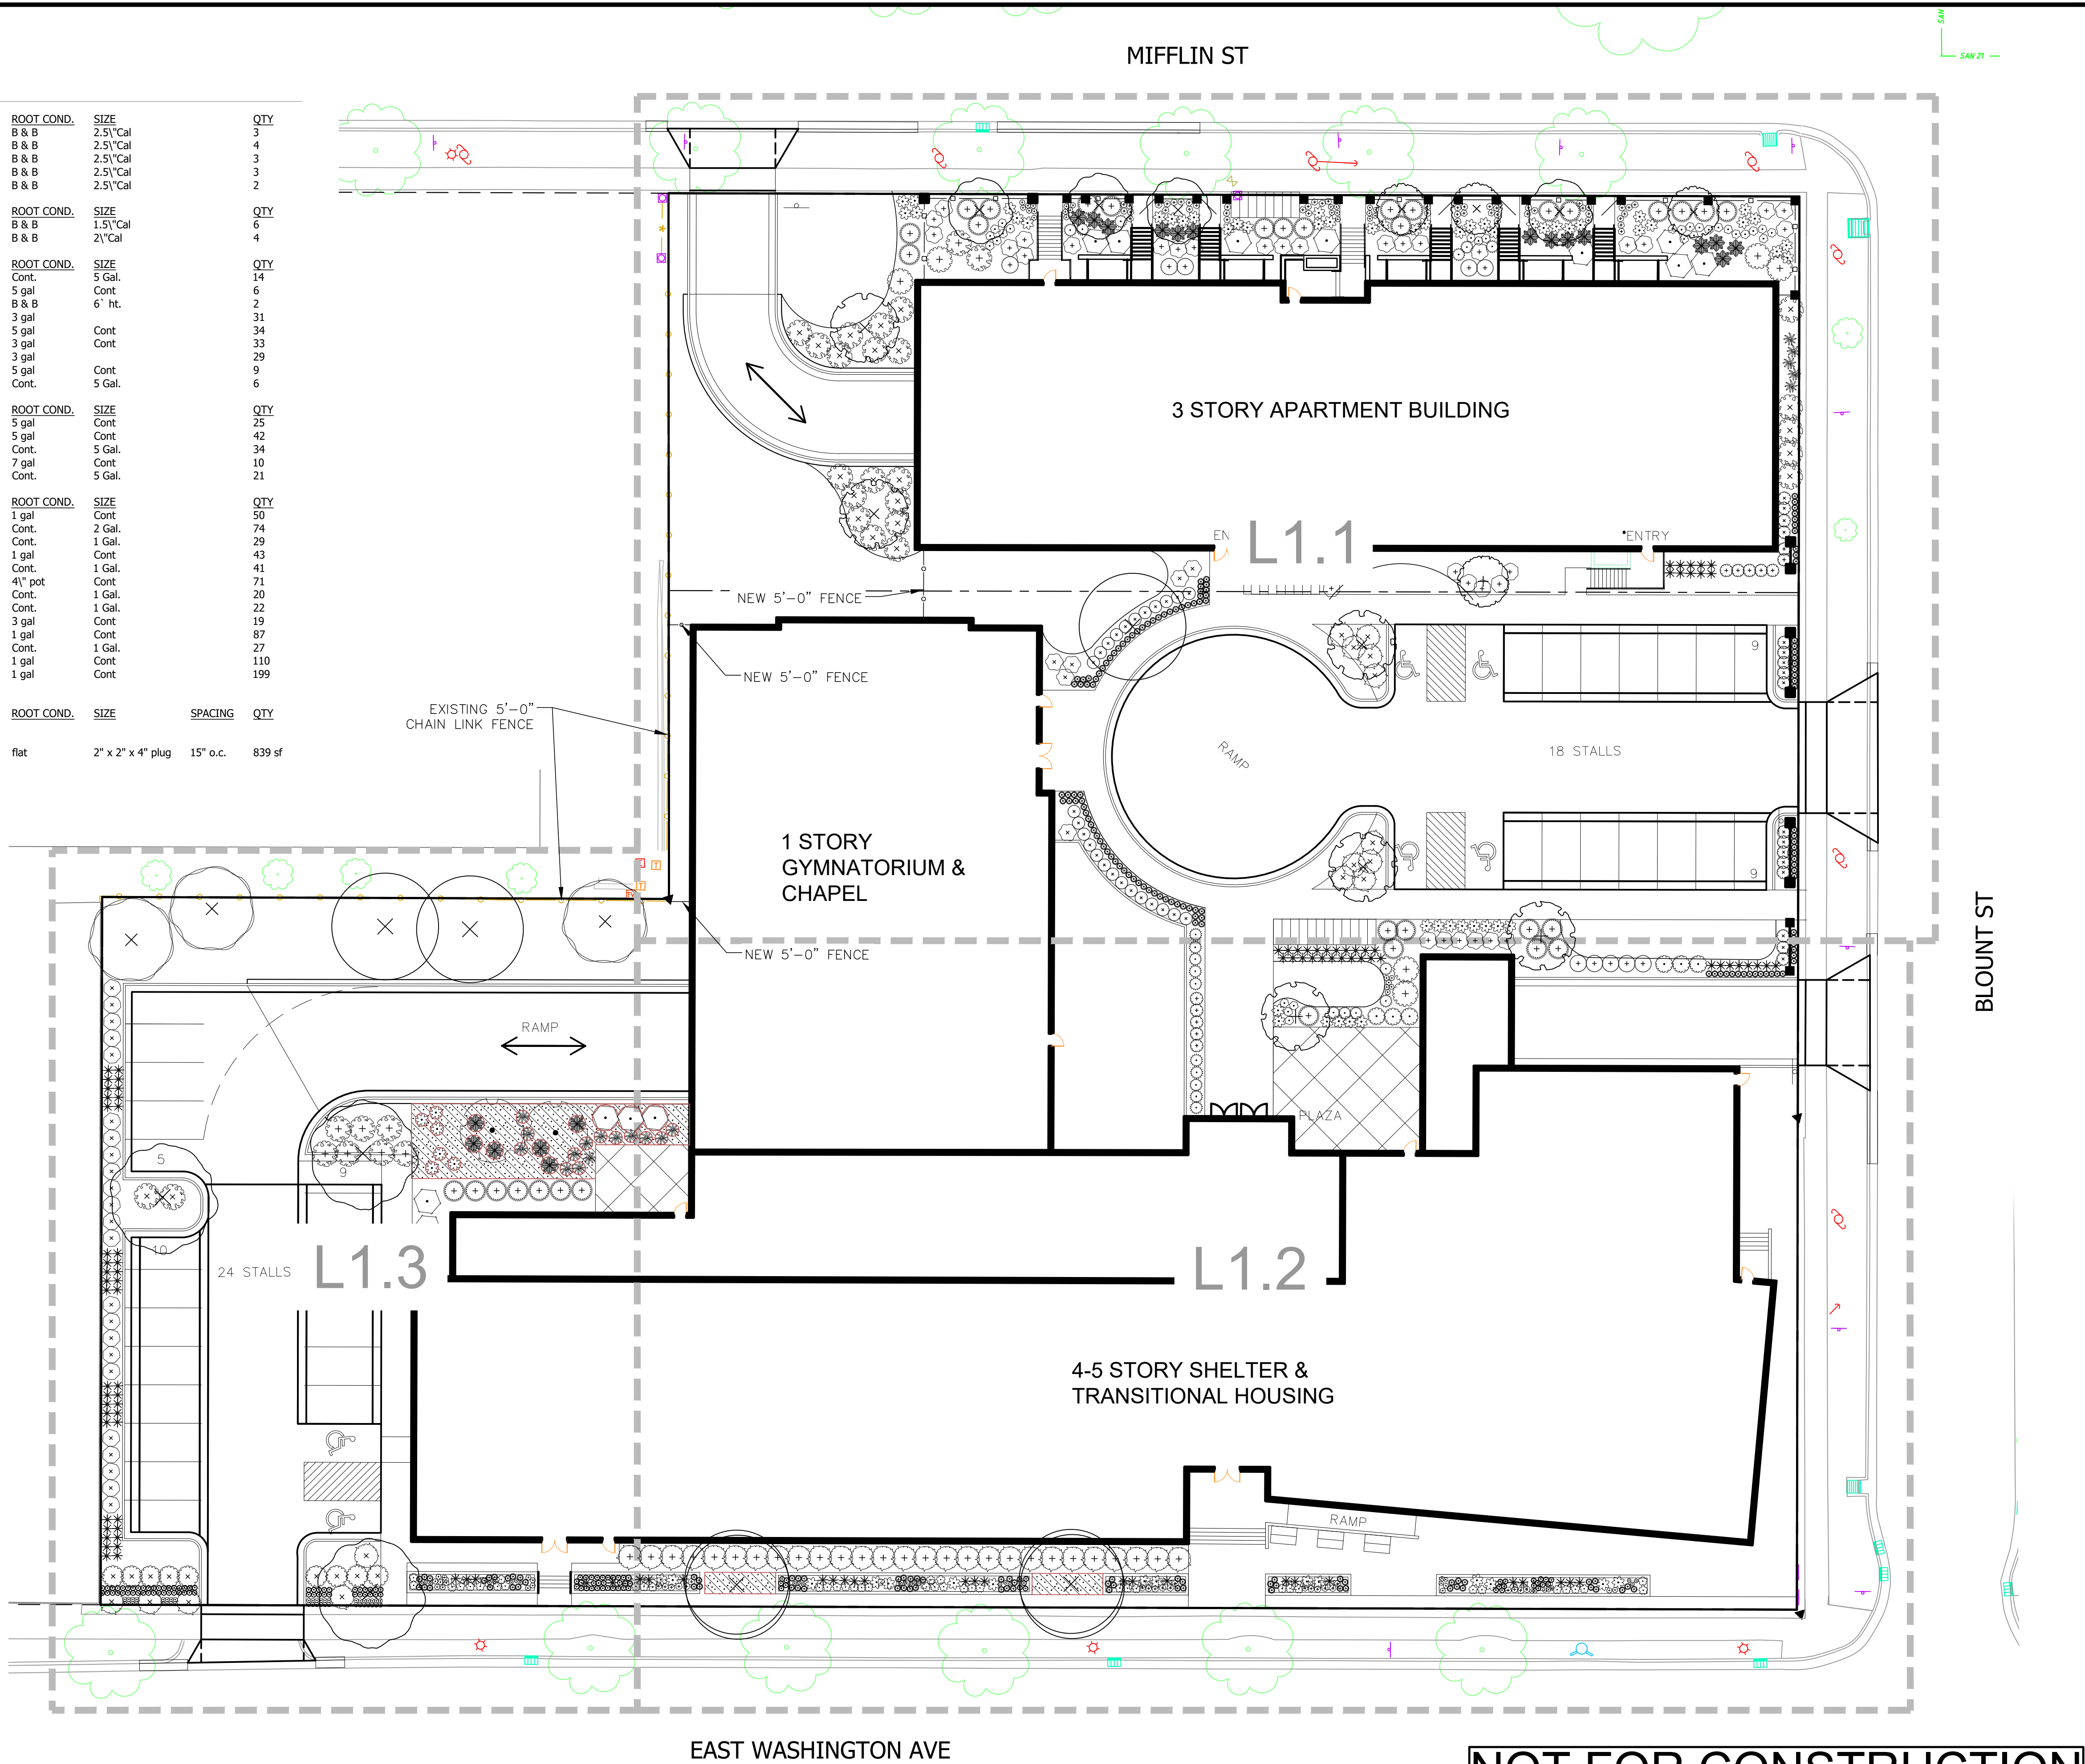
02 Mar 2022 - 3:45p M:\Salvation Army\160245\_630 East Washington\CADD\210406 - Landscape 20220302.dwg by: cina

**PLANT SCHEDULE**


DECIDUOUS TREES	BOTANICAL / COMMON NAME	ROOT COND.	SIZE	QTY	
AF	Acer x freemanii 'Celzam' TM / Celebration Maple	B & B	2.5"/Cal	3	
GTD	Gleditsia triacanthos 'Draves' / Street Keeper Honey Locust	B & B	2.5"/Cal	4	
GTS	Gleditsia triacanthos inermis 'Shademaster' TM / Shademaster Locust	B & B	2.5"/Cal	3	
QH	Quercus robur x macrocarpa 'Clemens' TM / Heritage	B & B	2.5"/Cal	3	
UN	Ulmus x 'New Horizon' / New Horizon Elm	B & B	2.5"/Cal	2	
UNDERSTORY TREES	BOTANICAL / COMMON NAME	ROOT COND.	SIZE	QTY	
MS	Malus x 'Spring Snow' / Spring Snow Crab Apple	B & B	1.5"/Cal	6	
SR	Syringa reticulata 'Ivory Pillar' / Ivory Pillar Japanese Tree Lilac	B & B	2"/Cal	4	
DECIDUOUS SHRUBS	BOTANICAL / COMMON NAME	ROOT COND.	SIZE	QTY	
Aa	Aronia arbutifolia 'Brilliantissima' / Brilliant Red Chokeberry	Cont.	5 Gal.	14	
Cf	Calycanthus floridus / Sweet Shrub	5 gal	Cont.	6	
Ca	Cornus alternifolia / Pagoda Dogwood	B & B	6' ht.	2	
DI	Diervilla lonicera / Dwarf Bush Honeysuckle	3 gal	Cont.	31	
Ha	Hydrangea arborescens 'Annabelle' / Annabelle Smooth Hydrangea	5 gal	Cont.	34	
Ra	Rhus aromatica 'Gro-Low' / Gro-Low Fragrant Sumac	3 gal	Cont.	33	
St	Spiraea betulifolia 'Tor' / Birchleaf Spirea	3 gal	Cont.	29	
Sb	Spiraea x bumalda 'Froebeli' / Froebel Spirea	5 gal	Cont.	9	
Vd	Viburnum dentatum 'Little Joe' / Little Joe Arrowwood Viburnum	Cont.	5 Gal.	6	
EVERGREEN SHRUBS	BOTANICAL / COMMON NAME	ROOT COND.	SIZE	QTY	
Bx	Buxus x 'Green Mound' / Green Mound Boxwood	5 gal	Cont.	25	
Jh	Juniperus horizontalis 'Blue Chip' / Blue Chip Juniper	5 gal	Cont.	42	
Tm	Taxus x media 'Everlow' / Yew	Cont.	5 Gal.	34	
To	Thuja occidentalis 'Holmstrup' / Holmstrup Cedar	7 gal	Cont.	10	
Th	Thuja occidentalis 'Hetz Midget' / Hetz Midget Arborvitae	Cont.	5 Gal.	21	
PERENNIALS	BOTANICAL / COMMON NAME	ROOT COND.	SIZE	QTY	
as	Allium x 'Summer Beauty' / Summer Beauty Allium	1 gal	Cont.	50	
at	Anemone tabernaemontana 'Blue Ice' / Blue Ice Eastern Bluestar	Cont.	2 Gal.	74	
ah	Anemone x hybrida 'Honorable Jobert' / Honorable Jobert Japanese Anemone	Cont.	1 Gal.	29	
cq	Coreopsis grandiflora 'Early Sunrise' / Early Sunrise Coreopsis	1 gal	Cont.	43	
gbv	Geranium macrorrhizum 'Bevan's Variety' / Bevan's Variety Bigroot Geranium	Cont.	1 Gal.	41	
hx	Heuchera x 'Berry Timeless' / Coral Bells	4"/ pot	Cont.	71	
hg	Hosta x 'Guacamole' / Guacamole Hosta	Cont.	1 Gal.	20	
lko	Liatris spicata 'Kobold Original' / Kobold Original Blazing Star	Cont.	1 Gal.	22	
msf	Matteuccia struthiopteris / Ostrich Fern	3 gal	Cont.	19	
pv	Panicum virgatum 'Shenandoah' / Shenandoah Red Switch Grass	1 gal	Cont.	87	
plb	Perovskia atriplicifolia 'Lislett' / Lacey Blue Russian Sage	Cont.	1 Gal.	27	
ss	Schizachyrium scoparium / Little Bluestem Grass	1 gal	Cont.	110	
sh	Sporobolus heterolepis / Prairie Dropseed	1 gal	Cont.	199	
GROUND COVERS	BOTANICAL / COMMON NAME	ROOT COND.	SIZE	SPACING	QTY
	Ajuga reptans 'Bronze Beauty' / Bronze Beauty Carpet Bugle	flat	2" x 2" x 4" plug	15" o.c.	839 sf

**GENERAL NOTES:**

- All plantings shall conform to quality requirements as per ANSI Z60.1.
- All plant material shall be true to the species, variety and size specified, nursery grown in accordance with good horticultural practices, and under climactic conditions similar to those of the project site.
- Contact Landscape Architect, in writing, to request and plant material substitutions due to availability issues.
- All disturbed areas, unless otherwise noted, to be seeded with Madison Parks Mix by LaCrosse Seed Company or equivalent, per manufacturer's specified application rates. All seeded areas are to be watered daily to maintain adequate soil moisture for proper germination. After vigorous growth is established, apply 1/2" water twice weekly until final acceptance.
- All plants shall be guaranteed to be in healthy and flourishing condition during the growing season following installation. All plant material shall be guaranteed for one year from the time of installation.
- Contractor shall provide a suitable amended topsoil blend for all planting areas where soil conditions are unsuitable for plant growth. Topsoil shall conform to quality requirements as per Section 625.2(1) of the Standard Specifications for Highway Construction. Provide a minimum of 12" of topsoil in all planting areas and 6" of topsoil in areas to be seeded/sodded.
- Landscape beds to be mulched with undyed shredded hardwood bark mulch to 3" depth min. and edged with commercial grade aluminum landscape edging, Permaloc CleanLine 3/8" x 4" or equal, color black anodized.



**NOT FOR CONSTRUCTION**

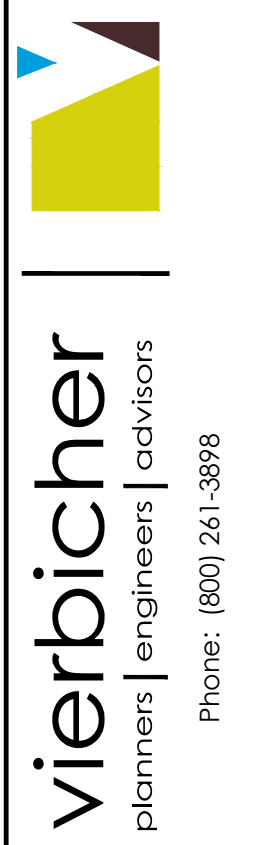

**Landscape Plan**  
622 and 630 East Washington  
City of Madison  
Dane County, Wisconsin

REVISIONS	NO.	DATE	REMARKS

SCALE AS SHOWN

DATE 02/17/2022

DRAFTER SVIN

CHECKED JKAS

PROJECT NO. 160245

SHEET 1 OF 4

DWG. NO. L1.0










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P1	2	P1	RSX1 LED P1 30K R3	RSX1 LED P1 30K R3	51.34	4459	0.900
P2	2	P2	RSX1 LED P1 30K R4	RSX1 LED P1 30K R4	51.34	4543	0.900
P4HS	1	P4HS	RSX1 LED P2 30K R4 HS	RSX1 LED P2 30K R4 HS	72.9467	6300	0.900
P5	1	P5	RSX1 LED P1 30K R5B	RSX1 LED P1 30K R5B	51.34	4607	0.900
P6	4	P6	RCL40-4K	SURFACE AREA LIGHT AND PARKING GARAGE	40.8	5244	0.900
S1	32	S1	RSL5-10x4-NH	RSL5-10x4-NH	120.4	726	0.900
S2	6	S2	FCCL10R-D-30	SURFACE DOWNLIGHT CYLINDER	42.8	1689	0.900
W1	2	W1	W062 LED P4 30K BUCKI VF	W062 LED P4 30K BUCKI VF	34.94	4211	0.900
W2	4	W2	RSL1-1-4K	PULL CORD WALL PACK	15.1239	1509	0.900
S3	1	S3	8FT STK WALL FT LOW	8FT Optic 6921	32	3255	0.900

Apartment Building Drive  
 Illuminance (Fc)  
 Average = 1.01  
 Maximum = 1.5  
 Minimum = 0.6  
 Avg/Min Ratio = 1.68  
 Max/Min Ratio = 2.50

Main Parking and Turn Around  
 Illuminance (Fc)  
 Average = 1.12  
 Maximum = 2.4  
 Minimum = 0.4  
 Avg/Min Ratio = 2.80  
 Max/Min Ratio = 6.50

Gym Parking Drive  
 Illuminance (Fc)  
 Average = 1.79  
 Maximum = 4.6  
 Minimum = 0.5  
 Avg/Min Ratio = 3.58  
 Max/Min Ratio = 17.20


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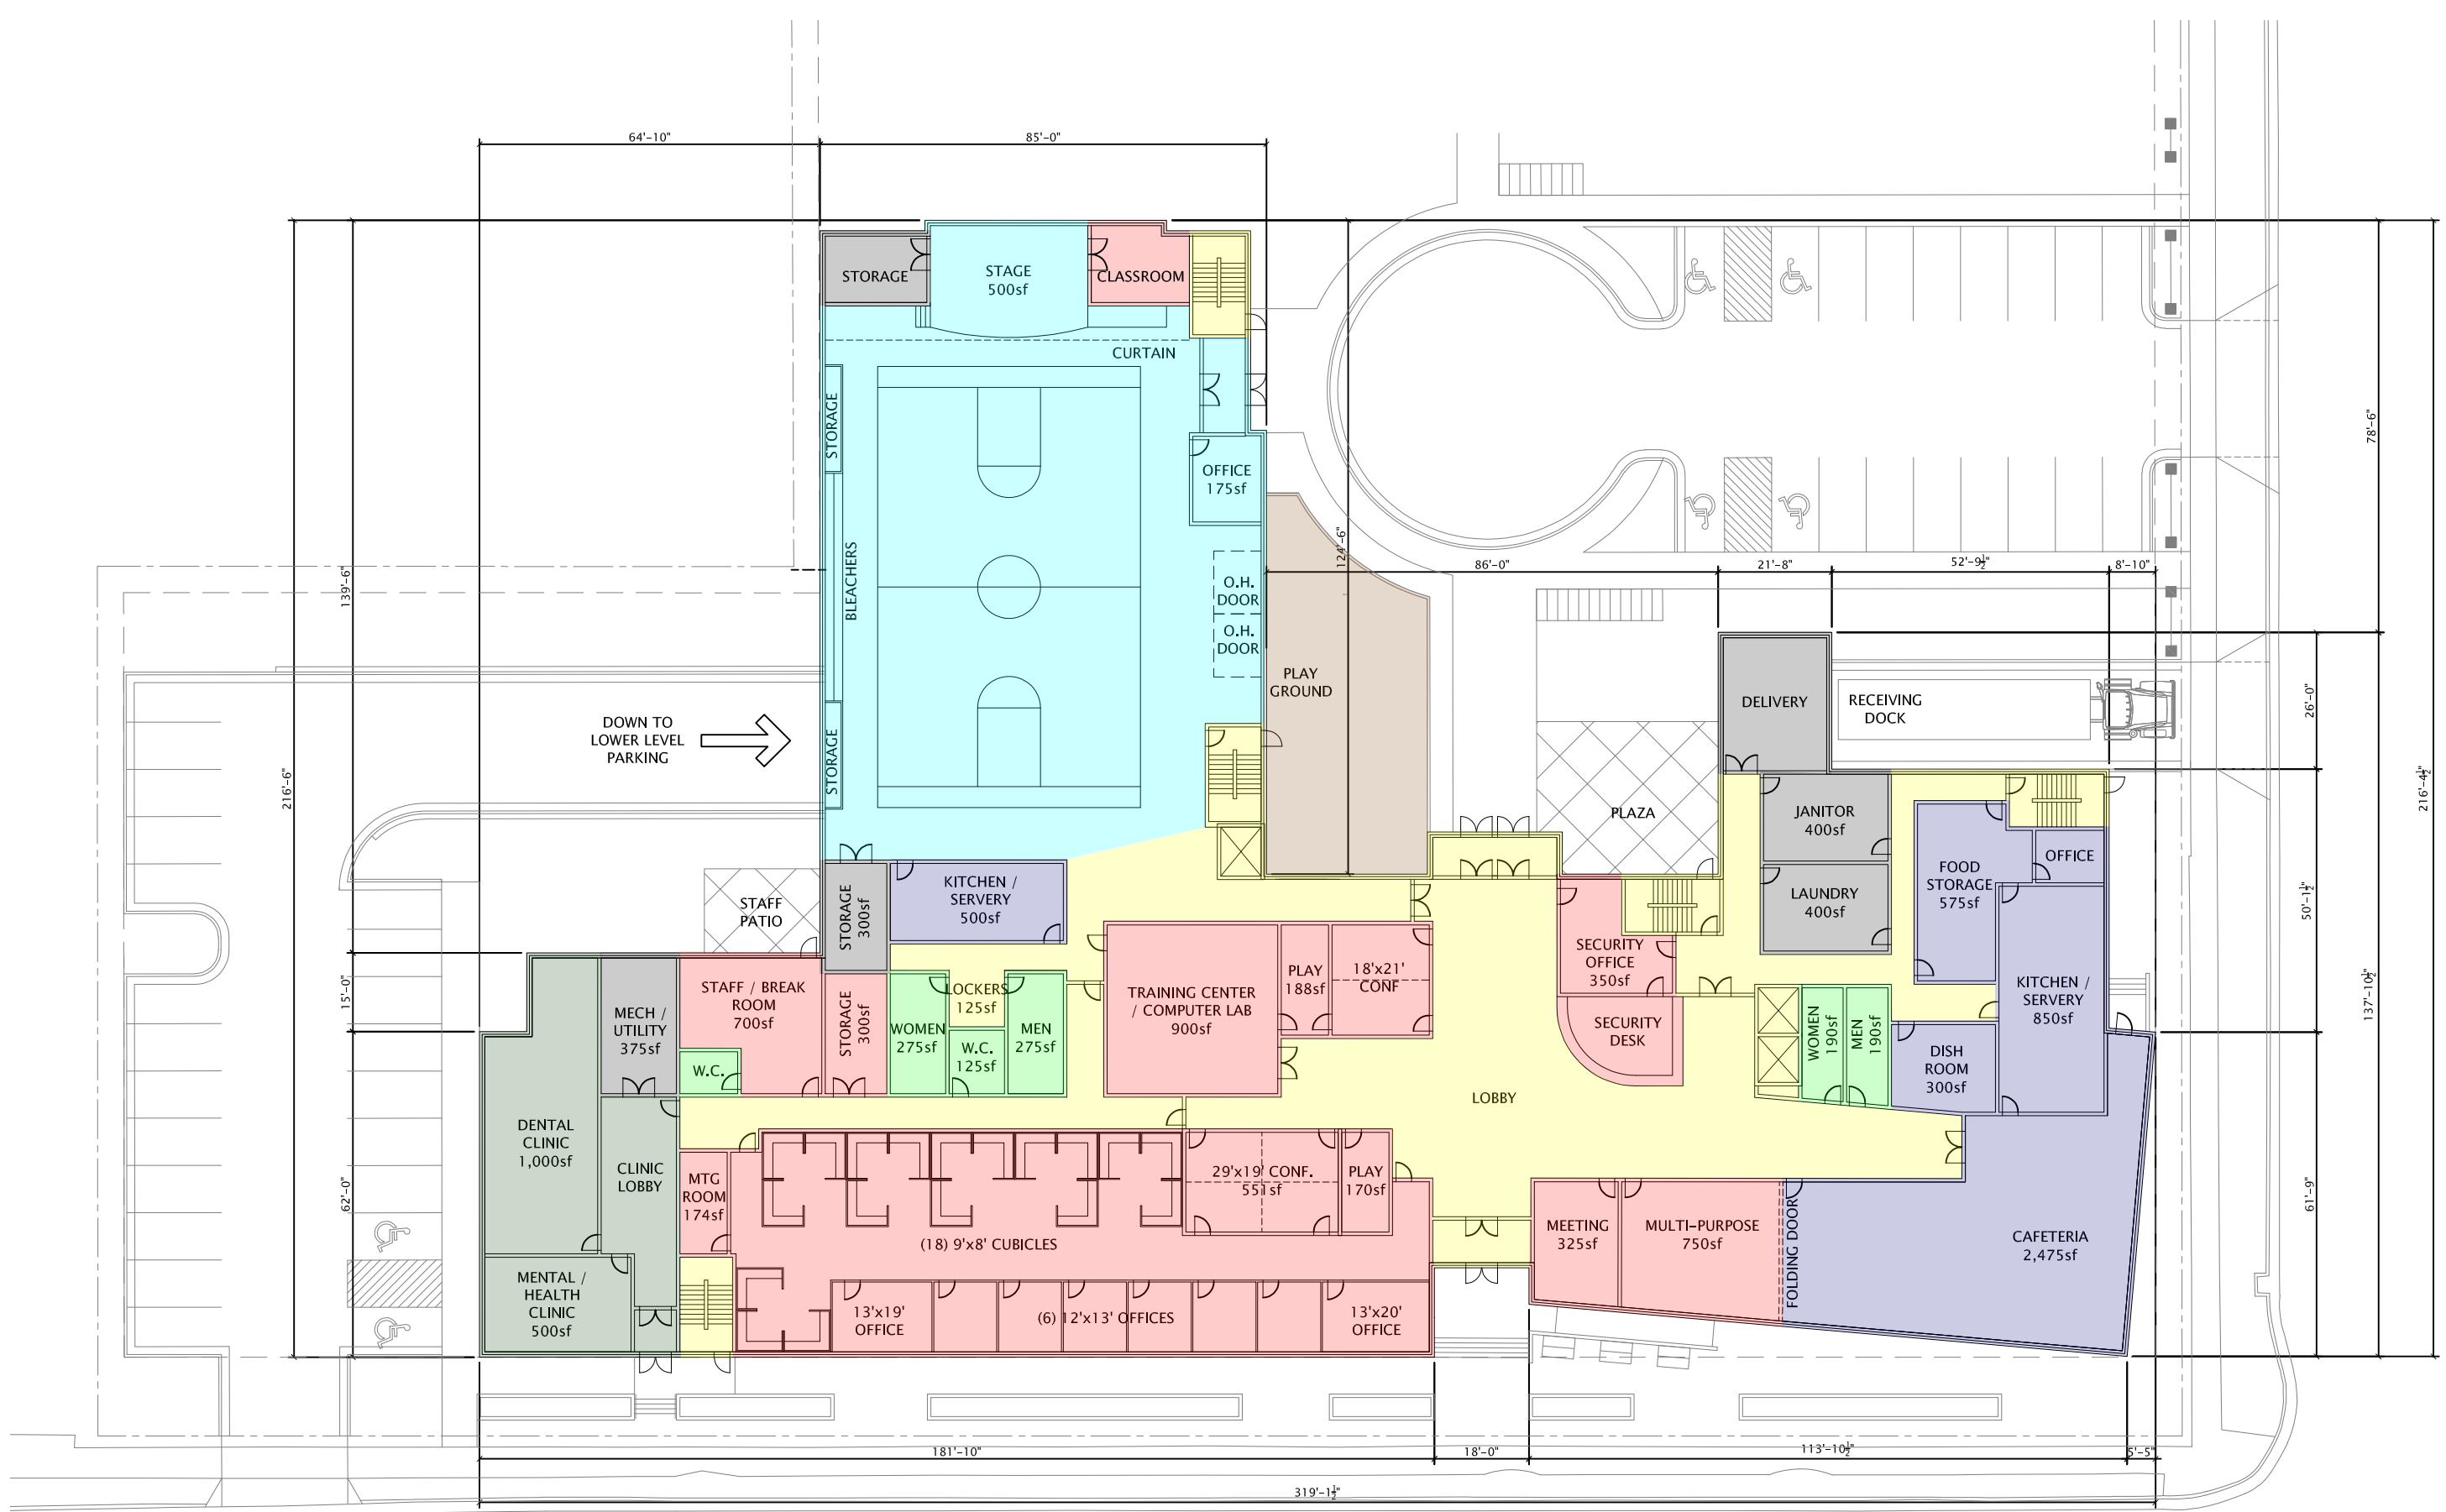


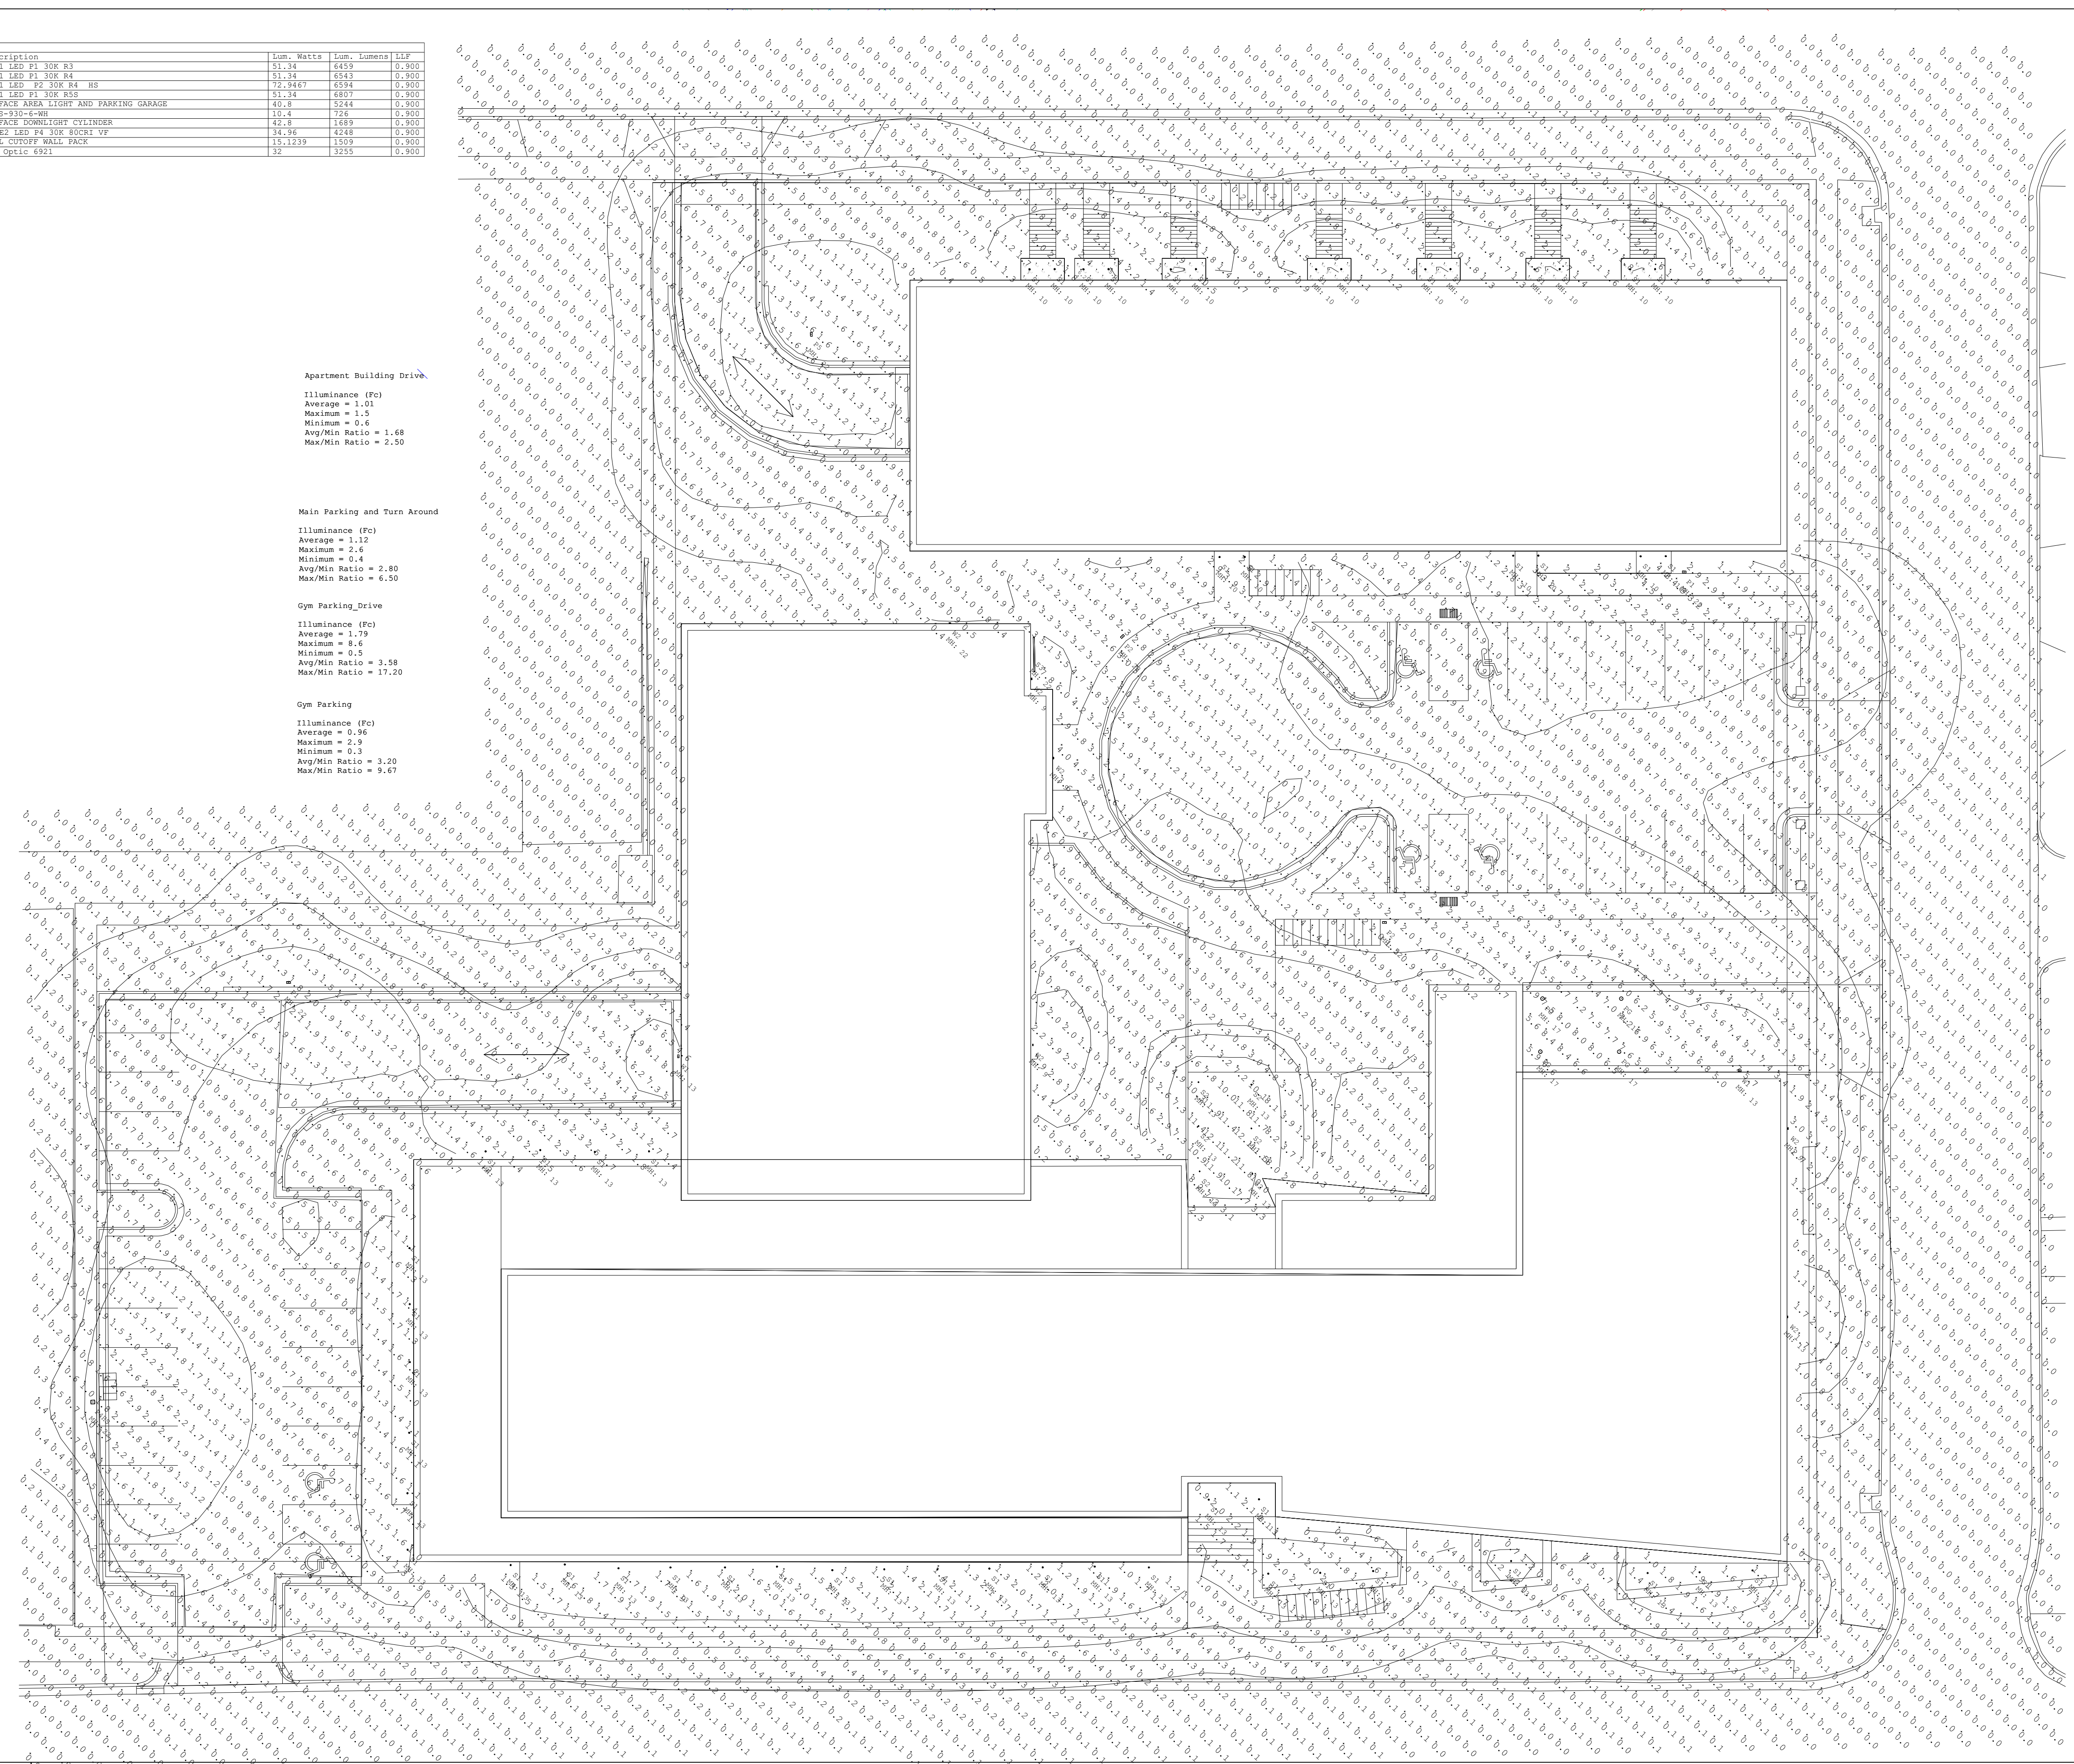
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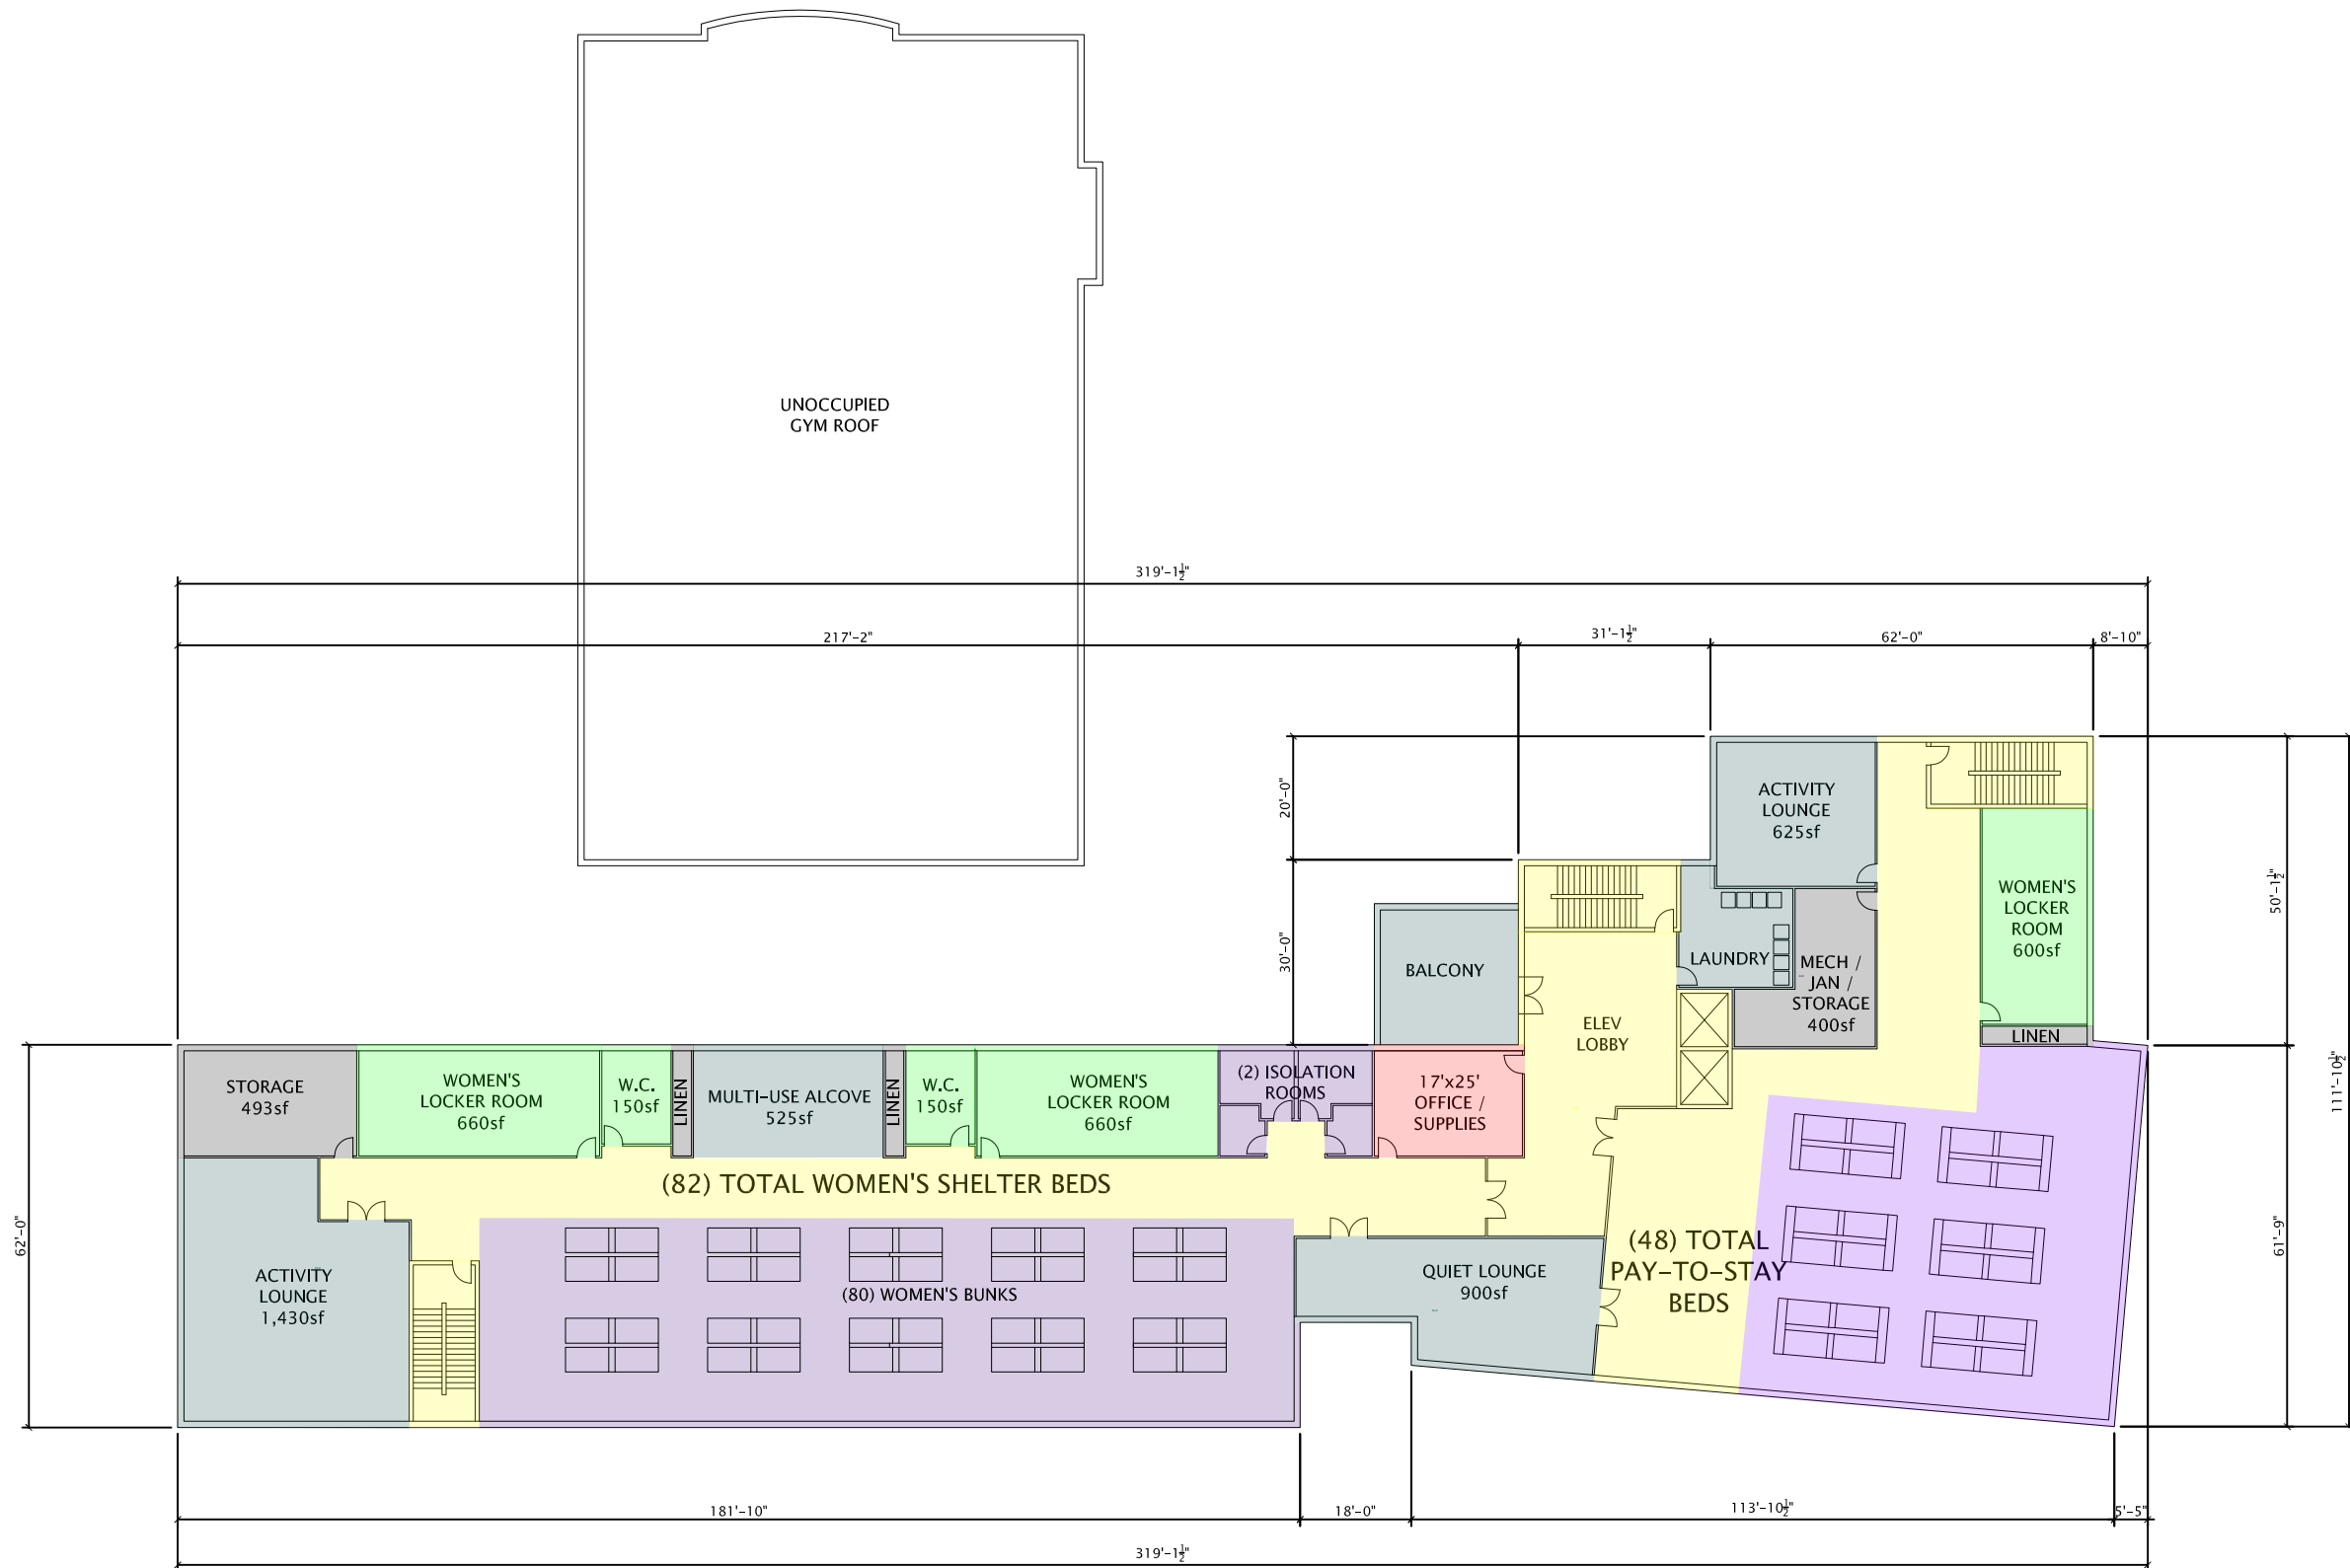
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SALVATION ARMY  
 EAST WASHINGTON AVE  
 LIGHTING LAYOUT










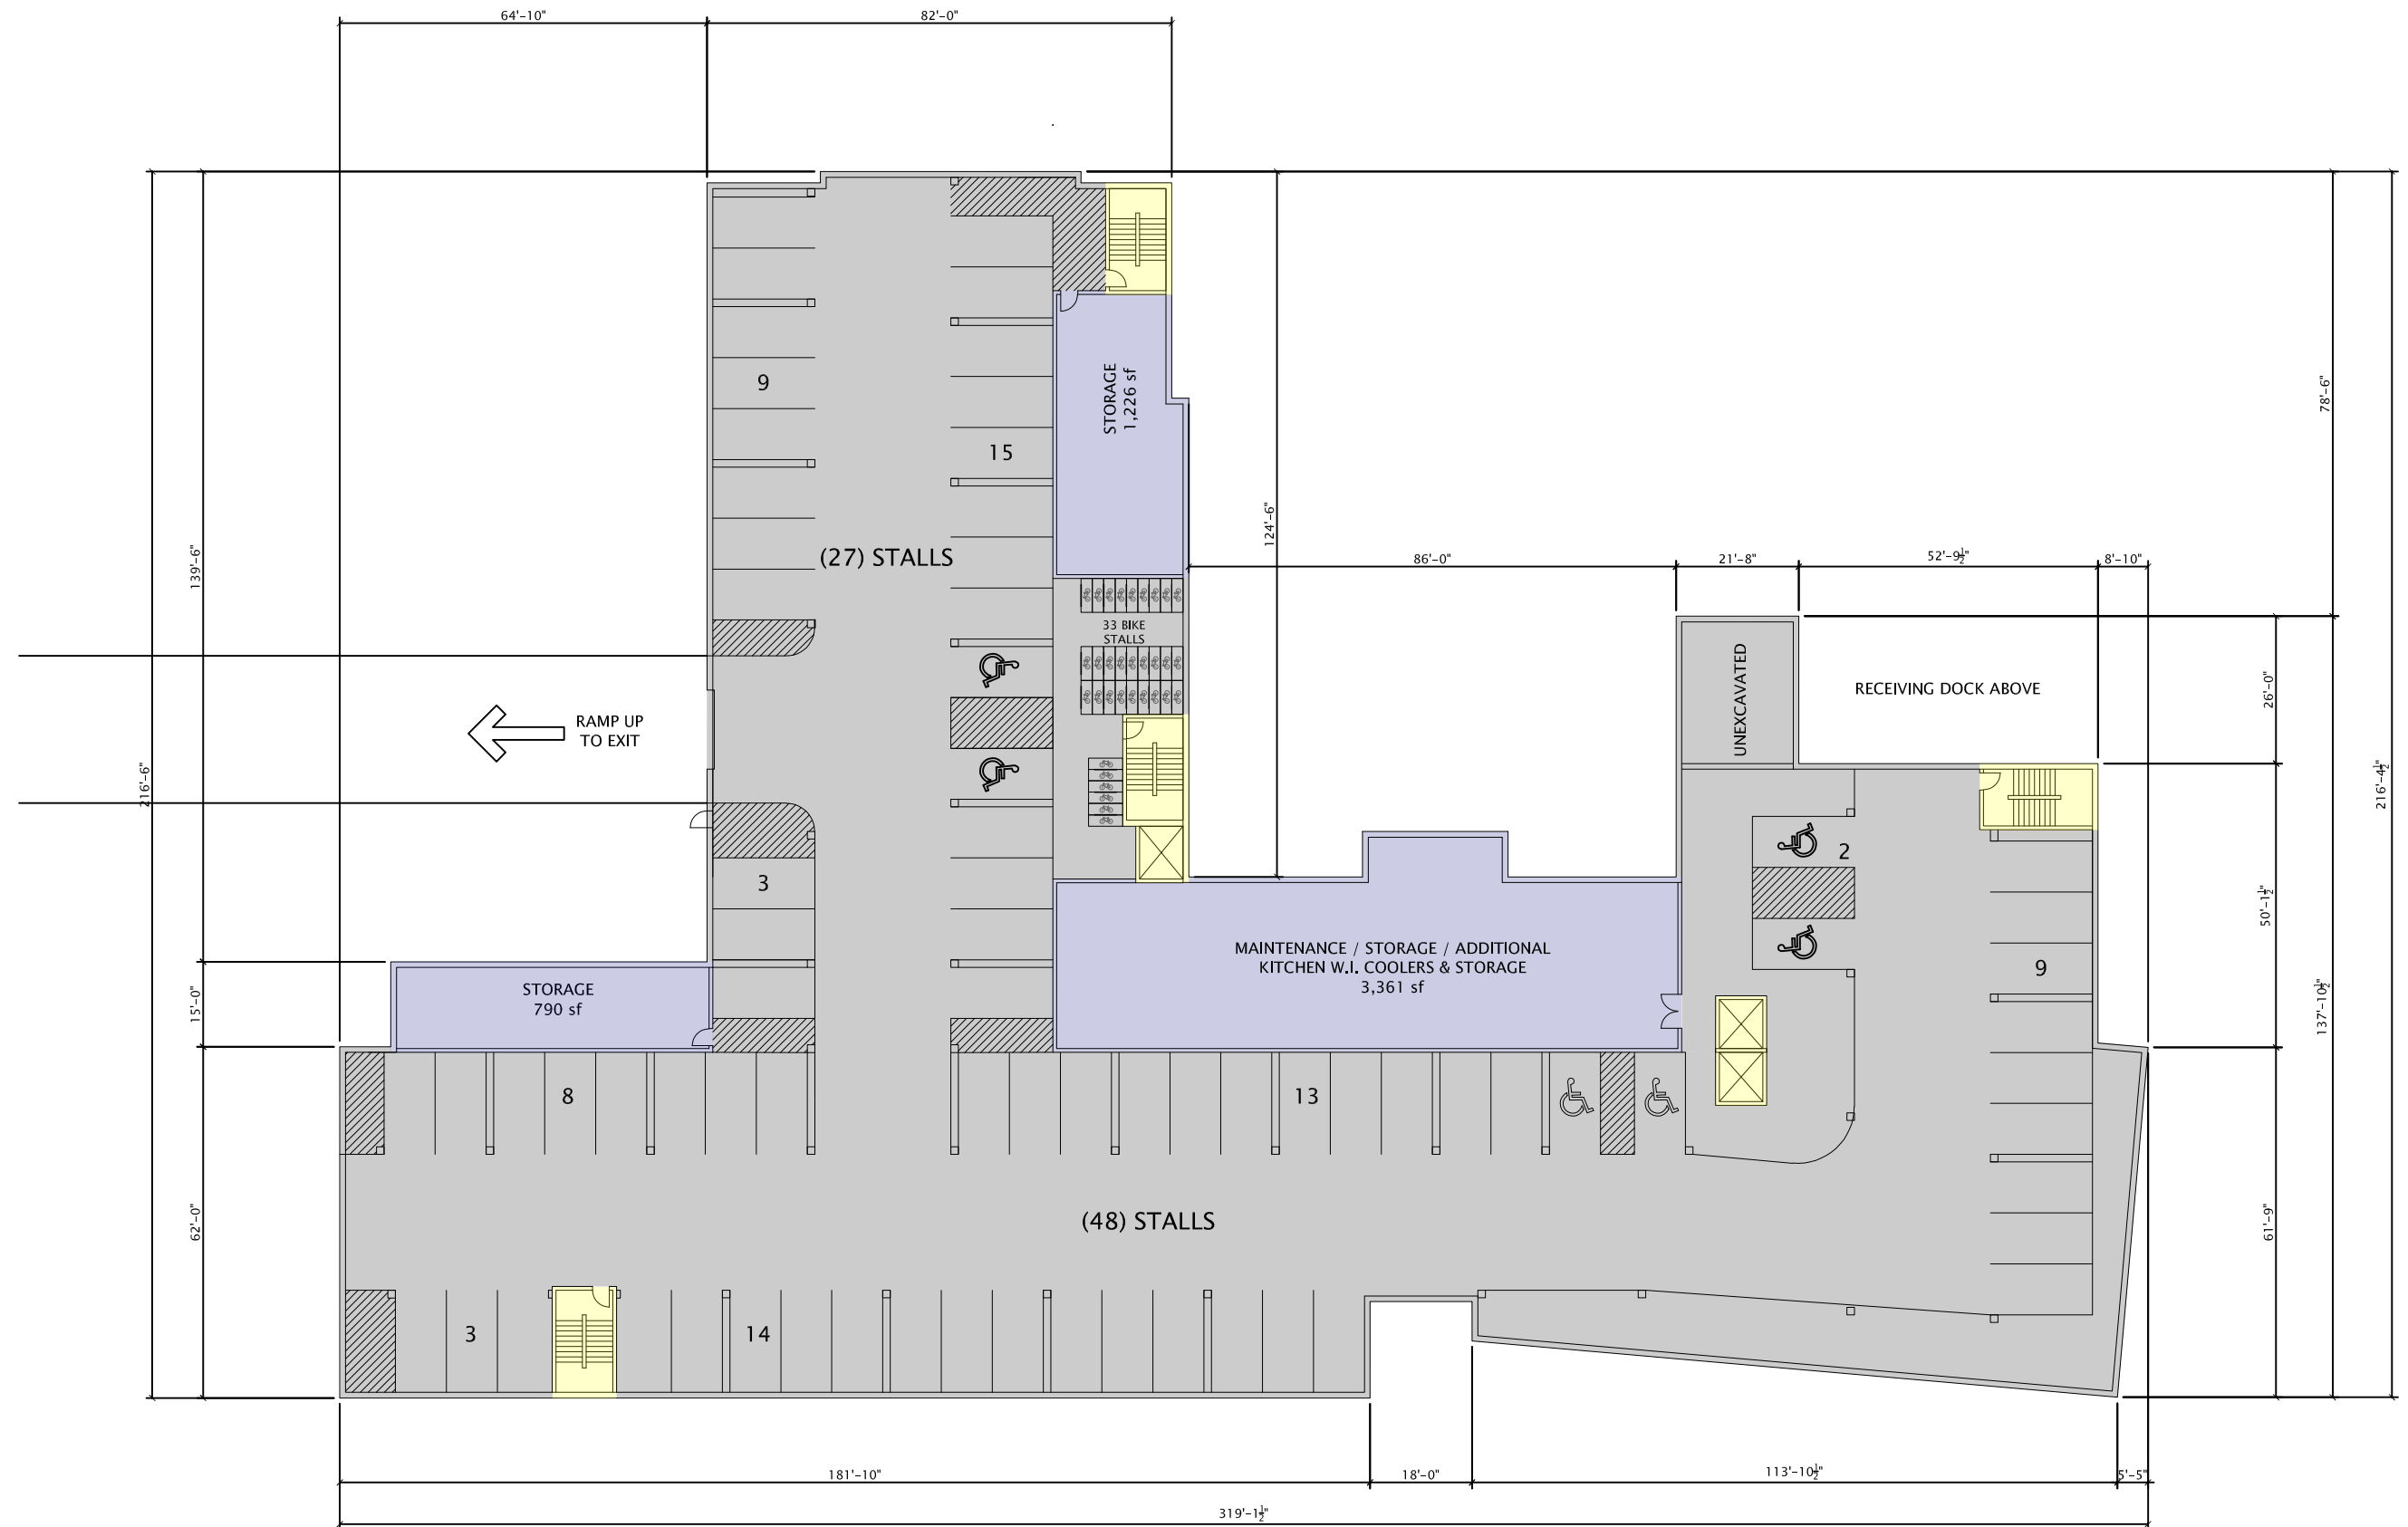

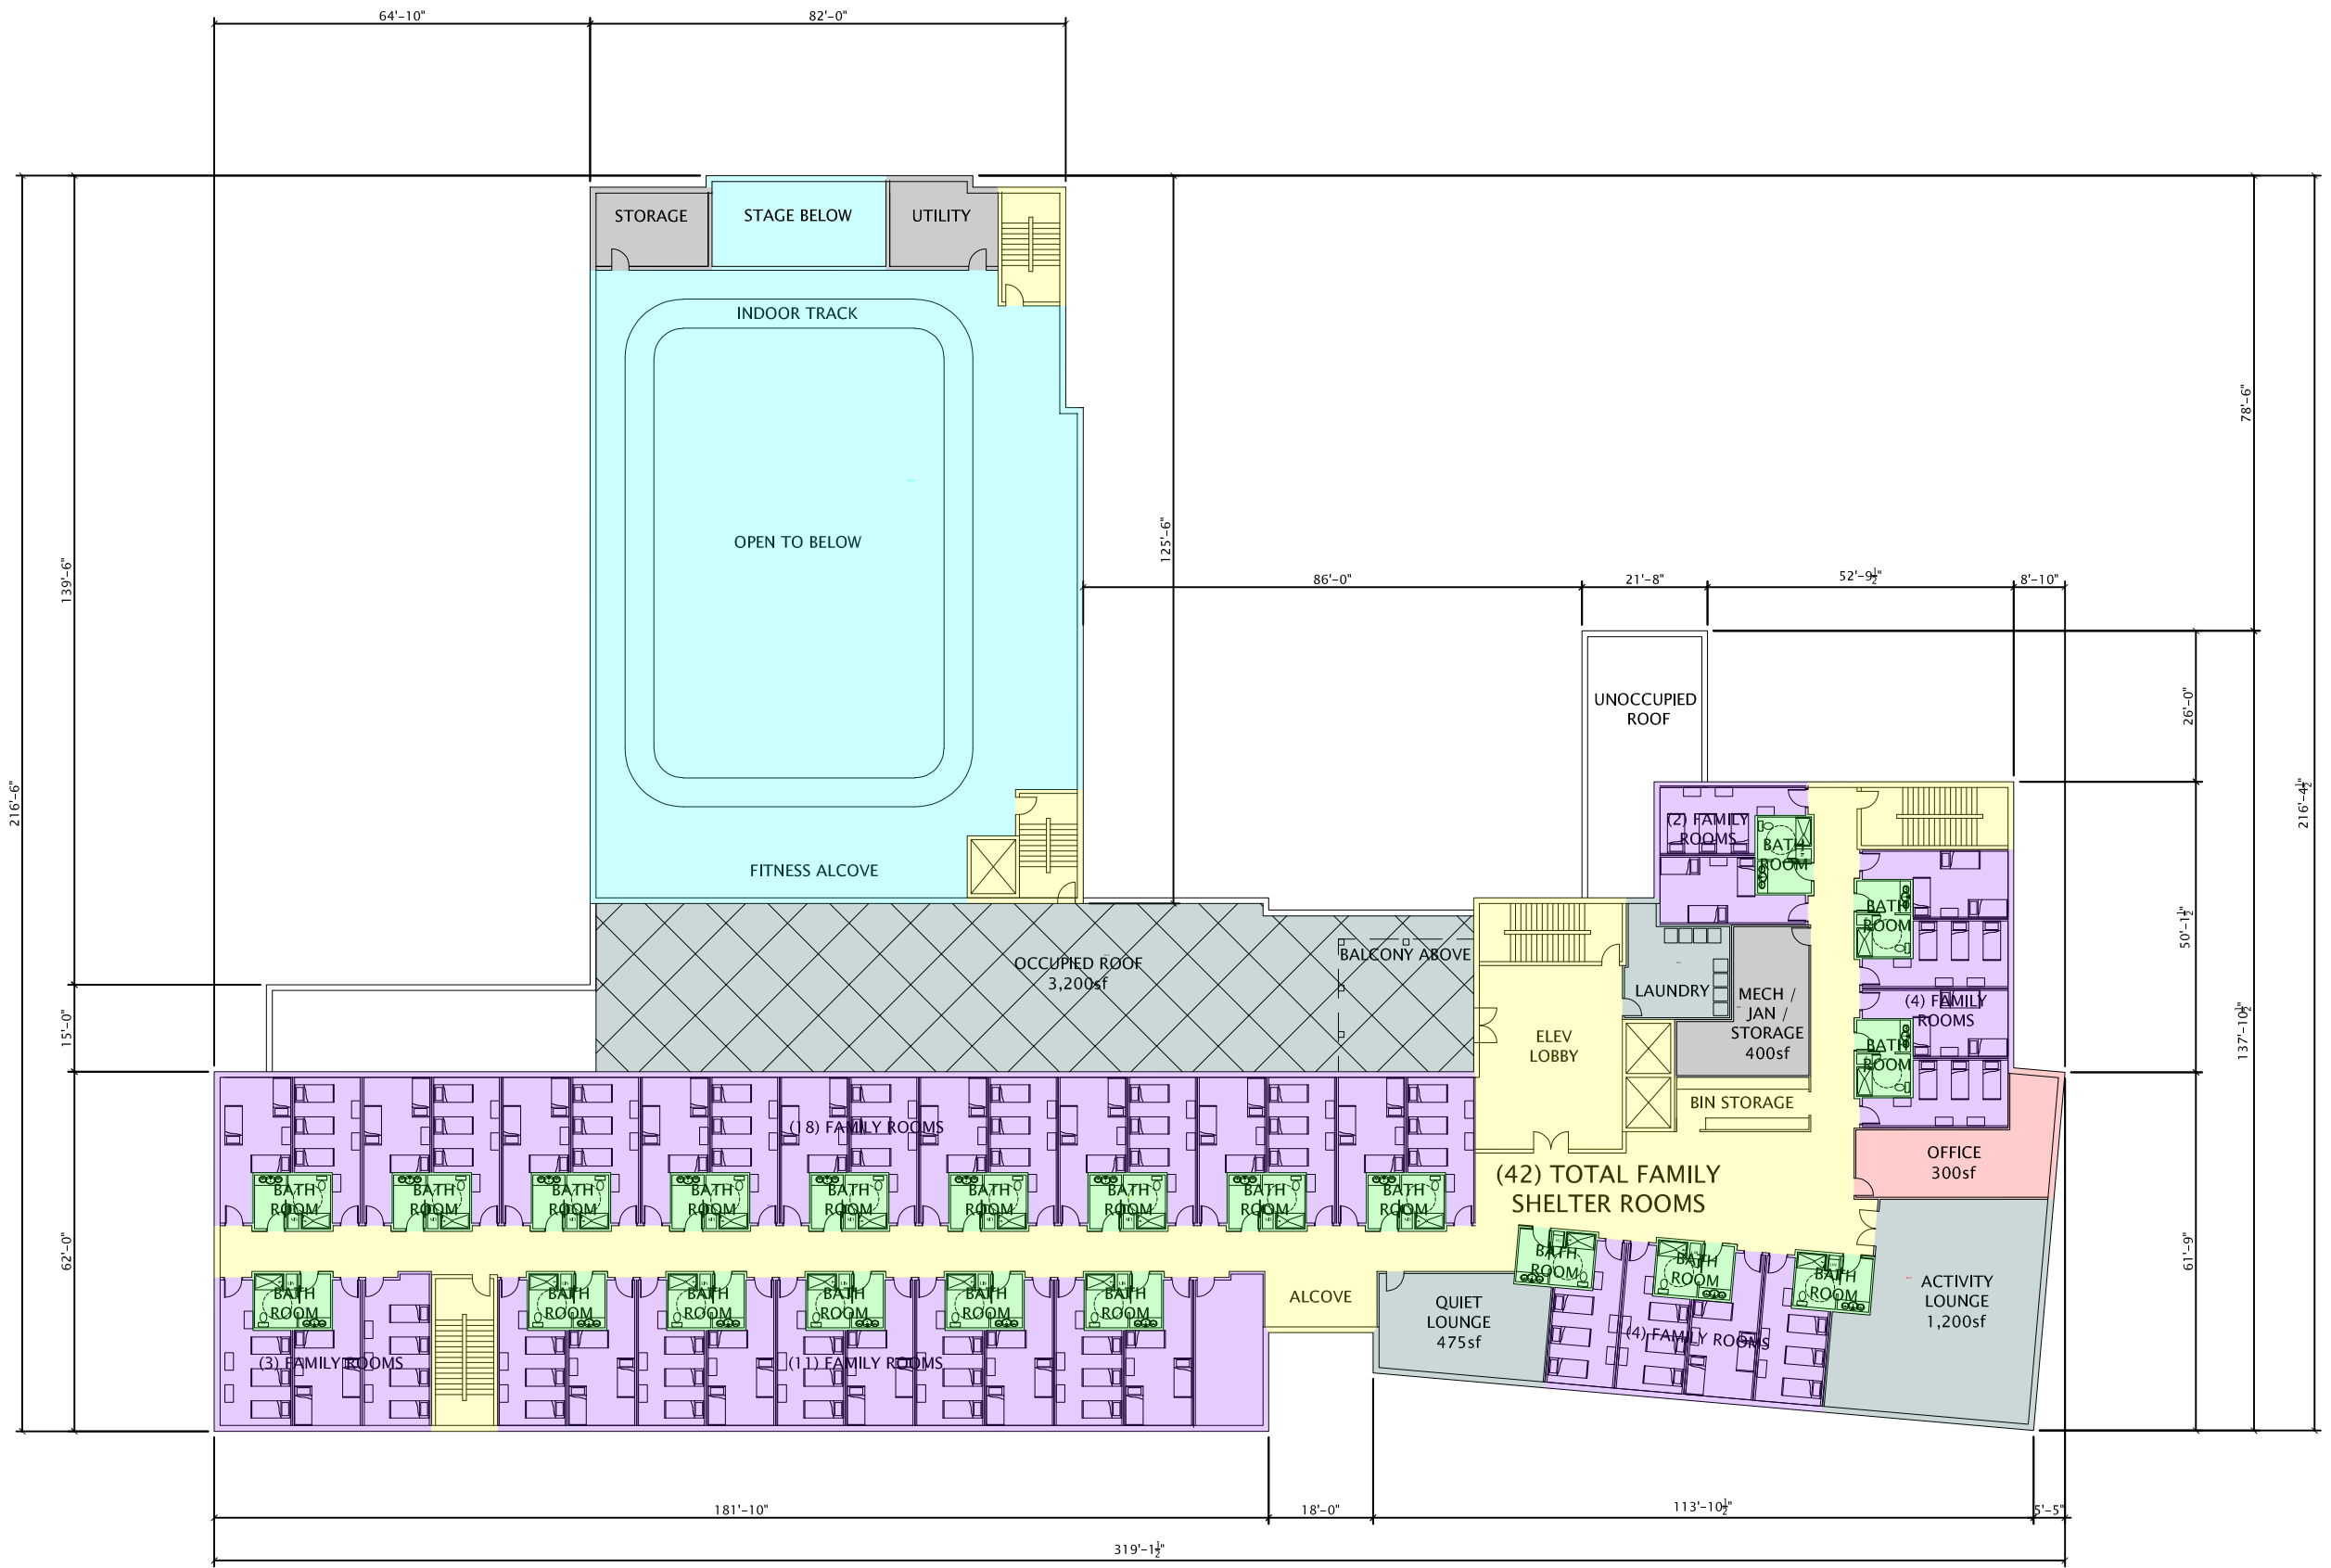

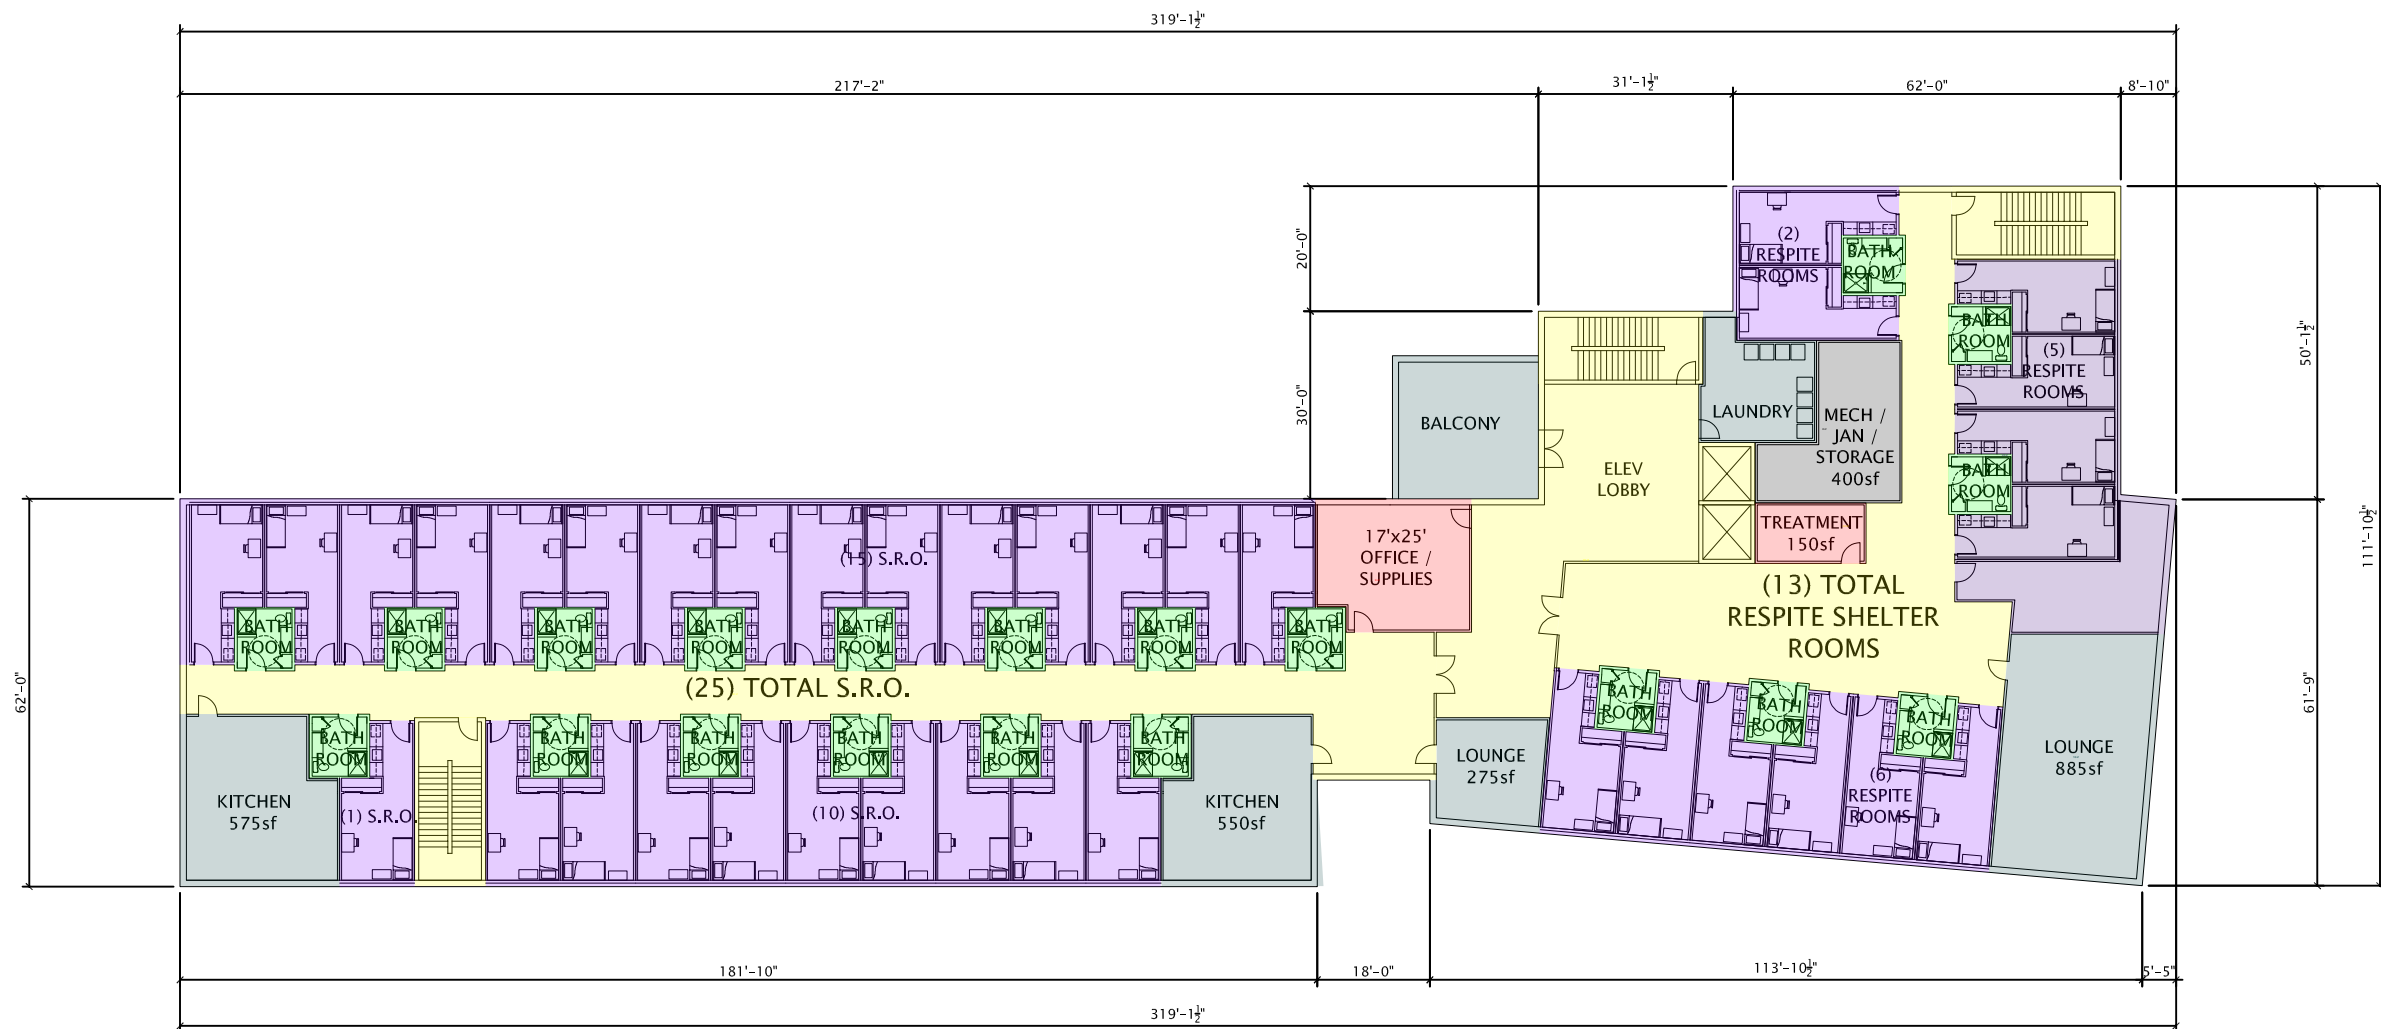

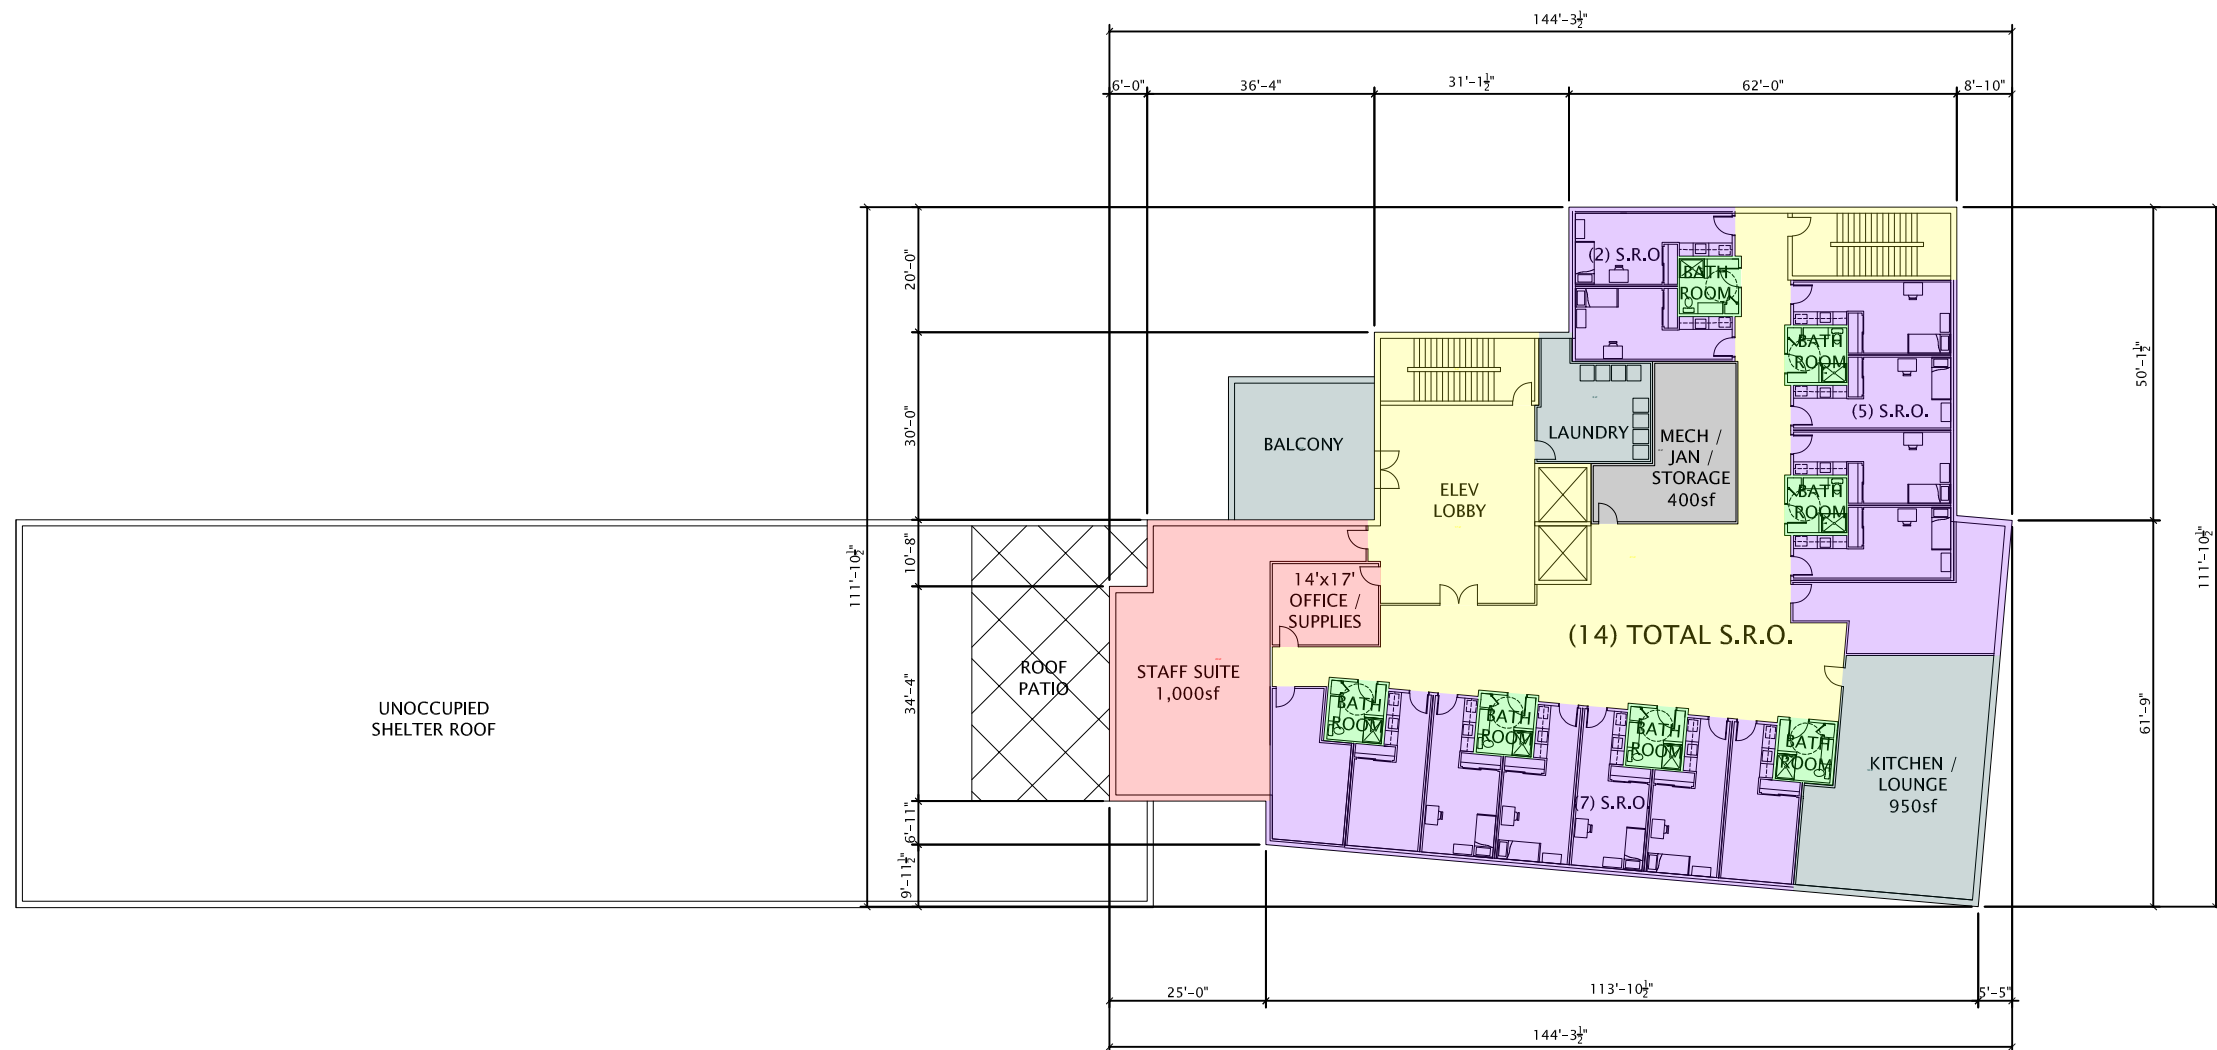

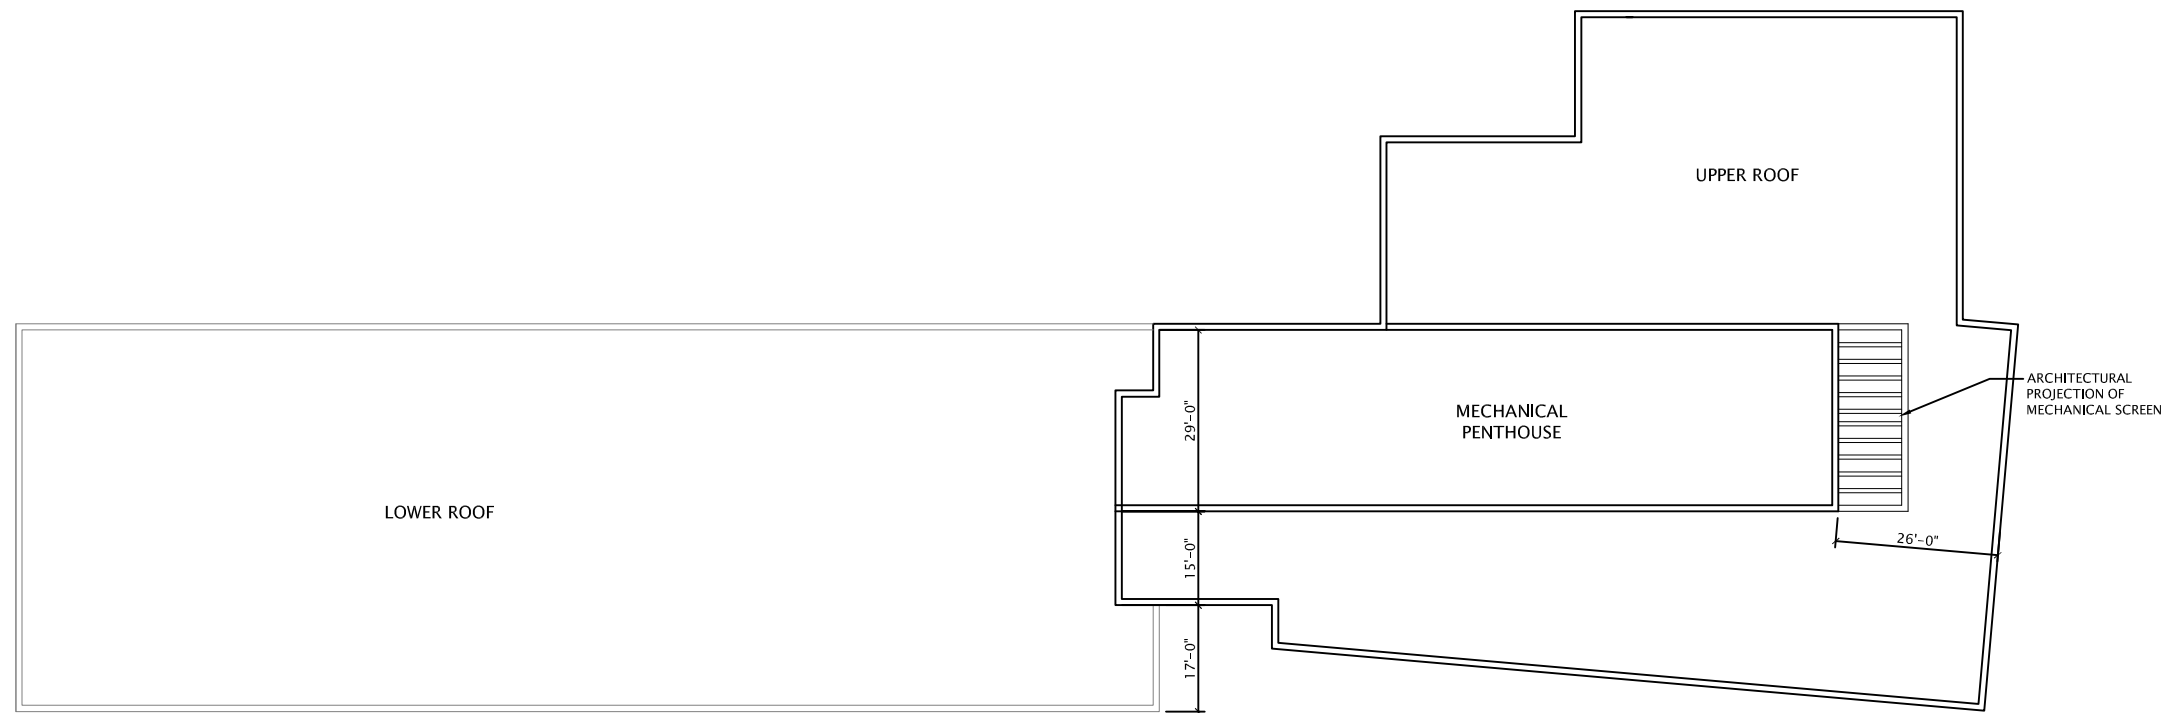



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ARCHITECTS

THE SALVATION ARMY  
SHELTER - EXTERIOR PERSPECTIVES

MARCH 1, 2022



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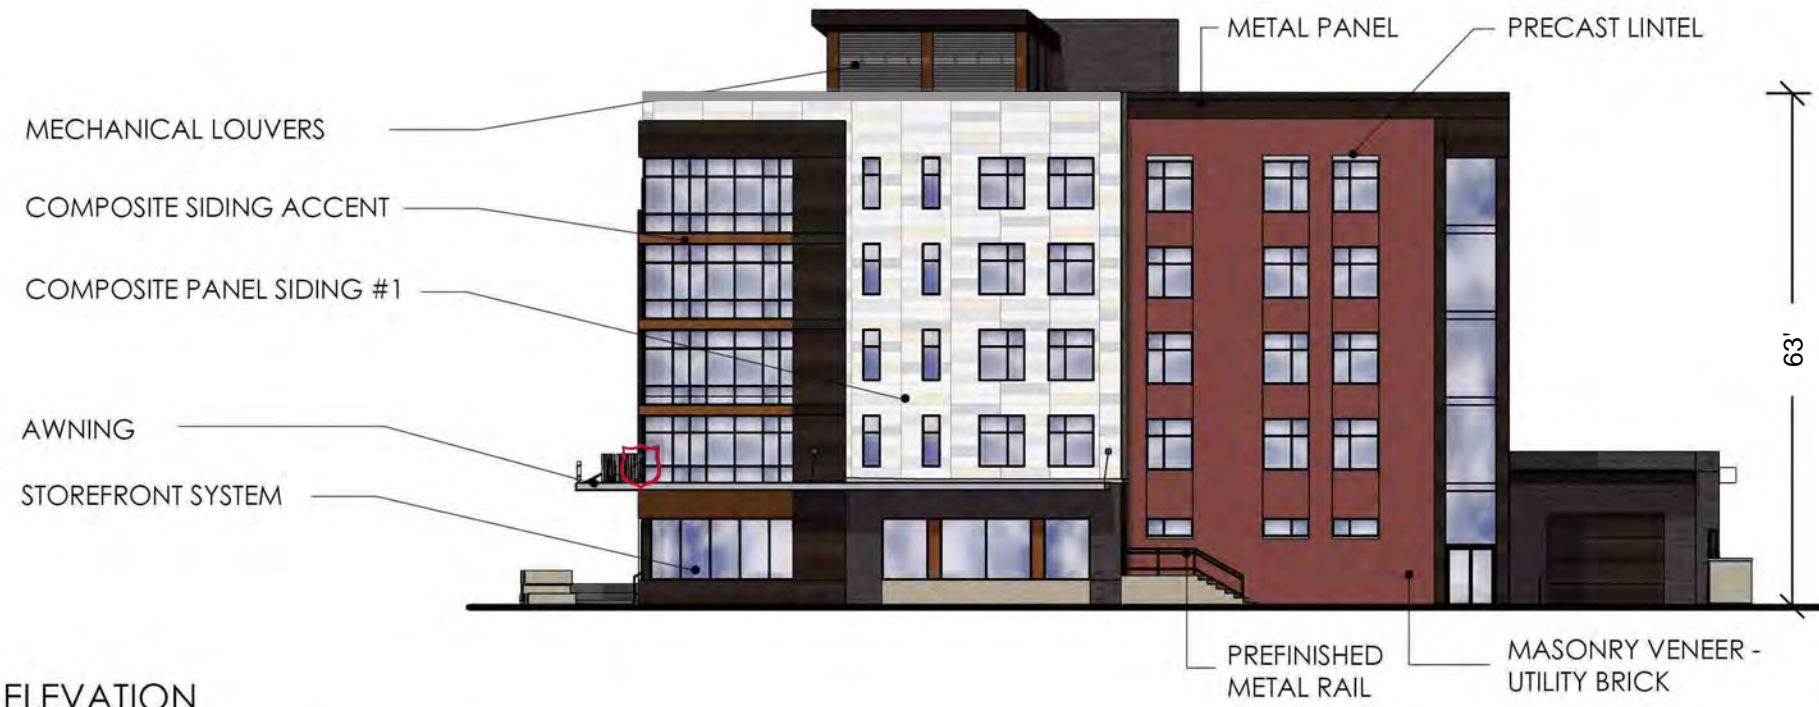





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SHELTER - EXTERIOR PERSPECTIVES

MARCH 1, 2022



BLOUNT ST. ELEVATION  
SCALE 1/25" = 1'0"

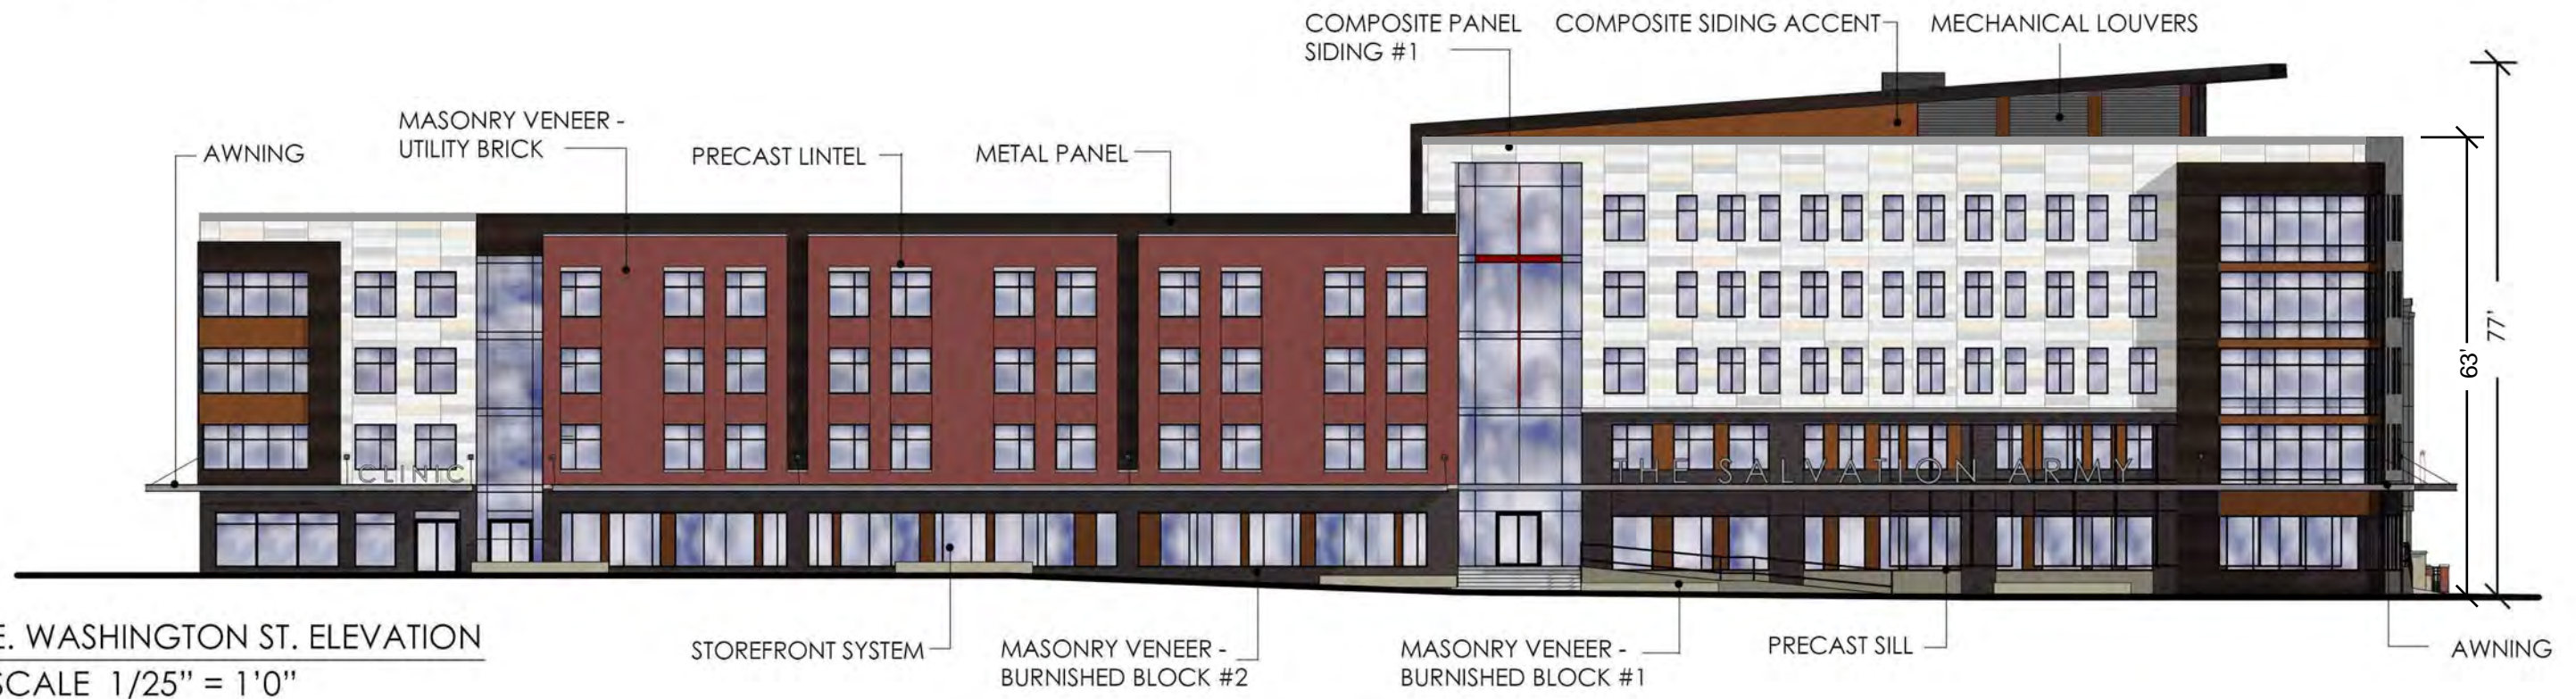

E. WASHINGTON ST. ELEVATION  
SCALE 1/25" = 1'0"



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SHELTER - ELEVATIONS




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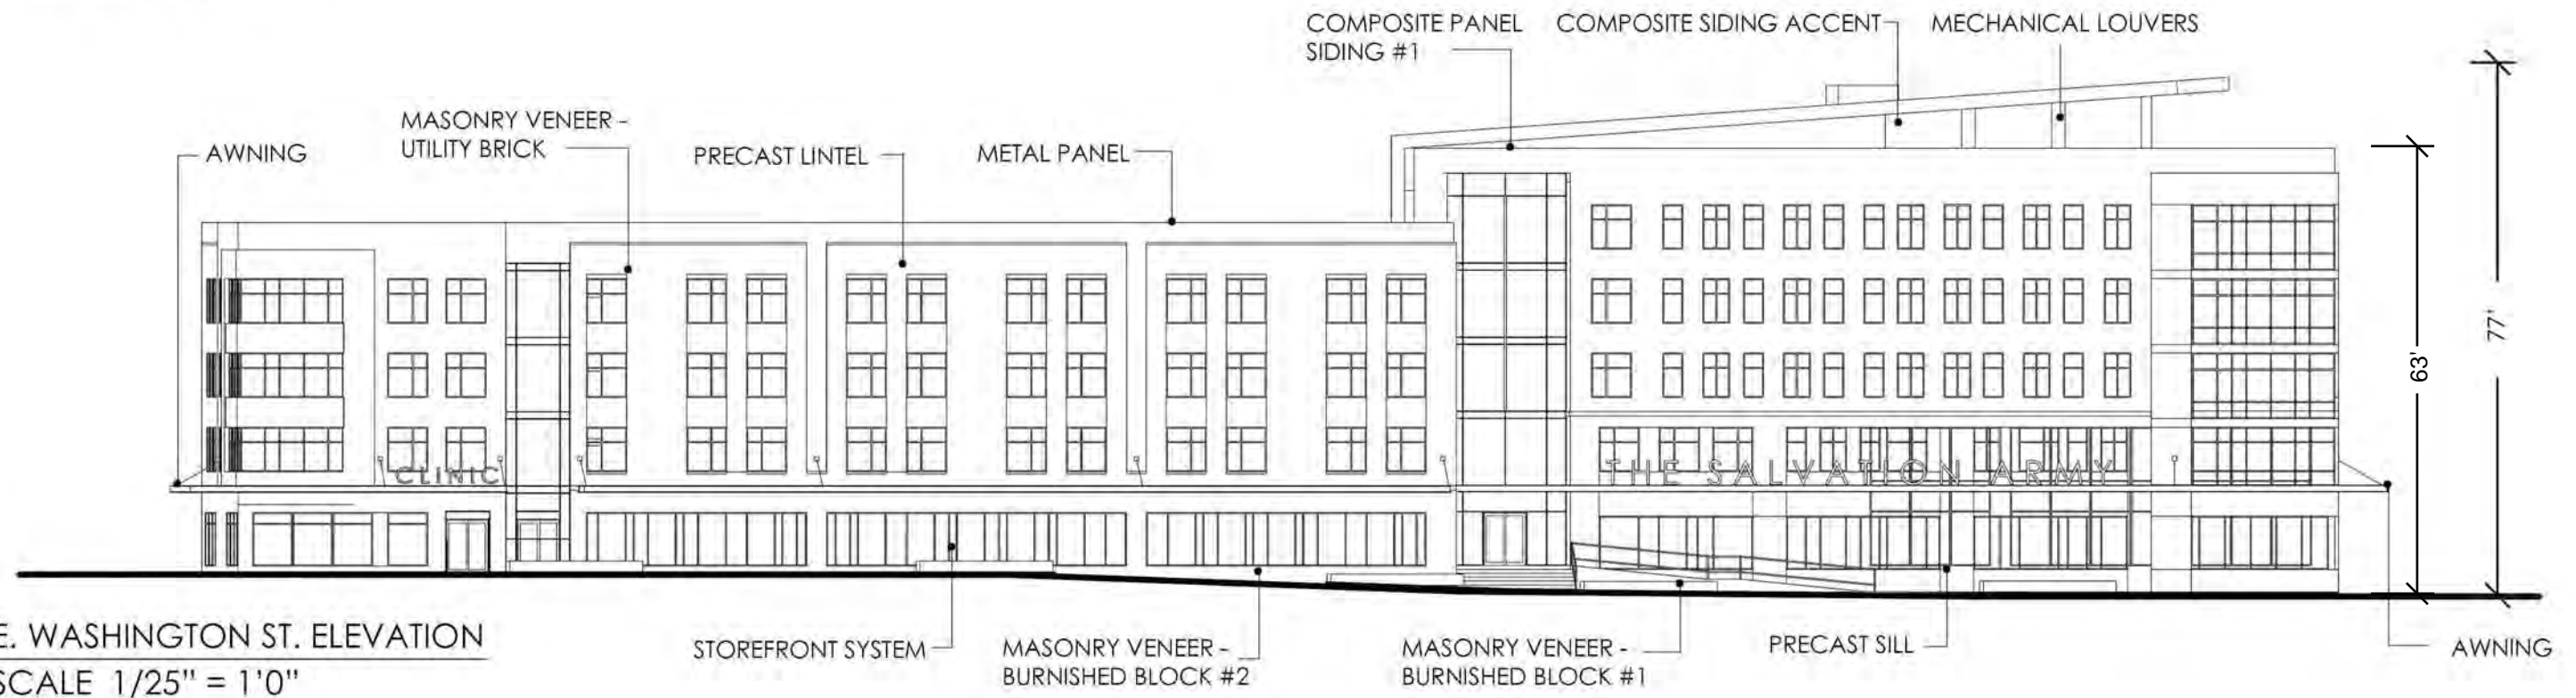


COURTYARD ELEVATION

SCALE 1/25" = 1'0"



BLOUNT ST. ELEVATION  
SCALE 1/25" = 1'0"

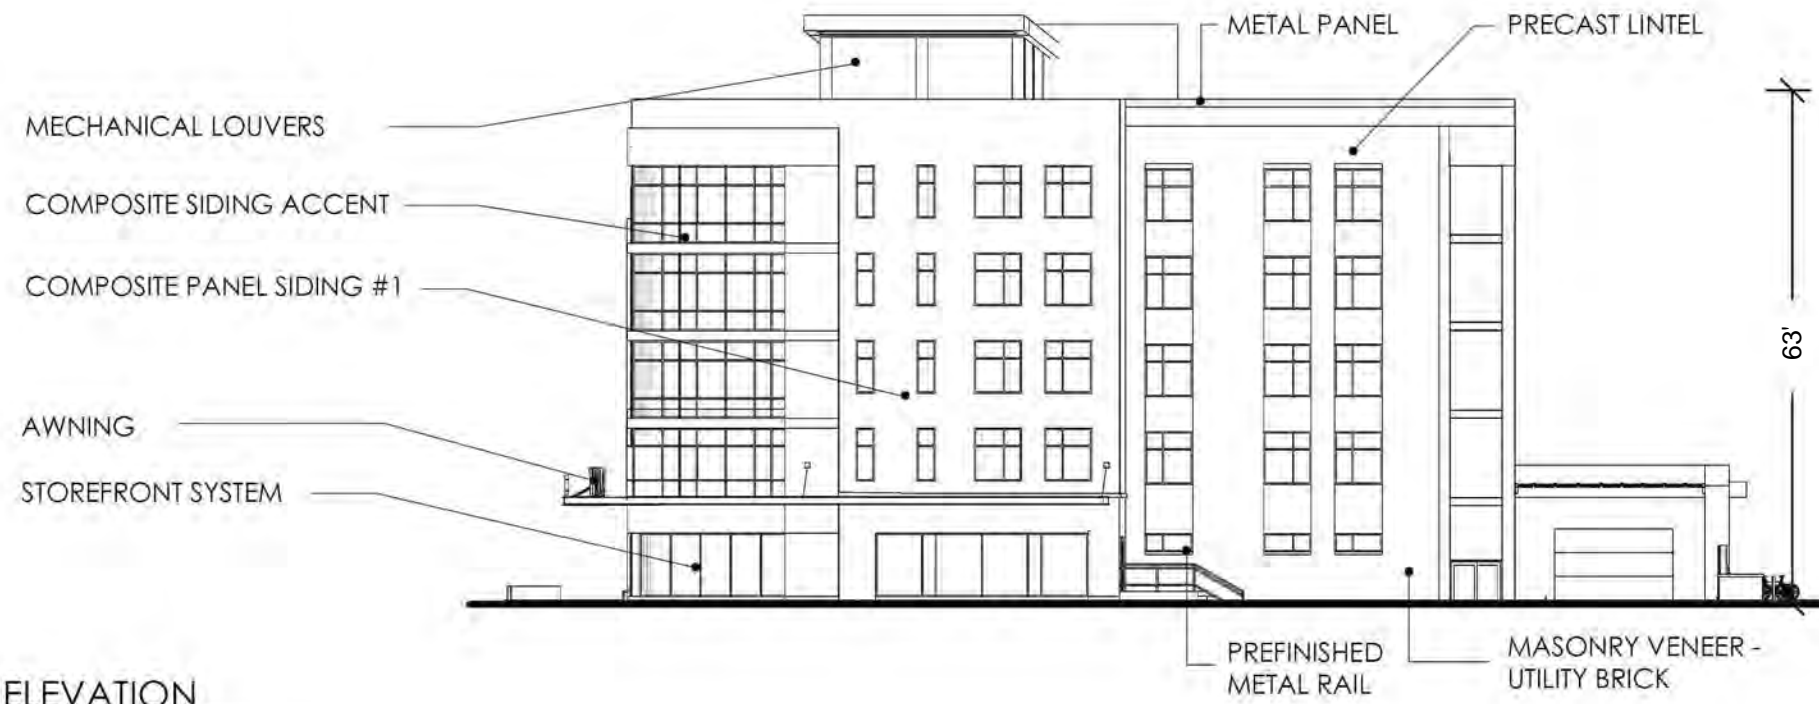

E. WASHINGTON ST. ELEVATION  
SCALE 1/25" = 1'0"



REAR ELEVATION

SCALE 1/25" = 1'0"



COURTYARD ELEVATION


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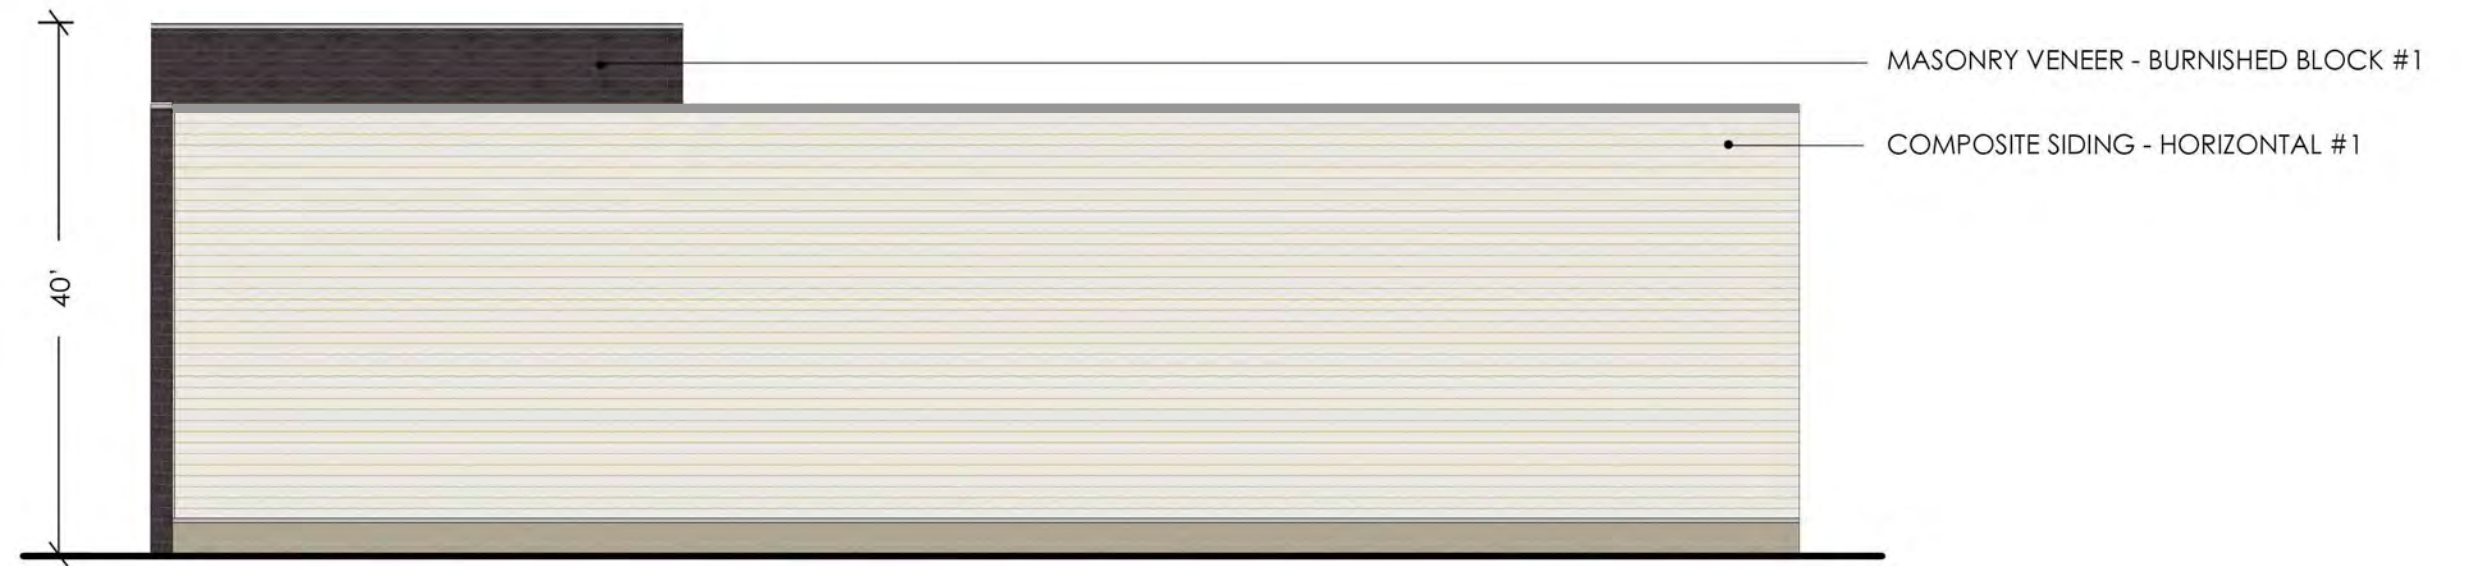
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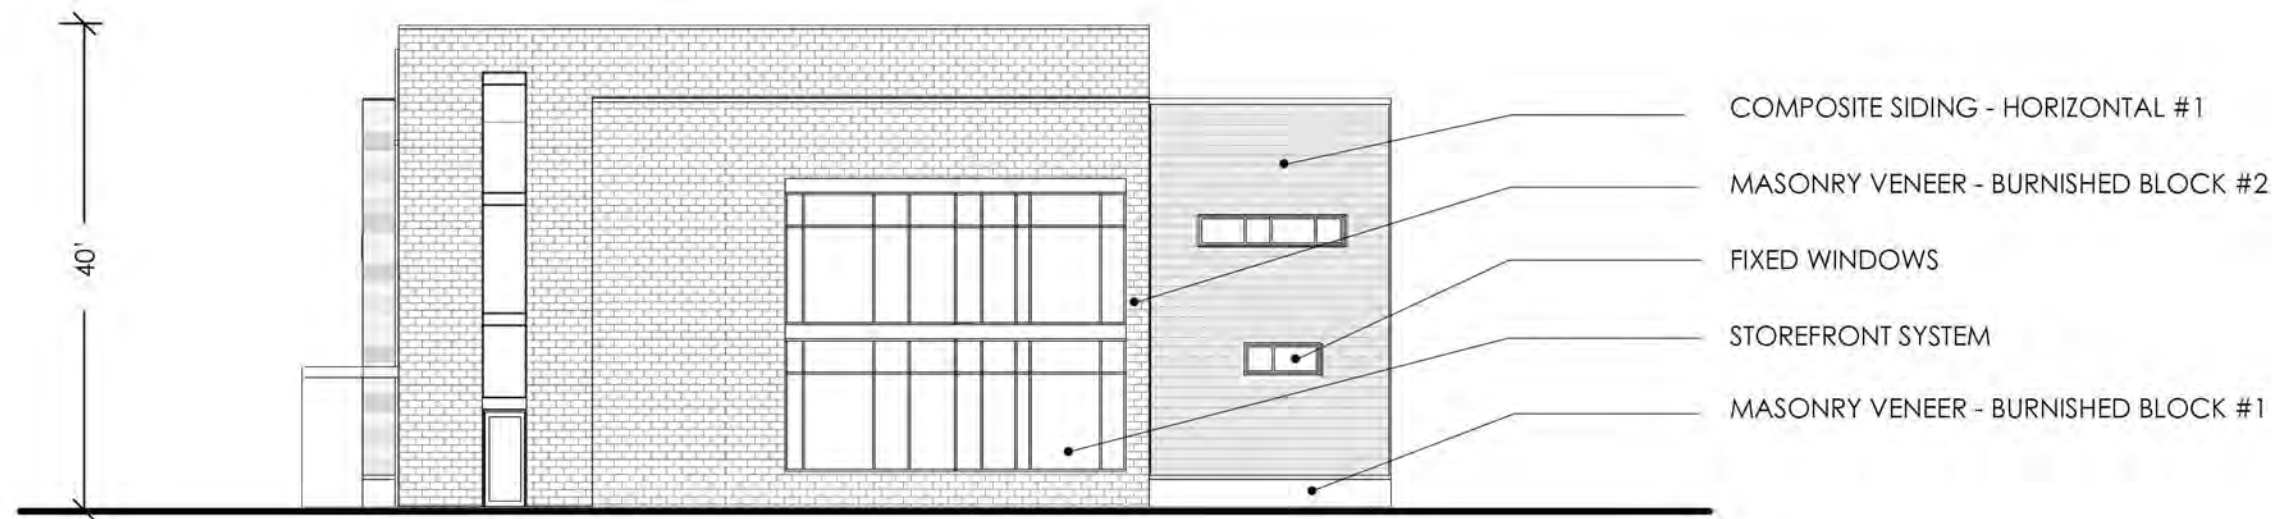
COURTYARD ELEVATION  
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SOUTH ELEVATION  
SCALE 1/16" = 1'0"



WEST ELEVATION  
SCALE 1/16" = 1'0"




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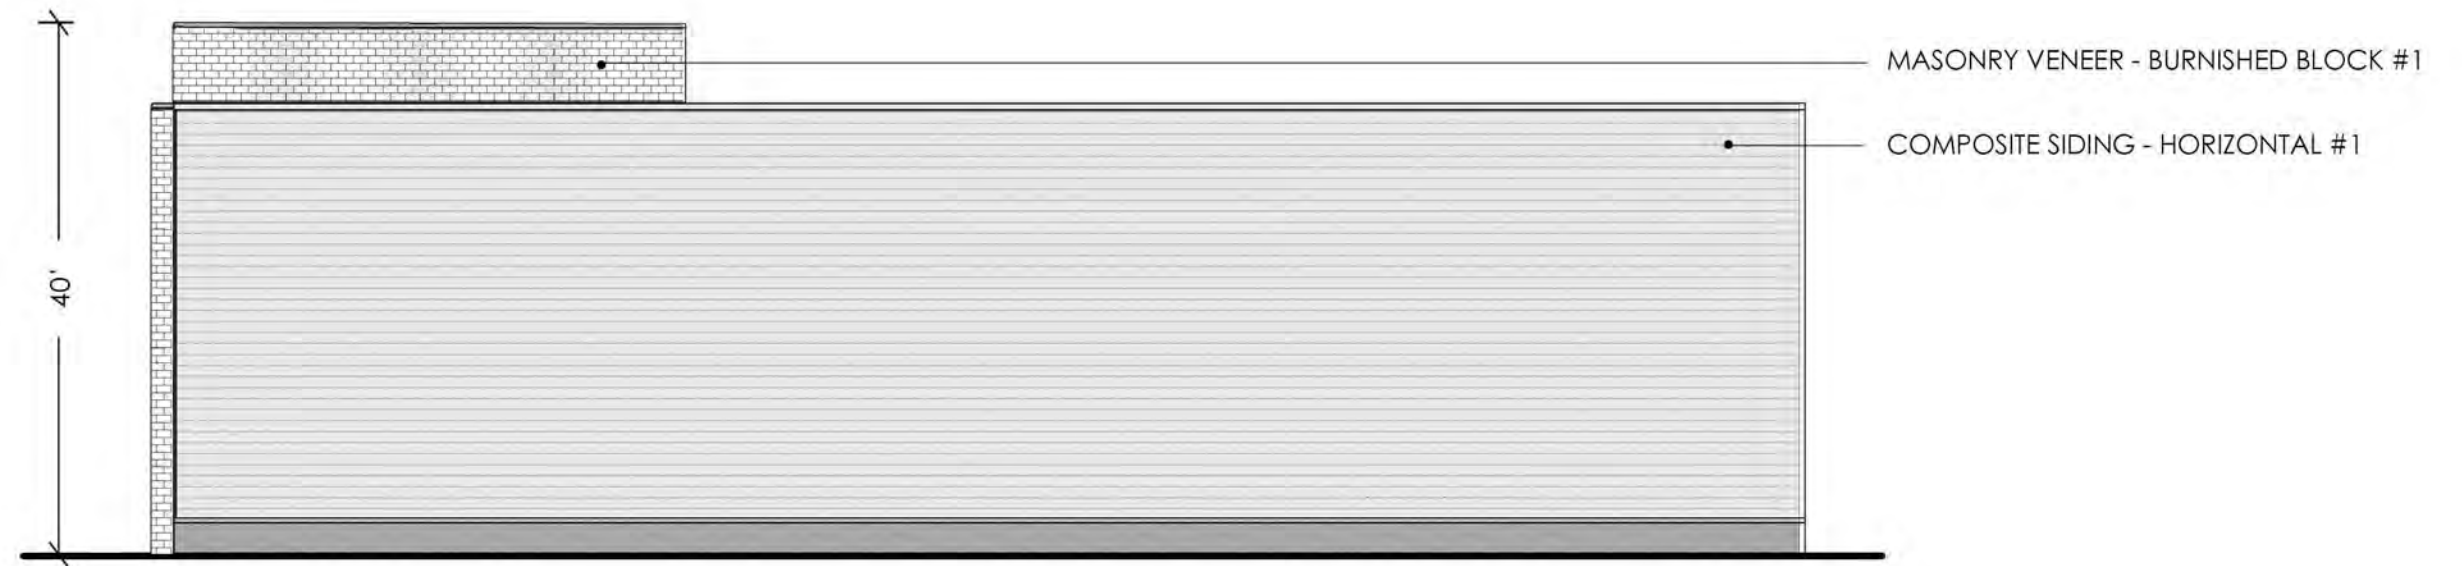

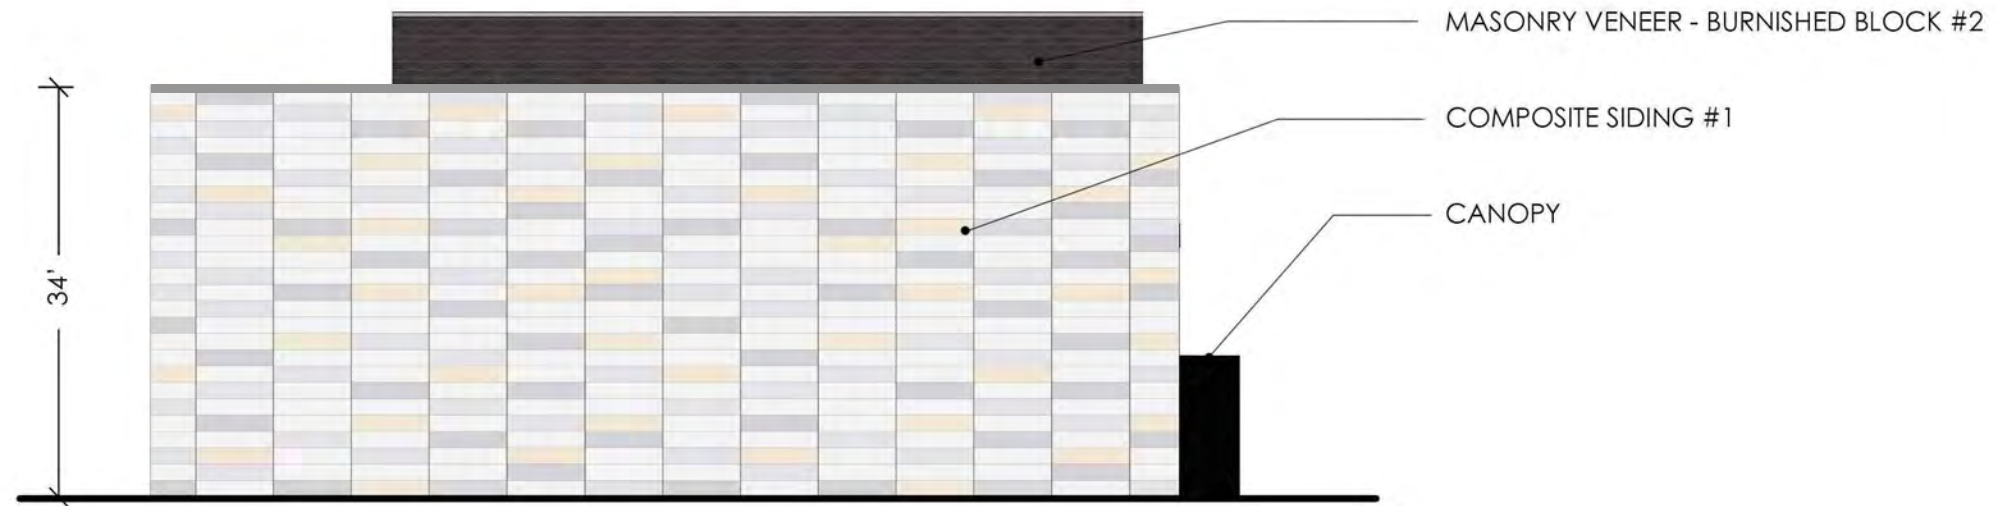
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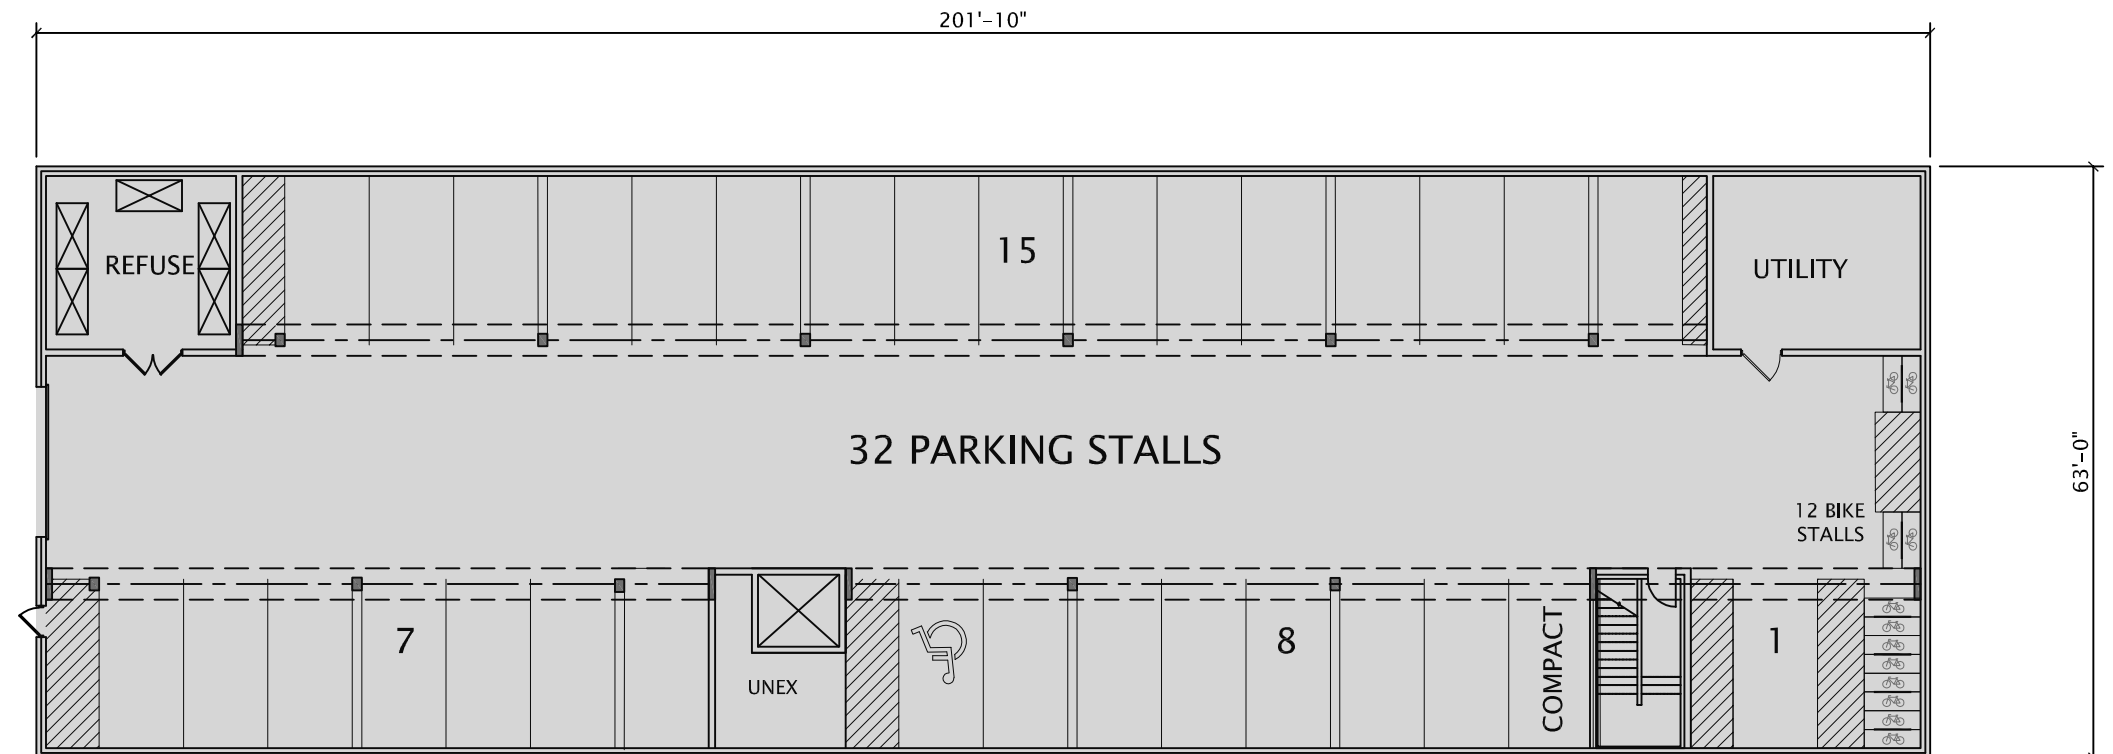




SOUTH ELEVATION  
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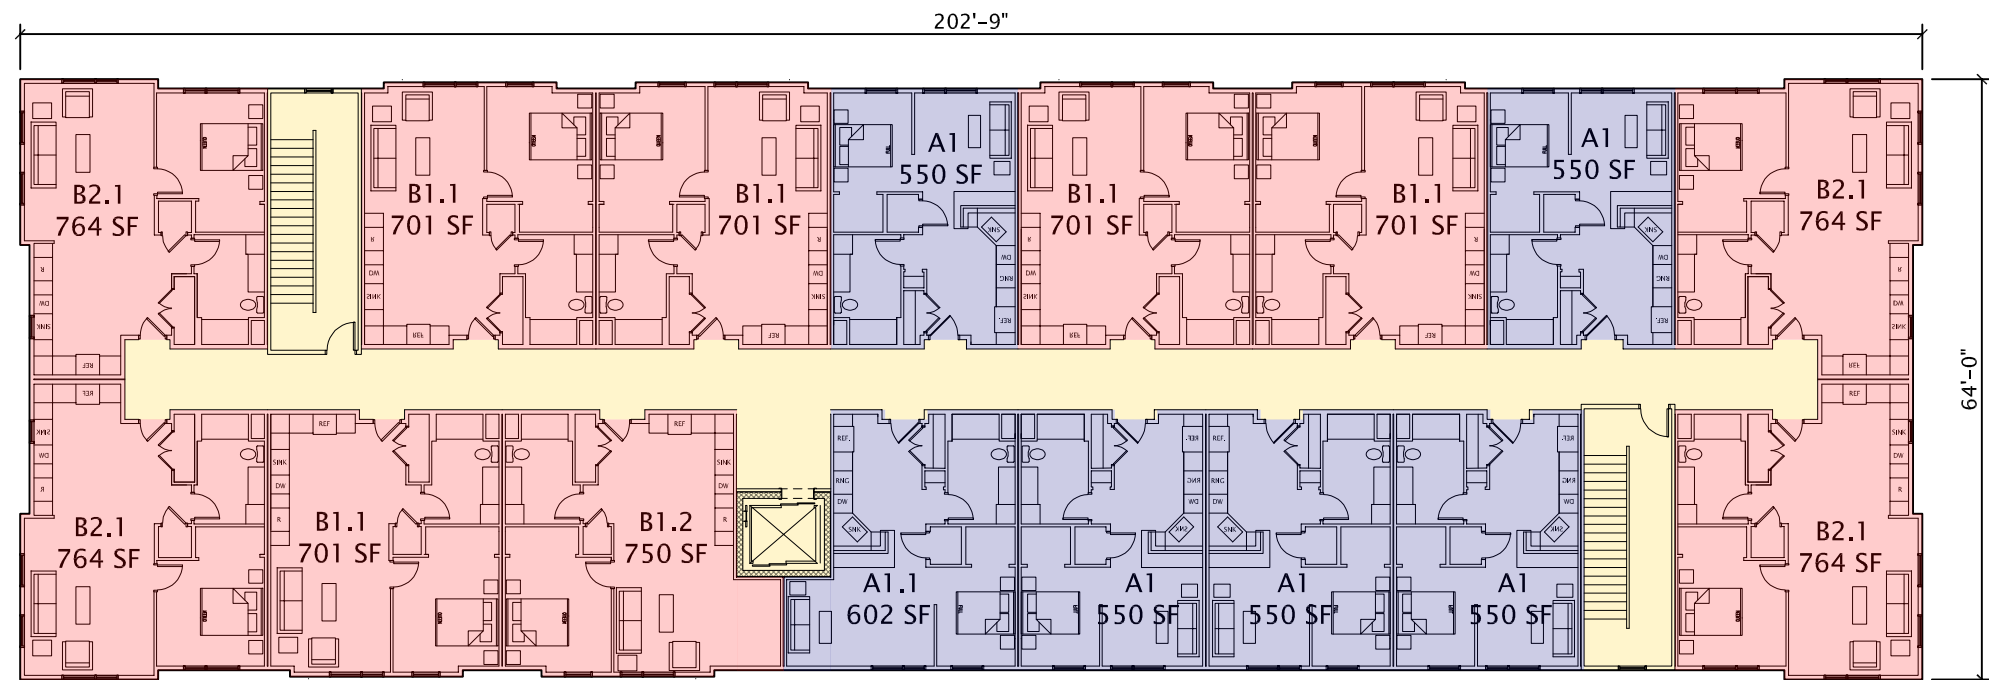

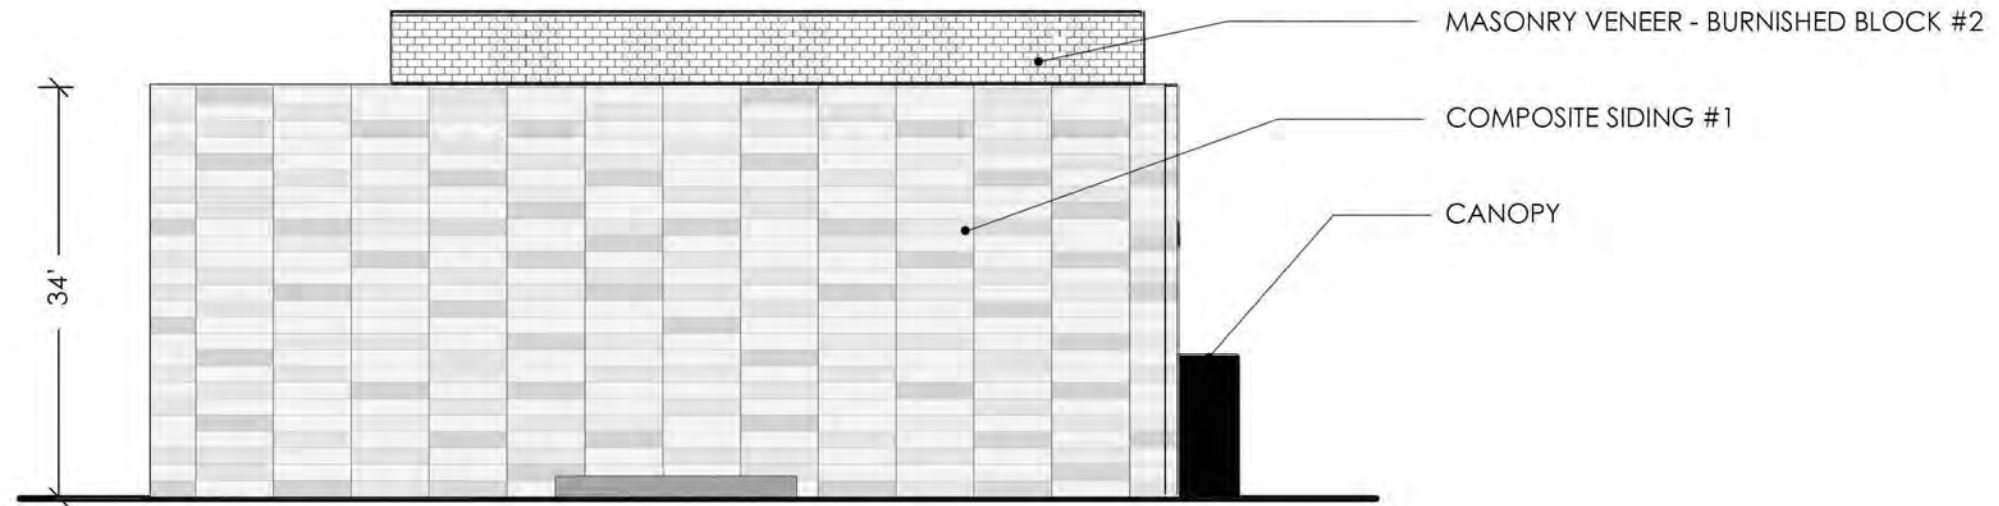
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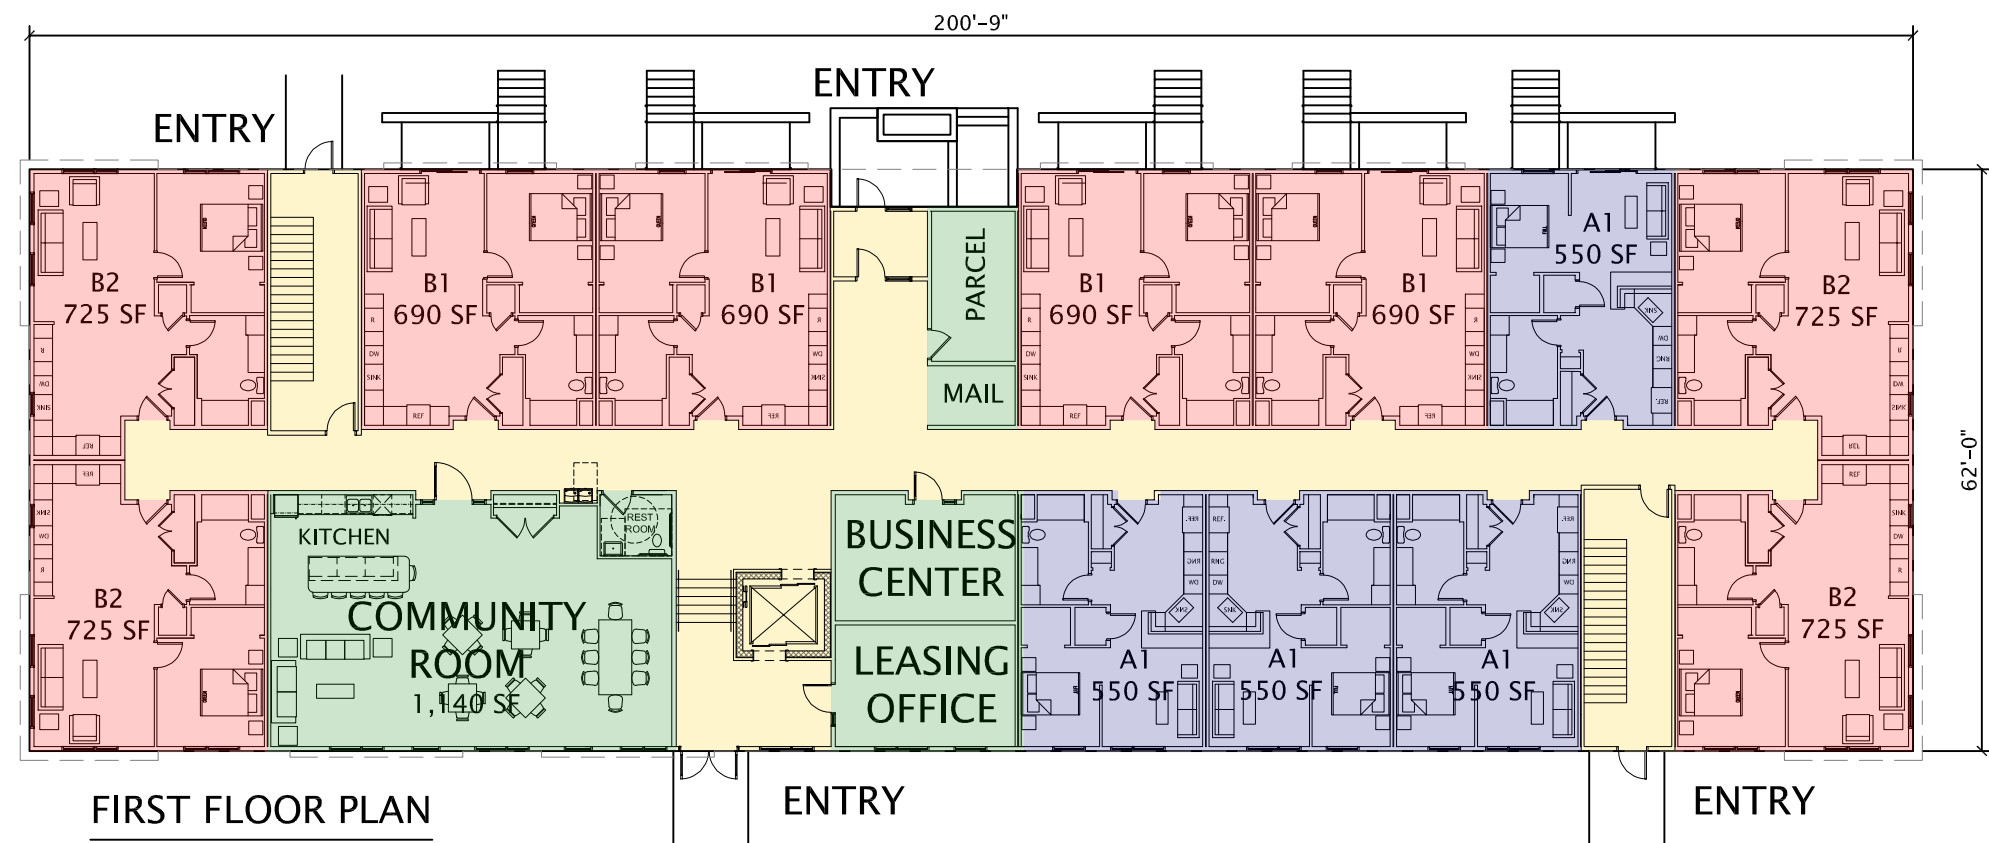
U.G. PARKING GARAGE  
12,189 s.f.





**SECOND & THIRD FLOOR PLAN**  
12,411 s.f. / floor

APARTMENT BUILDING DATA					
FLOOR	UNITS				COVERED PKG
	STUDIO	1BR	TOTAL	BR'S	
3	6	10	16	16	32
2	6	10	16	16	
1	4	8	12	12	
T.	16	28	44	44	.72 / UNIT
	39%	61%			



**FIRST FLOOR PLAN**  
12,140 s.f.





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THE SALVATION ARMY  
THE SHIELD APARTMENTS - EXTERIOR PERSPECTIVES

MARCH 1, 2022



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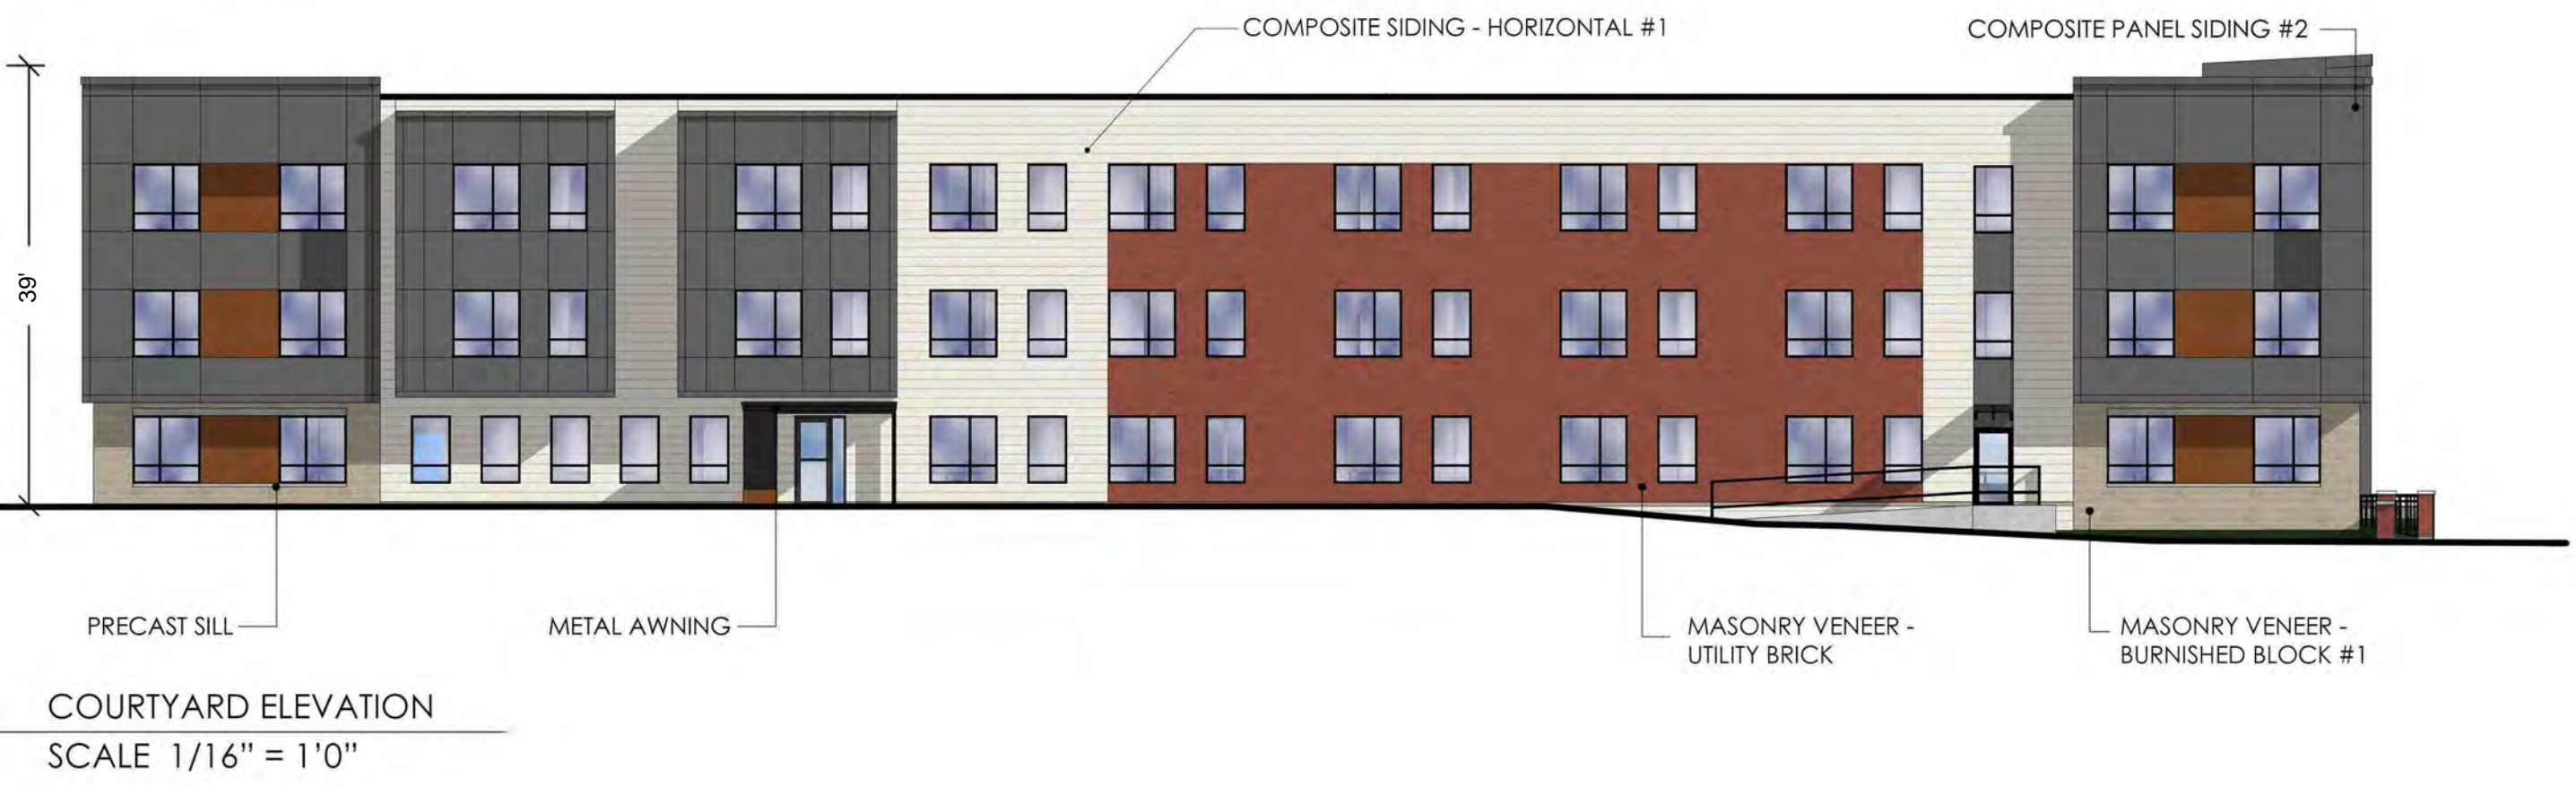



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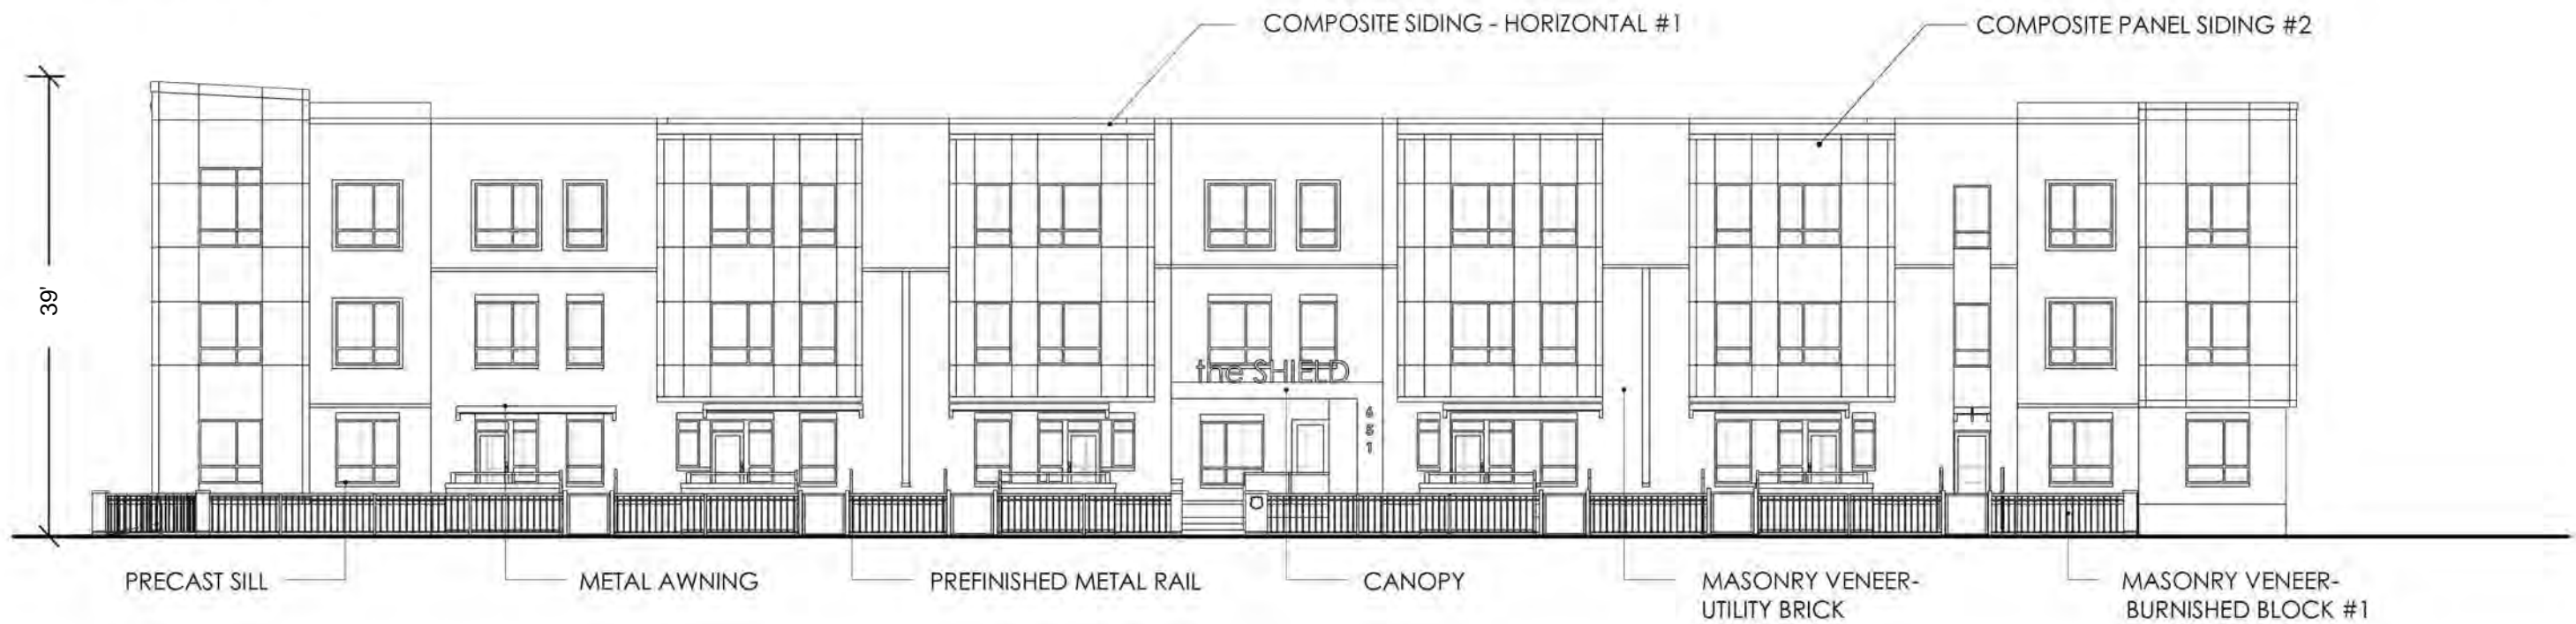
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BLOUNT ST. ELEVATION  
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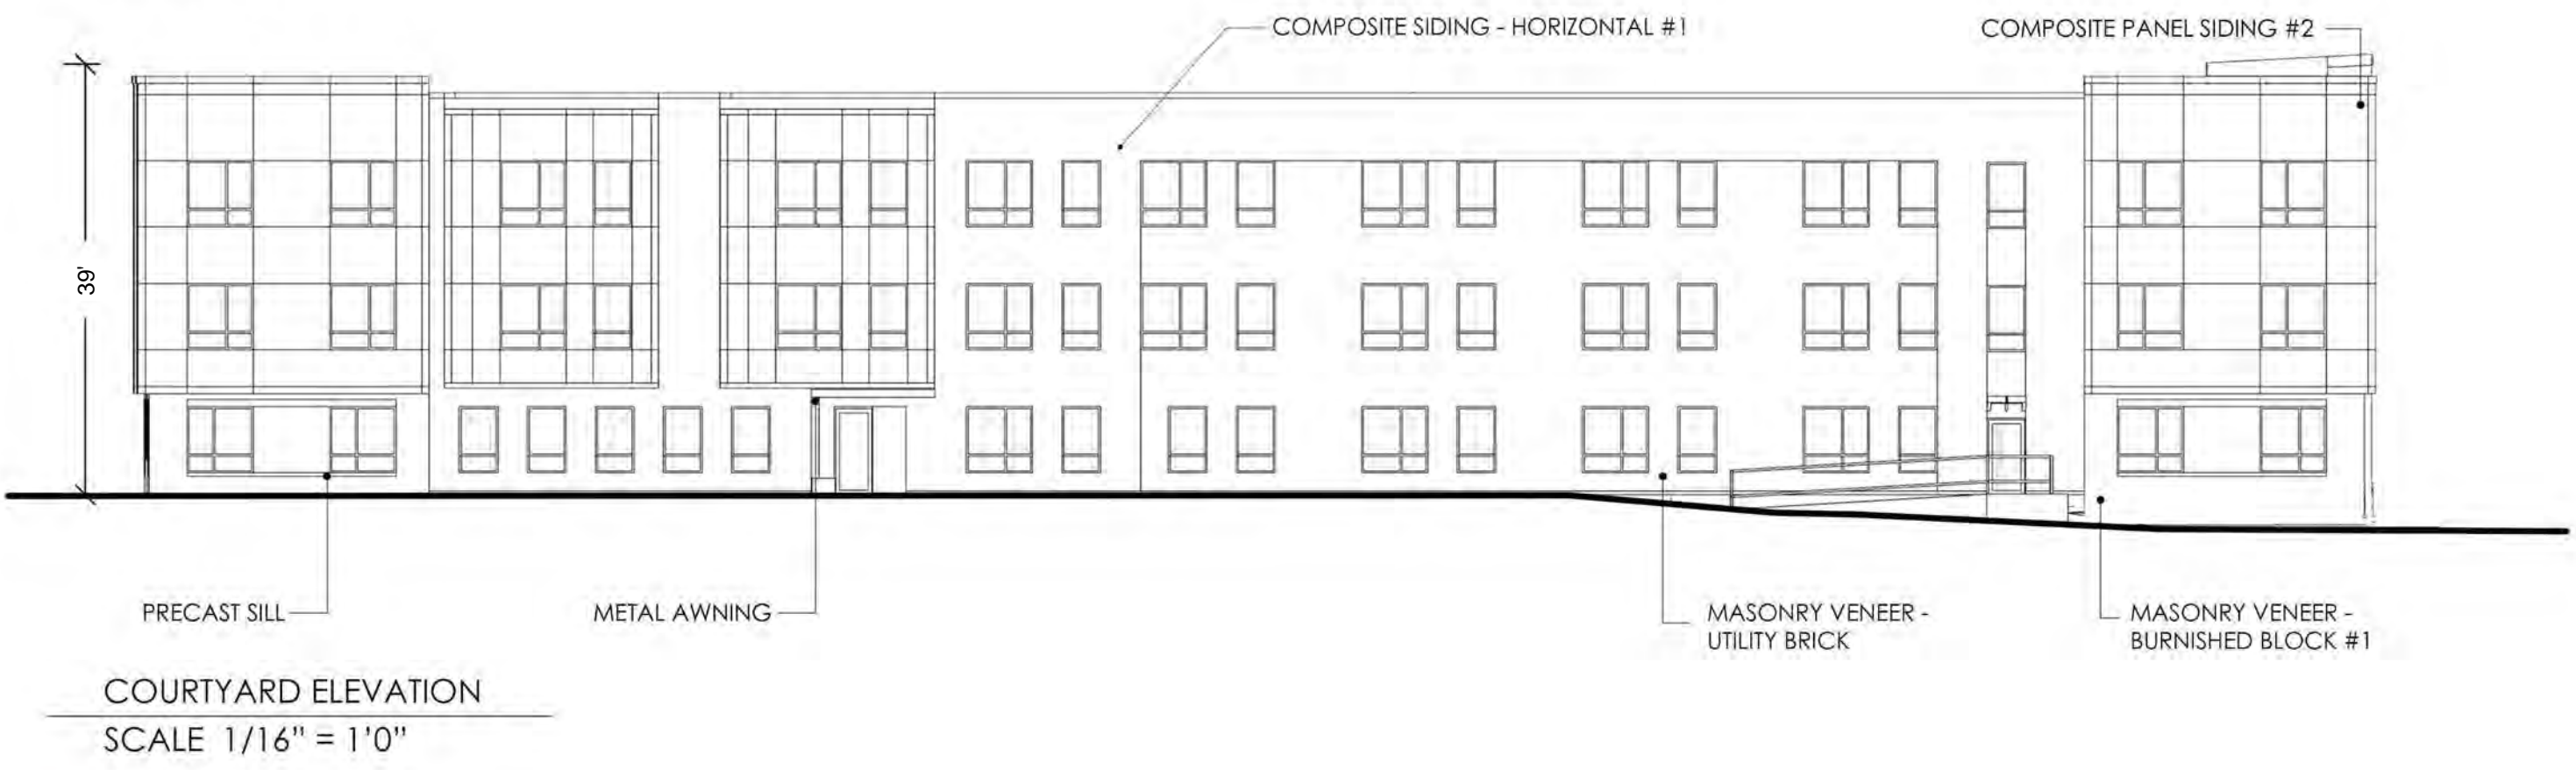
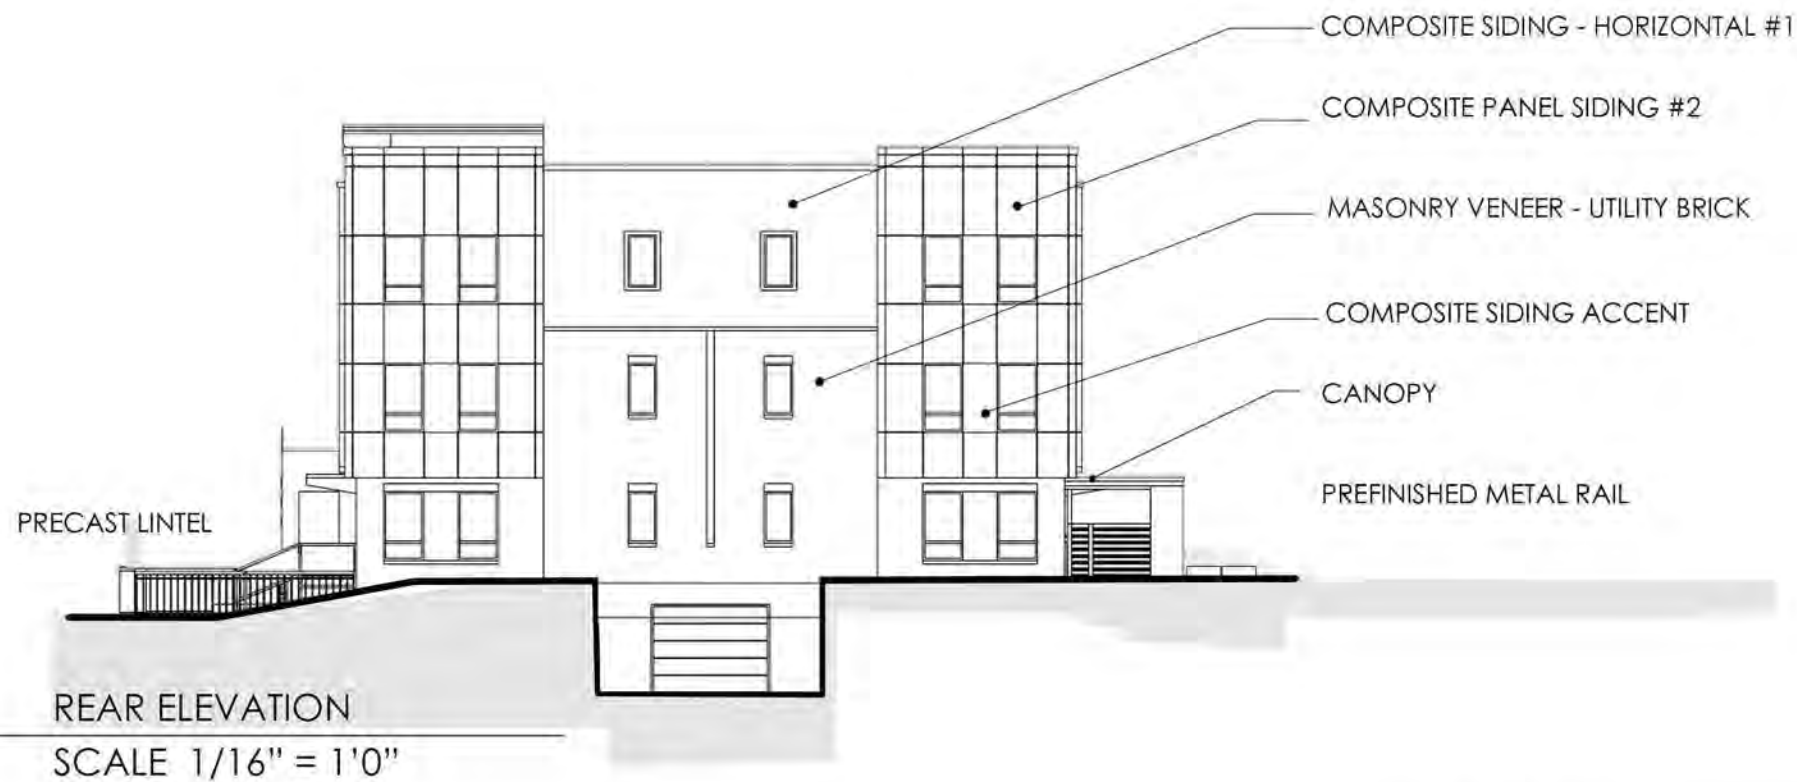



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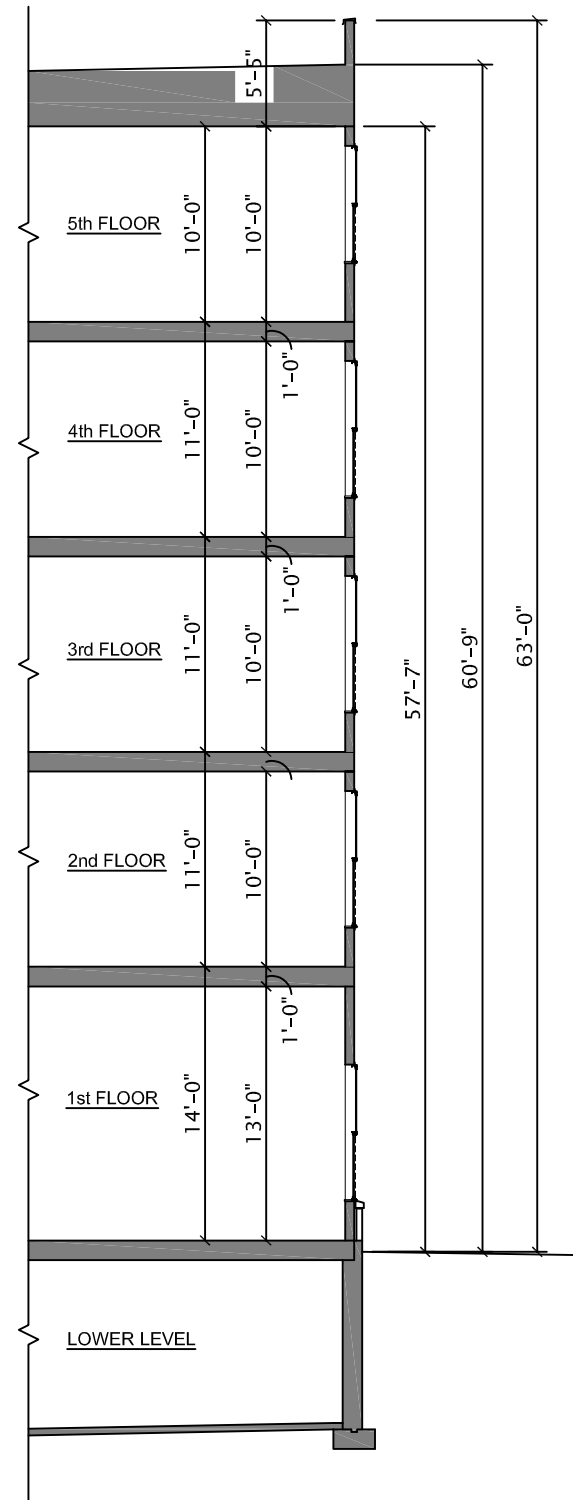
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THE SALVATION ARMY  
THE SHIELD APARTMENTS - ELEVATIONS





○ APARTMENT BUILDING SECTION

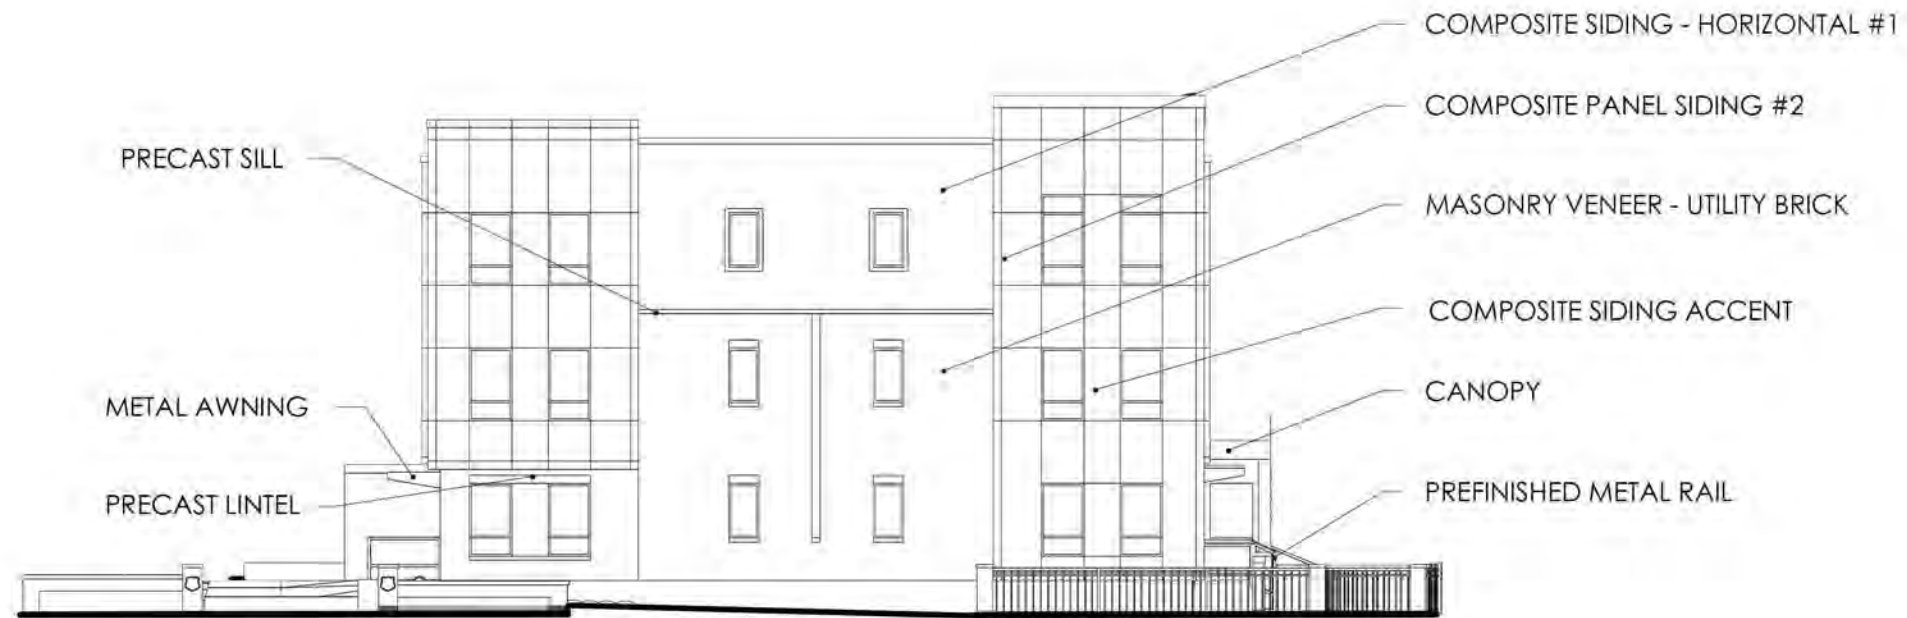

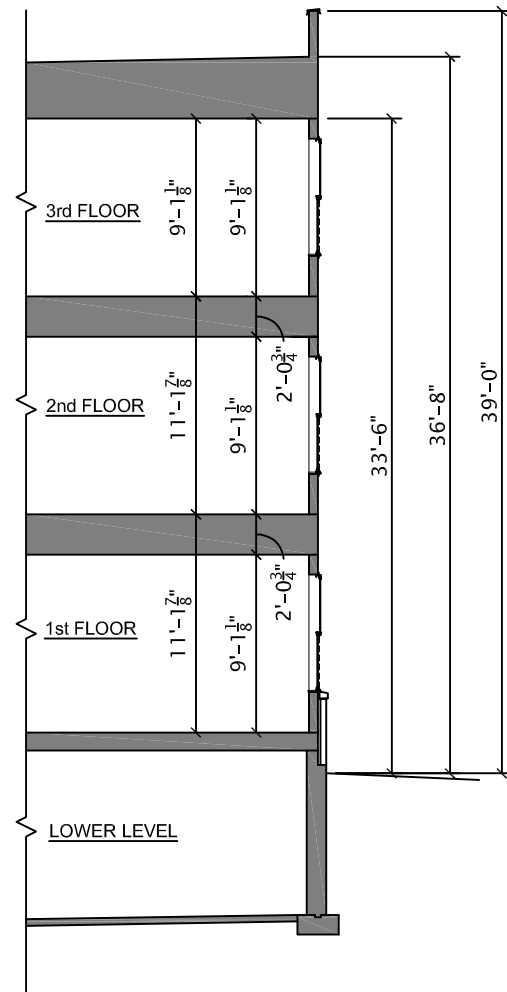○ SHELTER BUILDING SECTION





COMPOSITE PANEL SIDING #1



COMPOSITE SIDING - HORIZONTAL #1



COMPOSITE PANEL SIDING #2  
MULTI GROVE PANEL



METAL AWNING/ CANOPY



METAL AWNING/ CANOPY




MASONRY VENEER - BURNISHED BLOCK #1



MASONRY VENEER - BURNISHED BLOCK #2



PRECAST SILL / PRECAST LINTEL

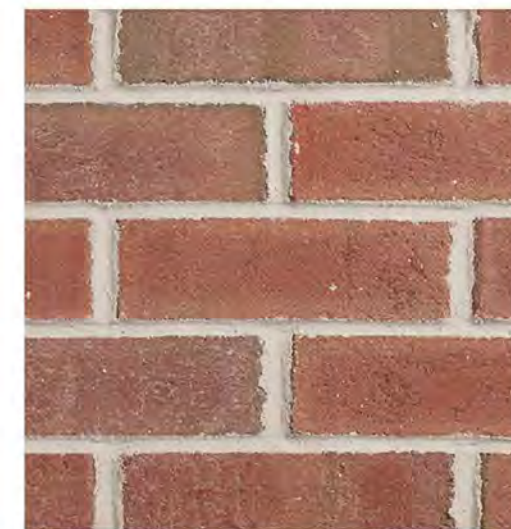

MASONRY VENEER - UTILITY BRICK



COMPOSITE SIDING ACCENT

