







#### City of Madison Forestry Requirements

- 1. An existing inventory of street trees located within the right of way shall be included on the landscape, site, grading, demo, and utility plans. The inventory shall include the following: location, size (diameter at 4 1/2 feet), and species of existing street trees. The inventory should also note if a street tree is proposed to be removed and the reason for removal.
- 2. All proposed street tree removals within the right of way shall be reviewed by City Forestry before the Plan Commission meeting. Street tree removals require approval and a tree removal permit issued by City Forestry. Any street tree removals requested after the development plan is approved by the Plan Commission or the Board of Public Works and City Forestry will require a minimum of a 72-hour review period which shall include the notification of the Alderperson within who's district is affected by the street tree removal(s) prior to a tree removal permit being issued.
- 3. As defined by the Section 107.13 of City of Madison Standard Specifications for Public Works Construction: No excavation is permitted within 5 feet of the trunk of the street tree or when cutting roots over 3 inches in diameter. If excavation is necessary, the Contractor shall contact Madison City Forestry (266-4816) prior to excavation. City of Madison Forestry personnel shall assess the impact to the tree and to its root system prior to work commencing. Tree protection specifications can be found on the following website: <a href="https://www.cityofmadison.com/business/pw/specs.cfm">https://www.cityofmadison.com/business/pw/specs.cfm</a>
- 4. Contractor shall take precautions during construction to not disfigure, scar, or impair the health of any street tree. Contractor shall operate equipment in a manner as to not damage the branches of the street tree(s). This may require using smaller equipment and loading and unloading materials in a designated space away from trees on the construction site. Any damage or injury to existing street trees (either above or below ground) shall be reported immediately to City Forestry at 266-4816. Penalties and remediation shall be required.
- 5. Section 107.13(g) of City of Madison Standard Specifications for Public Works Construction addresses soil compaction near street trees and shall be followed by Contractor. The storage of parked vehicles, construction equipment, building materials, refuse, excavated spoils or dumping of poisonous materials on or around trees and roots within five (5) feet of the tree or within the protection zone is prohibited.
- 6. On this project, street tree protection zone fencing is required. The fencing shall be erected before the demolition, grading or construction begins. The fence shall include the entire width of terrace and, extend at least 5 feet on both sides of the outside edge of the tree trunk. Do not remove the fencing to allow for deliveries or equipment access through the tree protection zone.
- 7. Street tree pruning shall be coordinated with Madison Forestry at a minimum of two weeks prior to the start of construction for this project. All pruning shall follow the American National Standards Institute (ANSI) A300 Part 1 Standards for pruning.
- 8. Additional street trees are needed for this project. Tree planting specifications can be found in section 209 of City of Madison Standard Specifications for Public Works Construction All street tree planting locations and tree species within the right of way shall be determined by City Forestry. A landscape plan (in PDF format) shall be submitted City Forestry for approval of planting locations and tree species. All available street tree planting locations shall be planted within the project boundaries. At least one week prior to street tree planting, Contractor shall contact City Forestry at (608) 266-4816 to schedule inspection and approval of nursery tree stock and review planting specifications with the landscaper.
- 9. The Developer shall post a security deposit prior to the start of the development to be collected by City Engineering. In the event that street trees are damaged during the construction process, the Developer shall reimburse the city for the loss of each street tree.
- 10. The Developer shall submit a street tree report performed by a certified arborist as part of the LAND USE APPLICATION for Forestry's review of the project. This report shall identify all trees within the right of way on proposed project for species type, canopy spread, tree condition, proposed tree to remain or remove, the impacts of proposed building and any pruning.



Wood Privacy Fence (Board on Board Style 6' Height)

### GENERAL NOTES

A) Areas labeled "Brown Wood Mulch" to receive a mixture of recycled wood mulch, colored brown, spread to a 3" depth over pre-emergent herbicide.

B) Individual trees (and shrub groupings) found along perimeter of property as well as those found within lawn areas to receive wood mulch rings (and wood mulch beds) consisting of a mixture of recycled wood mulch, colored brown, spread to a minimum 3" depth (3' wide beds for shrub groupings).

C) "Vinyl Edging" to be Valley View Black Diamond Vinyl Edging or equivalent.

D) Areas labeled "washed stone" to receive I-I/2" washed stone spread to a 3" depth over fabric weed barrier.

E) "Seed" areas shall be finish-graded and seeded at a rate of 4 lbs. per 1,000 sq. ft.

F) Seed shall consist of the following mixture: 10% Palmer IV Perennial Ryegrass

20% Dragon Kentucky Bluegrass 20% Diva Kentucky Bluegrass

20% Foxy II Creeping Red Fescue


15% Vail II Perennial Ryegrass15% Ginney Kentucky Bluegrass

G) Areas labeled "Seed/Mat" shall be seeded with the above-noted premium lawn seed mixture and overlaid with DS75 straw erosion control netting that is then pegged into the soil with metal staples.

H) Areas labeled "Sod" shall receive only No. I grade nursery-grown bluegrass sod.

I) Plant beds adjacent to building foundation to be mulched with I-I/2" diameter washed stone mulch spread to a 3" depth over fabric weed barrier.

Plant Material List \*

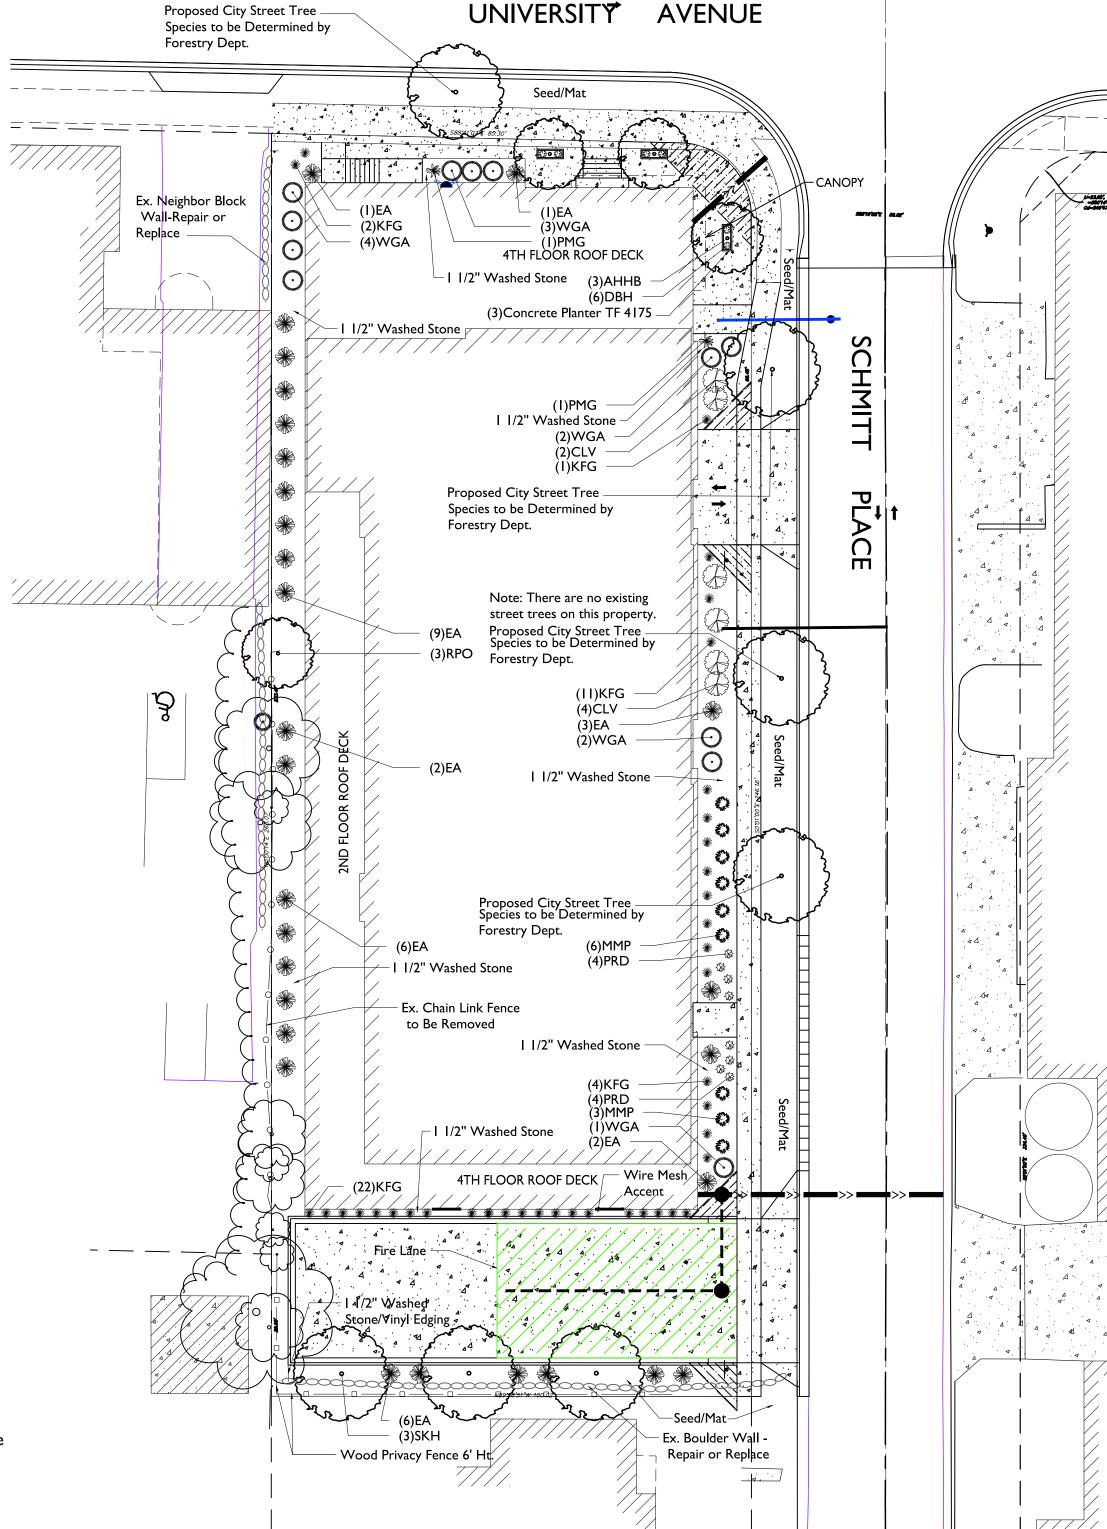

# Product Information Planter TF 4175



Size: 72"L x 30"W x 30"H

Weight: 1,900 Lbs.

Material: Reinforced concrete

Reinforcing: 3/8" Dia. steel rebar

Drain Hole: (1) 2" Dia. drain hole

Hardware: (4) 5/8" Dia. lifting inserts

**Note:**Lifting inserts are to ONLY be used when planter is EMPTY

**Accepts Reservoir System** 

Finish Options

Standard
-Exposed Aggregate
-Weatherstone

## Broadleaf Deciduous

CLV

| Quantity      | Code Name | Common Name                        | Scientific Name                          | Planting Size |
|---------------|-----------|------------------------------------|--|---------------|
| 3             | SKH       | Street Keeper Honeylocust          | Gleditsia Triacan 'draves'               | 2" B&B        |
| 3             | АННВ      | Amer Hophornbeam                   | Ostrya Virginiana                        | 2" B&B        |
| 4             | RPO       | Regal Prince English Oak           | Quercus Robur 'long'                     | 2 I/2" B&B    |
| Conifer Everg | green     |                                    |  |               |
| Quantity      | Code Name | Common Name                        | Scientific Name                          | Planting Size |
| 9             | MMP       | Mops Mugo Pine                     | Pinus Mugo 'mops'                        | #3 CONT.      |
| 29            | EA        | Emerald Arborvitae                 | Thuja Occidentalis 'smaragd'             | 5' B&B        |
| 12            | WGA       | Woodward Globe Arborvitae          | Thuja Occidentalis 'woodwardii'          | #5 CONT.      |
| Perennial     |           |                                    |  |               |
| Quantity      | Code Name | Common Name                        | Scientific Name                          | Planting Size |
| 40            | KFG       | Karl Foerster's Feather Reed Grass | Calamagrostis Acutiflora 'karl Foerster' | #I CONT.      |
| 2             | PMG       | Purple Maiden Grass                | Miscanthus Sinensis Var Purpurescens     | #I CONT.      |
| 8             | PRD       | Prairie Dropseed                   | Sporobolus Heterolepis                   | #I CONT.      |
| Shrub         |           |                                    |  |               |
| Quantity      | Code Name | Common Name                        | Scientific Name                          | Planting Size |
| 6             | DBH       | Dwf Bush-Honeysuckle               | Diervilla Lonicera                       | #5 CONT.      |
| •             |           |                                    | \/(I)   D                                | 41.000        |

RICHARD J.
STROHMENGER LA85
OREGON,
WI
JAPE ARCHITICAL
MINIMALINA

SCALE: I"=20'-0"

L-1.1

LANDSCAPE CONTRACTOR
2830 PARMENTER STREET
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FAX (608) 831-6266

**PMENT** 

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Checked By: SS

Revised:

Revised:

Revised: Revised:

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Revised: Revised:

Drawn By: I-10-22 RS

Revised: I-12-22 RS Revised: 2-03-22 RS

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\*NOTE: Street Trees are Not Included in above List

Viburnum Dentatum 'synnestvedt'

4' B&B

Chicago Lustre Arwd Viburnum

PO Box 1520, Wausau, WI 54402-1520
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A WAUSAU TILE INC. BRAND

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KEY PLAN

Issued for LUA & UDC Submittal - Jan. 10, 2022

PROJECT TITLE SMOKY'S CLUB REDEVELOPMENT

3005 University Ave Madison, Wisconsin SHEET TITLE **ELEVATIONS** COLORED

SHEET NUMBER

A-2.3

|   | PARAPET 158'-11 5/8"  |
|---|---|
| COMPOSITE TRIM ALUMINIUM RAILINGS                       | ROOF TRUSS BEARING 155'-0 3/4"  |
| (#1) COMPOSITE LAP SIDING (#2) COMPOSITE PANEL          | FIFTH FLOOR 146'-11 5/8"  |
| COMPOSITE WINDOWS COMPOSITE WINDOWS                     | FOURTH FLOOR 135'-3 3/4"  |
| BRICK VENEER BRICK VENEER                               | (#2) COMPOSITE PANEL SIDING  METAL PANEL SIDING  THIRD FLOOR  124'-1 7/8" |
| BRICK SOLDIER COURSING  DECORATIVE METAL SCREEN ELEMENT |   |
| CAST STONE BANDS/SILLS CAST STONE                       | SIGNAGE 113'-0"   |
|   | FIRST FLOOR 100'-0"   |
|   | BA <u>SEMENT</u><br>90'-8"  |

1 COLORED ELEVATION - EAST 1/8" = 1'-0"

A-2.3 1/8" = 1'-0"

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JOKI H

KEY PLAN

Issued for LUA & UDC Submittal - Jan. 10, 2022

PROJECT TITLE
SMOKY'S CLUB
REDEVELOPMENT

3005 University Ave
Madison, Wisconsin
SHEET TITLE
ELEVATIONS
COLORED

SHEET NUMBER

A-2.4

PROJECT NUMBER 1838

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|  |  |  | PARAPET  |
|--|--|--|--|
|  |  |  | PARAPET 158'-11 5/8"   |
|  |  |  | ROOF TRUSS BEARING 155'-0 3/4"   |
| COMPOSITE TRIM                                   |  |  |  |
| ALUMINIUM RAILINGS                               |  |  |  |
|  |  |  | FIFTH FLOOR 146'-11 5/8"   |
|  |  |  |  |
| (#1) COMPOSITE LAP SIDING                        |  |  |  |
| COMPOSITE WINDOWS                                |  |  |  |
|  |  |  | FOURTH FLOOR 135'-3 3/4"   |
| (#2) COMPOSITE PANEL                             |  |  | 135-3 3/4"   |
| SIDING   | A SECTION AND ADDRESS OF THE PROPERTY OF THE P |  |  |
|  |  |  | The state of the s |
| BRICK VENEER                                     |  |  | THIRD FLOOR 124'-1 7/8"  |
| BRICK SOLDIER COURSING                           |  |  |  |
|  | # 1  |  |  |
|  |  |  |  |
|  |  |  | SECOND FLOOR 113'-0"   |
| CAST STONE BANDS/SILLS                           |  | The second secon | 113'-0"  |
| CAST STONE CAST STONE                            |  |  |  |
|  |  |  |  |
|  |  |  |  |
|  |  |  | FIRST FLOOR 100'-0"  |
|  |  |  |  |
|  |  |  |  |
|  |  |  | BASEMENT 90'-8"  |
| COLORED ELEVATION MEST                           |  |  | 90'-8"   |
| 2 COLORED ELEVATION - WEST<br>A-2.4 1/8" = 1'-0" |  |  |  |
|  |  |  |  |





















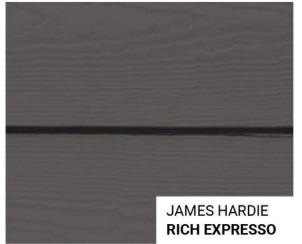

#1 - COMPOSITE LAP SIDING

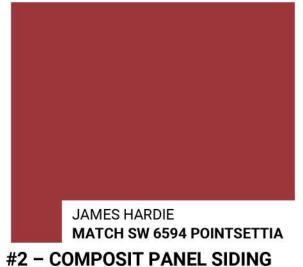



#5 - BRICK VENEER





#8 - COMPOSIT WINDOWS



| EXT                             | TERIOR MATERIAL SCHEDULE |                                 |  |
|---------------------------------|--------------------------|---------------------------------|--|
| BUILDING ELEMENT                | MANUFACTURER             | COLOR                           |  |
| (#1) - COMPOSITE LAP SIDING     | JAMES HARDIE             | RICH ESPRESSO                   |  |
| (#2) - COMPOSITE PANEL SIDING   | JAMES HARDIE             | MATCH SW 6594 POINTSETTIA       |  |
| METAL PANEL SIDING              | TBD                      | WHITE                           |  |
| COMPOSITE TRIM                  | JAMES HARDIE             | MATCH ADJ. SIDING COLOR         |  |
| (#5) - BRICK VENEER             | SIOUX CITY BRICK         | STONINGTON GRAY VELOUR          |  |
| (#6) - MASONRY BASE VENEER      | PRAIRIE STONE            | GRIS                            |  |
| (#7) - CAST STONE BANDS & SILLS | EDWARDS CAST STONE       | MATCH PRAIRE STONE GRIS         |  |
| (#8) - COMPOSITE WINDOWS        | ANDERSEN 100             | BLACK                           |  |
| (#9) - ALUM. STOREFRONT         | N/A                      | BLACK                           |  |
| CANOPY & BAY SOFFITS            | JAMES HARDIE             | COLOR TO MATCH ADJ. TRIM/SIDING |  |
| (#12) - RAILINGS & HANDRAILS    | SUPERIOR                 | BLACK                           |  |
| TREATED-EXPOSED DECK BEAMS      | N/A                      | BROWN TREATED                   |  |
|                                 |                          |                                 |  |

# 3005 UNIVERSITY AVE REDEVELOPMENT

knothe bruce

3005 UNIVERSITY MADISON, WI 01/19/2022 KBA #1838