

City of Madison Fire Department

314 W Dayton Street, Madison, WI 53703-2506

Phone: 608-266-4420 • Fax: 608-267-1100 • E-mail: fire@cityofmadison.com


Project Address:	2902 Dryden Drive		
Contact Name & Pl	none #:	Kevin Burow, 608-836-3690	

FIRE APPARATUS ACCESS AND FIRE HYDRANT WORKSHEET

1. Is the building completely protected by an NFPA 13 or 13R automatic fire sprinkler system? If non-sprinklered, fire lanes extend to within 150-feet of all portions of the exterior wall? If sprinklered, fire lanes are within 250-feet of all portions of the exterior wall?	X Yes Yes X Yes	☐ No ☐ No ☐ No	N/AN/AN/A
 2. Is the fire lane constructed of concrete or asphalt, designed to support a minimum load of 85,000 lbs? a) Is the fire lane a minimum unobstructed width of at least 20-feet? b) Is the fire lane unobstructed with a vertical clearance of at least 13½-feet? c) Is the minimum inside turning radius of the fire lane at least 28-feet? d) Is the grade of the fire lane not more than a slope of 8%? e) Is the fire lane posted as fire lane? (Provide detail of signage.) f) Is a roll-able curb used as part of the fire lane? (Provide detail of curb.) g) Is part of a sidewalk used as part of the required fire lane? (Must support +85,000 lbs.) 	X Yes X Yes X Yes X Yes X Yes Yes Yes Yes Yes Yes Yes Yes Yes	☐ No	 N/A N/A N/A N/A N/A N/A N/A N/A N/A
3. Is the fire lane obstructed by security gates or barricades? If yes:a) Is the gate a minimum of 20-feet clear opening?b) Is an approved means of emergency operations installed, key vault, padlock or key switch?	☐ Yes ☐ Yes ☐ Yes	No No No	N/A N/A N/A N/A
4. Is the Fire lane dead-ended with a length greater than 150-feet? If yes, does the area for turning around fire apparatus comply with IFC D103?	☐ Yes ☐ Yes	X No No	□ N/A ▼ N/A
5. Is any portion of the building to be used for high-piled storage in accordance with IFC Chapter 3206.6 If yes, see IFC 3206.6 for further requirements.	Yes	X No	□ N/A
6. Is any part of the building greater than 30-feet above the grade plane?	X Yes	☐ No	□ N/A
If yes, answer the following questions: a) Is the aerial apparatus fire lane parallel to one entire side of the building and covering at least 25% of the perimeter? b) Is the near edge of the aerial apparatus fire lane between 15' and 30' from the building? c) Are there any overhead power or utility lines located across the aerial apparatus fire lane? d) Are there any tree canopies expected to grow across the aerial fire lane? (Based on mature	 X Yes X Yes X Yes Yes Yes 	No No No No No No No	 N/A N/A N/A N/A N/A
If yes, answer the following questions: a) Is the aerial apparatus fire lane parallel to one entire side of the building and covering at least 25% of the perimeter? b) Is the near edge of the aerial apparatus fire lane between 15' and 30' from the building? c) Are there any overhead power or utility lines located across the aerial apparatus fire lane?	X Yes X Yes Yes	☐ No ☐ No ☒ No	□ N/A □ N/A □ N/A
If yes, answer the following questions: a) Is the aerial apparatus fire lane parallel to one entire side of the building and covering at least 25% of the perimeter? b) Is the near edge of the aerial apparatus fire lane between 15' and 30' from the building? c) Are there any overhead power or utility lines located across the aerial apparatus fire lane? d) Are there any tree canopies expected to grow across the aerial fire lane? (Based on mature canopy width of tree species) e) Does the aerial apparatus fire lane have a minimum unobstructed width of 26-feet?	X Yes X Yes Yes Yes Yes X Yes	NoNoNoNoNoNo	 N/A N/A N/A N/A N/A
If yes, answer the following questions: a) Is the aerial apparatus fire lane parallel to one entire side of the building and covering at least 25% of the perimeter? b) Is the near edge of the aerial apparatus fire lane between 15' and 30' from the building? c) Are there any overhead power or utility lines located across the aerial apparatus fire lane? d) Are there any tree canopies expected to grow across the aerial fire lane? (Based on mature canopy width of tree species) e) Does the aerial apparatus fire lane have a minimum unobstructed width of 26-feet? f) Is the space between the aerial lane and the building free of trees exceeding 20' in heights?	 X Yes X Yes Yes Yes X Yes X Yes 	 No No No No No No No No 	 N/A N/A N/A N/A N/A N/A N/A


Attach an additional sheet if further explanation is required for any answers.

This worksheet is based on MGO 34.503 and IFC 2015 Edition Chapter 5 and Appendix D; please see the codes for further information.

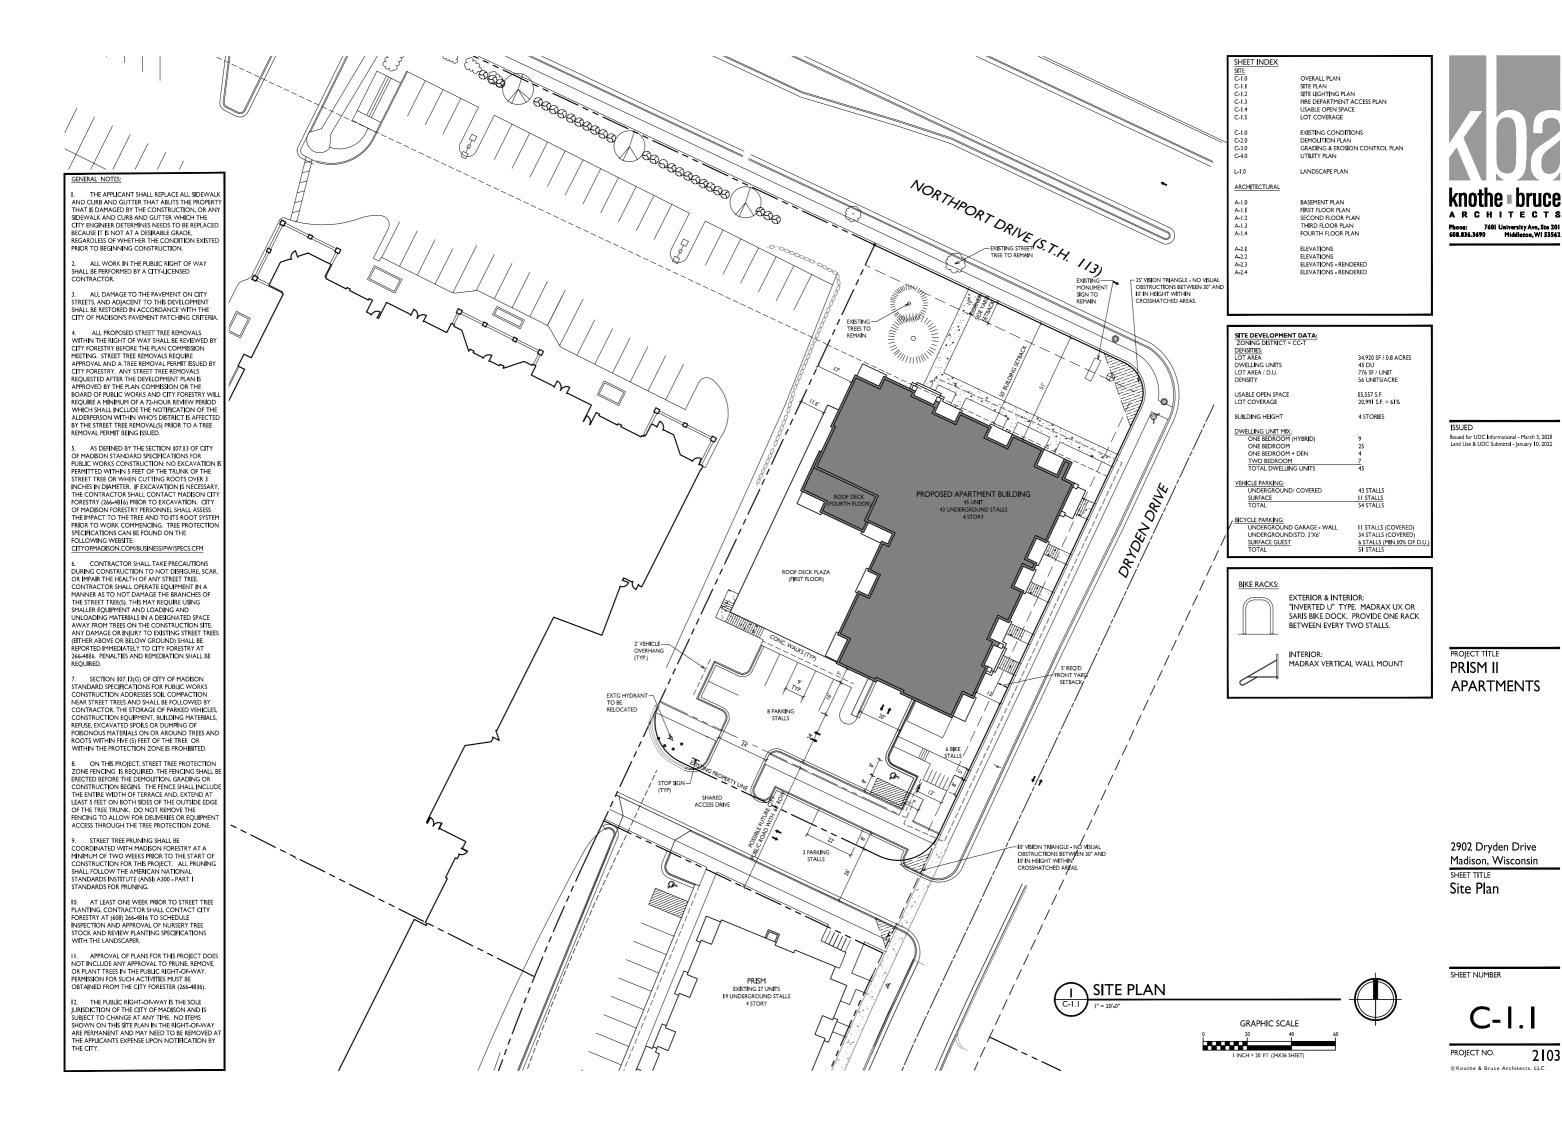

LIGHT LEVEL STATISTICS						
DESCRIPTION	SYMBOL	AVG.	MAX.	MIN.	MAX. / MIN.	AVG. / MIN.
Parking Lot and Drive Aisle Lighting	+	1.3 fc	4.5 fc	0.3 fc	15.0:1	4.3 : I
Parking Garage Entry Security Lighting	+	2.5 fc	6.4 fc	1.2 fc	5.3:1	2.1:1

LUMII	NAIR	E SC	CHEDULE				
SYMBOL	LABEL	QTY	. MANUF.	CATALOG	DESCRIPTION	FILE	MOUNTING
П	Α	I	LITHONIA LIGHTING	WPXI LED PI 30K MVOLT	WPXI LED WALLPACK, I500LM, 3000K COLOR TEMP., I20-277 VOLTS	WPXI_LED_PI_30K _MVOLT.ies	8'-0" ABOVE GRADE ON BUILDING
	В	I	LITHONIA LIGHTING	DSXI LED PI 30K RCCO MVOLT	DSXI LED PI 30K RCCO MVOLT	DSXI_LED_PI_30K _RCCO_MVOLT.ies	I6'-0" POLE ON 2'-0" TALL CONC. BASE
	С	I	LITHONIA LIGHTING	DSXI LED PI 30K RCCO MVOLT	DSXI LED PI 30K RCCO MVOLT	DSXI_LED_PI_30K _RCCO_MVOLT.ies	18'-0" POLE ON FLUSH CONC. BASE
	D			GHT FIXTURE ENT PROPERTY			
ISOLUX CONTOUR = 0.25 FC ISOLUX CONTOUR = 0.5 FC ISOLUX CONTOUR = 1.0 FC LIGHT FIXTURE							

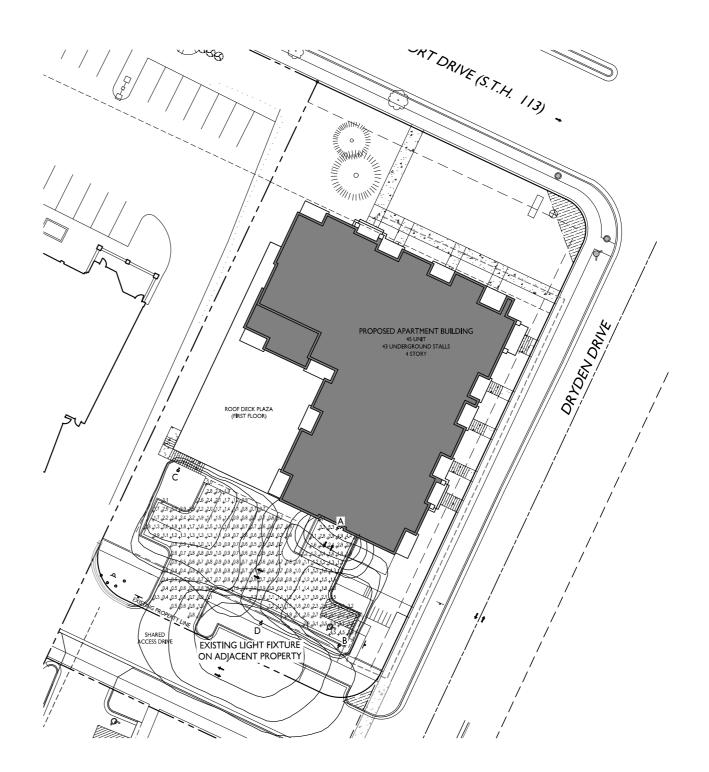


ISSUED
Issued for UDC Informational - March 3, 2021
Land Use & UDC Submittal - January 10, 2022

PROJECT TITLE
PRISM II **APARTMENTS**

2902 Dryden Drive
Madison, Wisconsin
SHEET TITLE
Site Lighting Plan



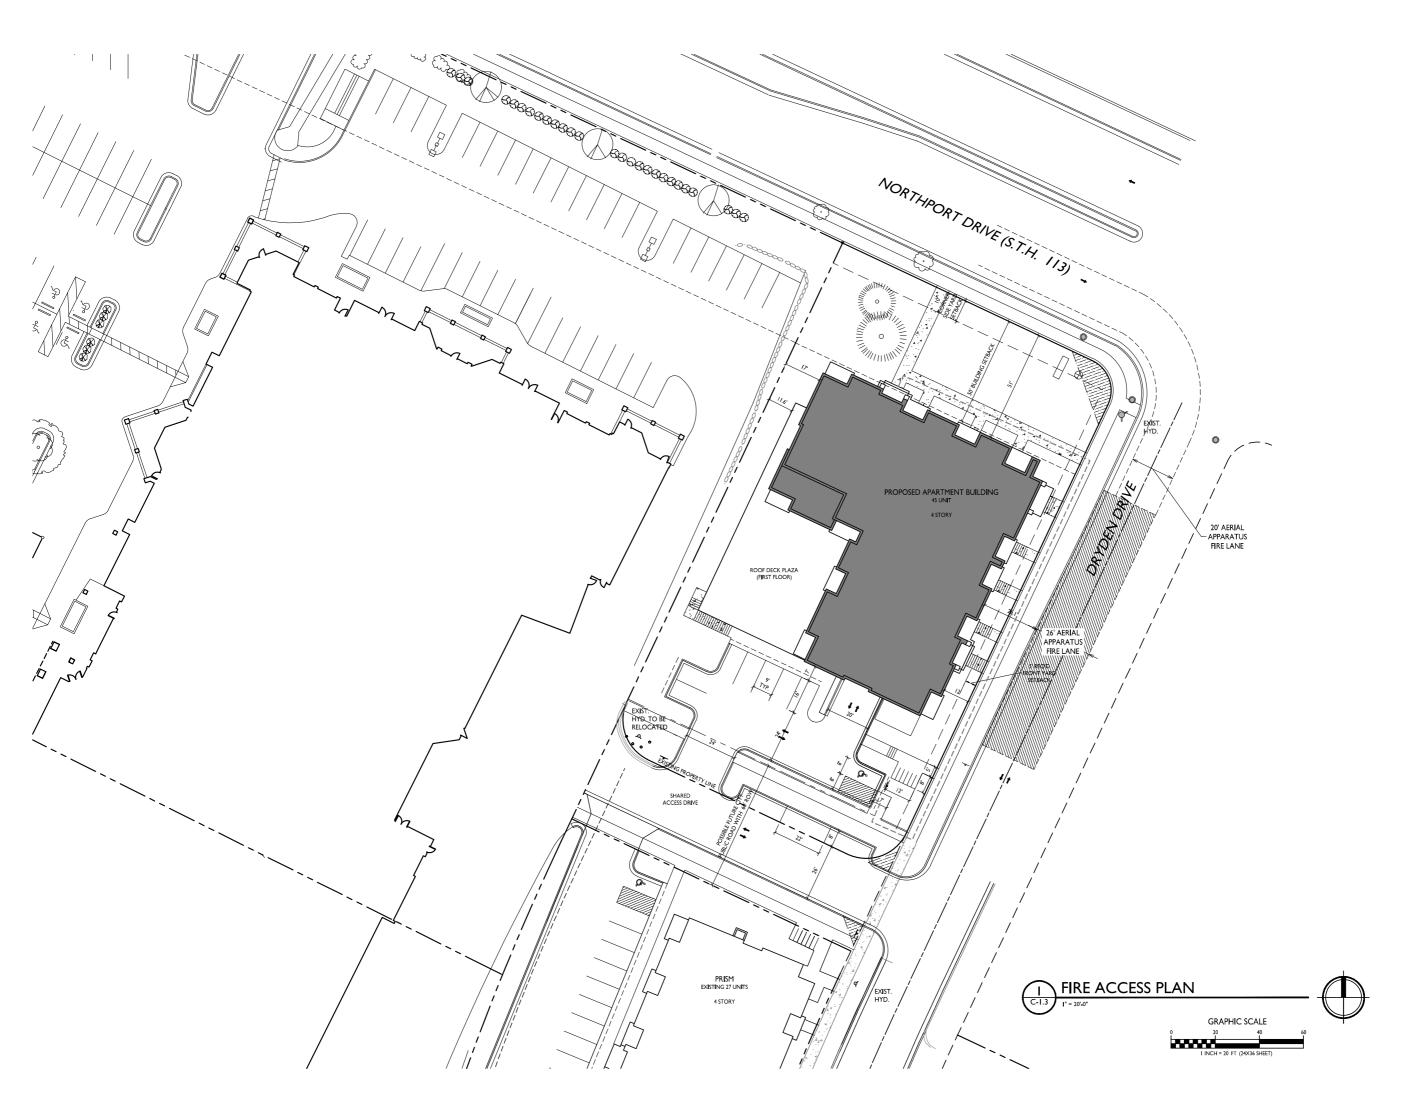




ISSUED
Issued for UDC Informational - March 3, 2021
Land Use & UDC Submittal - January 10, 2022

PROJECT TITLE
PRISM II **APARTMENTS**

2902 Dryden Drive Madison, Wisconsin SHEET TITLE Fire Department

Access Plan

SHEET NUMBER

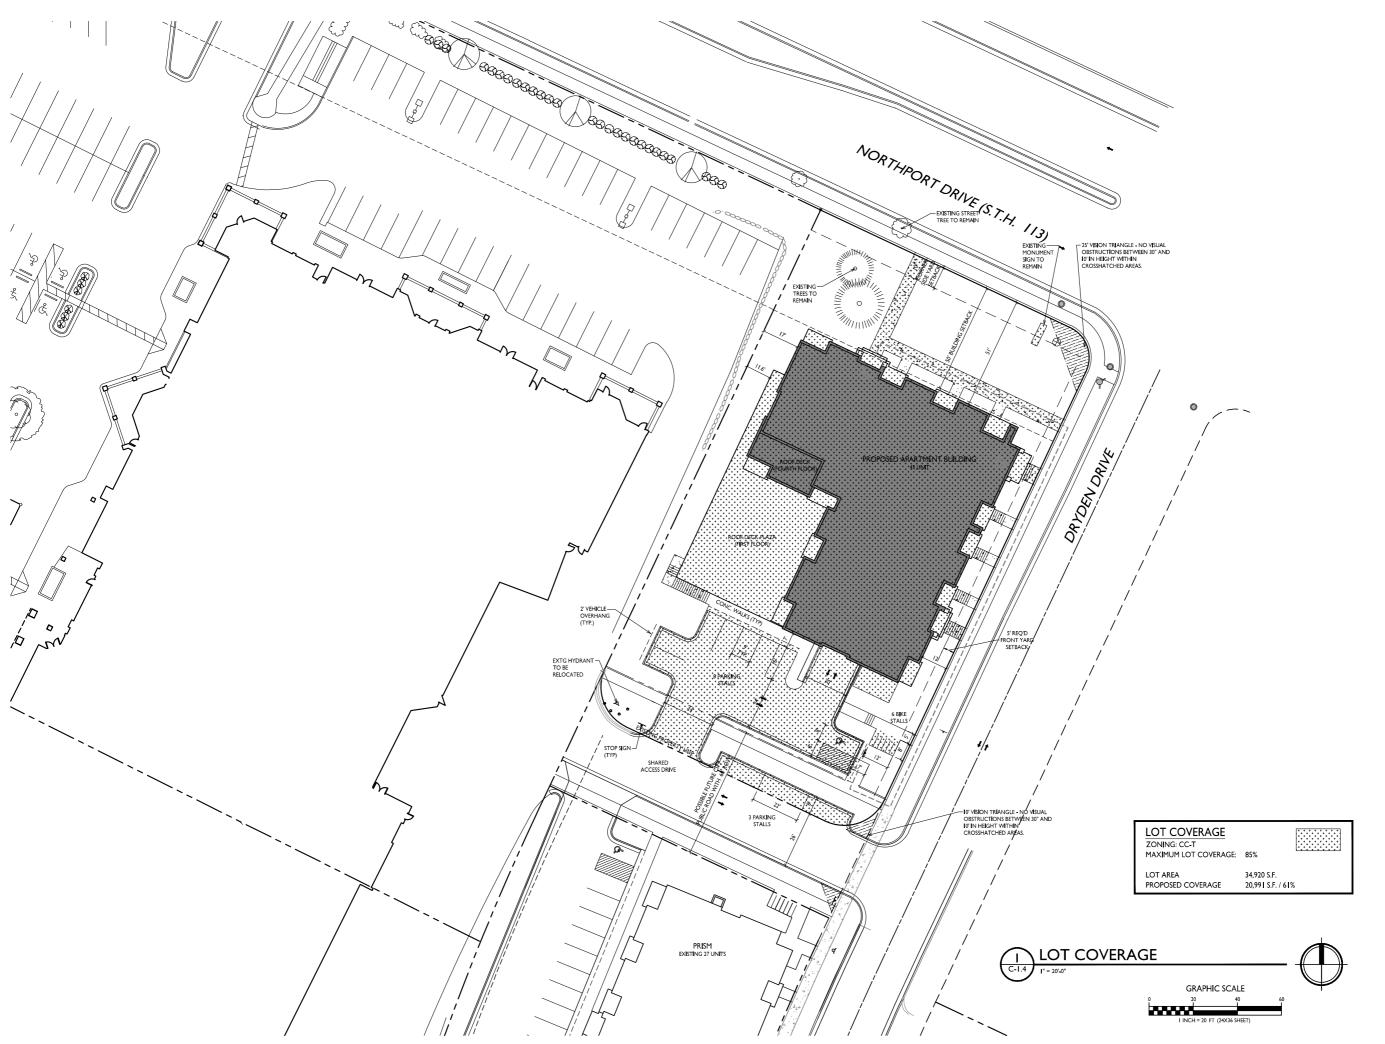




ISSUED Land Use & UDC Submittal - January 10, 2022

PROJECT TITLE
PRISM II **APARTMENTS**

2902 Dryden Drive Madison, Wisconsin SHEET TITLE Lot Coverage

SHEET NUMBER

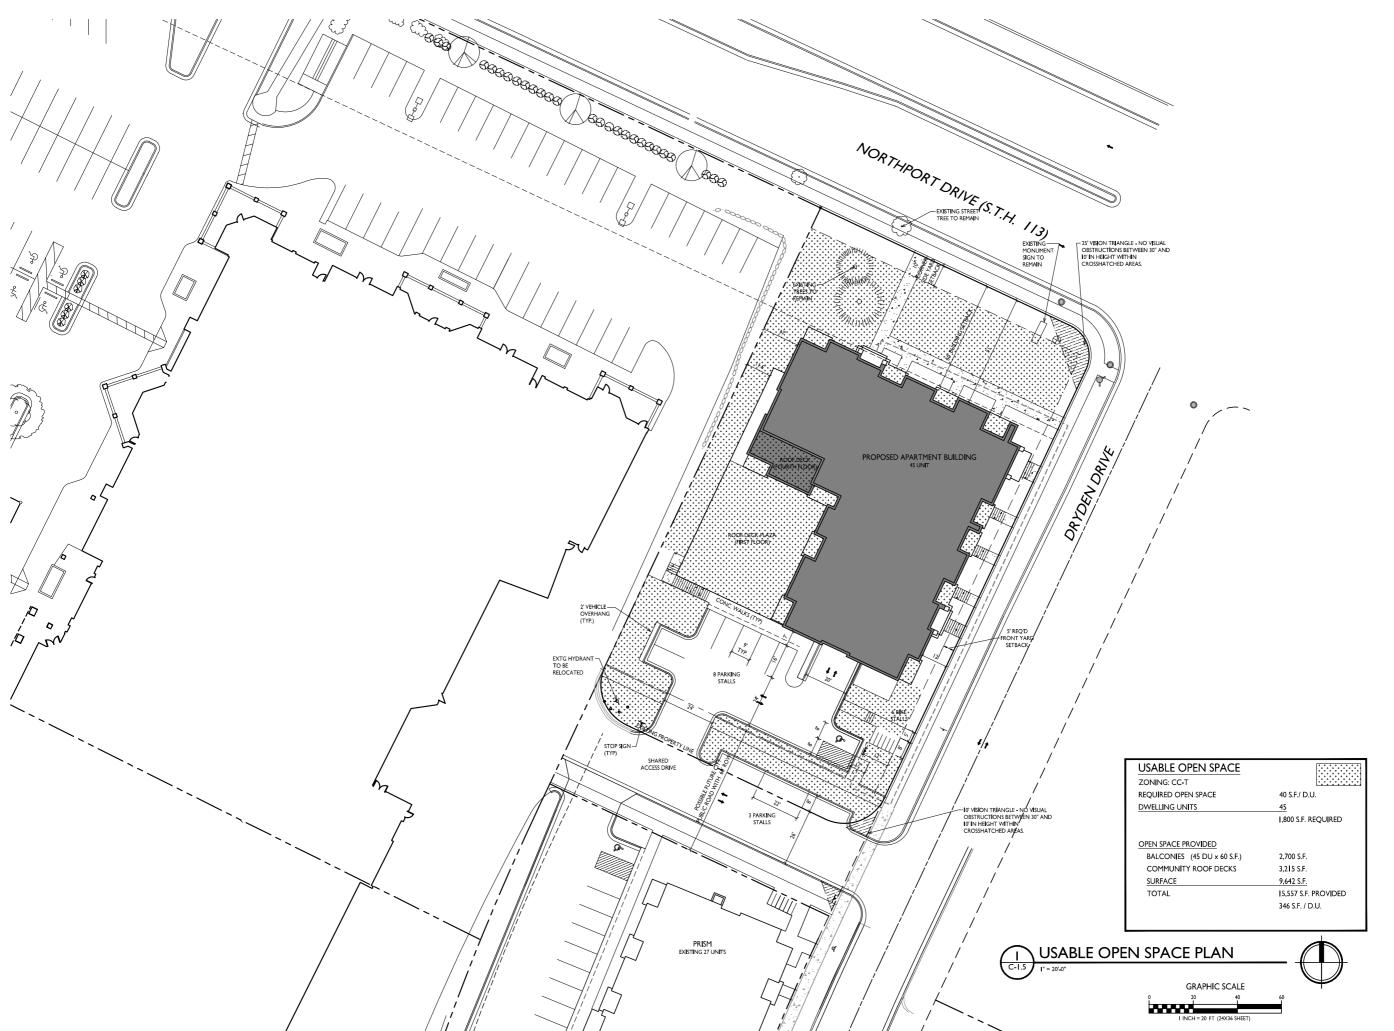



ISSUED Land Use & UDC Submittal - January 10, 2022

PROJECT TITLE
PRISM II
APARTMENTS


2902 Dryden Drive Madison, Wisconsin SHEET TITLE Usable Open


Space Plan


SHEET NUMBER

C-1.5

ROJECT NO. 2 1 0 3

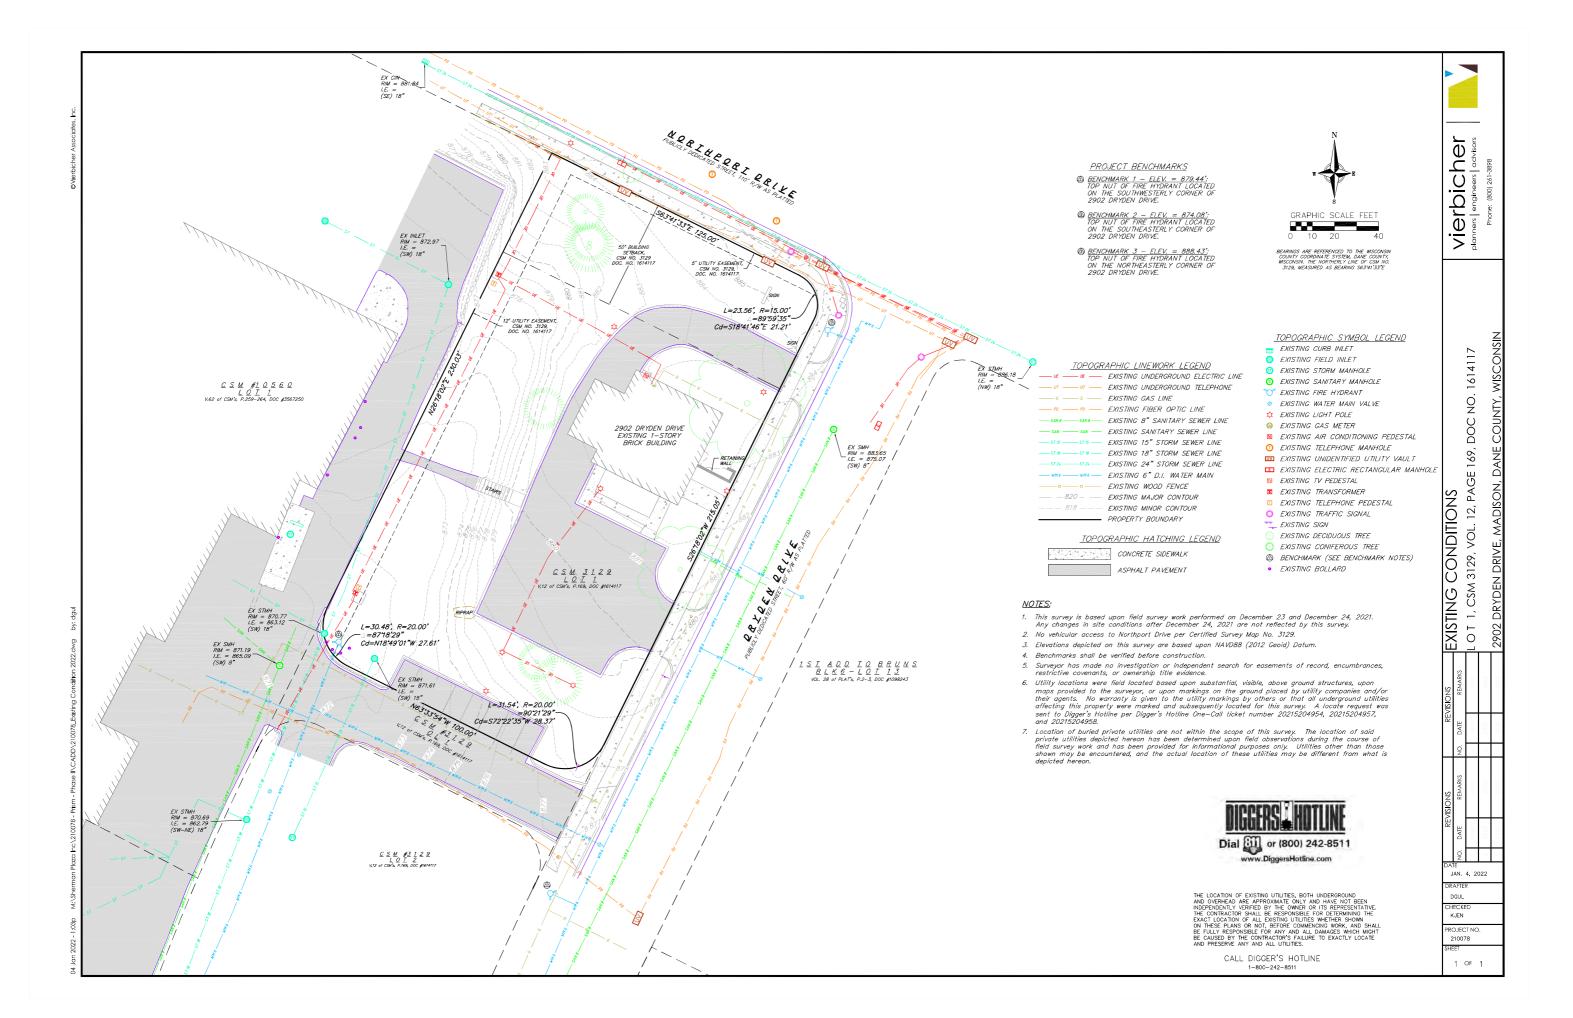

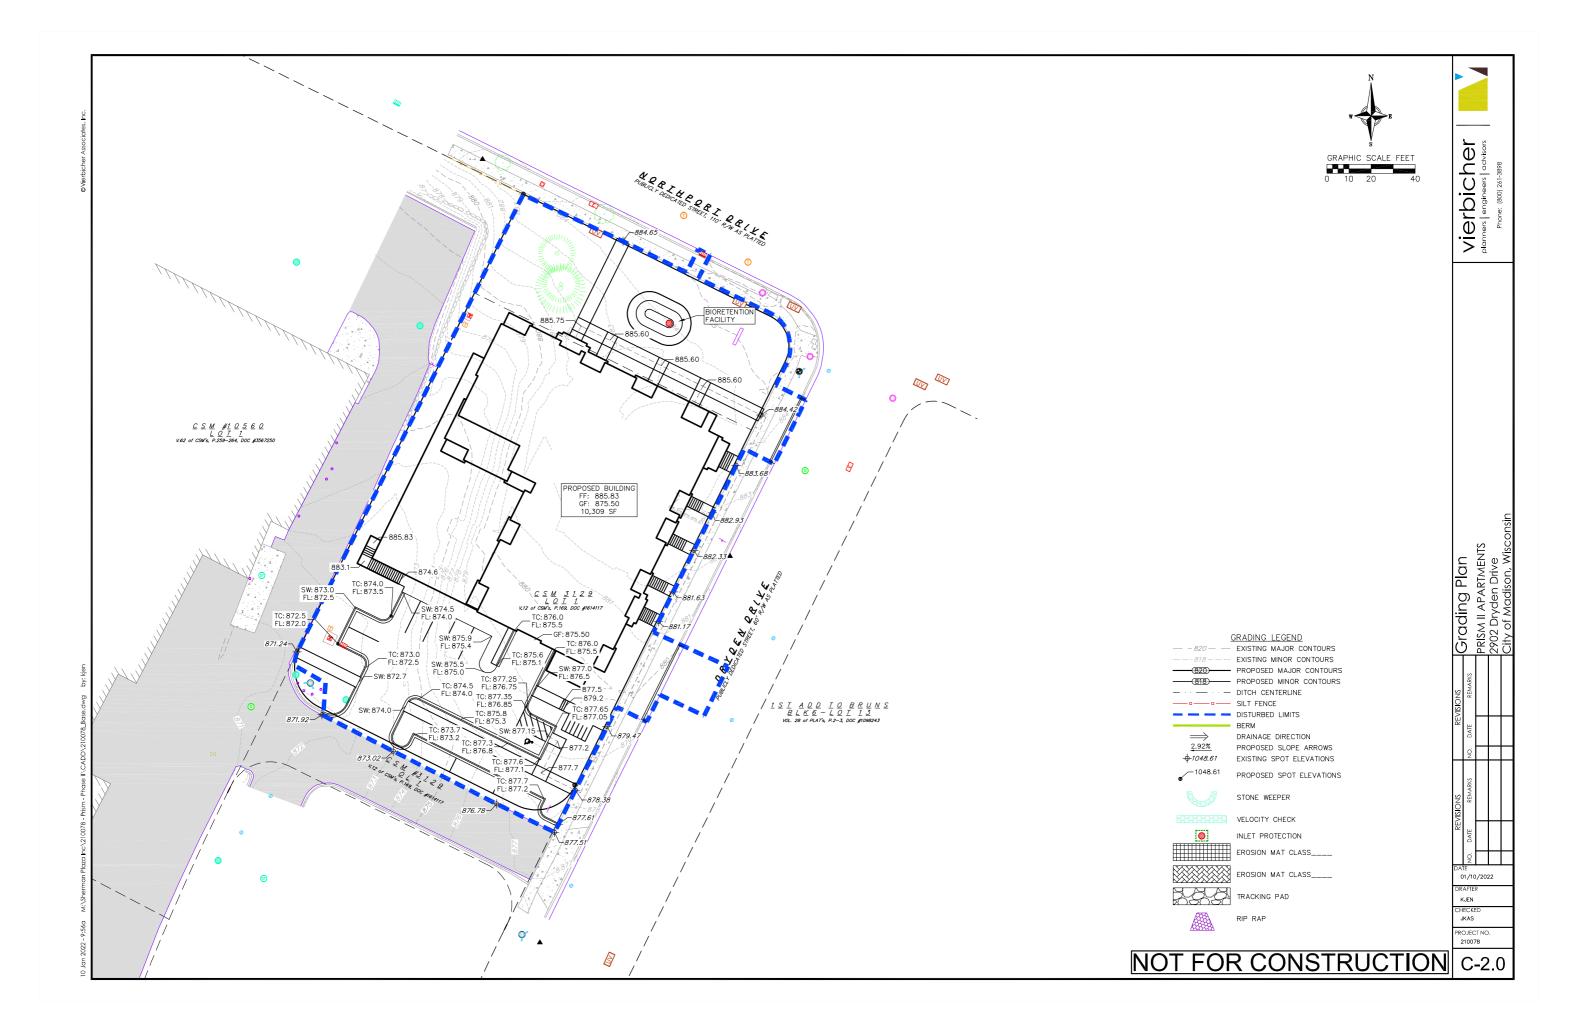

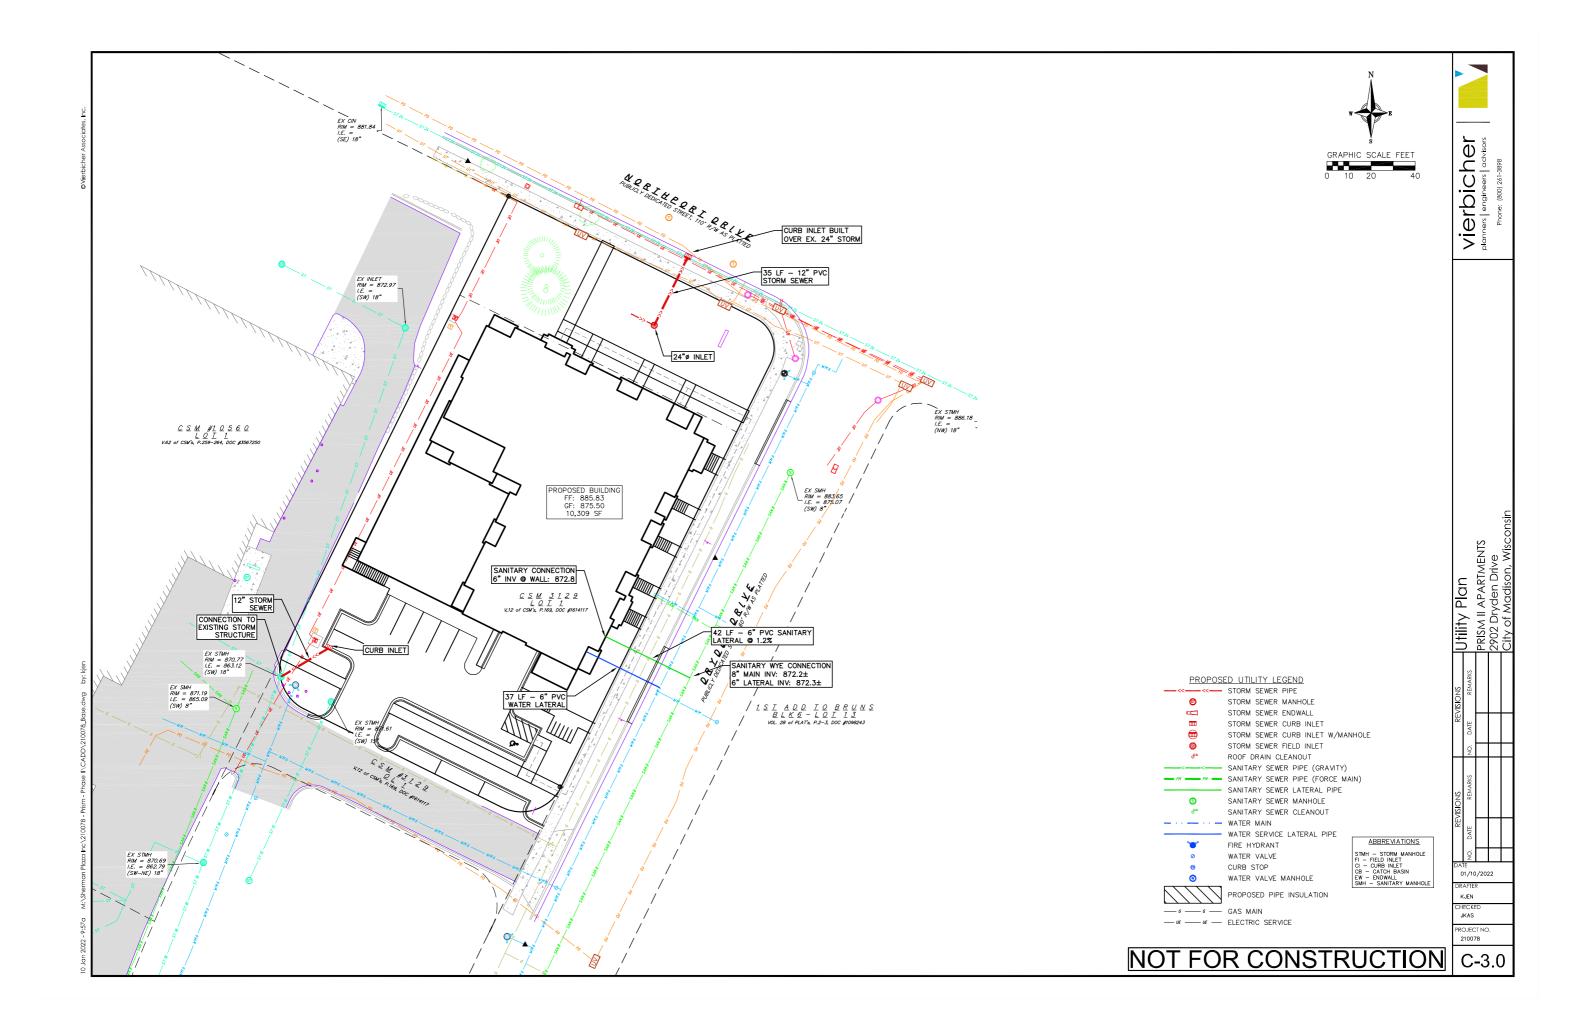

LANDSCAPE WORKSHEET 2902 Dryden Drive	
Landscape Points Required	
Developed Area = Landscape Points: 6,042/300 x 5 =	6,042 SF 101 points
Total Landscape Points Required	_101_points
Landscape Points Supplied	
Existing canopy trees – 0 @ 35 = Proposed canopy trees – 17 @ 35 = Existing evergreen trees – 2 @ 35 = Proposed evergreen trees – 0 @ 35 = Existing ornamental trees – 0 @ 15 = Existing ornamental trees – 6 @ 15 = Existing upright evergreen shrubs – 0 @ 10 = Proposed upright evergreen shrubs – 8 @ 10 = Existing deciduous shrubs – 71 @ 3 = Existing evergreen shrubs – 0 @ 4 = Proposed evergreen shrubs – 20 @ 4 = Existing perennials & grasses 0 @ 2 = Proposed perennials & grasses 50 @ 2 =	35 points 560 points 70 points 0 points 0 points 90 points 0 points 0 points 213 points 0 points 0 points 213 points 0 points 0 points 100 points
Total landscape points supplied =	1,228 points
Lot Frontage Landscape Required (Section 28.142(5) Development Frontage Landscaping)	
"One (1) over-story deciduous tree and five (5) shrubs shall be pla (30) lineal feet of lot frontage. Two (2) ornamental trees or two (2)	

370 LF

12 trees 62 shrubs

be used in place of one (1) over-story deciduous tree."

Overstory trees required 370'/30' = 12.3 Shrubs required (370'/30') x 5 = 61.6


Northport Drive and Dryden Drive =

	10 trees 6 trees 68 shrubs				
			PLANT LIST		
KEY (QUAN	SIZE	COMMON NAME	ROOT	
CH EM EP QA SHL TM	17 4 1 4 3 1 4	2 ½" 3" + 2 ½" 2" 2" 2 ½"		BB EX BB BB BB	
EWP RJC	<u>6</u>	1 ½"	11	EX BB	
AC BC DBH LDN GLS WS	22	24" 24" 24" 24" 24" 18" 24"	Tina Sergeant Crab Deciduous shrubs Alpine Currant Black Chokeberry Dwarf Bush Honeysuckle Little Devil Ninebark Gro Low Sumac White Snowberry	Pat Pot Pot Pot Pot Pot	
KCJ WBJ	28 20 8	16" 5'	Evergreen shrubs Kallay Compact Juniper Wichita Blue Juniper	Con BB	
MC PMD SWD	50 12 29 9	1 G 1 G	Perennials Moonbeam Coreopsis Pardon Me Day Lily Summer Wine Day Lily	Con Con Con	
NOTE	S.				

- Designated lawn areas to be seeded (Madison Parks seed mix), fertilized and mulched with straw mat.
- 2) Drainage swales and lawns with slopes steeper than 3/1 shall be mulched with erosion control fabric (installed per manufacturer's specifications).

 3) Foundation planting beds to be mulched with shredded hardwood bark
- mulch spread to a depth of 3".
- Individual trees and shrub groupings in lawn areas to receive shredded hardwood bark mulch plant rings (4' diameter) spread to a depth of 3"
 Designated planting beds to be separated from lawn areas with 5" black
- vinyl edge.

 6) Owner will be responsible for landscape maintenance after completion

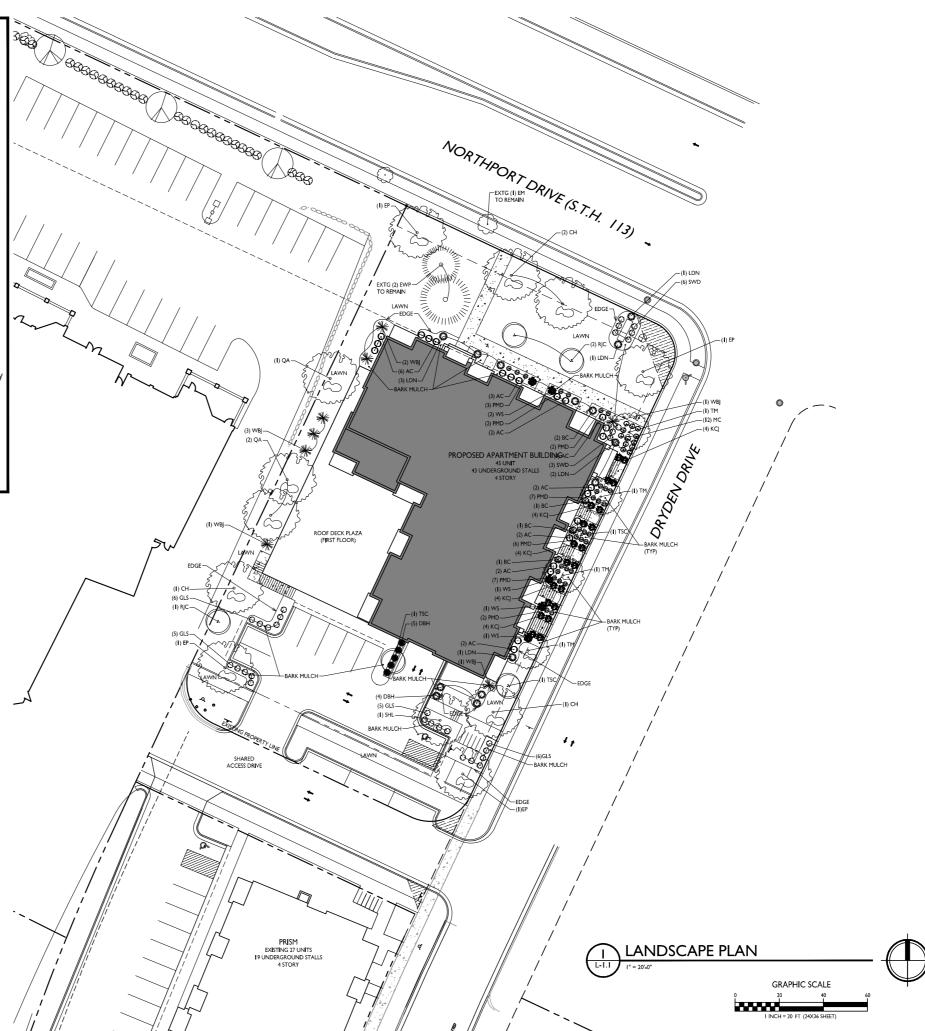



ISSUED

Land Use & UDC Submittal - January 10, 2022


PROJECT TITLE
PRISM II **APARTMENTS**



2902 Dryden Drive Madison, Wisconsin

SHEET TITLE Landscape Plan

SHEET NUMBER

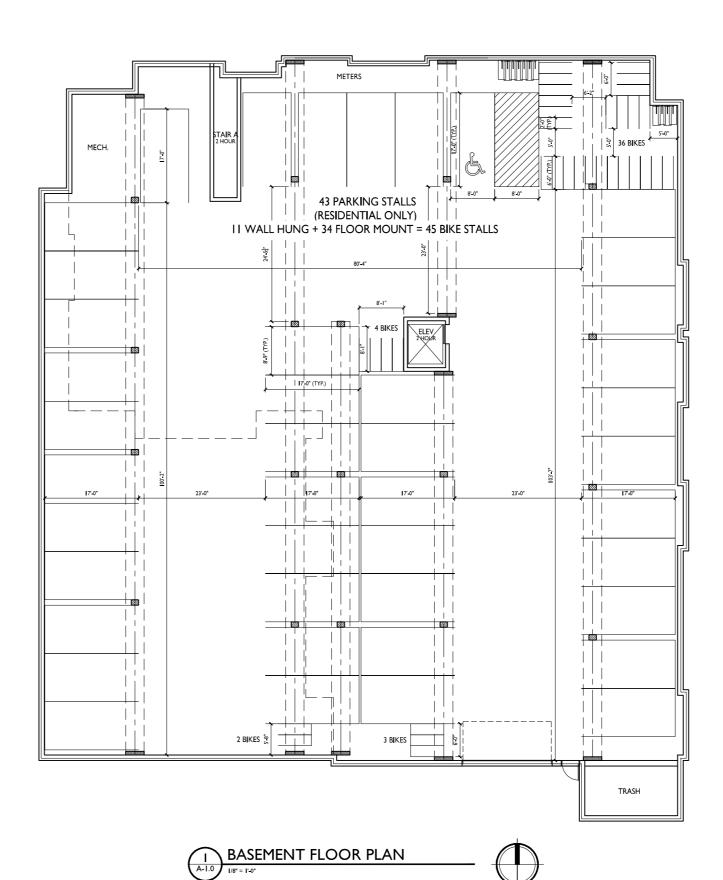



Issued for UDC Informational - March 3, 2021 Issued for UDC & LUA - Jan. 10, 2022


PROJECT TITLE
PRISM II **APARTMENTS**


2902 Dryden Drive Madison, Wisconsin

Basement Floor Plan

SHEET NUMBER



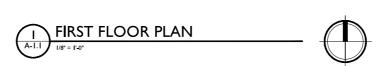

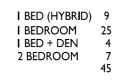




Issued for UDC Informational - March 3, 2021 Issued for UDC & LUA - Jan. 10, 2022

PROJECT TITLE
PRISM II **APARTMENTS**

2902 Dryden Drive Madison, Wisconsin SHEET TITLE First Floor Plan

SHEET NUMBER

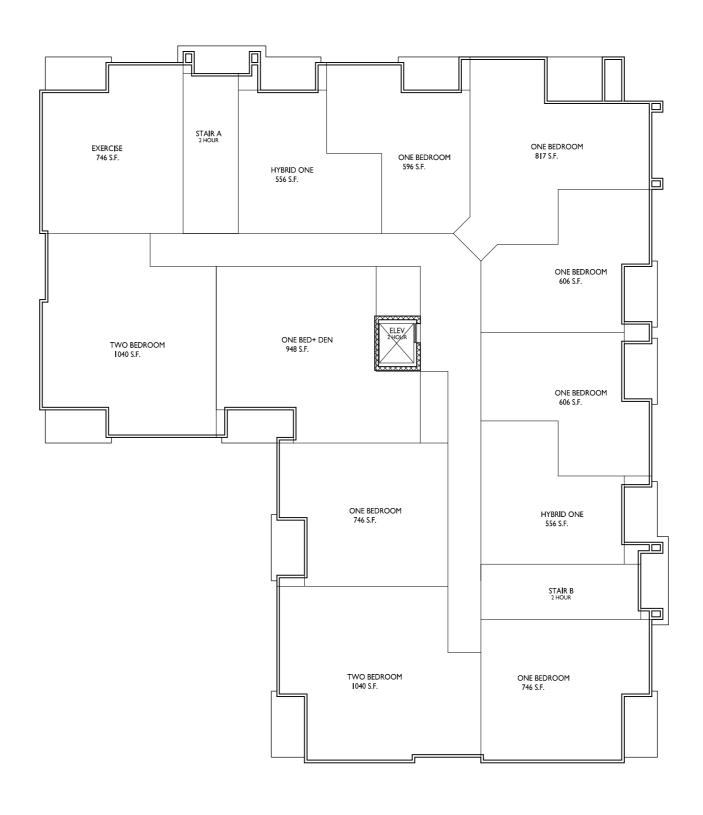






Issued for UDC Informational - March 3, 2021 Issued for UDC & LUA - Jan. 10, 2022

PROJECT TITLE
PRISM II **APARTMENTS**

2902 Dryden Drive Madison, Wisconsin SHEET TITLE Second Floor Plan

SHEET NUMBER

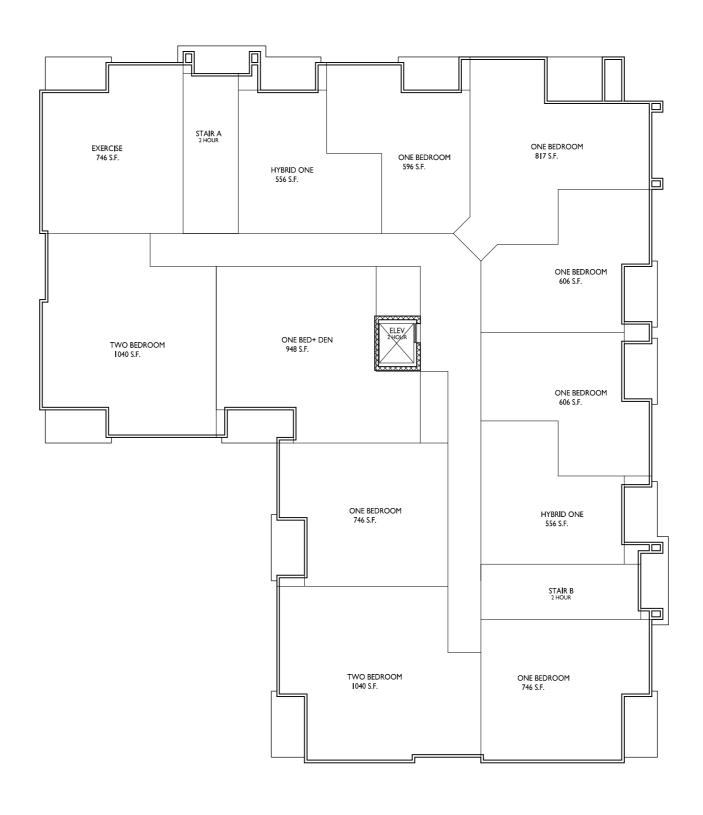






Issued for UDC Informational - March 3, 2021 Issued for UDC & LUA - Jan. 10, 2022

PROJECT TITLE
PRISM II **APARTMENTS**

2902 Dryden Drive Madison, Wisconsin SHEET TITLE Third Floor Plan

SHEET NUMBER

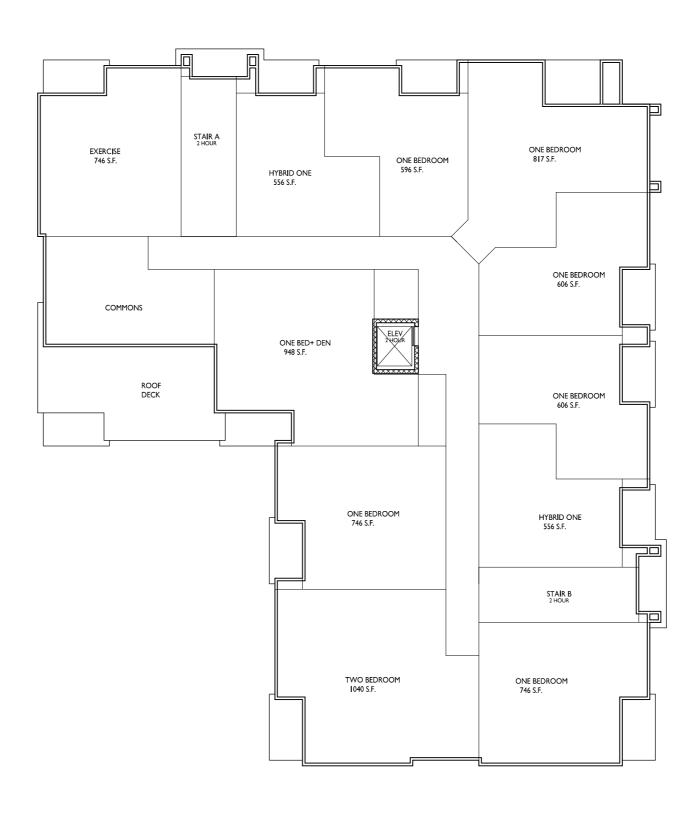





Issued for UDC Informational - March 3, 2021 Issued for UDC & LUA - Jan. 10, 2022

PROJECT TITLE
PRISM II **APARTMENTS**

2902 Dryden Drive Madison, Wisconsin SHEET TITLE Fourth Floor Plan

SHEET NUMBER





Issued for UDC Info. - March 3, 2021
Issued for UDC & LUA - Jan. 10, 2022

PROJECT TITLE
PRISM II
APARTMENTS

2902 DRYDEN DRIVE MADISON, WI SHEET TITLE

ELEVATIONS

SHEET NUMBER

A-2.1

PROJECT NUMBER 2103
© Knothe & Bruce Architects, LLC

1 ELEVATION - NORTH

(2) 1/8" = 1'-0"

FOURH FLOOR

121" - 5/5"

121" - 1/8"

2 ELEVATION - EAST 1/8" = 1'-0"

EXTERIOR MATERIAL SCHEDULE					
BUILDING ELEMENT	MANUFACTURER	COLOR			
(#1) - REVEAL COMPOSITE PANELS	JAMES HARDIE	ARCTIC WHITE			
(#2) - 6" COMPOSITE LAP SIDING	JAMES HARDIE	RICH ESPRESSO			
(#3) - 6" COMPOSITE LAP SIDING	JAMES HARDIE	WOODTONE SUMMER WHEAT			
(#4) - REVEAL COMPOSITE PANELS	JAMES HARDIE	HL - 0599 FLORIDA WATERS			
COMPOSITE TRIM	JAMES HARDIE	MATCH ADJ. SIDING COLOR			
(#5) - STONE VENEER	ROCKAST	SLATE			
(#6) - CAST STONE BANDS & SILLS	ROCKAST	SLATE			
(#7) - COMPOSITE WINDOWS	ANDERSEN 100	DARK BRONZE			
(#8) - ALUM. STOREFRONT	N/A	DARK BRONZE INODIZED			
CANOPY & BAY SOFFITS	JAMES HARDIE	COLOR TO MATCH ADJ. TRIM/SIDING			



1) REVATION - SOUTH

222) 1/8" = 1-Q"

ROUTHS-1000 V

337 - 3.96*

SECONO 1000 V

221 - 3.96*

SECONO 1000 V

337 - 3.96*

SECONO 1000 V

337 - 3.96*

SECONO 1000 V

2 ELEVATION - WEST A-2.2 1/8" = 1'-0"

EXTERIOR MATERIAL SCHEDULE			
BUILDING ELEMENT	MANUFACTURER	COLOR	
(#1) - REVEAL COMPOSITE PANELS	JAMES HARDIE	ARCTIC WHITE	
(#2) - 6" COMPOSITE LAP SIDING	JAMES HARDIE	RICH ESPRESSO	
(#3) - 6" COMPOSITE LAP SIDING	JAMES HARDIE	WOODTONE SUMMER WHEAT	
(#4) - REVEAL COMPOSITE PANELS	JAMES HARDIE	HL - 0599 FLORIDA WATERS	
COMPOSITE TRIM	JAMES HARDIE	MATCH ADJ. SIDING COLOR	
(#5) - STONE VENEER	ROCKAST	SLATE	
(#6) - CAST STONE BANDS & SILLS	ROCKAST	SLATE	
(#7) - COMPOSITE WINDOWS	ANDERSEN 100	DARK BRONZE	
(#8) - ALUM. STOREFRONT	N/A	DARK BRONZE INODIZED	
CANOPY & BAY SOFFITS	JAMES HARDIE	COLOR TO MATCH ADJ. TRIM/SIDING	
(#9) - RAILINGS & HANDRAILS	SUPERIOR	DARK BRONZE	



ISSUED Issued for UDC Info. - March 3, 2021

Issued for UDC Info. - March 3, 2021 Issued for UDC & LUA - Jan. 10, 2022

PROJECT TITLE
PRISM II
APARTMENTS

2902 DRYDEN DRIVE
MADISON, WI
SHEET TITLE
EXTERIOR

SHEET NUMBER

ELEVATIONS

A-2.2

PROJECT NUMBER 2103

© Knothe & Bruce Architects, LLC



ELEVATION - NORTH COLOR 1/8" = 1'-0"

133' - 5 5/8" THIRD FLOOR 122' - 3 3/4" SECOND FLOOR 111' - 1 7/8"

2 A-2.3 ELEVATION - SOUTH COLOR 1/8" = 1'-0"

EXTERIOR MATERIAL SCHEDULE				
BUILDING ELEMENT	MANUFACTURER	COLOR		
(#1) - REVEAL COMPOSITE PANELS	JAMES HARDIE	ARCTIC WHITE		
(#2) - 6" COMPOSITE LAP SIDING	JAMES HARDIE	RICH ESPRESSO		
(#3) - 6" COMPOSITE LAP SIDING	JAMES HARDIE	WOODTONE SUMMER WHEAT		
(#4) - REVEAL COMPOSITE PANELS	JAMES HARDIE	HL - 0599 FLORIDA WATERS		
COMPOSITE TRIM	JAMES HARDIE	MATCH ADJ. SIDING COLOR		
(#5) - STONE VENEER	ROCKAST	SLATE		
(#6) - CAST STONE BANDS & SILLS	ROCKAST	SLATE		
(#7) - COMPOSITE WINDOWS	ANDERSEN 100	DARK BRONZE		
(#8) - ALUM. STOREFRONT	N/A	DARK BRONZE INODIZED		
CANOPY & BAY SOFFITS	JAMES HARDIE	COLOR TO MATCH ADJ. TRIM/SIDING		
(#9) - RAILINGS & HANDRAILS	SUPERIOR	DARK BRONZE		



ISSUED Issued for UDC Info. - March 3, 2021 Issued for UDC & LUA - Jan. 10, 2022

PROJECT TITLE PRISM II **APARTMENTS**

2902 DRYDEN DRIVE MADISON, WI SHEET TITLE **EXTERIOR**

ELEVATIONS -COLOR

SHEET NUMBER

PROJECT NUMBER 2103



1 A-2.4 ELEVATION - EAST COLOR 1/8" = 1'-0"



2 ELEVATION - WEST COLOR 1/8" = 1'-0"

EXT	ERIOR MATERIAL SCHEDUL	E
BUILDING ELEMENT	MANUFACTURER	COLOR
(#1) - REVEAL COMPOSITE PANELS	JAMES HARDIE	ARCTIC WHITE
(#2) - 6" COMPOSITE LAP SIDING	JAMES HARDIE	RICH ESPRESSO
(#3) - 6" COMPOSITE LAP SIDING	JAMES HARDIE	WOODTONE SUMMER WHEAT
(#4) - REVEAL COMPOSITE PANELS	JAMES HARDIE	HL - 0599 FLORIDA WATERS
COMPOSITE TRIM	JAMES HARDIE	MATCH ADJ. SIDING COLOR
(#5) - STONE VENEER	ROCKAST	SLATE
(#6) - CAST STONE BANDS & SILLS	ROCKAST	SLATE
(#7) - COMPOSITE WINDOWS	ANDERSEN 100	DARK BRONZE
(#8) - ALUM. STOREFRONT	N/A	DARK BRONZE INODIZED
CANOPY & BAY SOFFITS	JAMES HARDIE	COLOR TO MATCH ADJ. TRIM/SIDING
(#9) - RAILINGS & HANDRAILS	SUPERIOR	DARK BRONZE

ISSUED

Issued for UDC Info. - March 3, 2021 Issued for UDC & LUA - Jan. 10, 2022

PROJECT TITLE PRISM II **APARTMENTS**

2902 DRYDEN DRIVE MADISON, WI

SHEET TITLE **EXTERIOR ELEVATIONS -**COLOR

SHEET NUMBER

PROJECT NUMBER 2103















#1 - REVEAL COMPOSITE PANELS

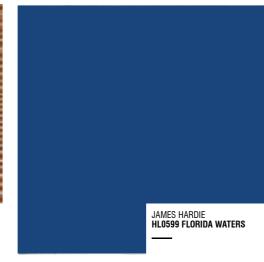

#2 - COMPOSITE LAP SIDING

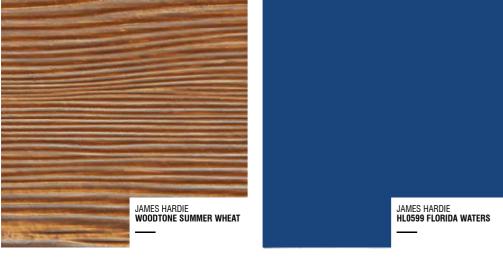

#3 - COMPOSITE LAP SIDING





CAST STONE VENEER, SILLS & BANDS



ALUM. STOREFRONT COMPOSITE WINDOWS ALUM. RAILINGS

EXTERIOR MATERIAL SCHEDULE				
BUILDING ELEMENT	MANUFACTURER	COLOR		
(#1) - REVEAL COMPOSITE PANELS	JAMES HARDIE	ARCTIC WHITE		
(#2) - 6" COMPOSITE LAP SIDING	JAMES HARDIE	RICH ESPRESSO		
(#3) - 6" COMPOSITE LAP SIDING	JAMES HARDIE	WOODTONE SUMMER WHEAT		
(#4) - REVEAL COMPOSITE PANELS	JAMES HARDIE	HL - 0599 FLORIDA WATERS		
COMPOSITE TRIM	JAMES HARDIE	MATCH ADJ. SIDING COLOR		
(#5) - STONE VENEER	ROCKAST	SLATE		
(#6) - CAST STONE BANDS & SILLS	ROCKAST	SLATE		
(#7) - COMPOSITE WINDOWS	ANDERSEN 100	DARK BRONZE		
(#8) - ALUM. STOREFRONT	N/A	DARK BRONZE INODIZED		
CANOPY & BAY SOFFITS	JAMES HARDIE	COLOR TO MATCH ADJ. TRIM/SIDING		
(#9) - RAILINGS & HANDRAILS	SUPERIOR	DARK BRONZE		

