

**APPLICATION FOR
URBAN DESIGN COMMISSION
REVIEW AND APPROVAL**

AGENDA ITEM # _____
Project # _____

| | |
|--|--|
| DATE SUBMITTED: _____ | Action Requested |
| UDC MEETING DATE: <u>JUNE 4, 2008.</u> | <input type="checkbox"/> Informational Presentation |
| | <input type="checkbox"/> Initial Approval and/or Recommendation |
| | <input checked="" type="checkbox"/> Final Approval and/or Recommendation |

PROJECT ADDRESS: 610 & 614 SOUTH PARK STREET, MADISON, WI 53715

ALDERMANIC DISTRICT: _____

OWNER/DEVELOPER (Partners and/or Principals) ARCHITECT/DESIGNER/OR AGENT:
MR. JING-JUN JIANG, OWNER BARRY CHEN-JUI YANG ARCHITECT.
EDO GARDEN RESTAURANT.

CONTACT PERSON: BARRY C. YANG
Address: 5559 N. SHORELAND AVE.
MILWAUKEE, WI 53217
Phone: 414-431-3131 (OFFICE) 414-460-0921 CELL
Fax: 414-431-0531
E-mail address: bcyang@a9arch.com

TYPE OF PROJECT:

(See Section A for:)

- Planned Unit Development (PUD)
 - General Development Plan (GDP)
 - Specific Implementation Plan (SIP)
- Planned Community Development (PCD)
 - General Development Plan (GDP)
 - Specific Implementation Plan (SIP)
- ~~New Construction or~~ Exterior Remodeling in an Urban Design District * (A public hearing is required as well as a fee)
- School, Public Building or Space (Fee may be required)
- ~~New Construction or~~ Addition to or Remodeling of a Retail, Hotel or Motel Building Exceeding 40,000 Sq. Ft.
- Planned Commercial Site

(See Section B for:)

- New Construction or Exterior Remodeling in C4 District (Fee required)

(See Section C for:)

- R.P.S.M. Parking Variance (Fee required)

(See Section D for:)

- Comprehensive Design Review* (Fee required)
- Street Graphics Variance* (Fee required)
- Other _____

*Public Hearing Required (Submission Deadline 3 Weeks in Advance of Meeting Date)

Where fees are required (as noted above) they apply with the first submittal for either initial or final approval of a project.

LETTER OF INTENT

PROJECT:

EDO STEAK HOUSE Tenant Improvement & Addition
610 & 614 South Park Street
Madison, WI 53715

FROM:

Barry C. Yang, AIA
BARRY C. YANG ARCHITECT
5559 North Shoreland Avenue
MILWAUKEE, WI 53217
Phone: 414-460-0921
Email: bcyang@agarch.com

The project is located at 610 & 614 South Park Street, Madison, WI 53715. It belongs to zoning district C2 (General Commercial District) & is in Urban Design District No. 7. The applicable codes include Wisconsin Enrolled Commercial Building Code, Madison Zoning Ordinances, & Madison Urban Design Ordinances.

Proposed Building Use

The existing building was used by two tenants - beauty shop /barber shop & night club. The property owner, Mr. Jing-Jun Jiang, purchased the property in July 2007 & plans to reuse this building as a restaurant. The existing space is around 3,312 square feet & new addition is about 1,032 square feet. In total, this project is about 4,344 square feet. Most of the existing spaces will be used as private dining rooms & general dining area. The new addition, next to the existing alley, will be mainly used as the kitchen. The roof-top HVAC equipment (air make-up unit & exhaust fans) will therefore be located close to the back of the building.

Exterior Material – Brick & Stone

The existing front façade, as shown in the site photos, has deteriorated wood panels, wood trims, wood columns, painted vinyl siding, & a gable. The design intent is to maintain the existing brick veneers (two different colors) as much as possible. Glen-Grey Modular Bricks (Autumn Haze Classic & Oxford Ironspot Classic) will be applied to match the existing bricks. Limestone window sills, window heads, copings, & bends across the building will be incorporated into the design. The purpose is to better relate to the existing adjacent building, while giving the building a permanent look.


Exterior Material – Glass & Aluminum Frame

The existing window head is at 7'-4" above finished floor & existing ceiling is 8'-0". To enhance the pedestrian character & scale, the design uses 5'-0" (W) x 4'-8" (H) punched windows. Because the existing bearing walls (party walls) divide the building & front façade into three (3) bays, the total window areas are thus limited by its structural system. Most of the existing window openings will be reused & the new building entrance will be located as shown on the building elevation. Low-E argon gas-filled stationary tinted glass & bronze aluminum frame will be applied to the whole project.

Exterior Material – Lighting Fixture & Signage

Two exterior lighting fixtures are proposed. Wall sconce (Architectural Area Lighting, Model ES2) will be located on both sides of the building entrance & Sign Light (Vision3 Lighting, Model SL-1) will be located above each window. Both lighting fixtures will use 50-Watt light bulbs.

The proposed wall sign (EDO ETEAK HOUSE) is around 16'-0" (L) x 1'-4" (H) & located at 12'-6" above the existing sidewalk. The total allowable signage area is 120 square feet, while the proposed sign is 21.28 square feet. Currently, it is proposed as an internally-lighted acrylic with aluminum frames.

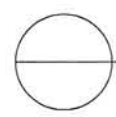

PROPOSED BUILDING ELEVATION (COLORED)

3/16"=1'-0"


BARRY C. J. YANG ARCHITECT, AIA

5559 North Shoreland Avenue,
Milwaukee, WI 53217
Phone: (414) 431-3131; Fax: (414) 431-0531
Email: bcyang@agarch.com


EDO STAKE HOUSE

TENANT IMPROVEMENT & ADDITION
614 SOUTH PARK STREET
MADISON, WI 53715

| | |
|-----------|--------------|
| DATE | JOB NUMBER |
| 5-14-2008 | 08011 |
| DRAWN BY | SHEET NUMBER |
| BCY | 500-1 |


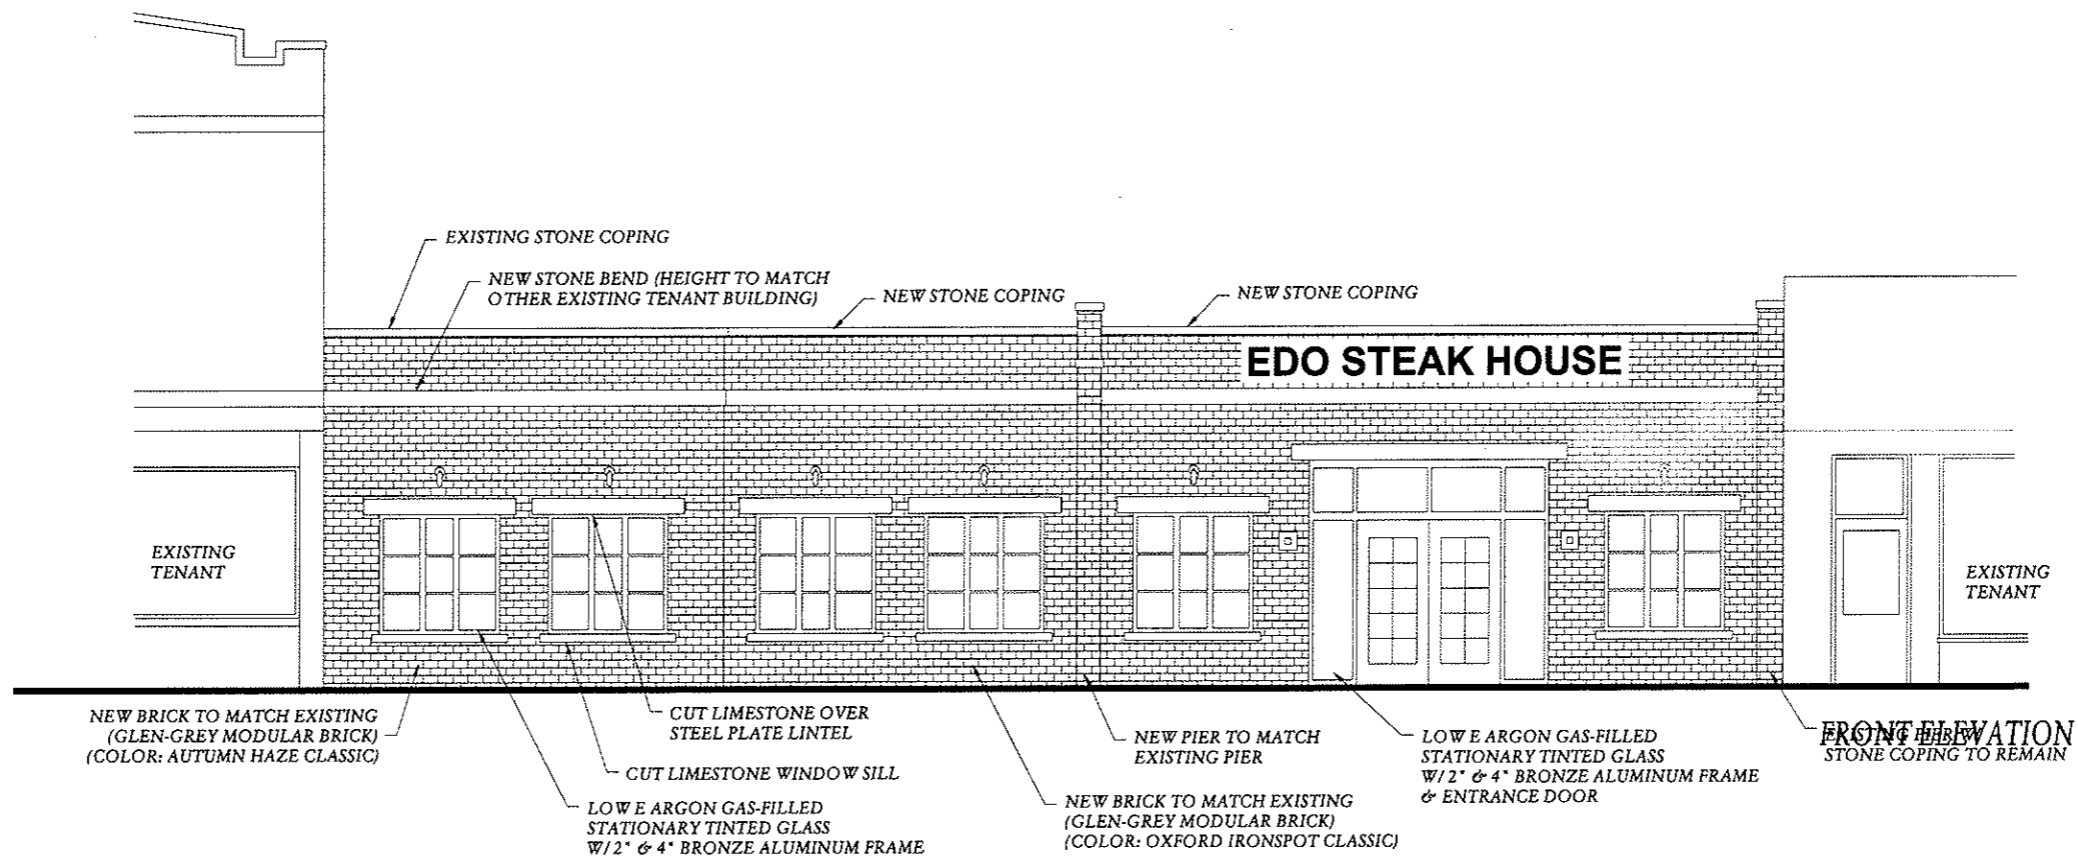


- NOTE:**
- ↑ VISION3 LIGHTING FIXTURE (DOWNLIGHT 50W) (MODEL SL1A-BN-C4-18-12)
 - ARCHITECTURAL AREA LIGHTING ESCONCE (MODEL ES2 - 50W) (UPLIGHT LIGHT + DOWNLIGHT)

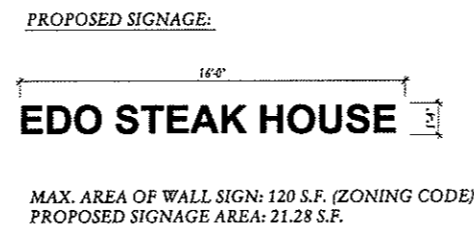


PROPOSED BUILDING ELEVATION & SIGNAGE
 1/8" = 1'-0"

| | | | |
|---|---|-----------|--------------|
| BARRY C. J. YANG ARCHITECT, AIA 5559 North Shoreland Avenue, Milwaukee, WI 53217 Phone: (414) 431-3131; Fax: (414) 431-0531 Email: bcyang@agarch.com | EDO STAKE HOUSE TENANT IMPROVEMENT & ADDITION 614 SOUTH PARK STREET MADISON, WI 53715 | DATE | JOB NUMBER |
| | | 5-14-2008 | 08011 |
| | | DRAWN BY | SHEET NUMBER |
| | | BCY | 500 |

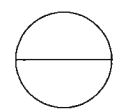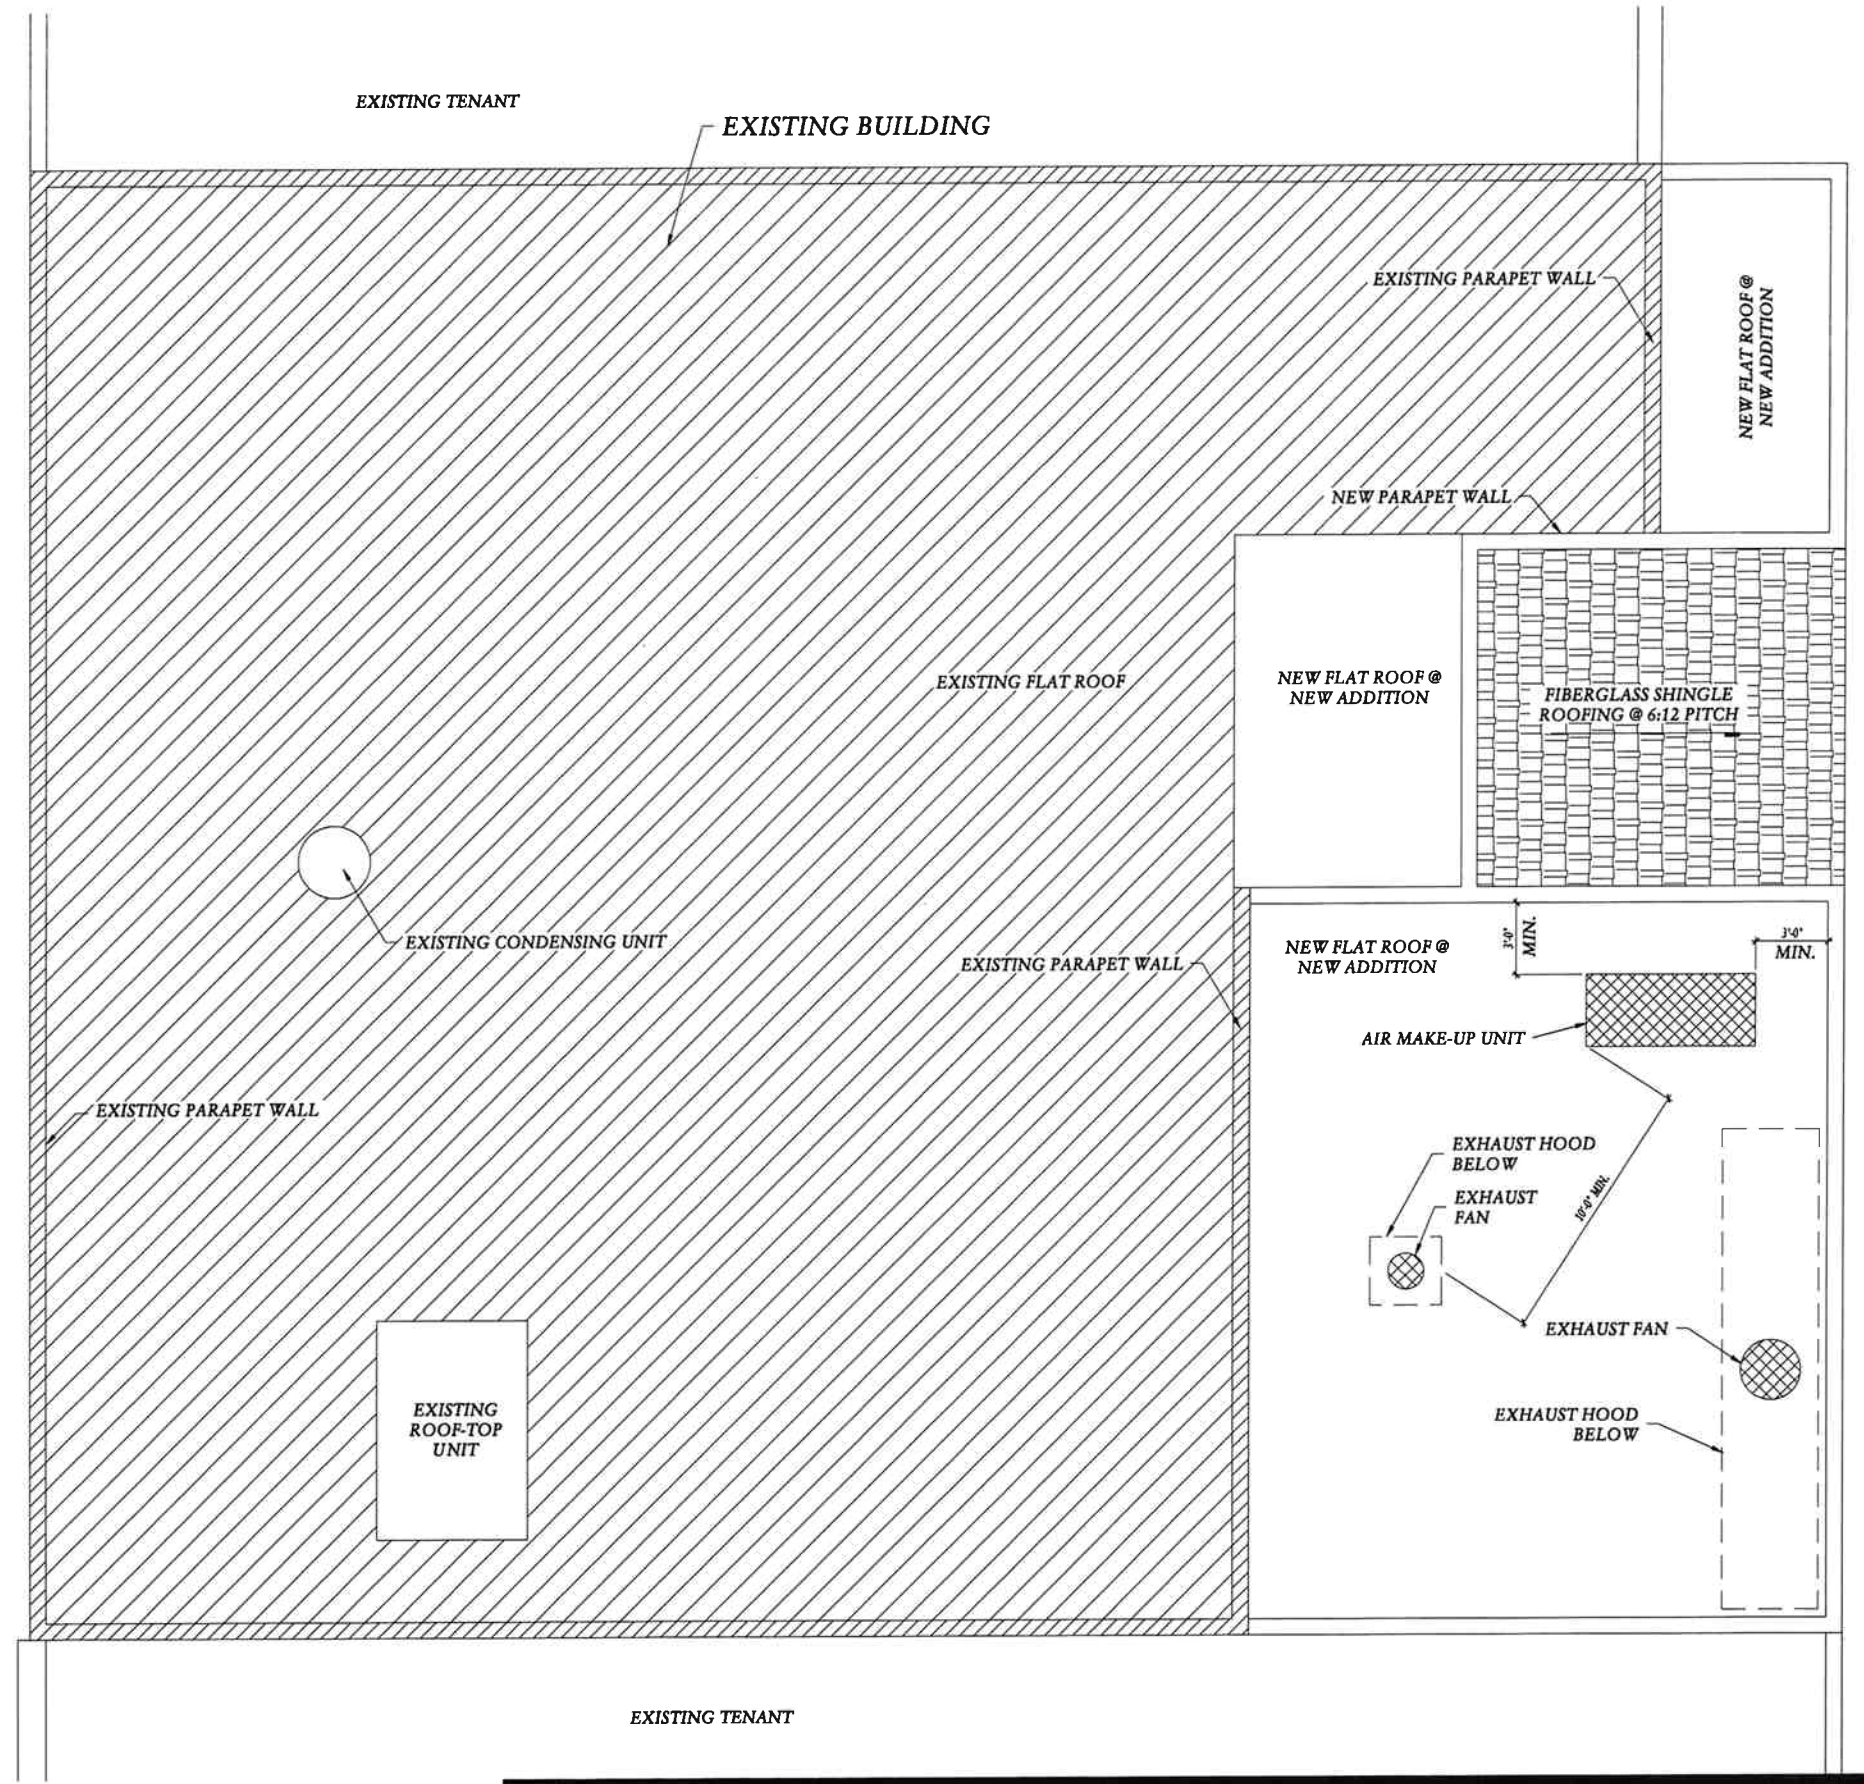

PROPOSED SITE PLAN & ROOF PLAN (HVAC EQUIPMENT LOCATIONS)

1/8" = 1'-0"

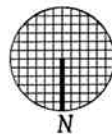

BARRY C. J. YANG ARCHITECT, AIA


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| BCJY | 400 |

FLOOR PLAN - SYMBOLS LEGEND



FLOOR PLAN - GENERAL NOTES

- A. DIMENSIONS ON FLOOR PLAN ARE BASED ON FACE OF FINISHED WALL TO FACE OF FINISHED WALL (NOMINAL).
- B. VERIFY ALL DIMENSIONS AND CONDITIONS AT JOB SITE. PORTIONS OF EXISTING CONSTRUCTION MAY HAVE BEEN REMOVED BY OWNERS.
- C. MAINTAIN CONTINUOUS UTILITY SERVICE TO ALL SPACES IN THE BUILDING NOT AFFECTED BY THIS WORK. COORDINATE WITH OWNER ANY DISRUPTION IN SERVICES REQUIRED TO PERFORM WORK OR TO MODIFY EXISTING PIPING, DUCTWORK OR ANY ASSOCIATED EQUIPMENT.
- D. REFER TO SHEET 800 FOR ROOM FINISH SCHEDULE AND NOTES. REFER TO SHEET 800 FOR DOOR SCHEDULES, DOOR TYPES, AND NOTES.

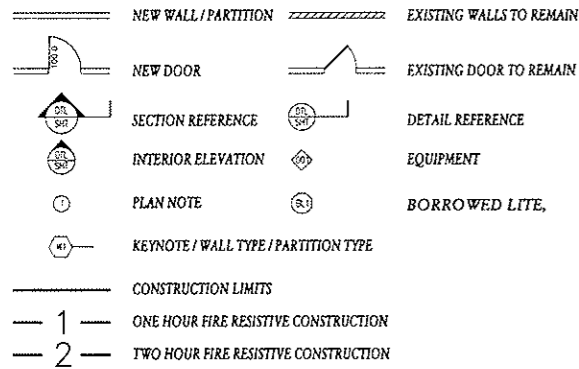GYPSON BOARD PARTITION SCHEDULE

- SOUND PARTITION
- A4 3 1/2" STEEL STUDS @ 16" OC W/ 3 1/2" SOUND ATTENUATION INSUL & 5/8" GYP BD @ EACH FACE.
 - A6 6" STEEL STUDS @ 16" OC W/ 6" SOUND ATTENUATION INSUL & 5/8" GYP BD @ EACH FACE.


GYPSON BOARD PARTITION GENERAL NOTES

- ALL GYPSON BOARD PARTITIONS SHALL BE UNLESS OTHERWISE NOTED ON FLOOR PLAN.
- GYPSON BOARD PARTITION DIMENSIONS ON FLOOR PLAN ARE BASED ON FACE OF FINISHED PARTITION TO FACE OF FINISHED PARTITION (NOMINAL).
- EXTEND ALL GYPSON BOARD PARTITIONS FULL HEIGHT TO UNDERSIDE OF METAL DECK ABOVE. AT METAL DECK CONSTRUCTION ABOVE PROVIDE SLIP JOINT BETWEEN TOP OF PARTITION AND UNDERSIDE OF METAL DECK ABOVE.

KITCHEN EQUIPMENT LIST


| | |
|----|---|
| 1 | GAS FRYER |
| 2 | S.S. WORK TABLE (TO BE DETERMINED) |
| 3 | WOK STOVE (3'-9X6'-3") W/ EXHAUST HOOD ABOVE (4'-0" X 20'-0") |
| 4 | GAS FRY PAN (4'-0" X 3'-0") |
| 5 | GAS OVEN (3'-0" X 3'-0") |
| 6 | RICE COOKER |
| 7 | PREP. COOLER (5'-0" X 3'-0") |
| 8 | 3-COMP SINK UNIT (9'-0" X 2'-7") |
| 9 | GREASE TRAP (LOCATION TO BE DETERMINED) |
| 10 | WALK-IN FREEZER (8'-0" X 8'-0") |
| 11 | WALK-IN COOLER (10'-0" X 8'-0") |
| 12 | ICE MAKER (2'-8" X 2'-8") |
| 13 | DISH WASHER (2'-8" X 2'-8") W/ EXHAUST HOOD ABOVE (3'-0" X 3'-0") |
| 14 | S.S. HAND SINK |
| 15 | FOOD PREP. SINK (PROVIDE MIN 1" AIR-GAP TO DRAIN PIPE) |
| 16 | MOB SINK |

PROPOSED FIRST FLOOR PLAN
1/8"=1'-0"

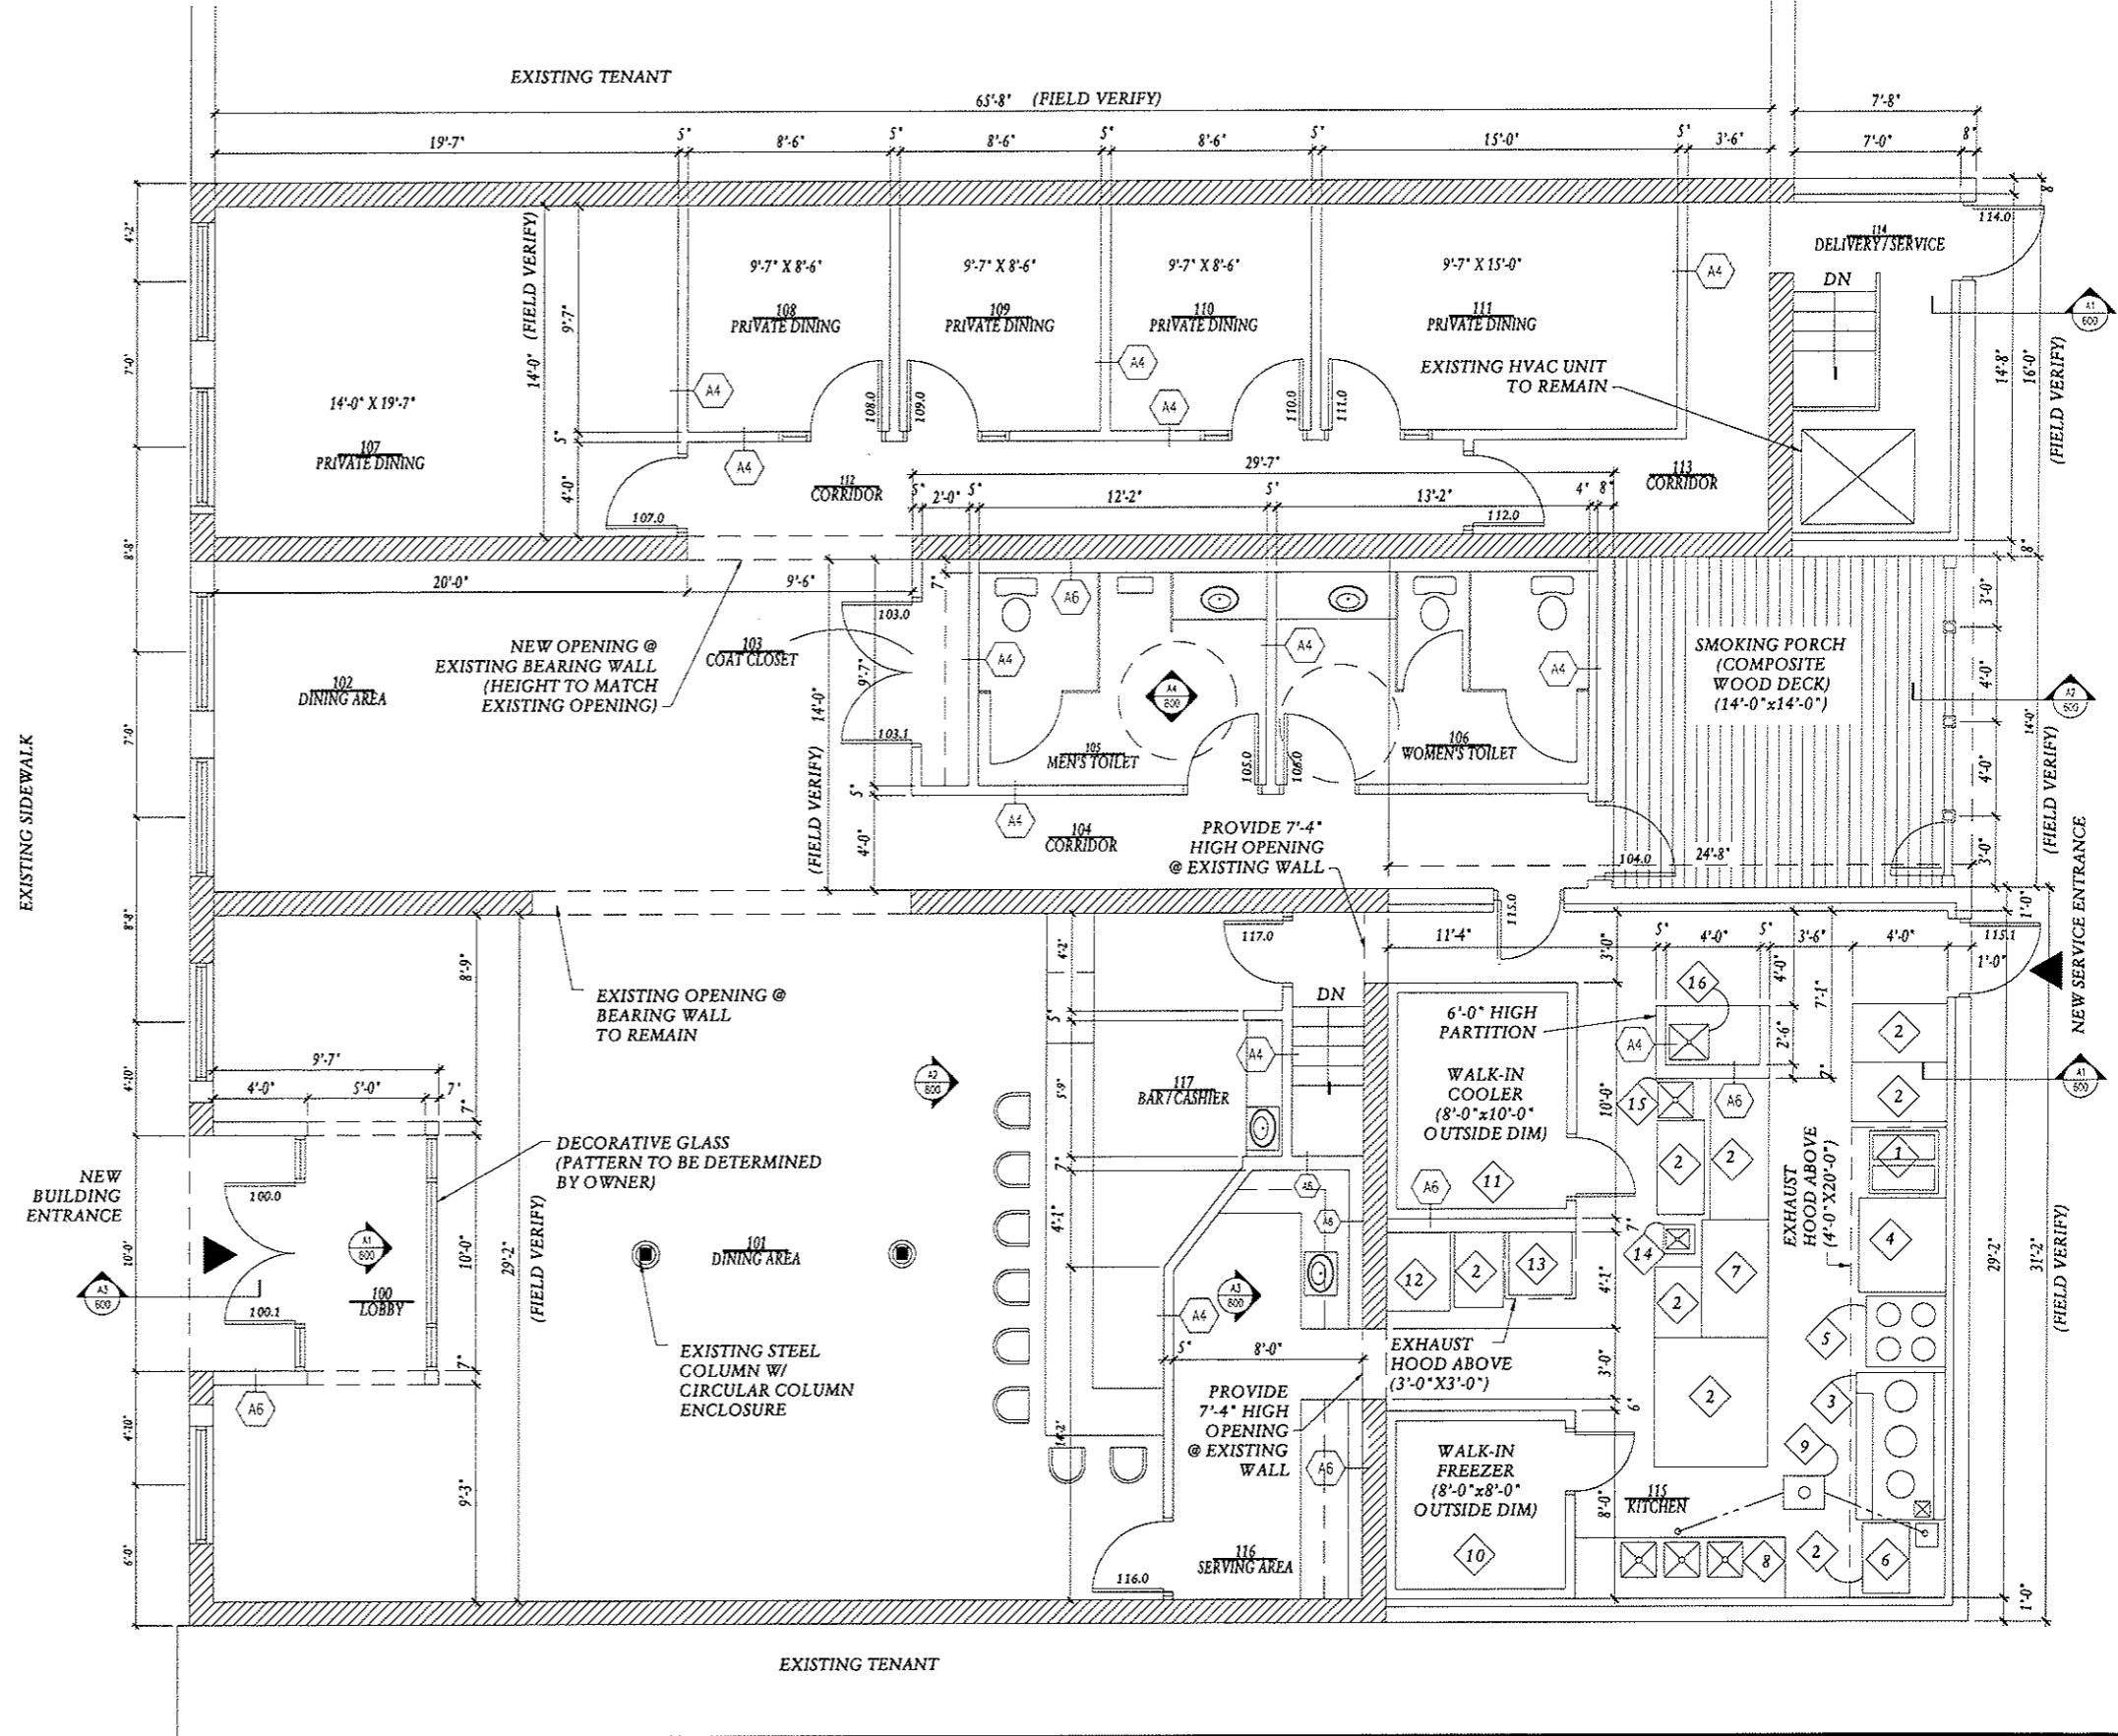


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| | DRAWN BY BCY | SHEET NUMBER 200 | |

NOTE:
ALL KITCHEN EQUIPMENT TO BE PURCHASED BY OWNER & INSTALLED BY CONTRACTOR

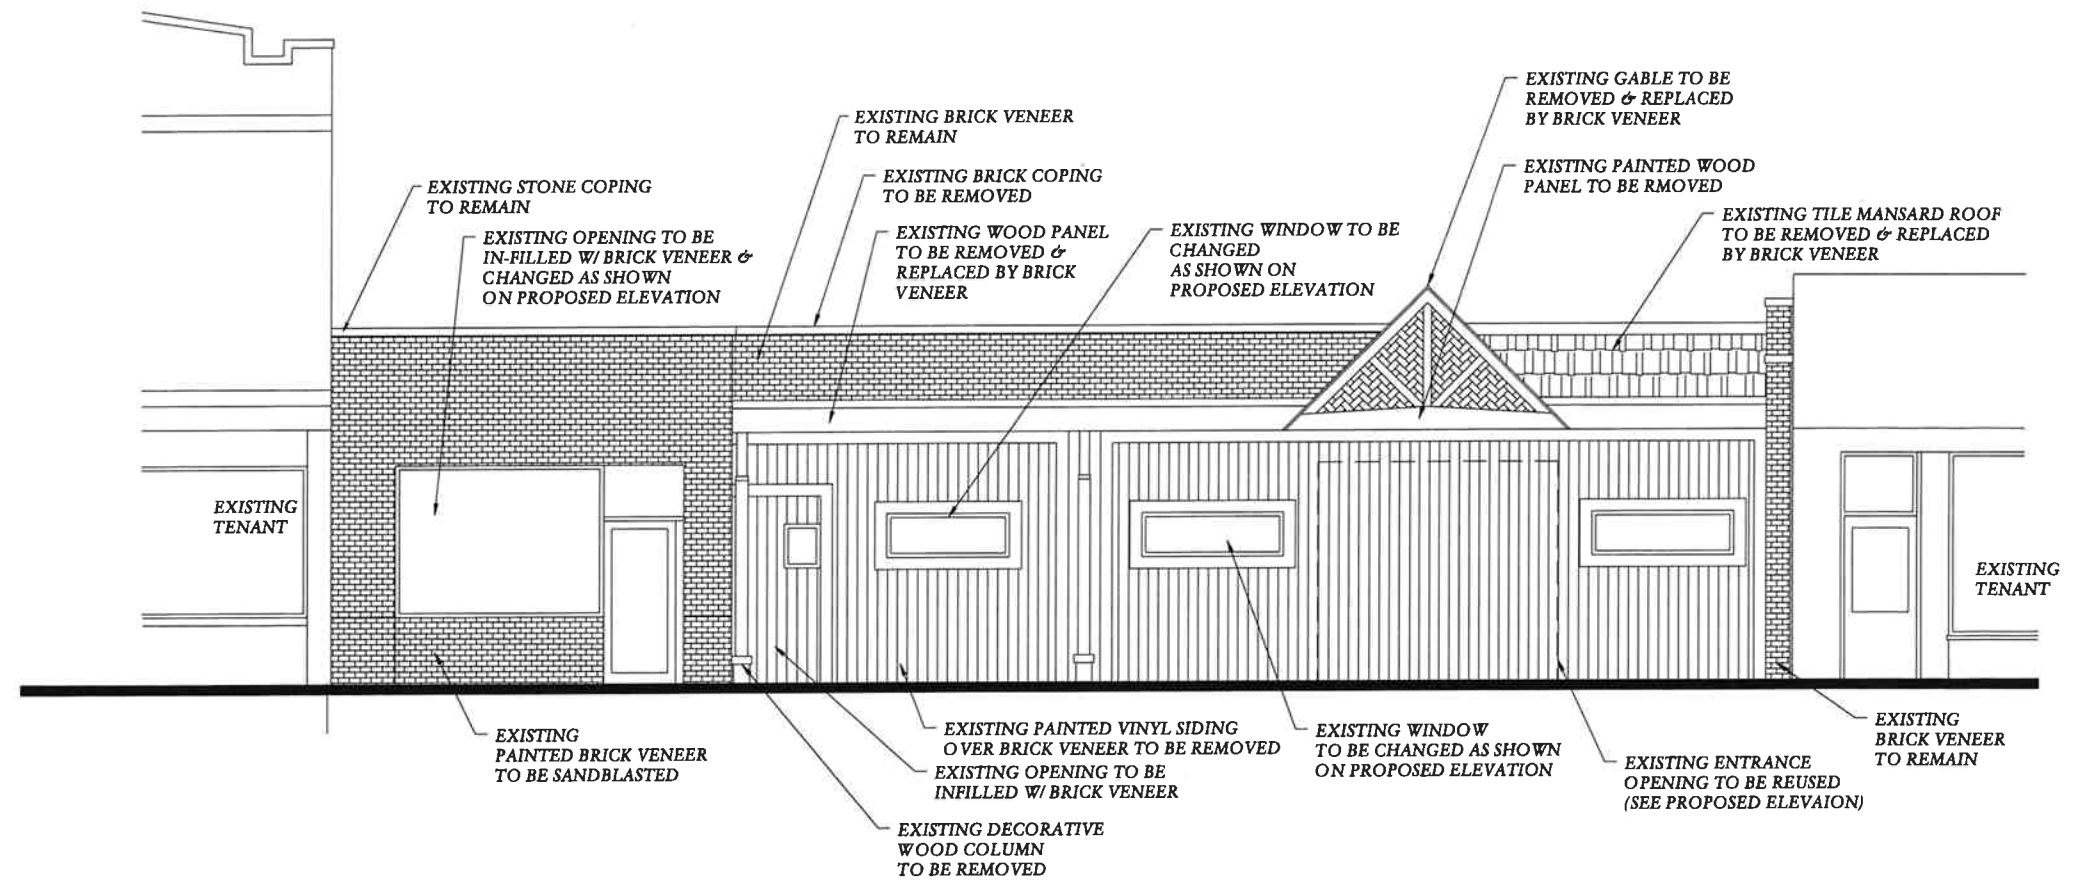

GENERAL NOTE:
 ALL EXISTING WALL SIGNS & AWNINGS TO BE REMOVED
 (NOT SHOWN ON ELEVATION)

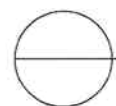

EXISTING BUILDING ELEVATION

1/8"=1'-0"

BARRY C. J. YANG ARCHITECT, AIA











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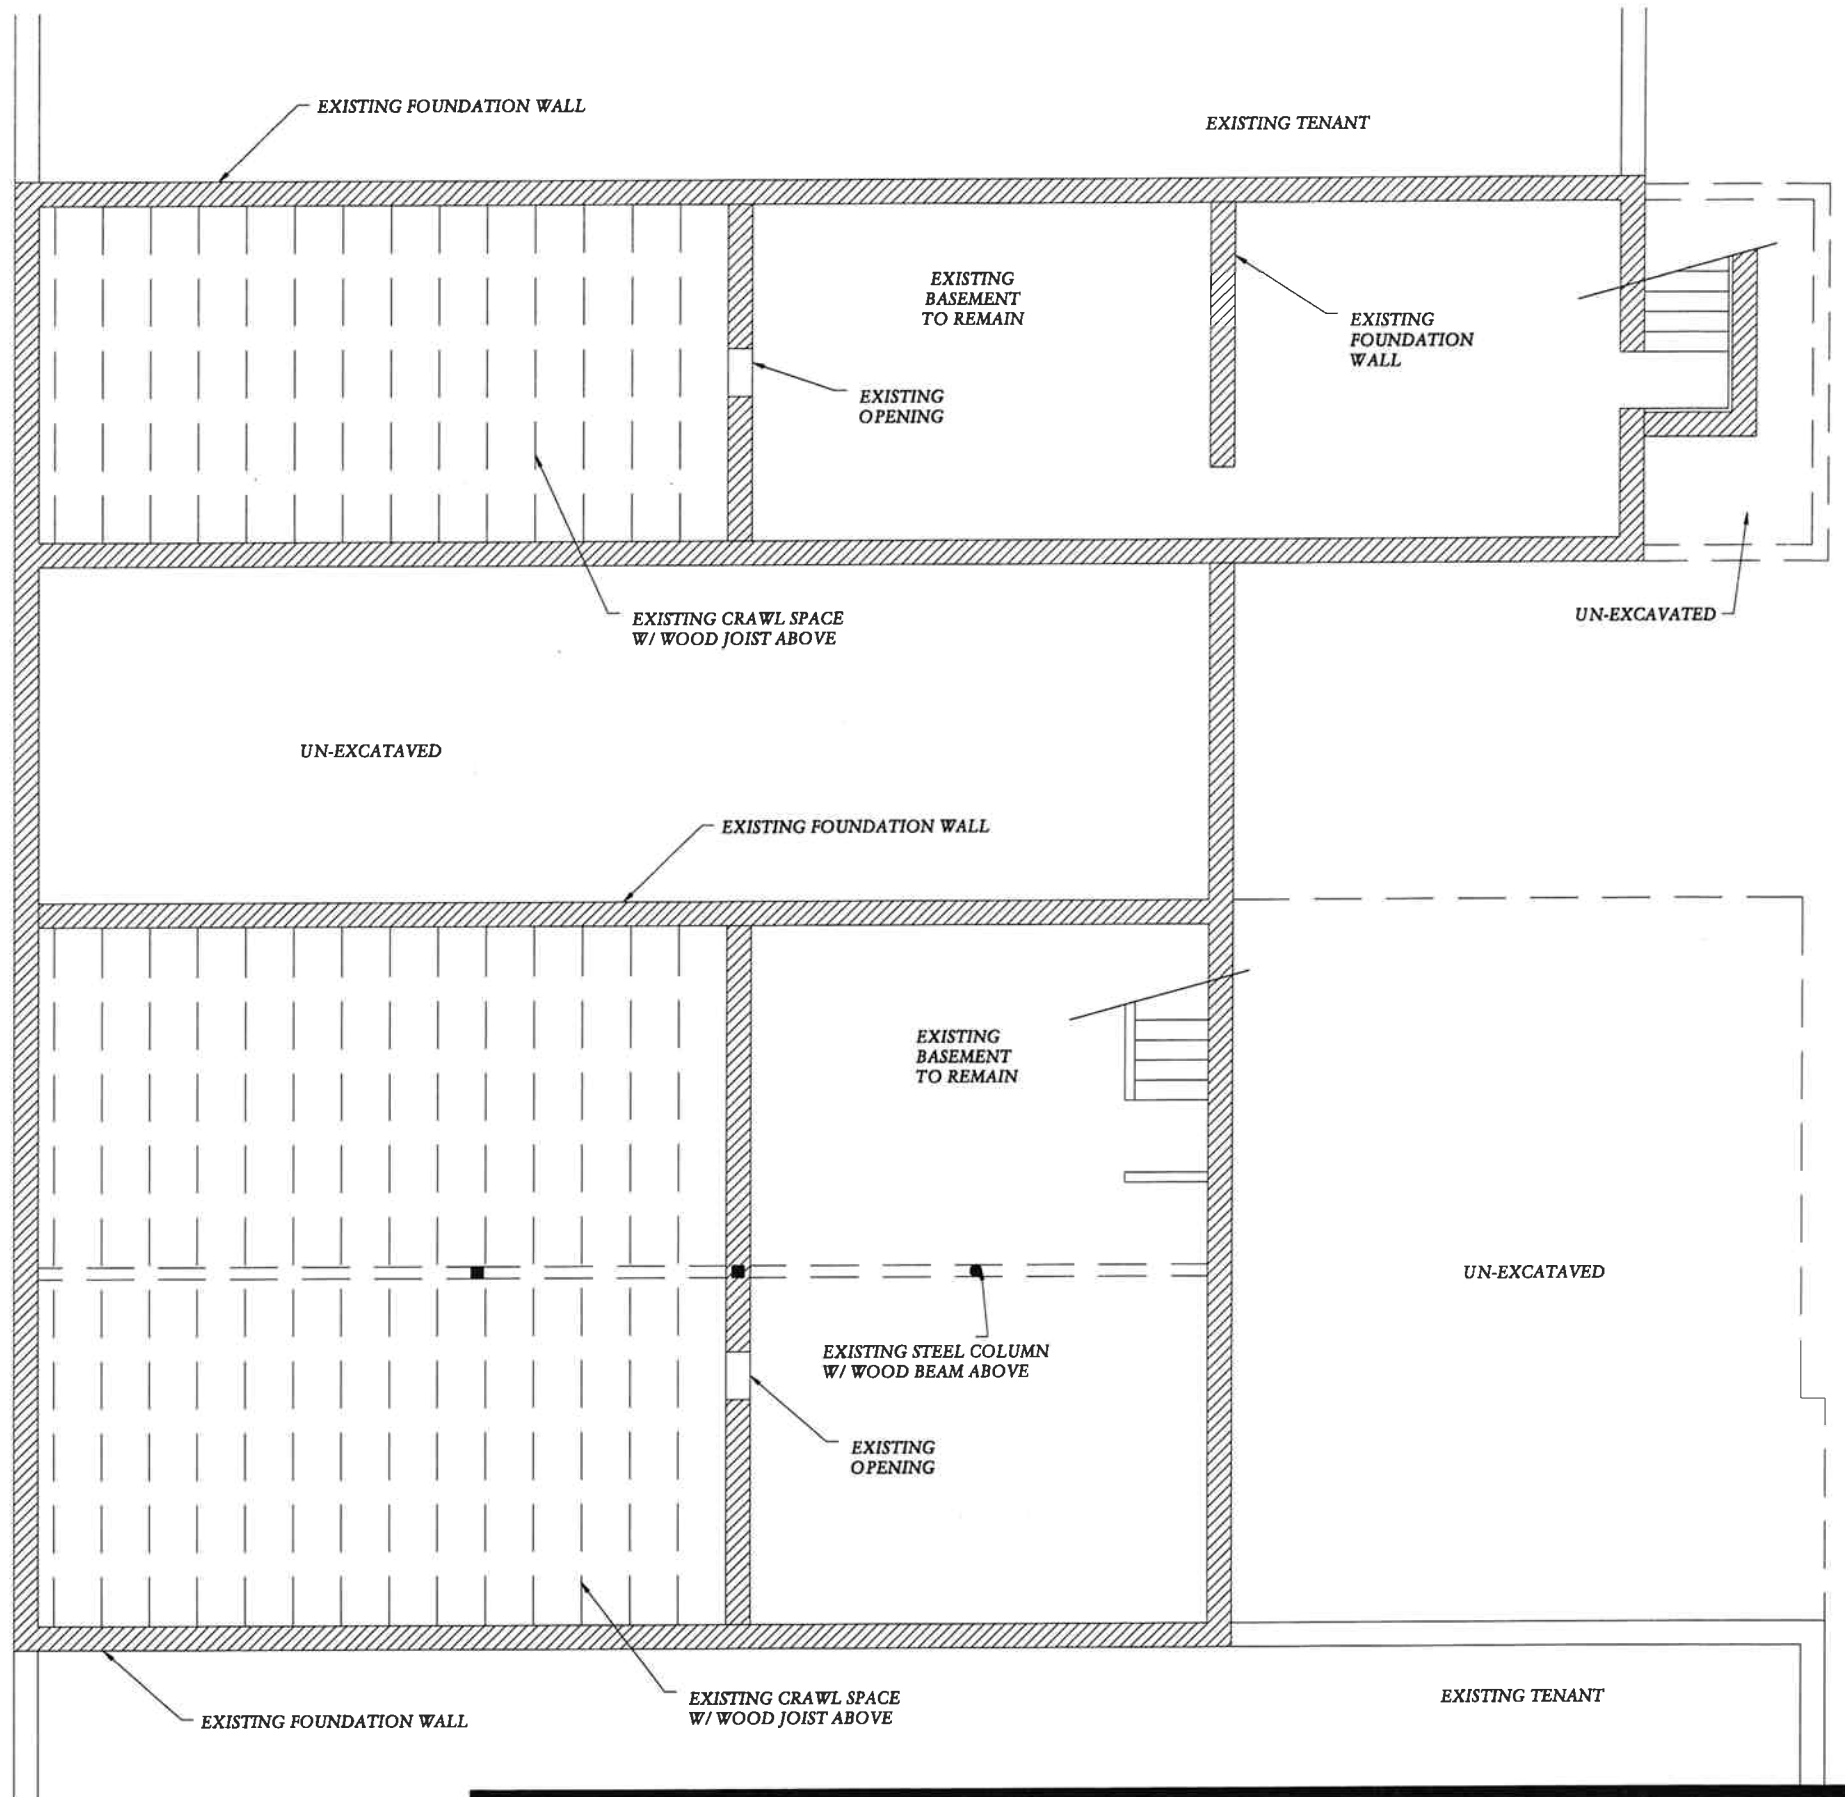
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| DATE | JOB NUMBER |
| 5-14-2008 | 08011 |
| DRAWN BY | SHEET NUMBER |
| BCY | 102 |

DEMOLITION PLAN - SYMBOLS LEGEND


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-  EXISTING ITEM TO REMAIN
-  EXISTING ITEM TO BE REMOVED
-  DEMOLITION PLAN NOTE
-  CONSTRUCTION LIMITS
-  EXISTING CMU PARTITION
-  EXISTING GYPSUM BOARD PARTITION

DEMOLITION PLAN - GENERAL NOTES

- A. VERIFY ALL DIMENSIONS AND CONDITIONS AT JOB SITE. PORTIONS OF EXISTING CONSTRUCTION MAY HAVE BEEN REMOVED BY OWNER.
- B. VERIFY EXACT COMPOSITION OF EXISTING WALLS TO BE REMOVED.
- C. REMOVE SUSPENDED CEILINGS AND RELATED HANGERS, OR GYPSUM BOARD/ PLASTER CEILINGS WHERE NEW CEILINGS ARE INDICATED ON REFLECTED CEILING PLAN OR ROOM FINISH SCHEDULE.
- D. REMOVE ALL INTERIOR AND WALL MOUNTED ITEMS IN AREAS TO BE REMODELED (REFER TO ROOM FINISH SCHEDULE) INCLUDING BUT NOT LIMITED TO, CABINETS, EQUIPMENT, LOCKERS, TOILET PARTITIONS, SHELVING, HOOKSTRIPS, HANDRAILS, CLOSET POLES, CHALK AND TACK BOARDS, MIRRORS, WALL AND CEILING TRIM, BASE.
- E. REFER TO PLUMBING, HVAC AND ELECTRICAL PLANS FOR ADDITIONAL DEMOLITION ITEMS AND NOTES. COORDINATE WORK WITH PLUMBING, HVAC AND ELECTRICAL REQUIREMENTS.
- F. COORDINATE DEMOLITION OF LOAD BEARING WALLS WITH STRUCTURAL PLANS.
- G. MAINTAIN CONTINUOUS UTILITY SERVICE TO ALL SPACES IN THE BUILDING NOT AFFECTED BY THIS WORK. COORDINATE WITH OWNER ANY DISRUPTION IN SERVICES REQUIRED TO PERFORM WORK OR TO MODIFY EXISTING PIPING, DUCTWORK OR ANY ASSOCIATED EQUIPMENT.
- H. CONSTRUCT A DUST-PROOF PARTITION TO SEPARATE AREAS OF CONSTRUCTION FROM ADJACENT OCCUPIED AREAS OUTSIDE SCOPE OF CONSTRUCTION.



EXISTIN BASEMENT PLAN
1/8" = 1'-0"

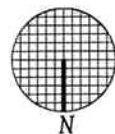











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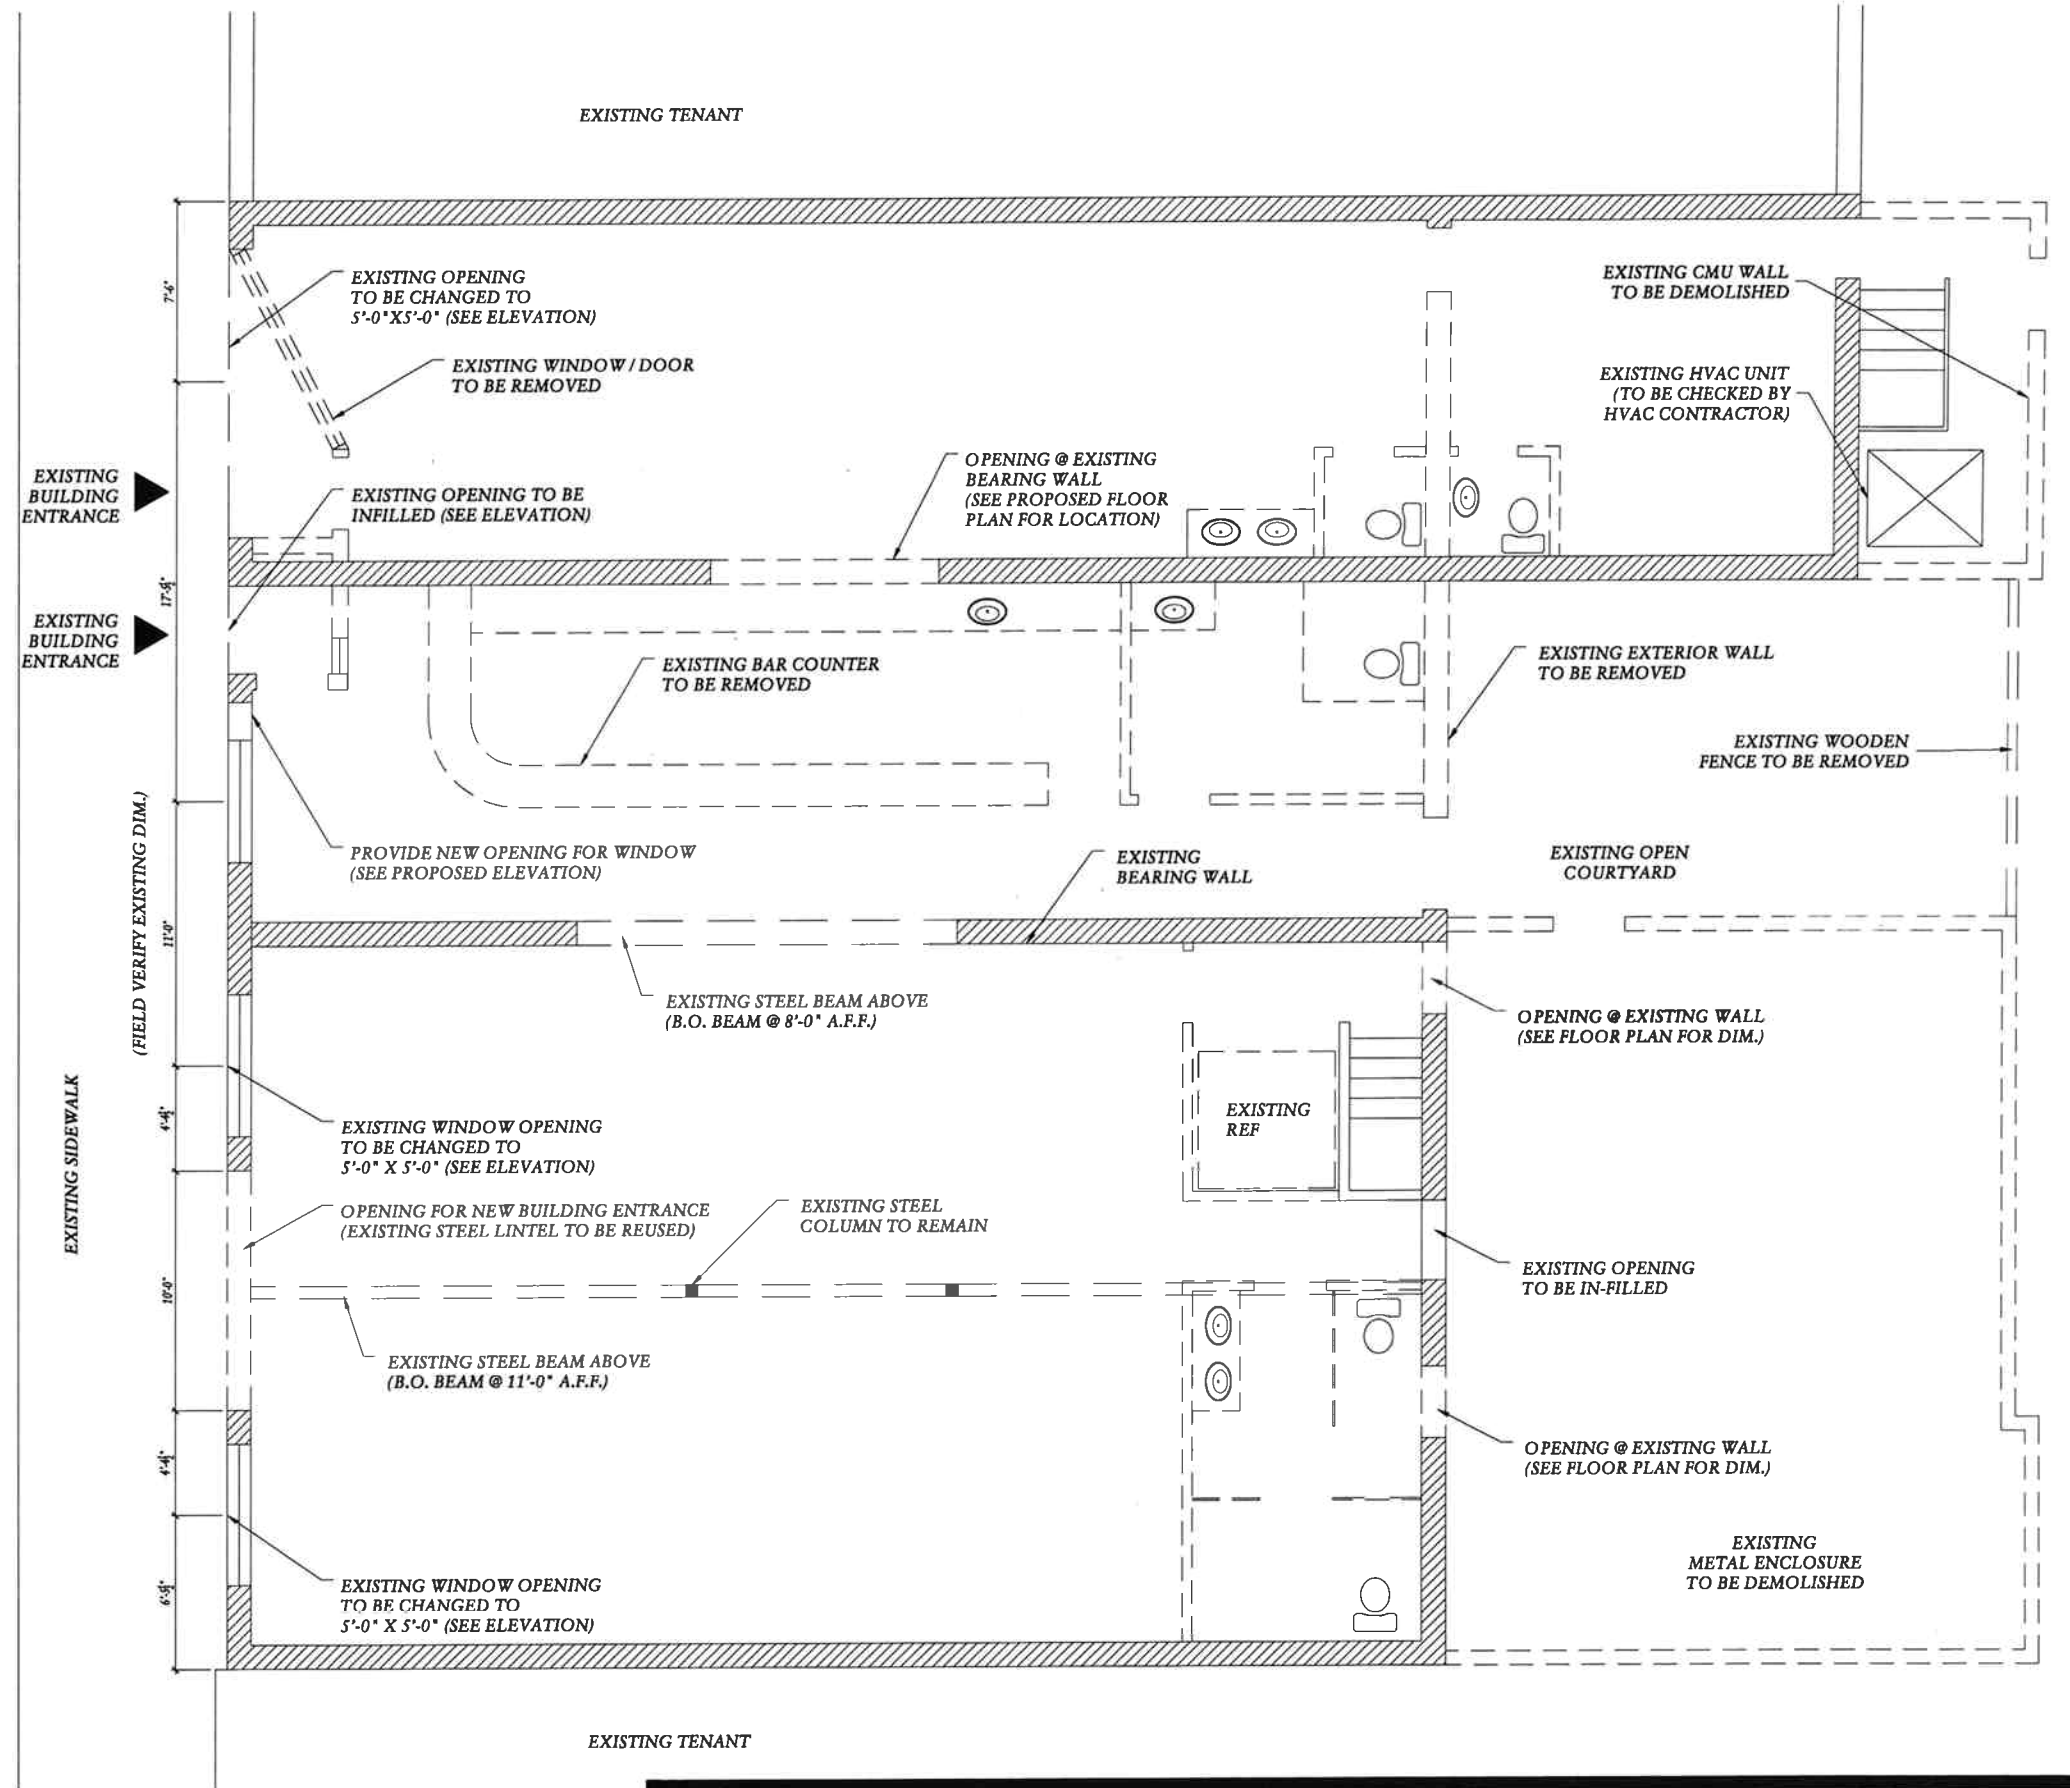
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| DATE | 5-14-2008 | JOB NUMBER | 08011 |
| DRAWN BY | BCY | SHEET NUMBER | 100 |

DEMOLITION PLAN - SYMBOLS LEGEND


-  EXISTING WALLS TO REMAIN
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-  DEMOLITION PLAN NOTE
-  CONSTRUCTION LIMITS
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-  EXISTING GYPSUM BOARD PARTITION

DEMOLITION PLAN - GENERAL NOTES

- A. VERIFY ALL DIMENSIONS AND CONDITIONS AT JOB SITE. PORTIONS OF EXISTING CONSTRUCTION MAY HAVE BEEN REMOVED BY OWNER.
- B. VERIFY EXACT COMPOSITION OF EXISTING WALLS TO BE REMOVED.
- C. REMOVE SUSPENDED CEILING AND RELATED HANGERS, OR GYPSUM BOARD/ PLASTER CEILINGS WHERE NEW CEILINGS ARE INDICATED ON REFLECTED CEILING PLAN OR ROOM FINISH SCHEDULE.
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- F. COORDINATE DEMOLITION OF LOAD BEARING WALLS WITH STRUCTURAL PLANS.
- G. MAINTAIN CONTINUOUS UTILITY SERVICE TO ALL SPACES IN THE BUILDING NOT AFFECTED BY THIS WORK. COORDINATE WITH OWNER ANY DISRUPTION IN SERVICES REQUIRED TO PERFORM WORK OR TO MODIFY EXISTING PIPING, DUCTWORK OR ANY ASSOCIATED EQUIPMENT.
- H. CONSTRUCT A DUST-PROOF PARTITION TO SEPARATE AREAS OF CONSTRUCTION FROM ADJACENT OCCUPIED AREAS OUTSIDE SCOPE OF CONSTRUCTION.



EXISTING FIRST FLOOR PLAN & DEMO PLAN
1/8" = 1'-0"

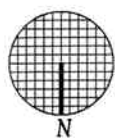


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| | |
|-------------------|---------------------|
| DATE 5-14-2008 | JOB NUMBER 08011 |
| DRAWN BY BCY | SHEET NUMBER 101 |



CONTEXT-1.JPG



CONTEXT-10.JPG

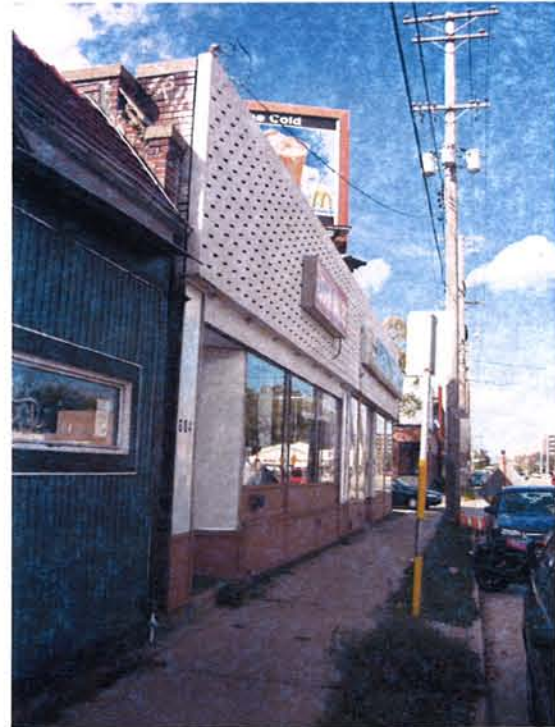

CONTEXT-11.JPG



CONTEXT-12.JPG



CONTEXT-2.JPG



CONTEXT-3.jpg



CONTEXT-4.jpg



CONTEXT-5.JPG



CONTEXT-6.JPG



CONTEXT-7.JPG



CONTEXT-8.JPG



CONTEXT-9.jpg



DETAIL-BUILDING-1.JPG



DETAIL-BUILDING-2.JPG




DETAIL-BUILDING-3.JPG





DETAIL-BUILDING-4.JPG

A: 614 S Park St, Madison, WI 53715-1828

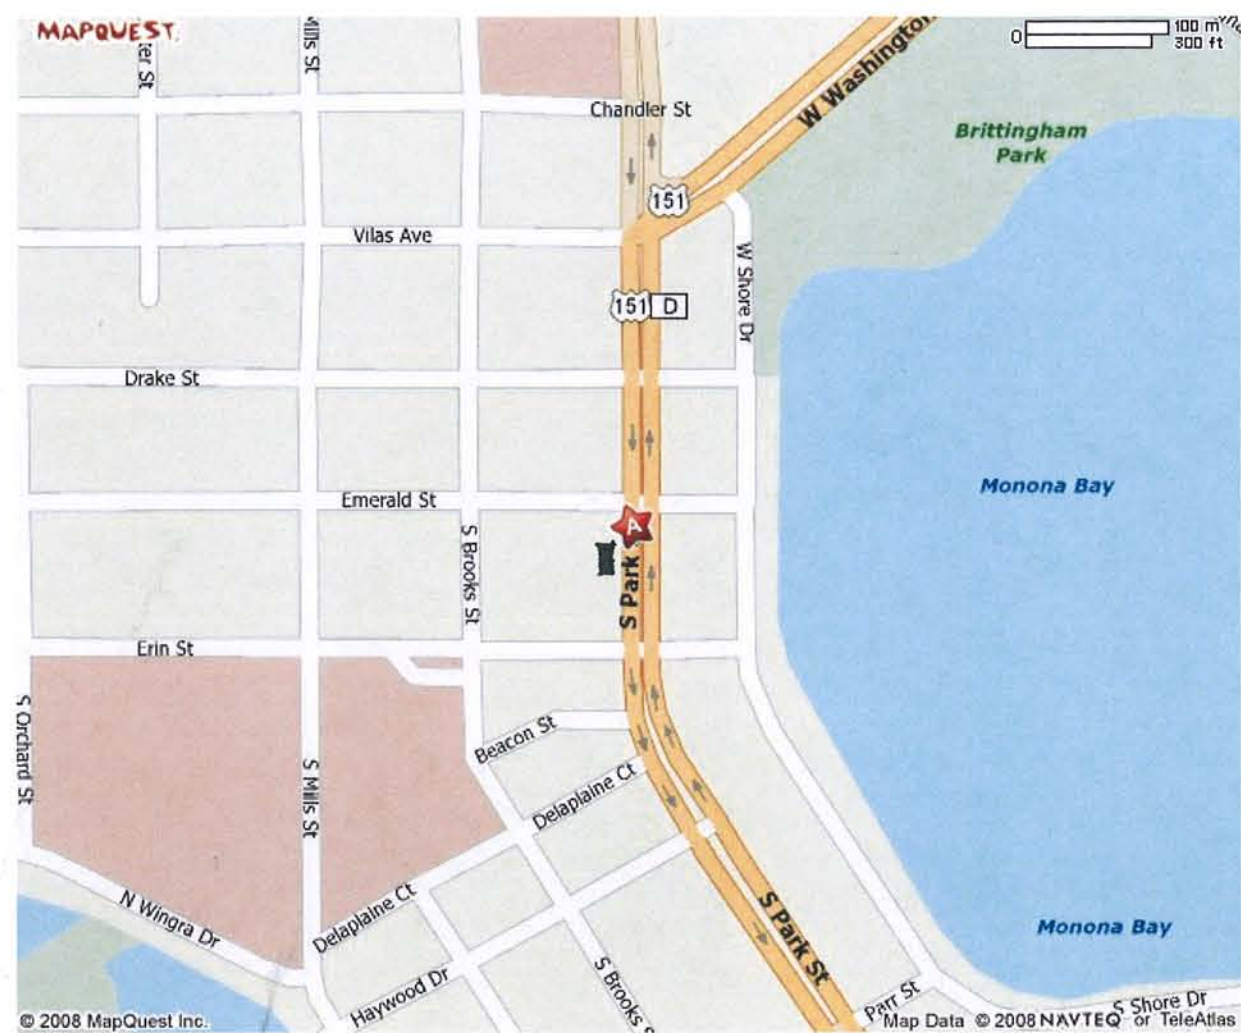

A: 614 S Park St, Madison, WI 53715-1828

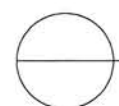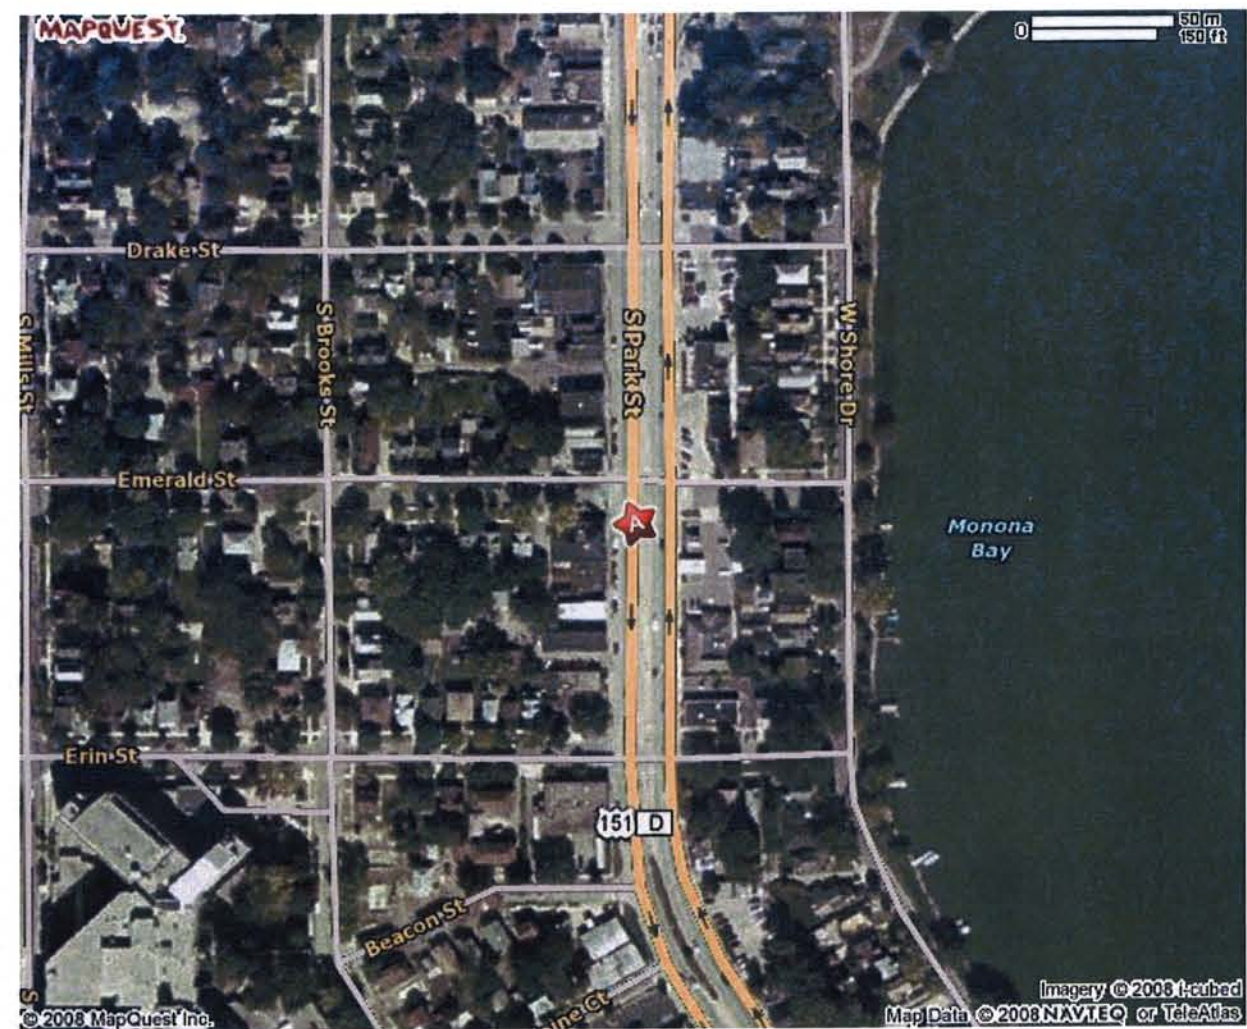

LOCATOR MAP

NOT TO SCALE

BARRY C. J. YANG ARCHITECT, AIA

5559 North Shoreland Avenue,
 Milwaukee, WI 53217
 Phone: (414) 431-3131; Fax: (414) 431-0531
 Email: bcyang@agarch.com

EDO STAKE HOUSE

TENANT IMPROVEMENT & ADDITION
 614 SOUTH PARK STREET
 MADISON, WI 53715

DATE
 5-14-2008

JOB NUMBER
 08011

DRAWN BY
 BCJY

SHEET NUMBER
 MAP

EDO STAKE HOUSE TENANT IMPROVEMENT & ADDITION

SUBMITTALS FOR URBAN DESIGN COMMISSION APPROVAL

EDO STAKE HOUSE
610 & 614 SOUTH PARK STREET
MADISON, WI 53715

DRAWING INDEX

ARCHITECTURAL

000 TITLE SHEET
000-1 LOCATOR MAP
100 EXISTING BASEMENT PLAN
101 EXISTING FIRST FLOOR PLAN & DEMOLITION PLAN
102 EXISTING BUILDING ELEVATION
200 PROPOSED FIRST FLOOR PLAN
400 PROPOSED SITE PLAN & ROOF PLAN
(INCLUDING HVAC EQUIPMENT LOCATIONS)
500 PROPOSED BUILDING ELEVATION & SIGNAGE
500 PROPOSED BUILDING ELEVATION (COLORED)

PROJECT INFORMATION

APPLICABLE CODES AND ZONING:

WISCONSIN ENROLLED COMMERCIAL BUILDING CODE 2005
ASSEMBLY OCCUPANCY, GROUP A-2
ZONING: MADISON ZONING ORDINANCES
ZONING DISTRICT: C2 (GENERAL COMMERCIAL DISTRICT)
RESTAURANTS AS PERMITTED PRINCIPAL USE
MADISON URBAN DESIGN ORDINANCE (URBAN DESIGN DISTRICT NO. 7)

TYPE OF CONSTRUCTION

ALTERATION & ADDITION
- TYPE OF CONSTRUCTION: TYPE III-B-UNPROTECTED
- EXISTING BUILDING IS NOT SPRINKLED
- MAX. BUILDING AREA: 9,500 S.F.
- MAX. BUILDING HEIGHT: 2 STORIES

BUILDING AREA:

REMODEL AREA: 3,312 SQ. FT.
ADDITION AREA: 1,032 SQ. FT.
TOTAL BUILDING AREA: 4,344 SQ. FT.
TOTAL BUILDING VOLUME: 4,344 S.F. X 13'-0" (H) = 56,472 CU. FT.

OCCUPANT LOAD:

DINING AREA (2,436 S.F.): 163 (BASED ON 15 S.F. PER OCCUPANT)
KITCHEN (1,073 S.F.): 6 (BASED ON 200 S.F. PER OCCUPANT)
ACCESSORY (835 S.F.): 3 (BASED ON 300 S.F. PER OCCUPANT)
TOTAL: 172 (DESIGN CAPACITY)

PARKING REQUIREMENTS:

EXISTING STREET PARKING TO REMAIN AS IS

ADA ACCESS ROUTE :

REFER TO SHEET 200

EXITING:

REQUIRED AGGREGATE EXIT WIDTH: 34.4" (BASED ON 0.2" PER OCCUPANT)
PROPOSED AGGREGATE EXIT WIDTH: 144"

SANITARY FACILITIES REQUIREMENTS:

| WOMEN | REQUIRED FIXTURES | PROVIDED |
|-------|-------------------|----------|
| W.C. | 1 PER 75 = 2 | 2 |
| LAVS | 1 PER 200 = 1 | 1 |

| MEN | REQUIRED FIXTURES | PROVIDED |
|------|-------------------|----------|
| W.C. | 1 PER 75 = 2 | 2 |
| LAVS | 1 PER 200 = 1 | 1 |

| JANITOR CLOSET | REQUIRED | PROVIDED |
|----------------|----------|----------|
| SERVICE SINK | 1 | 1 |

PROJECT TEAM

KITCHEN EQUIPMENT

T:
F:
ISSUED FOR INFORMATION ONLY
UNDER SEPARATE CONTRACT WITH OWNER

BUILDING OWNER

EDO GARDEN, MADISON, WI T: (608) 226-9828
F: (608) 226-9830

STRUCTURAL ENGINEER

J. ROBBINS & ASSOCIATES, INC. T: (262) 567-5380
F: (262) 567-5471

GENERAL CONTRACTOR

TO BE DETERMINED T:
F:

HVAC CONTRACTOR

TO BE DETERMINED T:
F:

PLUMBING CONTRACTOR

TO BE DETERMINED T:
F:

ELECTRICAL CONTRACTOR

TO BE DETERMINED T:
F:

BARRY C. J. YANG ARCHITECT, AIA

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Milwaukee, WI 53217
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EDO STAKE HOUSE

TENANT IMPROVEMENT & ADDITION
614 SOUTH PARK STREET
MADISON, WI 53715

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| DRAWN BY | SHEET NUMBER |
| BCJY | 000 |


MODEL SL1 MR16 SIGN LIGHT 50W 12V

Vision3
lighting



Shown in Style C1
Cap, Black finish.

- Precision machined aluminum construction.
- Designed for easy mounting to industry standard round junction boxes.
- Stem is permanently attached to the canopy using a stainless steel threaded nipple to prevent loosening or sagging.
- Exclusive patented 'Rotate & Lock' double taper knuckle features rotational aiming and ensures positive locking.
- Available in 4 cap styles. C2 & C4 caps contain a weep hole for drainage. Caps accept up to three lens accessories.
- Tempered glass lens sealed with high-temp silicone adhesive.
- MR16 halogen lamp. 50W max.
- Available in 14 standard TGIC polyester powder coat finishes. RAL and custom colors are available.
- High-temp silicone o-ring seals.
- Porcelain bi-pin socket rated 250°C with 18 ga. Teflon® coated leads.
- Stainless steel hardware.
- Remote transformer required.

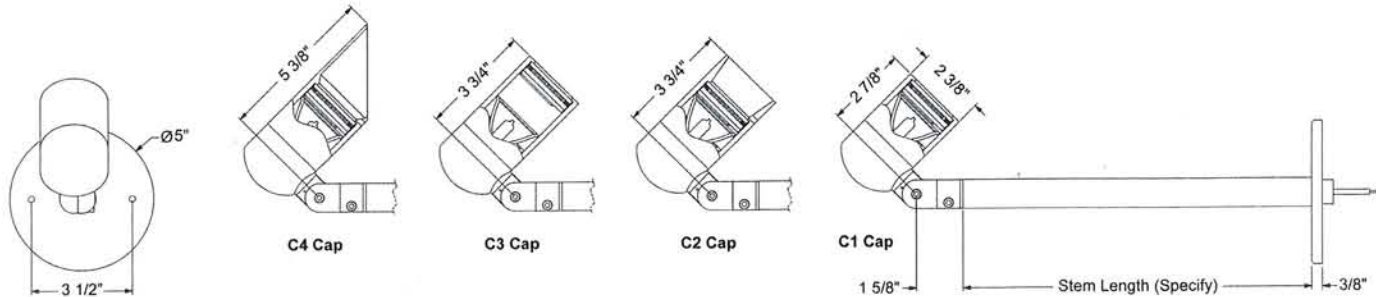

HOW TO SPECIFY: Example: SL1A-SI-C1-18-09-0-F2-H1

| | | | | | | | |
|-------|--------|-----------|-------|------|----------------|--------|--------|
| SL1A | SI | C1 | 18 | 09 | 0 | F2 | H1 |
| Model | Finish | Cap Style | Stem* | Lamp | Lens Accessory | Filter | Louver |


| | | | | | | | |
|-----------------|---|--|---|--|---|---|-----------------------------------|
| SL1A - Aluminum | BL - Black BLT - Textured Black BN - Bronze BNT - Textured Bronze BAT - Textured Bark WI - White GRT - Textured Green SI - Silver GY - Grey BE - Beige GNT - Textured Granite SAT - Textured Sand PAT - Textured Patina EAT - Textured Earth | C1 - Flush Lens C2 - Regress Lens C3 - Regress Lamp C4 - 45° Angled | 12 - 12" Stem 18 - 18" Stem 24 - 24" Stem 30 - 30" Stem 36 - 36" Stem 42 - 42" Stem 48 - 48" Stem | 0 - None 01 - ESX 20W 12° N Spot 02 - BAB 20W 40° Flood 03 - FRB 35W 12° N Spot 04 - FRA 35W 23° N Flood 05 - FMW 35W 40° Flood 06 - EYR 42W 12° N Spot 07 - EYS 42W 23° N Flood 08 - EYP 42W 40° Flood 09 - EXT 50W 13° N Spot 10 - EXZ 50W 26° N Flood 11 - EXN 50W 40° Flood 12 - FNV 50W 60° W Flood | 0 - None L1 - Spread Lens L2 - Linear Lens L3 - Softening Lens | 0 - None F1 - Red F2 - Blue F3 - Light Blue F4 - Green F5 - Amber F6 - Pink | 0 - None H1 - Honeycomb Louver |
|-----------------|---|--|---|--|---|---|-----------------------------------|

* - Other stem lengths are available upon request (due to weight and safety issues, the maximum allowable stem length is 48"). Consult your Vision3 Lighting sales representative.



Vision3 Lighting Tel: 559.834.5749 Fax: 559.834.4779 vision3lighting.com

eSconce™

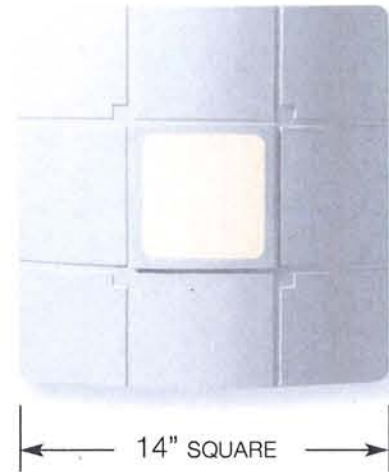

14" SQUARE

ES1 - uplight or downlight

ES2 - uplight + downlight

Lamps

- Metal Halide - 50 to 175 watts, ED-17 and T-6 lamps
- High Pressure Sodium - 50 to 150 watts, ED-17 lamps

ES3 - uplight, downlight or uplight + downlight

Lamps


- Compact Fluorescent: 1 or 2 PLT lamps 26, 32 or 42 watt




Optical Systems

The ES1 and ES2 are available with four precise optical systems for use with metal halide or high pressure sodium lamps. The T-6 ceramic metal halide lamps can be specified to ensure color accuracy and consistency. The ES3 utilizes 42 watt compact fluorescent lamps with a type 3 reflector.


Type 2 Reflector
Wide, Shallow beam

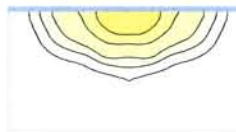

Type 4 Reflector
Forward Throw Beam

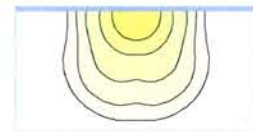

Type 3 Reflector
Medium Throw Beam

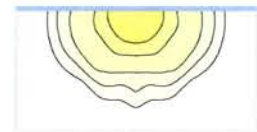

Column Accent
Narrow Short Beam



Optional LDL lens

The lightly diffused lens reduces the overall brightness of the fixture reflector. This lens eliminates discomfort glare when using HID lamps at low mounting heights or when the viewing angle allows a direct line of sight into the reflector.

