Version/Date: DEMO PERMIT

230106

17JAN'23

Printed by:

APPLICATION

DEMOLITION

SEWRIGHTS
lea, WI. 5373

HOUL 1217 Culmen St. Madis www.housewrights.com (608) 238 - 7519

A1

m.t.

A E E

4009 BIRC

FORESTRY NOTES REGARDING STREET TREE:

There is one street tree in the apron infront of the house. The street tree is intended to be preserved and will be protected according to the folloing guidelines


Contractor shall take precautions during construction to not disfigure, scar, or impair the health of any street tree. Contractor shall operate equipment in a manner as to not damage the branches of the street tree(s). This may require using smaller equipment and loading and unloading materials in a designated space away from trees on the construction site. Any damage or injury to existing street trees (either above or below ground) shall be reported immediately to City Forestry at 266-4816. Penalties and remediation shall be required.

As defined by the Section 107.13 of City of Madison Standard Specifications for Public Works Construction: No excavation is permitted within 5 feet of the trunk of the street tree or when cutting roots over 3 inches in diameter. If excavation is necessary, the Contractor shall contact Madison City Forestry (266-4816) prior to excavation. City of Madison Forestry personnel shall assess the impact to the tree and to its root system prior to work commencing. Tree protection specifications can be found on the following website: https://www.cityofmadison.com/business/pw/specs.cfm

On this project, street tree protection zone fencing is required. The fencing shall be erected before the demolition, grading or construction begins. The fence shall include the entire width of terrace and, extend at least 5 feet on both sides of the outside edge of the tree trunk. Do not remove the fencing to allow for deliveries or equipment access through the tree protection

Street tree pruning shall be coordinated with Madison Forestry at a minimum of two weeks prior to the start of construction for this project. All pruning shall follow the American National Standards Institute (ANSI) A300 - Part 1 Standards for pruning.

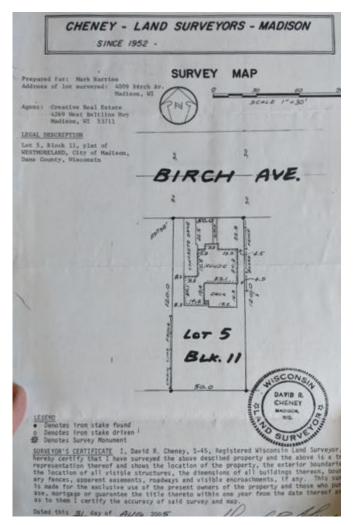Section 107.13(g) of City of Madison Standard Specifications for Public Works Construction addresses soil compaction near street trees and shall be followed by Contractor. The storage of parked vehicles, construction equipment, building materials, refuse, excavated spoils or dumping of poisonous materials on or around trees and roots within five (5) feet of the tree or within the protection zone is prohibited.



SCAN OF SURVEY CANNOT BE PRESENTED TO SCALE

EXISTING HOUSE AREA TABULATIONS MEASURED TO THE OUTSIDE FACE OF STRUCTURE

TO REMAIN

DEMO

EXISTING

GARAGE

6'-0" REQ. SETBACK

7'-11" EXSTG. SETBACK

EXISTING

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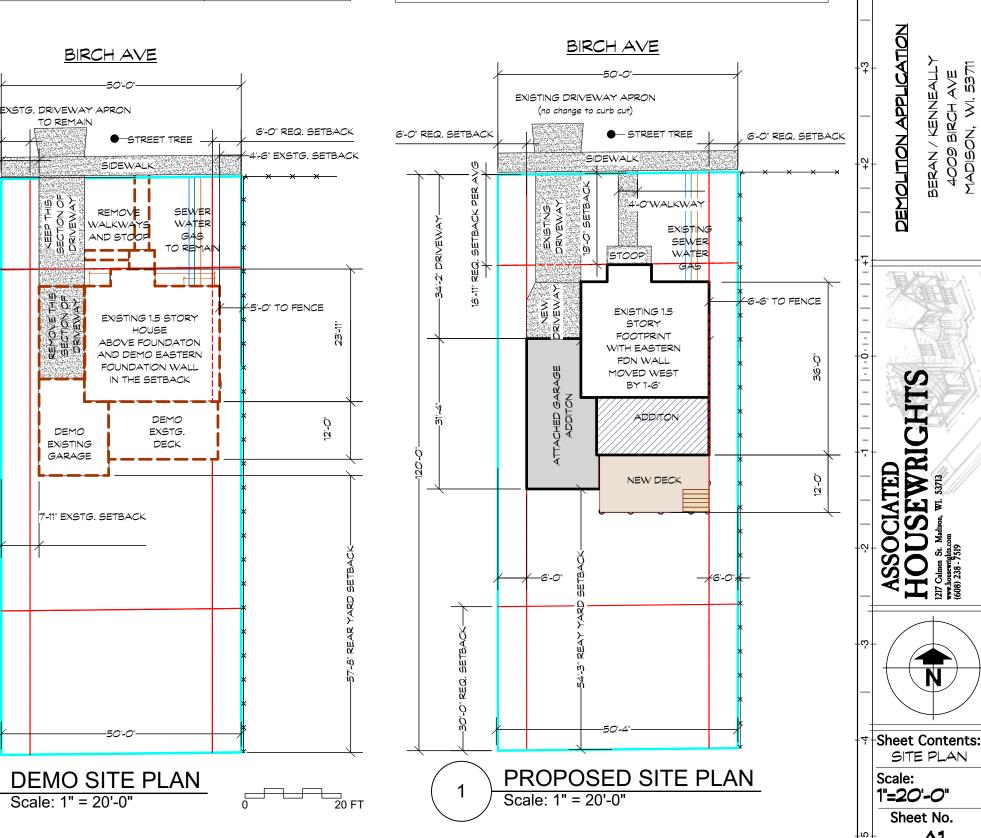
R G

<u>6</u>

UNFINIHSED BASEMENT = 705 SQFT FIRST FLOOR = 705 SQFT SECOND FLOOR = 345 SQFT **TOTAL EXISTING HOUSE = 1,050**

EXISTING HOUSE AREA TABULATIONS MEASURED TO THE OUTSIDE FACE OF STRUCTURE

> UNFINISHED BASEMENT = 950 SQFT FIRST FLOOR = 950 SQFT SECOND FLOOR = 695 SQFT TOTAL PROPOSED HOUSE = 1645 SQFT



· Plan views assume walls have first layer of sheathing on each side (see typical sections) unless otherwise noted.

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· Site verify all dimensions. Report discrepancies to AH Design.

· Larger scaled drawings supersede smaller scale drawings.

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4009 19'-0" front yard setback

4013 17'-5" front yard setback

4017 18'-1" front yard setback

4021 18'-10" front yard setback

4027 23'-3" front yard setback

4029 26'-4" front yard setback



ZONING ANALYSIS


TR-C2 ZONING ANALYSIS	REQUIRED	PROPOSED
LOT AREA.	4,000	6,000
FRONT YARD SETBACK	20'-0" but 18'-11" per averaging	19'-0"
SIDE YARD SETBACK	ONE-STORY:5, TWO-STORY:6	6'-0"
REAR YARD SETBACK	30'-0"	54'-3"
MAX HEIGHT	2 STORIES : 35'-0"	2 STORIES : 23'-9" (avg. of all bldg. facades)
MAX LOT COVERAGE	65%	34%
USEABLE OPEN SPACE	750 SF	2,886 SF

Setback Averaging, Front Setback.

Where at least fifty percent (50%) of the front footage of any block is built up with principal structures, the minimum front yard setback for new structures shall be the average setback of the existing principal structures on the block face or the normal setback requirement in the district whichever is less, but no less than ten (10) feet. Setback averaging on lakefront lots is as specified in Sec. 28.138. For the purpose of calculating the average setback:

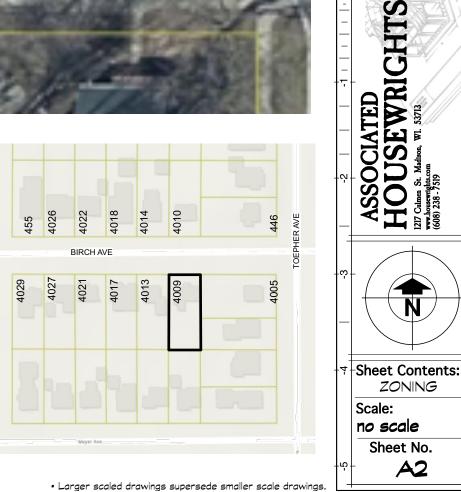- (a) If the setback of an existing structure is greater than the required setback, the required setback shall be used.
- (b) Setback averaging uses only front yard setbacks; side yards and reverse corner side yards on corner lots shall not be included.
- (c) Projection into setbacks shall not be included.
- (d) Setback reductions approved by variance or special exception shall not be included.
- (e) If a block face is at least seventy-five percent (75%) built, a vacant lot on the block face shall not be included.







front/side view



rear yard view

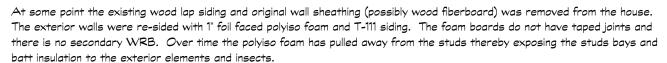
the deck components will be dismanteled, cataloged and re-used for the new construction



front/ west side view




typical condition of windows and trim






east side yard view



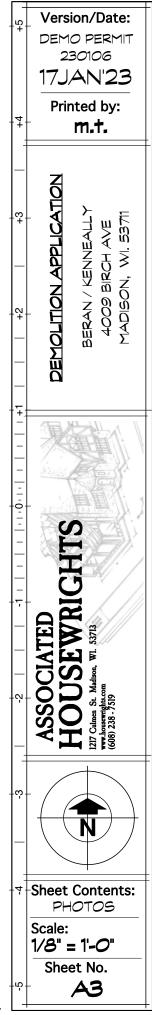


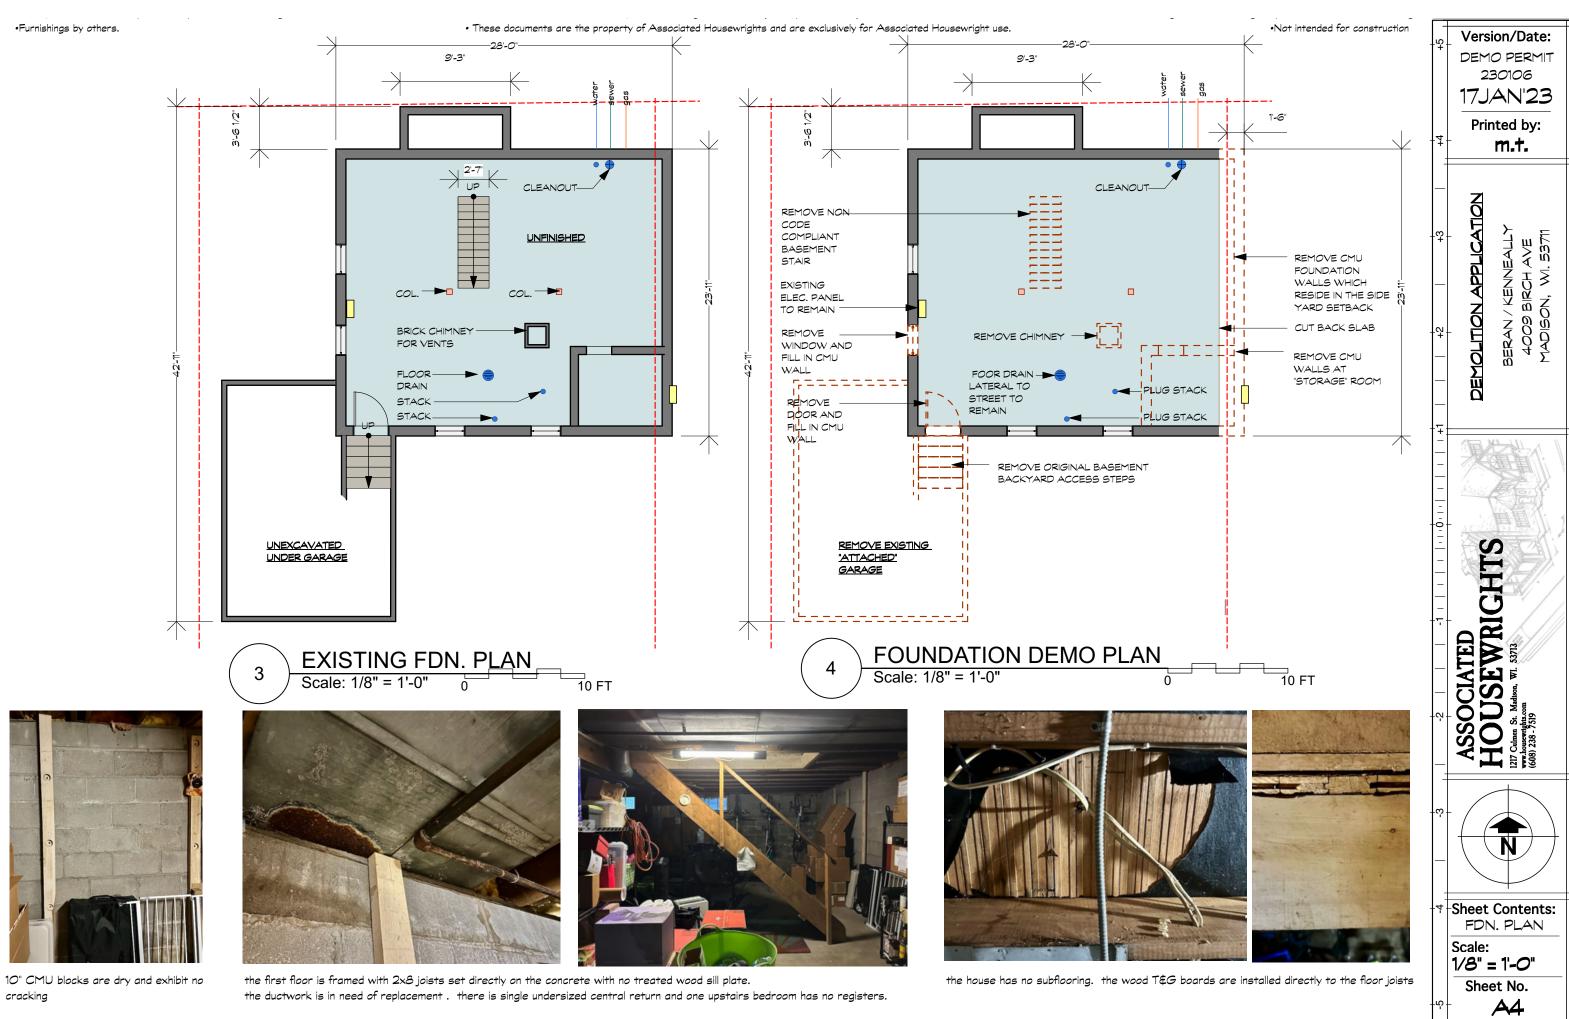



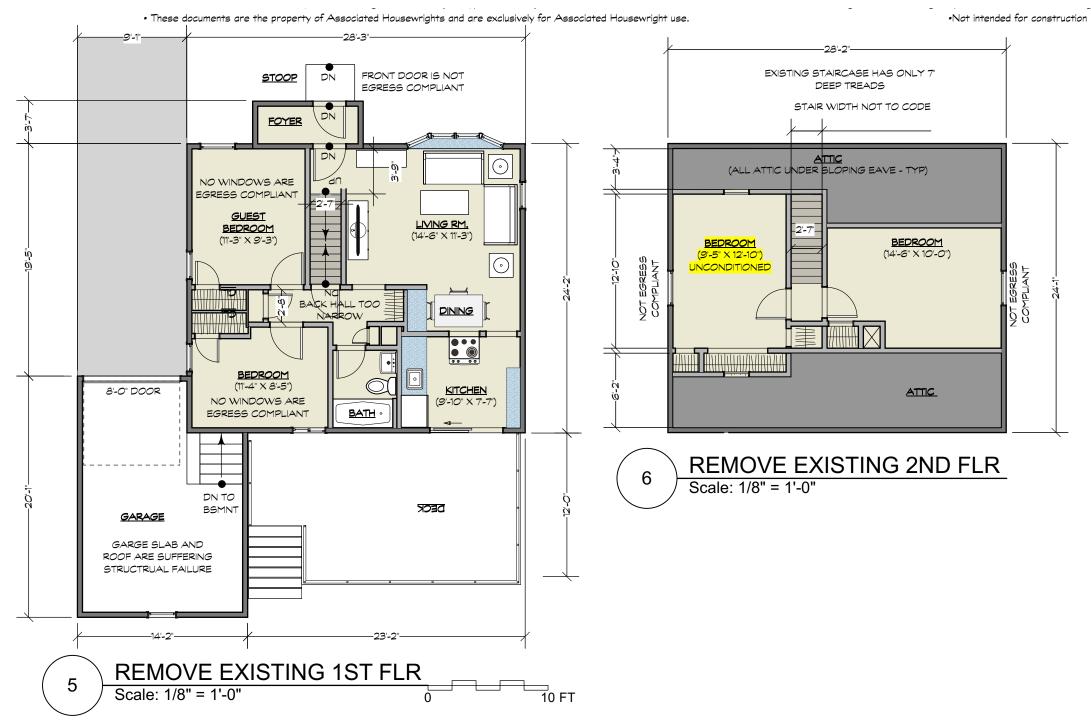garage interior large crack in slab holes in roofing structure is rotten







kitchen



bathroom - clearances are way too tight for modern use staircase



2'-7" wide with 7" deep treads



living & dining room (7-6" clg) back hallway only 2'-7" wide.



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DEMOLITION APPLICATION

ASSOCIATED HOUSEWRIGHTS

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Sheet Contents: UPPER PLANS

Sheet No.

A5

Scale: 1/8" = 1'-0"

BERAN / KENNEALL

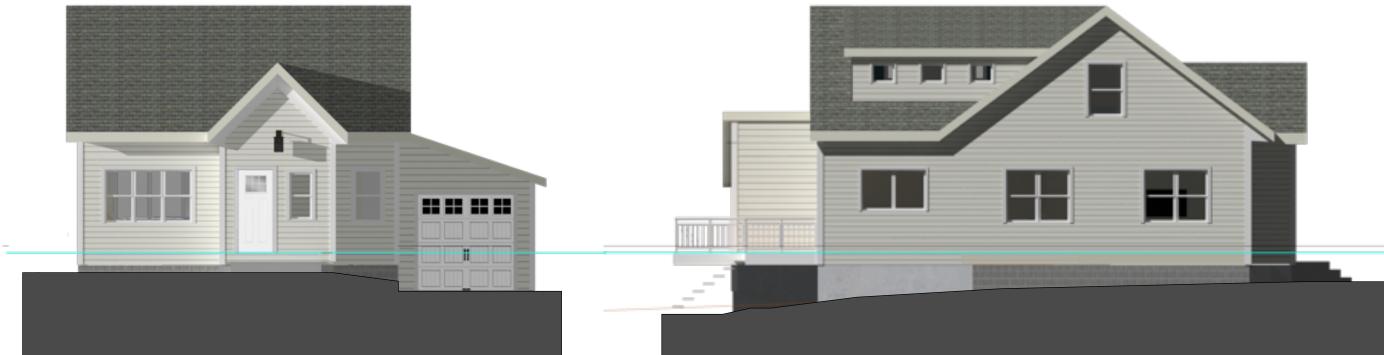
m.t.

SIRCH AVE X, WI. 53711

clearances (lacking ductwork and light switches)

upstairs bedrooms with low ceiling heights and tight

PROPOSED NEW EXTERIOR ELEVATIONS



PROPOSED FRONT
Scale: 1/8" = 1'-0"

PROPOSED EAST SIDE
Scale: 1/8" = 1'-0"



PROPOSED REAR
Scale: 1/8" = 1'-0"


PROPOSEDWEST SIDE
Scale: 1/8" = 1'-0" 13

· Plan views assume walls have first layer of sheathing on each side (see typical sections) unless otherwise noted.

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Sheet Contents: ELEVATIONS

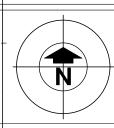Scale: 1/8" = 1'-0" Sheet No.

A7