



KEY PLAN

ISSUED
ISSUED FOR LANDMARKS - JANUARY 13, 2023
ISSUED FOR LUA - MARCH 27, 2023
ISSUED FOR ADDRESSING - MAY 30, 2023

PROJECT TITLE

Threshold
Development
Struck & Irwin
Site

838 Williamson St.


Madison, WI

SHEET TITLE

SITE PLAN

SHEET NUMBER

X106.1
PROJECT NUMBER 2241

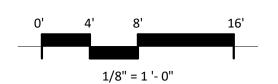

ЛARK	BUILDING ELEMENT	MANUFACTURER	COLOR				
	EXTERIOR SIGNAGE LIGHT FIXTURE	BARN LIGHT ELECTRIC CO.	BLACK				
1	COMPOSITE LAP SIDING 6" - SMOOTH	JAMES HARDIE	IRON GRAY				
2	COMPOSITE TRIM	JAMES HARDIE	ARCTIC WHITE				
3	COMPOSITE PANEL - SMOOTH	JAMES HARDIE	PEARL GRAY				
4	METAL PANEL	CMG	SILVER				
5	COMPOSITE PANEL - SMOOTH	JAMES HARDIE	GREEN				
6.1	BRICK VENEER	INTERSTATE BRICK	CHIPPEWA				
6.2	BRICK VENEER	INTERSTATE BRICK	OCHRE BUFF				
6.3	BRICK VENEER	INTERSTATE BRICK	PLATINUM				
7.1	BRICK VENEER - SOLDIER						
7.2	BRICK VENEER - ROWLOCK						
7.3	BRICK VENEER - ANGLED						
8	CAST STONE						
9	RAILINGS	TBD	BLACK				
10	COMPOSITE WINDOWS	ANDERSEN	BLACK				
11	ALUMINIUM STOREFRONT		BLACK				
13	FABRIC AWNING						

RECESSED CAN LIGHTS OVER

BACK/SIDE ENTRANCE

 $\langle 11 \rangle \langle 13 \rangle \langle 7.1 \rangle \langle 9 \rangle$ FOURTH FLOOR 890'-8" THIRD FLOOR 879'-4" SECOND FLOOR 868'-0" FIRST FLOOR

856'-8"

COMMERCIAL/LOBBY

854'-0" BASEMENT 841'-0"

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608.836.3690

GOOSENECK LAMPS LOCATED

(TYP).

- AT COMMERCIAL STOREFRONTS

Middleton, WI 53562

1 ELEVATION - SOUTH WEST COLOR 1/8" = 1'-0"



Development Struck & Irwin Site


PROJECT TITLE

Threshold

838 Williamson St. Madison, WI SHEET TITLE **EXTERIOR ELEVATIONS** COLOR

SHEET NUMBER

X203

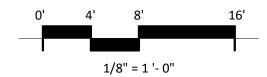

MARK	BUILDING ELEMENT	MANUFACTURER	COLOR		
	EXTERIOR SIGNAGE LIGHT FIXTURE	BARN LIGHT ELECTRIC CO.	BLACK		
1	COMPOSITE LAP SIDING 6" - SMOOTH	JAMES HARDIE	IRON GRAY		
2	COMPOSITE TRIM	JAMES HARDIE	ARCTIC WHITE		
3	COMPOSITE PANEL - SMOOTH	JAMES HARDIE	PEARL GRAY		
4	METAL PANEL	CMG	SILVER		
5	COMPOSITE PANEL - SMOOTH	JAMES HARDIE	GREEN		
6.1	BRICK VENEER	INTERSTATE BRICK	CHIPPEWA		
6.2	BRICK VENEER	INTERSTATE BRICK	OCHRE BUFF		
6.3	BRICK VENEER	INTERSTATE BRICK	PLATINUM		
7.1	BRICK VENEER - SOLDIER				
7.2	BRICK VENEER - ROWLOCK				
7.3	BRICK VENEER - ANGLED				
8	CAST STONE				
9	RAILINGS	TBD	BLACK		
10	COMPOSITE WINDOWS	ANDERSEN	BLACK		
11	ALUMINIUM STOREFRONT		BLACK		





7601 University Ave. #201

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PROJECT TITLE

Threshold Development Struck & Irwin Site

838 Williamson St. Madison, WI

SHEET TITLE **EXTERIOR** 

**ELEVATIONS** COLOR

SHEET NUMBER

X204


PROJECT NUMBER 2241 © Knothe & Bruce Architects, LLC

1 ELEVATION - NORTH EAST COLOR x204 1/8" = 1'-0"


SMOOTH SIDING AT ALL FIBER CEMENT MATERIAL LOCATIONS (PANEL OR LAP SIDING) TYP.



2 ELEVATION - NORTH WEST COLOR X204 1/8" = 1'-0"

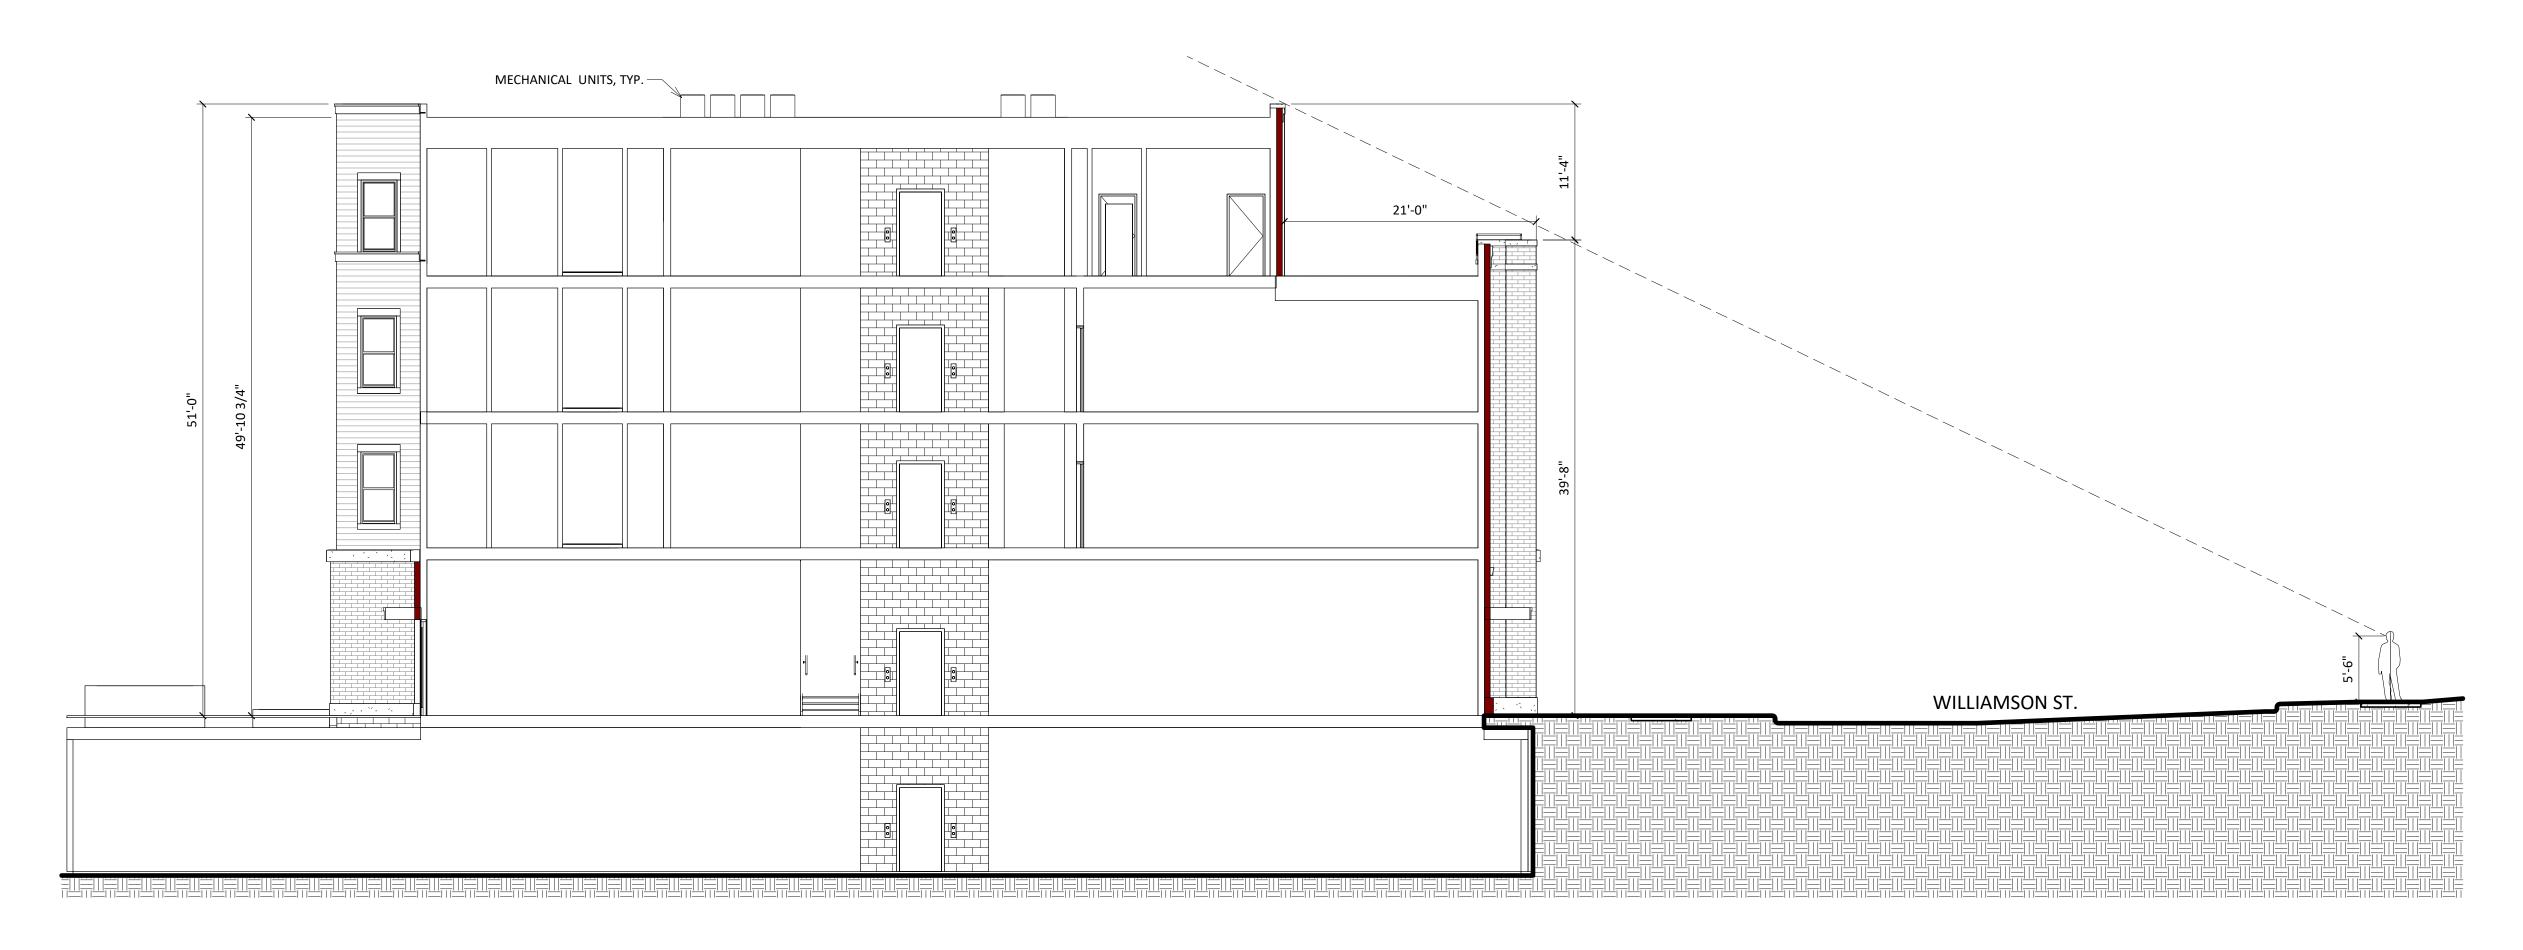



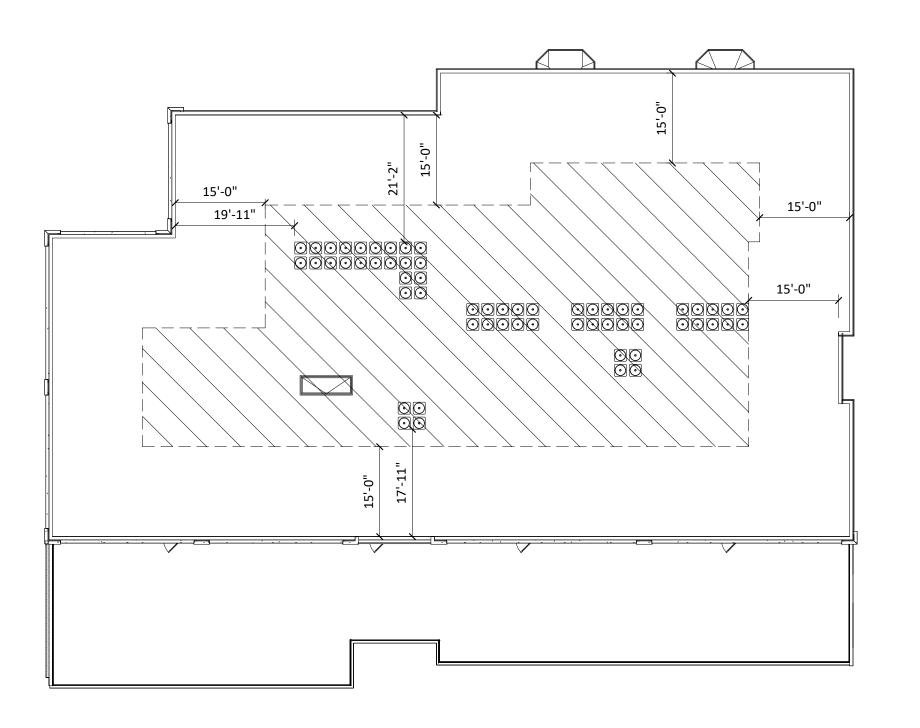

2 00 - WILLY ST - ROOF PLAN X301 1/16" = 1'-0"



ISSUED

Threshold
Development
Struck & Irwin
Site


838 Williamson St.
Madison, WI & 306 S.
Paterson St. Madison,
Wisconsin
SHEET TITLE

ROOFTOP MECH.
SIGHTLINES

SHEET NUMBER

X301
PROJECT NUMBER 2241



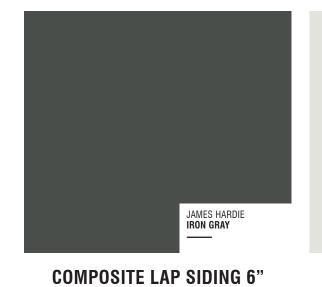




**COMPOSITE TRIM** 

SMOOTH

JAMES HARDIE PEARL GRAY

COMPOSITE PANEL SMOOTH

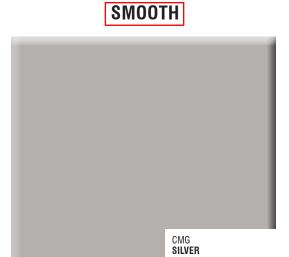

JAMES HARDIE GREEN



RAILINGS & WINDOWS


ROCKCAST
CREME BUFF| SMOOTH

**CAST STONE SILLS & BANDS** 

**METAL PANEL** 

INTERSTATE BRICK CHIPPEWA

COMPOSITE PANEL & TRIM SMOOTH

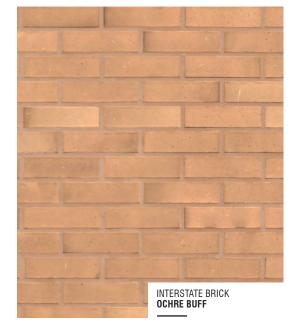



	EXTERIOR	R MATERIAL	<b>SCHED</b>	ULE	
MARK	BUILDING ELEMENT	MANUFACTURER		COLO	R
1	COMPOSITE LAP SIDING 6" - SMOOTH	JAMES HARDIE	IRON GRAY		, to the con-
2	COMPOSITE TRIM	JAMES HARDIE	ARCTIC WHITE		
3	COMPOSITE PANEL - SMOOTH	JAMES HARDIE	PEARL GRAY		
4	METAL PANEL	CMG	SILVER		
. 5	COMPOSITE PANEL - SMOOTH	JAMES HARDIE	GREEN		
6.1	BRICK VENEER	INTERSTATE BRICK	CHIPPEWA		
6.2	BRICK VENEER	INTERSTATE BRICK	OCHRE BUFF		
6.3	BRICK VENEER	INTERSTATE BRICK	PLATINUM		
7.1	BRICK VENEER - SOLDIER				
7.2	BRICK VENEER - ROWLOCK			4.5	
7.3	BRICK VENEER - ANGLED			1.	
8	CAST STONE	ROCKCAST	CREME BUFF		
10	COMPOSITE WINDOWS	ANDERSEN	BLACK		40,146
11	ALUMINIUM STOREFRONT	t the state of the	BLACK		1.
12	RAILINGS & HANDRAILS	SUPERIOR	BLACK		
13	FABRIC AWNING				

6.1 6.2 6.3

Development Struck & Irwin Site


MATERIAL Board

Threshold


826 Williamson St. Madison, WI January 26, 2023 KBA PROJECT #2241

**BRICK** 

# **MOUNTING STYLE**

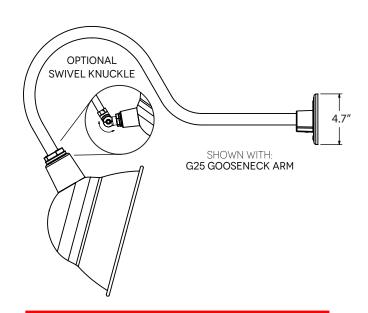

Gooseneck lamps at commercial storefronts

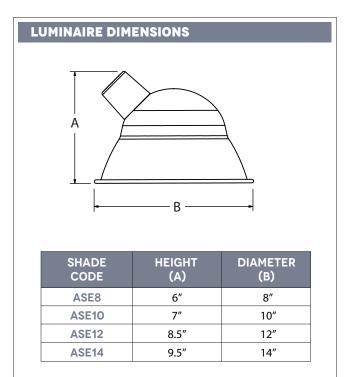

# **SPECIFICATIONS**

### **CERTIFICATIONS. LISTINGS & WARRANTY**

MADE IN THE USA

Manufactured and Hand-Crafted in Our 60,000 Square Foot Facility Located in Titusville, FL

CSA LISTED FOR WET LOCATIONS

LIMITED WARRANTY

For Additional Information on Our Limited Warranty, Please See Our Terms & Conditions

**UL CERTIFICATION** 

UL Listed Fixtures Available upon Request. Please Consult Factory for Additional Information.

# **CONSTRUCTION & FINISH**

POWDER COAT SHADE

Hand-Spun from High Purity 3003-O Temper Aluminum

GALVANIZE SHADE

Hand Spun from High Quality Galvanized Steel

PORCELAIN SHADE

Hand-Spun from 20 Gauge Porcelain Steel

POWDER COAT FINISHES

Polyester Powder Coat Finishes Are Electro-Statically Applied and Thermocured

PORCELAIN FINISHES

Applied by Hand and Fired in a High Temperature Oven

### **CONSTRUCTION & FINISH (CONTINUED)**

COPPER

 $Hand\mbox{-}Spun\ from\ High\ Purity\ .032\ Thick\ C11000\mbox{-}O60\ ETP\ Copper$ 

BRASS

Hand-Spun from High Purity .050" Thick C2600-O60 Brass

GOOSENECK

1/2" Nominal (0.84" Actual) or 3/4" Nominal (1.05" Actual) Sch 40, 6063 Aluminum Gooseneck

MAX FIXTURE WEIGHT

10 lbs

## **LIGHT SOURCE**

INCANDESCENT

Medium Base E26 Socket, 120 VAC, 200W Max

COMPACT FLUORESCENT

Bi-Pin Base GU24 Socket, 120 VAC, 23W Max

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# **SPECIFICATIONS**

Energy Star Yes
Title 24 Compliant Yes

www.kichler.com/warranty

**Dimensions** 

Base Backplate 5.00" X 5.00"
Extension 6.50"
Weight 2.50 LBS
Height from center of Wall opening 3.50"

(Spec Sheet)

Height 7.00" Width 5.00"

**Light Source** 

Delivered Lumens 450
Dimmable Yes
Expected Life Span (Hours) 45000
Lamp Included Integrated
Light Source LED
Max or Nominal Watt 10.00
Max Wattage/Range 10W

Mounting/Installation

Interior/Exterior Exterior
Location Rating Wet
Mounting Style Wall Mount
Mounting Weight 2.50 LBS

**Photometrics** 

Color Rendering Index 90
Kelvin Temperature 3000K

#### **FIXTURE ATTRIBUTES**

Housing

Primary Material EPMM
Shade Dimensions 4.60" D X 7.00"

**Product/Ordering Information** 

SKU 11309BKTLED
Finish Textured Black
Style Other
UPC 783927545280

# **Finish Options**



Textured Black



Wall Sconces at walk up unit entrances



# **D-Series Pole Mount**

LED Area Luminaire









Parking Lot lighting

# Catalog Notes Туре

# **Specifications**


### Luminaire

0.8 ft<sup>2</sup> EPA: (.07 m<sup>2</sup>) 13-3/4" Width: 11.5" Length:

8" Height:

16.03 lbs Weight:



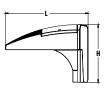

# Introduction

The D-Series Pole Mount luminaire is a stylish, fully integrated LED solution for area and site applications. It features a sleek, modern design and is carefully engineered to provide long-lasting, energy-efficient lighting with a variety of optical and control options for customized performance.

With an expected service life of over 20 years of nighttime use and up to 74% in energy savings over comparable 250W metal halide luminaires, the D-Series Pole Mount is a reliable, low-maintenance lighting solution that produces sites that are exceptionally illuminated.

# **Ordering Information**

(20.3 cm)

## **EXAMPLE:** DSXWPM LED 20C 1000 40K T5M MVOLT SPUMBA DDBXD

DSXWPM LED							
Series	LEDs	Drive current	Color temperature	Distribution	Voltage	Mounting <sup>3</sup>	
DSXWPM LED	10C 10 LEDs (one engine) 20C 20 LEDs (two engines)	350 350 mA 530 530 mA 700 700 mA 1000 1000 mA (1 A)	30K 3000K 40K 4000K 50K 5000K AMBPC Amber phosphor converted	T2S Type II short T5M Type V medium T2M Type II medium T5S Type V short T3S Type III short T5A Type V area T3M Type III medium T5W Type V wide T4M Type IV medium SYMDF Symmetric diffuse TFTM Forward throw medium	MVOLT <sup>1</sup> 120 <sup>1</sup> 208 <sup>1</sup> 240 <sup>1</sup> 277 <sup>1</sup> 347 <sup>2</sup> 480 <sup>2</sup>	Shipped included  SPUMBA Square pole universal mounting adapter  RPUMBA Round pole universal mounting adapter  PUMBA Square and round universal mounting adapters	

Control Options		Othe	Other Options			Finish (required)			
Shipped installed		Shipped installed		Shipped separately 9		DDBXD	Dark bronze	DDBTXD	Textured dark bronze
PE	Photoelectric cell, button type <sup>4</sup>	SF	Single fuse (120, 277, 347V) 8	BSW	Bird-deterrent spikes	DBLXD	Black	DBLBXD	Textured black
DMG	0-10v dimming wires pulled outside fixture (for use	DF	Double fuse (208, 240, 480 V) 8	WG	Wire guard	DNAXD	Natural aluminum	DNATXD	Textured natural aluminum
	with an external control, ordered separately)	HS	House-side shield 8	VG	Vandal guard	DWHXD	White	DWHGXD	Textured white
PIR	Motion/ambient light sensor, <15' mtg ht 5,6				DDL	Diffused drop lens	DSSXD	Sandstone	DSSTXD
PIRH	Motion/ambient light sensor, 15-30' mtg ht 5,6			552	biliasea alop ielis	555,15	Sarrastorie	5551,70	restarea sarrastorre
PIR1FC3V	Motion/ambient sensor, 8-15' mounting height, ambient sensor enabled at 1fc <sup>7</sup>								
PIRH1FC3V	Motion/ambient sensor, 15–30' mounting height,								

- MVOLT driver operates on any line voltage from 120-277V (50/60 Hz). Specify 120, 208, 240 or 277 options only when ordering with fusing (SF, DF options), or photocontrol (PE option).
- Only available with 20C, 700mA or 1000mA. Not available with PIR, PIRH.
- Not available with 90 degree mounting. Not recommended for 3" poles.
- Photocontrol (PE) requires 120, 208, 240, 277 or 347 voltage option. Not available with motion/ambient light sensors (PIR or PIRH).
- PIR specifies the SensorSwitch SBGR-10-ODP control; PIRH specifies the SensorSwitch SBGR-6-ODP control; see Motion Sensor Guide for details. Dimming driver standard. Includes ambient light sensor. Not available with "PE" option (button type photocell).
- Not available with 20 LED/1000 mA configuration (DSXWPM LED 20C 1000).
- PIR1FC3V specify the SensorSwitch SBGR-10-ODP control; PIRH1FC3V specify the SensorSwitch SBGR-6-ODP control; see Motion Sensor Guide for details. Dimming driver standard. Not available with PER5 or PER7. Separate on/off required.
- Single fuse (SF) requires 120, 277, or 347 voltage option. Double fuse (DF) requires 208, 240, or 480 voltage option.
- Also available as a separate accessory; see Accessories information.

## Accessories

Ordered and shipped separately House-side shield (one per light engine)

DSXWBSW U Bird-deterrent spikes DSXW1WG U Wire guard accessory DSXW1VG U Vandal guard accessory DSXWDDL U Diffused drop lens



June 26, 2023



Heather Bailey, Ph.D.
Preservation Planner
Department of Planning & Community & Economic Development
Madison Municipal Building, Suite 017
215 Martin Luther King Jr. Boulevard
Madison, Wisconsin 53703

Re: Follow up itmes for 826 Williamson Street Legistar File ID#: 70738 KBA Project #2241

Heather Bailey,

Attached we are submitting several items to follow up on outstanding issues to review.

Specifically we are including drawings and associated information for:

- I Exterior Lighting
- 2 Visibility of Roof Top Units
- 3 Materials Boards (specifically regarding the Fiber Cement Siding

# **Item I – Exterior Lighting**

<u>Commercial Lighting</u> - As indicated on the exterior elevations we are calling out Gooseneck lamps over the commercial storefronts. These lamps are the same style of lamps used on 811 Williamson Street, 940 Williamson Street, 1370 Williamson Street and several more.

<u>Residential Entrance Lighting</u> – The lighting at the main entrance to the building on Williamson Street is lit from above with recessed can lights in the overhead canopy – no other decorative lights are present in this area.

<u>Walk Up Entrance</u> – The individual walk-up entrances each have a 7" high wall sconce (cut sheet attached). These lights are meant to be subtle, providing only downlight and no uplighting, and were selected to be as unobtrusive as possible while still providing adequate lighting.

<u>Side/Back Entrance</u> - The side entrance to the building (off of parking area, not directly off of street) will also be lit with recessed lighting in the overhead canopy by the door, no decorative lights to be located here either.

<u>Parking Lot Lighting</u> – Locations for the parking pole light locations are indicated on attached page X106.1 (Site Plan). Specifications for the light are included in the cut sheets as well. The specified lights here provide the code required lighting level and still comply with the night-sky ordinance. The lights are similar to (but smaller) than the existing street lighting on Williamson Street.

# Item 2 – Visibility of Roof Top Units

Attached sheet X301 includes a diagram indicating Roof Top Unit locations, their proximity to the roof edge, and the line of vision from across the street.

# Item 3 - Mateial Board

The last page in the attached supplemental materials includes an updated list of materials, to include specific instruction for all Fiber Cement materials to be smooth sided and not the textured side.

Thank you for your time reviewing our materials.


Sincerely,

Jacob Morrison, AIA, NCARB

Lead Designer




2 ELEVATION - NORTH EAST GAS METER LOCATION 1/8" = 1'-0"

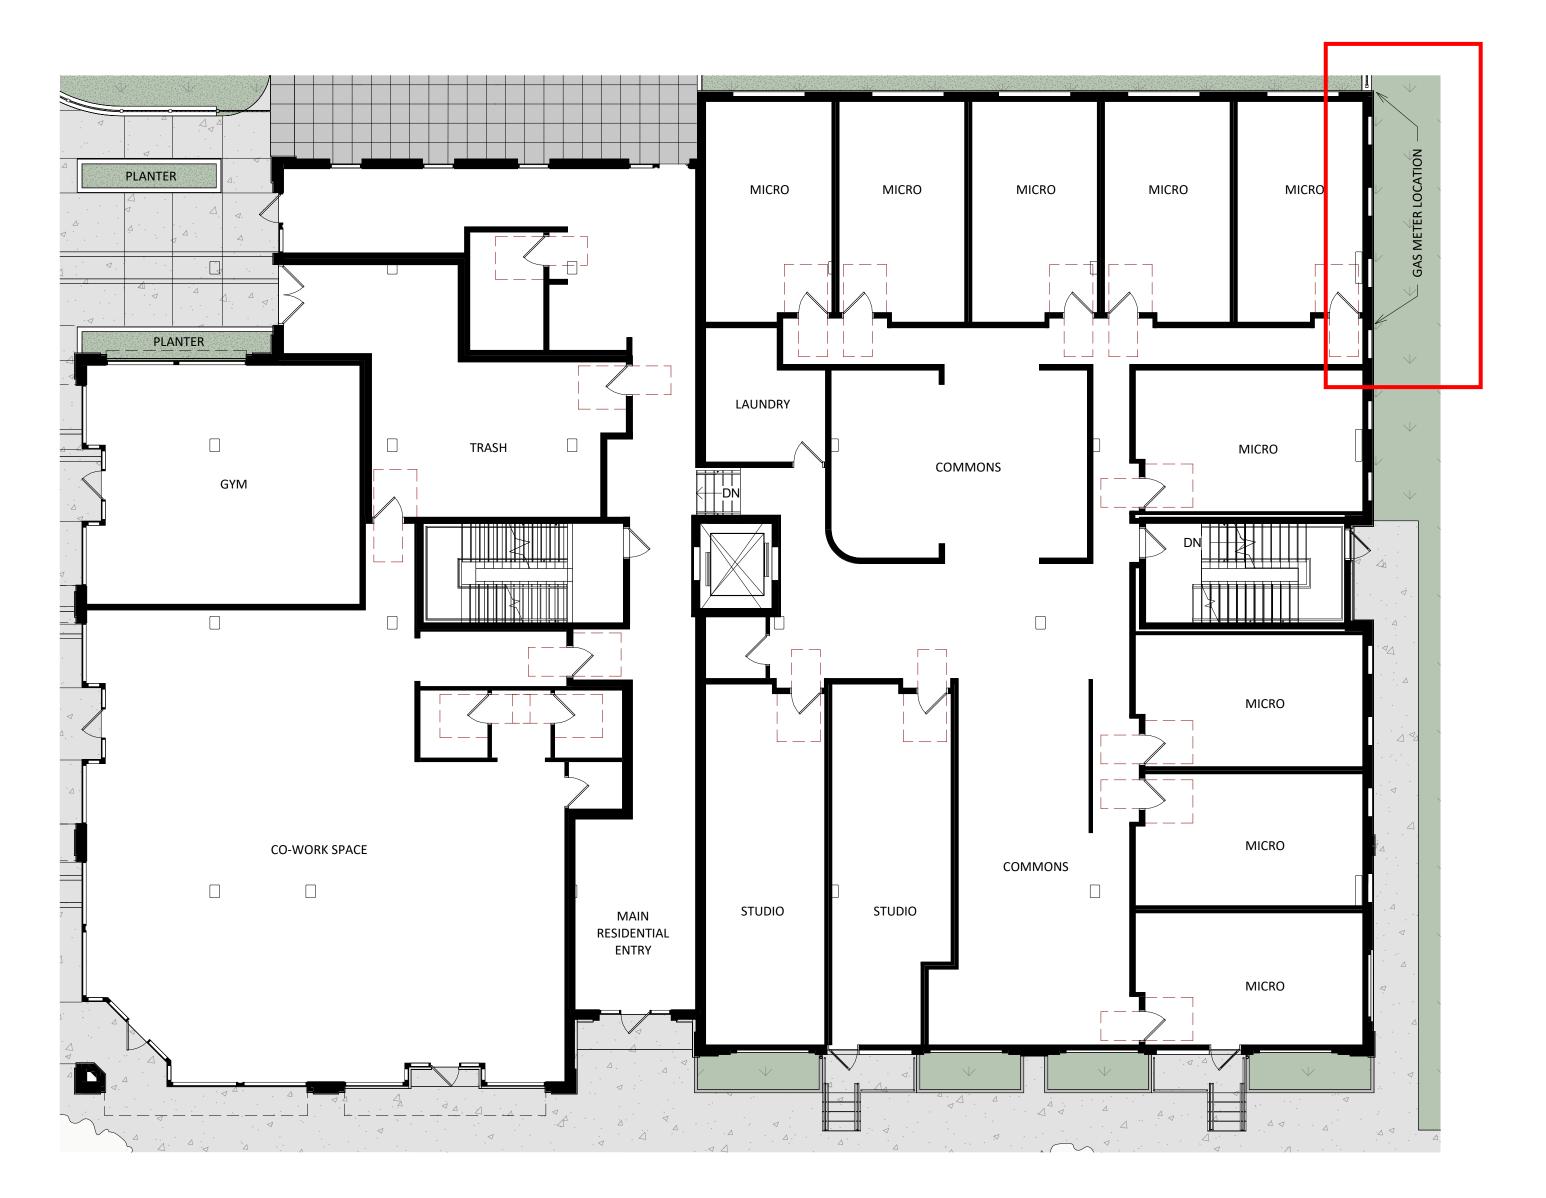





TRUE NORTH

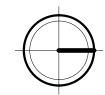

KEY PLAN

ISSUED

ISSUED FOR LANDMARKS - JANUARY 13, 2023 ISSUED FOR LUA - MARCH 27, 2023 ISSUED FOR ADDRESSING - MAY 30, 2023

ISSUED FOR SITE PLAN REVIEW - JULY 05, 2023

PROJECT TITLE

Threshold Development Struck & Irwin Site

838 Williamson St. Madison, WI

SHEET TITLE **GAS METER** LOCATION

SHEET NUMBER

X128

PROJECT NUMBER 2241