# APPLICATION FOR URBAN DESIGN COMMISSION REVIEW AND APPROVAL

AGENDA ITEM	#
Project #	

DATE SUBMITTED: 04/16/08  UDC MEETING DATE: 04/23/08	Action Requested Informational Presentation Initial Approval and/or Recommendation X Final Approval and/or Recommendation
PROJECT ADDRESS: Lake Park Apartment:	
ALDERMANIC DISTRICT: 4 - Verveer	<u> </u>
OWNER/DEVELOPER (Partners and/or Principals)  McGrath Associates, Inc.	ARCHITECT/DESIGNER/OR AGENT: SGN+A
Lance T. McGrath, P.E.	Bruce Simonson
CONTACT PERSON: Lance T. McGrath  Address: 103 N. Hamilton St.  Madison, WI 53703  Phone: 608-255-3976 x-225	
Fax: 608-255-1132 E-mail address: 1mcgrath@mcgrathproj	ects.com
well as a fee) School Public Building or Space (Fee may be	an Urban Design District * (A public hearing is required as e required) ing of a Retail, Hotel or Motel Building Exceeding 40,000
(See Section B for:)  New Construction or Exterior Remodeling in	C4 District (Fee required)
(See Section C for:) R.P.S.M. Parking Variance (Fee required)	
(See Section D for:)  Comprehensive Design Review* (Fee required)  Street Graphics Variance* (Fee required)	ed)
Other	
*Public Hearing Required (Submission Deadline 3 V	Veeks in Advance of Meeting Date)

Where fees are required (as noted above) they apply with the first submittal for either initial or final approval of a project.



REAL ESTATE INVESTMENTS

103 N. HAMILTON STREET, MADISON W1 53703
608-255-3976/FAX 255-1132
www.mcgrathprojects.com

April 16, 2008

Al Martin Department of Planning and Development City of Madison 215 Martin Luther King Jr. Blvd. Madison, WI 53701

RE: LAKE PARK APARTMENT HOMES URBAN DESIGN COMMISSION - APRIL 23, 2008

Dear Al,

On February 6, 2008 we submitted a PUD-GDP-SIP for the Lake Park Apartment Homes located at 451 W. Wilson Street and 351 S. Bassett St. Lake Park is a 40-unit four story apartment building over two levels of structured parking. The 1<sup>st</sup> and 4<sup>th</sup> floors of the buildings feature set backs – please refer to the attached Letter of Intent and Plans for additional information.

On March 12, 2008 we went before the Urban Design Commission (UDC) with the project and received Initial Approval. Since that time we have been working to address the comments/conditions of approval that were raised by UDC, and the following changes have been made:

- Multiple landscape and site design issues have been addressed
- All HVAC condensors will be located on the roof of the building
- The front and rear raised parapets have been eliminated.
- Side elevations have been enhanced:
  - o All EIFS removed from the design
  - o Added significant amount of brick to reinforce the "Book-Ends" of the building
  - The central "body" of the building is now more coherent and consists of one material (metal siding) and one main color with complementary accents.
- Steps taken to bring the mass of the building down and to activate the Bassett Street Elevation:
  - Two bays on Bassett extended all the way down to grade
  - o Two parking level windows have been extended down to the lower level at the end of Bassett Street
  - Accentuate the Bassett stair entrance with the addition of signage
  - O Use a darker base material to soften and reduce the apparent height of the parking structure wall.

Please include this project on the Urban Design Commission agenda for April 23, 2008. Attached to this letter please find 14 copies of the required information.


Sincerely,

McGrath Associates, Inc.

lanu). MYIZ

Lance T. McGrath, P.E.

President

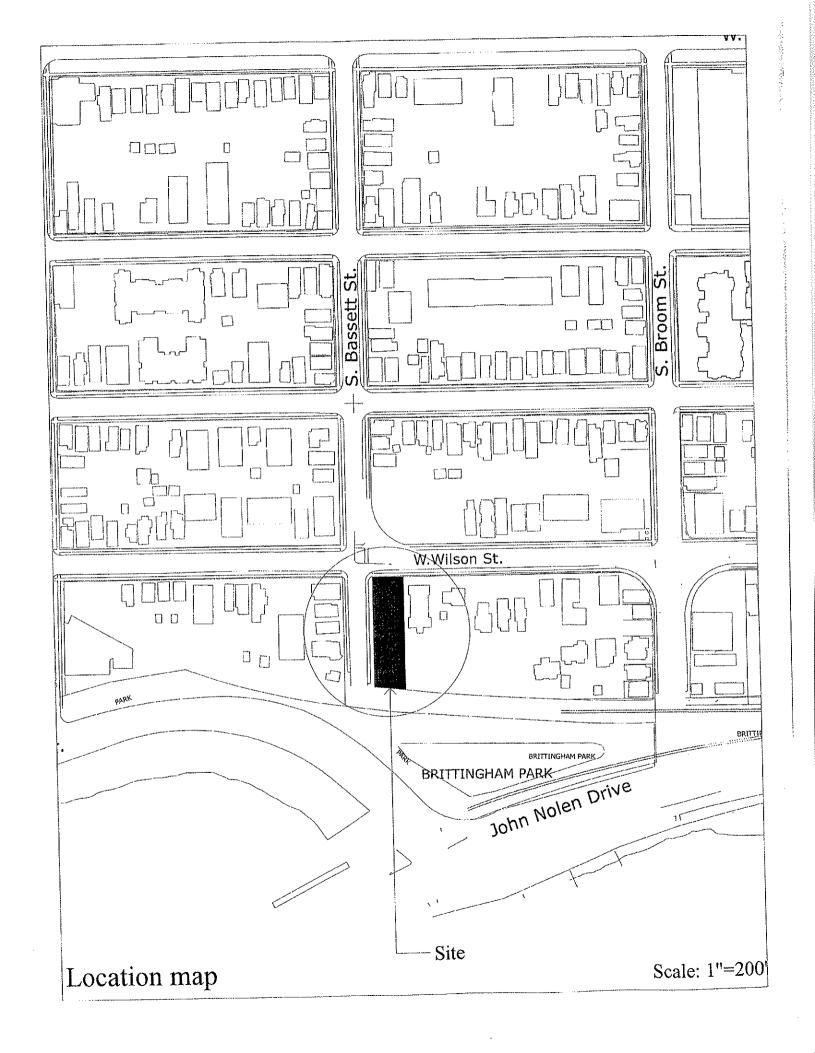

# **Lake Park Apartments**

Proposed Signage 4/16/08



# Wilson Street Entry



# Basset Street Entry

Scale" 1/4"=1'-0"



REAL ESTATE INVESTMENTS 103 N. HAMILTON STREET, MADISON WI 53703 608-255-3976/FAX 255-1132 www.mcgrathprojects.com

February 6, 2008

Mr. Brad Murphy Director of Planning Department of Planning and Development City of Madison 215 Martin Luther King Jr. Blvd. Madison, WI 53701

RE: LETTER OF INTENT - LAKE PARK APARTMENT HOMES

Dear Mr. Murphy:

The following is submitted together with the plans, application and zoning text for Staff, Plan Commission and Common Council consideration and Approval.

Project:

Lake Park Apartment Homes

451 W. Wilson and 315 S. Bassett Streets

Madison, WI 53703

Owner:

McGrath-Bassett, LLC c/o Lance McGrath McGrath Associates, Inc

103 N. Hamilton St. Madison, WI 53703

Architect:

SGN+A

1190 W. Druid Hills Dr., NE

Suite T-65

Atlanta, GA, 30329

Contact: Bruce Simonson

1-770-841-9977

Developer:

Lance T. McGrath, P.E.

McGrath Associates, Inc

103 N. Hamilton St. Madison, WI 53703

Landscape Architect/

Civil Eng.

Schreiber/Anderson Assoc.

717 John Nolen Drive Madison, WI 53703

Contact: Chris Theil

1-608-255-0800

### Project Summary:

McGrath Associates, Inc. proposes to develop the Lake Park Apartment Homes on a 15,349 square foot site located at 315 S. Bassett St. and 451 W. Wilson Streets in Downtown Madison. The site is currently zoned R6 and contains two residential rental buildings – containing a total of 9 apartments. These buildings (constructed in 1954 and 1962) will be demolished to allow for construction of 40 new residential rental units on four levels over two levels of structured parking. The residential levels step back at first level (rear only) and at the 4<sup>th</sup> floor at both ends of the building.

One of the goals of this project is to compliment and respect the adjacent Dowling. Apartment building. We have successfully accomplished this by maintaining the 20-foot set back along Wilson Street, by complimenting the architecture of the street façade, and by stepping the building back at the 4<sup>th</sup> level to correspond to the parapet height of the Dowling. McGrath Associates has a long history of completing challenging infill projects that compliment/enhance adjacent historic properties (4<sup>th</sup> Ward Lofts/Doris House, Capitol Point/Parkside Building, Nolen Shore/Doty School, and Hancock Court/Kleuter Building) and this project has been designed and will be executed with the same level of care.

## Site Description:

The site is comprised of two parcels located at the end of S. Bassett Street – where it terminates at the railroad tracks. The two parcels create an end-cap for the block. There is 16-feet of grade differential going from one end of the property to the other. This grade differential presents some challenges – but also allows for two distinct levels of parking – each accessed from different points along Bassett Street without having to create an internal parking ramp.

The proposed project is located in an area that is dominated by multifamily rental properties. The project is immediately surrounded by four homes to the South (on the other side of Bassett - two of which are owner-occupied), the railroad corridor to the East, the Dowling Apartment building to the North and the Wilson Bay Apartments to the West (on the other side of Wilson St.). There are several buildings in the area that are of comparable scale – primarily three-story apartment buildings with a pitched roof (like Wilson Bay) however immediately behind the 4 homes on the other side of Bassett street is the Diplomat Apartment building – which is 7 stories tall.

# **Building Description:**

The proposed building is set back 20-feet from Wilson Street, 10.5 feet from the side yard, 7-13 feet at the railroad corridor (this steps back an additional 8.5-feet at the first residential level) and 1-foot from the Bassett St. Property Line. It should be noted that this property line is located approximately 8-feet from the existing sidewalk. Bassett Street is a standard 66-foot right-of-way street but it has been built 50-feet wide resulting

in an 8-foot wide portion of City property outside the sidewalk on both sides of the street. As discussed with Staff, we will be requesting an Encroachment Agreement with the City which will allow us to project balconies and landscape the area.

The base of the building consists of two levels of structured parking and will be constructed with a pre-cast block veneer and features translucent windows that allow natural light into the parking levels. At the East and North ends of the building the first residential level steps back from the base of the building an additional 8.5 feet (East) and 5.8 feet (North). The residential levels repeat going up for the first three levels and then step back again at the fourth residential level.

The exterior of the building has been designed to incorporate multiple building products. The front and rear elevation are clad with a brick veneer which wraps back around the side elevations and return into the building where it transitions to a synthetic stucco material. The building also features several vertical bay elements that are clad with a horizontal metal panel product. The entire fourth floor is also clad with the same metal panel material.

A unique architectural feature of the project will be the balconies that project out from the face of the building and are connected back to the building with diagonal tie rods. Additionally 25% of the units will have large outdoor terraces that range from approximately 125 to 500 square feet in size.

The project will contain 40 residential apartments: 28 one bedroom units and 12 two bedroom units. These units range in size from 604 to 1,271 square feet. The four residential levels total 41,362 square feet. The parking levels total 21,347 square feet and creates 49 parking stalls (1.2:1 parking ratio) along with 54 bike parking stalls and 33 storage units. Both parking levels are accessed from Bassett Street. The applicant is requesting a street loading zone on S. Bassett St.

# Landscape Design:

The landscape design for the Lake Park Apartment project accents and compliments the architecture. Landscape plants were chosen and positioned to accent the lines of the building, integrating the building to the site. Two planters flank the stairs on the Wilson Street main entrance. The stairs and planters reduce the scale of the entrance to a pedestrian scale, making the entry inviting and comfortable for residents and visitors. The rear of the site incorporates two vine trellis structures to compliment the architecture and deter vandalism along the façade. Rainwater collected from approximately 1/3 of the roof area will be diverted from the City storm sewer collection system to the rear of the site where it will flow into a Rain Garden.

# Sustainability and Energy Efficiency:

Sustainability is synonymous with infill development. Infill projects like Lake Park create high quality housing opportunities close to work/educational centers and promotes the use of mass-transit, pedestrian and bicycle transportation. This dramatically lessens sprawl and the impact on our infrastructure and municipal services.

Another project goal is to make this a very energy efficient building. We have been working with Focus on Energy to realize this goal. We will incorporate energy star windows, appliances and light fixtures. The HVAC system is being designed to meet a high level of energy efficiency not typically seen in apartment projects. The roof will be covered with a white EPDM membrane which reflects heat in Summer and water conserving plumbing fixtures will be installed. Stormwater management techniques that were previously discussed will be implemented.

### Trash and Snow Removal:

Trash and snow removal from the building will be privately contracted. A separate trash collection room with garbage and recycling containers will be located at the lower parking level directly across from the garage entrance door for residents to dispose of their trash and recycling. The trash removal contractor will be able to collect these containers without impeding the flow of traffic.

#### Schedule:

Construction of Lake Park is planned to begin in June of 2008 with completion in the Summer of 2009. It is critical that we maintain this schedule in order to be ready for the 2009 Summer rental season.

Sincerely,

McGRATH ASSOCIATES,

lana 1. Myrk

Lance T. McGrath, P.E.

President

# **Lake Park Apartment Homes**

# SIP ZONING TEXT PLANNED UNIT DEVELOPMENT DISTRICT

February 6, 2008

Legal Description: The lands subject to this Planned Unit Development District shall include those described on Exhibit A, attached hereto.

# I. Statement of Purpose

This Planned Unit Development District is established to allow for the construction of a 40-unit residential apartment building with structured parking on a 15,349 sq. ft. site, located in the Bassett Neighborhood - near the Capitol Square business district.

# II. Permitted Uses

- A. Those that are stated as permitted uses in the R6 zoning District.
- B. Residential Dwellings: 40 New Residential Units, including:
  - 28 One (1).Bedroom Units
  - 12 Two (2) Bedroom Units
- C. Uses: Uses Accessory to permitted uses as listed above.

# III. Lot Area

A. 15,349 sq. ft., as stated in Exhibit A, attached hereto.

# IV. Height, Yard, Usable Open Space and Landscaping Requirements

A. As provided on the approved PUD plans.

# V. Accessory Off-Street Parking & Loading

- A. Accessory off-street parking will be provided as shown on the approved plans.
- B. A street Loading Zone will be provided on S. Bassett Street.

#### VI. Lighting

A. Site lighting will be provided as shown on the approved plans.

### VII. Signage

A. Signage will be allowed as per Chapter 31 of the Madison General Ordinances, as compared to the R-6 district, and/or signage will be provided as approved on the recorded plans.

B. Temporary Construction/Marketing Signage that does not conform with the Chapter 31 of the Madison General Ordinances will be allowed on the building during construction to promote the project, developer and contractors. This signage will be removed upon receipt of a certificate of occupancy.

# VIII. Family Definition

A For the purposes of this Planned Unit Development the family will be as defined in Chapter 28.03(2) of Madison General Ordinances for the R-6 District.

# IX. Alterations and Revisions

A. No alteration or revision of this Planned Unit Development shall be permitted unless approved by the City Plan Commission; however, the Zoning Administrator may issue permits for minor alterations or additions which are approved by the Director of Planning and Development and the Alderperson of the district and are compatible with the concept approved by the City Plan Commission.

## EXHIBIT A LEGAL DESCRIPTION

Being Lot 1, Block 47, of the Original (Pritchette) Plat of Madison, recorded in Vol. A, Pg. 3 of Plats, located in Section 23, T07N, R09E, City of Madison, Dane County, Wisconsin more particularly described as follows;

Commencing at a meander corner north of the East 1/4 of said Section 23, said meander corner being South 00 degrees 30 minutes 09 seconds West, 1615.78 feet of a meander corner which is southerly of the Northeast corner of Section 23, thence West, 536.82 feet to a point on the southeasterly right-of-way line of West Wilson Street, and the northwesterly boundary line of said Block 47, Pritchette Plat of Madison; thence South 45 degrees 39 minutes 45 seconds West, 435.12 feet to the northeasterly corner of Lot 1, of said Block 47, said point being marked by a bent 1" iron pipe and being the point of beginning of this description; thence South 44 degrees 20 minutes 15 seconds East, along the northeastly

boundary line of said Lot 1, Block 47, 235.30 feet to a point on the northwesterly right-of-way of the Chicago, Milwaukee, St. Paul & Pacific Raiload; thence South 51 degrees 06 minutes 20 seconds West, along said northwesterly railroad r.o.w. 66.42 feet; thence North 44 degrees 20 minutes 15 seconds West, along the southwesterly boundary line of Lot 1, Block 47, and northeasterly r.o.w. line of Bassett Street, 229.00 feet; thence North 45 degrees 39 minutes 45 seconds East, along the northwesterly boundary line of said Lot 1, Block 47 and the southeasterly r.o.w. line of West Wilson Street to the point of beginning.

# Urban Design Submittal Documents Lake Park Apartment Homes

Madison, Wisconsin

A Residential Development by McGrath Associates, Inc · Madison, Wisconsin

# 16 April 2008

# **Drawing Index**


#### Cover -

A0	Architectural	Site	Pla
-NO	Aichitecturai	DILL	1 10

- C1.0 Demolition Plan
- C4.0 Site Grading Plan
- C5.0 Site Layout PlanC6.0 Landscape Plan
- C7.0 Details
- C7.1 Details
- C7.2 Details
- C8.0 Lighting Plan
- A1 Lower Parking Level Plan
- A2 Upper Parking Level Plan
- A3 1st Residential level
- A4 2nd/3rd Residential LevelA5 4th Residential level
- A6 Roof Plan
- A7 Building Elevation
- A8 Building Elevation
- A9 Building Elevations
- A10 Wall Section at BrickA11 Wall Section at Bay Window

# Project Data

Lower Parking Upper Parking Total	23 Stall <u>26 Stall</u> 49 Stall
1st Residential Level	10 Unit
2nd Residential Level	10 Unit
3rd Residential Level	10 Unit
4th Residential Level	<u>10 Unit</u>
Total	40 Unit

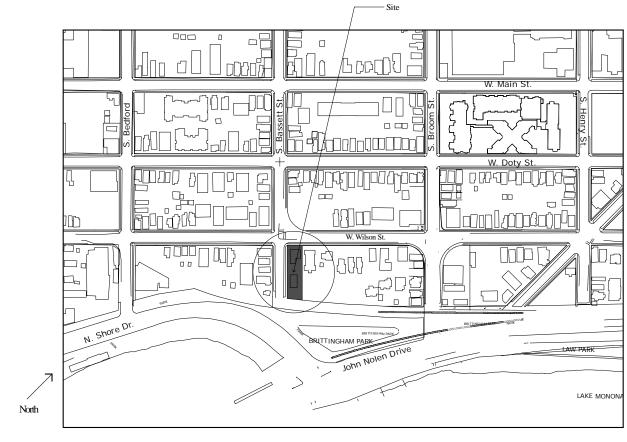


Location Map



Architectural Site Plan

Scale: 1/8"=1'-0"

McGrath Associates, Inc.

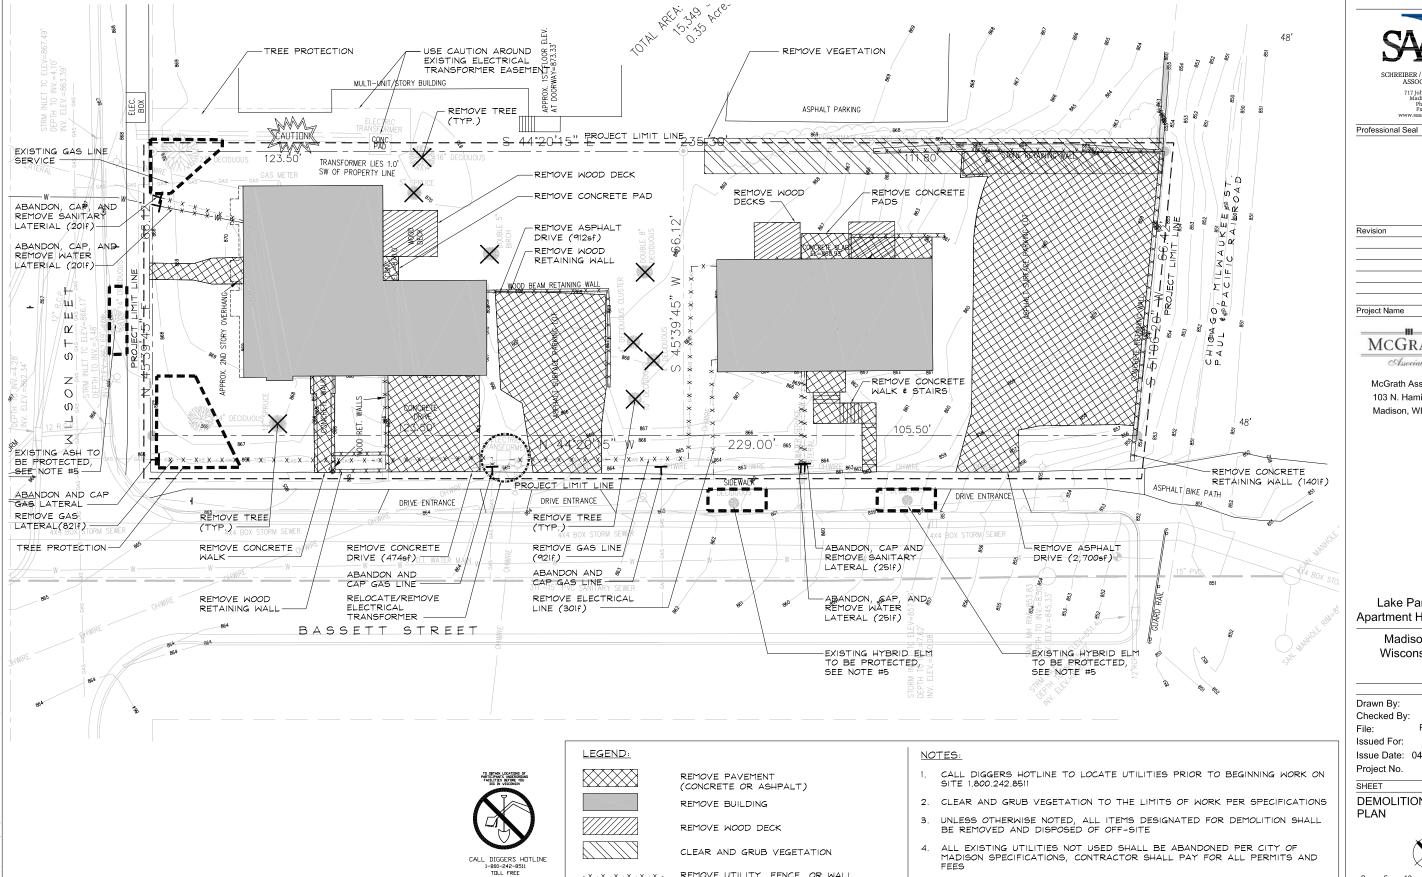

REMOVE UTILITY, FENCE, OR WALL

REMOVE VEGETATION

PROJECT LIMITS

TREE PROTECTION FENCE

- x · x · x · x · x · x

VIS STATUTE 182.0175(1974)
REQUIRES NIN. 3 VORK DAYS
NOTICE BEFORE YOU EXCAVATE

MILW. AREA 259-1181

717 John Nolen Drive Madison, WI 53713

Ph. 608.255.0800 Fx. 608.255.7750

Revision

Project Name

**MCGRATH** Associates

> McGrath Associates 103 N. Hamilton St. Madison, WI 53703

Lake Park **Apartment Homes** 

> Madison Wisconsin

Drawn By: AW Checked By: CT P-DEMO File: Issued For: UDC Issue Date: 04/16/2008 Project No. 2284


**DEMOLITION** 



CONTRACTORS SHALL INSTALL FENCING AROUND THE TRUNKS OF ALL EXISTING TERRACE TREES. FENCING SHALL COVER THE WIDTH OF THE TERRACE AND EXTEND AT LEAST FIVE (5) FEET FROM THE TRUNKS IN BOTH

DIRECTIONS. TREES INCLUDE: TWO (2) HYBRID ELMS ALONG S. BASSETT

STREET, # ONE (1) GREEN ASH ALONG W. WILSON STREET

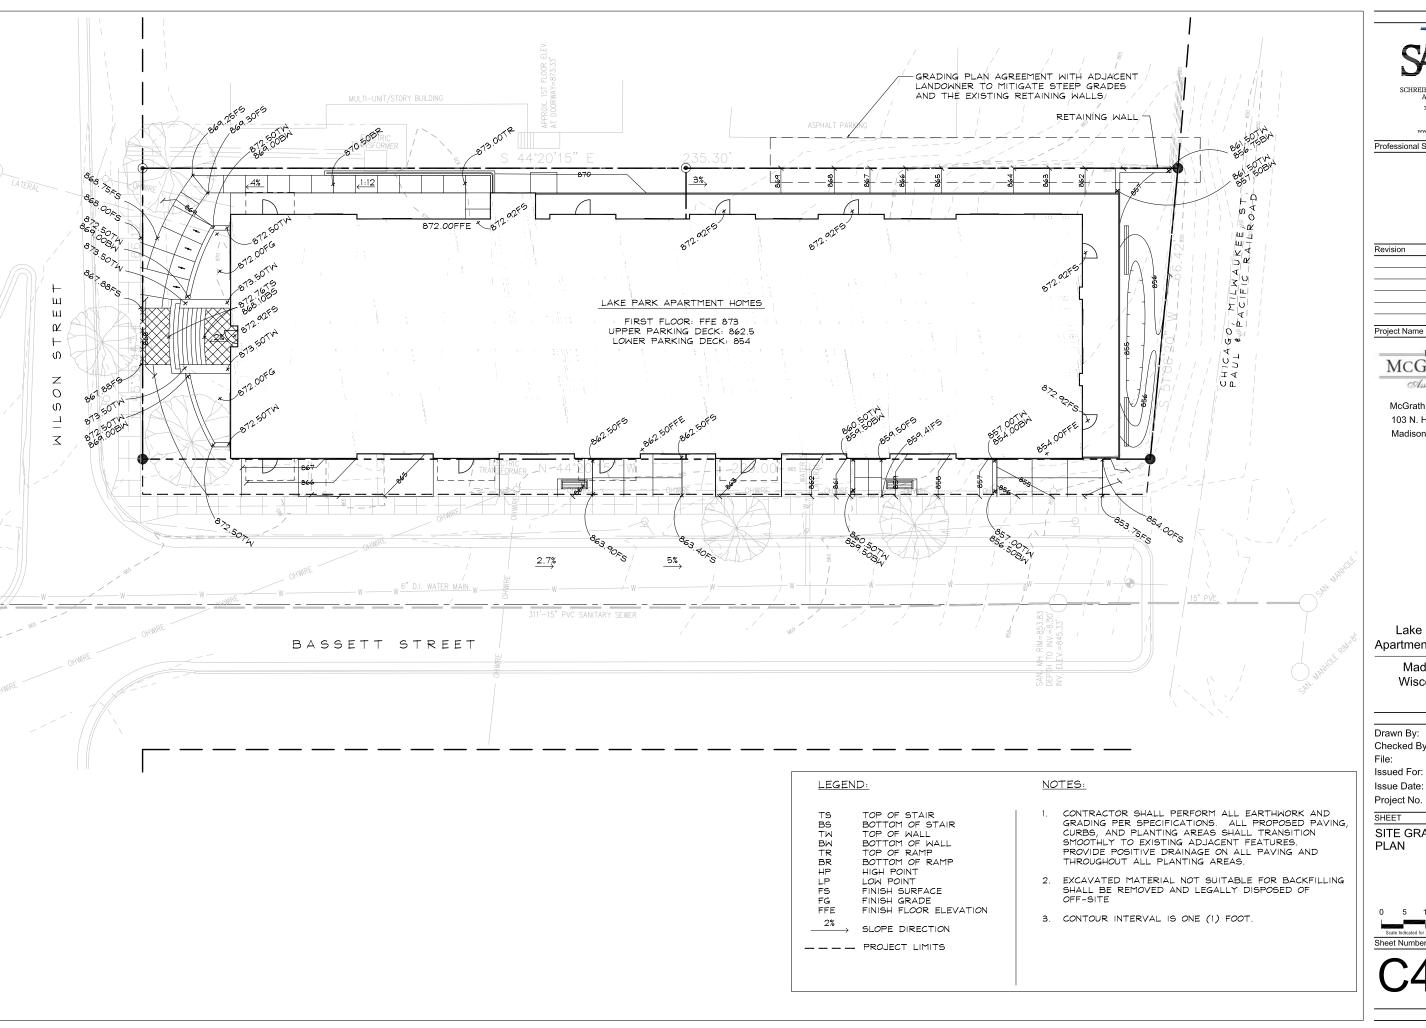

Ph. 608.255.0800 Fx. 608.255.7750 www.saa-madison.com

Professional Seal

Revision

Project Name



McGrath Associates 103 N. Hamilton St. Madison, WI 53703

Lake Park **Apartment Homes** 


> Madison Wisconsin

Drawn By: ΑW CT Checked By: P-SG UDC Issued For: Issue Date: 04/16/2008 2284

SHEET

SITE GRADING PLAN



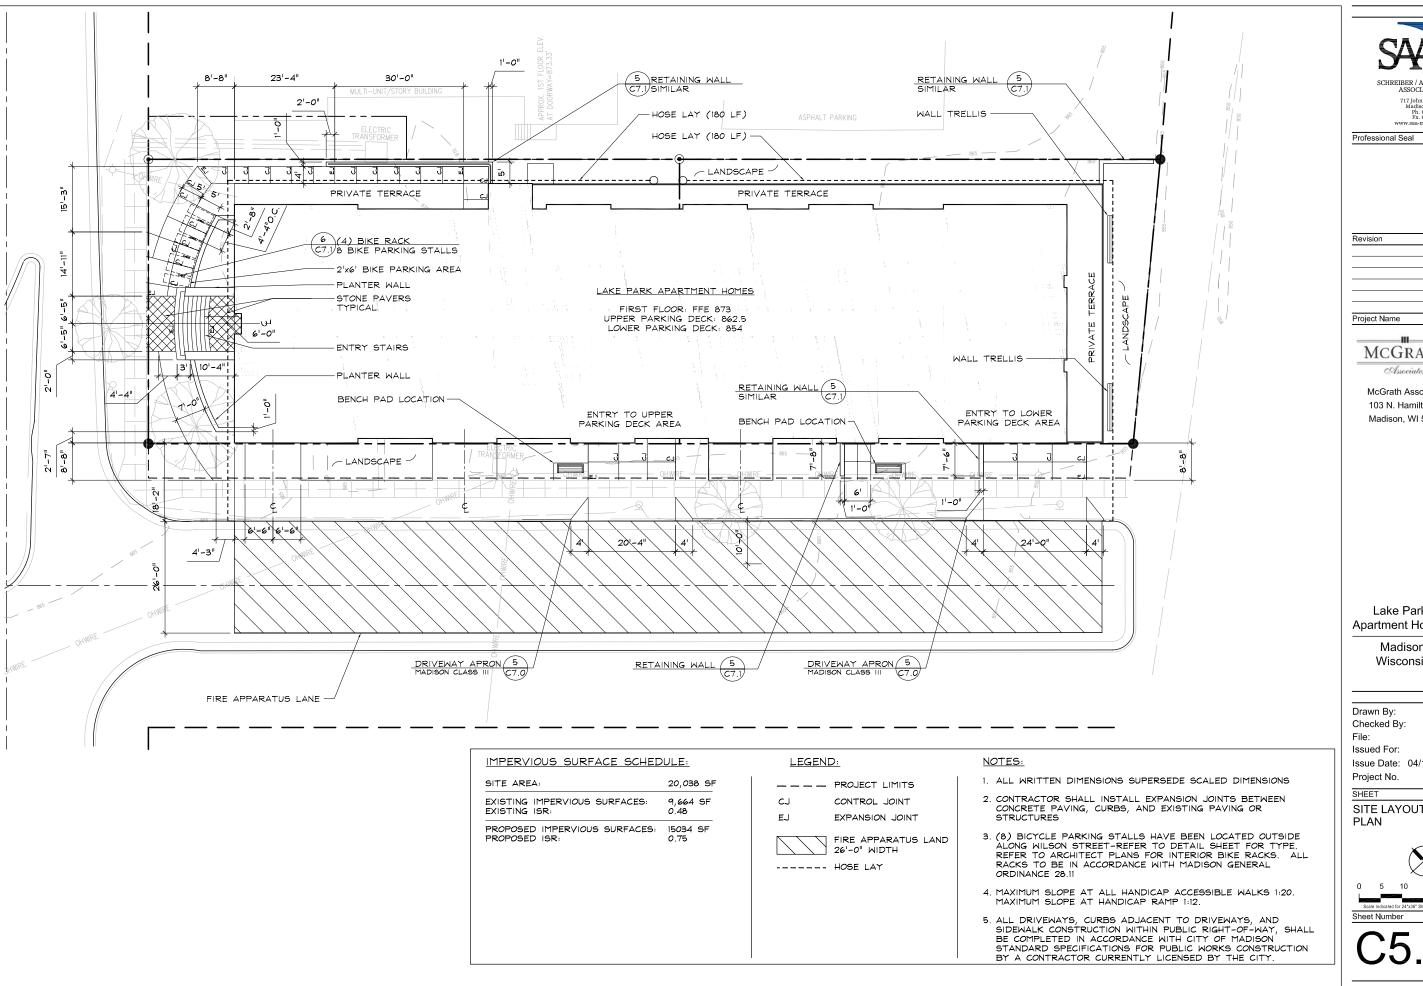



Ph. 608.255.0800 Fx. 608.255.7750

Project Name

**MCGRATH** Associates

McGrath Associates 103 N. Hamilton St. Madison, WI 53703

Lake Park **Apartment Homes** 


> Madison Wisconsin

AW Drawn By: Checked By: CT P-SP File: Issued For: UDC Issue Date: 04/16/2008 Project No. 2284

SHEET

SITE LAYOUT PLAN



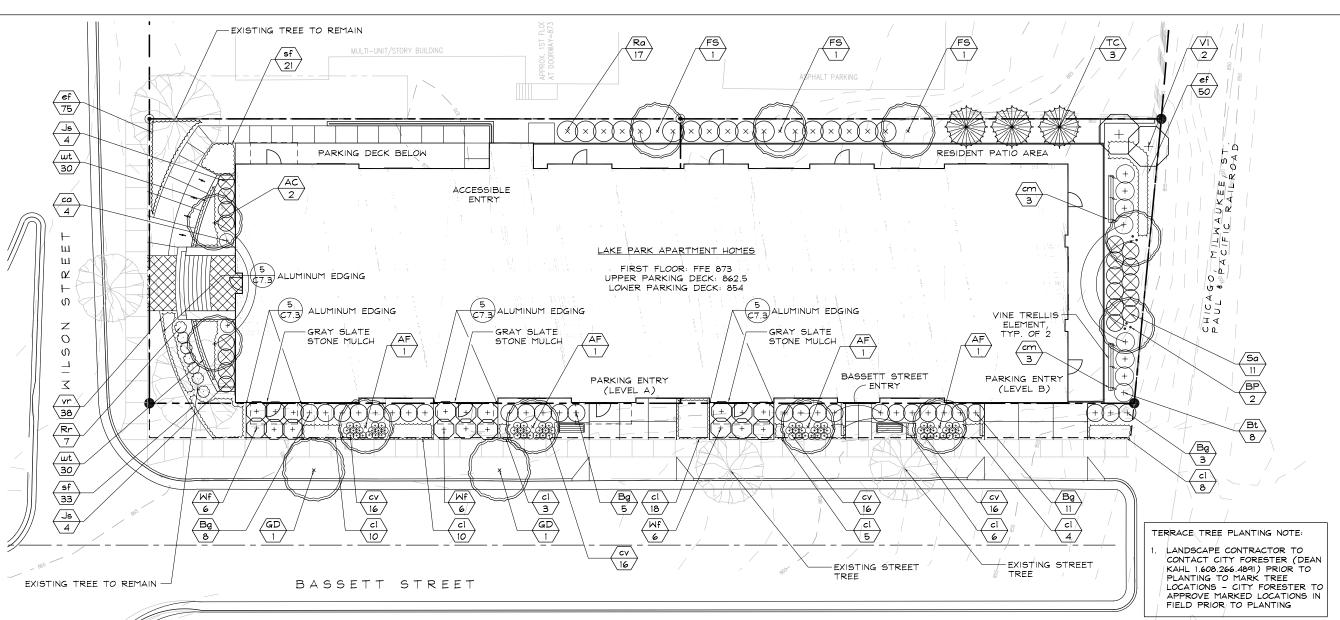

Symbol	Botanical name	Common Name	Size	Root	Quantity	Comments
PER	ENNIALS/GROUNDCOVERS/VIN	IES				
cm	Clematis virginiana	Virginsbower	5 Gal.	Cont.	6	tendril climber
са	Calamagrostis acutiflora 'Avalanche'	Avalanche Feather Grass	2 Gal.	Cont.	4	upright - match form/size
cl	Chasmanthium latifolium	Northern Sea Oats	1 Gal.	Cont.	59	salt tolerant
cv	Coreopsis verticillata 'Moonbeam'	Moonbeam Coreopsis	1 Gal.	Cont.	64	pale yellow flowers - cutleaf
ef	Euonymus fortunei 'Coloratus'	Purpleleaf Wintercreeper	2.5" pots	Cont.	125	14" O.C25 plants per tray
sf	Solidago 'fireworks'	Fireworks Solidago	1 Gal.	Cont.	54	
vs	Veronica 'Sunny Border Blue'	Sunny Blue Speedwell	1 Gal.	Cont.	38	
ωt	Waldsteinia ternata	Barron Strawberry	2.5" pots	Cont.	60	vellow flowers-urban tolerant

LANDSCAPE POINTS					
NUMBER OF TREES REQUIRED:		TABULATION OF POINT	S PROVIDE	D:	
NUMBER OF PARKING STALLS	0 - ALL UNDERGROUND	CANOPY TREES	35pts	10	350
STORAGE AREA SQUARE FOOTAGE	0 - NO STORAGE AREA	DECIDUOUS SHRUBS	2pts	88	176
CANOPY TREES REQUIRED	0 - NO TREES REQUIRED	EVERGREEN SHRUBS	3pts	43	129
		DECORATIVE WALL	5pts/lf	401f	200
NUMBER OF LANDSCAPE POINTS REQUIF	RED:	EVERGREEN TREES	15pts	4	60
POINTS REQUIRED PER PARKING STALLS	0 - ALL UNDERGROUND	ORNAMENTAL TREES	15pts	2	30
POINTS REQUIRED PER LOADING BERTHS TOTAL POINTS REQUIRED	0 - NO BERTHS 0 - NO POINTS REQUIRED	TOTAL POINTS			945pt:

gymbol	Botanical name	Common Name	Size	Root	Quantity	Comments
SHA	DE TREES					
AF	Acer x freemanii 'Armstrong'	Freeman Maple	3″ Cal.	B¢B	4	straight central leader
AC	Amelanchier canadensis	Shadblow Serviceberry	8' Ht.	B¢B	2	Multi-stem
BP	Betula papyrifera 'Renci'	Renaissance Reflection Paper Birch	101 Ht.	B¢B	2	Multi-stem
FS	Fagus sylvatica 'Fastigiata'	Upright European Beech	3" Cal.	B¢B	3	straight central leader
GD	Gymnocladus dioica 'Espresso'	Kentucky Coffeetree	3" Cal.	B¢B	2	female form acceptable if male is unavailable, per City Forester
EVE	RGREEN TREES/SHRUBS					
Bg	Buxus x 'Green Mountain'	Green Mountain Boxwood	30" Ht.	Cont.	27	similar form/size
Js	Juniperus squamata 'Blue Star'	Blue Star Juniper	3 Gal.	Cont.	8	
тс	Taxus cuspidata v. capitata	Upright Yew	4'-6" Ht.	B¢B	3	similar form/size-upright
DEC	LIDUOUS SHRUBS					
Bt	Berberis thun, v. 'Rose Glow'	Rose Glow Barberry	3 Gal.	Cont.	8	thorned variety
Ra	Rhus aromatica	Fragrant Sumac	3 Gal.	Cont.	17	slope stabilization
Rr	Rosa 'Frau Dagmar Hastrup'	F. D. Hastrup Rugosa Rose	3 Gal.	Cont.	7	match form/size
Sp	Salix purpurea 'Canyan Blue'	Arctic Blue Leaf Willow	3 Gal.	Cont.	11	match form/size
VI	Viburnum lentago	Nannyberry Viburnum	4' Ht.	B¢B	2	
Wf	Weigela florida 'Red Prince'	Red Prince Weigela	5 Gal.	Cont.	18	match form/size in groupings



Professional Seal

Project Name

MCGRATH

McGrath Associates 103 N. Hamilton St. Madison, WI 53703


Associates

Lake Park
Apartment Homes


Madison Wisconsin

Drawn By: AW
Checked By: CT
File: P-LS
Issued For: UDC
Issue Date: 04/16/2008
Project No. 2284

SHEET LANDSCAPE PLAN

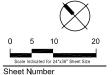


C6.0

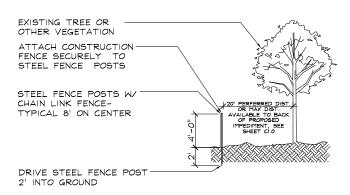


- CONTRACTORS SHALL INSTALL FENCING AROUND THE TRUNKS OF EXISTING TERRACE TREES. FENCING SHALL COVER THE WIDTH OF THE TERRACE AND EXTEND AT LEAST FIVE (5) FEET FROM THE TRUNKS IN
- 2. PLACE FENCE POSTS 8' O.C. \$ ATTACH CONSTRUCTION FENCE SECURELY TO EXISTING TREES TO BE PROTECTED WITHIN THE PROPERTY
- 3. NO ENTRY, NO STORAGE \$ NO TRENCHING IN TREE PROTECTION ZONE DURING ENTIRE SITE CONSTRUCTION




NTS

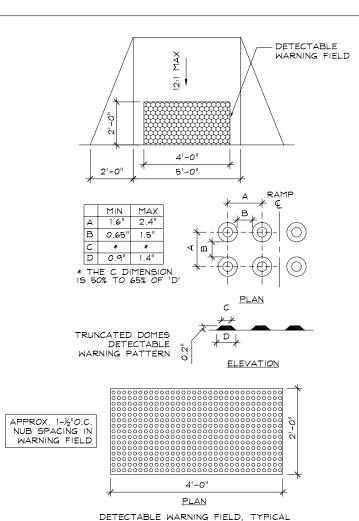

ACCESSIBLE RAMP CURB TAPERS INTO SIDEWALK SCALE: 1/2"=1'-0"

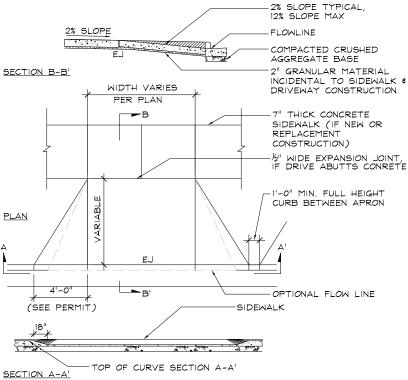

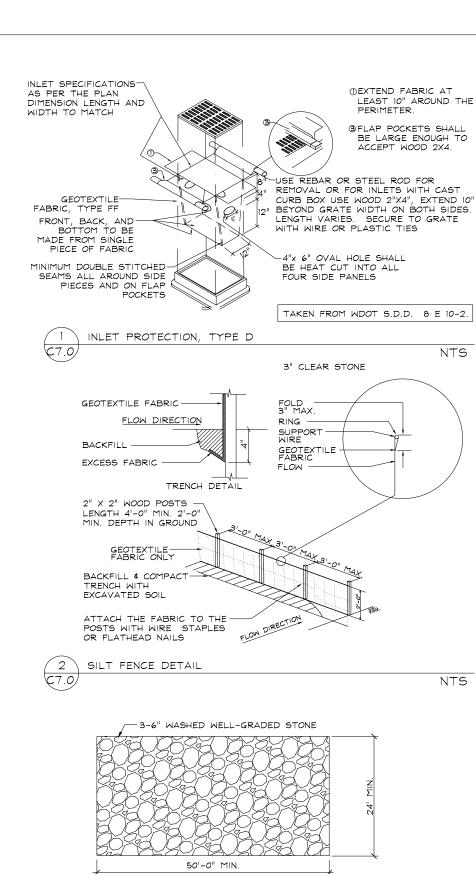



717 John Nolen Drive Madison, WI 53713

Ph. 608.255.0800 Fx. 608.255.7750

Professional Seal

Project Name

NTS

NTS

GEOTEXTILE MATERIAL

1/8"=1'-0"

EXISTING PAVEMENT

SITE R.O.W.

**MCGRATH** Associates

> McGrath Associates 103 N. Hamilton St. Madison, WI 53703

Lake Park **Apartment Homes** 

> Madison Wisconsin

Drawn By: AW Checked By: CT P-D Issued For: UDC Issue Date: 04/16/2008 Project No. 2284 SHEET

**DETAILS** 




TRACK MAT DETAIL

EXISTING GRADE

(C7.0 ) CLASS III CITY OF MADISON STANDARD DETAIL

DRIVE APRON

SCALE 1/4" = 1'-0"

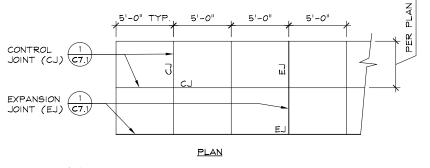


#### NOTES:


RETAINING WALL

1. CONTROL JOINTS @ 5'-0" O.C.; EXPANSION JOINTS @ 30' O.C. AND AT STRUCTURES, BUILDINGS, ETC., WITH GRAY JOINT

2. SEE LAYOUT PLANS FOR ADDITIONAL SCORING PATTERN

CONCRETE SCORE PATTERN - PLAN C7.1 SCALE: 1-0" FINISH GRADE -CONCRETE RETAINING WALL -1" CHAMFER ON ALL EXPOSED EDGES FINISH SURFACE PER PLAN EXPANSION JOINT C7-1, 6" COMP. AGGREGATE BASE COMP. SUBGRADE #5 VERTICAL REBAR 18" O.C., #4 HORIZONTAL REBAR @ 12" CONCRETE FOOTING 14 1 12 6" COMP. AGGREGATE BASE 2'-0"

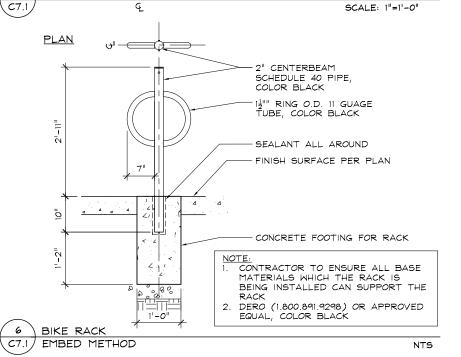


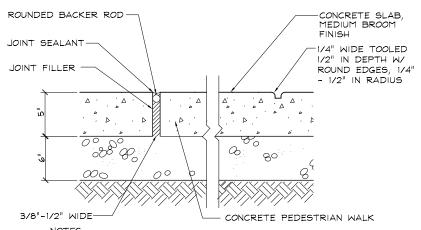

1. PROVIDE EXPANSION JOINTS 30' OC MAX. ALL WAYS
2. SEE LAYOUT PLANS FOR CONTROL \$ EXPANSION JOINT LAYOUTS

EXPANSION/CONTROL JOINT C7.1

NTS Project Name

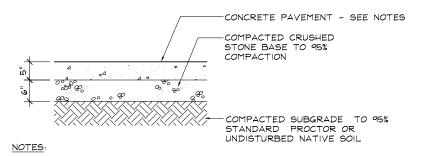


EXPANSION JOINTS EVERY 30' O.C. FOR LINEAR WALKS

SEE LAYOUT PLANS AND DETAIL 1/C7.1 FOR CONTROL \$ EXPANSION JOINT SPACING

3. CONCRETE PAVEMENT WITH MEDIUM BROOM FINISH PERPENDICULAR TO DIRECTION OF TRAFFIC

5" PEDESTRIAN CONCRETE PAVEMENT C7.1 NTS

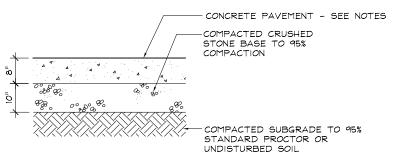

- EXPANSION JOINTS EVERY 30' O.C. FOR LINEAR WALKS SEE LAYOUT PLANS AND DETAIL 1/C7.1 FOR CONTROL \$ EXPANSION JOINT SPACING
- 3. CONCRETE PAVEMENT WITH MEDIUM BROOM FINISH PERPENDICULAR TO DIRECTION OF TRAFFIC
- 8" VEHICULAR CONCRETE PAVEMENT C7.1

macuson, WI 53713 Ph. 608.255.0800 Fx. 608.255.7750 www.saa-madison.com

Professional Seal

MCGRATH Associates.

McGrath Associates 103 N. Hamilton St. Madison, WI 53703


Lake Park **Apartment Homes** 


> Madison Wisconsin

Drawn By: ΑW СТ Checked By: File: P-D UDC Issued For: Issue Date: 04/16/2008 Project No. 2284

SHEET **DETAILS** 

5 10

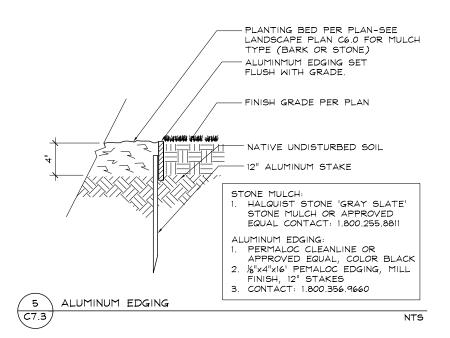

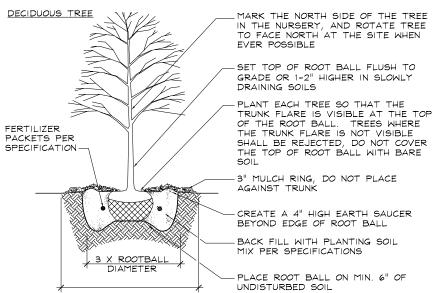

PLANT EACH TREE SO THAT THE TRUNK FLARE IS VISIBLE AT THE TOP OF THE ROOT BALL. TREES WHERE THE TRUNK FLARE IS NOT VISIBLE

3" MULCH RING, DO NOT PLACE

BEYOND EDGE OF ROOT BALL

MIX PER SPECIFICATIONS

FERTILIZER PACKETS PER

UNDISTURBED SOIL


BACK FILL WITH PLANTING SOIL

PLACE ROOT BALL ON MIN. 6" OF

CREATE A 4" HIGH EARTH SAUCER

AGAINST TRUNK

SHALL BE REJECTED, DO NOT COVER THE TOP OF ROOT BALL WITH BARE

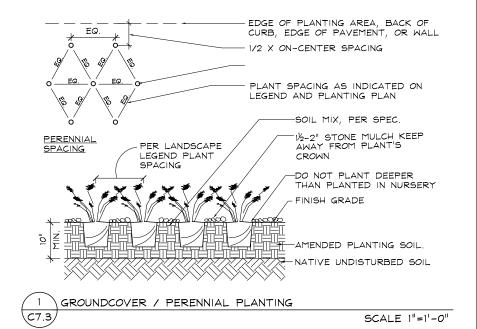



Project Name



McGrath Associates 103 N Hamilton St Madison, WI 53703

Lake Park

**Apartment Homes** 

Madison Wisconsin

Issue Date: 04/16/2008

AW

CT P-D

UDC

2284

Drawn By:

Checked By:

Issued For:

Project No.

**DETAILS** 

SHEET

REMOVE TOP 1/3-OF BURLAP -INSTALL SHRUB SO THAT ROOT FLARE IS SLIGHTLY 3" MULCH, DO ABOVE FINISHED GRADE NOT PLACE BACKFILL, SEE SPECS AGAINST TRUNK BUILD UP EDGE-- FINISH GRADE OF MULCH BED TO CREATE SAUCER 4" UNDISTURBED BED TO SUPPORT ROOT BALL

B¢B SHRUB PLANTING

SCALE 1" = 1'-0"

# MULCH RING, 6' DIA. MIN.

EVERGREEN TREE

NOTES:


-DO NOT HEAVILY PRUNE THE TREE AT PLANTING, PRUNE ONLY CROSSOVER LIMBS, CO-DOMINANT LEADERS, AND BROKEN OR DEAD BRANCHES. SOME INTERIOR TWIGS AND LATERAL BRANCHES MAY BE PRUNED; HOWEVER, DO NOT REMOVE THE TERMINAL BUDS OF BRANCHES THAT EXTEND TO THE EDGE OF THE CROWN

-STAKE TREES ONLY UPON THE APPROVAL OF THE LANDSCAPE ARCHITECT-IF APPLICABLE

-WRAP TREE TRUNKS ONLY UPON THE APPROVAL OF THE LANDSCAPE ARCHITECT-IF APPLICABLE

-IF PLANT IS SHIPPED WITH A WIRE BASKET AROUND THE ROOT BALL, CUT THE WIRE BASKET IN FOUR PLACES AND FOLD DOWN 8" INTO THE PLANTING HOLE

-REMOVE ALL TWINE, ROPE/WIRE, AND BURLAP FROM TOP HALF OF ROOT BALL

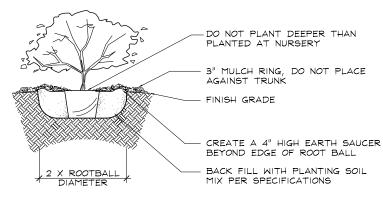


POTTED / CONTAINER PLANTING C7.3

5 10

-REFER TO SPECIFICATIONS FOR FURTHER INFORMATION

B#B TREE PLANTING DETAILS C7.3/TREES 3" CALIPER OR LESS

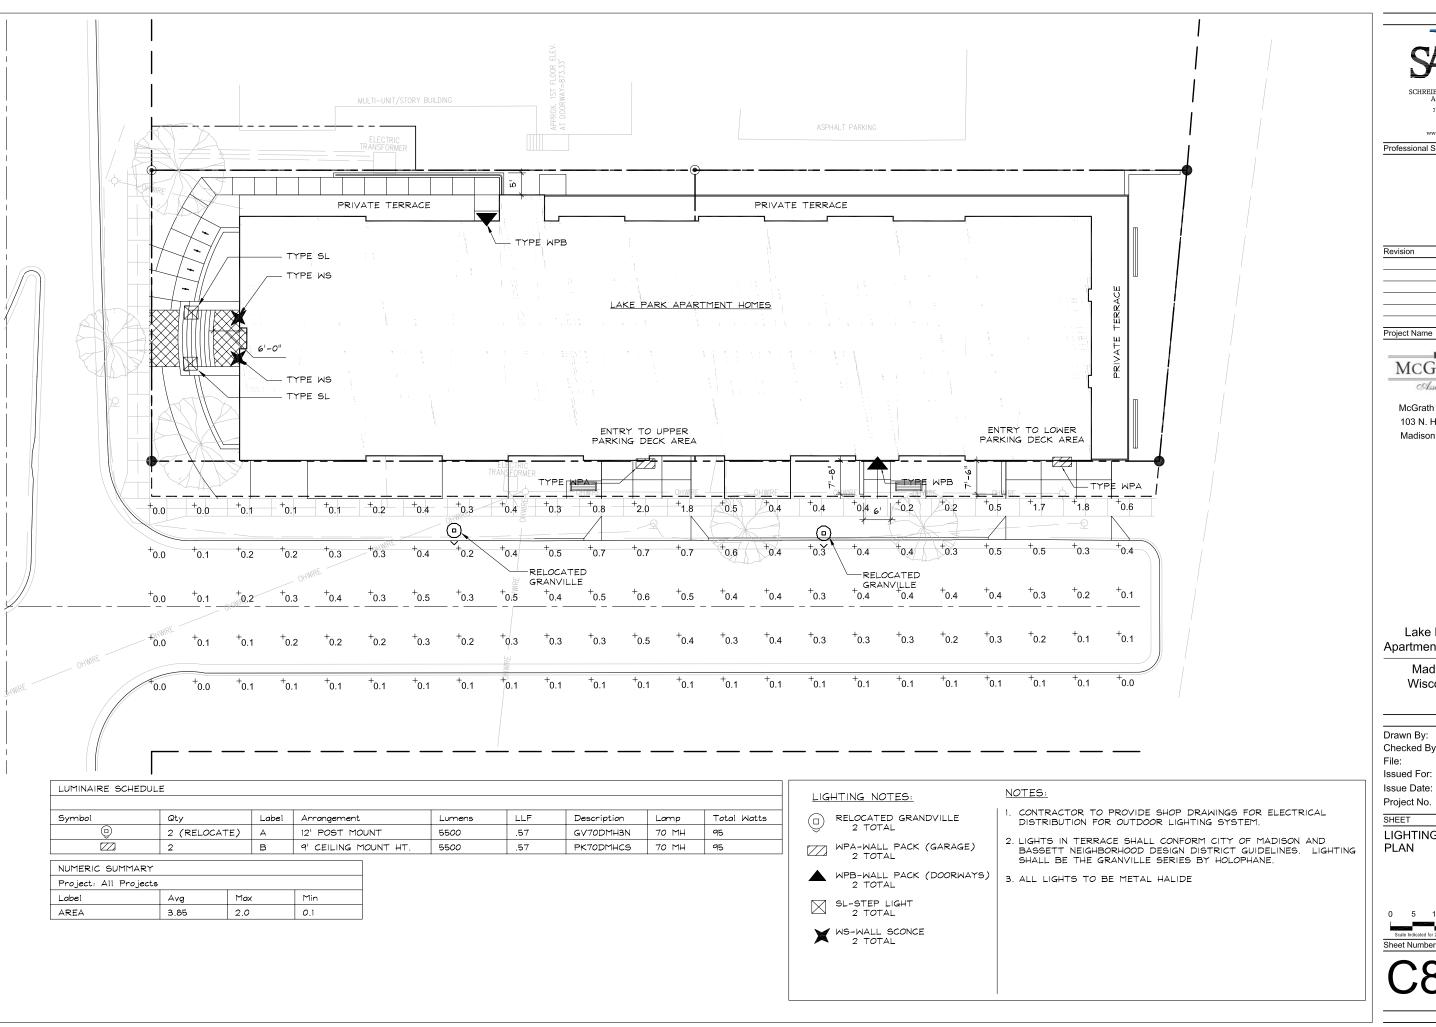

Ph. 608.255.0800 Fx. 608.255.7750 www.saa-madison.com

Professional Seal

Revision



McGrath Associates 103 N. Hamilton St. Madison, WI 53703

### Lake Park **Apartment Homes**


Madison Wisconsin

Drawn By: Checked By: P-Photo


Issue Date: 04/16/2008 Project No.


LIGHTING



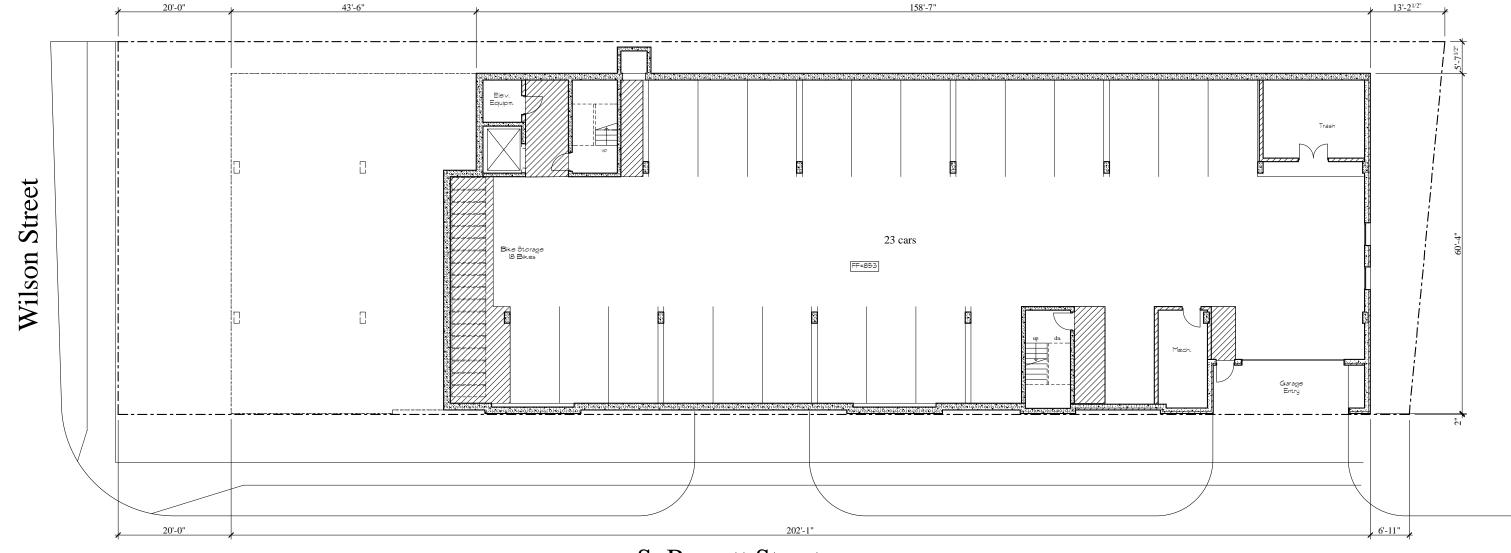



S. Bassett Street

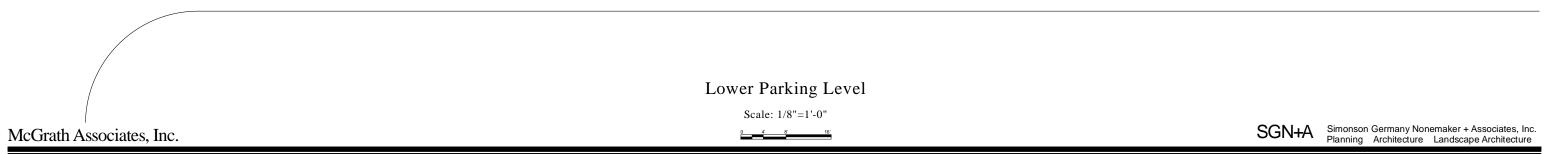

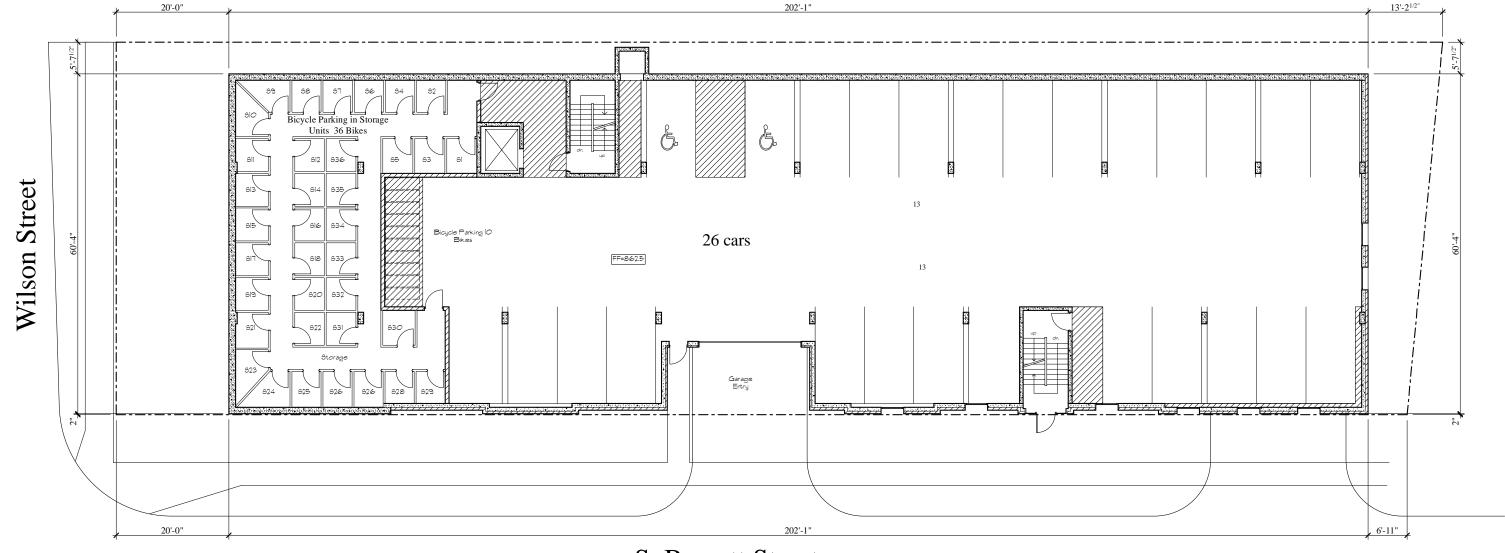

S. Bassett Street

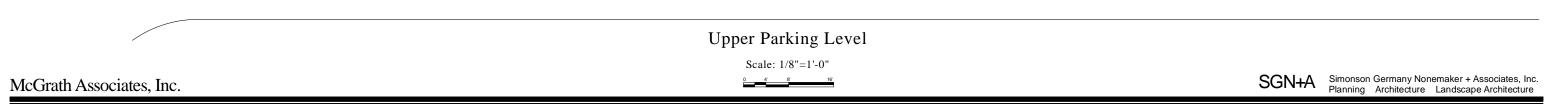

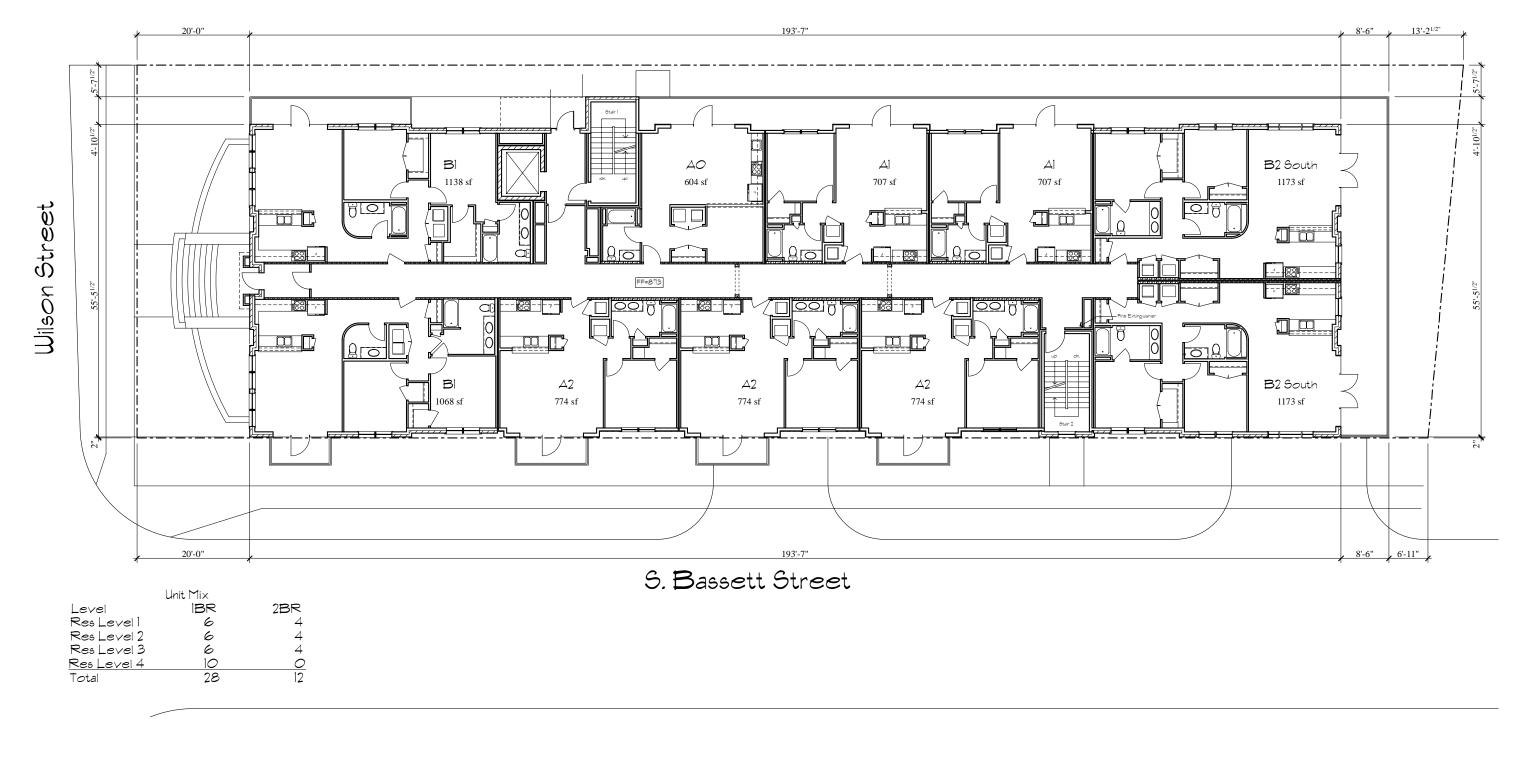


First Residential Level

Scale: 1/8"=1'-0"


McGrath Associates, Inc.



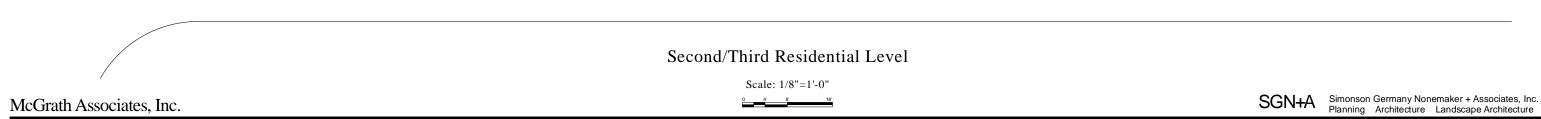


April 16, 2008



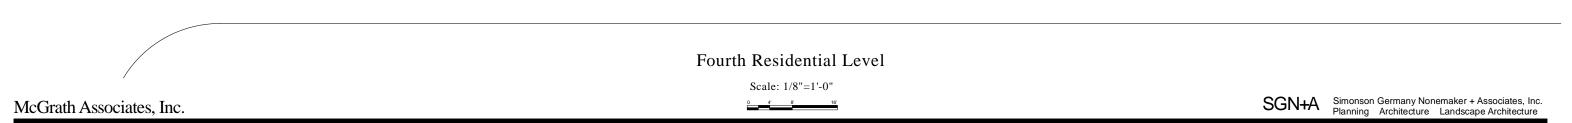

April 16, 2008

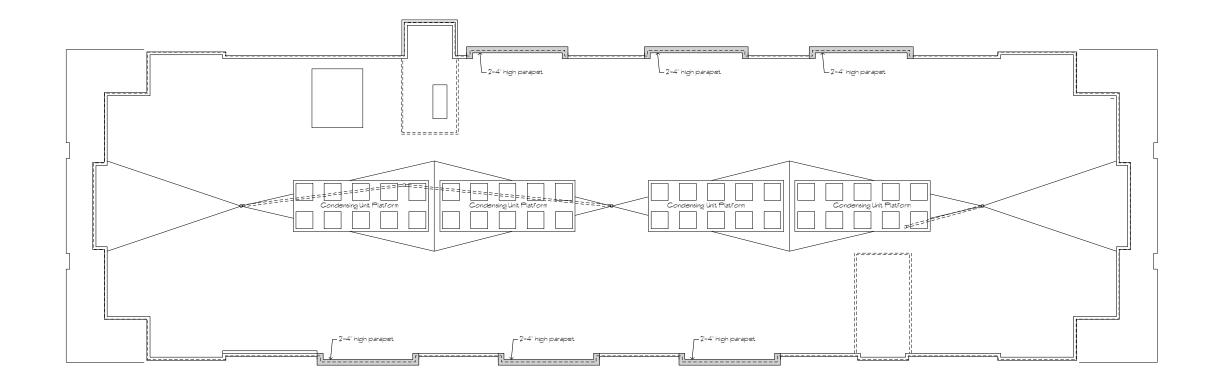

Roof Plan

Scale: 1/8"=1'-0"

McGrath Associates, Inc.





Wilson St. Elevation

Rear Elevation

**Building Elevations** 

Scale: 1/8"=1'-0"

McGrath Associates, Inc.



**Building Elevations** 

Scale: 1/8"=1'-0"


McGrath Associates, Inc.




**Building Elevations** 

Scale: 1/8"=1'-0"

McGrath Associates, Inc.

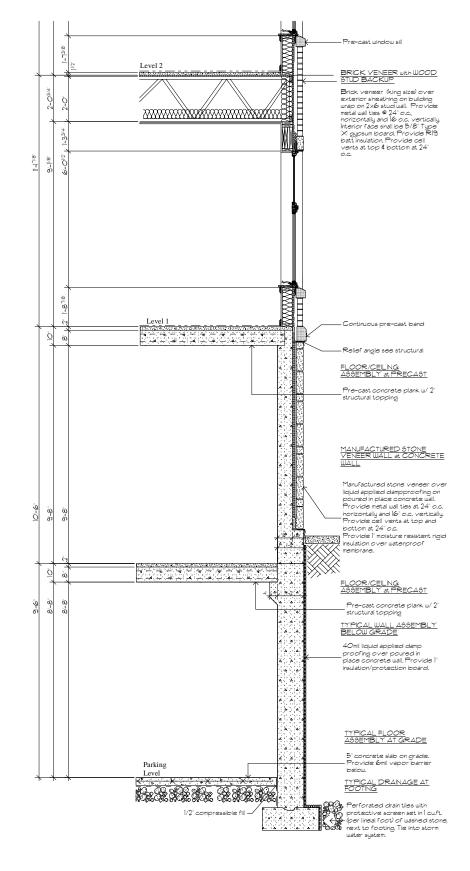


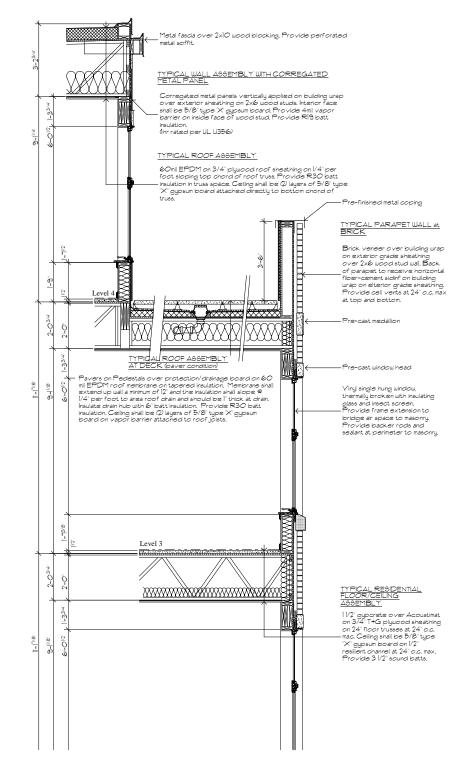

Typical Wall Section at Brick Veneer

Scale: 1/2"=1'-0"

McGrath Associates, Inc.

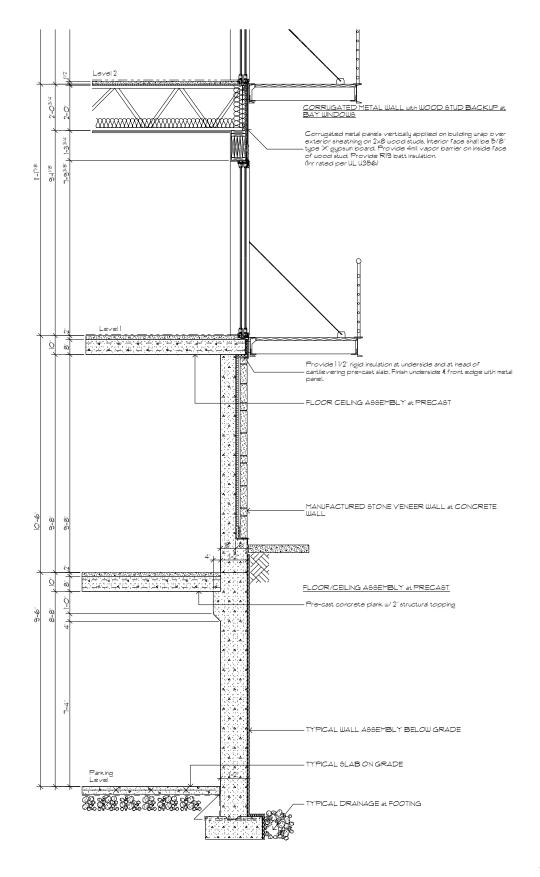

Metal panel medallion TYPICAL ROOF ASSEMBLY - Corrugated metal panel vertically applied . Metal panel door header. —Pre-finished aluminum rail Pre-finished metal frame hung off building to support wood decking TYPICAL FLOOR/CEILING ASSEMBLY

Wall Section at Bay Window

Scale: 1/2"=1'-0"

McGrath Associates, Inc.