


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ARCHITECTURE | PLANNING | DESIGN

1	ISSUED FOR PLANNING	06/20/18
<u>'</u>	REVISION / ISSUE	DATE
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THESE DOCUMENTS HAVE BEEN PREPARED BY ME OR UNDER MY CLOSE PERSONAL SUPERVISION, AND THEY

1/16" = 1'-0"



122 STATE ST. NEW HOTEL AND

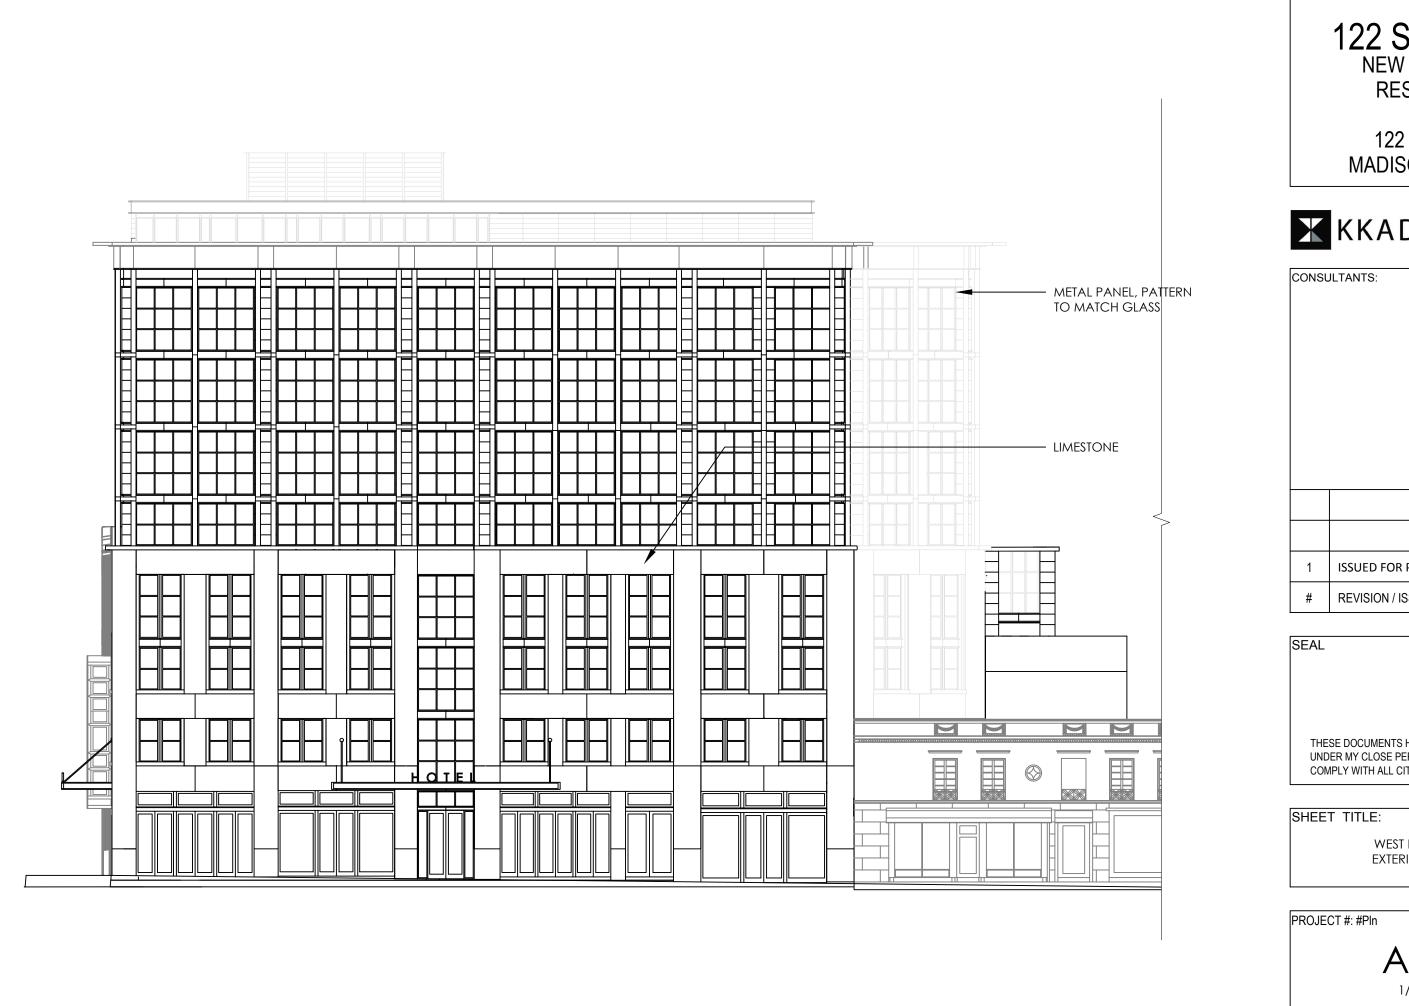RESTAURANT

122 STATE ST. MADISON, WI. 53703




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> WEST DAYTON STREET **EXTERIOR ELEVATIONS**

A-9.0

1/16" = 1'-0"



DISCLANER:
The underground utilities shown have been located from field survey information and existing drawings. The surveyor makes no guarantees that the underground utilities shown comprise all such utilities in the area, either in service or abandone. The surveyor further does not warrant that the underground utilities shown are in the exact location indicated although he does certify that they are located as accurately as possible from information available. The surveyor has not physically located the underground utilities.

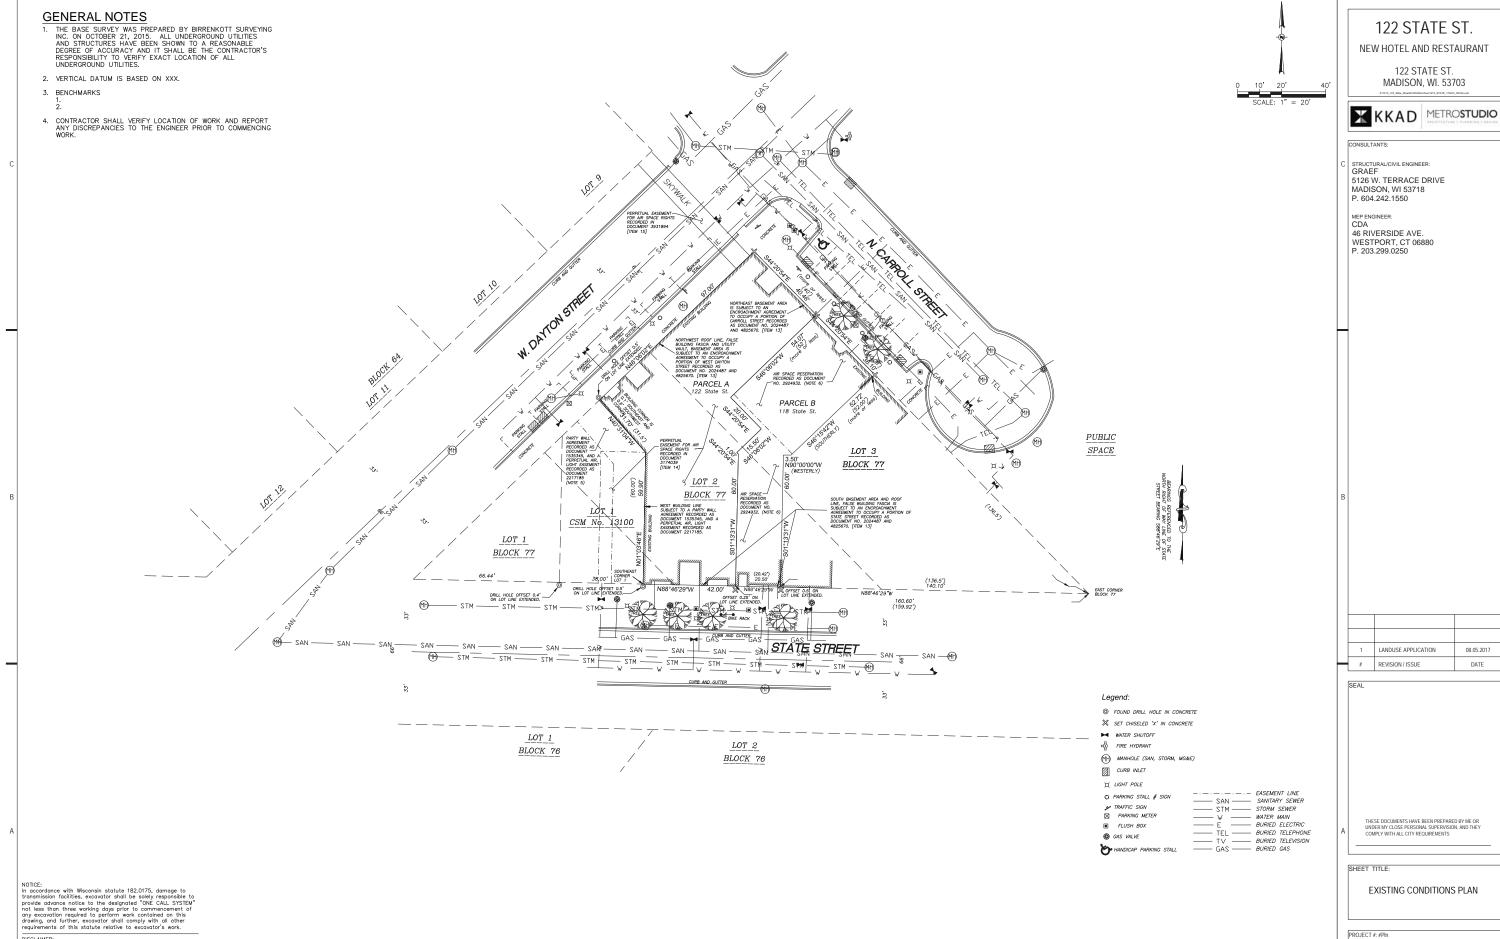C100

- 2. REFER TO SHEET C100 FOR BENCHMARKS, DATUM, AND TOPOGRAPHIC ELEMENTS.
- 3. CONTRACTOR SHALL VERIFY LOCATION OF WORK AND REPORT ANY DISCREPANCIES TO THE ENGINEER PRIOR TO COMMENCING

REMOVAL NOTES

- CONTRACTOR SHALL VERIFY ALL EXISTING UTILITY LINES NOTED FOR ABANDONMENT OR REMOVAL. EXISTING UTILITIES THAT ARE TO BE ABANDONED OR REMOVED SHALL BE RESPECTIVELY ABANDONED OR REMOVED TO THE LOCATIONS INDICATED ON THIS PLAN. ALL UTILITY STRUCTURES LOCATED ALONG REMOVED UTILITY LINES SHALL BE REMOVED IN THEIR ENTIRETY.
- 2. ASPHALT AND CONCRETE PAVEMENT NOTED FOR REMOVAL SHALL BE SAW CUT TO FULL DEPTH PRIOR TO REMOVAL.
- 3. CONCRETE CURB AND GUTTER AND SIDEWALK NOTED FOR REMOVAL SHALL BE REMOVED AT THE NEAREST JOINT.
- ITEMS SCHEDULED FOR REMOVAL AND EXCESS EXCAVATED MATERIALS SHALL BE DISPOSED OF OFF-SITE IN ACCORDANCE WITH ANY APPLICABLE REGULATIONS.
- 5. CONTRACTOR IS RESPONSIBLE FOR SECURING THE JOB SITE TO PROTECT THE PUBLIC.
- 6. CONTRACTOR IS RESPONSIBLE FOR COMPLIANCE WITH LOCAL ORDINANCES FOR DUST CONTROL.
- 7. UTILITIES SHALL BE REMOVED TO LOCATIONS INDICATED ON
- CONTRACTOR SHALL COMPLY WITH LOCAL, STATE, AND FEDERAL CODES, RULES AND REGULATIONS APPLICABLE TO DEMOLITION WORK INCLUDING BUT NOT LIMITED TO EROSION CONTROL, AIR POLLUTION, NOISE POLLUTION, AND WASTE DISPOSAL.
- 9. CONTRACTOR SHALL REPLACE PAVEMENT, CURB AND GUTTER, TREES, LAWN AREA, ANY ABOVE GROUND APPETENCIES, OR ANY OTHER ITEM THAT WAS DAMAGED AS A RESULT OF CONSTRUCTION RELATED ACTIVITIES AS DEEMED BY OWNERS REPRESENTATIVE THAT WAS NOT CALLED OUT FOR REMOVAL OR REPLACEMENT. CONTRACTOR SHALL REPLACE/REPAIR DAMAGED ITEM TO THE SATISFACTION OF OWNER'S REPRESENTATIVE AT NO ADDITIONAL SATISFACTION OF OWNER'S REPRESENTATIVE AT NO ADDITIONAL COST TO THE OWNER.
- 10. TREE PROTECTION FENCING LOCATIONS SHOWN ARE APPROXIMATE . TREE, PROTECTION FENCING LOCATIONS SHOWN ARE APPROXIMATE ALL EXISTING TREES OUTSIDE OF PROJECT LIMITS ARE INTENDED TO REMAIN, FINAL LOCATIONS OF FENCING SHALL BE DETERMINED IN THE FIELD AND AS IDENTIFIED ON CONSTRUCTION DETAILS. ADDITIONAL FENCING MAY BE REQUIRED, COORDINATE WITH OWNER'S REPRESENTATIVE. TREE PROTECTION FENCE SHALL REMAIN IN PLACE THROUGHOUT CONSTRUCTION.
- 11. REMOVE ALL PLANTER POTS AND TRASH CANS. COORDINATE WITH THE CITY OF MADISON ON FINAL LOCATION.

NOTICE: In accordance with Wisconsin statute 182.0175, damage to transmission facilities, excavator shall be solely responsible to provide advance notice to the designated "ONE CALL SYSTEM" not less than three working days prior to commencement of any excavation required to perform work contained on this drawing, and further, excavorts shall comply with all other requirements of this statute relative to excavator's work.

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12. CONTRACTOR SHALL FILL ALL EXISTING VALUETS SURROUNDING THE BUILDING THAT ARE TO BE ABANDONED.

N. CARROLL STREET -CONCRETE PAVEMENT REMOVAL X X X X X X X -SAWCUT -CONCRETE CURB AND GUTTER REMOVAL -SITE FEATURE REMOVAL -INLET PROTECTION REMOVE EXISTING RAMP AND TRUNCATED DOMES -TREE PROTECTION ASPHALT PAVEMENT -TREE REMOVAL REMOVAL (TYP.) EXISTING SKYWALK TO BE REMOVED -PEDESTRIAN CROSSING SIGN AND POLE TO BE REMOVED, SALVAGED, AND REINSTALLED PER THE CITY OF MADISON EXISTING STREET LIGHT TO BE REMOVED SALVAGED, AND REINSTALLED PER THE CITY OF MADISON -REMOVE, SALVAGE, AND REINSTALL STORM INLET CASTING CONCRETE PAVEMENT REMOVAL (TYPA) REMOVE BOLLARDS, PARKING SIGNS, PARKING NUMBERS, AND PARKING PAY STATION. COORDINATE WITH THE CITY OF MADISON ON STORAGE LOCATION PARKING SIONS AND STREET JOHTS TO REMAIN AND BE PROTECTED -REMOVE EXISTING PARKING STRIPING AND HANDICAP PAINT (TYP.) -REMOVE, SALVAGE, AND REINSTALL STORM INLET CASTING CAP EXISTING WATER SERVICE - EXISTING UTILITIES TO REMAIN AND BE PROTECTED (TYP.) CONCRETE CURB AND TRÉE REMOVAL (TYP.) GUTTER REMOVAL (TYP.) INLET PROTECTION (TYP.) STREET LIGHT TO REMAIN AND BE PROTECTED (TYP.) EXISTING CURB AND GUTTER-SPACE LOT 3 TO REMAIN (TYP.) BLOCK 77 EXISTING PAVEMENT TO REMAIN LOT 2 BLOCK 77 REMAIN AND BE PROTECTED DURING CONSTRUCTION CSM No. 13100 - RELOCATE BIKE RACK AS NEEDED DURING CONSTRUCTION CAP EXISTING SANITARY-LOT 1 BLOCK 77 -CAP EXISTING \ LIGHT POLE TO REMAIN AND BE PROTECTED (TYP.) CAP EXISTING WATER SERVICE STORM LATERAL -SAWCUT (TYP) — SAN — ___ MT2 _____ MT2 __ STATE STREET - STM (M) TREES TO REMAIN AND BE PROTECTED. REMOVE, SALVAGE, AND REINSTALL TREE GRATE. -EXISTING LIGHT POLES TO REMAIN AND BE PROTECTED DURING CONSTRUCTION -CAP EXISTING SANITARY SEWER LATERAL

EROSION CONTROL NOTES

LEGEND

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-ASPHALT PAVEMENT REMOVAL

- CONSTRUCTION SITE EROSION CONTROL AND SEDIMENTATION CONTROL SHALL COMPLY WITH THE REQUIREMENTS OF THE CITY OF MADISON, AND SHALL EMPLOY EROSION CONTROL METHODS AS SHOWN AND SPECIFIED IN THE WISCONSIN DEPARTMENT OF NATURAL RESOURCES (WDNR) "CONSTRUCTION SITE EROSION AND SEDIMENT CONTROL TECHNICAL STANDARDS".
- ALL EROSION CONTROL MEASURES SHALL BE ADJUSTED TO MEET FIELD CONDITIONS AT THE TIME OF CONSTRUCTION AND SHALL BE INSTALLED PRIOR TO ANY GRADING OR DISTURBANCE OF EXISTING SURFACE MATERIAL ON THE SITE.
- ALL EROSION AND SEDIMENT CONTROL MEASURES WILL BE CHECKED FOR STABILITY AND OPERATION AFTER A RAINFALL OF 0.5 INCHES OR MORE, BUT NO LESS THAN ONCE EVERY WEEK, MAINTENANCE OF ALL EROSION CONTROL STRUCTURES SHALL BE PROVIDED TO INSURE INTENDED PURPOSE IS ACCOMPUSHED. REPAIRS AND MAINTENANCE SHALL BE COMPLETED WITHIN 24 HOURS OF INSPECTION. CONTRACTOR SHALL BE RESPONSIBLE FOR CLEANUP AND REMOVAL OF ALL SEDIMENT WHEN LEAVING PROPERTY. EROSION CONTROL MEASURES MUST BE IN WORKING CONDITION AT END OF EACH WORK DAY.
- 4. PERIODIC STREET SWEEPING SHALL BE COMPLETED TO MAINTAIN THE PUBLIC STREET FREE OF DUST AND DIRT.

- 5. CONSTRUCTION SEQUENCE FOR EROSION CONTROL INCLUDES:
 1. INSTALL INLET PROTECTION.
 2. REMOVE EXISTING PAYEMENT AND UTILITIES NOTED FOR REMOVAL
 3. PERFORM MASS EXCAVATION
 4. COMPLETE BUILDING CONSTRUCTION, INSTALLING ALL OTHER UTILITIES, AND FINAL GRADING.
 5. PAVE PARKING LOTS, DRIVES, AND SIDEWALKS.
 6. REMOVE EROSION CONTOL DEVICES ONCE THE SITE IS STABILIZED AND PERMANENT VEGETAION IS ESTABILISHED AS APPROVED BY THE ENGINEER.
- 6. SITE DEWATERING. WATER PUMPED FROM THE SITE SHALL BE TREATED BY APPROPRIATE BEST MANAGEMENT PRACTICES SPECIFIED IN THE WDNR "CONSTRUCTION SITE EROSION AND SEDIMENT CONTROL TECHNICAL STANDARDS" AND IN ACCORDANCE WITH CITY OF MADISON ENGINEERING DEPARTMENT. WATER SHALL NOT BE DISCHARGED IN A MANNER THAT CAUSES EROSION OF THE SITE, ADJACENT SITES, OR
- 7. WASTE AND MATERIAL DISPOSAL. ALL WASTE AND UNUSED BUILDING MATERIALS (INCLUDING GARBAGE, DEBRIS, CLEANING WASTES, WASTEWATER, TOXIC MATERIALS, OR HAZARDOUS MATERIALS) SHALL BE PROPERLY DISPOSED AND NOT ALLOWED TO BE CARRIED OFF-SITE BY RUNOFF OR WIND.
- 8. SEDIMENT CLEANUP. ALL OFF-SITE SEDIMENT DEPOSITS OCCURRING AS A RESULT OF A STORM EVENT SHALL BE CLEANED UP BY THE END OF THE NEXT WORK DAY. ALL OTHER OFF-SITE SEDIMENT DEPOSITS OCCURRING AS A RESULT OF CONSTRUCTION ACTIVITIES SHALL BE CLEANED UP BY THE END OF THE THE
- WHEN THE DISTURBED AREA HAS BEEN STABILIZED BY PERMANENT VEGETATION OR OTHER MEANS, TEMPORARY BEST MANAGEMENT PRACTICES.
- 10. NOTIFY THE CITY OF MADISON WITHIN TWO WORKING DAYS OF COMMENCING ANY LAND DEVELOPMENT OR LAND DISTURBING ACTIVITY.
- 11. NOTIFY THE CITY OF MADISON OF COMPLETION OF ANY BEST MANAGEMENT PRACTICES WITHIN THE NEXT WORKING DAY AFTER THEIR INSTALLATION.
- 12. OBTAIN PERMISSION IN WRITING FROM THE CITY OF MADISON ENGINEERING DEPARTMENT PRIOR TO MODIFYING THE EROSION CONTROL PLAN. NOTIFY WDNR AT LEAST FIVE WORKING DAYS PRIOR TO IMPLEMENTING CHANGES TO THE EROSION CONTROL PLAN.
- 13. REPAIR ANY SILTATION OR EROSION DAMAGE TO ADJOINING SURFACES AND DRAINAGE WAYS RESULTING FROM LAND DEVELOPMENT OR LAND DISTURBING ACTIVITIES.
- 14. KEEP A COPY OF THE EROSION CONTROL PLAN ON SITE.

122 STATE ST.

NEW HOTEL AND RESTAURANT

122 STATE ST MADISON, WI. 53703



STRUCTURAL/CIVIL ENGINEER GRAEF 5126 W. TERRACE DRIVE MADISON, WI 53718 P. 604.242.1550

MEP ENGINEER 46 RIVERSIDE AVE. WESTPORT, CT 06880 P. 203.299.0250

LANDUSE APPLICATION 08.05.2017 # REVISION / ISSUI DATE

COMPLY WITH ALL CITY REQUIREMENTS

SHEET TITLE:

DEMOLITION AND EROSION CONTROL PLAN

3. CONTRACTOR SHALL MATCH EXISTING SIDEWALK JOINTING PATTERN.

4. CONTRACTOR SHALL COORDINATE WITH THE CITY OF MADISON ON ANY RELOCATION AND REINSTALLATIONS OF STREET LIGHTS, SIGNS, AND PAY STATION.

5. ALL PROPOSED WORK WITHIN RIGHT-OF-WAY WILL NEED TO MEET CITY OF MADISON STANDARDS AND SPECIFICATIONS.

LAND USE SUMMARY

TOTAL PARCEL AREA	9,835 S.F.	0.23 ACRES
RIGHT-OF-WAY PAVED AREA	4,995 S.F.	0.11 ACRES
RIGHT-OF-WAY LANDSCAPED AREA	0 S.F.	0.00 ACRES
TOTAL SITE AREA	14,830 S.F.	0.34 ACRES

BUILDING SUMMARY

BASEMENT	10,366 S.F
1ST FLOOR/LOBBY/LOWER LOBBY	10,366 S.F.
2ND FLOOR	10,242 S.F
3RD FLOOR	10,115 S.F.
4TH FLOOR	10,115 S.F.
5TH FLOOR	10,188 S.F.
6TH FLOOR	8,270 S.F.
7TH FLOOR	8,270 S.F.
8TH FLOOR	8,165 S.F.
PENTHOUSE/TERR	8,563 S.F.
ROOF/MECH	5,050 S.F
GROSS BUILDING	99,650 S.F.
OVERALL BUILDING SITE	10,336 S.F
LOT COVERAGE	100%
USEABLE OPEN SPACE	0 S.F.
LANDSCAPE AREA	0 S.F.
PAVED AREA	0 S.F.

UNIT SIZE BREAKDOWN BY BEDROOM = SEE ARCHITECTURAL PLANS

NUMBER AND SIZE OF TENANT UNIT = SEE ARCHITECTURAL PLANS/

LEGEND -PROPOSED ASPHALT PAVEMENT

-PROPOSED CONCRETE SIDEWALK

-PROPOSED HEAVY DUTY CONCRETE PAVEMENT

-PROPOSED CONCRETE CURB AND GUTTER -PROPOSED FLUSH CURB AND GUTTER

R -PROPOSED RAMP

LAND USE SUMMARY NOTES

EIGHT (8) PARKING SPACES OFF CARROLL STREET ARE BEING ELIMINATED.



PROPOSED SLIDING

PROJECT LIMITS-

PROPOSED BUILDING ARCHITECTURAL PLAN

LOT 1

BLOCK 76

LOT 1 BLOCK 77

PROPOSED BUILDING -CANOPY - SEE ARCHITECTURAL PLANS

PROPOSED BUILDING LOBBY ELEV = 99.84 LOWER LOBBY ELEV. 96.84

> 61.94' LOT 2 BLOCK 77

CONNECT TO EXISTING CURB AND GUTTER СUкь . (TYP.) _______3____

STM STM W STM W

BLOCK 77

-PROPOSED ASPHALT PAVEMENT (TYP.)

PROPOSED BUILDING

CANOPY - SEE ARCHITECTURAL PLANS

-PROPOSED CONCRETE SIDEWALK (TYP.)

-PROPOSED FLUSH CURB AND GUTTER

SPACE

SAN ——M

STATE STREET

LOT 2

BLOCK 76

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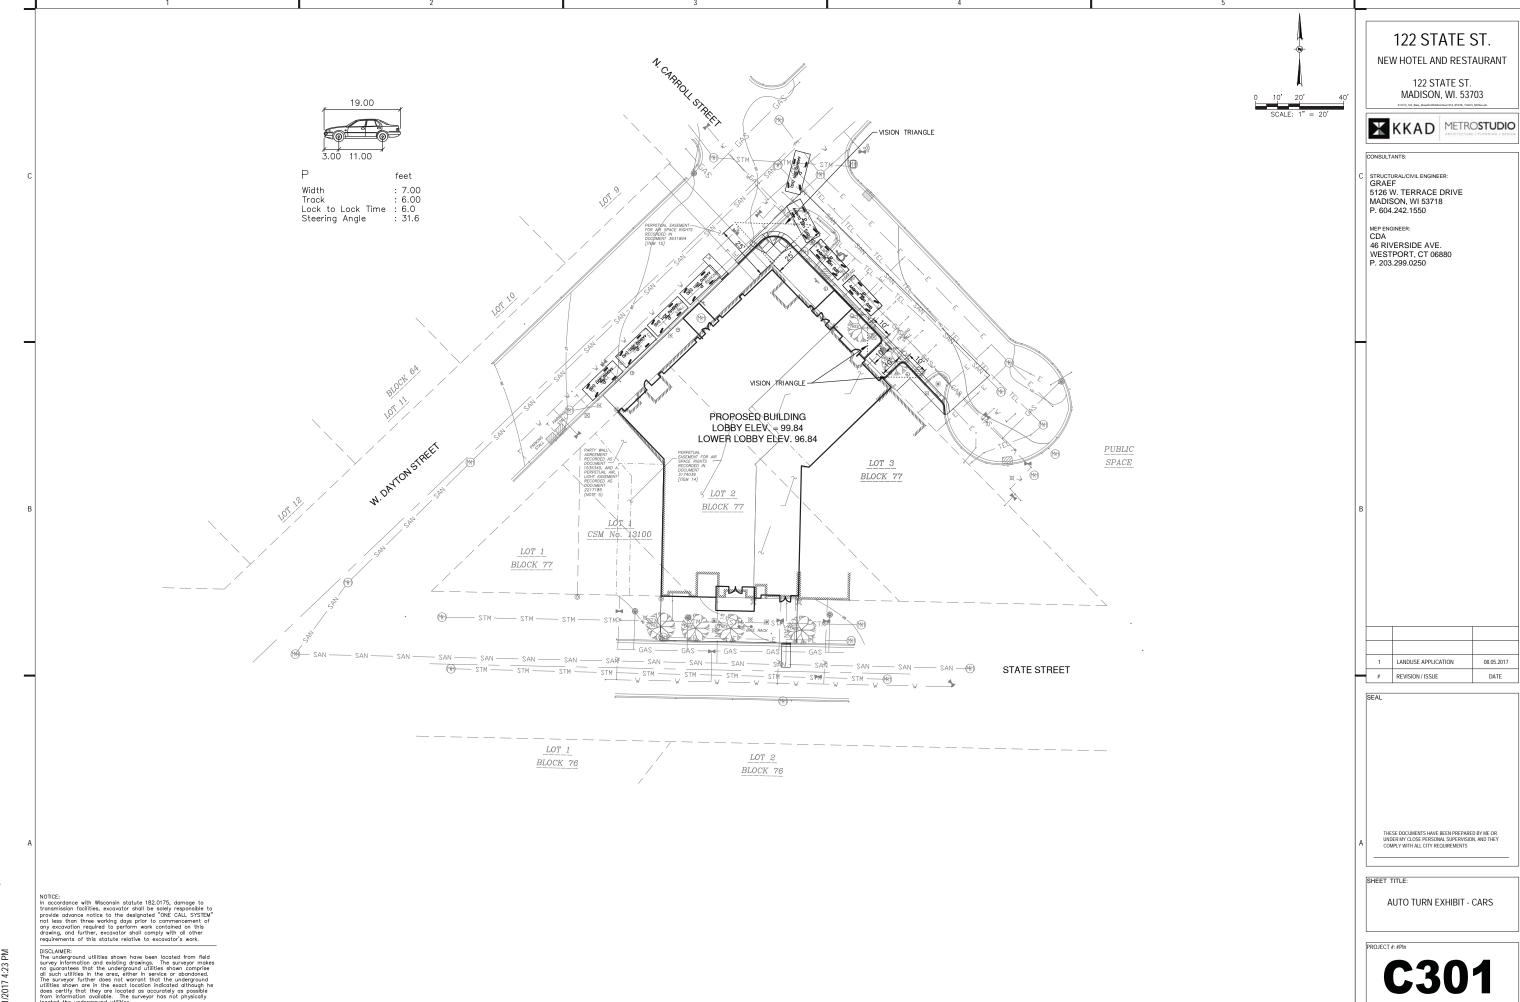
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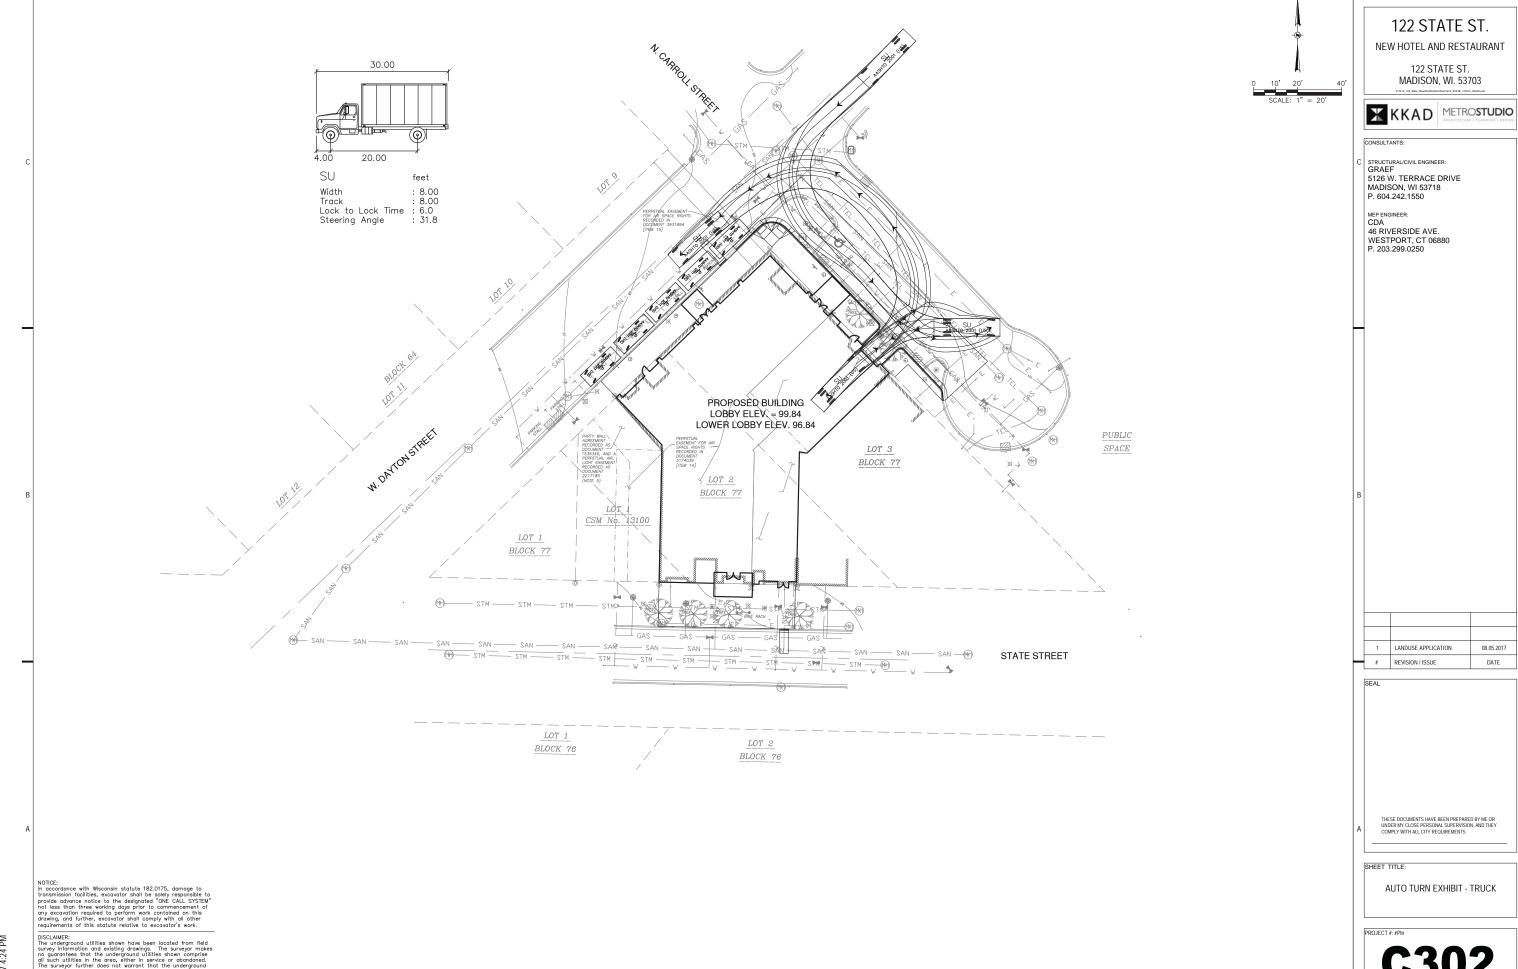
SHEET TITLE:

OVERALL SITE PLAN


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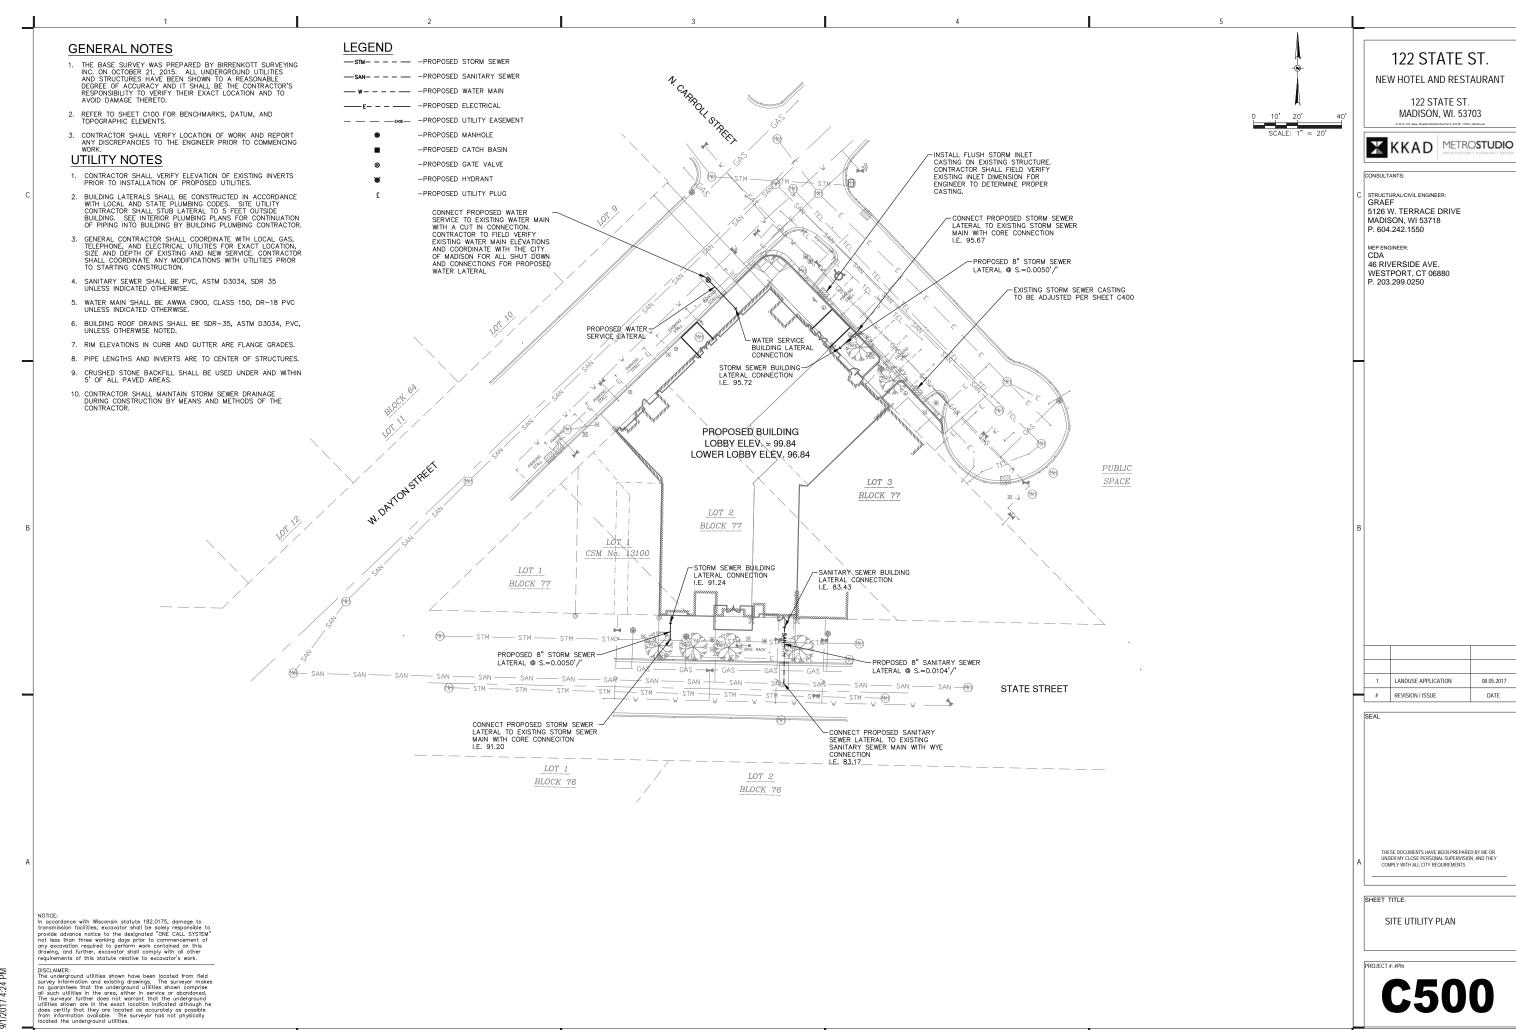
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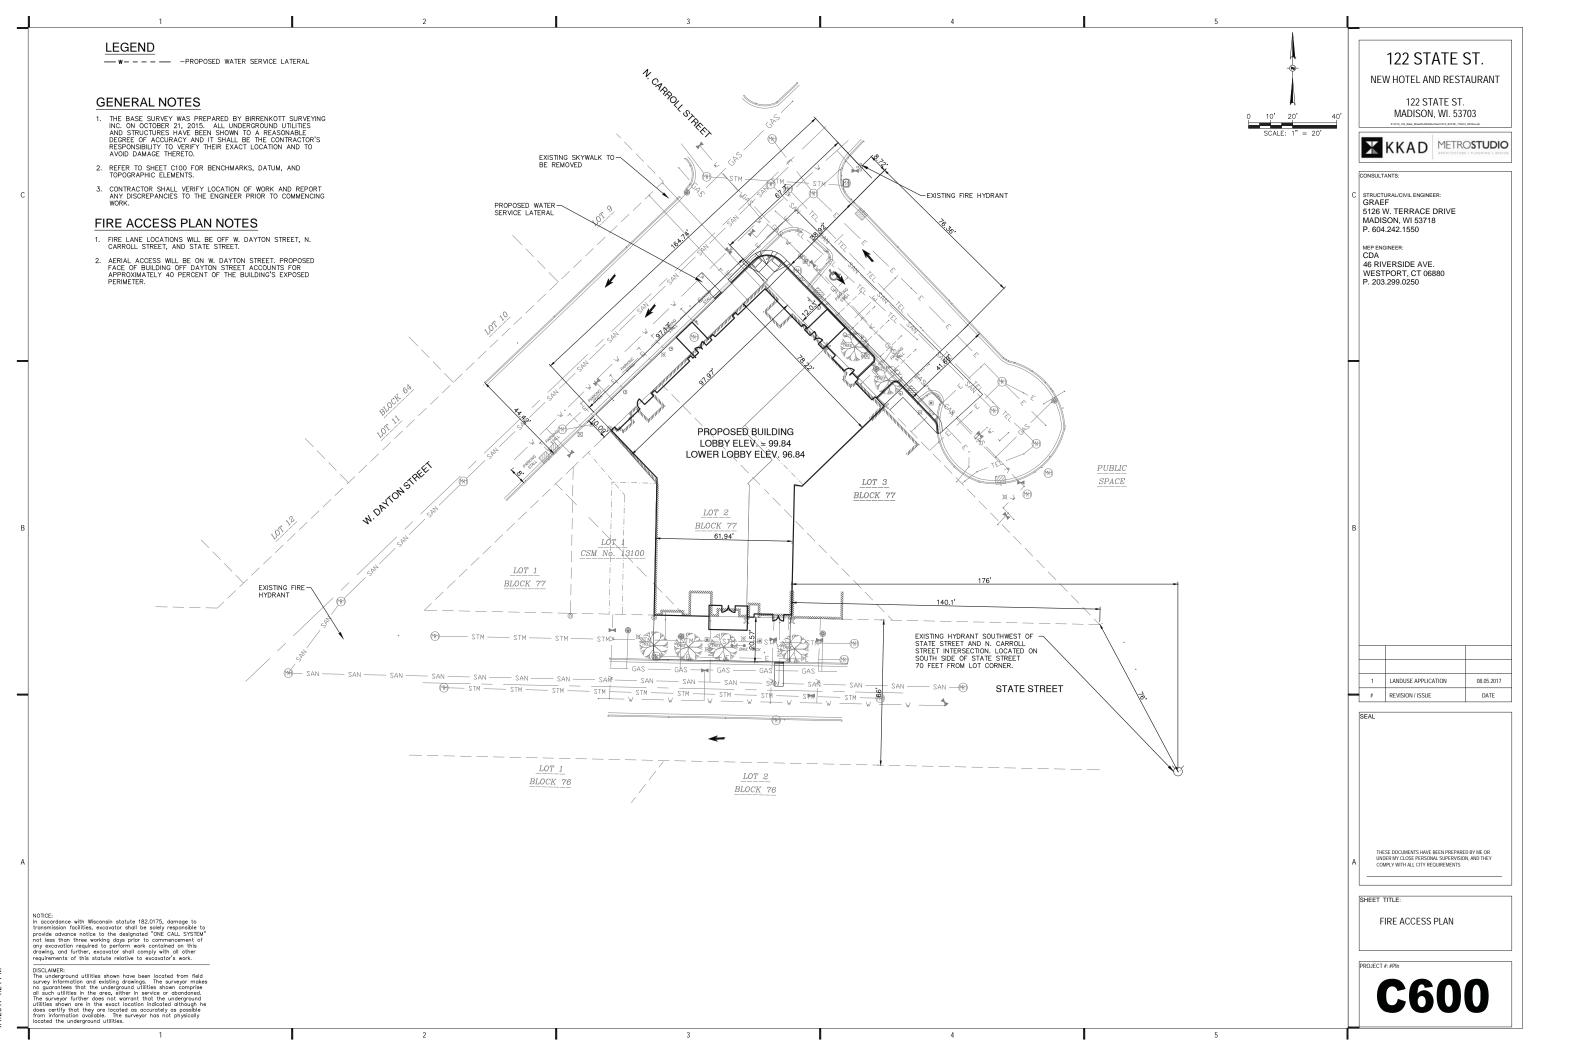
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08.05.2017

DATE



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DAYTON/CARROLL CORNER PERSPECTIVE



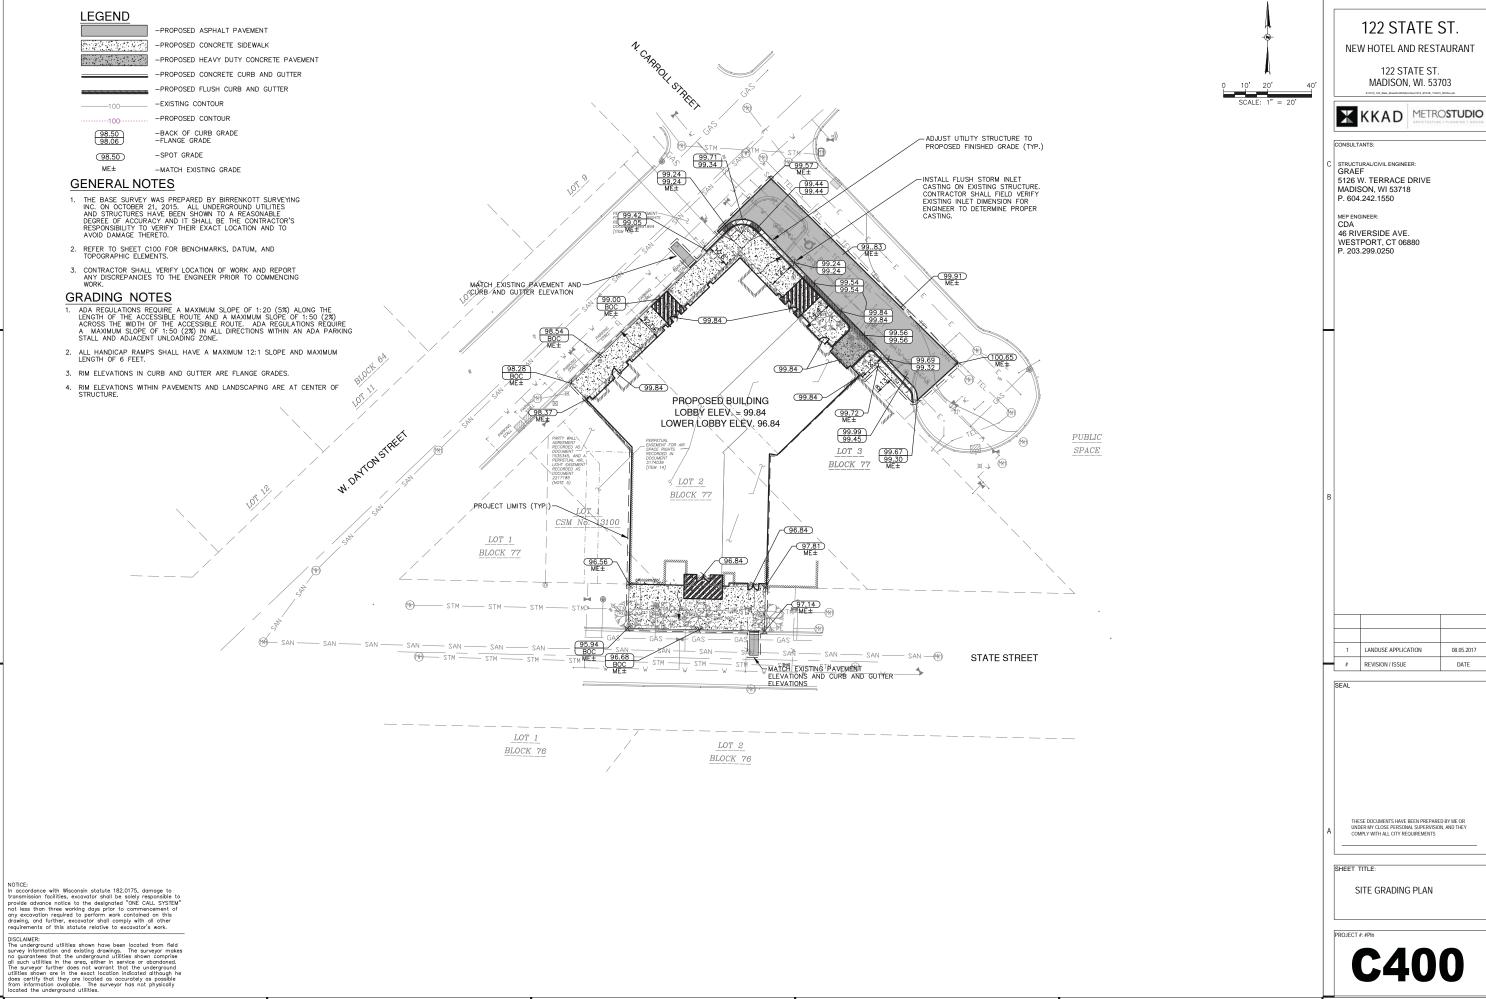















STATE STREET EAST-FACING PERSPECTIVE














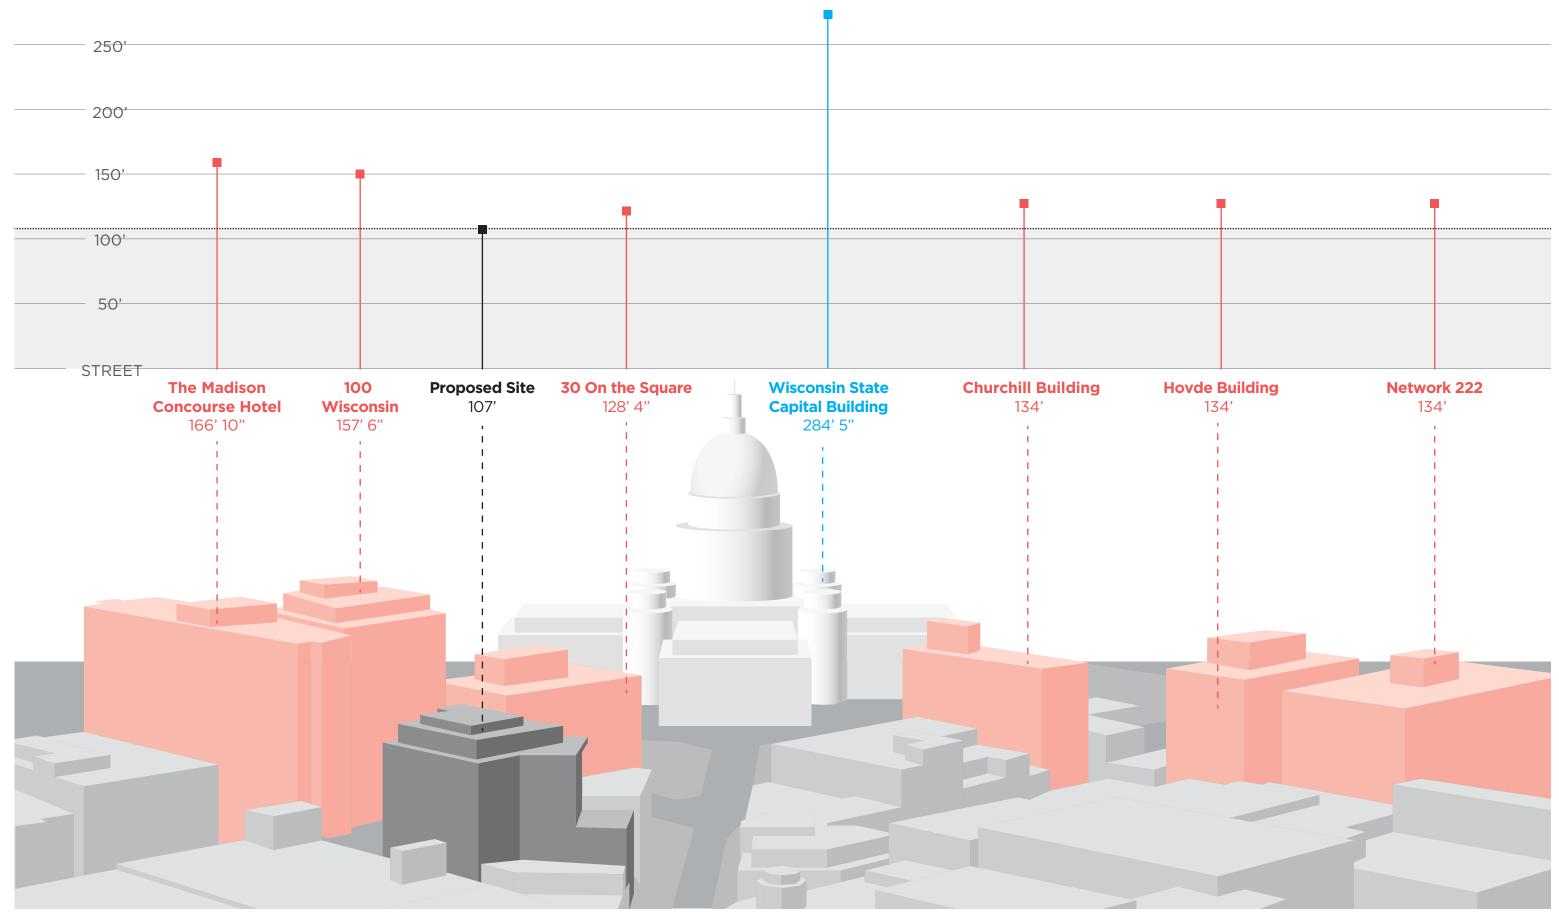













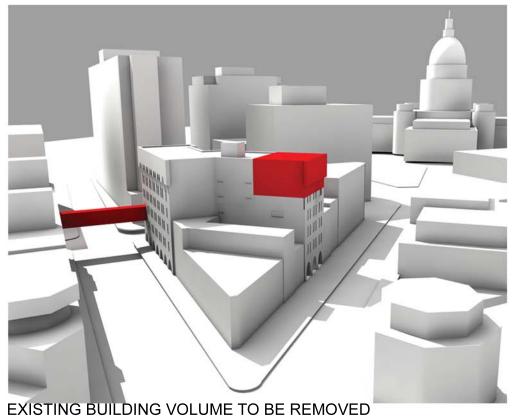

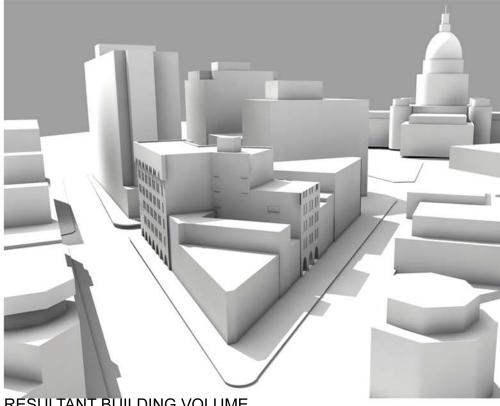



RESULTANT BUILDING VOLUME

PROPOSED NEW BUILDING











