

7707 Harwood Avenue | Milwaukee, WI 53213 | zastudios.com TELEPHONE [414] 476.9500 FACSIMILE [414] 476.8582

## Letter of Intent For:

# **Linden Park Elementary School**

801 Redan Drive Madison, WI

January 3, 2007

Summary

Linden Park Elementary will be a newly constructed school within the Veridian Homes Neighborhood Development of the same name. The school will be home to 650 students in five classes per grades K-5. This project will utilize sustainable energy in the form of cool daylighting, geothermal heating/cooling and wind generation that will contribute to a LEED Silver Certification.

**Legal Description of Property:** 

Outlot 22 of Linden Park Development

**Construction Schedule:** 

April 2007 thru August 2008

**Project Contacts:** 

Following Page

**Building Use:** 

**New Elementary School** 

Total Building Gross Sq. Ft.:

First Floor

50,141 s.f.

Second Floor

39,779 s.f.

Total

89,920 s.f.

**Total Building Occupants:** 

Students

650

Staff

90

Total

740

# **Parking Spaces:**

Spaces Required

45 (One parking space for every two (2) employees)

Spaces Provided

116

Faculty/Staff

95 (5 accessible, including 1 van)

Visitor

21 (1 accessible)

**Hours of Operation:** 

M-F 6:00 a.m. to 10:00 p.m.

Site Acreage:

8.3 acres

Trash removal will be via garbage/recycling service.

Snow will be plowed and remain on site.

Maintenance equipment will be stored within the building proper.

# **Project Contacts**

**Owner** 

**Madison Metropolitan School District** 

545 West Dayton Street Madison, WI 53718

Owner Representative

Doug Pearson, CFM, CEM Director of Building Services

4711 Pflaum Road Madison, WI 53718

608.204.7909 fax 608.204.0373

Owner Project Manager

Rick Hopke, P.E.

Coordinator of Facilities Engineering 608,204,7912 fax 608,204.0373

<u>Surveyor</u> STS Consultants

2821 Dairy Drive, Suite 5

Madison, WI 53718

608.222.7231 fax 608.222.3765

Project Engineer

Matthew D.Emrick, P.E.

**Architect** 

**Zimmerman Architectural Studios** 

7707 Harwood Avenue Milwaukee, WI 53213

414.476.9500 fax 414.476.8582

Project Architect

Doug Barnes, AIA, REFP

414.918.1461 Mark Wershay

Project Manager

414.918.1331

Landscape Architect

Joe Pepitone, ASLA

414.918.1475

**Engineer** 

Harwood Engineering Consultants, Ltd.

7420 W. State Street Wauwatosa, WI 53213

414.475.5554 fax 414.475.5698

Civil

Thomas B. Olejniczak, P.E., LEED AP

414.918.1240

Structural

Conrad Ettmayer, P.E.

414.918.1220

**Plumbing** 

Patrick Geraghty, D.E., CIPE

414.918.1232

Mechanical

Robert Bueches, D.E., LEED AP

414.918.1237

Electrical

Tom Peterson, P.E.

414.918.1225



ARCHITECTURE | ENGINEERING | INTERIORS | PLANNING | LANDSCAPE ARCHITECTURE

7707 Harwood Avenue | Milwaukee, WI 53213 | zastudios.com

TELEPHONE FACSIMILE [414] 476-9500 [414] 476-8582

# **TRANSMITTAL**

ТО	Secretary
COMPANY	Planning & Development Office 215 Martin Luther King Jr. Blvd Rm. LL-100 Madison, WI 53701
PROJECT NAME	Madison Metropolitan School District Linden Park Elementary School 801 Redan Drive Verona, WI 53593
PROJECT NUMBER	060092.00
DATE	January 3, 2007

# URGENT ○ FOR REVIEW ✓ FOR COMMENT ○ FOR YOUR USE ○ AS REQUESTED ○

FOR YOUR FILES ✓

#### NOTES / COMMENTS


Secretary,

Please find attached our submittal for the Initial Approval and/or Recommendation for the January 10<sup>th</sup> UDC meeting. This submittal includes:

- (1) Copy UDC Application Form
- (14) Copies 11x17 Presentation drawings
- (14) Copies Letter of Intent
- (1) Disk Individual .PDF Files of the Above


VERY TRULY YOURS; Mark Wershay Project Manager


Direct Phone: 414.918.1331

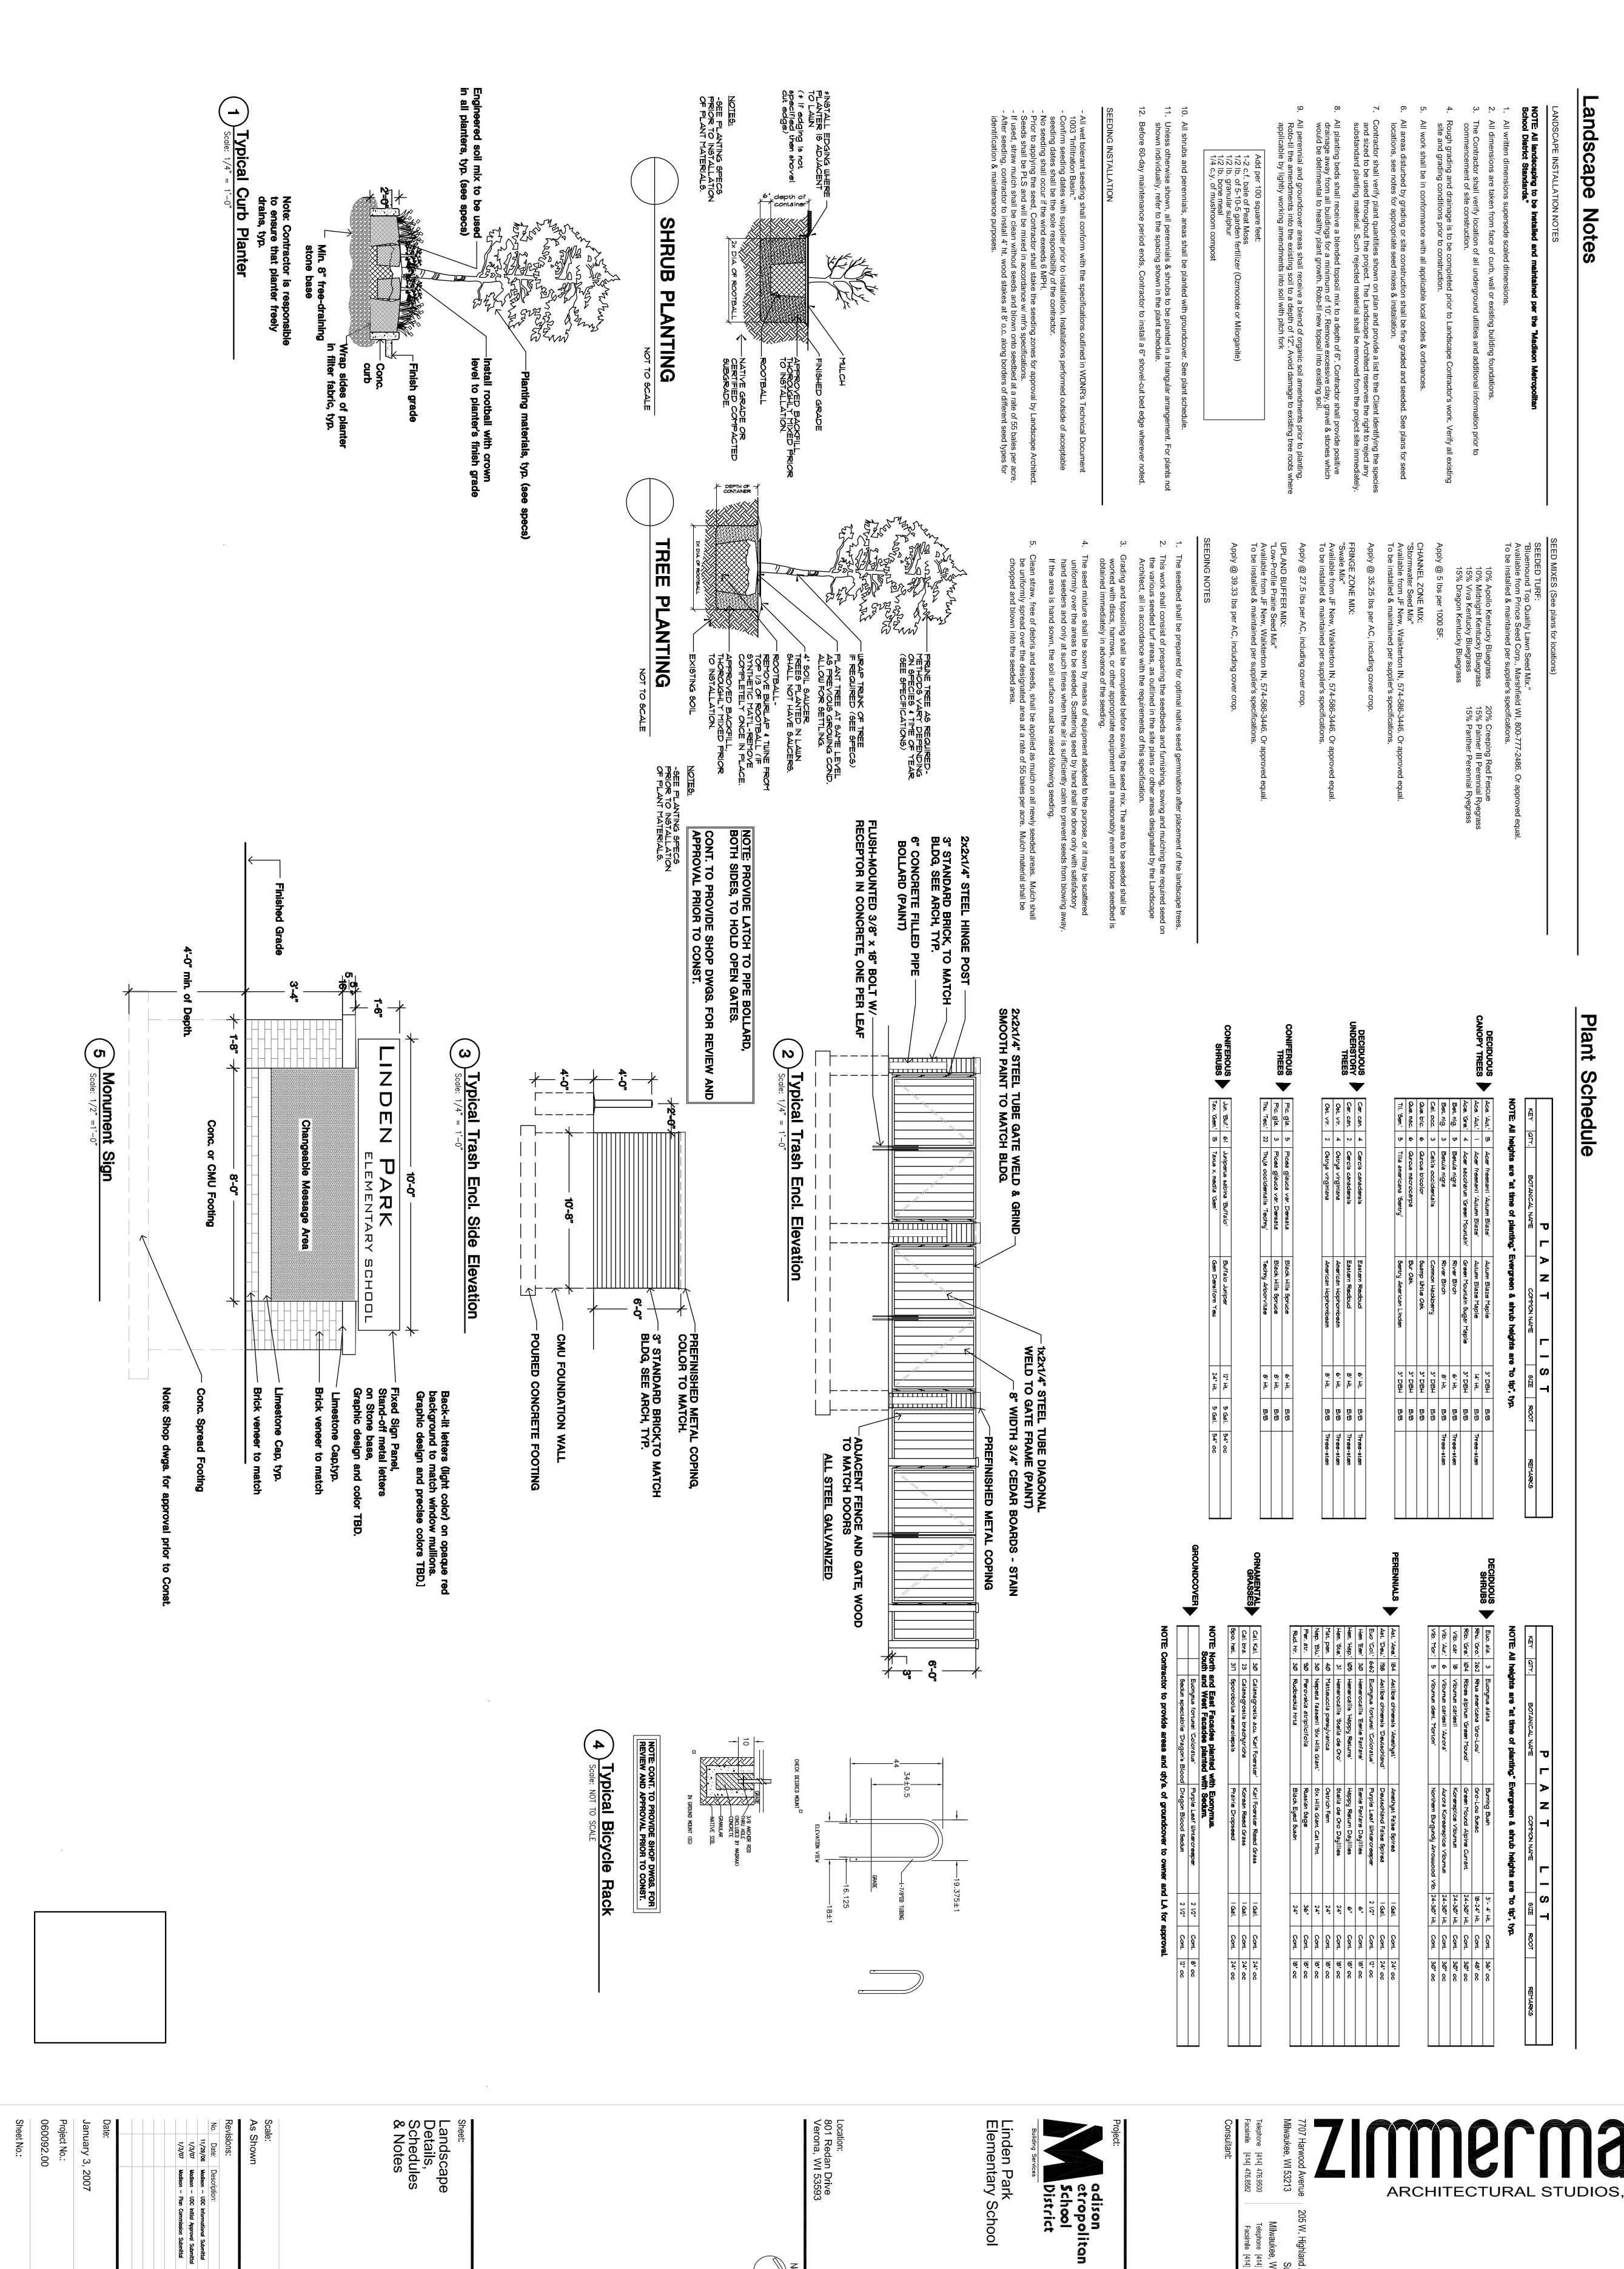

North

ARCHITECTURAL STUDIOS, INC.

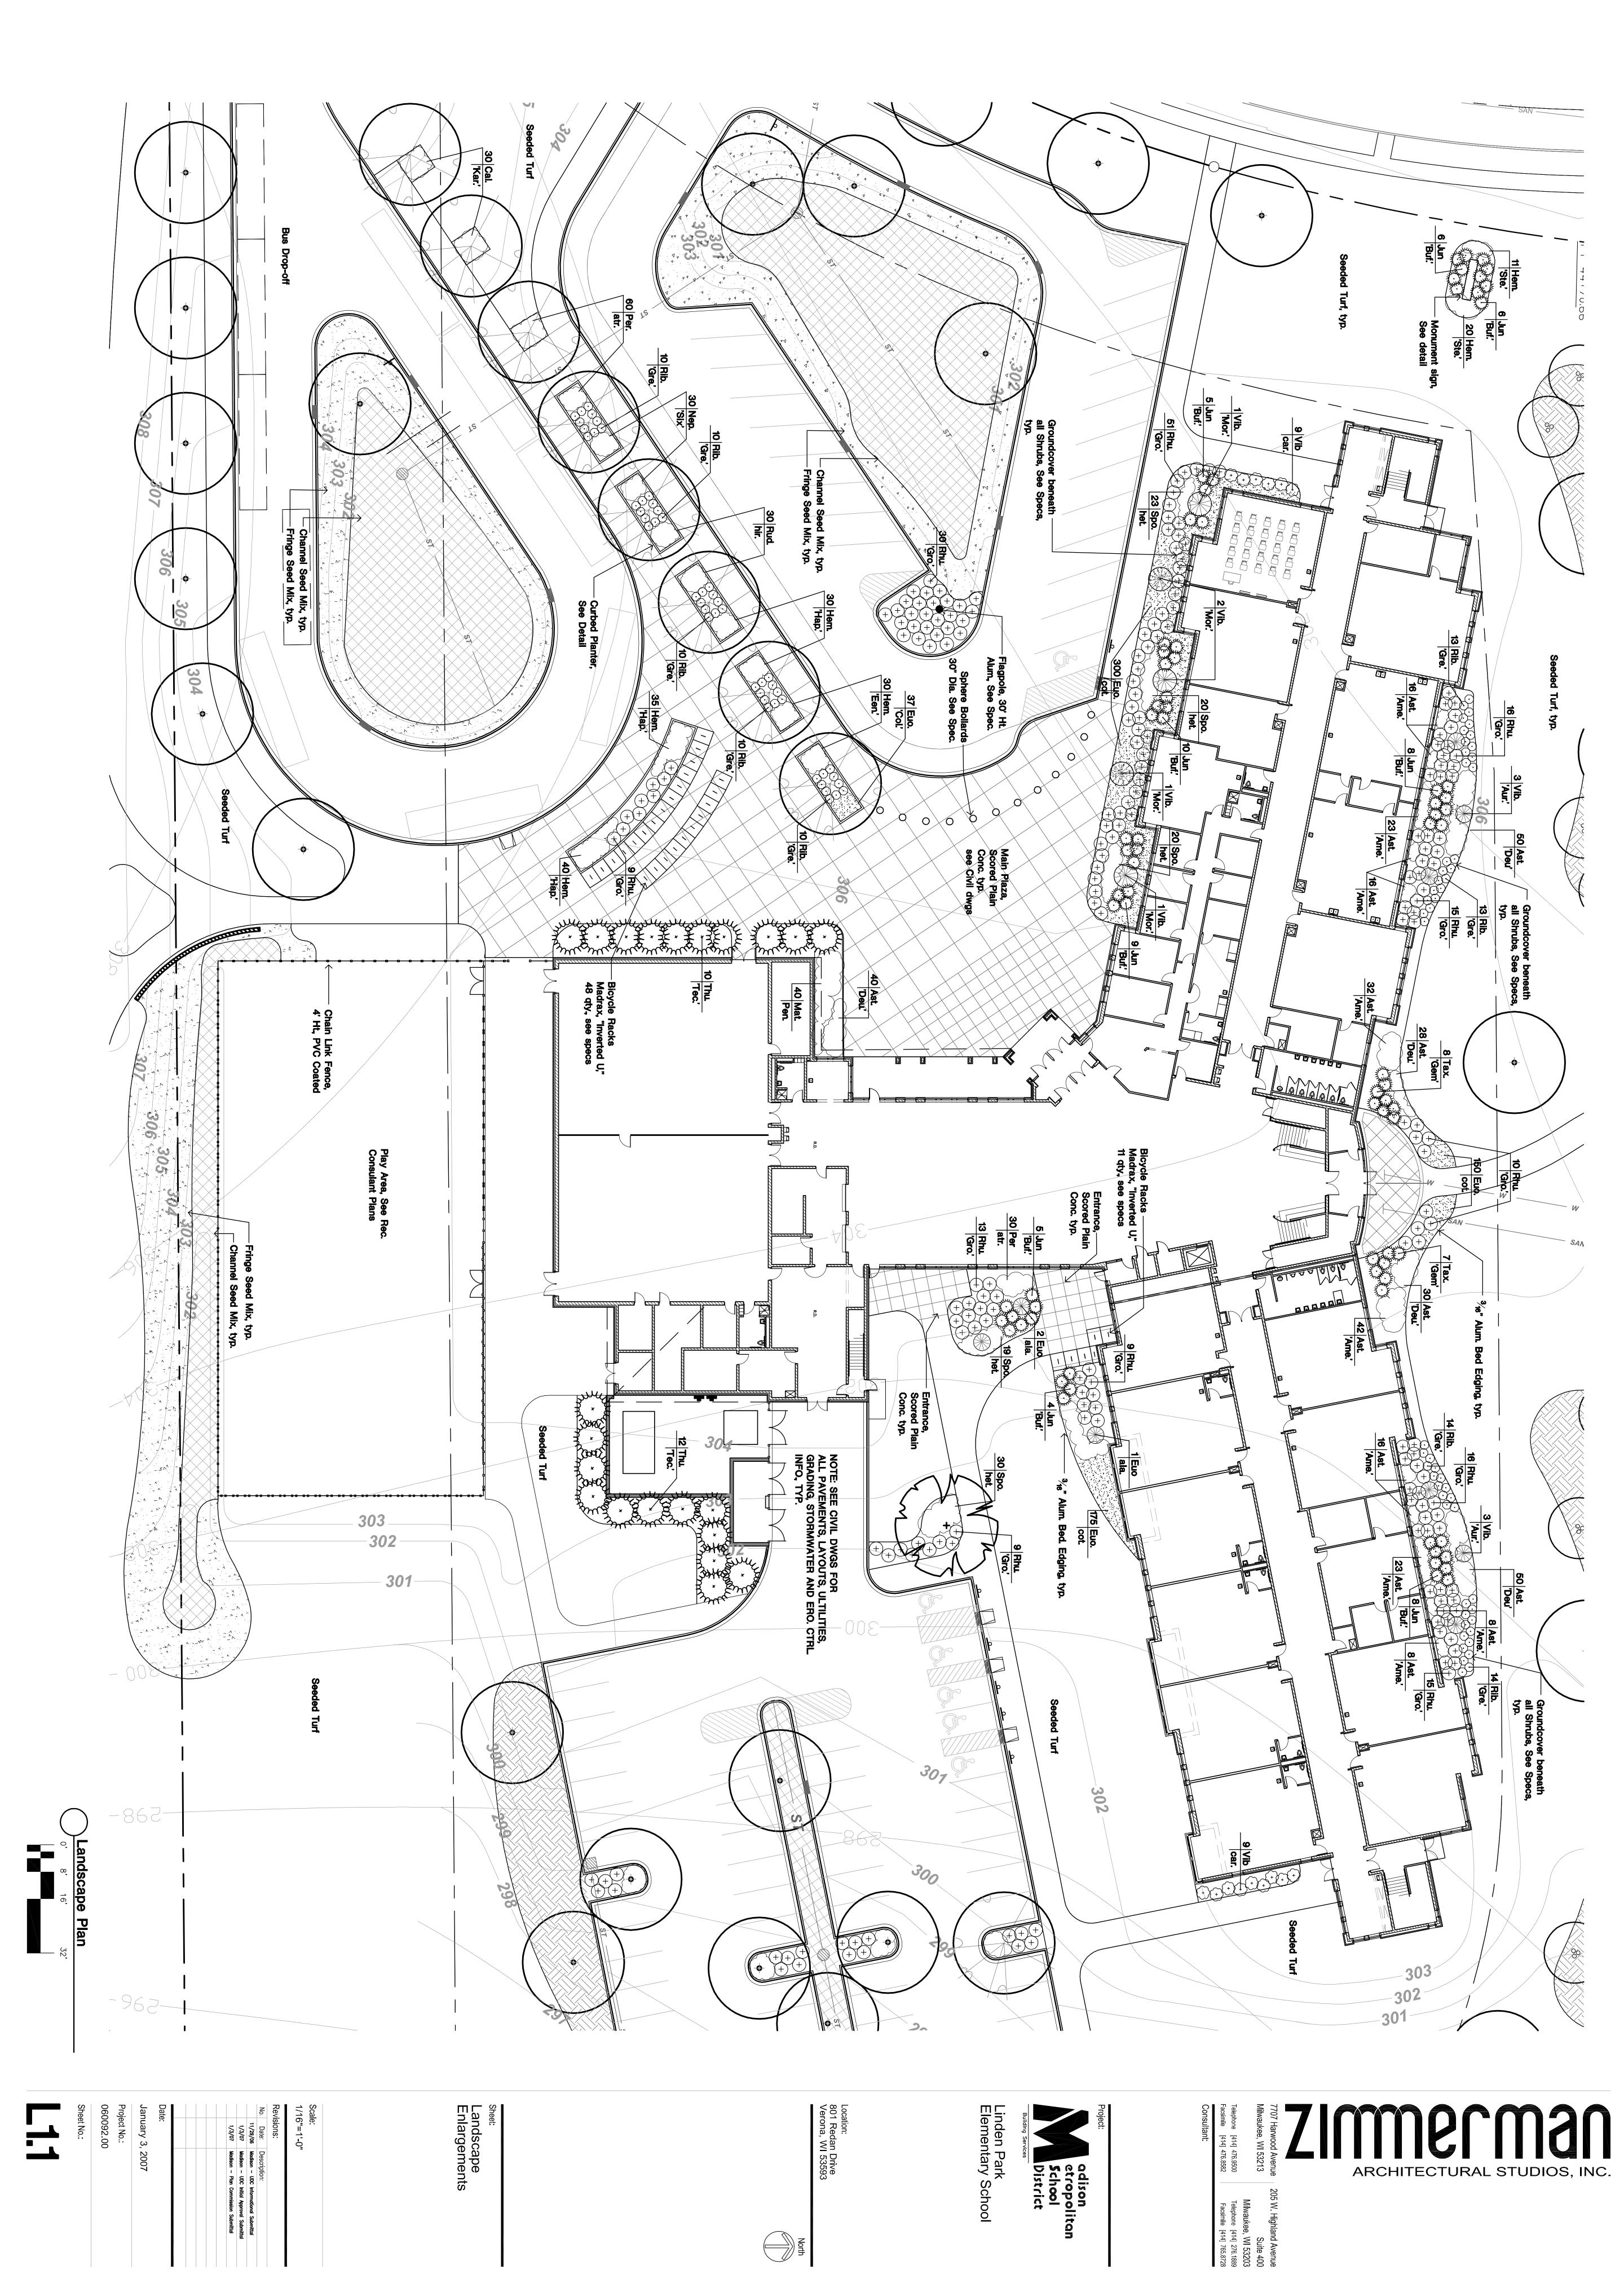

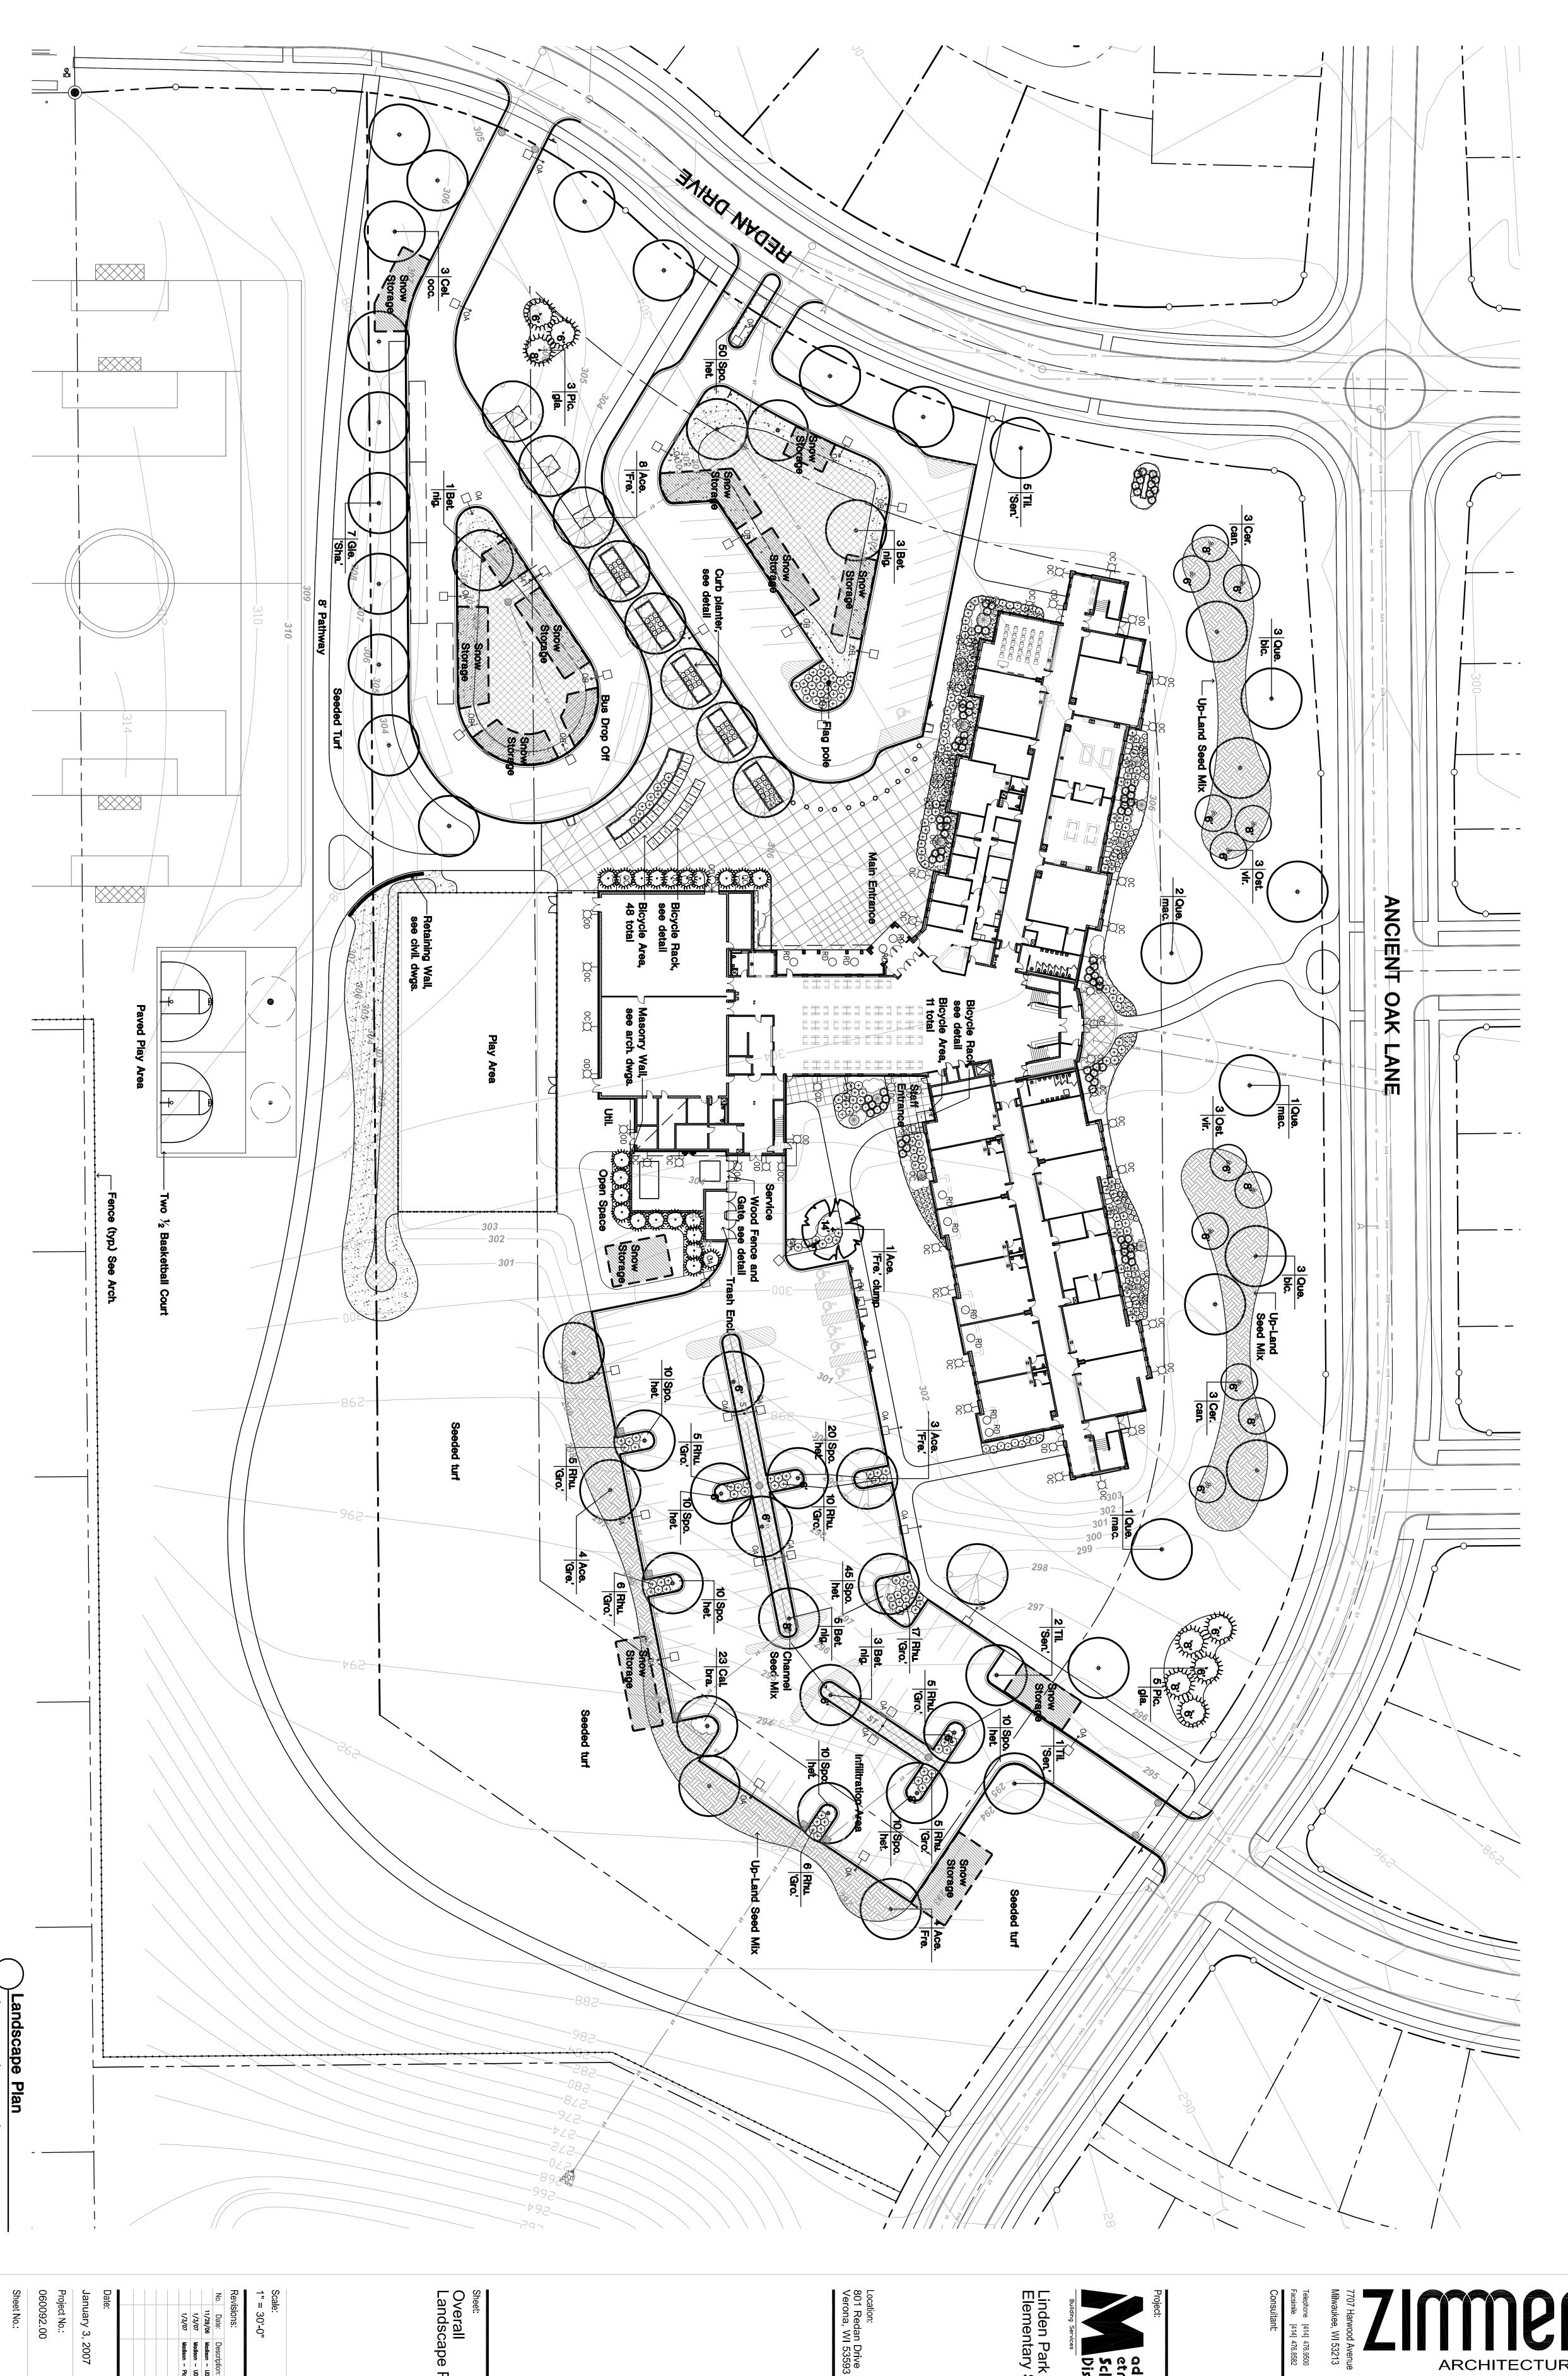

Scale:

1" = 30'-0"

Revisions:


No. Date: Description:


11/29/06 Madison - UDC Informational Submittal

1/3/07 Madison - UDC Infiel Approval Submittal

1/3/07 Madison - Plan Commission Submittal January 3, 2007
Project No.:
060092.00
Sheet No.:



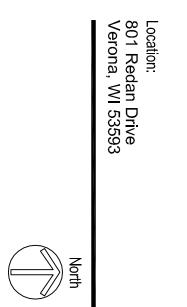

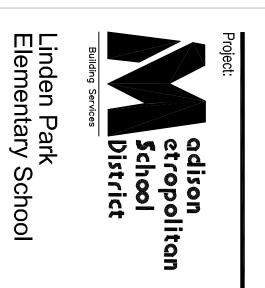





# APPLICATION FOR URBAN DESIGN COMMISSION REVIEW AND APPROVAL


AGENDA	ITEM#	
Project#		


DATE SUBMITTED: 1/3/07  UDC MEETING DATE: 1/10/07	Action Requested Informational Presentation Initial Approval and/or Recommendation Final Approval and/or Recommendation
PROJECT ADDRESS: 801 REDAN ALDERMANIC DISTRICT:	
OWNER/DEVELOPER (Partners and/or Principals) Madison Motro School District 545 W. Dayton St. Madison Wi 53703	ARCHITECT/DESIGNER/OR AGENT: DIVA BARNES, ALA ZIMMEYMAN Architectural Studios
CONTACT PERSON: DOUG BARNES  Address: 7707 HARWOOD  Phone: 44.918.1961  Fax: 414.476.8582  E-mail address: 4016. 500.00	ALE. VI 53213
TYPE OF PROJECT:  (See Section A for:)  Planned Unit Development (PUD)  General Development Plan (GDP)  Specific Implementation Plan (SIP)  Planned Community Development (PCD)  General Development Plan (GDP)  Specific Implementation Plan (SIP)  Planned Residential Development (PRD)  New Construction or Exterior Remodeling in an well as a fee)  School, Public Building or Space (Fee may be respectively)	a Urban Design District * (A public hearing is required as required) LINDEN PARK ELEMENTARY SURg of a Retail, Hotel or Motel Building Exceeding 40,000
(See Section B for:)  New Construction or Exterior Remodeling in C	4 District (Fee required)
(See Section C for:)  R.P.S.M. Parking Variance (Fee required)	
(See Section D for:)  Comprehensive Design Review* (Fee required)  Street Graphics Variance* (Fee required)	
Other	
*Public Hearing Required (Submission Deadline 3 Wed	eks in Advance of Meeting Date)


Where fees are required (as noted above) they apply with the first submittal for either initial or final approval of a project.

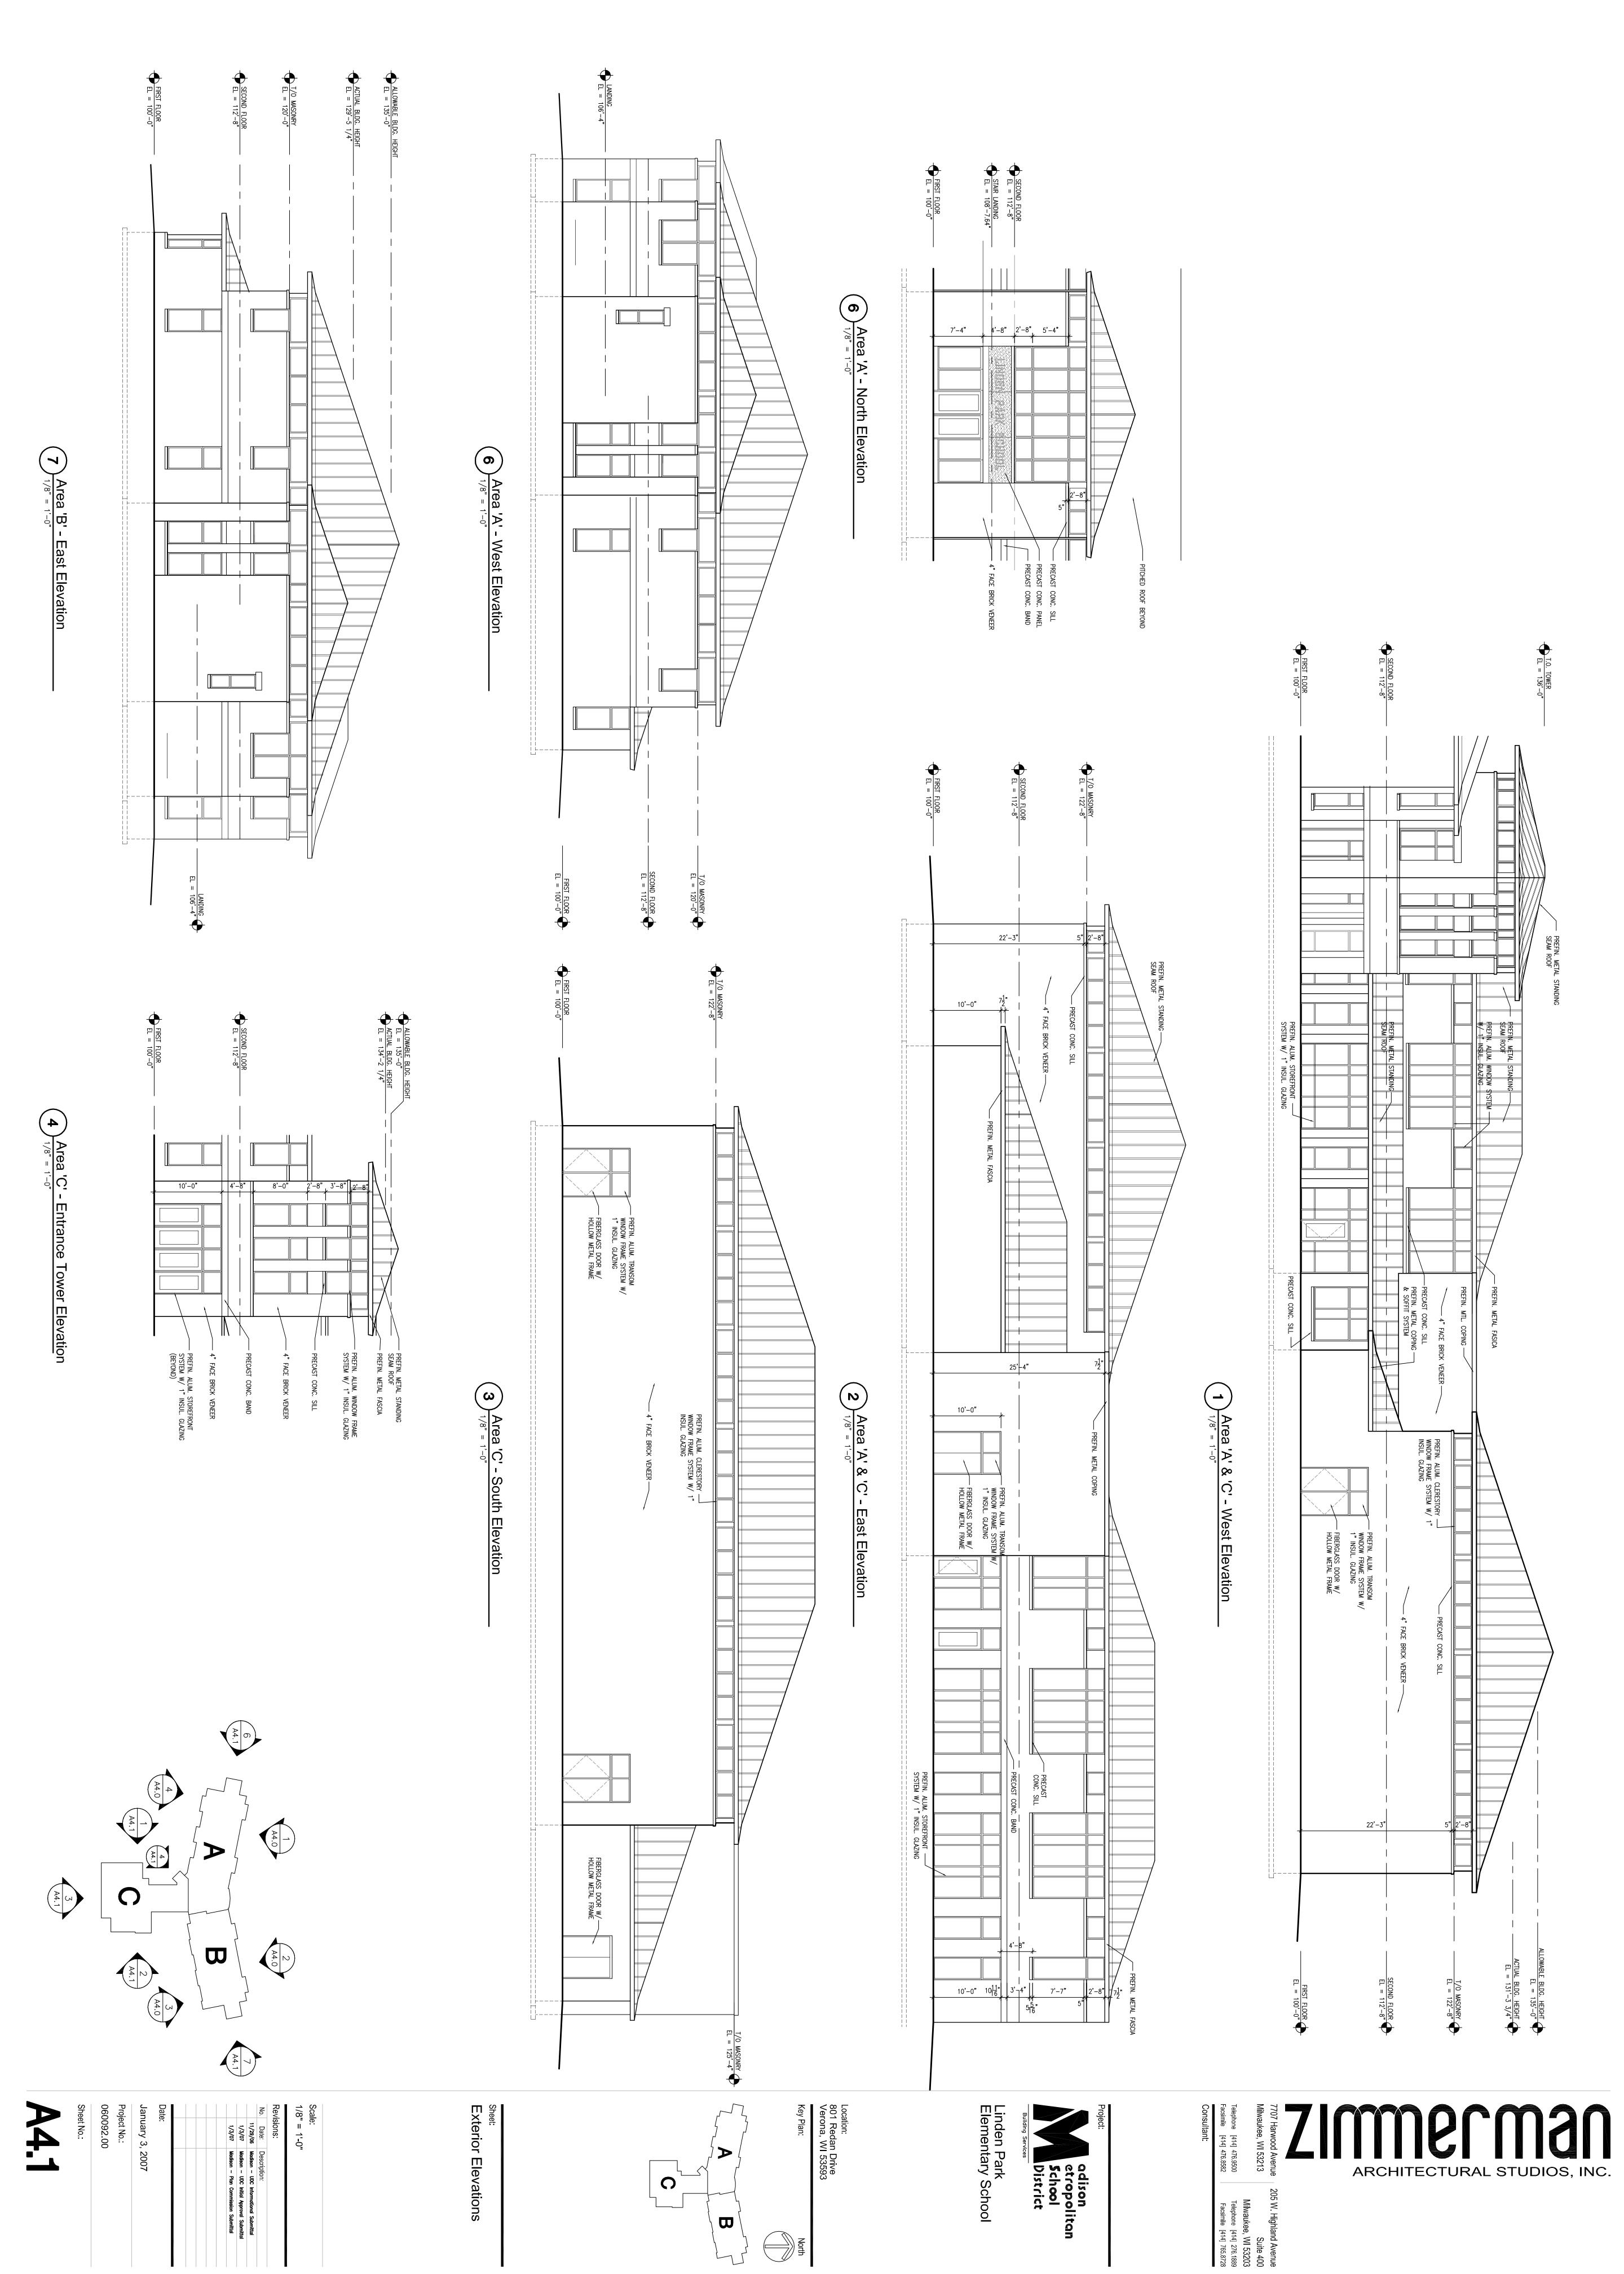

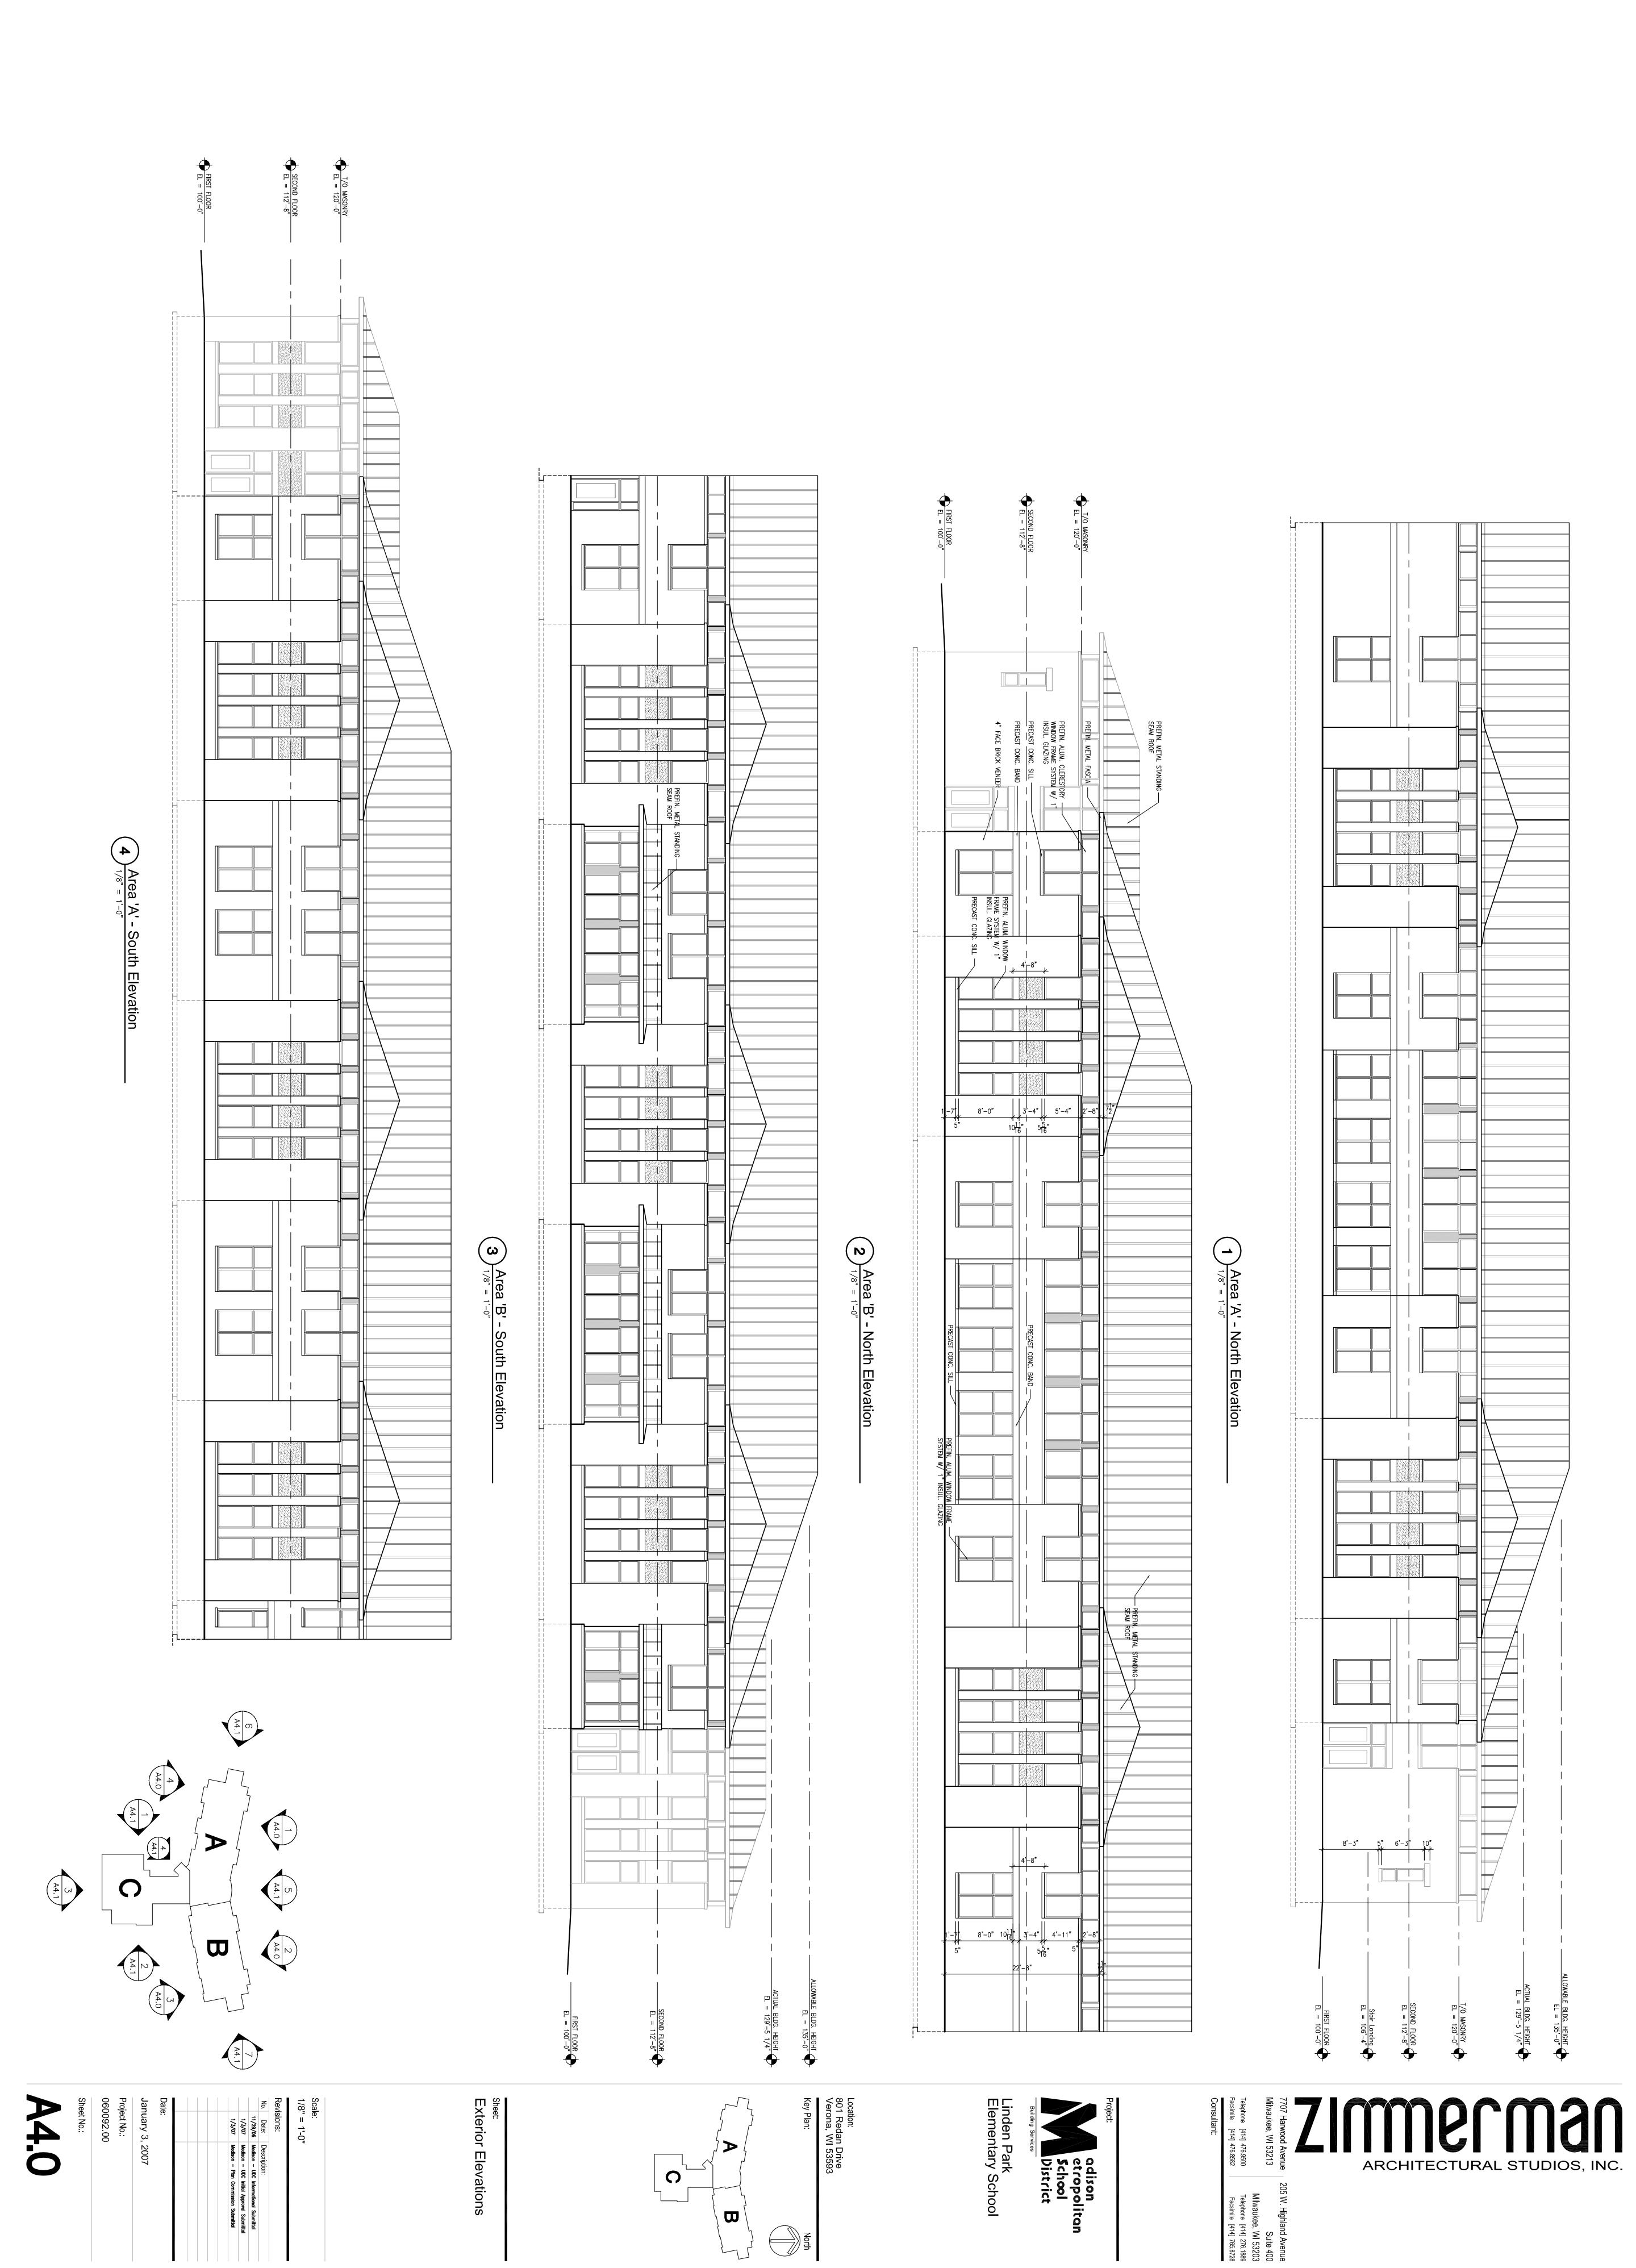

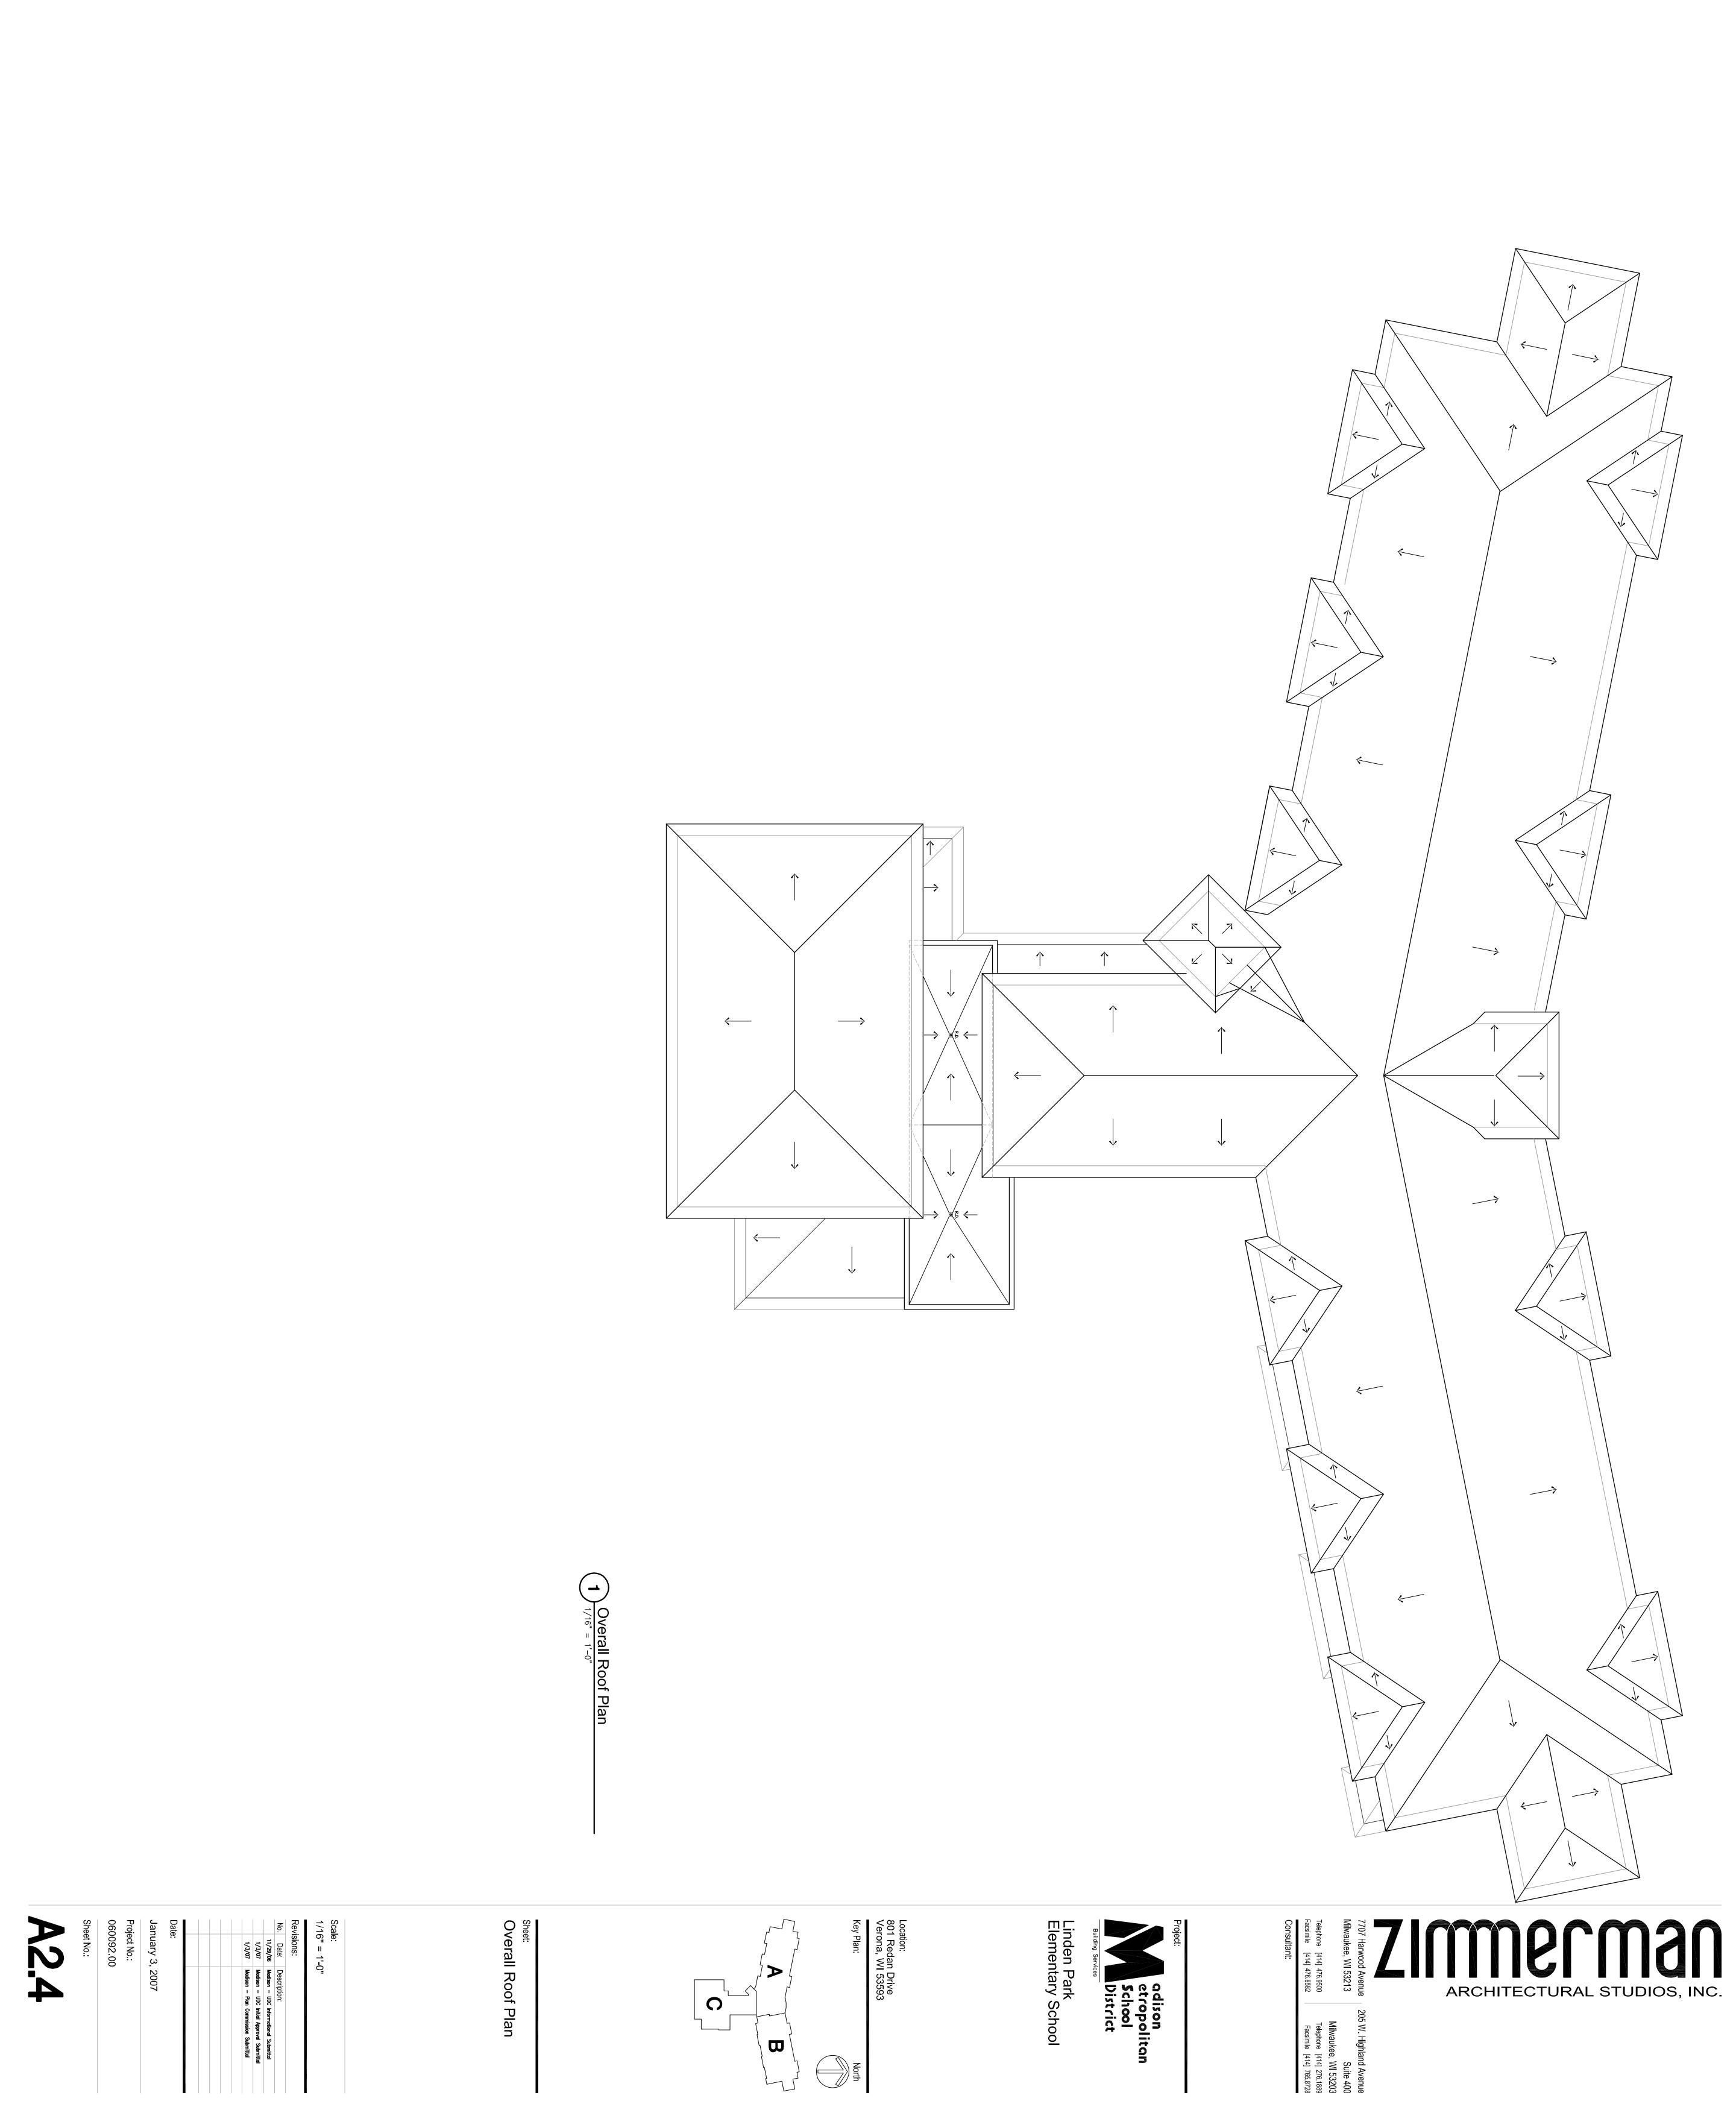

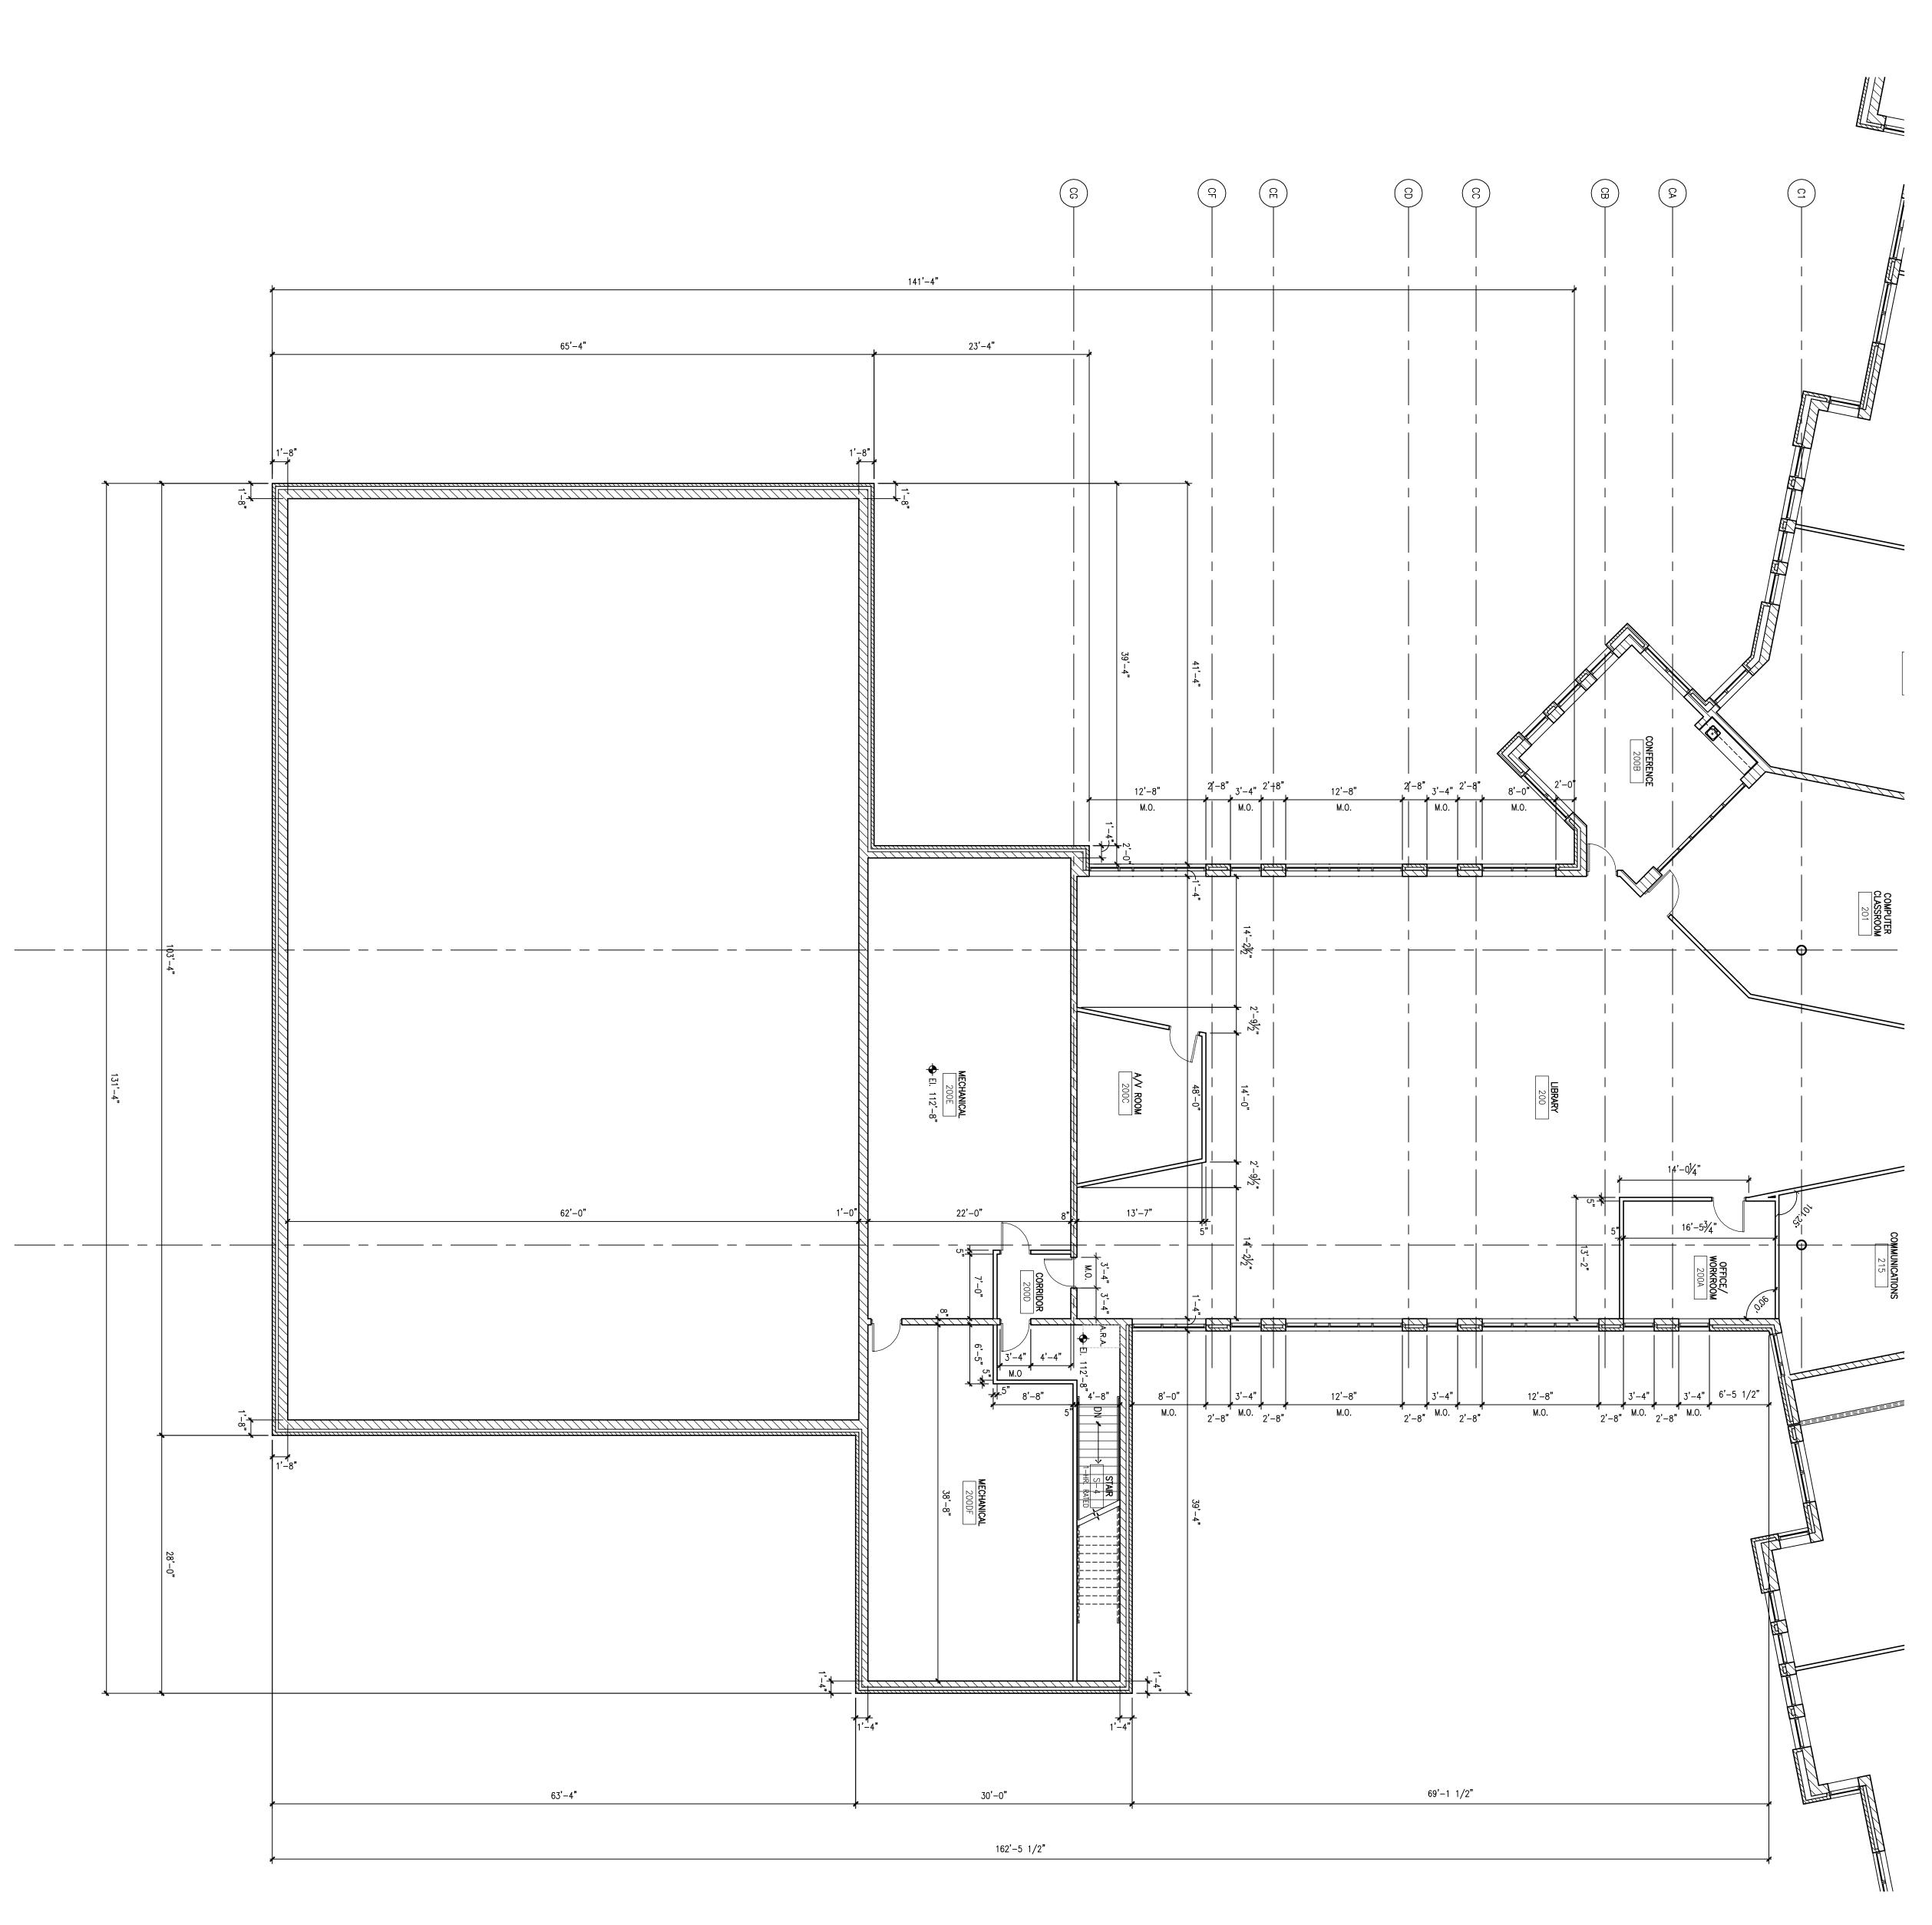

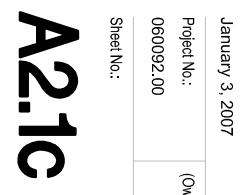

(Owner) Project No.:

Scale:

1/8" = 1'-0"

Revisions:

No. Date: Description:

11/29/06 Madison - UDC Informational Submittal


1/3/07 Madison - UDC Initial Approval Submittal


1/3/07 Madison - Plan Commission Submittal

Partial Second Floor Plan -




Partial Second Floor Plan-Area 'C'

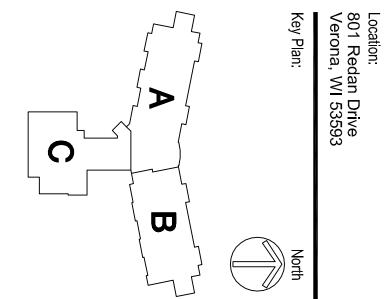

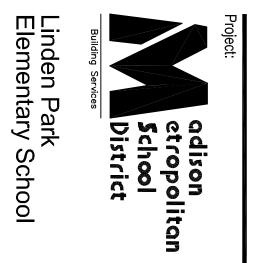


Telephone [414] 476.9500 Facsimile [414] 476.8582 Consultant:




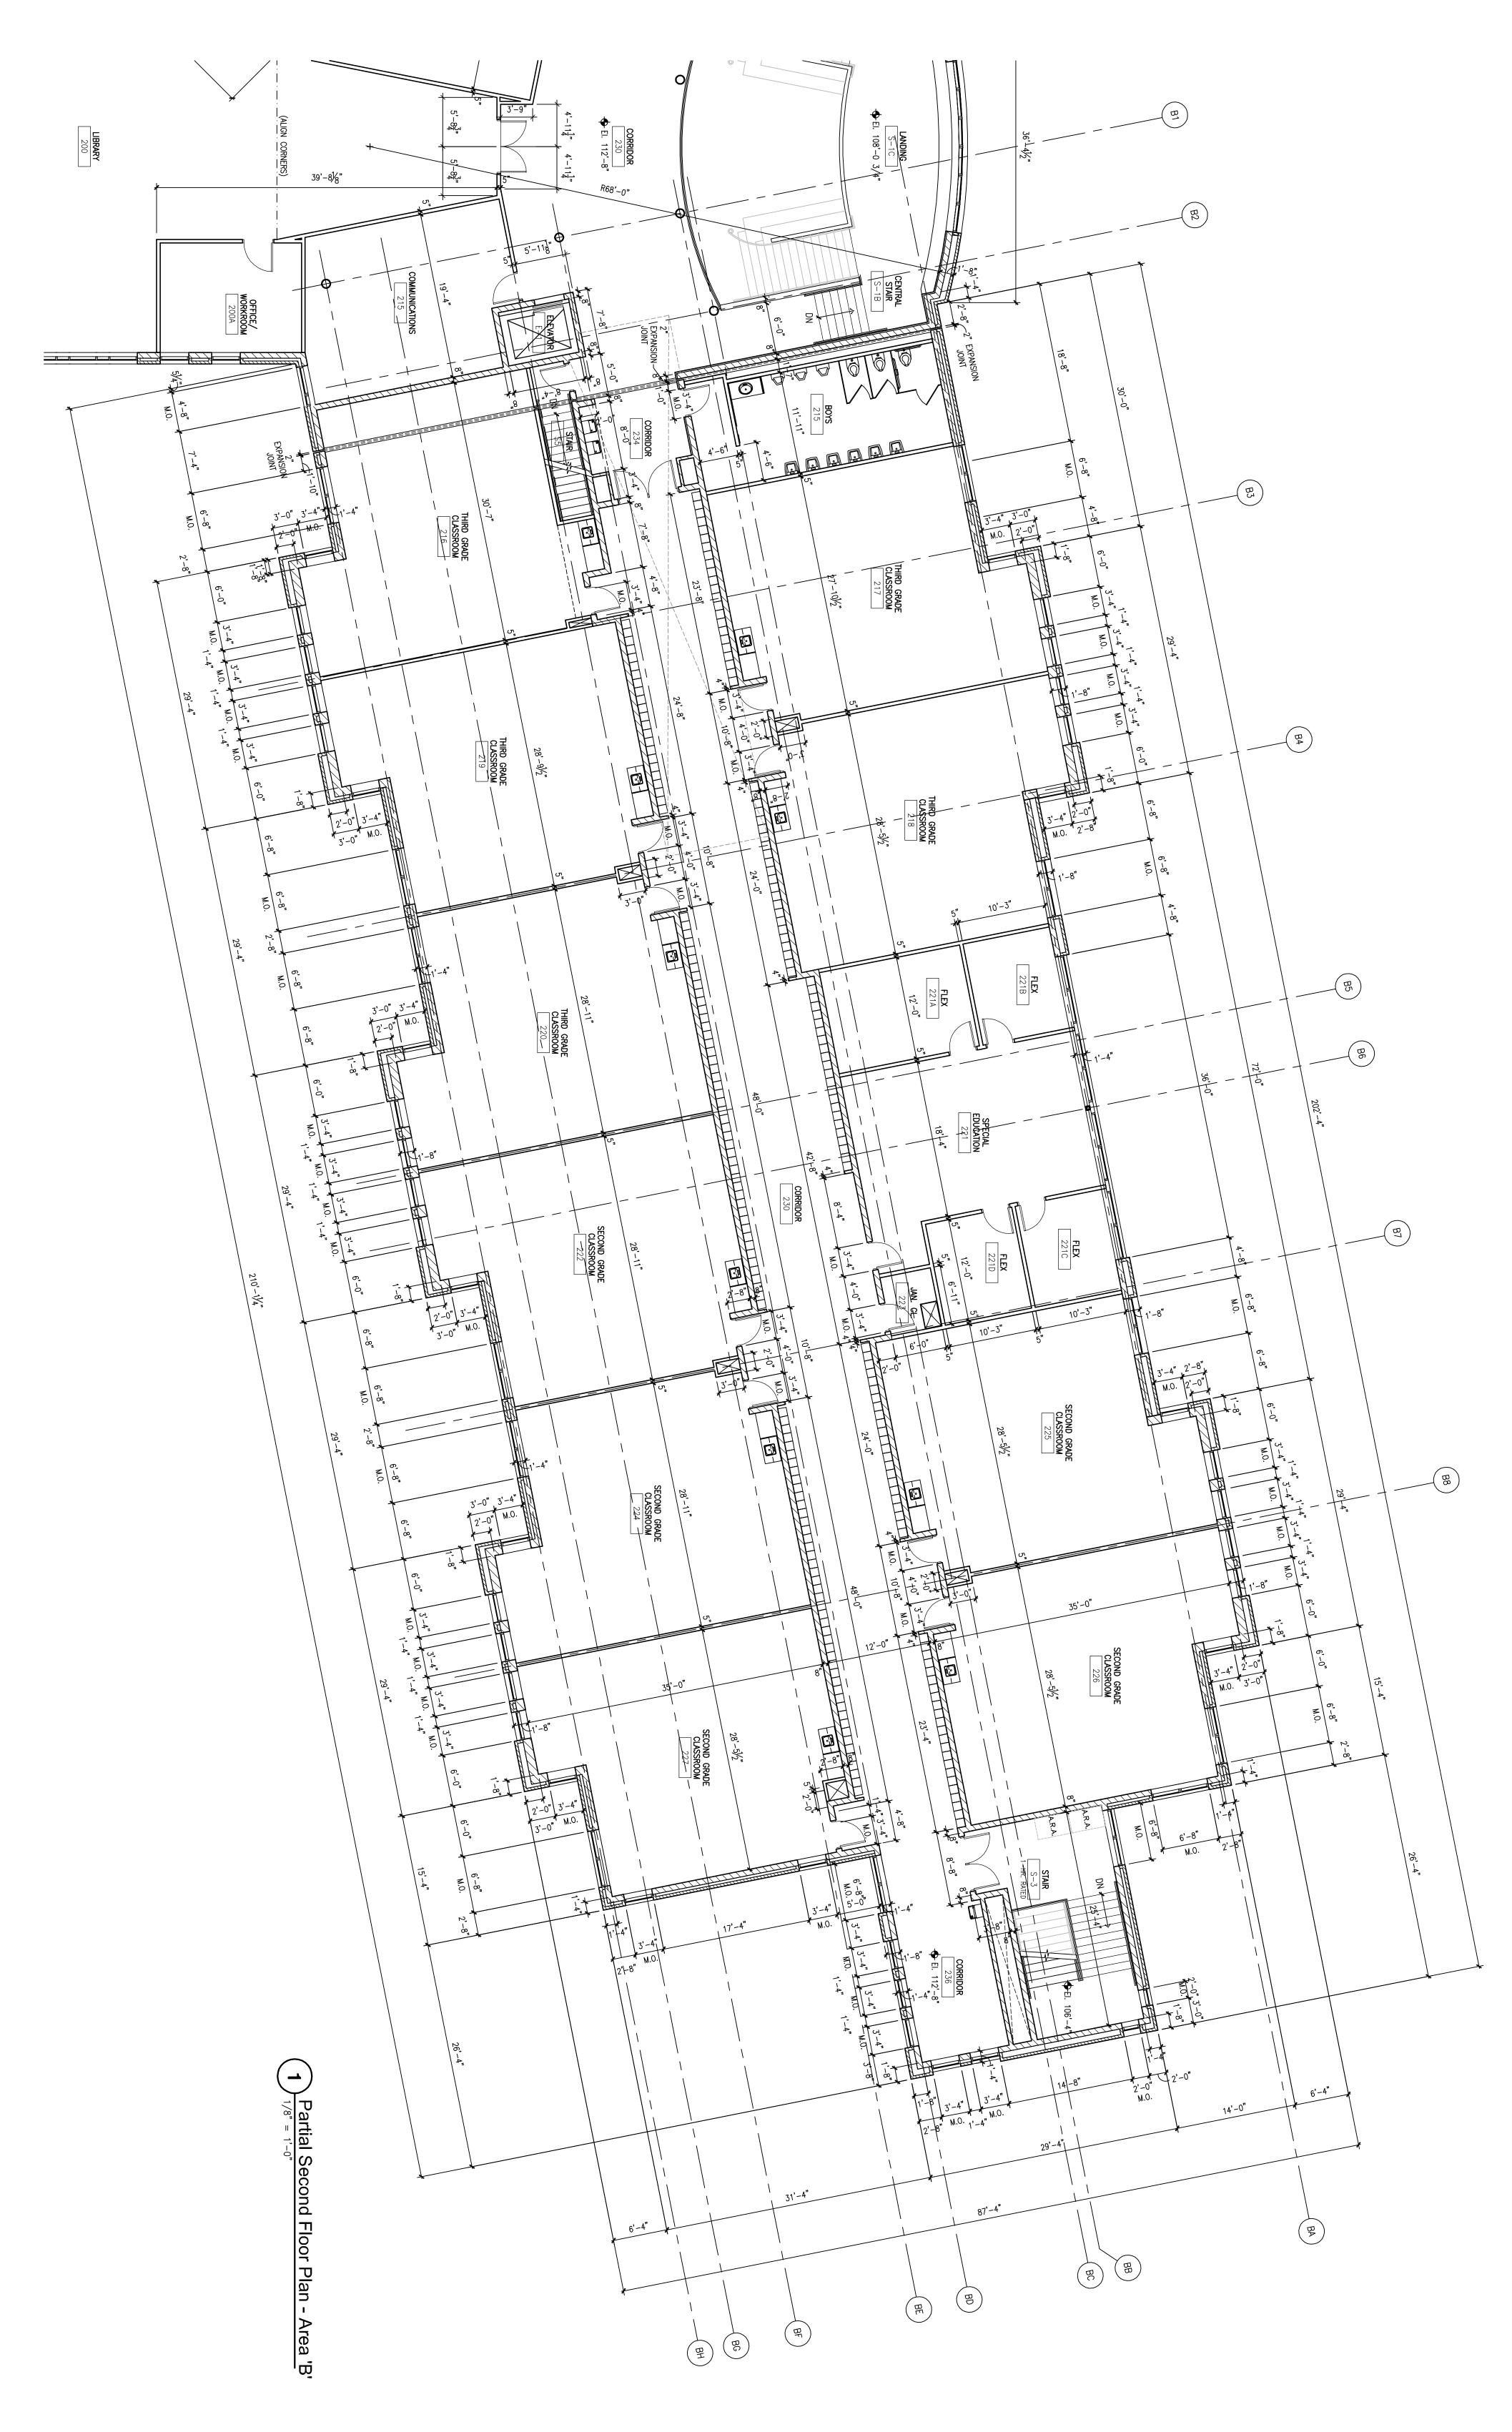


A2.1b	Sheet No.:	060092.00	Project No.:	January 3, 2007
			(Owner) Pro	

(Owner) Project No.:

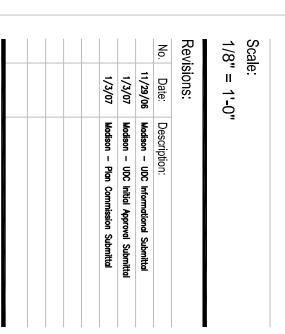


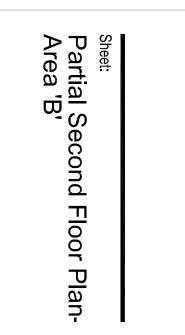

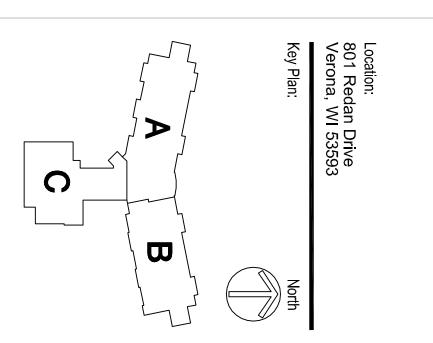





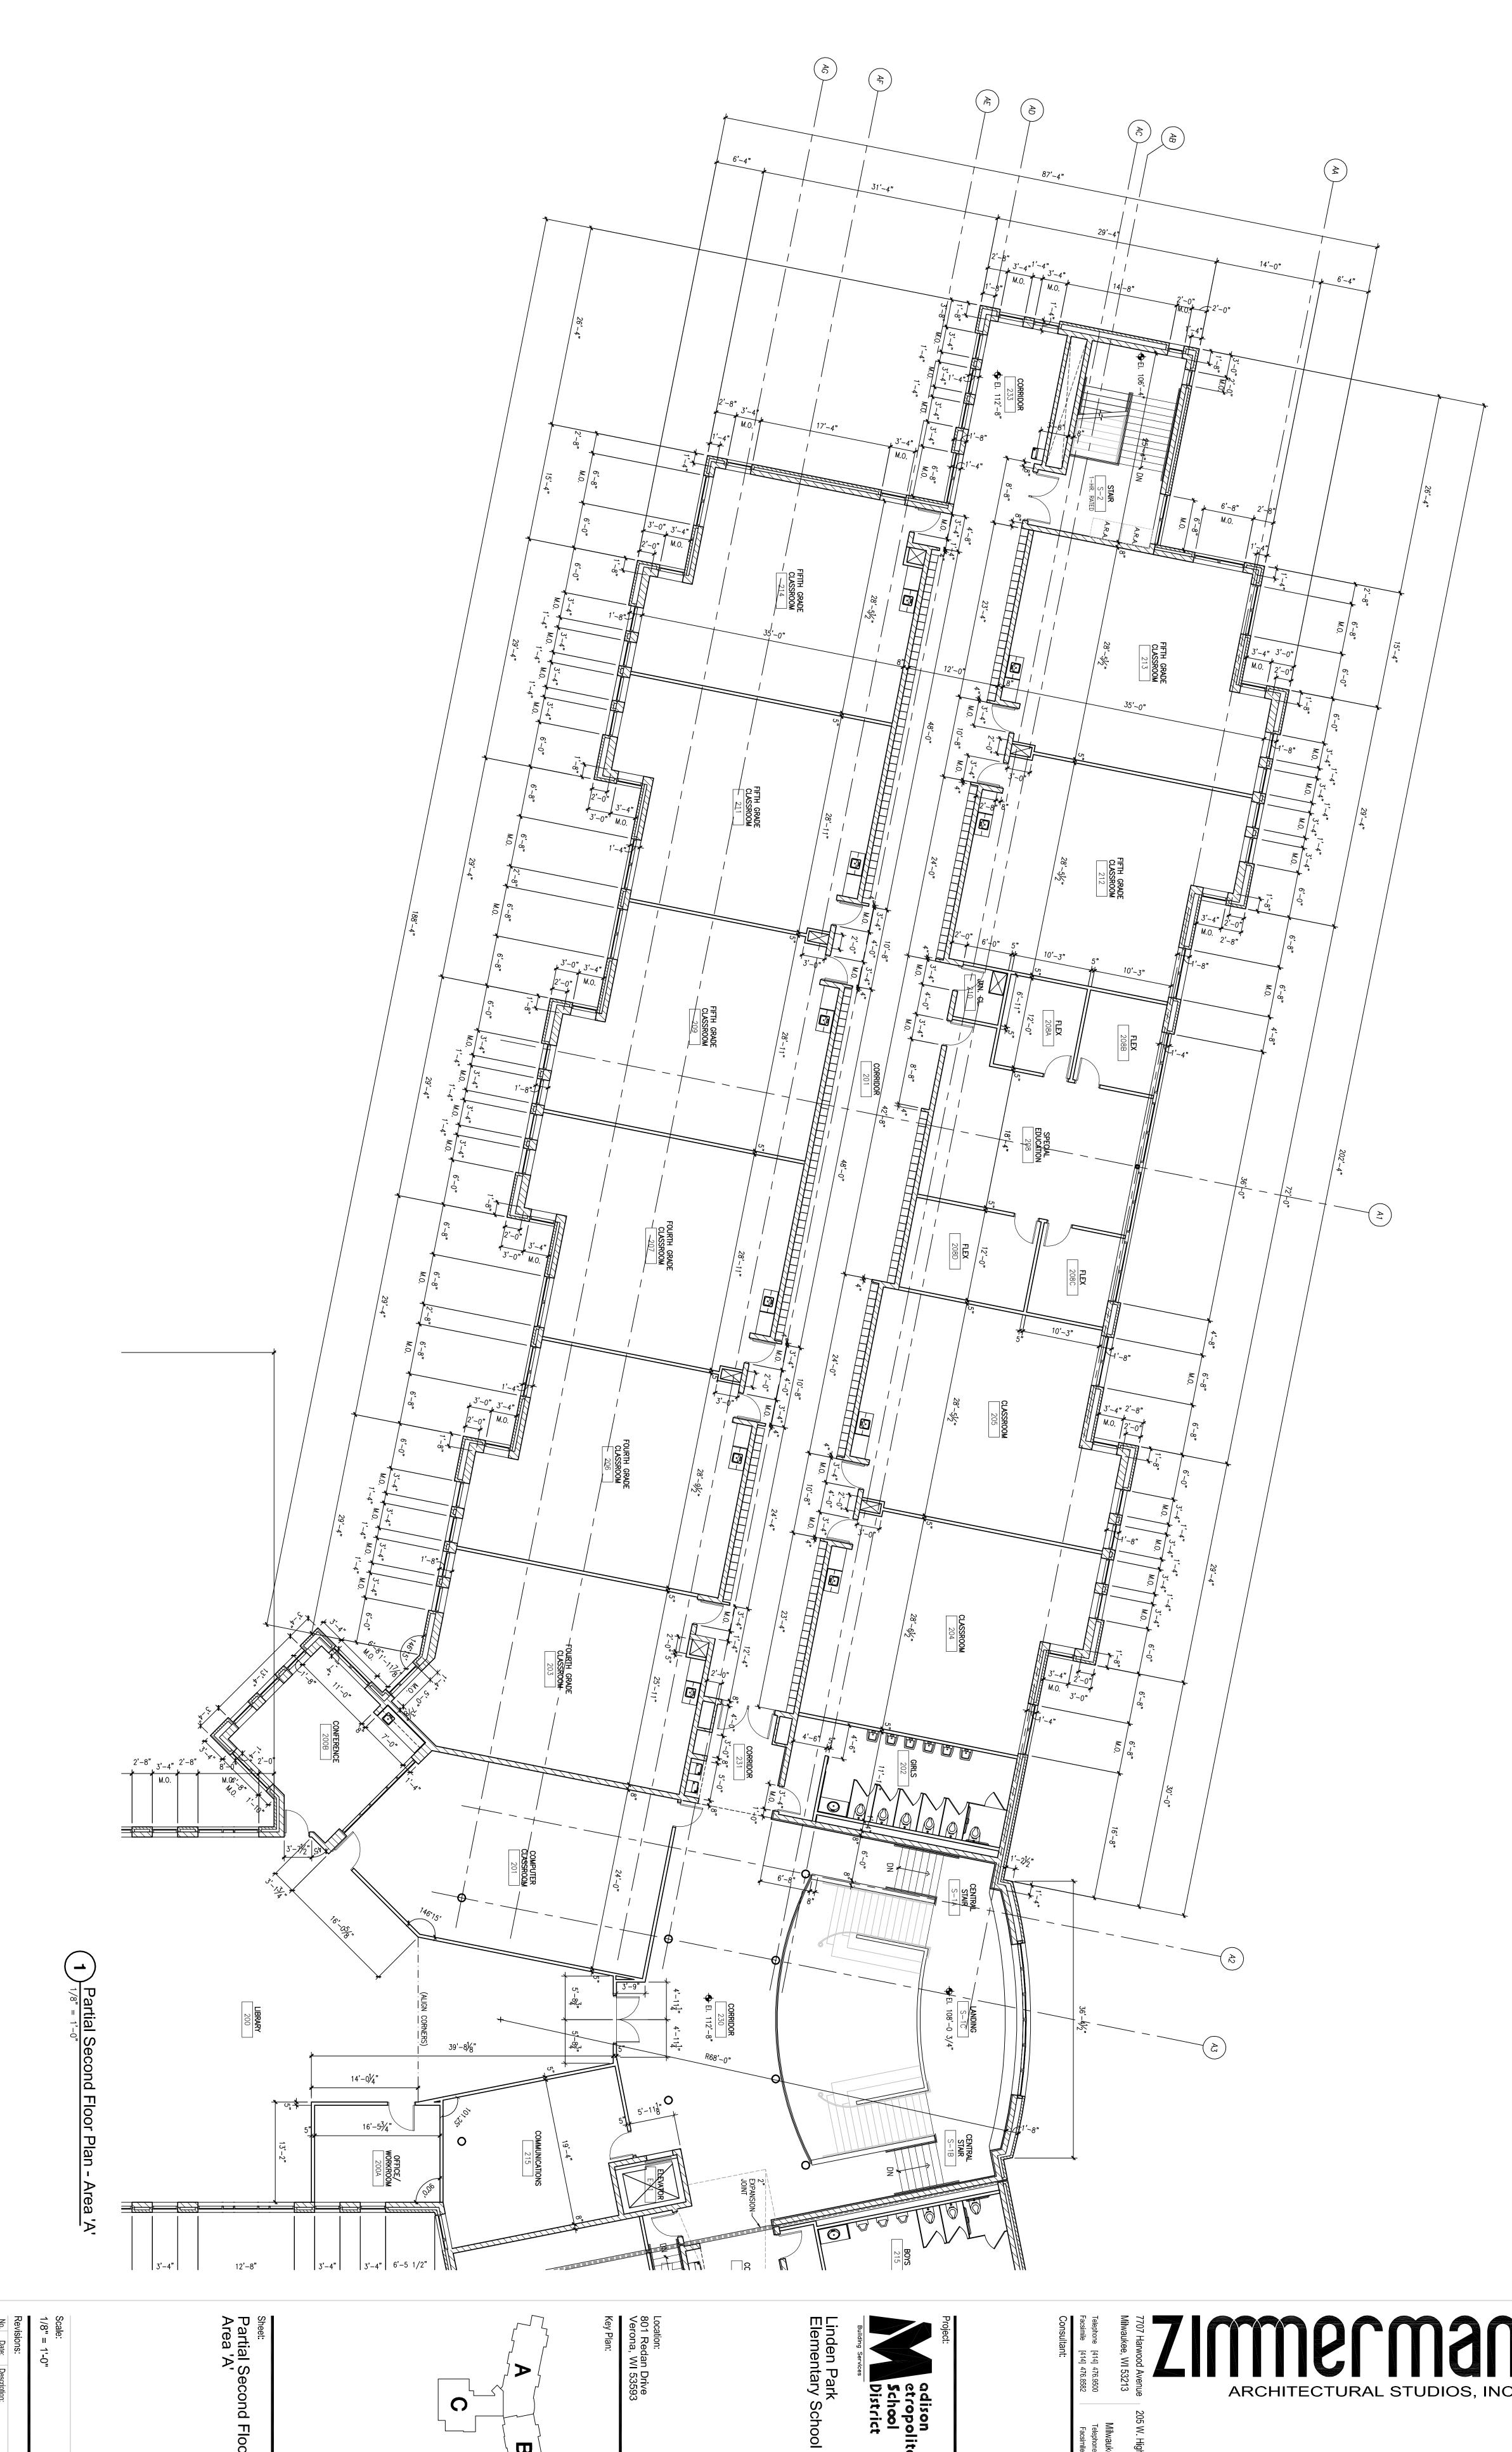

Revisions:


No. Date: Description:


11/29/06 Madison – UDC Informational Submittal

1/3/07 Madison – UDC Initial Approval Submittal


1/3/07 Madison – Plan Commission Submittal Project No.: 060092.00 January 3, 2007




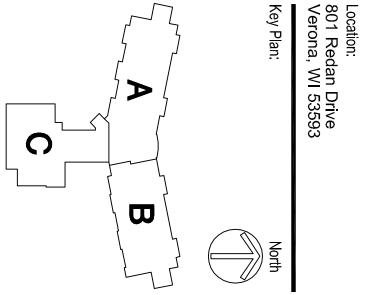


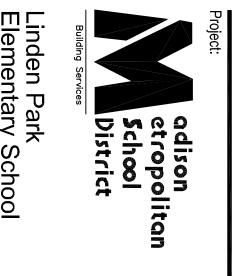




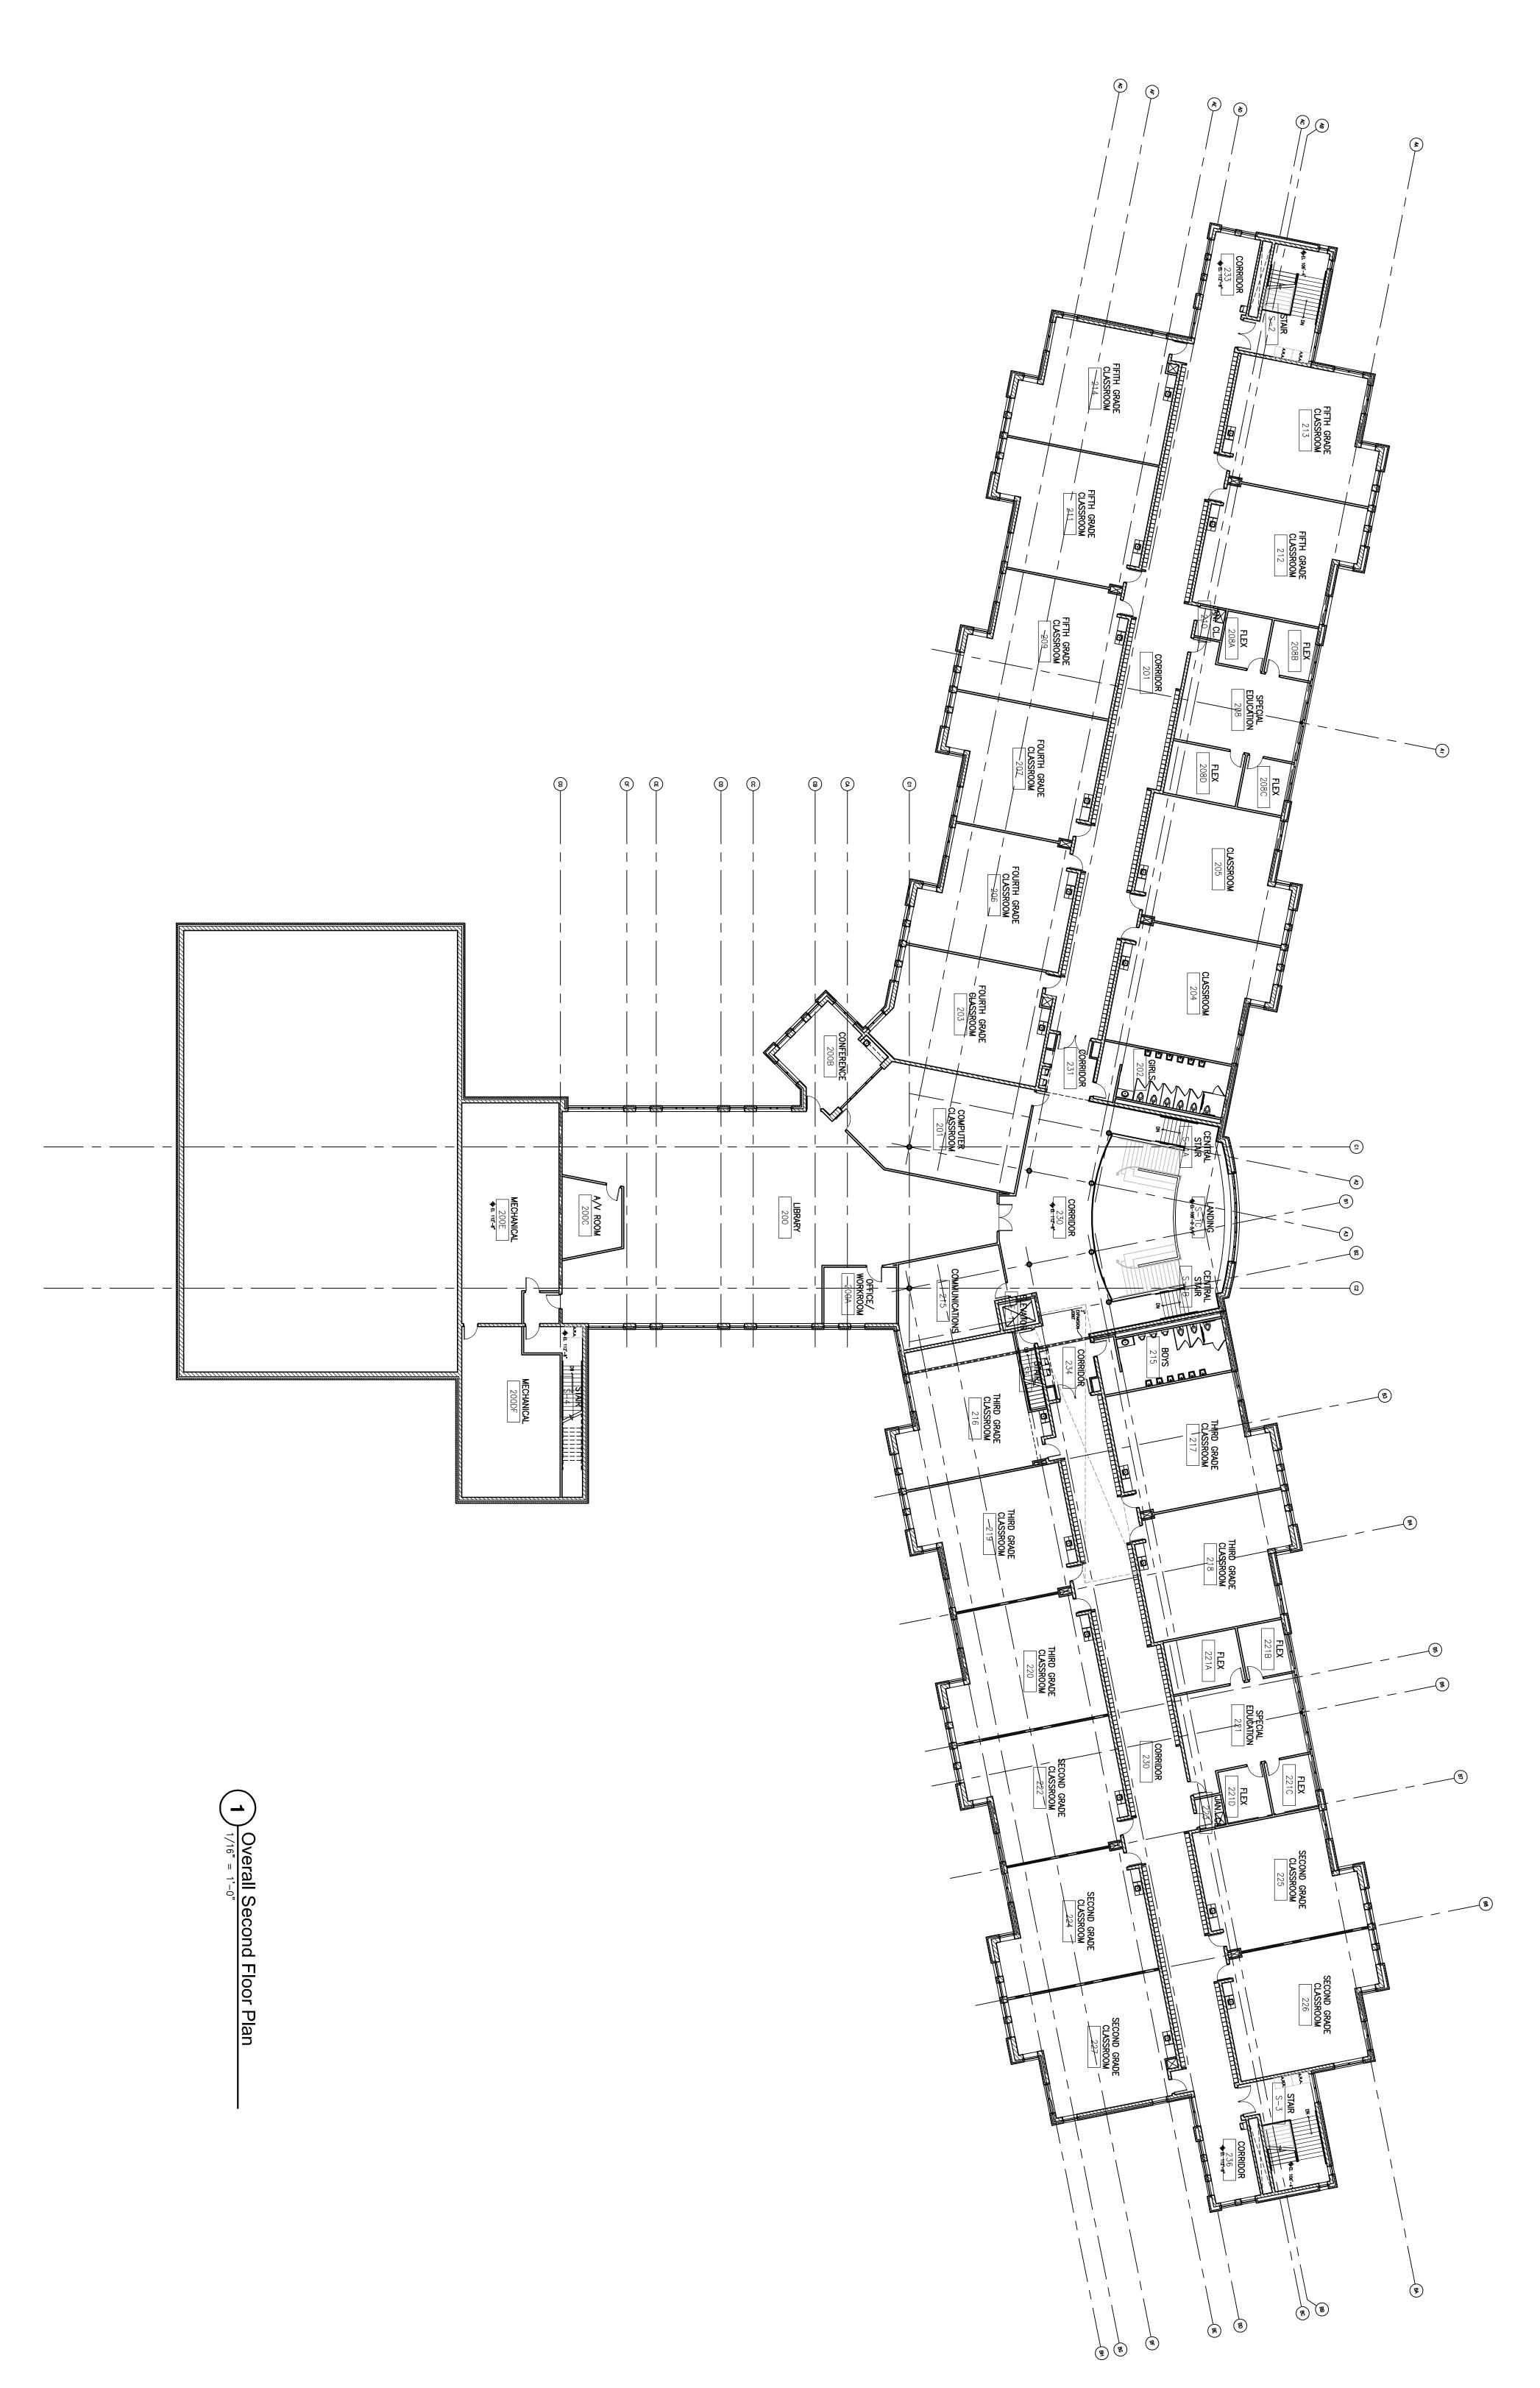


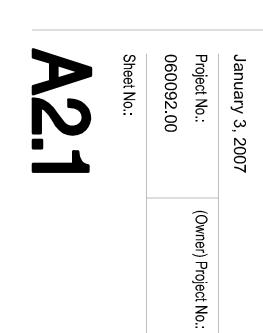

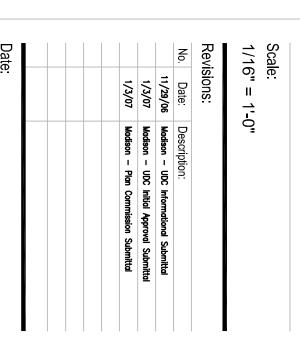




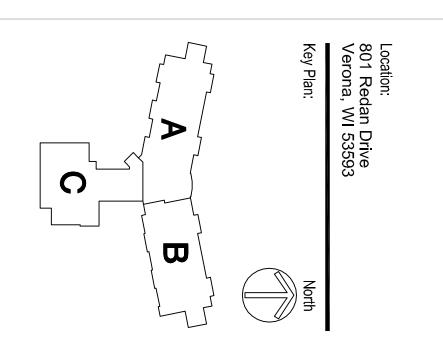

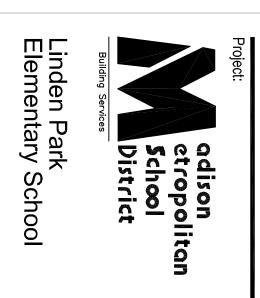



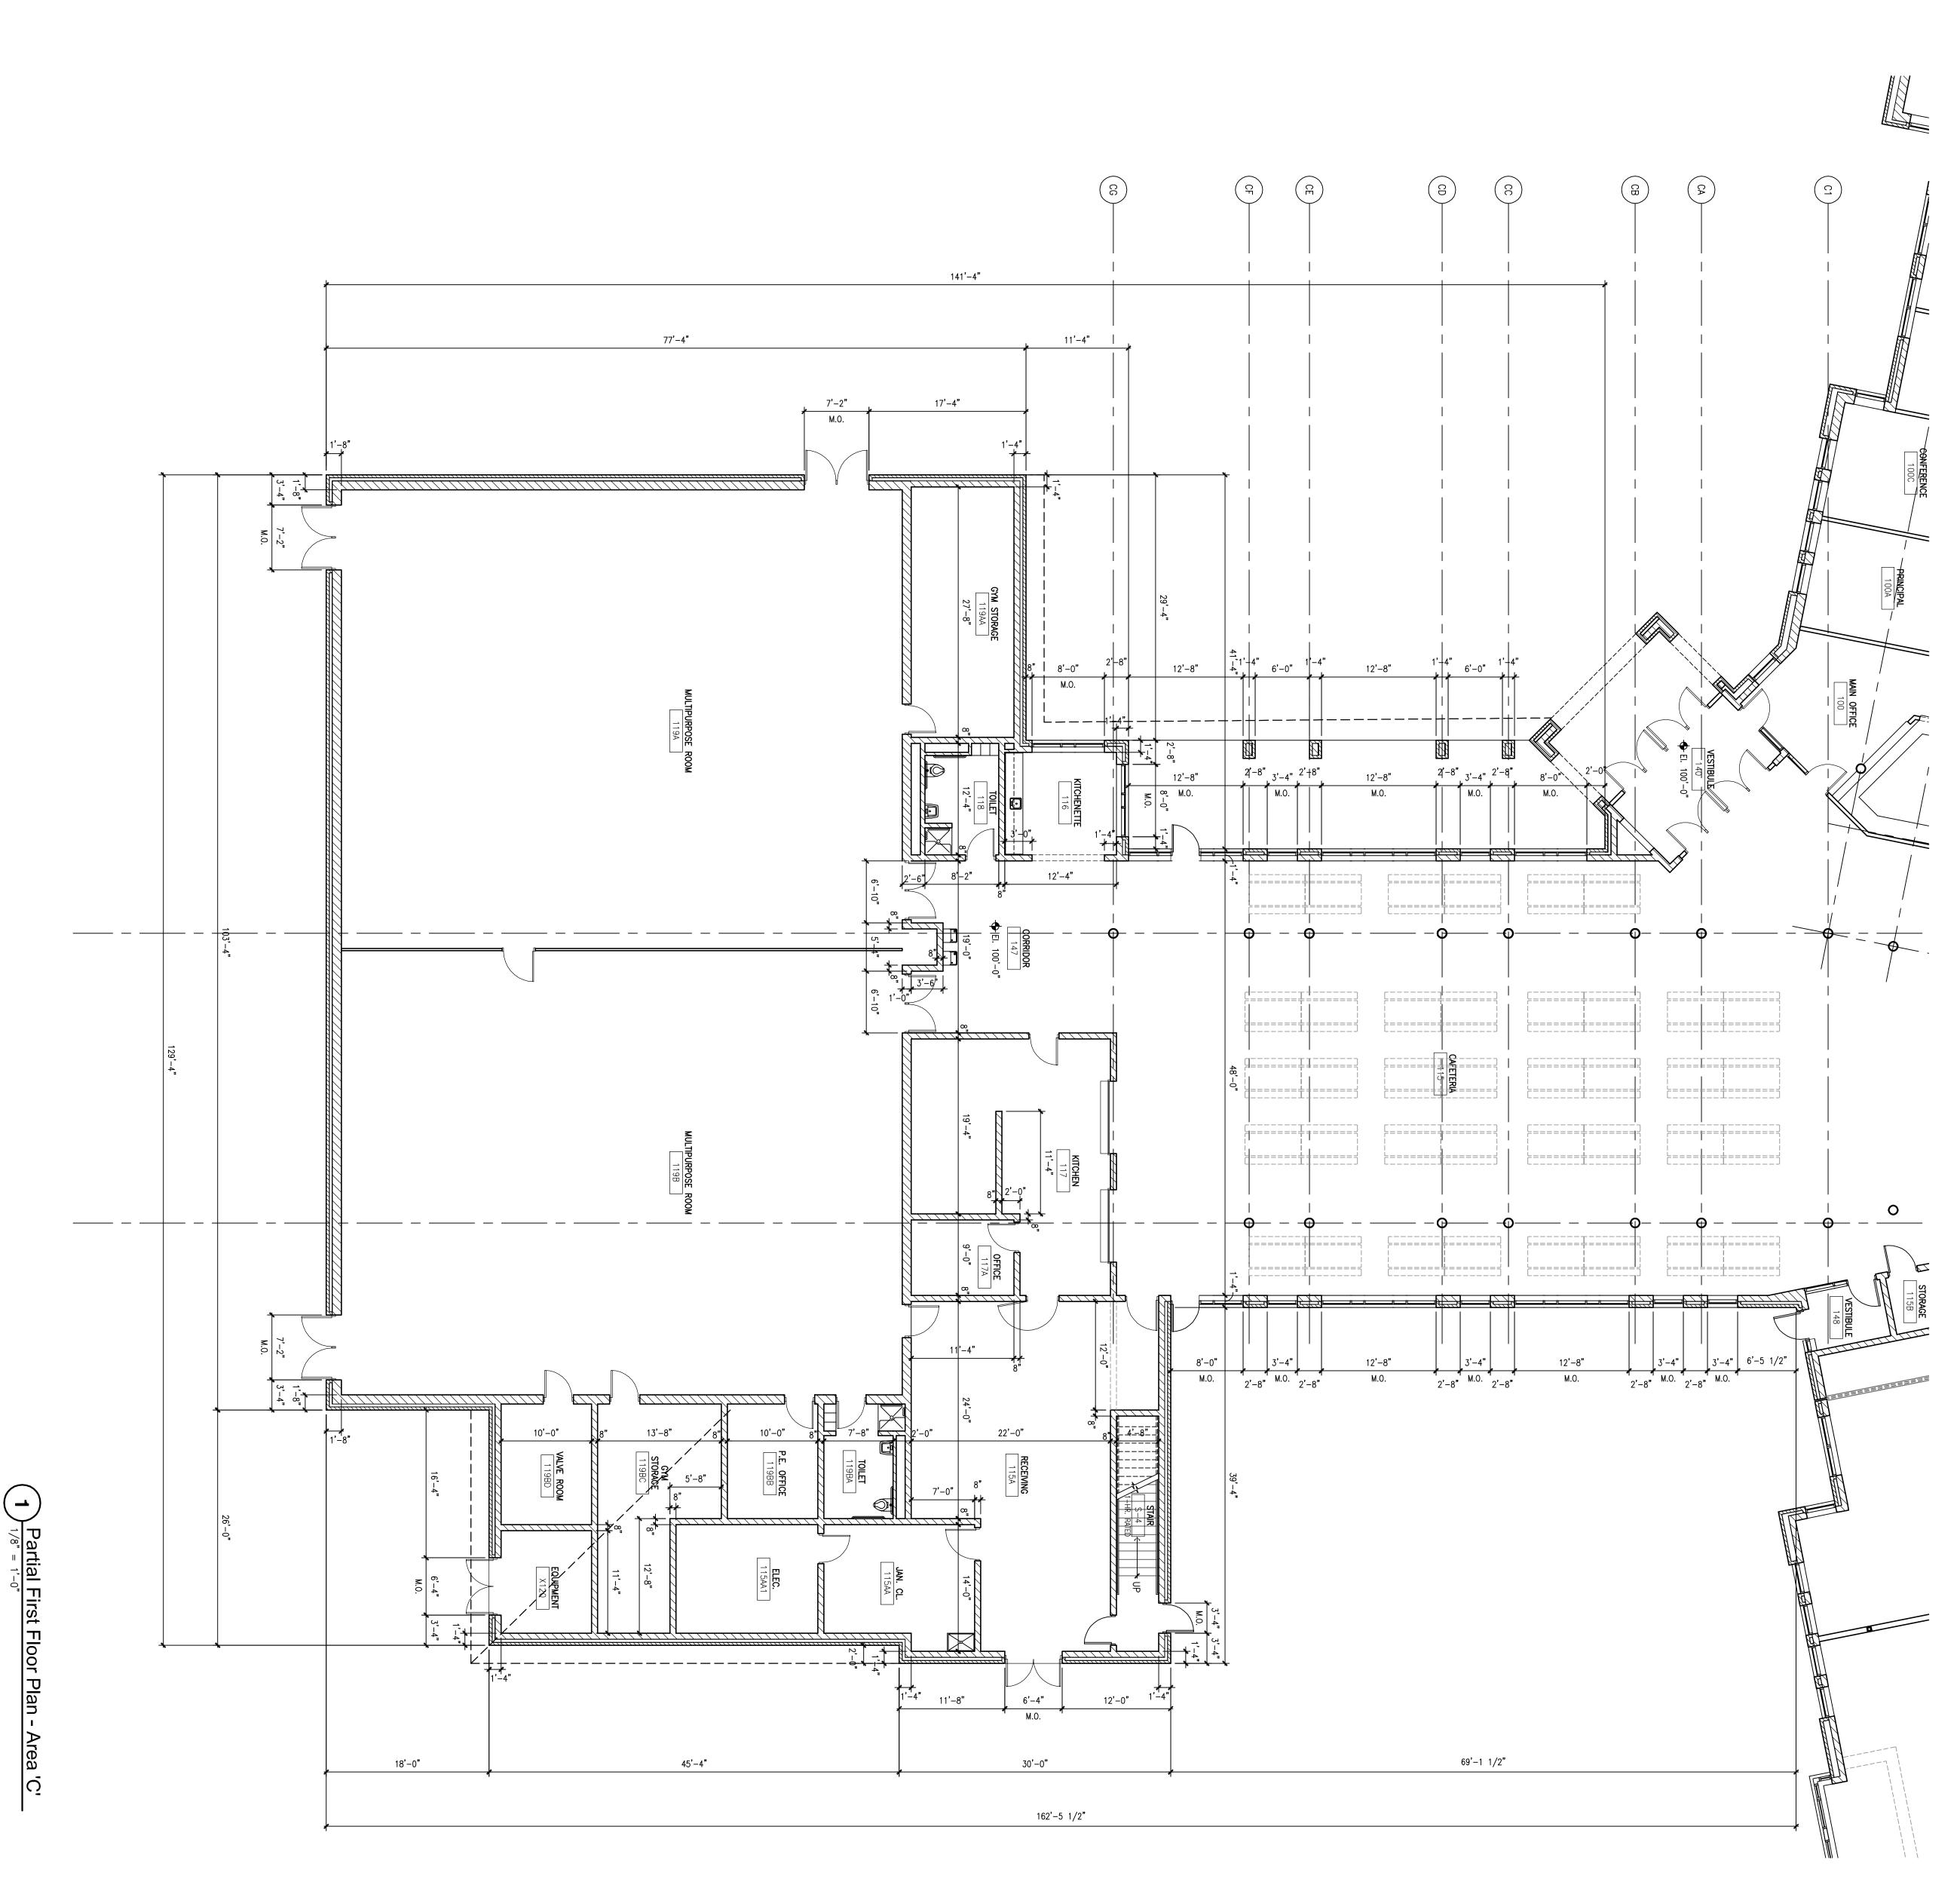



January 3, 2007

Revisions:


No. Date: Description:

11/29/06 Modison – UDC Informational Submittal

1/3/07 Modison – UDC Initial Approval Submittal

1/3/07 Modison – Plan Commission Submittal

Scale: 1/8" = 1'-0"

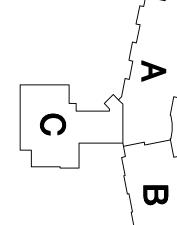

Location: 801 Redan Drive Verona, WI 53593 Key Plan:

North


Sheet: Partial First Floor Plan-Area 'C'





Linden Park Elementary School Telephone [414] 476.9500
Facsimile [414] 476.8582






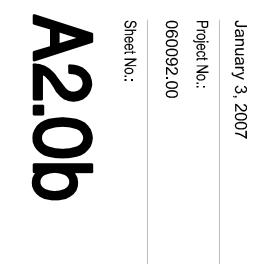

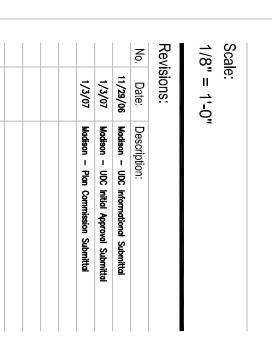


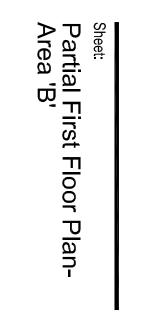

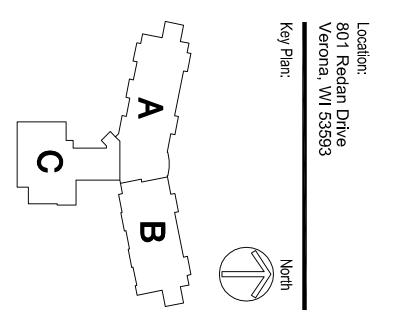






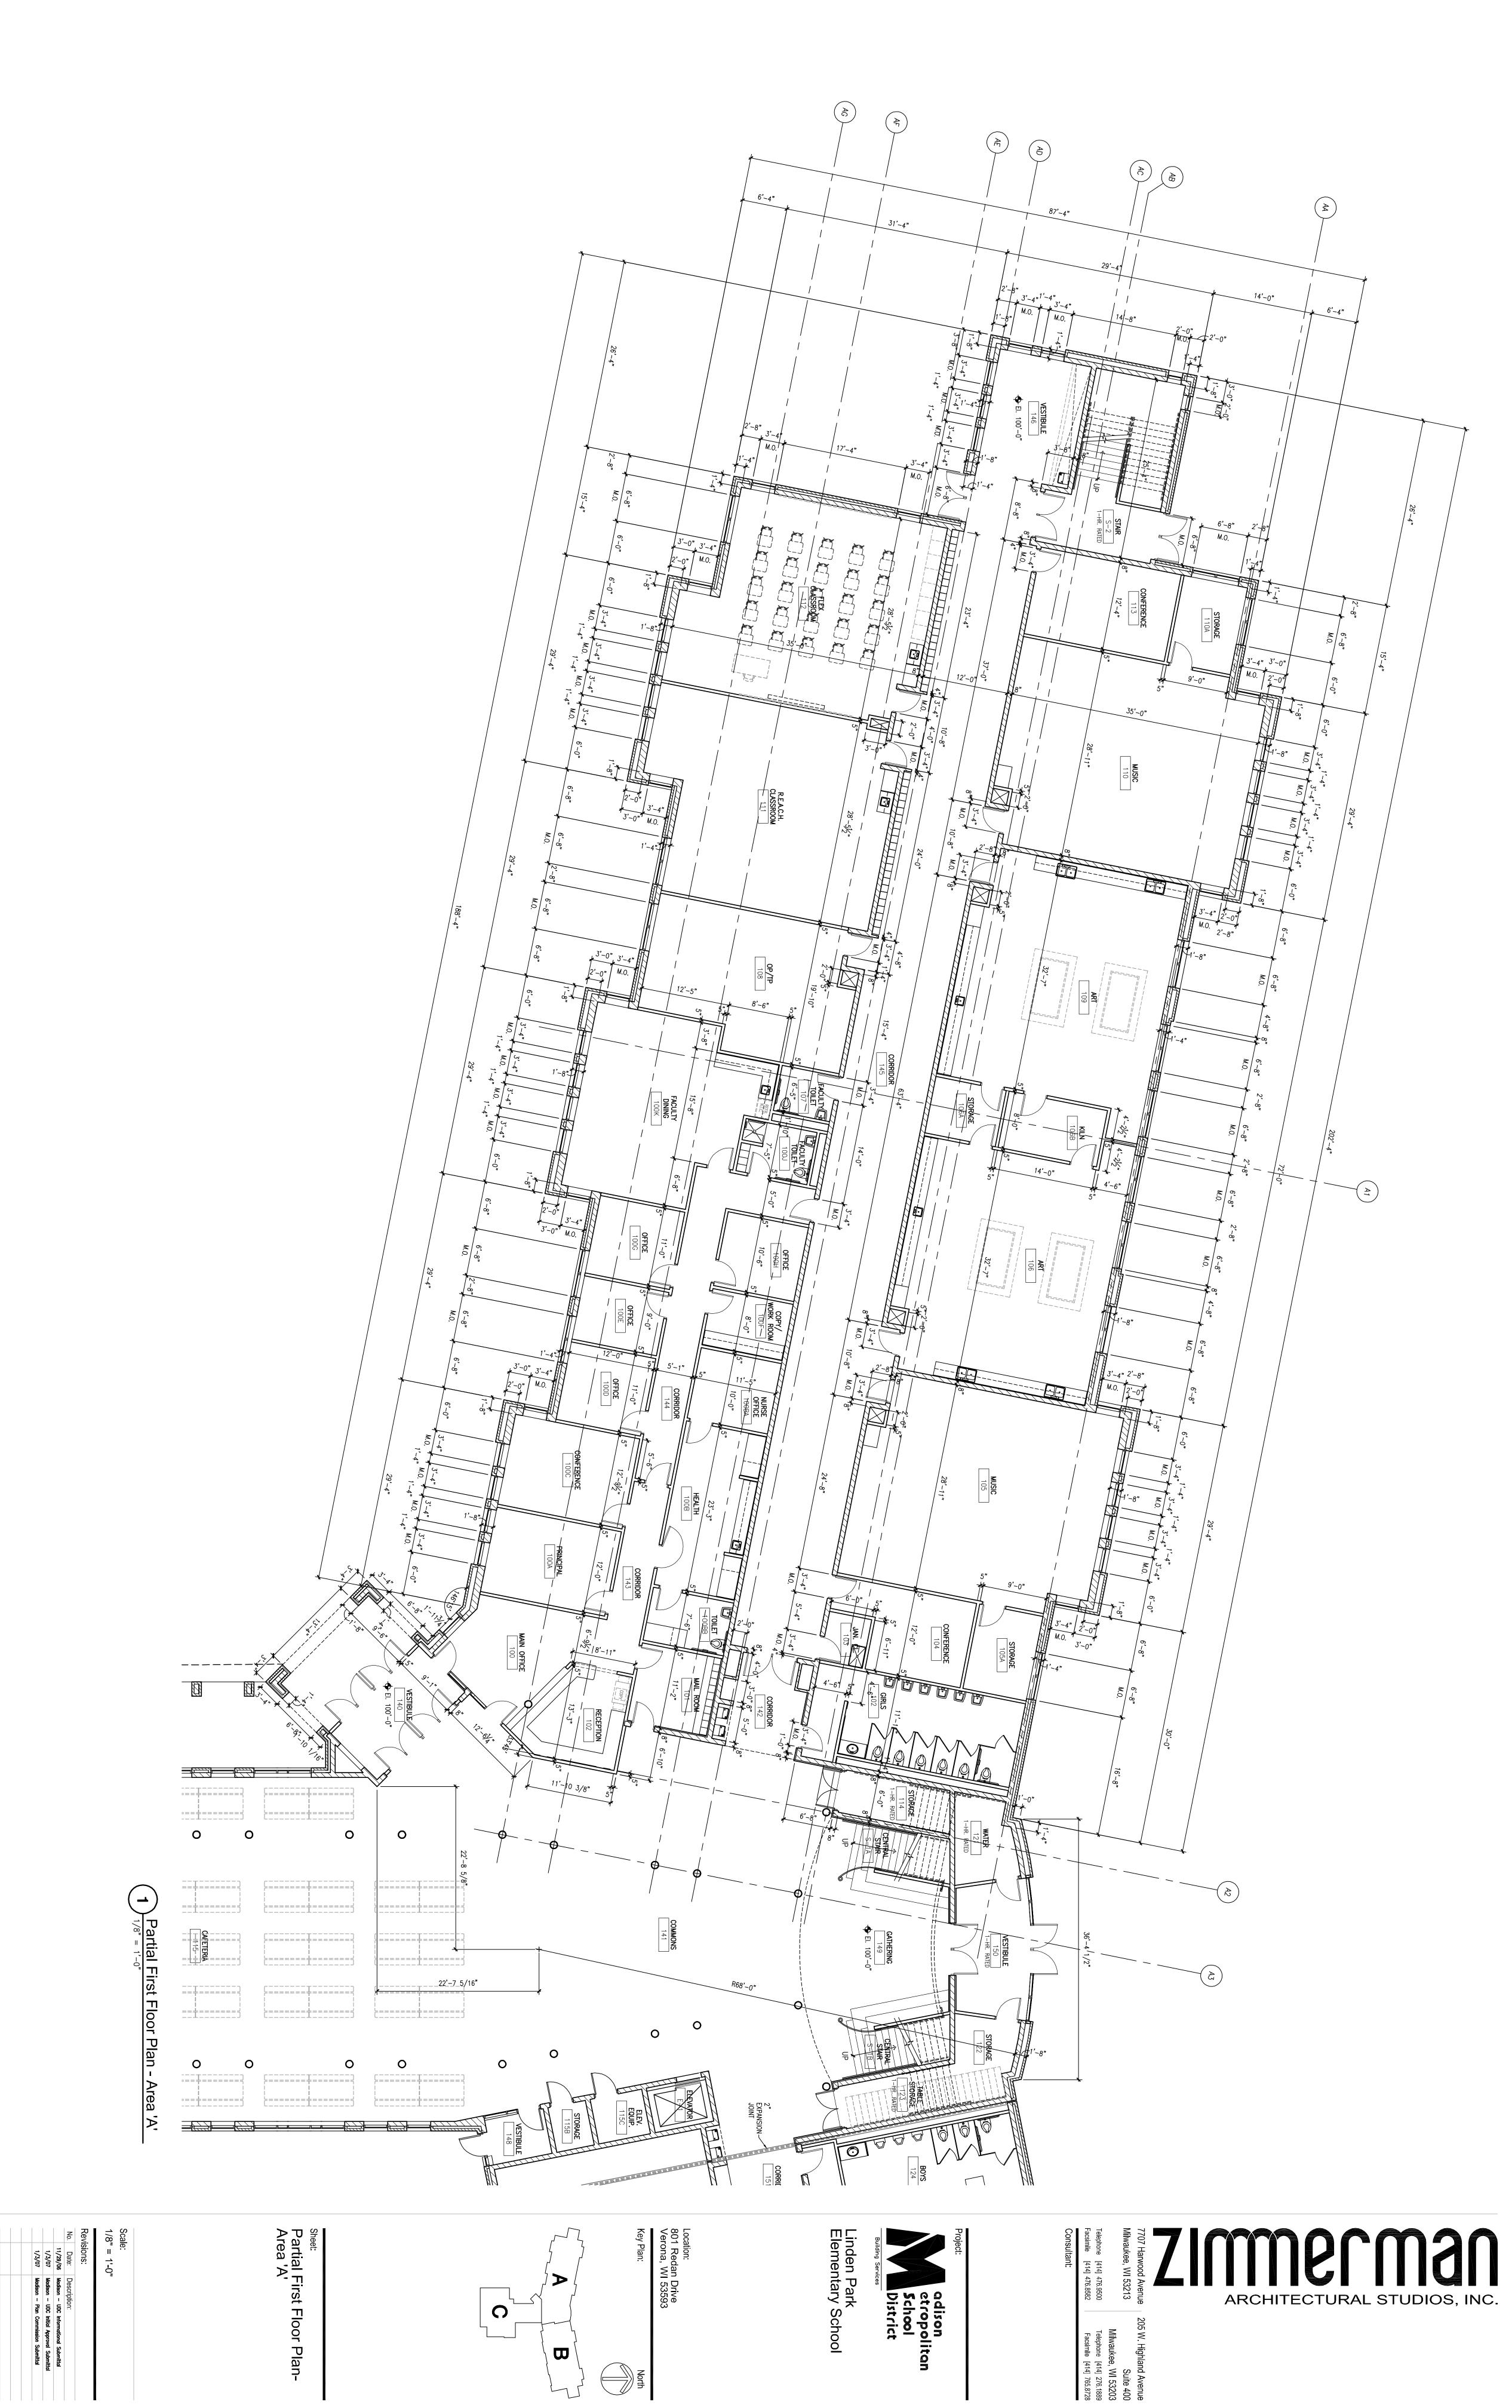


Project No.: 060092.00 Sheet No.:

January 3, 2007

A2.0a

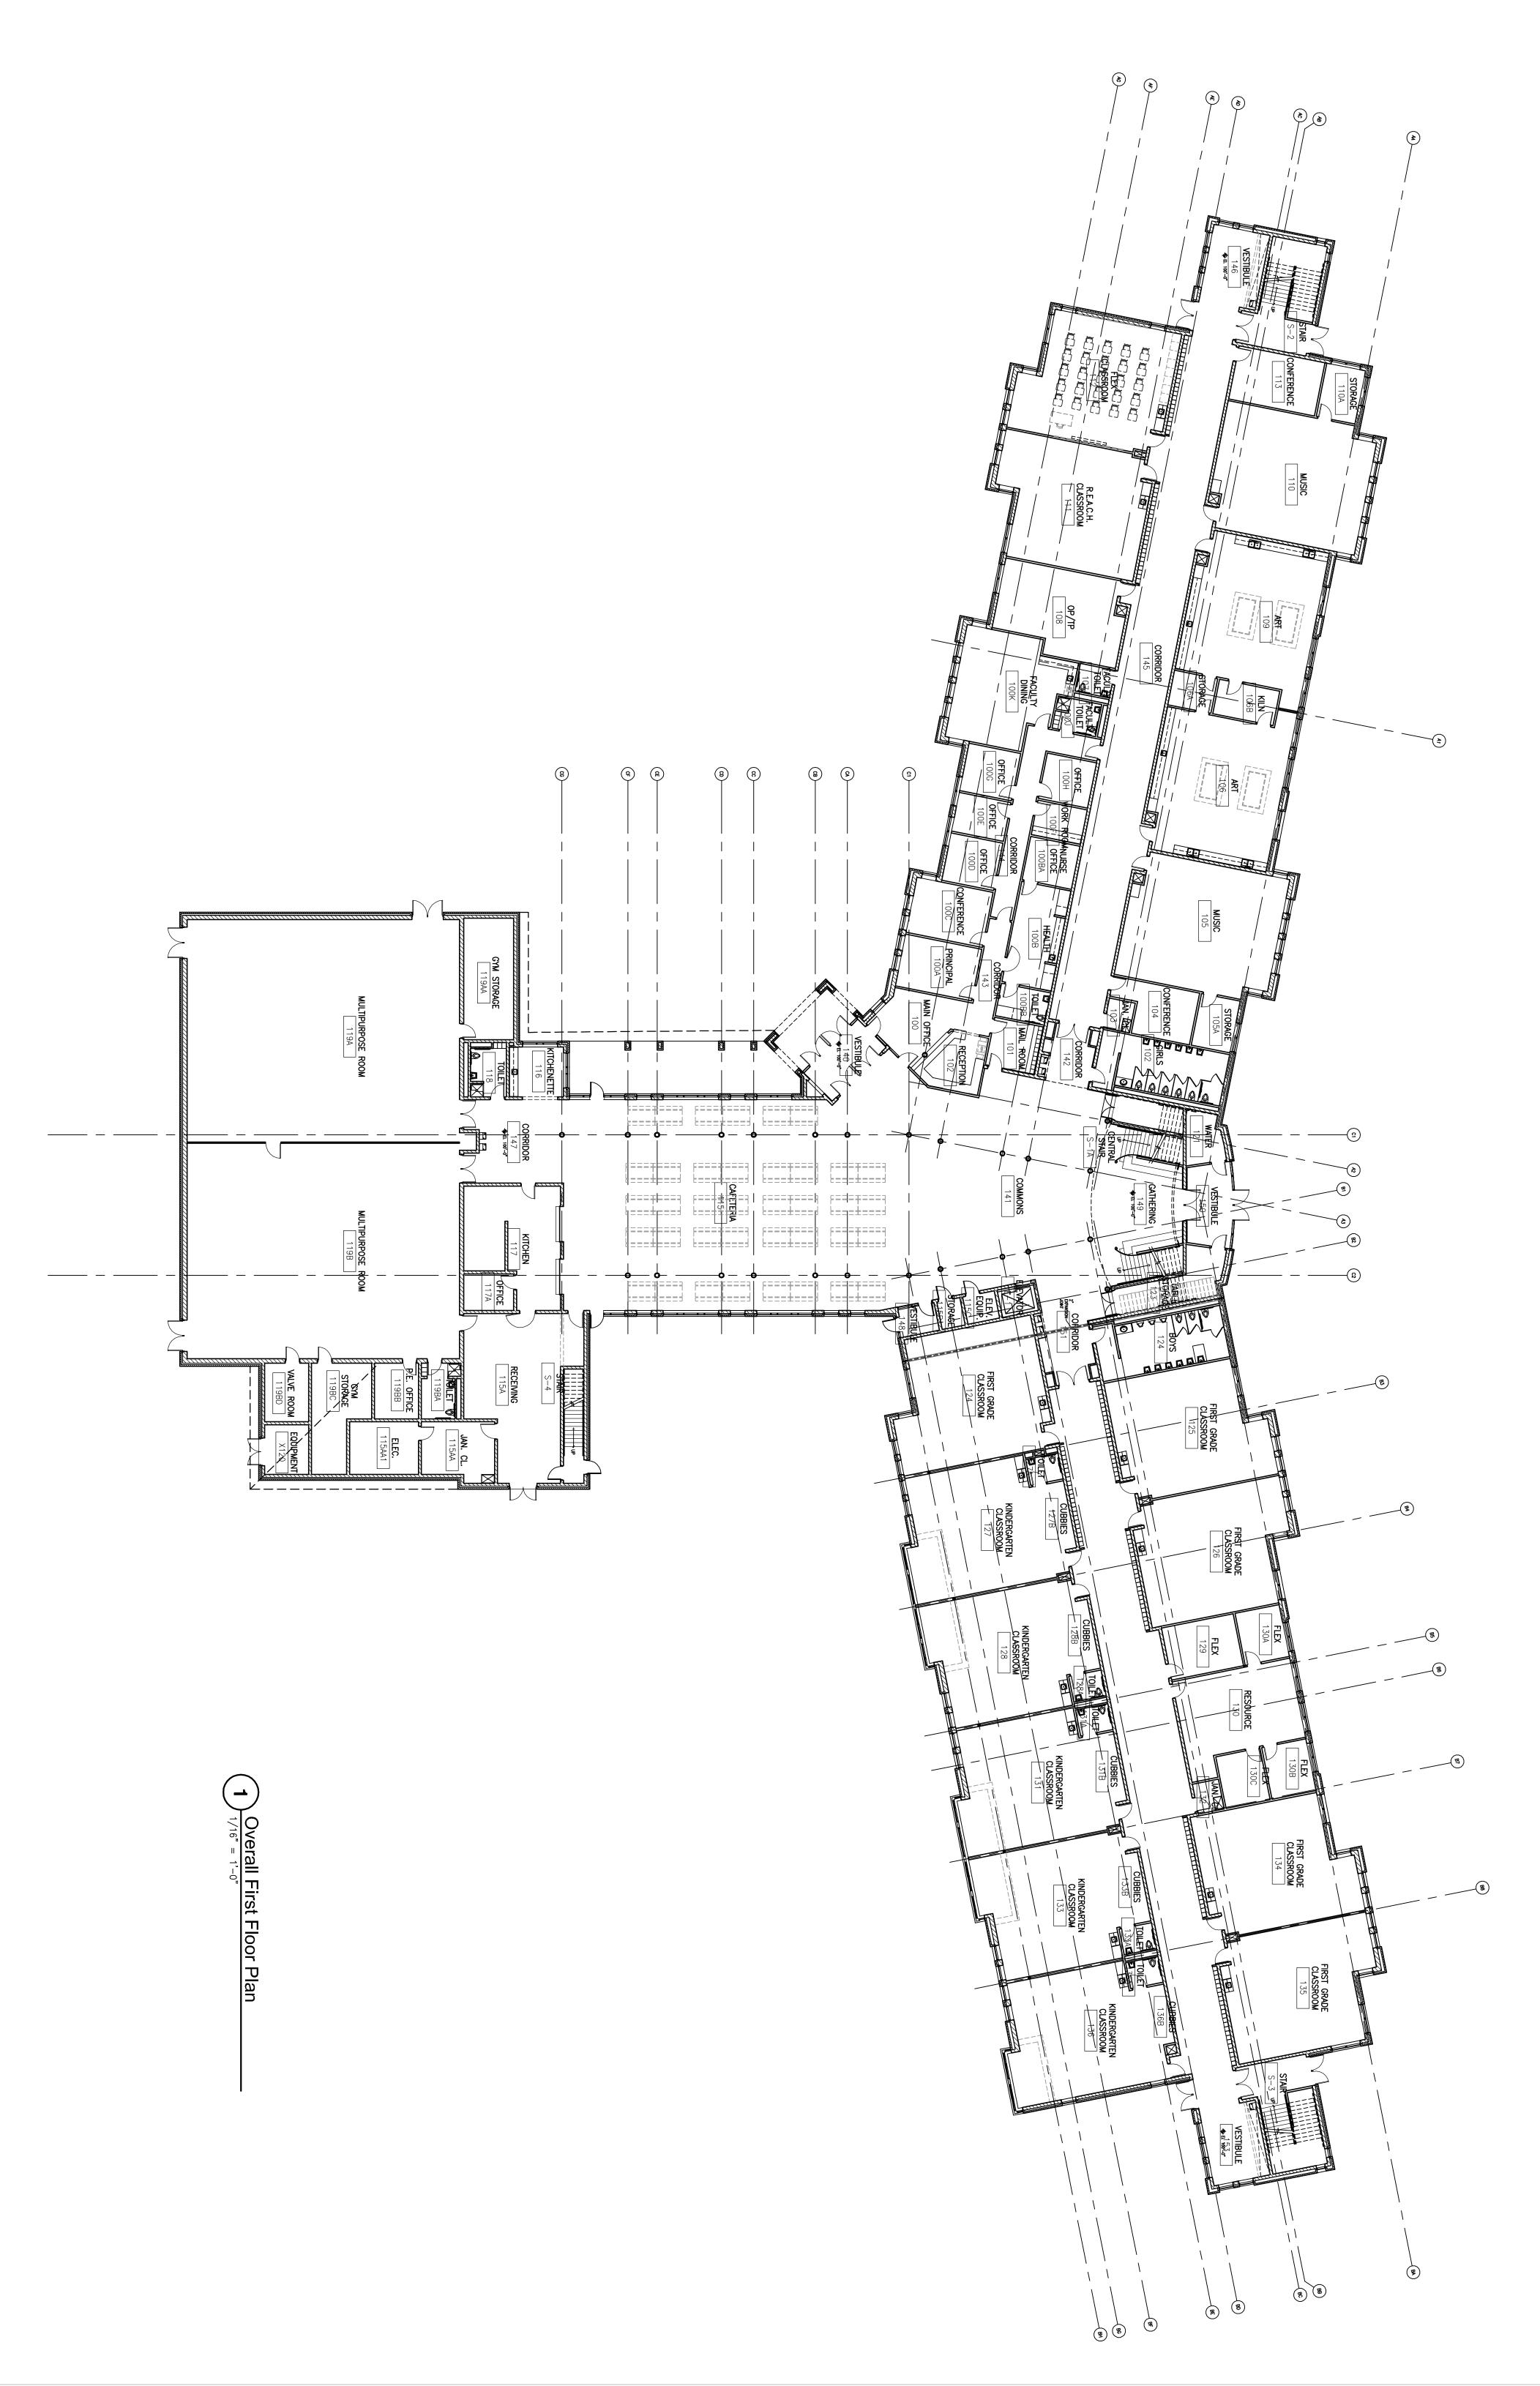



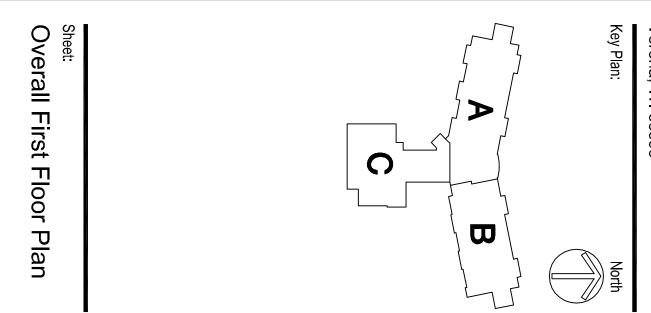

Location: 801 Redan Drive Verona, WI 53593 Key Plan:







7707 Harwood Avenue | Milwaukee, WI 53213 | zastudios.com TELEPHONE [414] 476.9500 FACSIMILE [414] 476.8582

## Letter of Intent For:

# **Linden Park Elementary School**

801 Redan Drive Madison, WI

January 3, 2007

Summary

Linden Park Elementary will be a newly constructed school within the Veridian Homes Neighborhood Development of the same name. The school will be home to 650 students in five classes per grades K-5. This project will utilize sustainable energy in the form of cool daylighting, geothermal heating/cooling and wind generation that will contribute to a LEED Silver Certification.

**Legal Description of Property:** 

Outlot 22 of Linden Park Development

**Construction Schedule:** 

April 2007 thru August 2008

**Project Contacts:** 

Following Page

**Building Use:** 

**New Elementary School** 

Total Building Gross Sq. Ft.:

First Floor

50,141 s.f.

Second Floor

39,779 s.f.

Total

89,920 s.f.

**Total Building Occupants:** 

Students

650

Staff

90

Total

740

# **Parking Spaces:**

Spaces Required

45 (One parking space for every two (2) employees)

Spaces Provided

116

Faculty/Staff

95 (5 accessible, including 1 van)

Visitor

21 (1 accessible)

**Hours of Operation:** 

M-F 6:00 a.m. to 10:00 p.m.

Site Acreage:

8.3 acres

Trash removal will be via garbage/recycling service.

Snow will be plowed and remain on site.

Maintenance equipment will be stored within the building proper.

# **Project Contacts**

**Owner** 

**Madison Metropolitan School District** 

545 West Dayton Street Madison, WI 53718

Owner Representative

Doug Pearson, CFM, CEM Director of Building Services

4711 Pflaum Road Madison, WI 53718

608.204.7909 fax 608.204.0373

Owner Project Manager

Rick Hopke, P.E.

Coordinator of Facilities Engineering 608,204,7912 fax 608,204.0373

<u>Surveyor</u> STS Consultants

2821 Dairy Drive, Suite 5

Madison, WI 53718

608.222.7231 fax 608.222.3765

Project Engineer

Matthew D.Emrick, P.E.

**Architect** 

**Zimmerman Architectural Studios** 

7707 Harwood Avenue Milwaukee, WI 53213

414.476.9500 fax 414.476.8582

Project Architect

Doug Barnes, AIA, REFP

414.918.1461 Mark Wershay

Project Manager

414.918.1331

Landscape Architect

Joe Pepitone, ASLA

414.918.1475

**Engineer** 

Harwood Engineering Consultants, Ltd.

7420 W. State Street Wauwatosa, WI 53213

414.475.5554 fax 414.475.5698

Civil

Thomas B. Olejniczak, P.E., LEED AP

414.918.1240

Structural

Conrad Ettmayer, P.E.

414.918.1220

**Plumbing** 

Patrick Geraghty, D.E., CIPE

414.918.1232

Mechanical


Robert Bueches, D.E., LEED AP

414.918.1237

Electrical


Tom Peterson, P.E.

414.918.1225

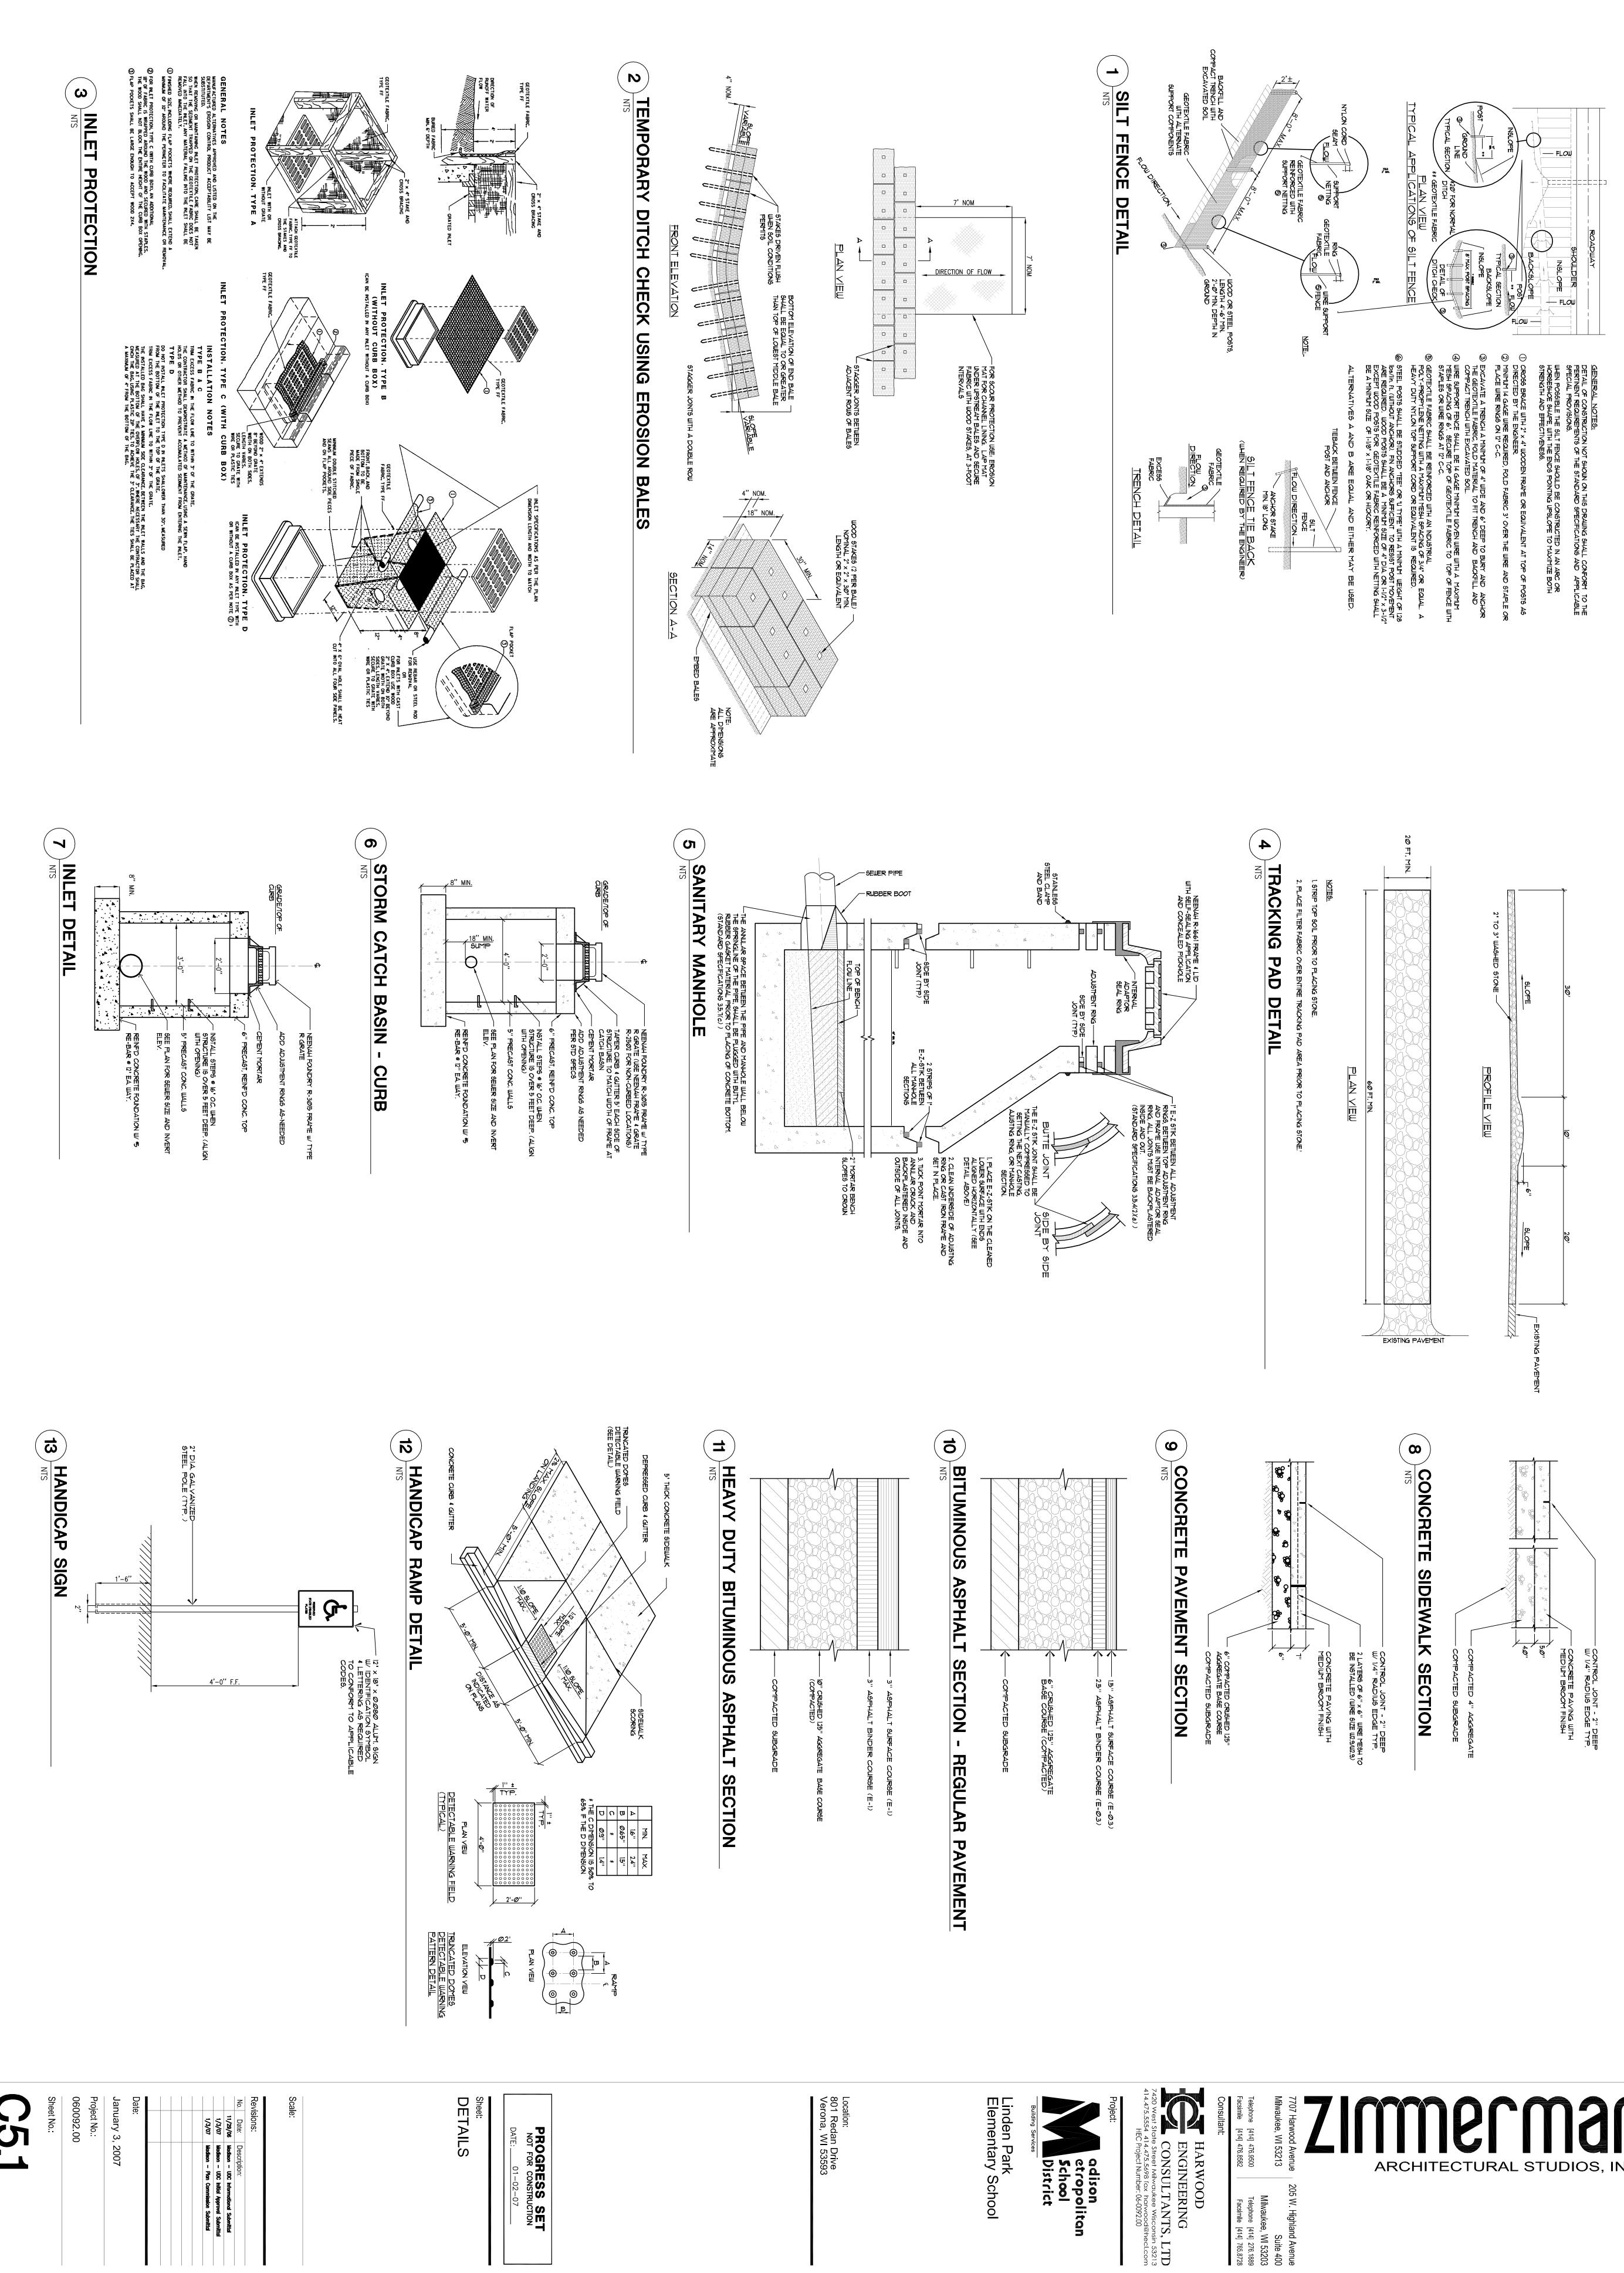


ARCHITECTURAL STUDIOS, INC.

205 W. Highlan

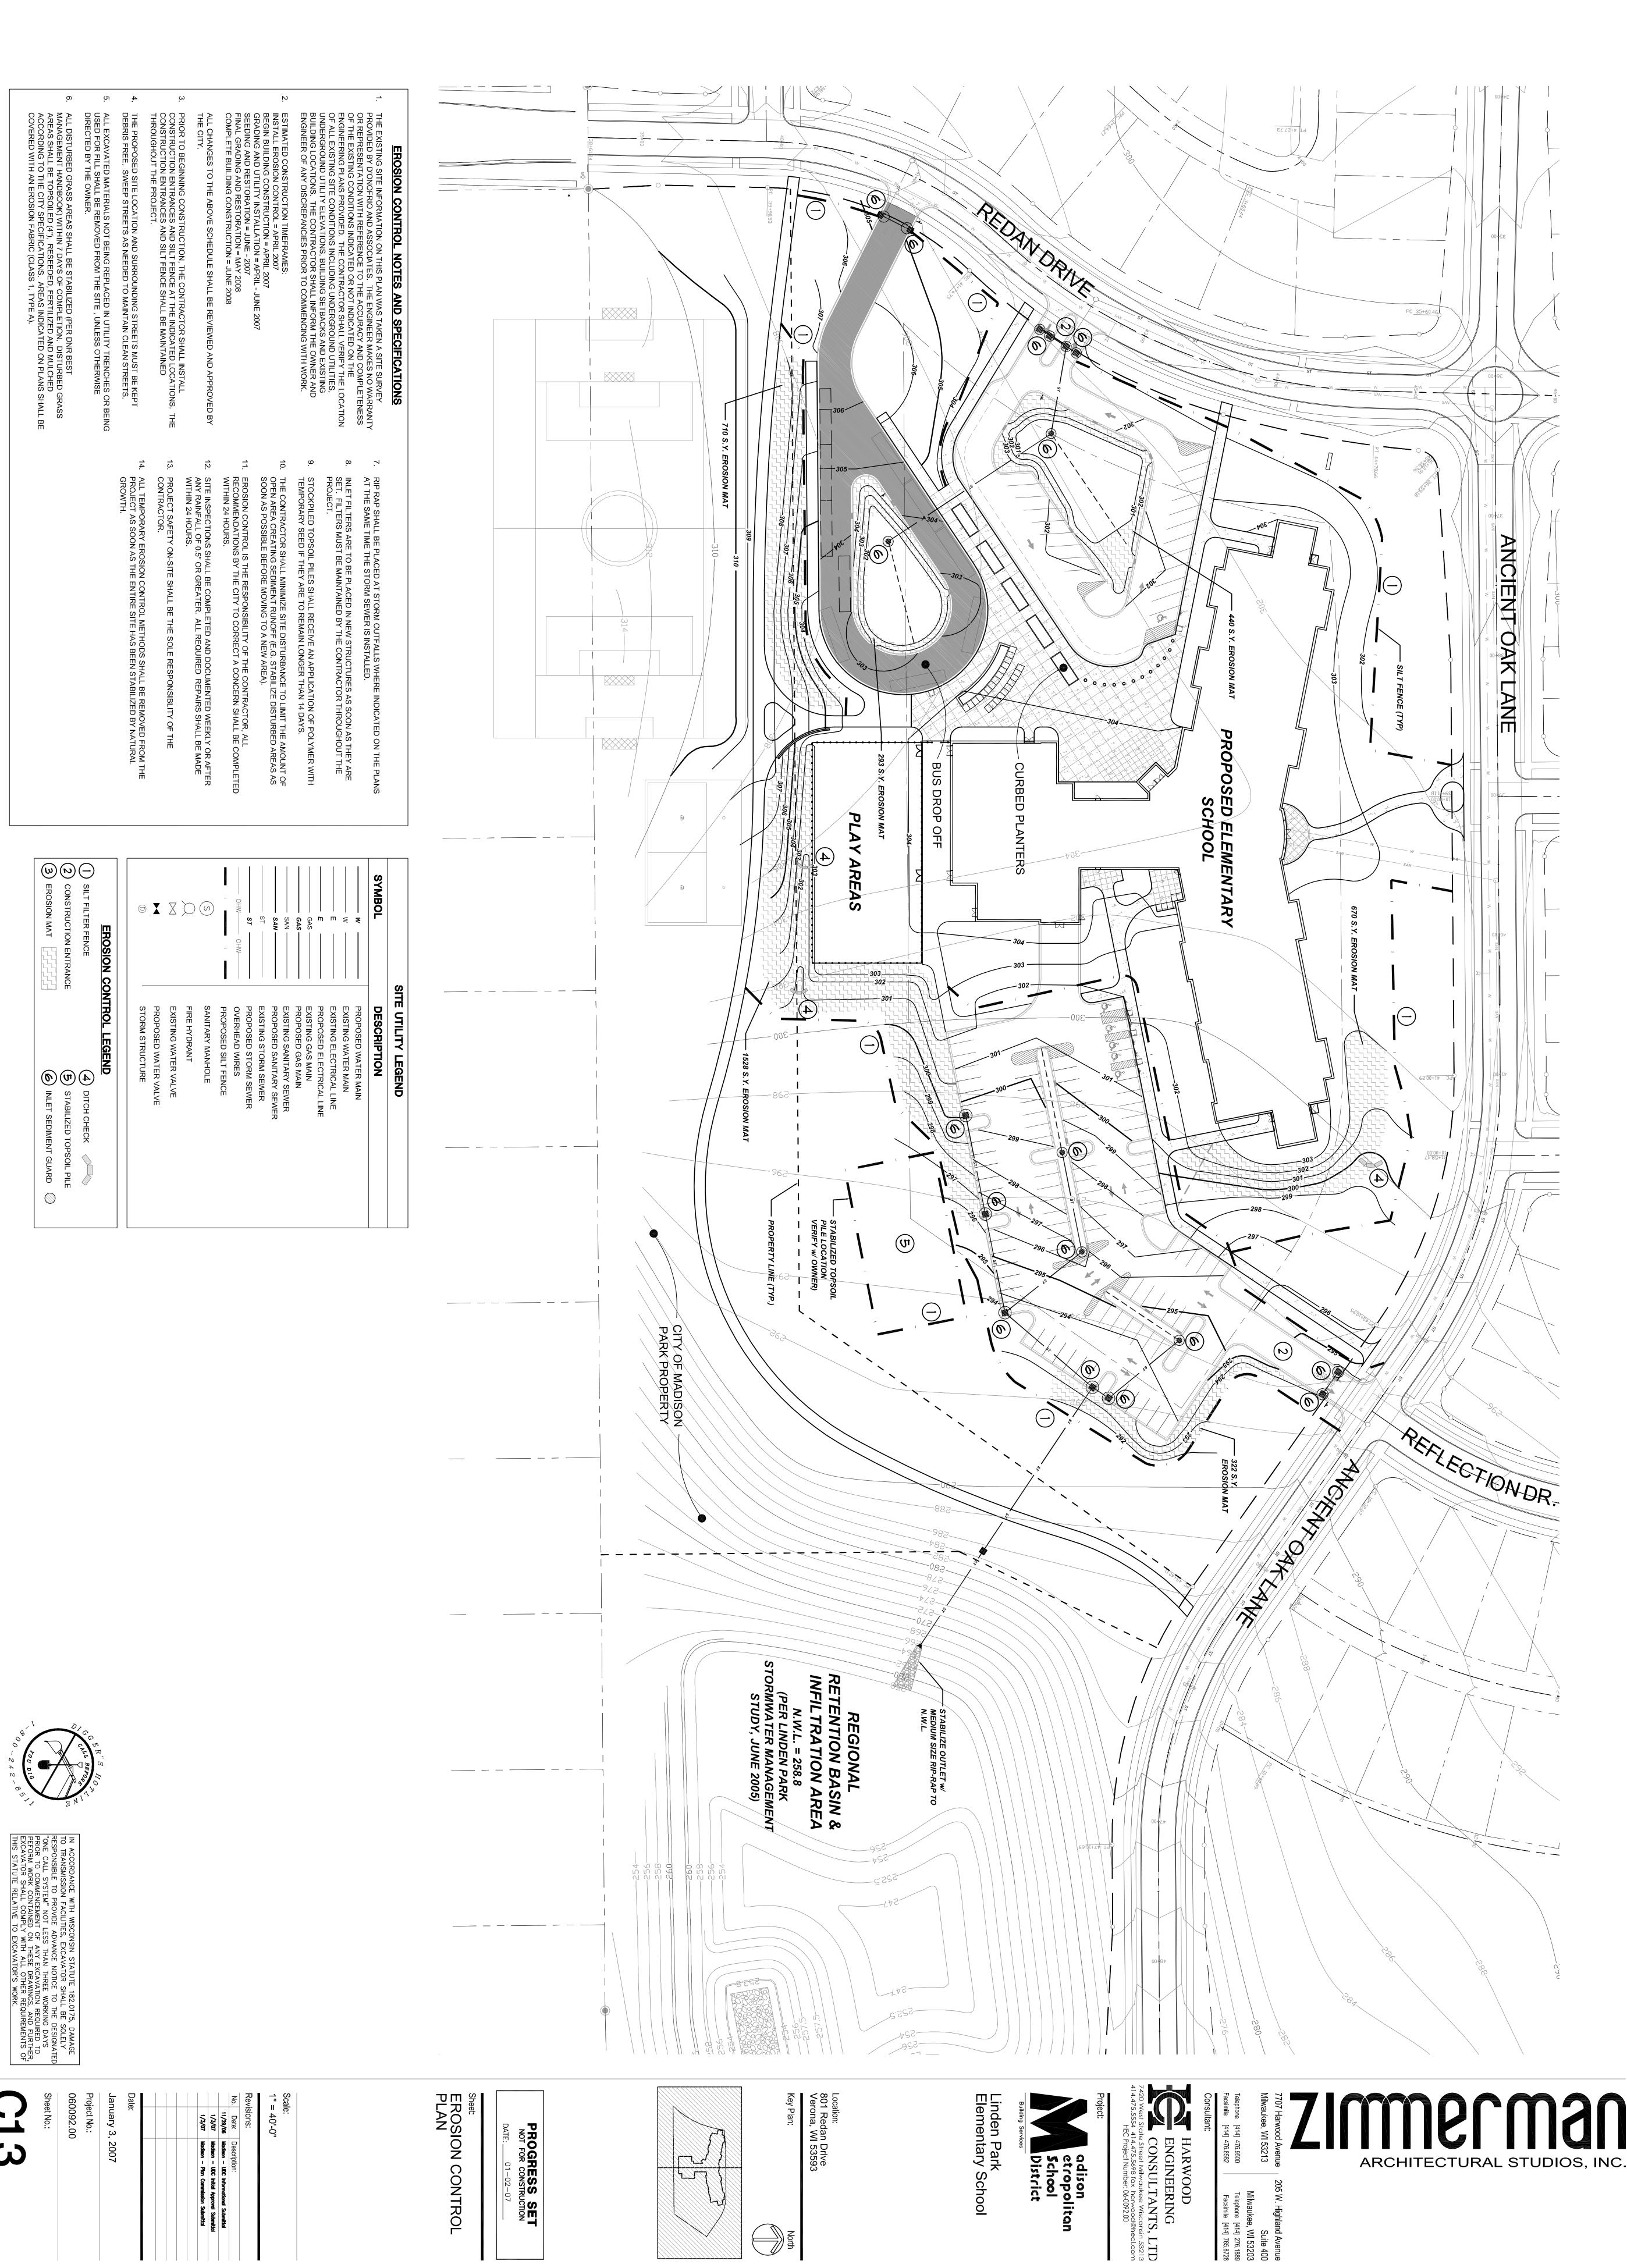

North

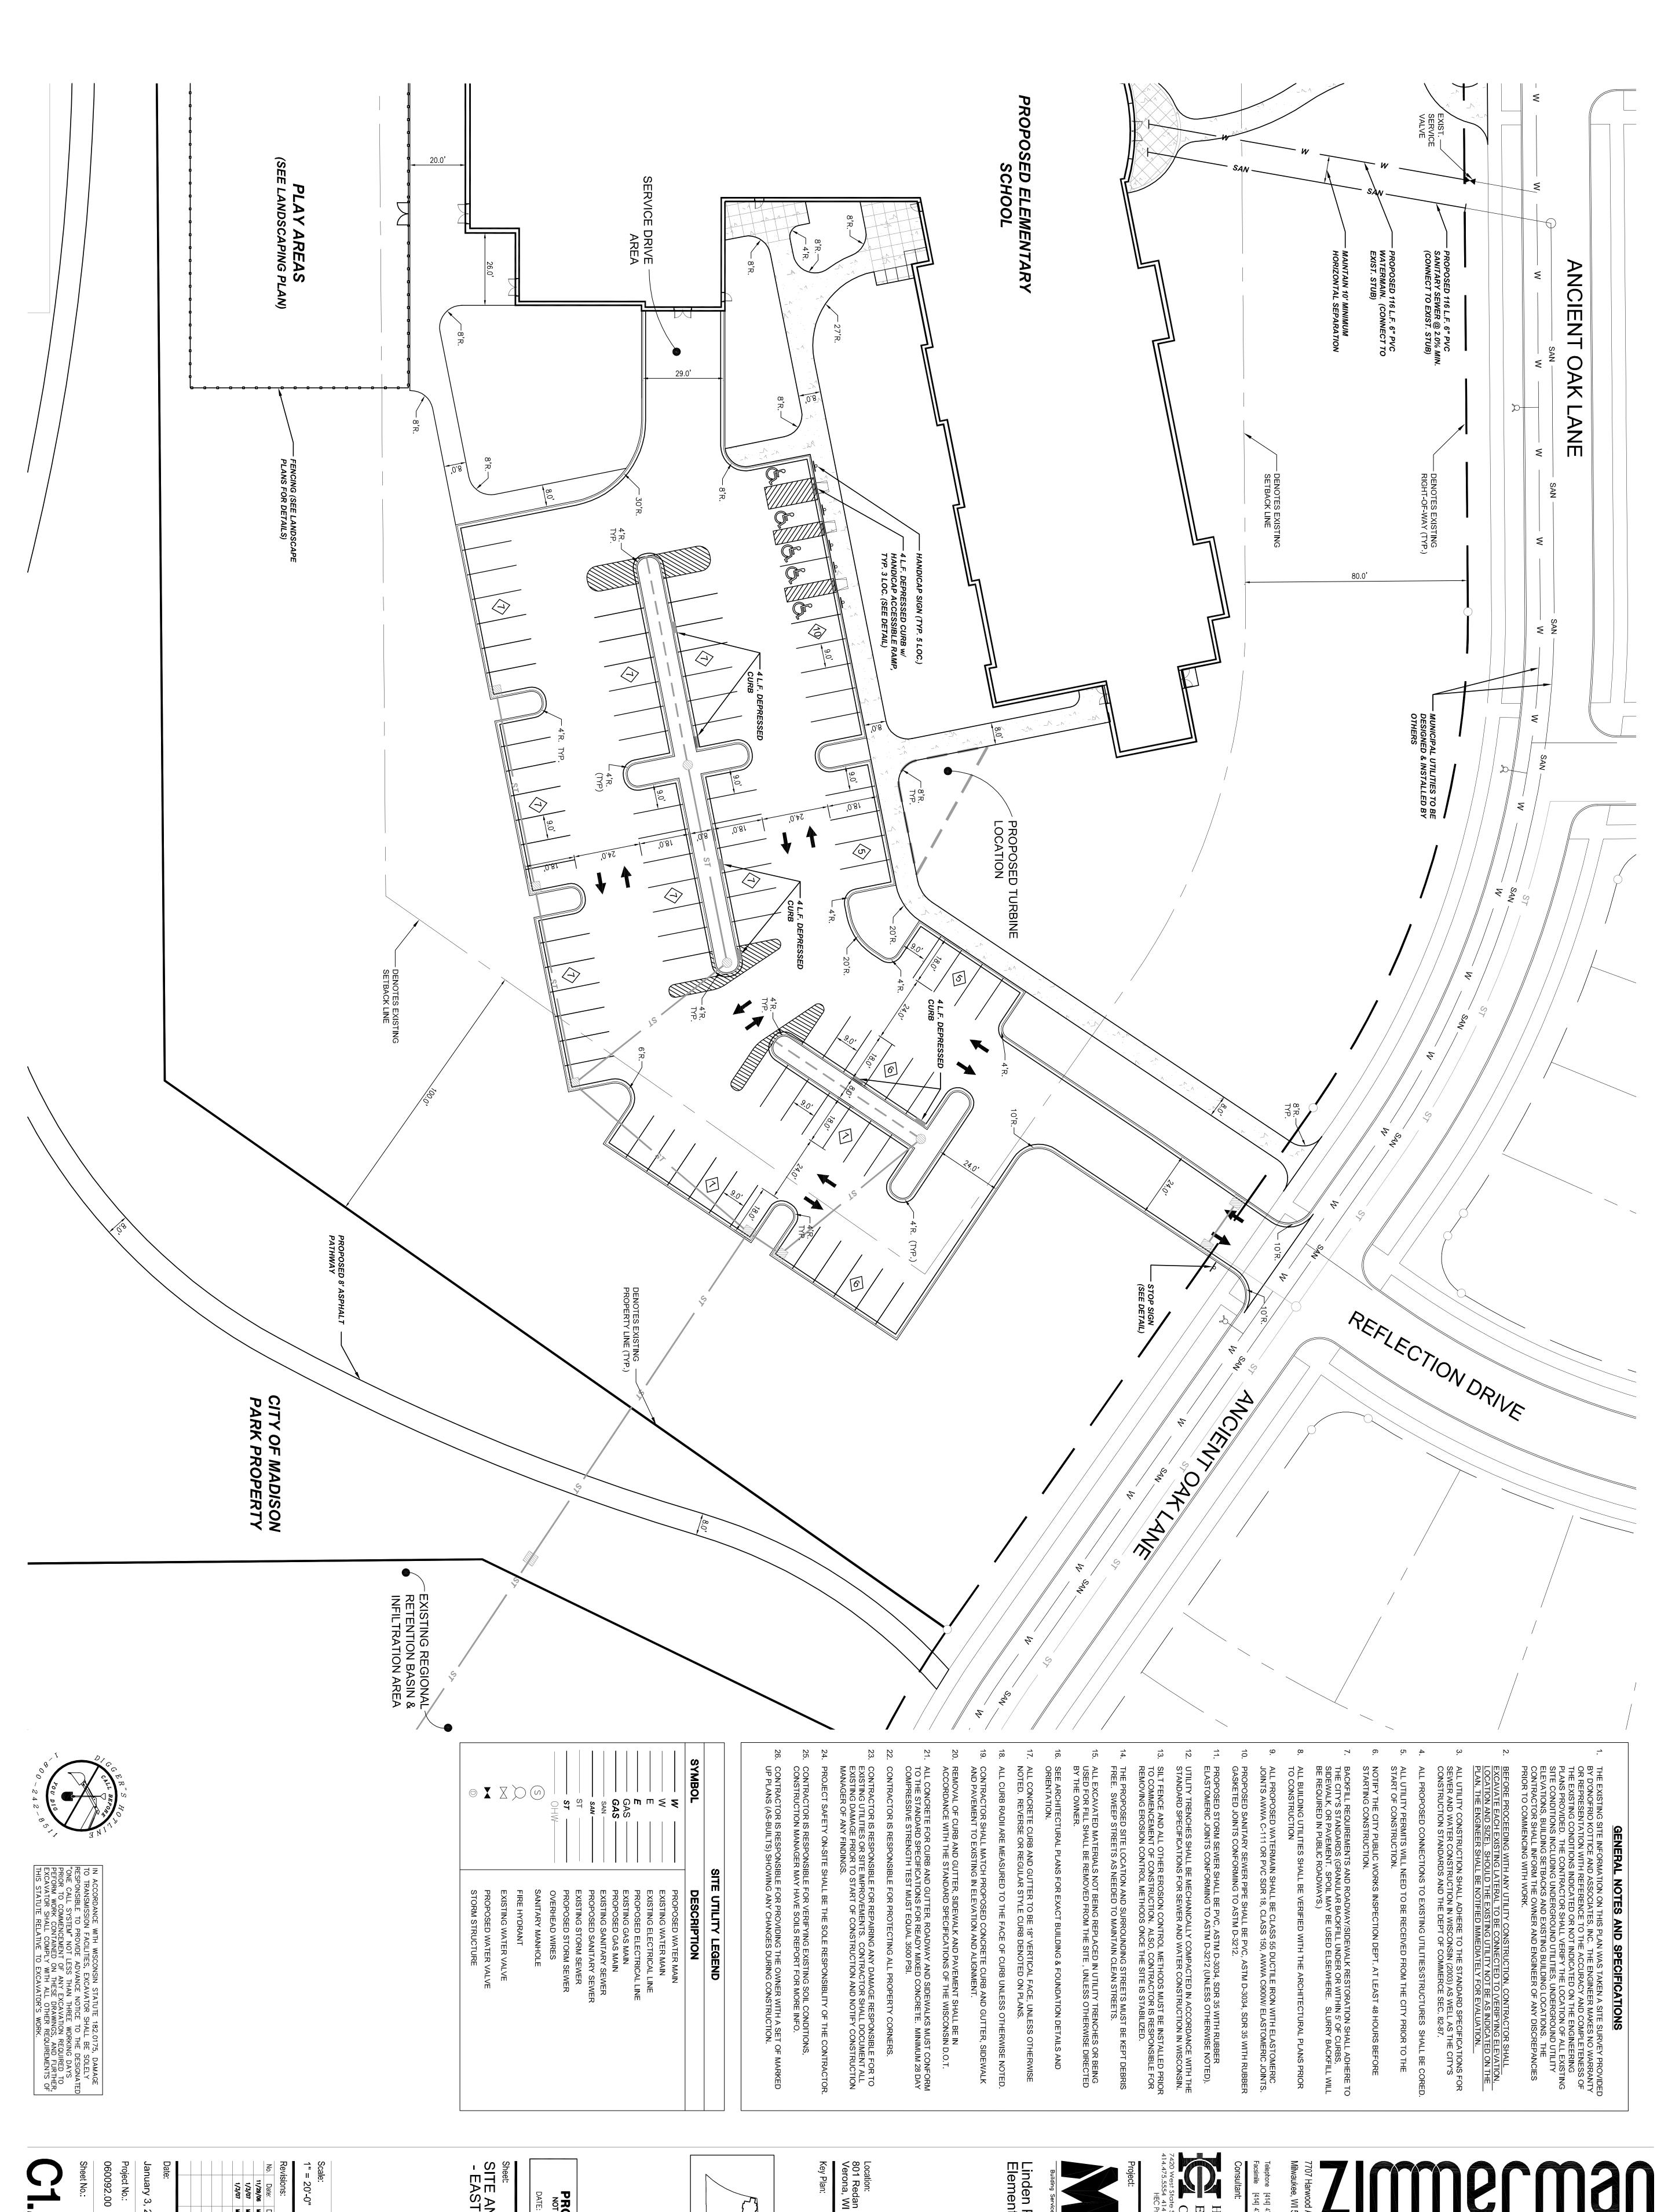

71.22

et No.


January 3, 2007


Scale: 1" = 20'-0" Madison - UDC Informational Submittal


Madison - UDC Initial Approval Submittal


Madison - Plan Commission Submittal

SITE AND UTILITY PLAN - EAST AREA

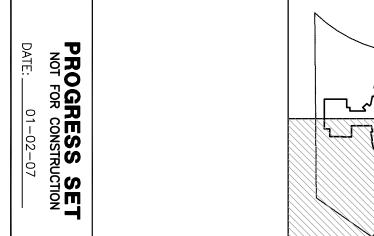

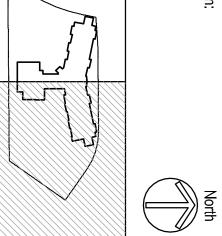

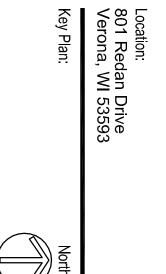

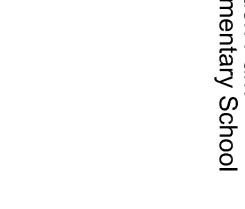



HARWOOD

ENGINEERING


CONSULTANTS, LTD

tate Street Milwaukee Wisconsin 53213
4 414.475.5698 fax harwood@hecl.com
HEC Project Number: 06-0092.00

205 W. Highlar 05 W. Highland Avenue Suite 400 Milwaukee, WI 53203 Telephone [414] 276.1889 Facsimile [414] 765.8728

lephone [414] 476.9500 csimile [414] 476.8582 ood Avenue , WI 53213

ARCHITECTURAL STUDIOS, INC.

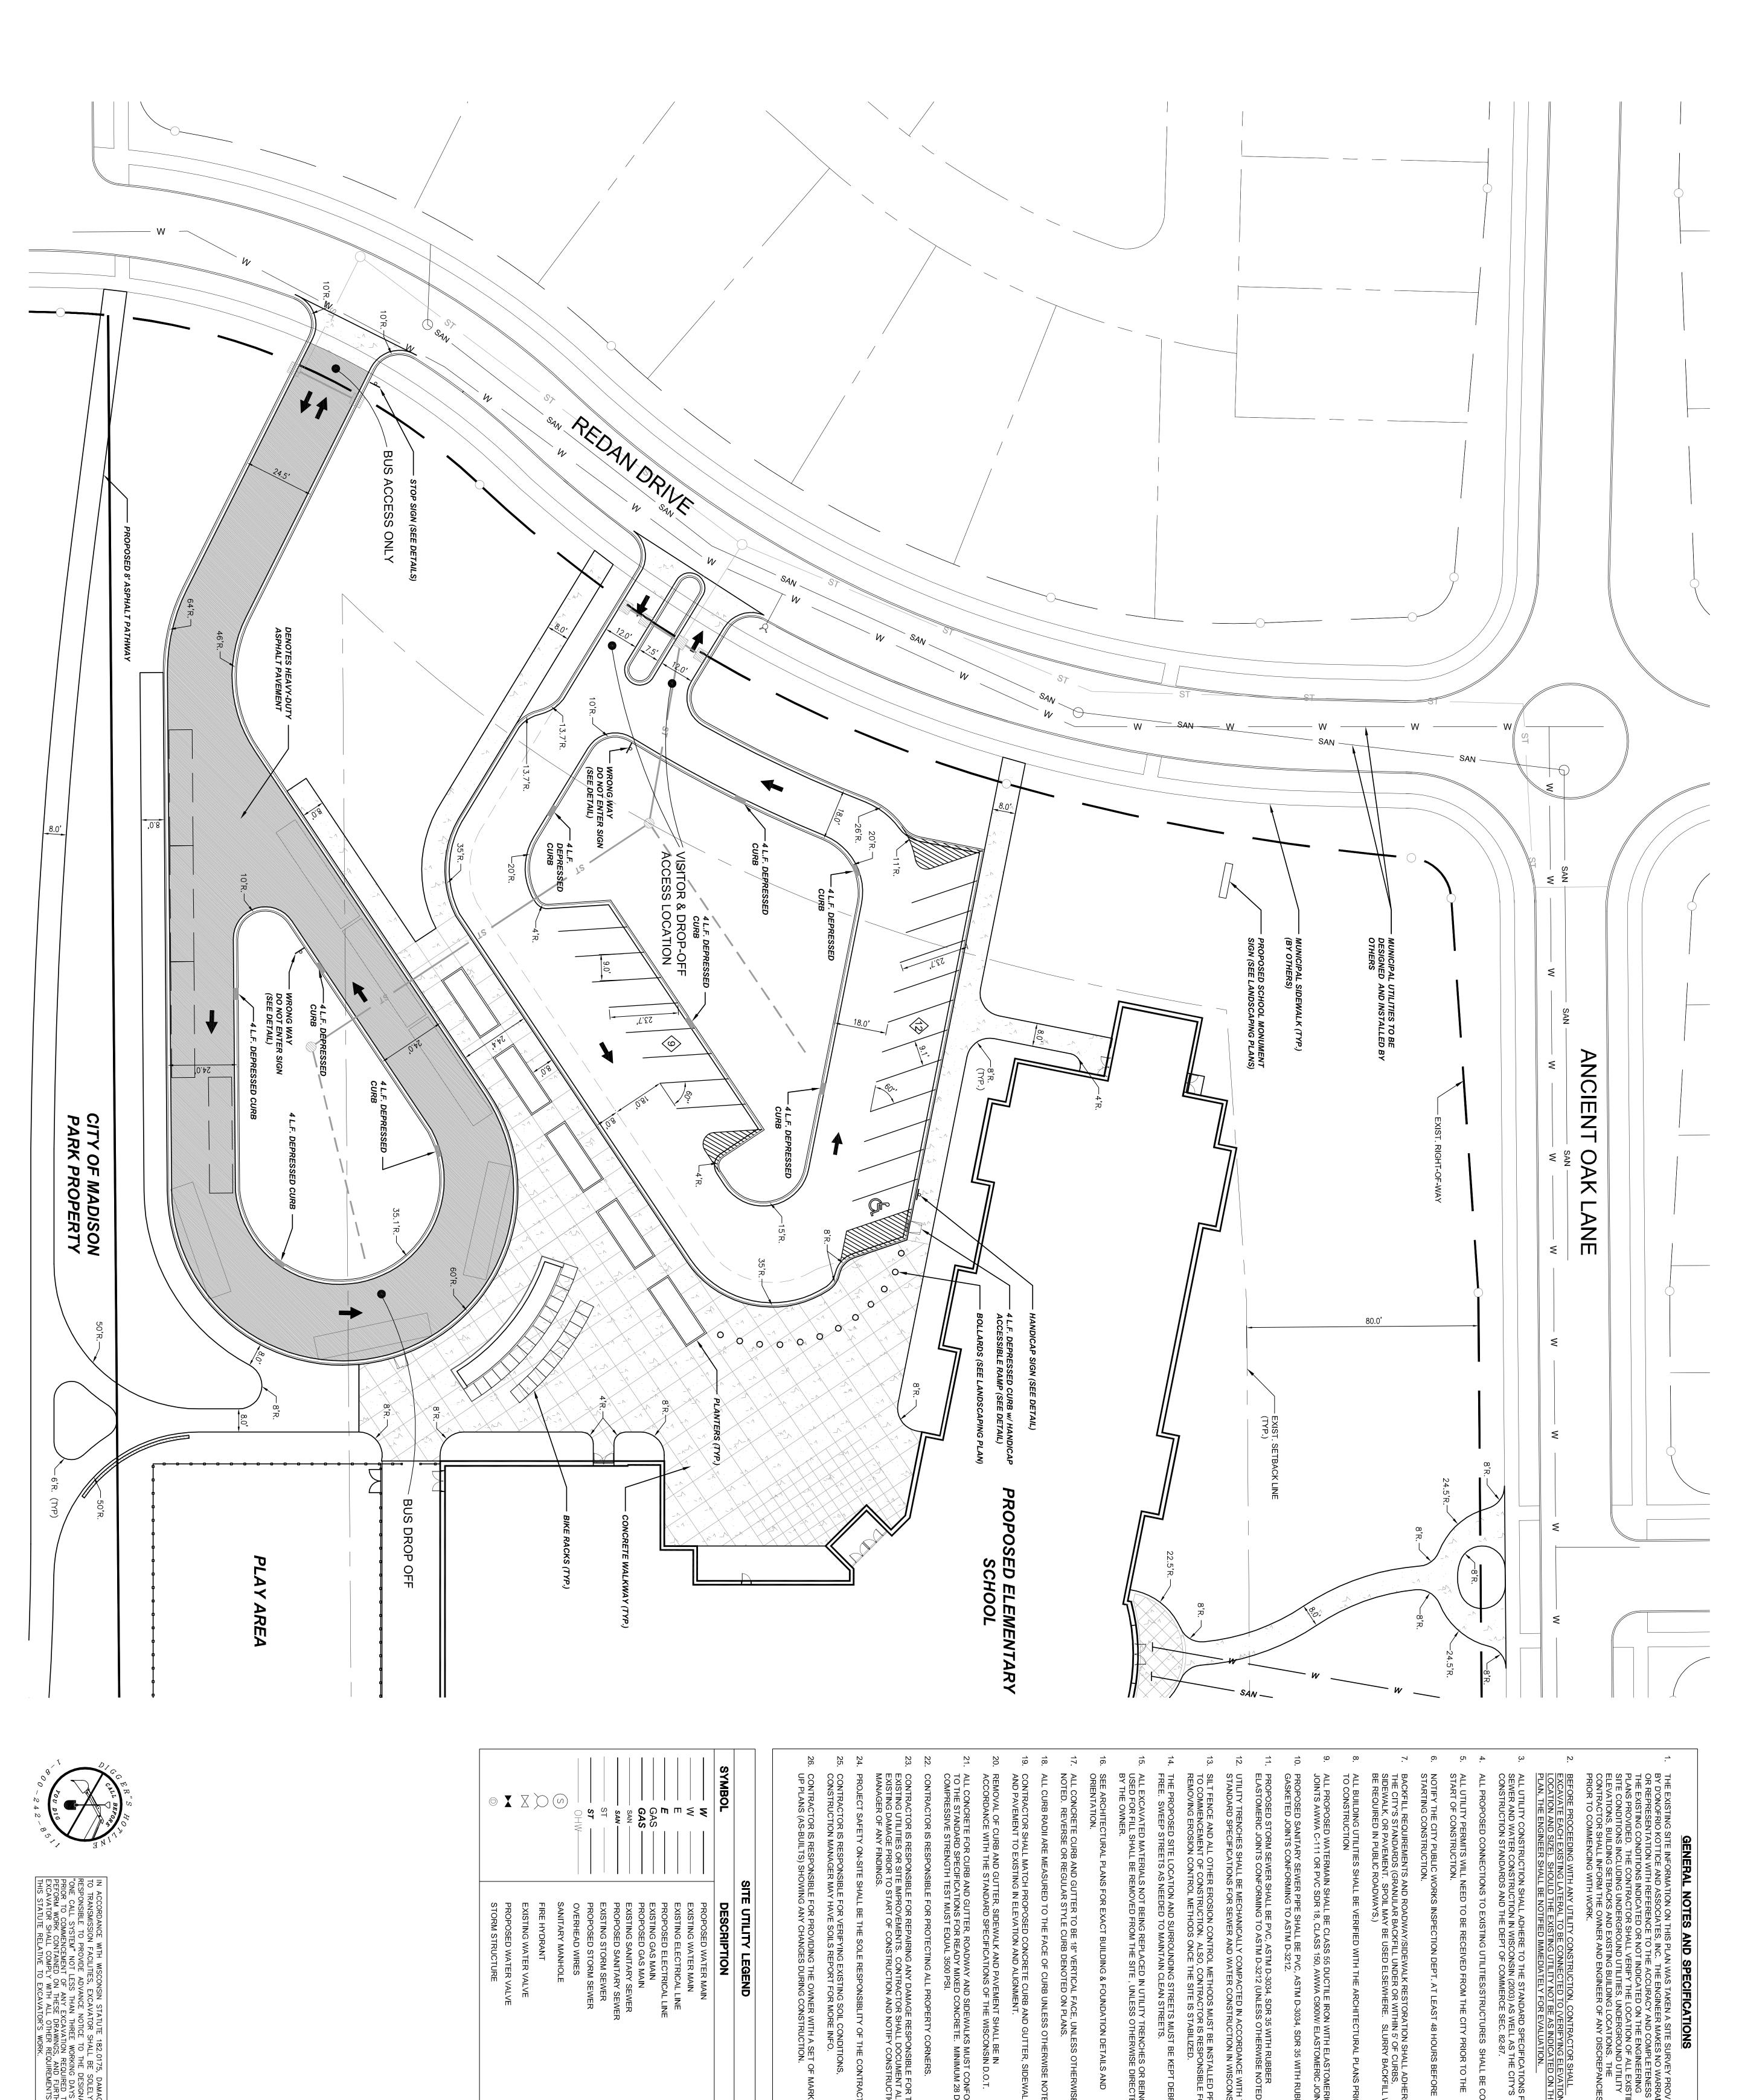

위됐

Project No.: 060092.00

et No.:


January 3, 2007

Scale: 1" = 20'-0" Madison – UDC Informational Submittal


Madison – UDC Initial Approval Submittal


Madison – Plan Commission Submittal

SITE AND UTILITY PLAN - WEST SIDE

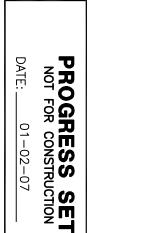



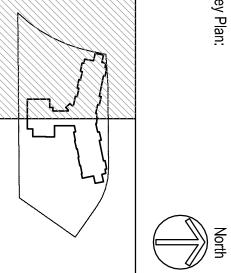

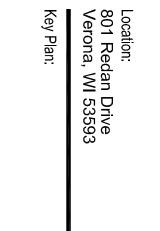



HARWOOD

ENGINEERING
CONSULTANTS, LTD
7420 West State Street Milwaukee Wisconsin 53213
414.475.5554
HEC Project Number: 06-0092.00


Telephone [414] 476.9500 =acsimile [414] 476.8582


205 W. Highlan 05 W. Highland Avenue Suite 400 Milwaukee, WI 53203 Telephone [414] 276.1889 Facsimile [414] 765.8728


ARCHITECTURAL STUDIOS, INC.


arwood Avenue kee, WI 53213

OR TO THE

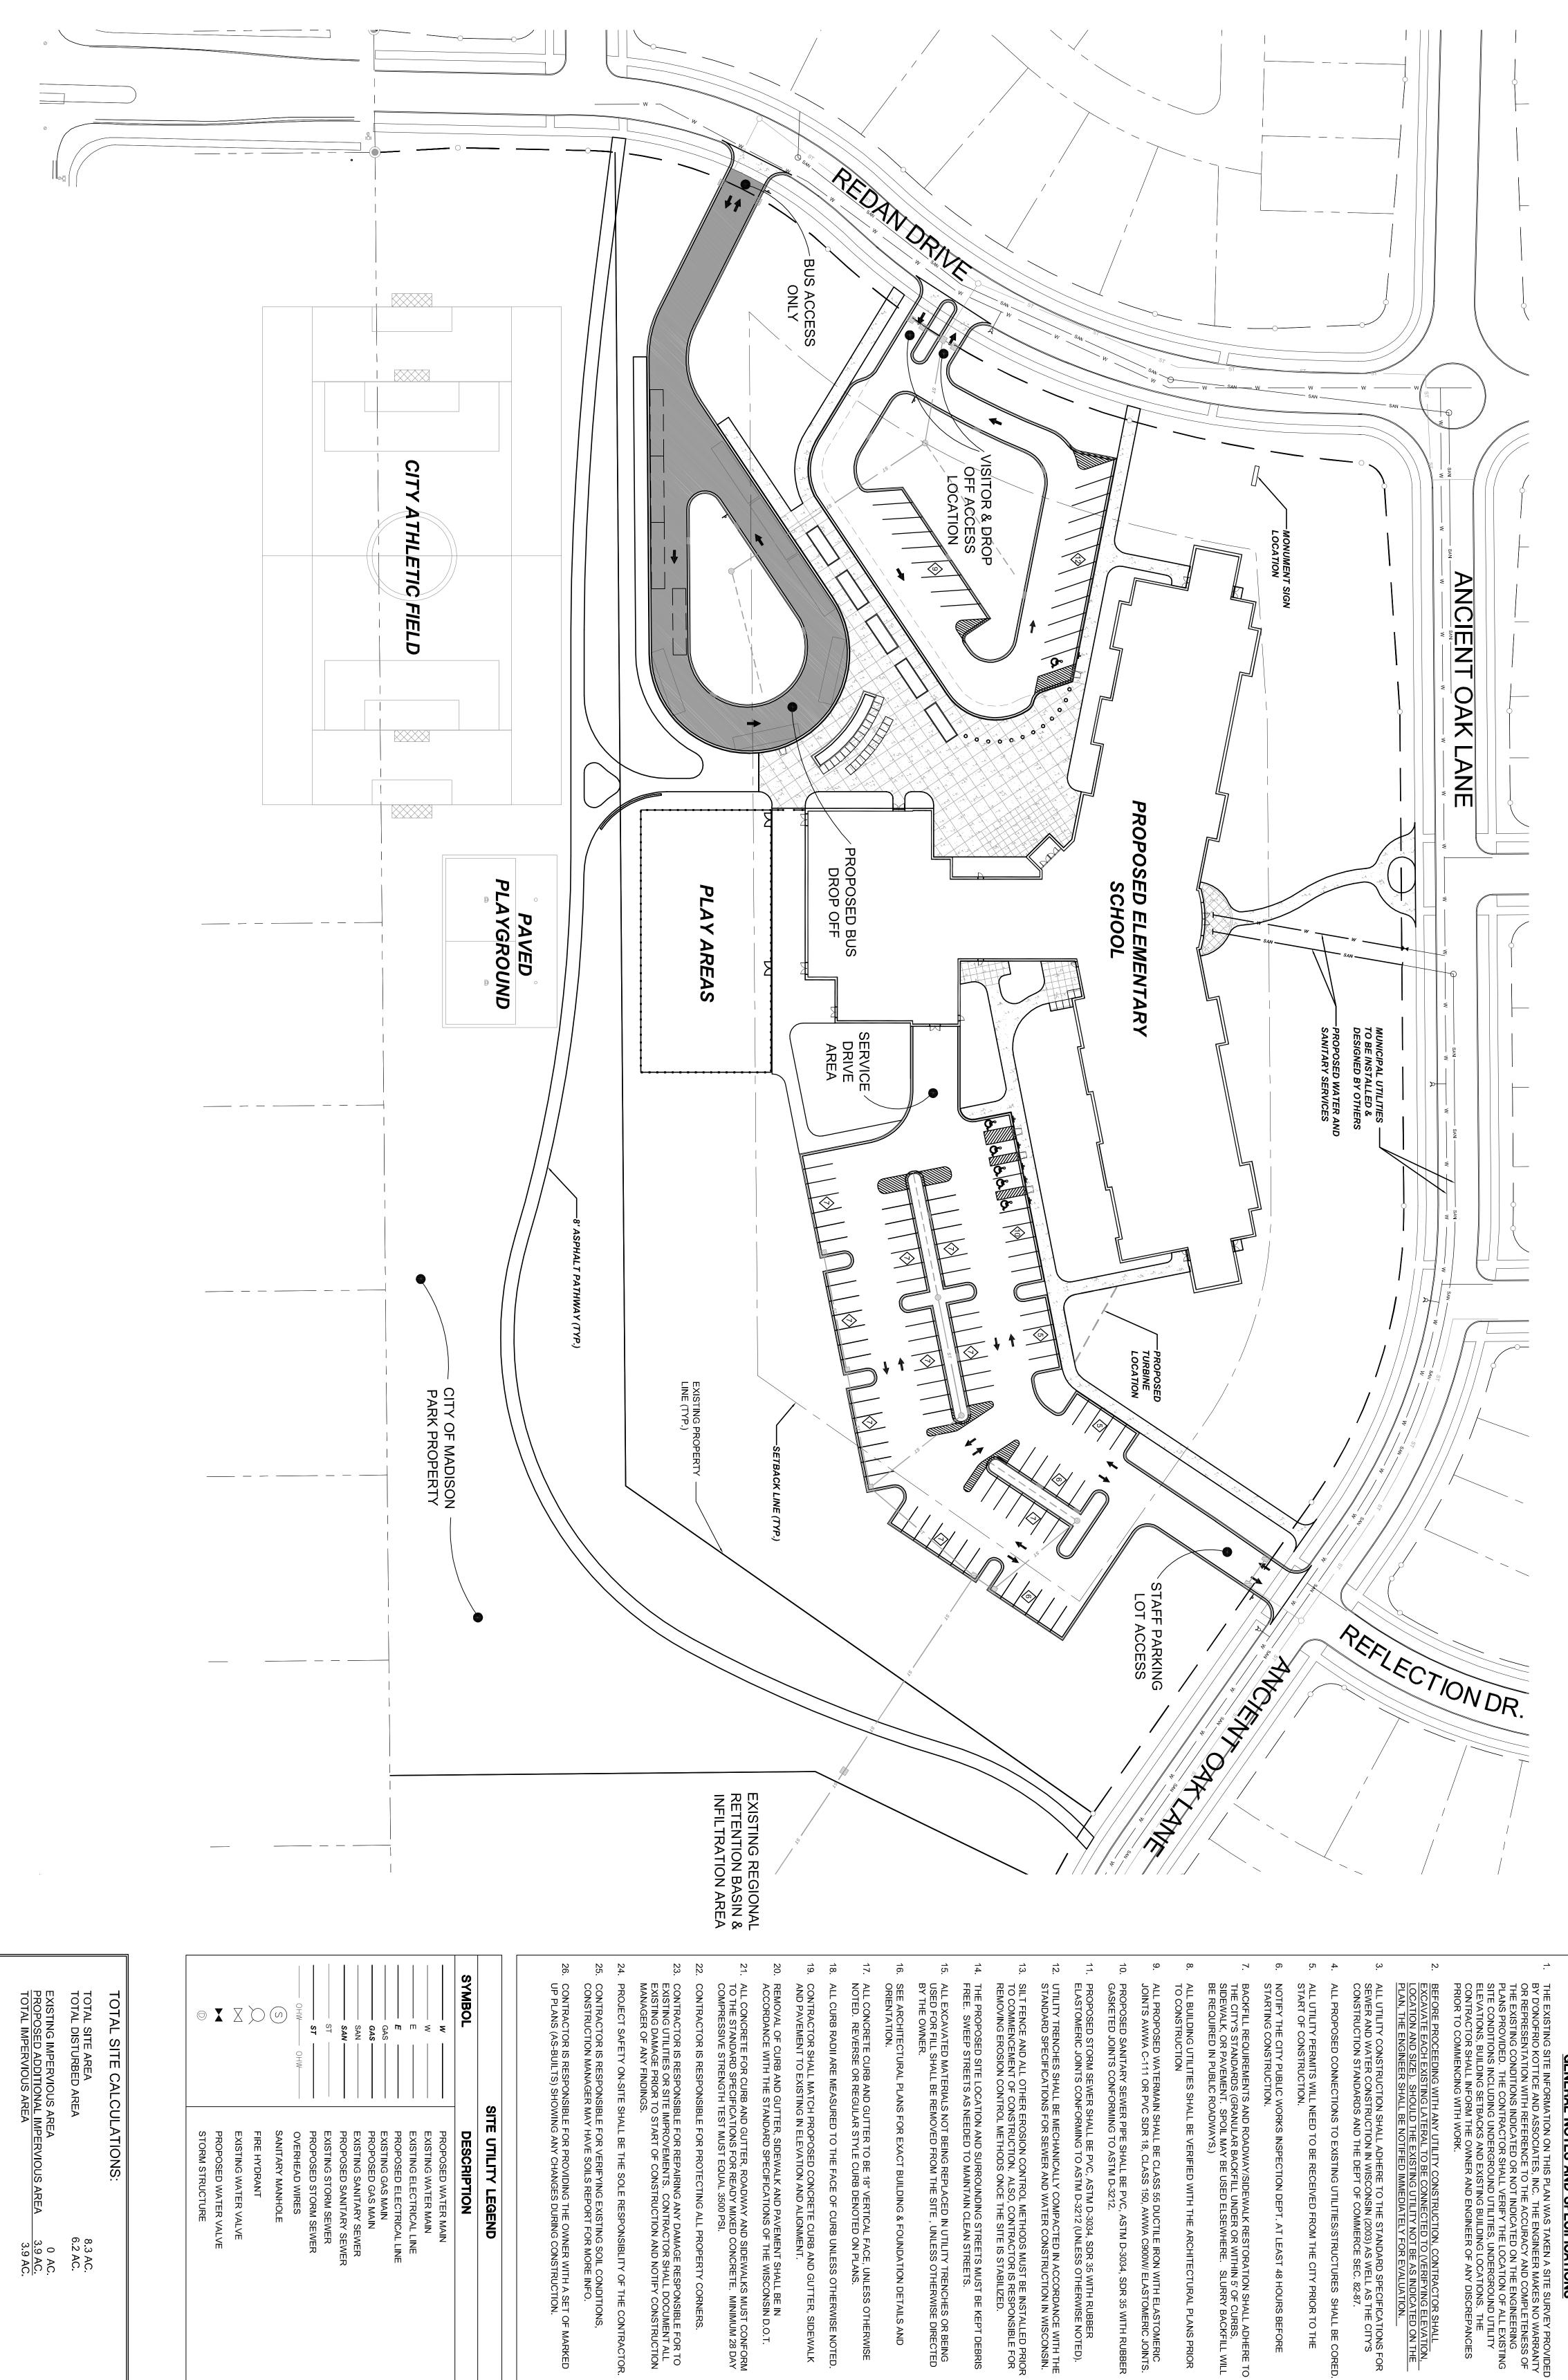

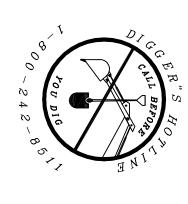

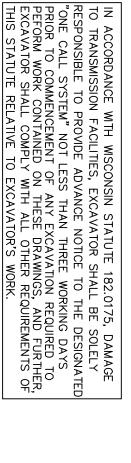

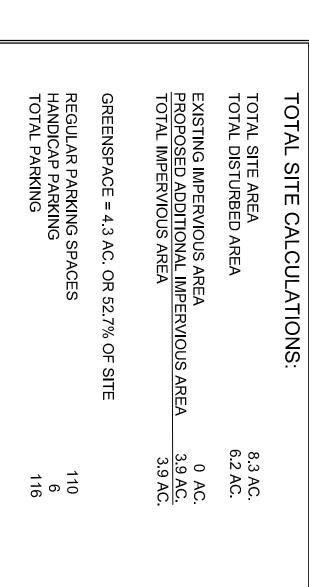

Scale: 1" = 40'-0"


Date: 11/29/06 1/3/07


Madison - UDC Informational Submittal


Madison - UDC Initial Approval Submittal


Madison - Plan Commission Submittal

(0	SITE UTILITY LEGEND
SYMBOL	DESCRIPTION
	PROPOSED WATER MAIN
W	EXISTING WATER MAIN
       	EXISTING ELECTRICAL LINE
E	PROPOSED ELECTRICAL LINE
GAS	EXISTING GAS MAIN
GAS	PROPOSED GAS MAIN
SAN	EXISTING SANITARY SEWER
SAN	PROPOSED SANITARY SEWER
TST	EXISTING STORM SEWER
ST	PROPOSED STORM SEWER
ОНWОНW	OVERHEAD WIRES
S	SANITARY MANHOLE
<u>&gt;</u>	FIRE HYDRANT
$\boxtimes$	EXISTING WATER VALVE
X	PROPOSED WATER VALVE
0	STORM STRUCTURE

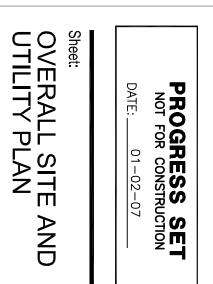

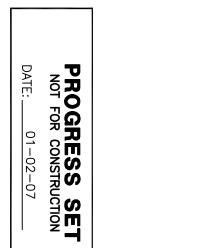

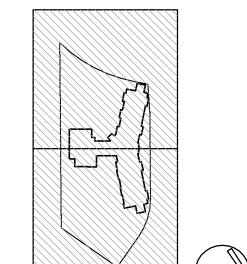

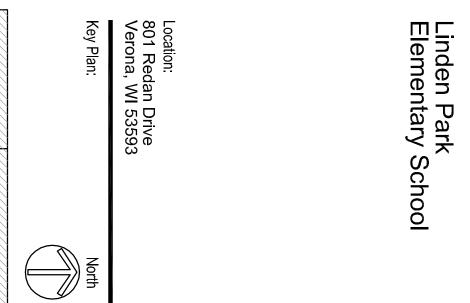



DATION DETAILS AND

7420 West Stat 414.475.5554 <i>-</i> HE(			Consultant:
7420 West State Street Milwaukee Wiscor 414.475.5554 414.475.5698 fax harwood@ HEC Project Number: 06-0092.00	ENGINEERING CONSULTANTS	HARWOOD	

S, LTD onsin 53213 @hecl.com

Telephone [414] 476.9500 Facsimile [414] 476.8582 arwood Avenue kee, WI 53213 205 W. Highland Avenue Suite 400 Milwaukee, WI 53203 Telephone [414] 276.1889 Facsimile [414] 765.8728


RIFIED WITH THE ARCHITECTURAL PLANS PRI

ARCHITECTURAL STUDIOS, INC.


GENERAL NOTES AND SPECIFICATIONS

Project No.: 060092.00 et No.


January 3, 2007

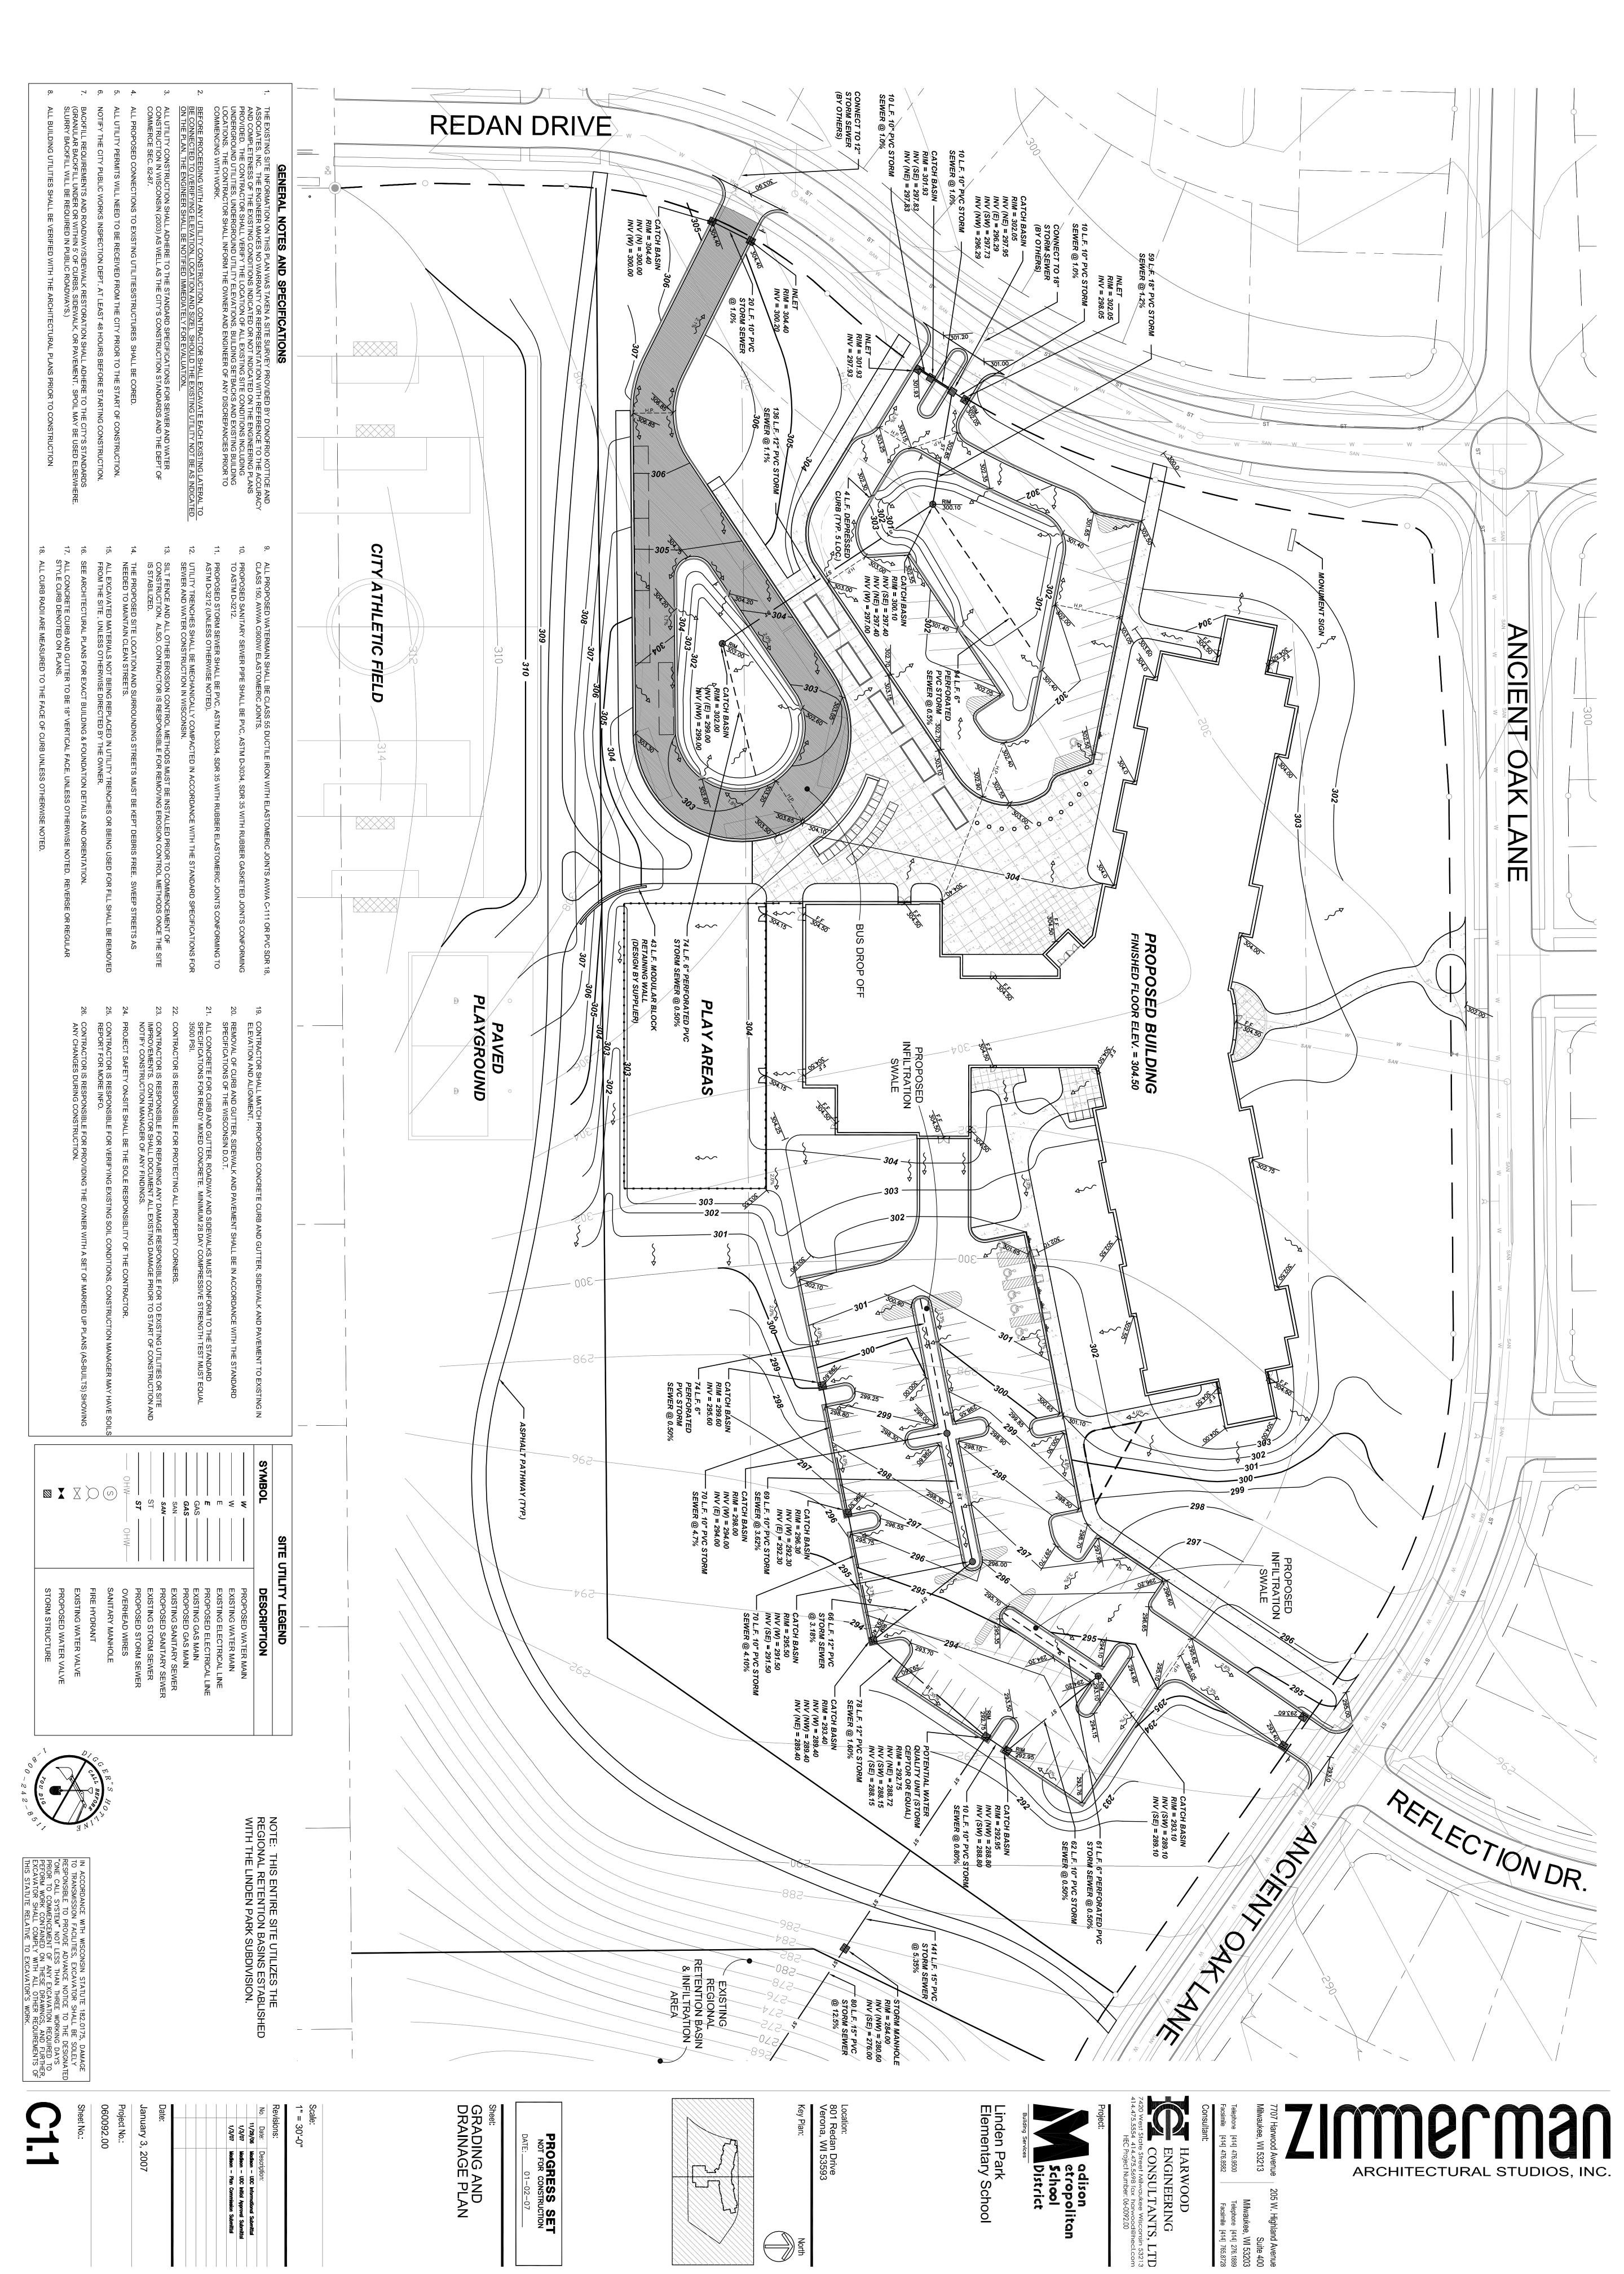


H:\DWGS\2006\06-0092\E\CITY REVIEW\07-01-03\06-0092.00\_CRE1.1.dwg, 1/2/2007 10:59:25 AM, \\HECSR1\PDF

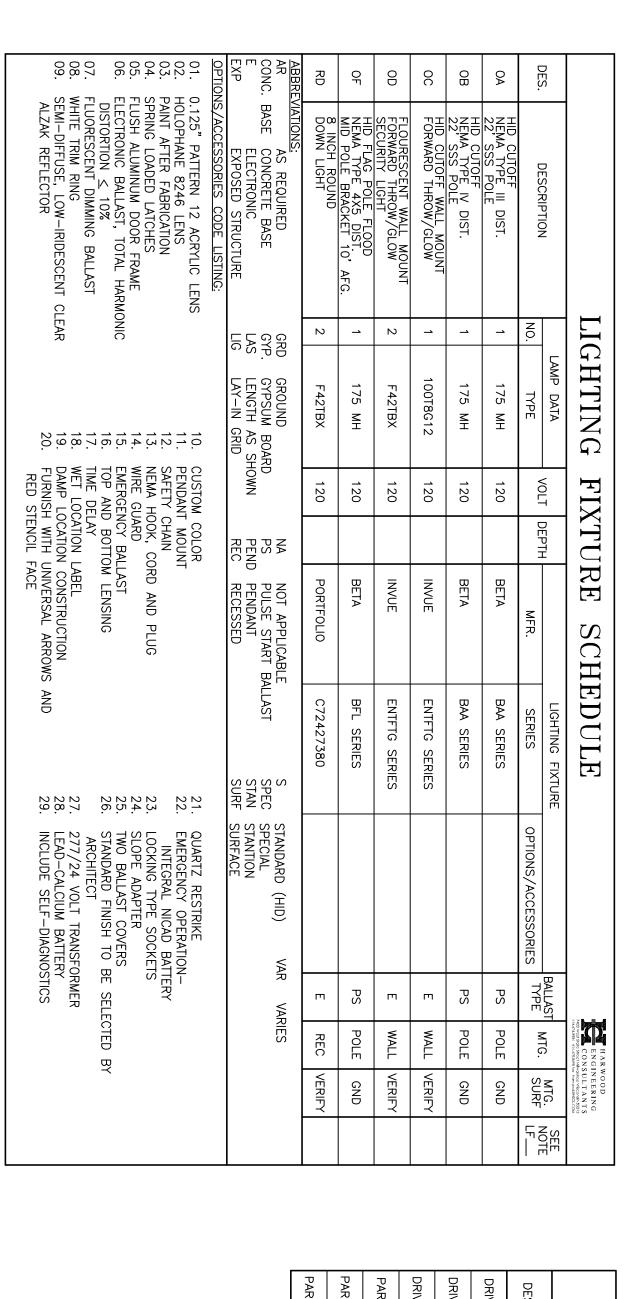


DRIVE NORTHWEST       1.0 fc       0.2 fc       5.0:1         DRIVE SOUTHWEST       0.9 fc       0.4 fc       2.3:1         PARKING EAST       1.4 fc       0.5 fc       2.8:1         PARKING NORTHWEST       1.4 fc       0.4 fc       3.5:1         PARKING SOUTHWEST       1.0 fc       0.2 fc       5.0:1	LIGHTING STATISTICS  DESCRIPTION AVG. MIN.  DRIVE EAST 0.9 fc 0.3 fc	HTII AVG.			AVG./MIN. 5.0:1
0.9 fc 0.4 fc 1.4 fc 0.5 fc 1.4 fc 0.4 fc 1.0 fc 0.2 fc	DRIVE NORTHWEST	1.0 1		).2 fc	
1.4 fc 0.5 fc 1.4 fc 0.4 fc 1.0 fc 0.2 fc	DRIVE SOUTHWEST	0.9		).4 fc	N
1.4 fc 0.4 fc 1.0 fc 0.2 fc	PARKING EAST	1.4		).5 fc	N
1.0 fc 0.2 fc	PARKING NORTHWES			).4 fc	W
	PARKING SOUTHWES		fc C	).2 fc	ڻ ن

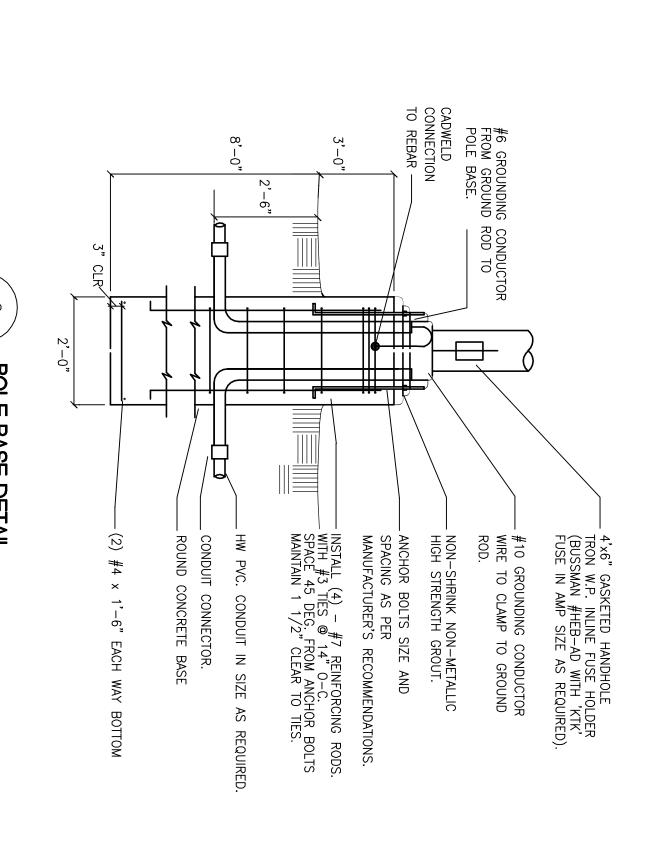



Electrical Site Plan

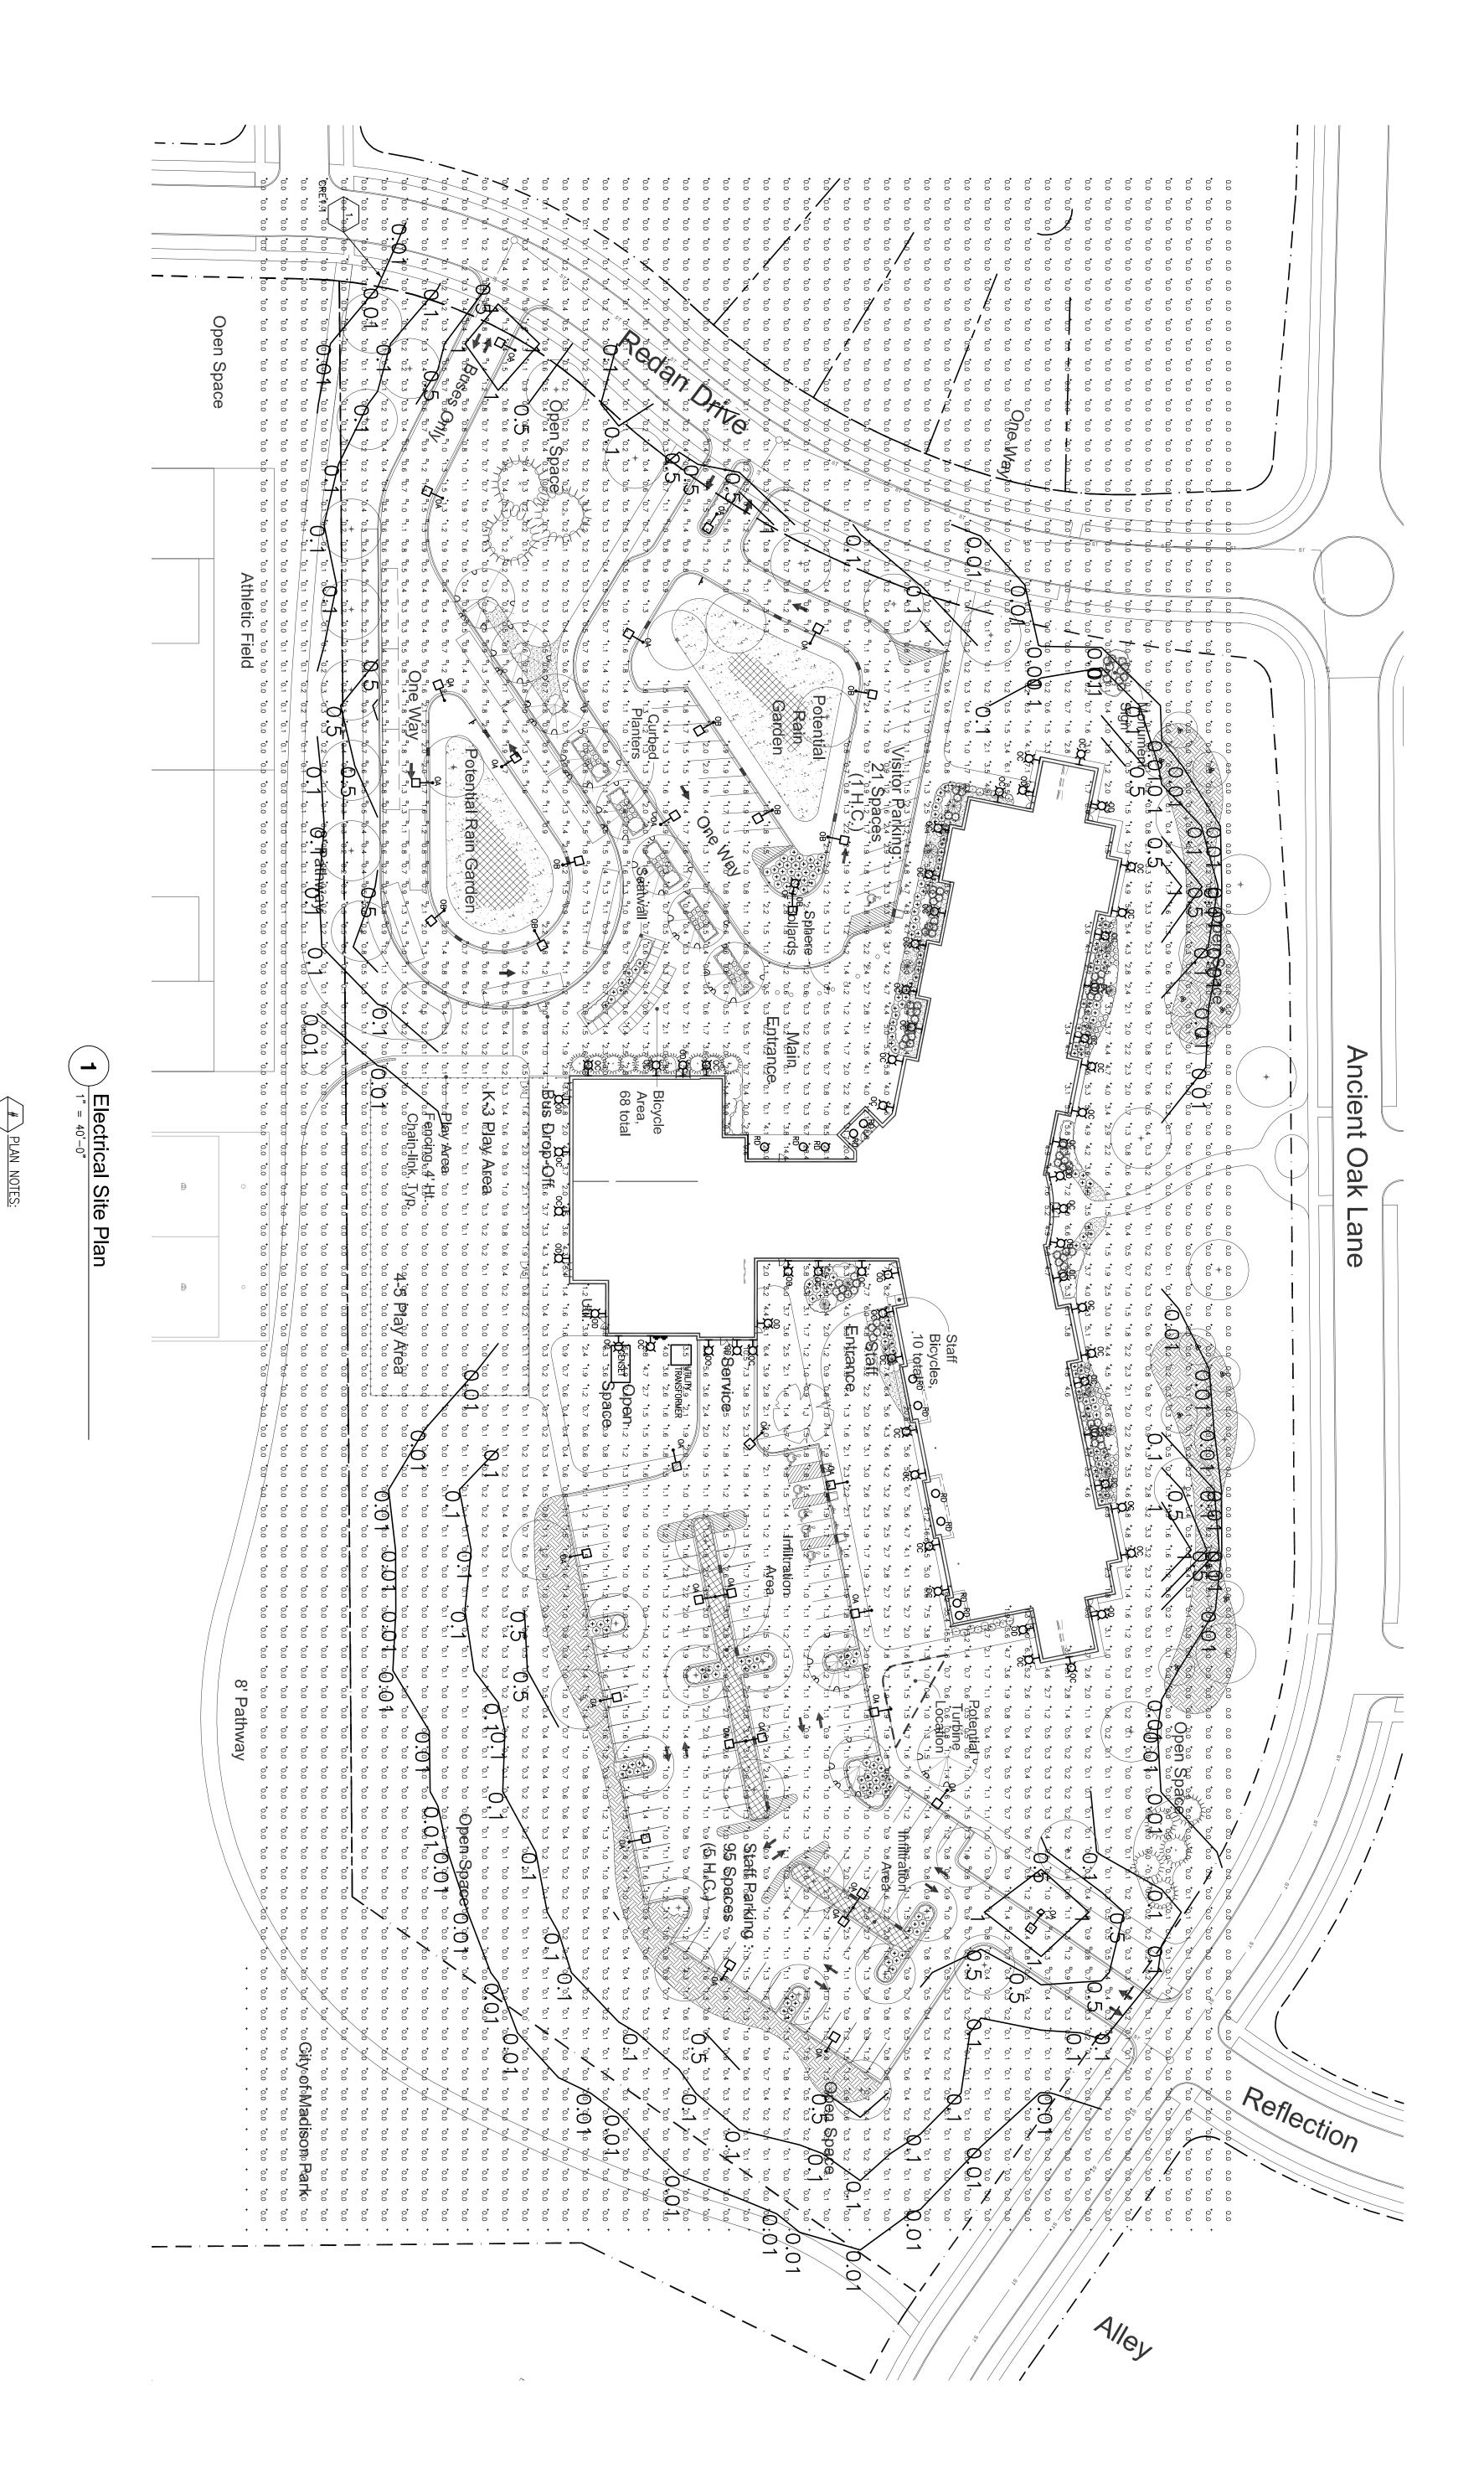


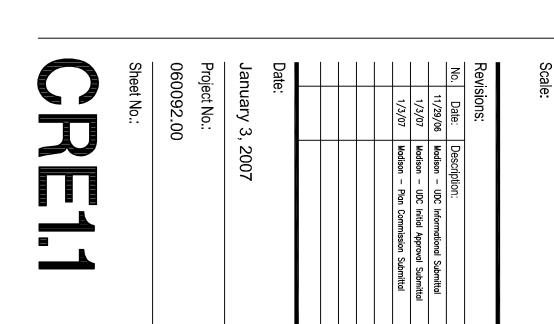


NOTES: 1. DIMENSIONS GIVEN ARE MINIMUM. PROVIDE POLE BASE DIAMETER AND DEPTH AS REQUIRED IN ACCORDANCE WITH LOCAL SOIL AND WIND VELOCITY

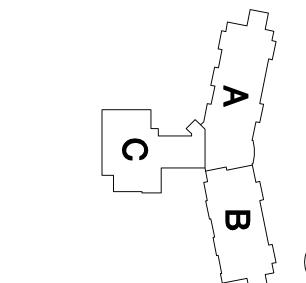

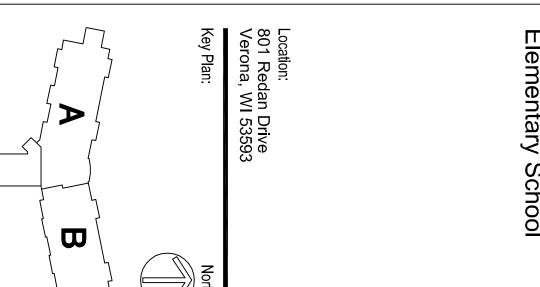

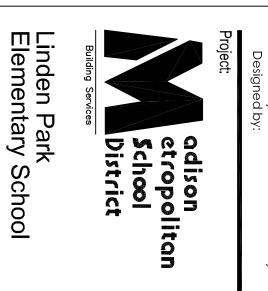

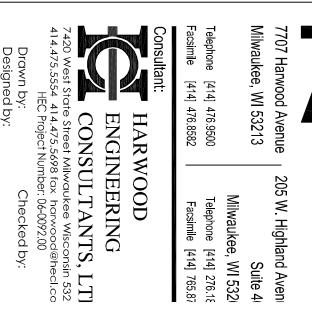

Telephone [414] 476.9500

Telephone [414] 476.9500

Telephone [414] 476.9500

Telephone [414] 476.9500



PARKING SPACES:
SPACES REQUIRED
SPACES PROVIDED
FACULTY/STAFF

STUDENTS

650 90 740

**FOTAL BUILDING OCCUPANTS:** 

SECOND FLOOR

50,141 S.F. 39,779 S.F. 89,920 S.F.

E (NEW ELEMENTARY SCHOOL)

HOURS OF OPERATION: SITE ACREAGE:

VISITOR

95 (5 ACCESSIBLE, INCLUDING 1 VAN) 21 (1 ACCESSIBLE) M-F 6:00 A.M. TO 10:00 P.M. 8.3 ACRES

45 (ONE PARKING SPACE FOR EVERY TWO (2) EMPLOYEES) 116



CHARACTER STUDY

CLASSROOM WING

ENTRY

# CONCEPTUAL DESIGN

- The proposed school responds to the layout of the Linden Park neighborhood and complements the new, adjacent city park The building has approximately 90,000 square feet
- The school will be environmentally friendly, meeting the LEED (Leadership in Energy and
- Environmental Design) "silver" standard.
- provides ample daylight and allows good views down the hil The school's central wing houses the larger common space:
- The school will have five classrooms each for kindergarten through fifth grade. These grade levels are paired (K-1, 2-3, 4-5) with flexible resource rooms provided in each wing.

  The first floor of the west wing contains other shared spaces: art and music rooms, the REACH classroom, and the office

PROJECT INFORMATION
BUILDING USE:
TOTAL BUILDING GROSS SQ. FT.:
FIRST FLOOR



Linden Park Elementary School

Revisions:
Revisions:
No. Date: Descriptor:
IV/AVV Makes - 002 Monates Sandad
VANV Makes - 002 Monates Sandad
VANV Makes - The Committee Sandad January 3, 2007 Sheet: Location Plan

A0.0

North