



GMP/SIP PACKAGE

# MADISON YARDS: BLOCK 2 - GROCER BASE CORE & SHELL

UNIVERSITY AVENUE AT GARDNER ROAD

KAHLER SLATER PROJECT: 219143.00

NOVEMBER 17, 2020



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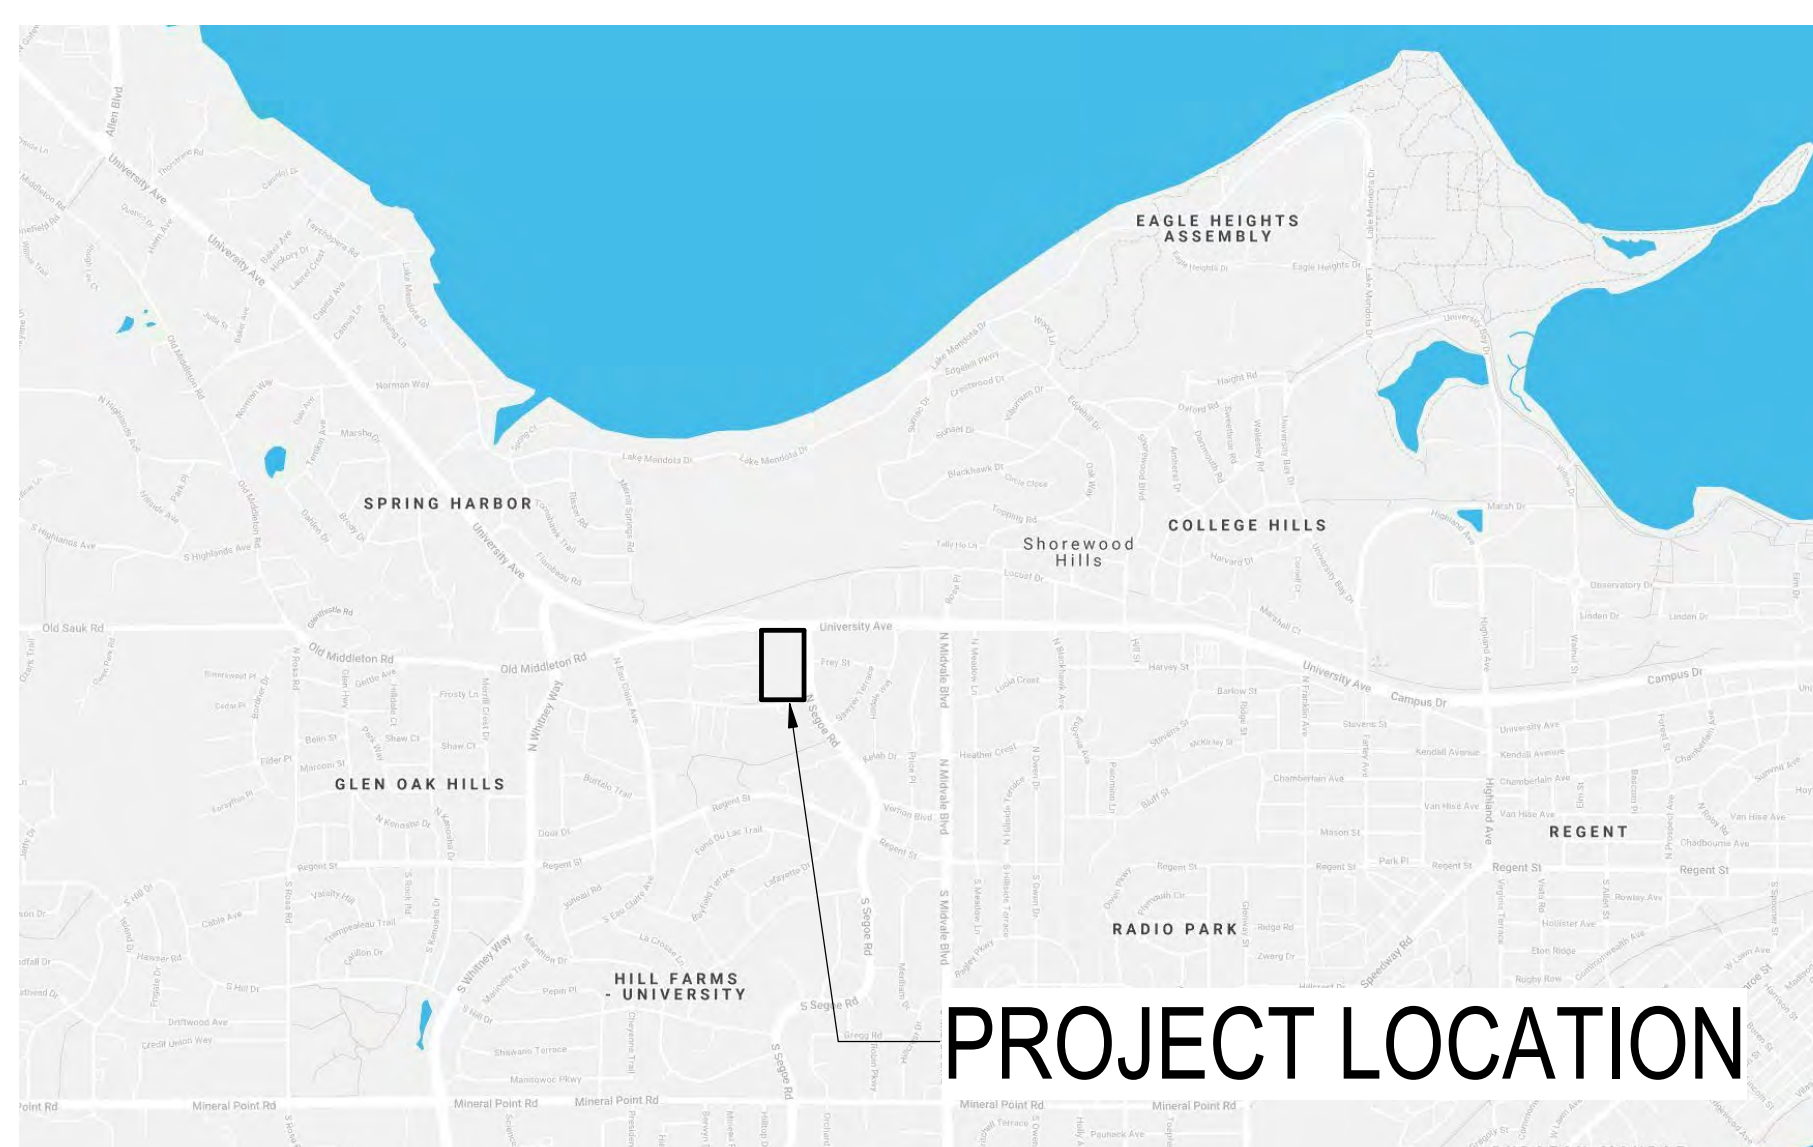
**MADISON YARDS:  
BLOCK 2 - GROCER  
BASE CORE & SHELL**  
UNIVERSITY AVENUE AT GARDNER ROAD


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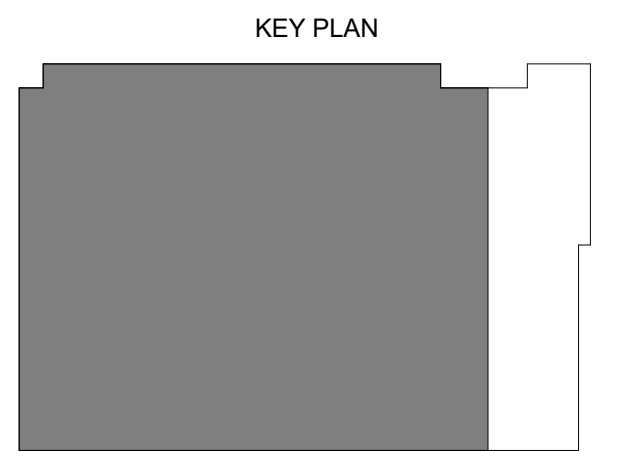
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MADISON YARDS:  
BLOCK 2 - GROCER  
BASE CORE & SHELL



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219143.00


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ARCHITECTURAL SITE PLAN

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Sheet No.  
AS-A10

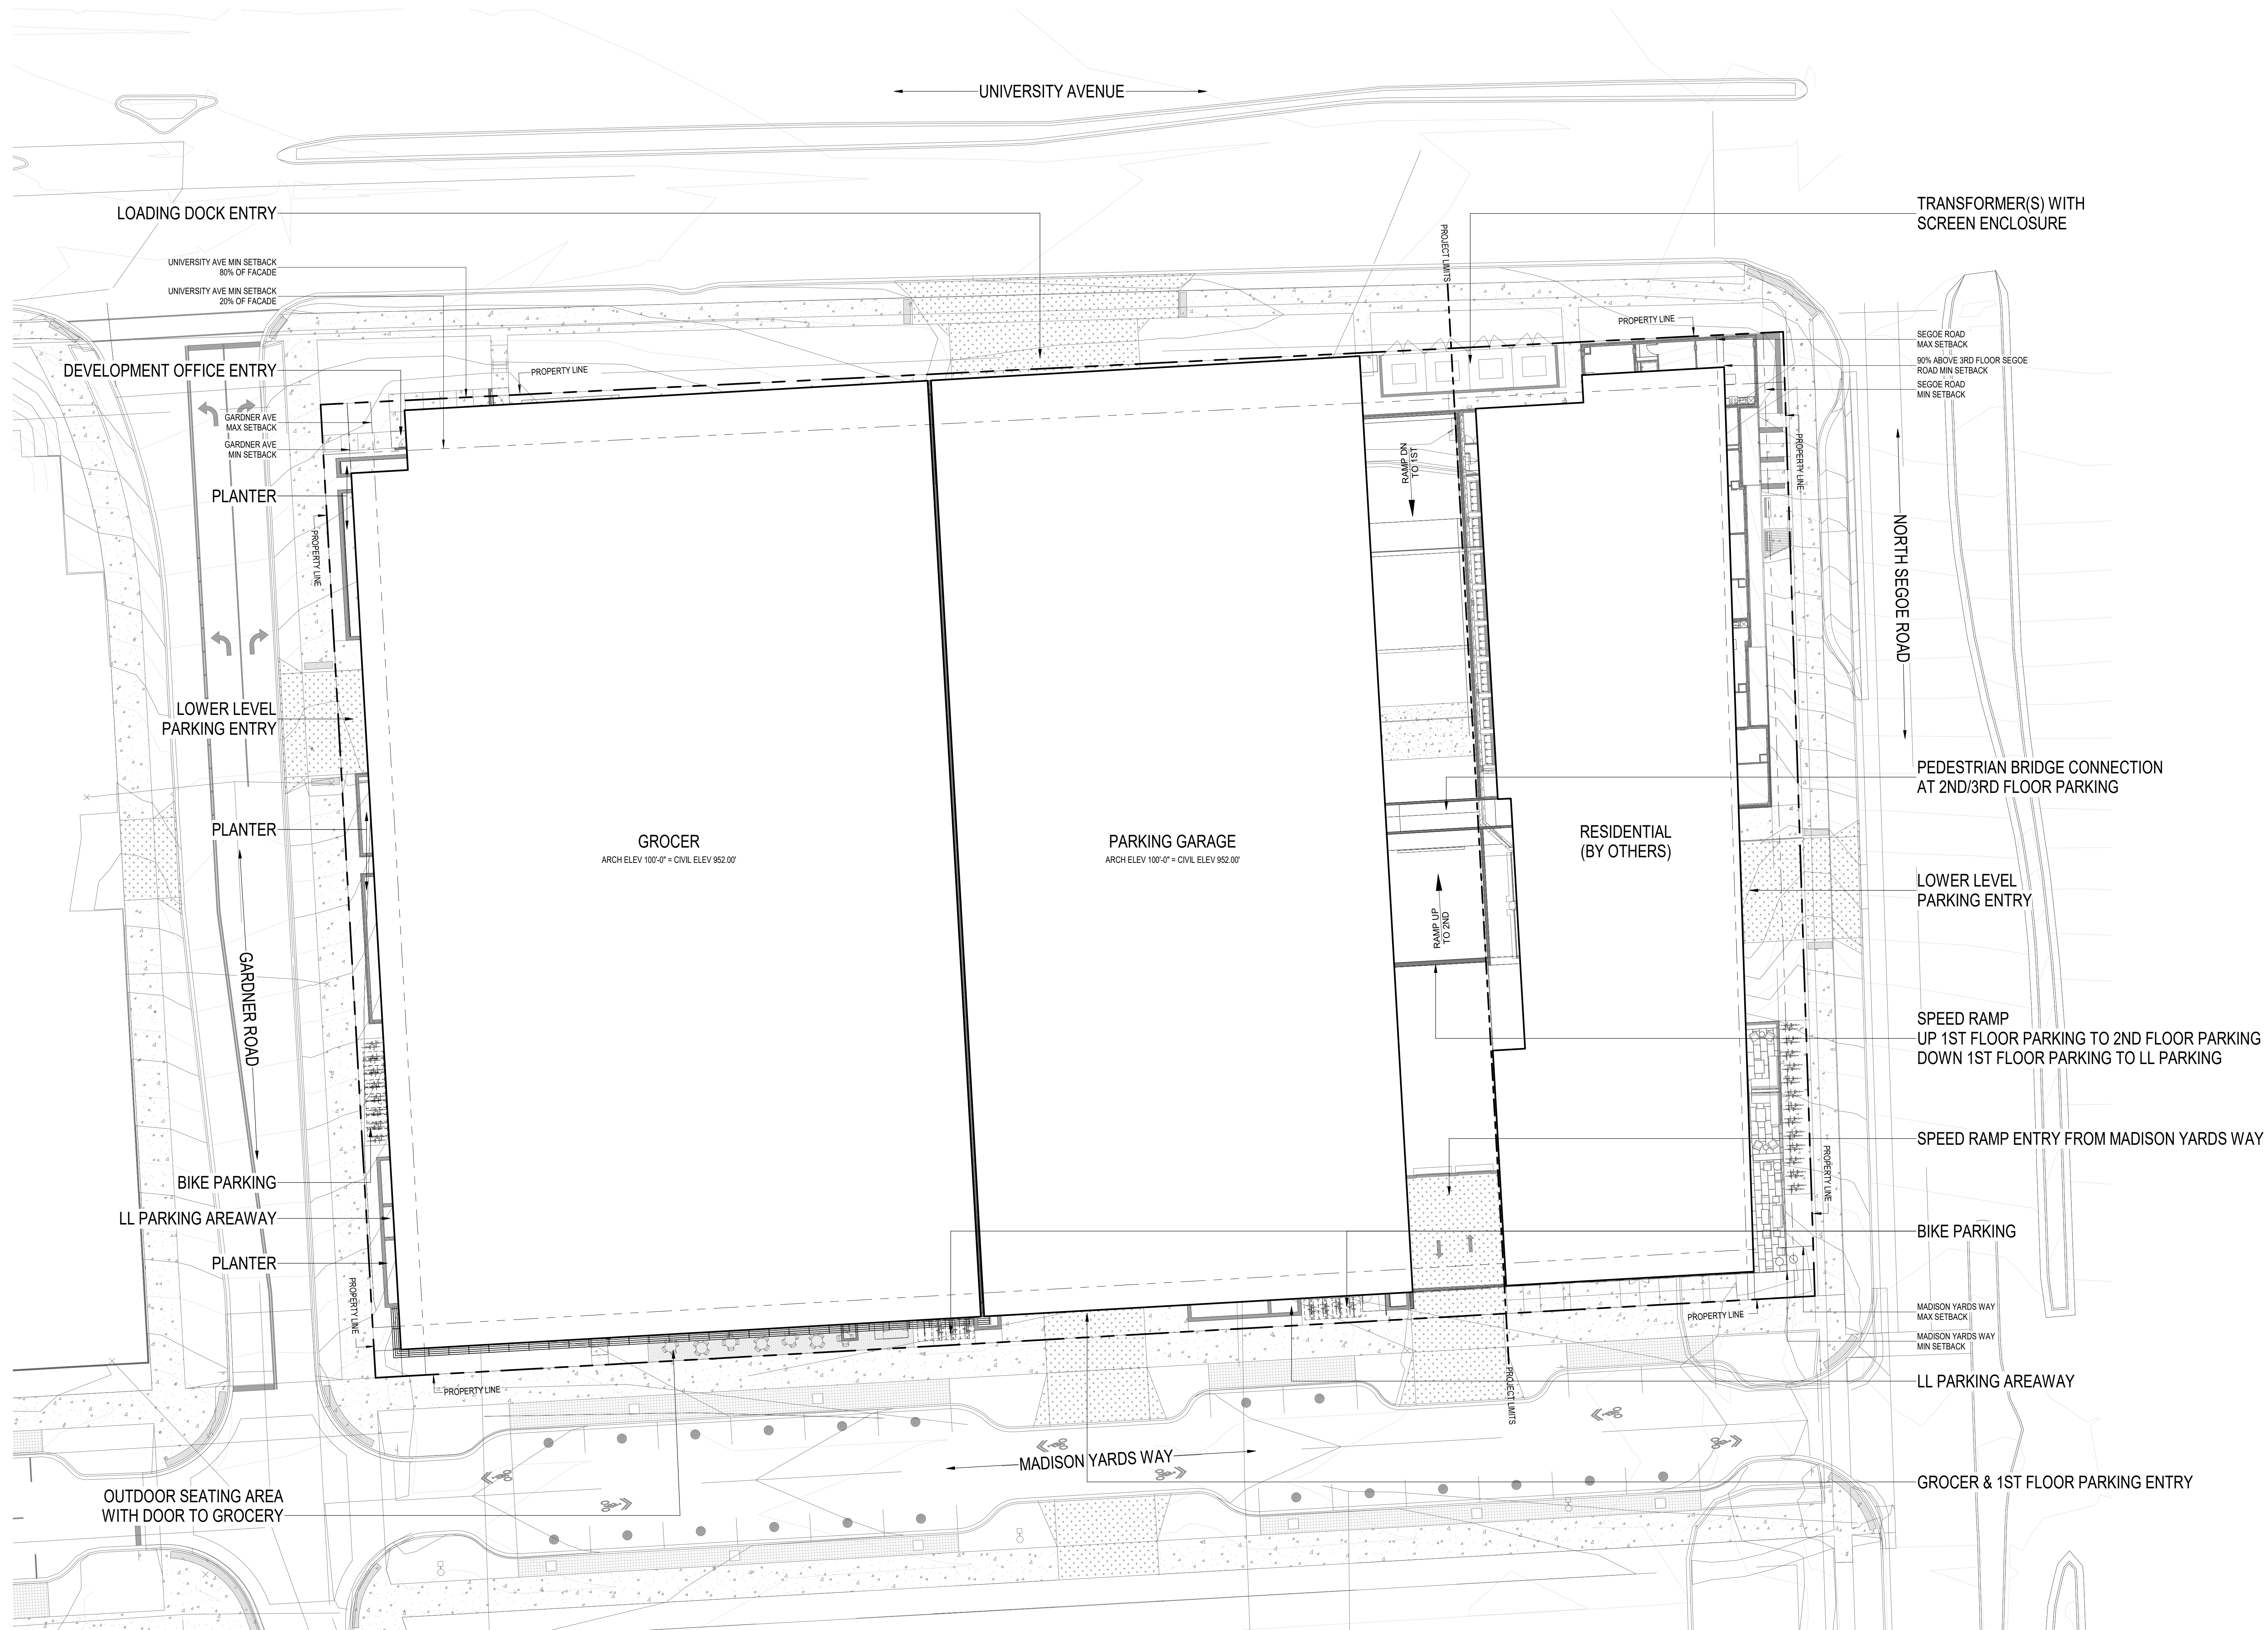

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**MADISON YARDS:  
BLOCK 2 - GROCER  
BASE CORE & SHELL**

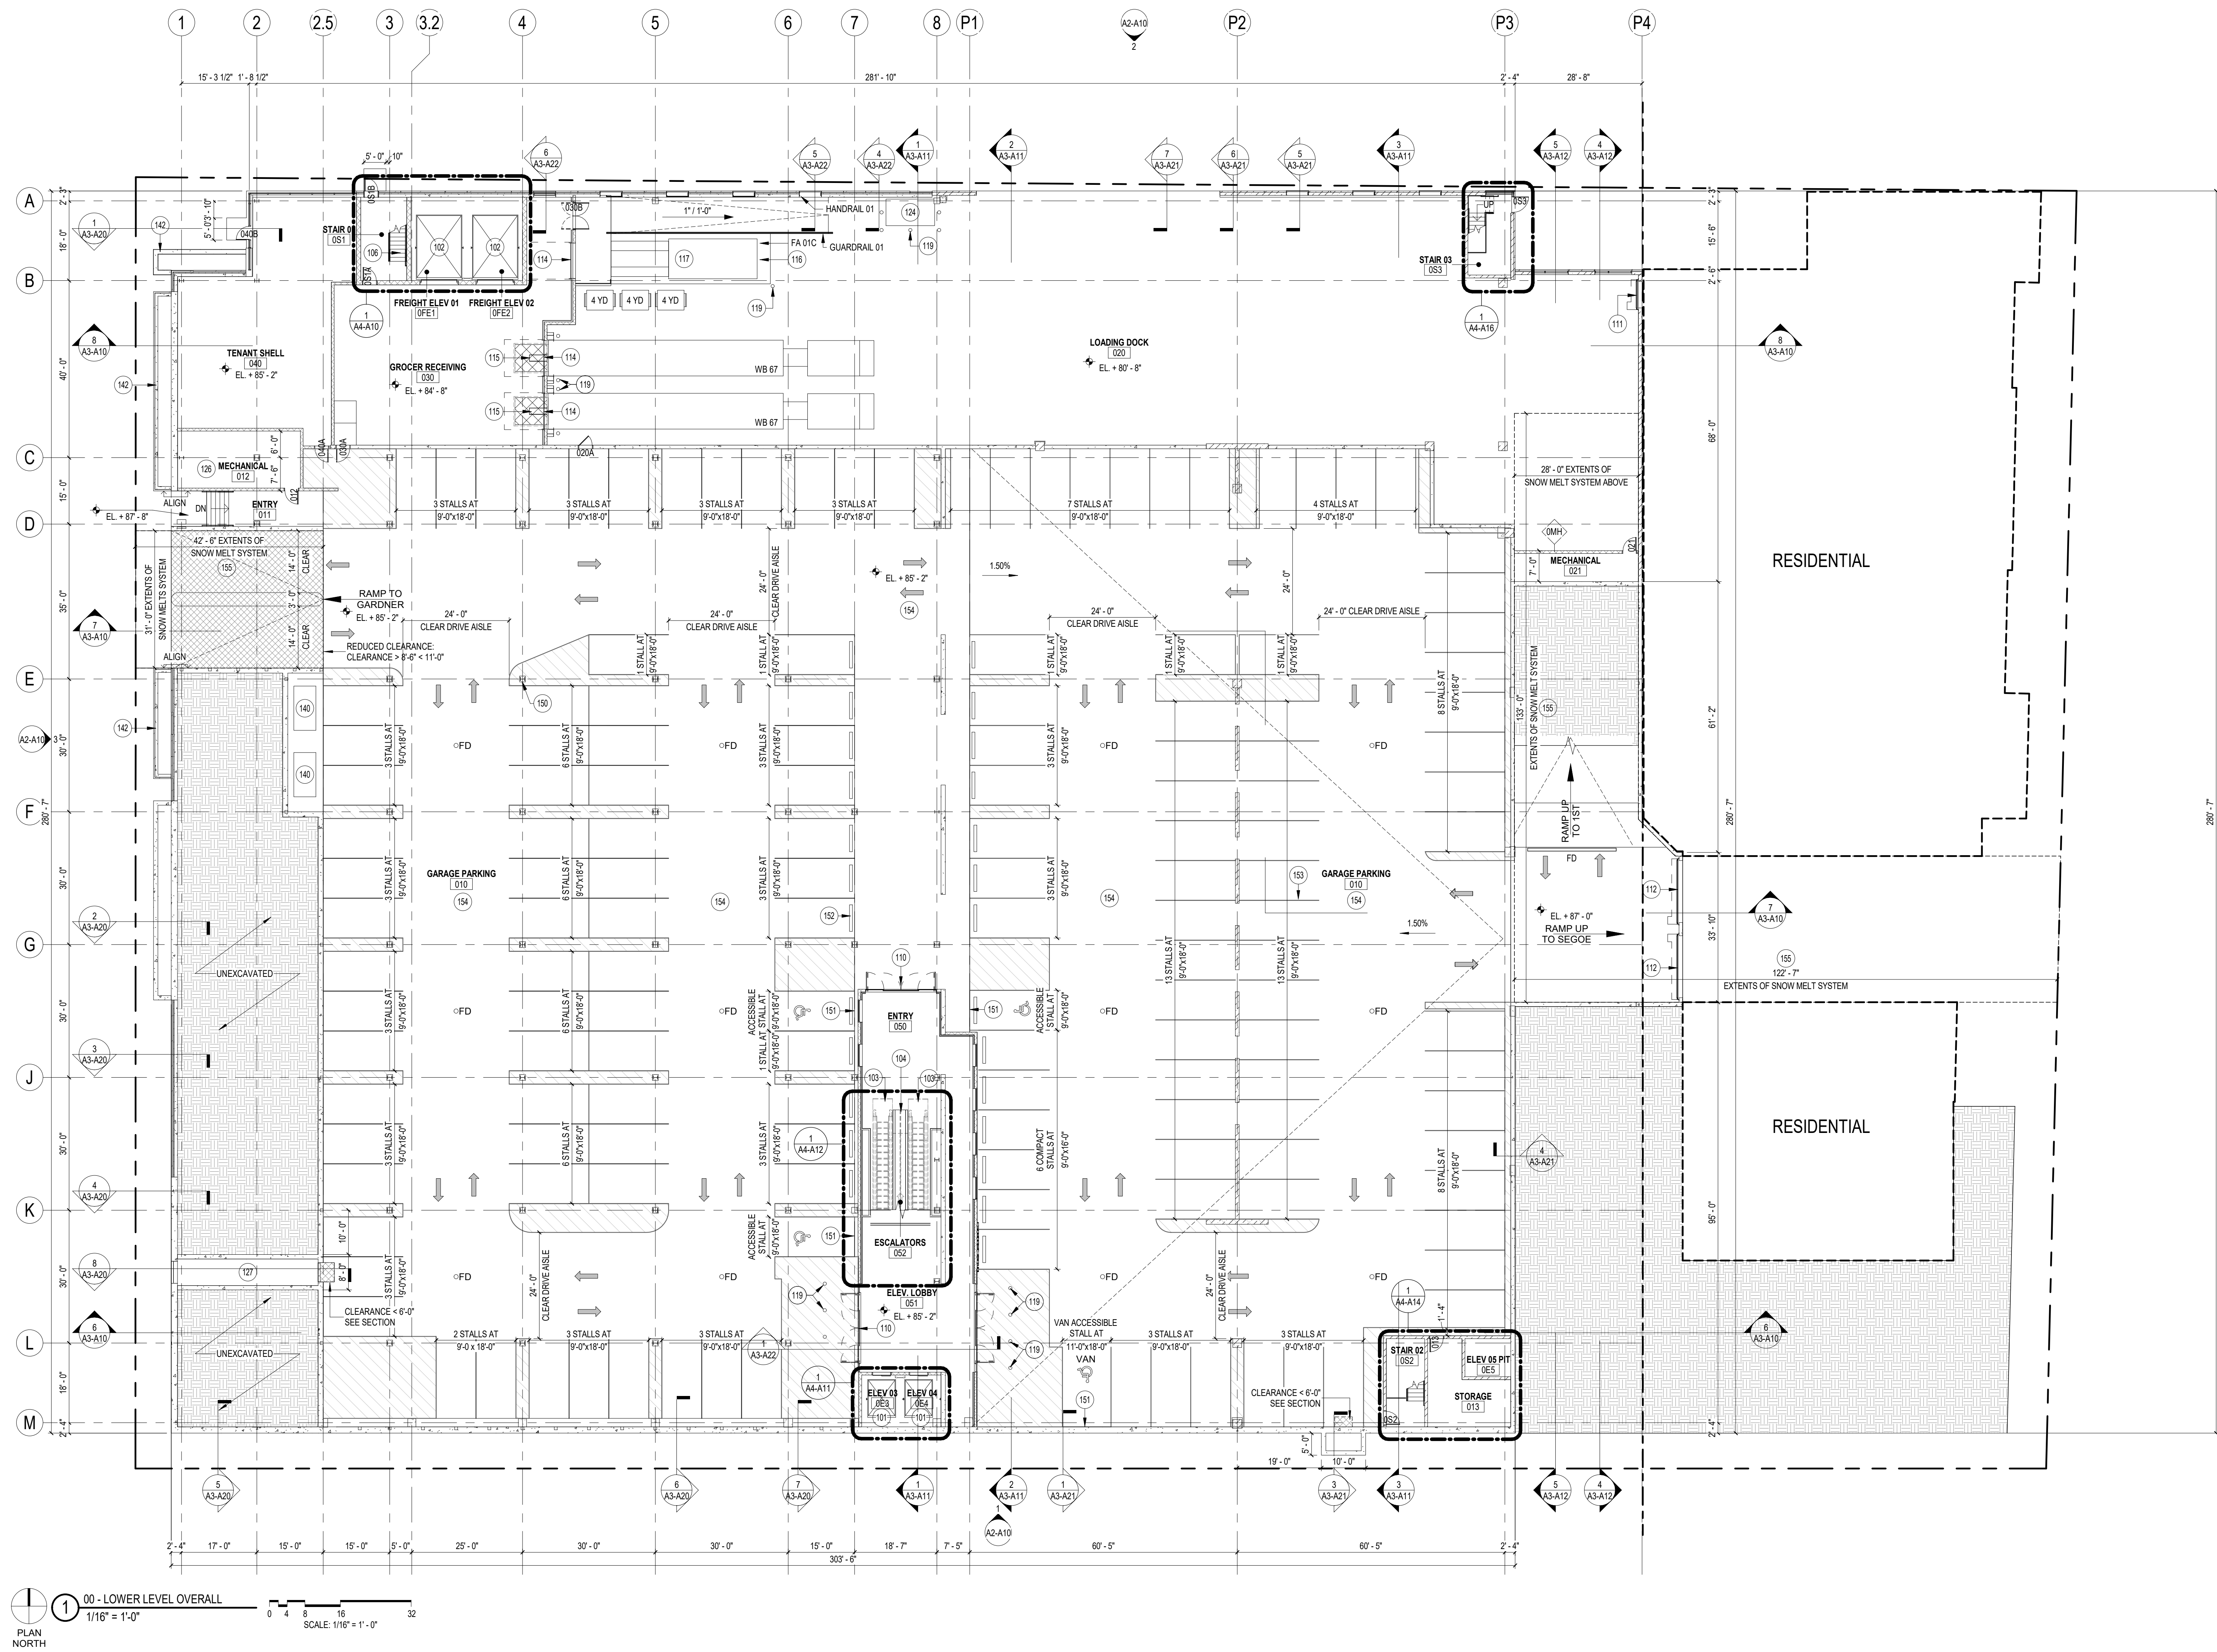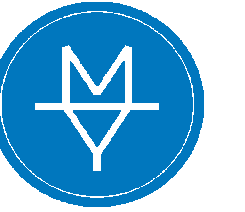UNIVERSITY AVENUE AT GARDNER ROAD

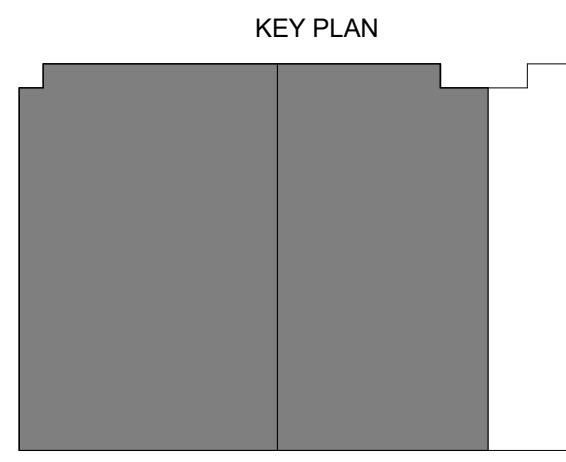Project No. SUMMIT SMITH/GILBANE  
219143.00

Sheet Title

**LOWER LEVEL PLAN**

**KEYNOTES - FLOOR PLAN**

101	MACHINE ROOM LESS PASSENGER SERVICE ELEVATOR, 5000 LB CAPACITY, 200 FPM, BASIS OF DESIGN: OTIS GEN2
102	FREIGHT ELEVATOR, 12,000 LB CAPACITY, 10'W x 14'D x 10'H
103	ESCALATOR, BASIS OF DESIGN THYSSENKRUPP VELINO
104	CART CONVERTING SYSTEM, SINGLE DOWNWARD TRACK, BASIS OF DESIGN: CARTVEYOR BY PFLOW INDUSTRIES
105	CONCRETE FLEED GALVANIZED STEEL STAIRS
110	16'-0" WIDE X 8'-5" HIGH AUTOMATIC SLIDING DOOR, BASIS OF DESIGN: BESAM
111	6'-0" x 8'-0" 3 HOUR RATED COILING FIRE DOOR
112	14'-0" x 8'-0" 3 HOUR RATED COILING FIRE DOOR
114	9'-0" x 10'-0" INSULATED SECTIONAL OVERHEAD DOOR, PROVIDE ELECTRONIC OPERATORS, MANUAL CHAIN HOIST OVERRIDE AND VISION PANELS
116	RAISED CONCRETE PLATFORM WITH IMBEDDED GALVANIZED STEEL SKID PLATES FOR TRASH COMPACTOR, COORDINATE SIZE AND ELEVATION WITH TENANT.
117	TRASH COMPACTOR, COORDINATE REQUIRED SIZE AND PROVIDER WITH TENANT.

**KEYNOTES - FLOOR PLAN**

119	6" DIAMETER CONCRETE FILLED BOLLARD
124	GENERATOR - VERIFY REQUIREMENTS w/ELECTRICAL
126	ROOM TO INCLUDE FIRE PROTECTION RISERS, WATER METER, FIRE DEPARTMENT CONNECTION & BACKFLOW PREVENTER, VERIFY REQUIREMENTS w/ELECTRICAL
127	AREAWAY w/GRATE, VERIFY REQUIREMENTS w/MECHANICAL
140	GREASE TRAPS, CHAINLINK FENCE w/ GATE
142	BUILT IN PLANTER - LINE WITH SHEET WATERPROOFING AND 2" EXTRUDED POLYSTYRENE INSULATION, PROVIDE 12" GARVEL BASE AND FILTER FABRIC AT BOTTOM OF PLANTER, FILL REMAINDER OF PLANTER WITH TOP SOIL, HOLD INSULATION 2" MIN. BELOW GRADE
150	CONCRETE ENCASED STEEL COLUMN, 1 HOUR FIRE RATED MINIMUM, TYPICAL
151	HANDICAP STALL SIGNAGE
152	PARKING BUMPER, TYPICAL
153	4" HEAVY DUTY, DURABLE WHITE, 2 COAT STRIPING TYPICAL
154	TRAFFIC BEARING MEMBRANE COATING
155	SNOW MELT SYSTEM - COORDINATE DESIGN BUILD MEP

**PARKING MATRIX - GROCER**

STALL TYPE	NO. OF STALLS
LOWER LEVEL (PARKING)	
ACCESSIBLE PARKING STALL	3
COMPACT PARKING STALL	6
STANDARD PARKING STALL	139
VAN ACCESSIBLE PARKING STALL	1
TOTAL STALLS	239

**PARKING MATRIX - RESIDENTIAL**

STALL TYPE	NO. OF STALLS
2ND FLOOR (PARKING)	
ACCESSIBLE PARKING STALL	2
STANDARD PARKING STALL	69
VAN ACCESSIBLE PARKING STALL	2
3RD FLOOR (PARKING)	
ACCESSIBLE PARKING STALL	2
STANDARD PARKING STALL	100
VAN ACCESSIBLE PARKING STALL	2
4TH FLOOR (PARKING)	
STANDARD PARKING STALL	108
5.5 FLOOR (PARKING)	
STANDARD PARKING STALL	30
TOTAL STALLS	313

**FLOOR PLAN SYMBOL LEGEND**

ALIGN	ALIGN FACE OF INDICATED ELEMENTS
PLAN KEYNOTE	SEE KEYNOTE LEGEND
FEC	FIRE EXTINGUISHER CABINET (FEC)
FE	FIRE EXTINGUISHER (FE)
RD	ROOF DRAIN
FD	FLOOR DRAIN
SKYLIGHT	SKYLIGHT




- FLOOR PLAN GENERAL NOTES**
- VERIFY DIMENSIONS, CONDITIONS, AND FINISHES PRIOR TO PRICING OR PROCEEDING WITH WORK.
  - DO NOT SCALE FROM DRAWINGS. BRING ANY DISCREPANCIES TO ARCHITECT'S ATTENTION IMMEDIATELY.
  - COORDINATE LOCATIONS AND QUANTITY OF WORK WITH MECHANICAL, ELECTRICAL AND PLUMBING CONTRACTORS.
  - REFER TO PARTITION SCHEDULE ON G005 FOR TYPICAL PARTITION TYPES, STAIRS, ELEVATORS, MECHANICAL AND OTHER SHAFT WALLS TO HAVE A 1-HOUR FIRE RATING WHERE INDICATED. TYPICAL PARTITION WALLS TO BE OHD U.N.O.
  - SLOPE ALL ROOF INSULATION 1/4" PER 1'-0" TOWARDS ROOF DRAINS PER PLAN ANNOTATIONS. MAINTAIN MINIMUM 4" INSULATION.

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**A1-A10**



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**MADISON YARDS:  
BLOCK 2 - GROCER  
BASE CORE & SHELL**  
UNIVERSITY AVENUE AT GARDNER ROAD

Project No. SUMMIT SMITH/GILBANE  
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Sheet Title  
**1ST FLOOR PLAN**
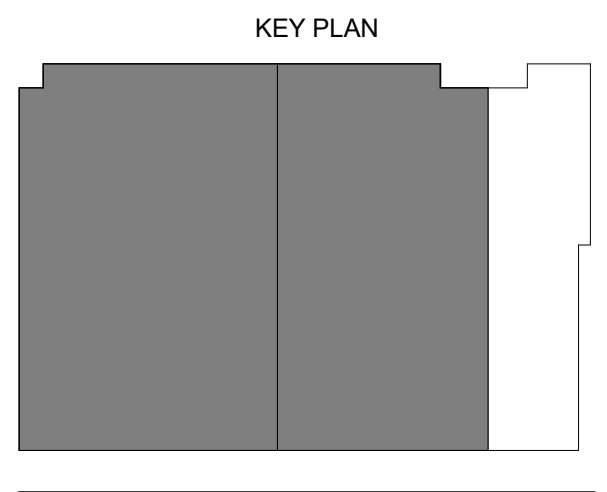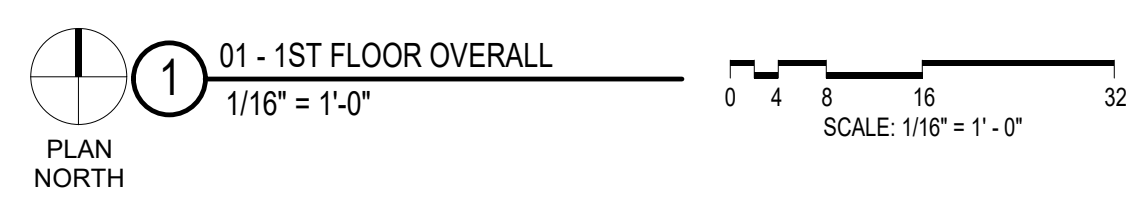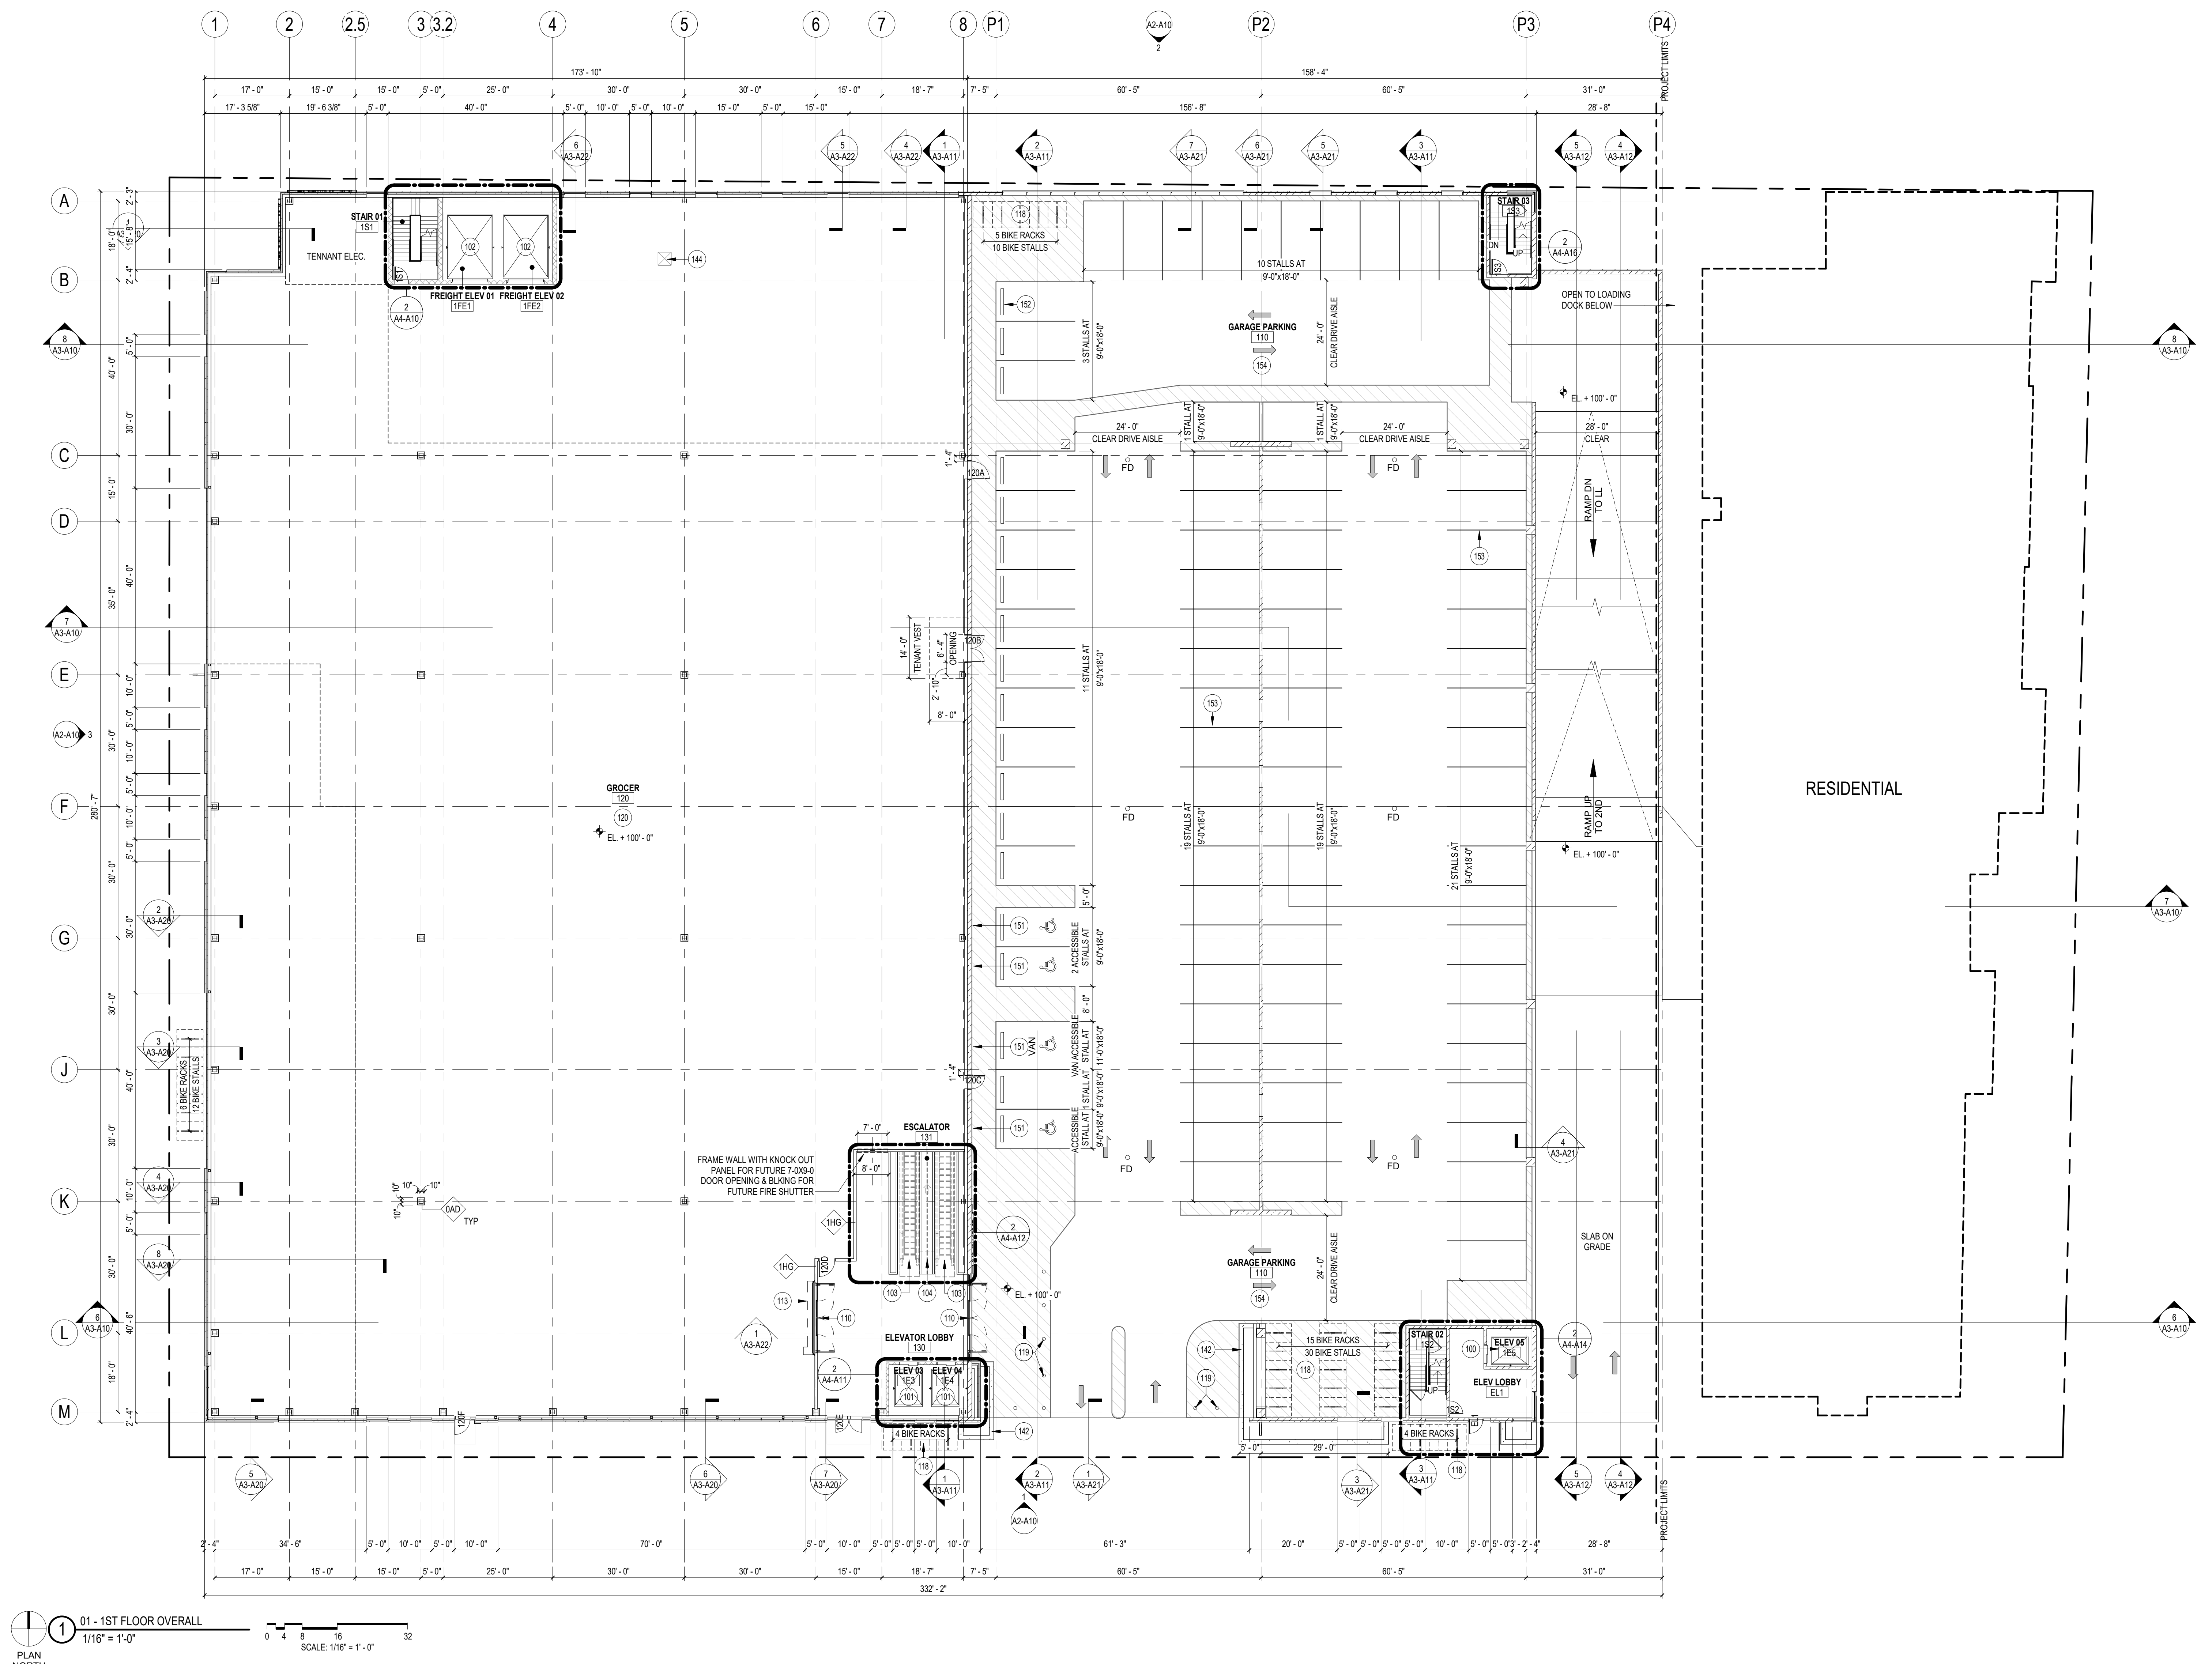
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Sheet No.  
**A1-A11**

KEYNOTES - FLOOR PLAN	
100	MACHINE ROOM LESS PASSENGER ELEVATOR, 3000 LB CAPACITY, 200 FPM BASIS OF DESIGN: OTIS GEN2
101	MACHINE ROOM LESS PASSENGER/SERVICE ELEVATOR, 5000 LB CAPACITY, 200 FPM BASIS OF DESIGN: OTIS GEN2
102	FREIGHT ELEVATOR, 12,000 LB CAPACITY, 10'W x 14'D x 10'H
103	ESCALATOR, BASIS OF DESIGN: THYSSENKRUPP VELDHO
104	CART CONVEYING SYSTEM, SINGLE DOWNWARD TRACK BASIS OF DESIGN: CARTVEYOR BY PLOW INDUSTRIES.
110	16'-0" WIDE X 8'-8" HIGH AUTOMATIC SLIDING DOOR, BASIS OF DESIGN: BESAM
113	16'-0" x 8'-8" 1 HOUR RATED COILING FIRE DOOR
118	BIKE RACK - VERIFY REQUIREMENTS WITH GROCER TENANT.
119	16" DIAMETER CONCRETE FILLED BOLLARD
120	TENANT FINISH FLOOR AT 100'-0" LANDLORD PROVIDED STRUCTURAL SLAB AT 99'-3"
142	BUILT IN PLANTER - LINE WITH SHEET WATERPROOFING AND 2" EXTRUDED POLYSTYRENE INSULATION. PROVIDE 1/2" GARVEL BASE AND FILTER FABRIC AT BOTTOM OF PLANTER. FILL REMAINDER OF PLANTER WITH TOP SOIL. HOLD INSULATION 2" MIN BELOW GRADE
144	LOCATION OF SLAB OPENING FOR TRASH CHUTE AT FIRST FLOOR GROCER. COORDINATE FINAL LOCATION W/ STRUCTURAL AND GROCER TENANT
151	HANDICAPED STALL SIGNAGE
152	PARKING BUMPER, TYPICAL
153	4" HEAVY DUTY, DURABLE WHITE, 2 COAT STRIPING TYPICAL.
154	TRAFFIC BEARING MEMBRANE COATING


PARKING MATRIX - GROCER	
STALL TYPE	NO. OF STALLS
LOWER LEVEL (PARKING)	
ACCESSIBLE PARKING STALL	3
COMPACT PARKING STALL	6
STANDARD PARKING STALL	139
VAN ACCESSIBLE PARKING STALL	1
TOTAL STALLS	239

PARKING MATRIX - RESIDENTIAL	
STALL TYPE	NO. OF STALLS
2ND FLOOR (PARKING)	
ACCESSIBLE PARKING STALL	2
STANDARD PARKING STALL	69
VAN ACCESSIBLE PARKING STALL	2
3RD FLOOR (PARKING)	
ACCESSIBLE PARKING STALL	2
STANDARD PARKING STALL	100
VAN ACCESSIBLE PARKING STALL	2
4TH FLOOR (PARKING)	
STANDARD PARKING STALL	108
4.5 FLOOR (PARKING)	
STANDARD PARKING STALL	30
TOTAL STALLS	313




FLOOR PLAN SYMBOL LEGEND	
ALIGN	ALIGN FACE OF INDICATED ELEMENTS
PLAN KEYNOTE	SEE KEYNOTE LEGEND
FEC	FIRE EXTINGUISHER CABINET (FEC)
FE	FIRE EXTINGUISHER (FE)
ROOF DRAIN	ROOF DRAIN
FLOOR DRAIN	FLOOR DRAIN
SKYLIGHT	SKYLIGHT

**FLOOR PLAN GENERAL NOTES**

- VERIFY DIMENSIONS, CONDITIONS, AND FINISHES PRIOR TO PRICING OR PROCEEDING WITH WORK.
- DO NOT SCALE FROM DRAWINGS. BRING ANY DISCREPANCIES TO ARCHITECTS' ATTENTION IMMEDIATELY.
- COORDINATE LOCATIONS AND QUANTITY OF WORK WITH MECHANICAL, ELECTRICAL AND PLUMBING CONTRACTORS.
- REFER TO PARTITION SCHEDULE ON G005 FOR TYPICAL PARTITION TYPES. STAIRS, ELEVATORS, MECHANICAL AND OTHER SHAFT WALLS TO HAVE A 1-HOUR FIRE RATING WHERE INDICATED. TYPICAL PARTITION WALLS TO BE OHD U.N.O.
- SLOPE ALL ROOF INSULATION 1/4" PER 1'-0" TOWARDS ROOF DRAINS PER PLAN ANNOTATIONS. MAINTAIN MINIMUM 4" INSULATION.

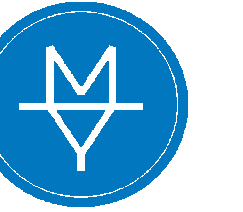

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Sheet Title  
**2ND FLOOR PLAN**
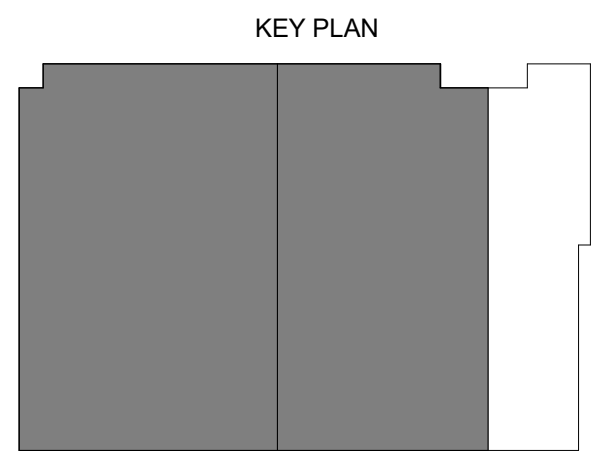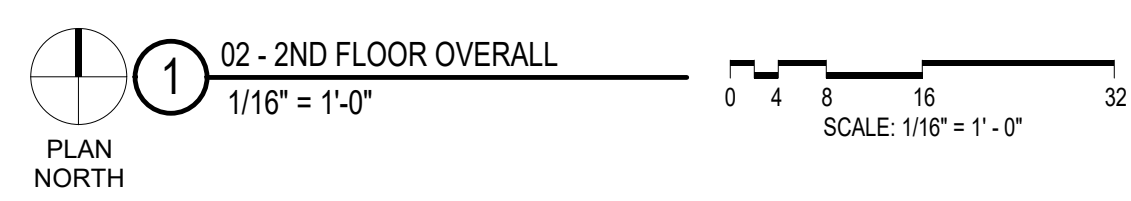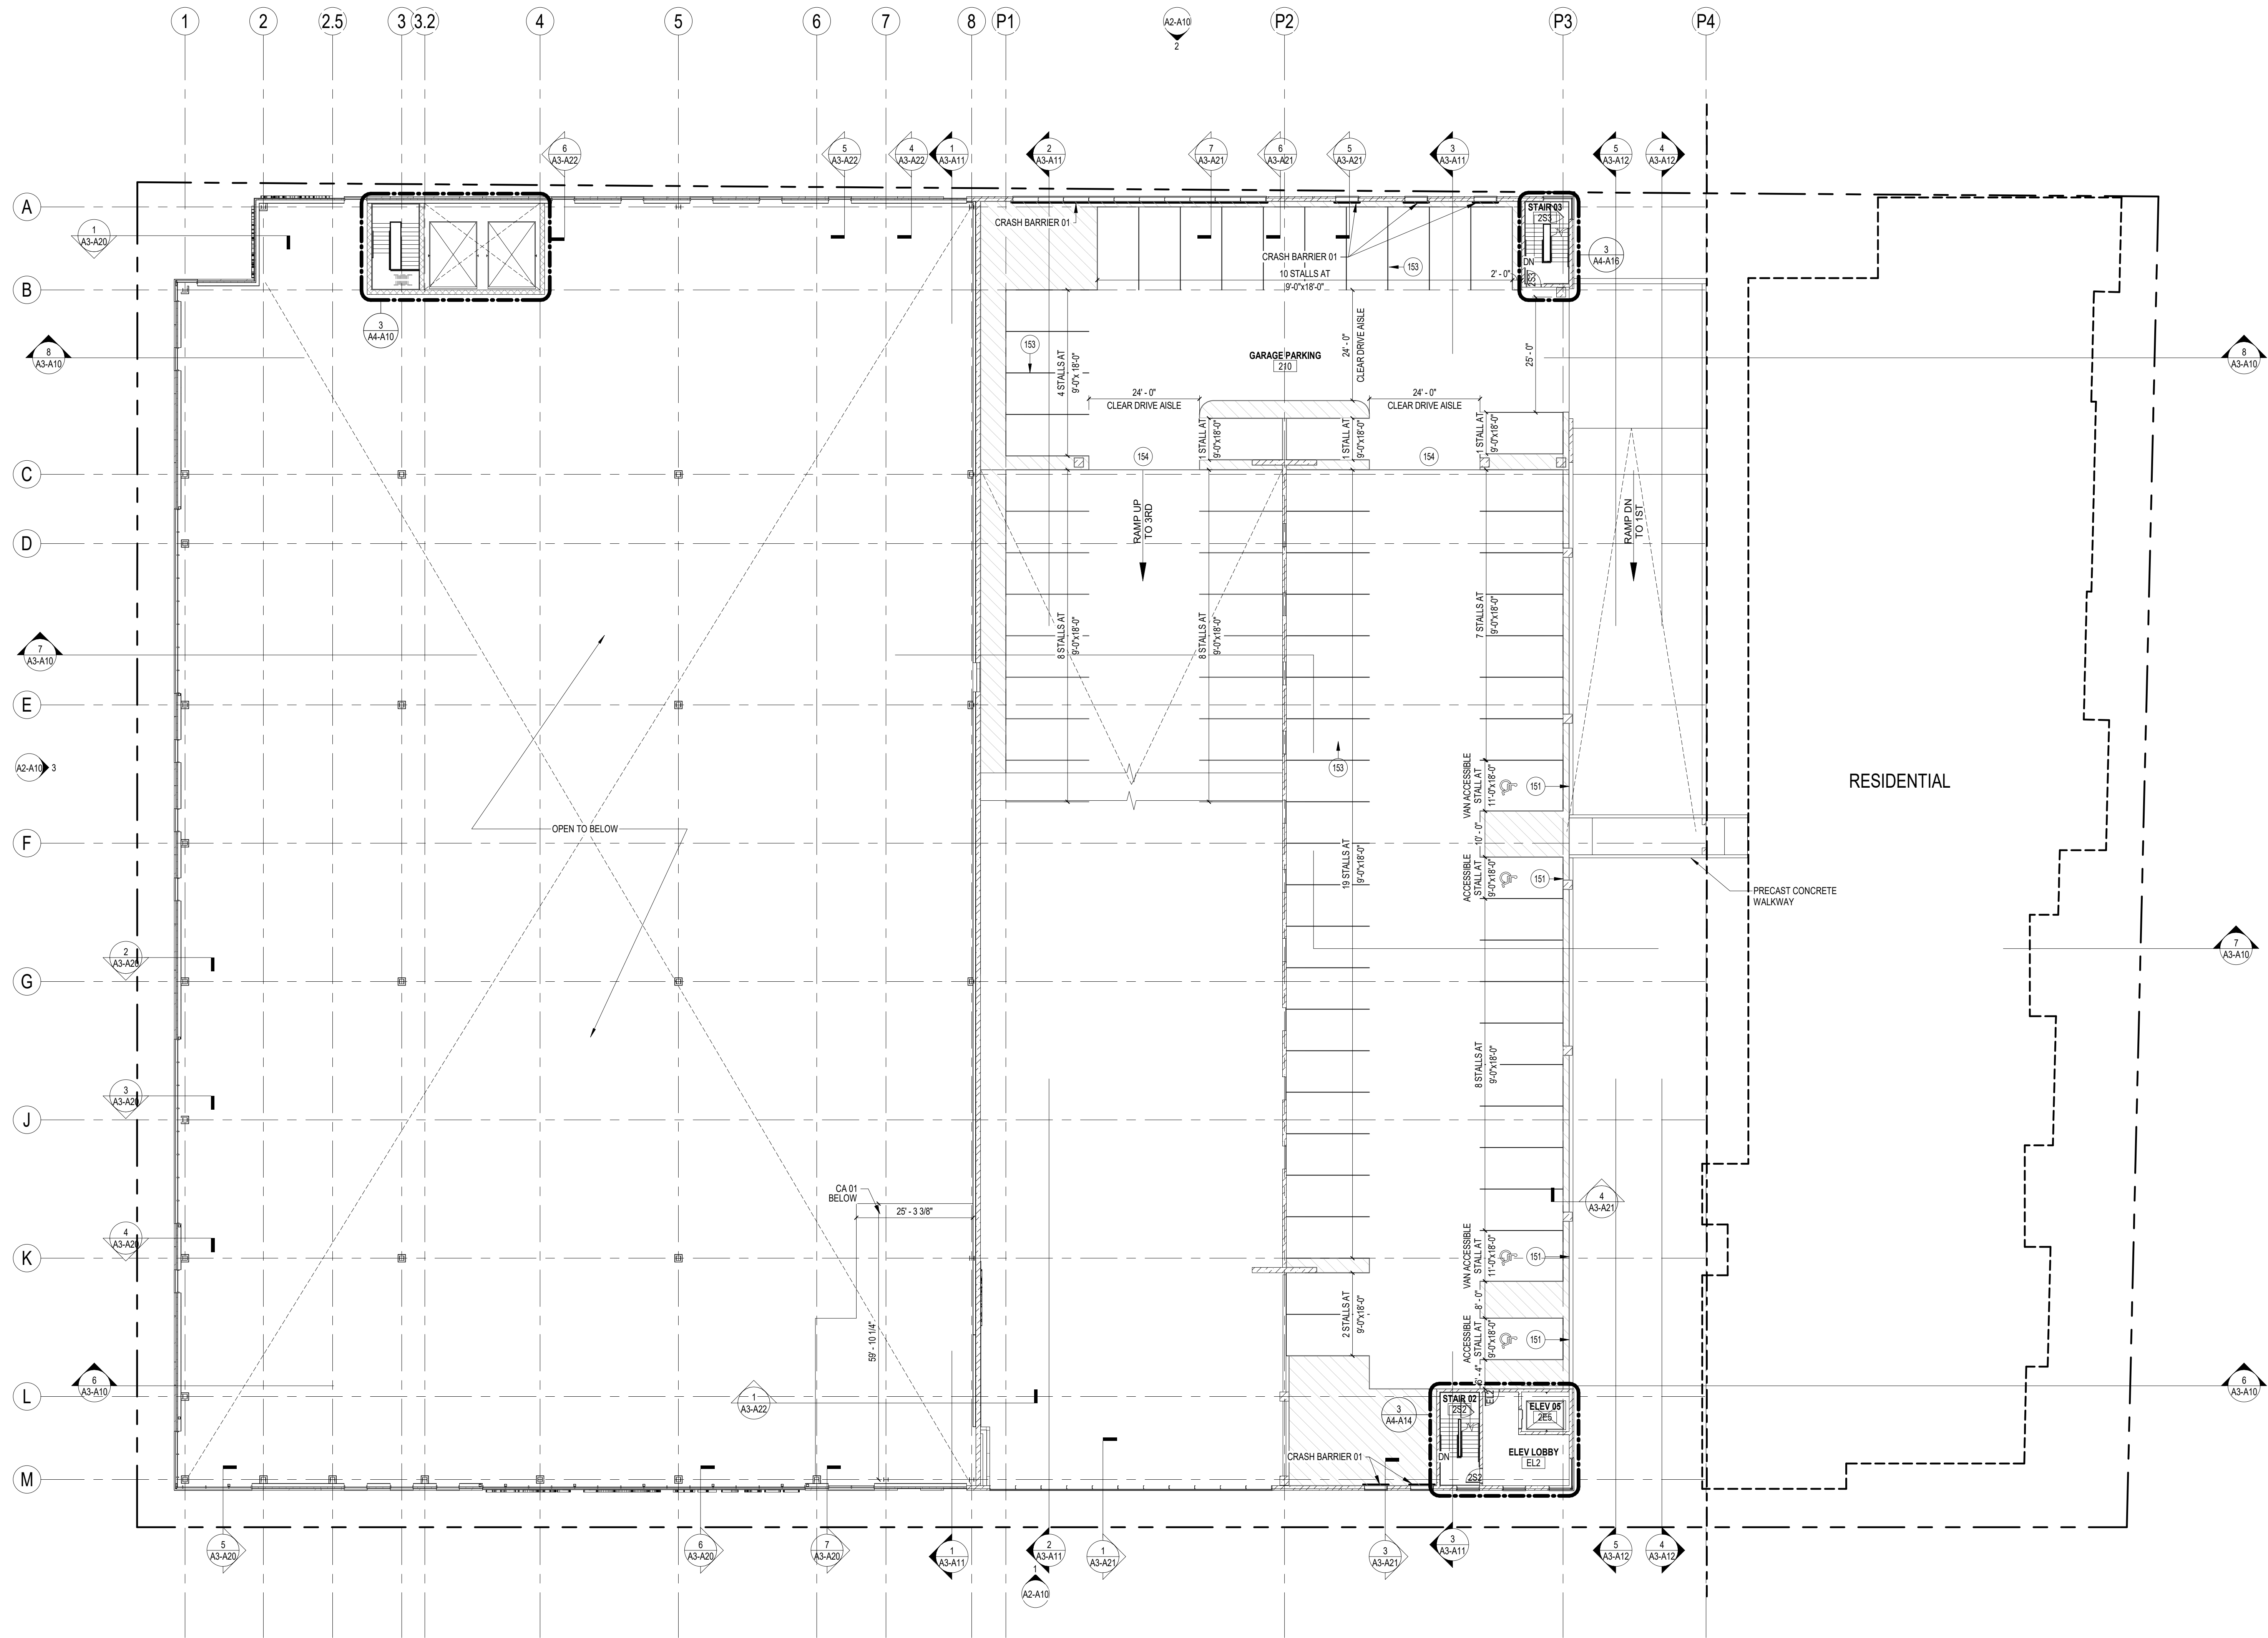
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Sheet No.  
**A1-A12**

ASSEMBLIES & COMPONENTS	
CA 01	C-JOIST FLOOR / CEILING ASSEMBLY UL-G556
CRASH BARRIER 01	42" HIGH 11-STRAND HORIZONTAL CABLE VEHICLE CRASH BARRIER GUARD - SEE STRUCTURAL

KEYNOTES - FLOOR PLAN	
151	HANDICAP STALL SIGNAGE
153	4" HEAVY DUTY, DURABLE WHITE, 2 COAT STRIPING TYPICAL
154	TRAFFIC BEARING MEMBRANE COATING

PARKING MATRIX - GROCER	
STALL TYPE	NO. OF STALLS
LOWER LEVEL (PARKING)	
ACCESSIBLE PARKING STALL	3
COMPACT PARKING STALL	6
STANDARD PARKING STALL	139
VAN ACCESSIBLE PARKING STALL	1
1ST FLOOR	
ACCESSIBLE PARKING STALL	3
STANDARD PARKING STALL	86
VAN ACCESSIBLE PARKING STALL	1
TOTAL STALLS	239




PARKING MATRIX - RESIDENTIAL	
STALL TYPE	NO. OF STALLS
2ND FLOOR (PARKING)	
ACCESSIBLE PARKING STALL	2
STANDARD PARKING STALL	69
VAN ACCESSIBLE PARKING STALL	2
3RD FLOOR (PARKING)	
ACCESSIBLE PARKING STALL	2
STANDARD PARKING STALL	100
VAN ACCESSIBLE PARKING STALL	2
4TH FLOOR (PARKING)	
STANDARD PARKING STALL	108
4.5 FLOOR (PARKING)	
STANDARD PARKING STALL	30
TOTAL STALLS	313

FLOOR PLAN SYMBOL LEGEND	
ALIGN	ALIGN FACE OF INDICATED ELEMENTS
PLAN KEYNOTE	SEE KEYNOTE LEGEND
FEC	FIRE EXTINGUISHER CABINET (FEC)
FE	FIRE EXTINGUISHER (FE)
RD	ROOF DRAIN
FD	FLOOR DRAIN
SKYLIGHT	SKYLIGHT

FLOOR PLAN GENERAL NOTES	
1.	VERIFY DIMENSIONS, CONDITIONS, AND FINISHES PRIOR TO PRICING OR PROCEEDING WITH WORK.
2.	DO NOT SCALE FROM DRAWINGS. BRING ANY DISCREPANCIES TO ARCHITECTS ATTENTION IMMEDIATELY.
3.	COORDINATE LOCATIONS AND QUANTITY OF WORK WITH MECHANICAL, ELECTRICAL AND PLUMBING CONTRACTORS.
4.	REFER TO PARTITION SCHEDULE ON G005 FOR TYPICAL PARTITION TYPES. STAIRS, ELEVATORS, MECHANICAL AND OTHER SHAFT WALLS TO HAVE A 1-HOUR FIRE RATING WHERE INDICATED. TYPICAL PARTITION WALLS TO BE 09D U.N.O.
5.	SLOPE ALL ROOF INSULATION 1/4" PER 1'-0" TOWARDS ROOF DRAINS PER PLAN ANNOTATIONS. MAINTAIN MINIMUM 4" INSULATION.



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**3RD FLOOR PLAN**

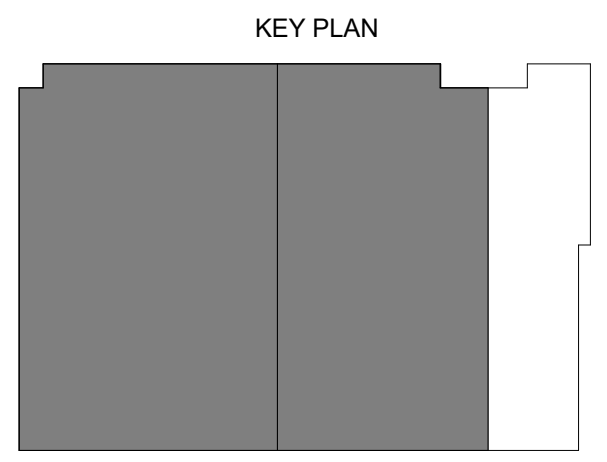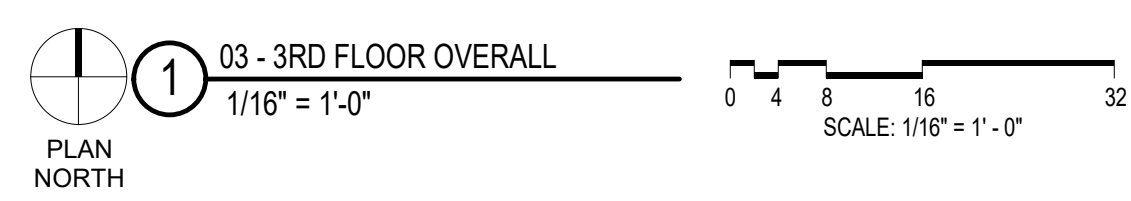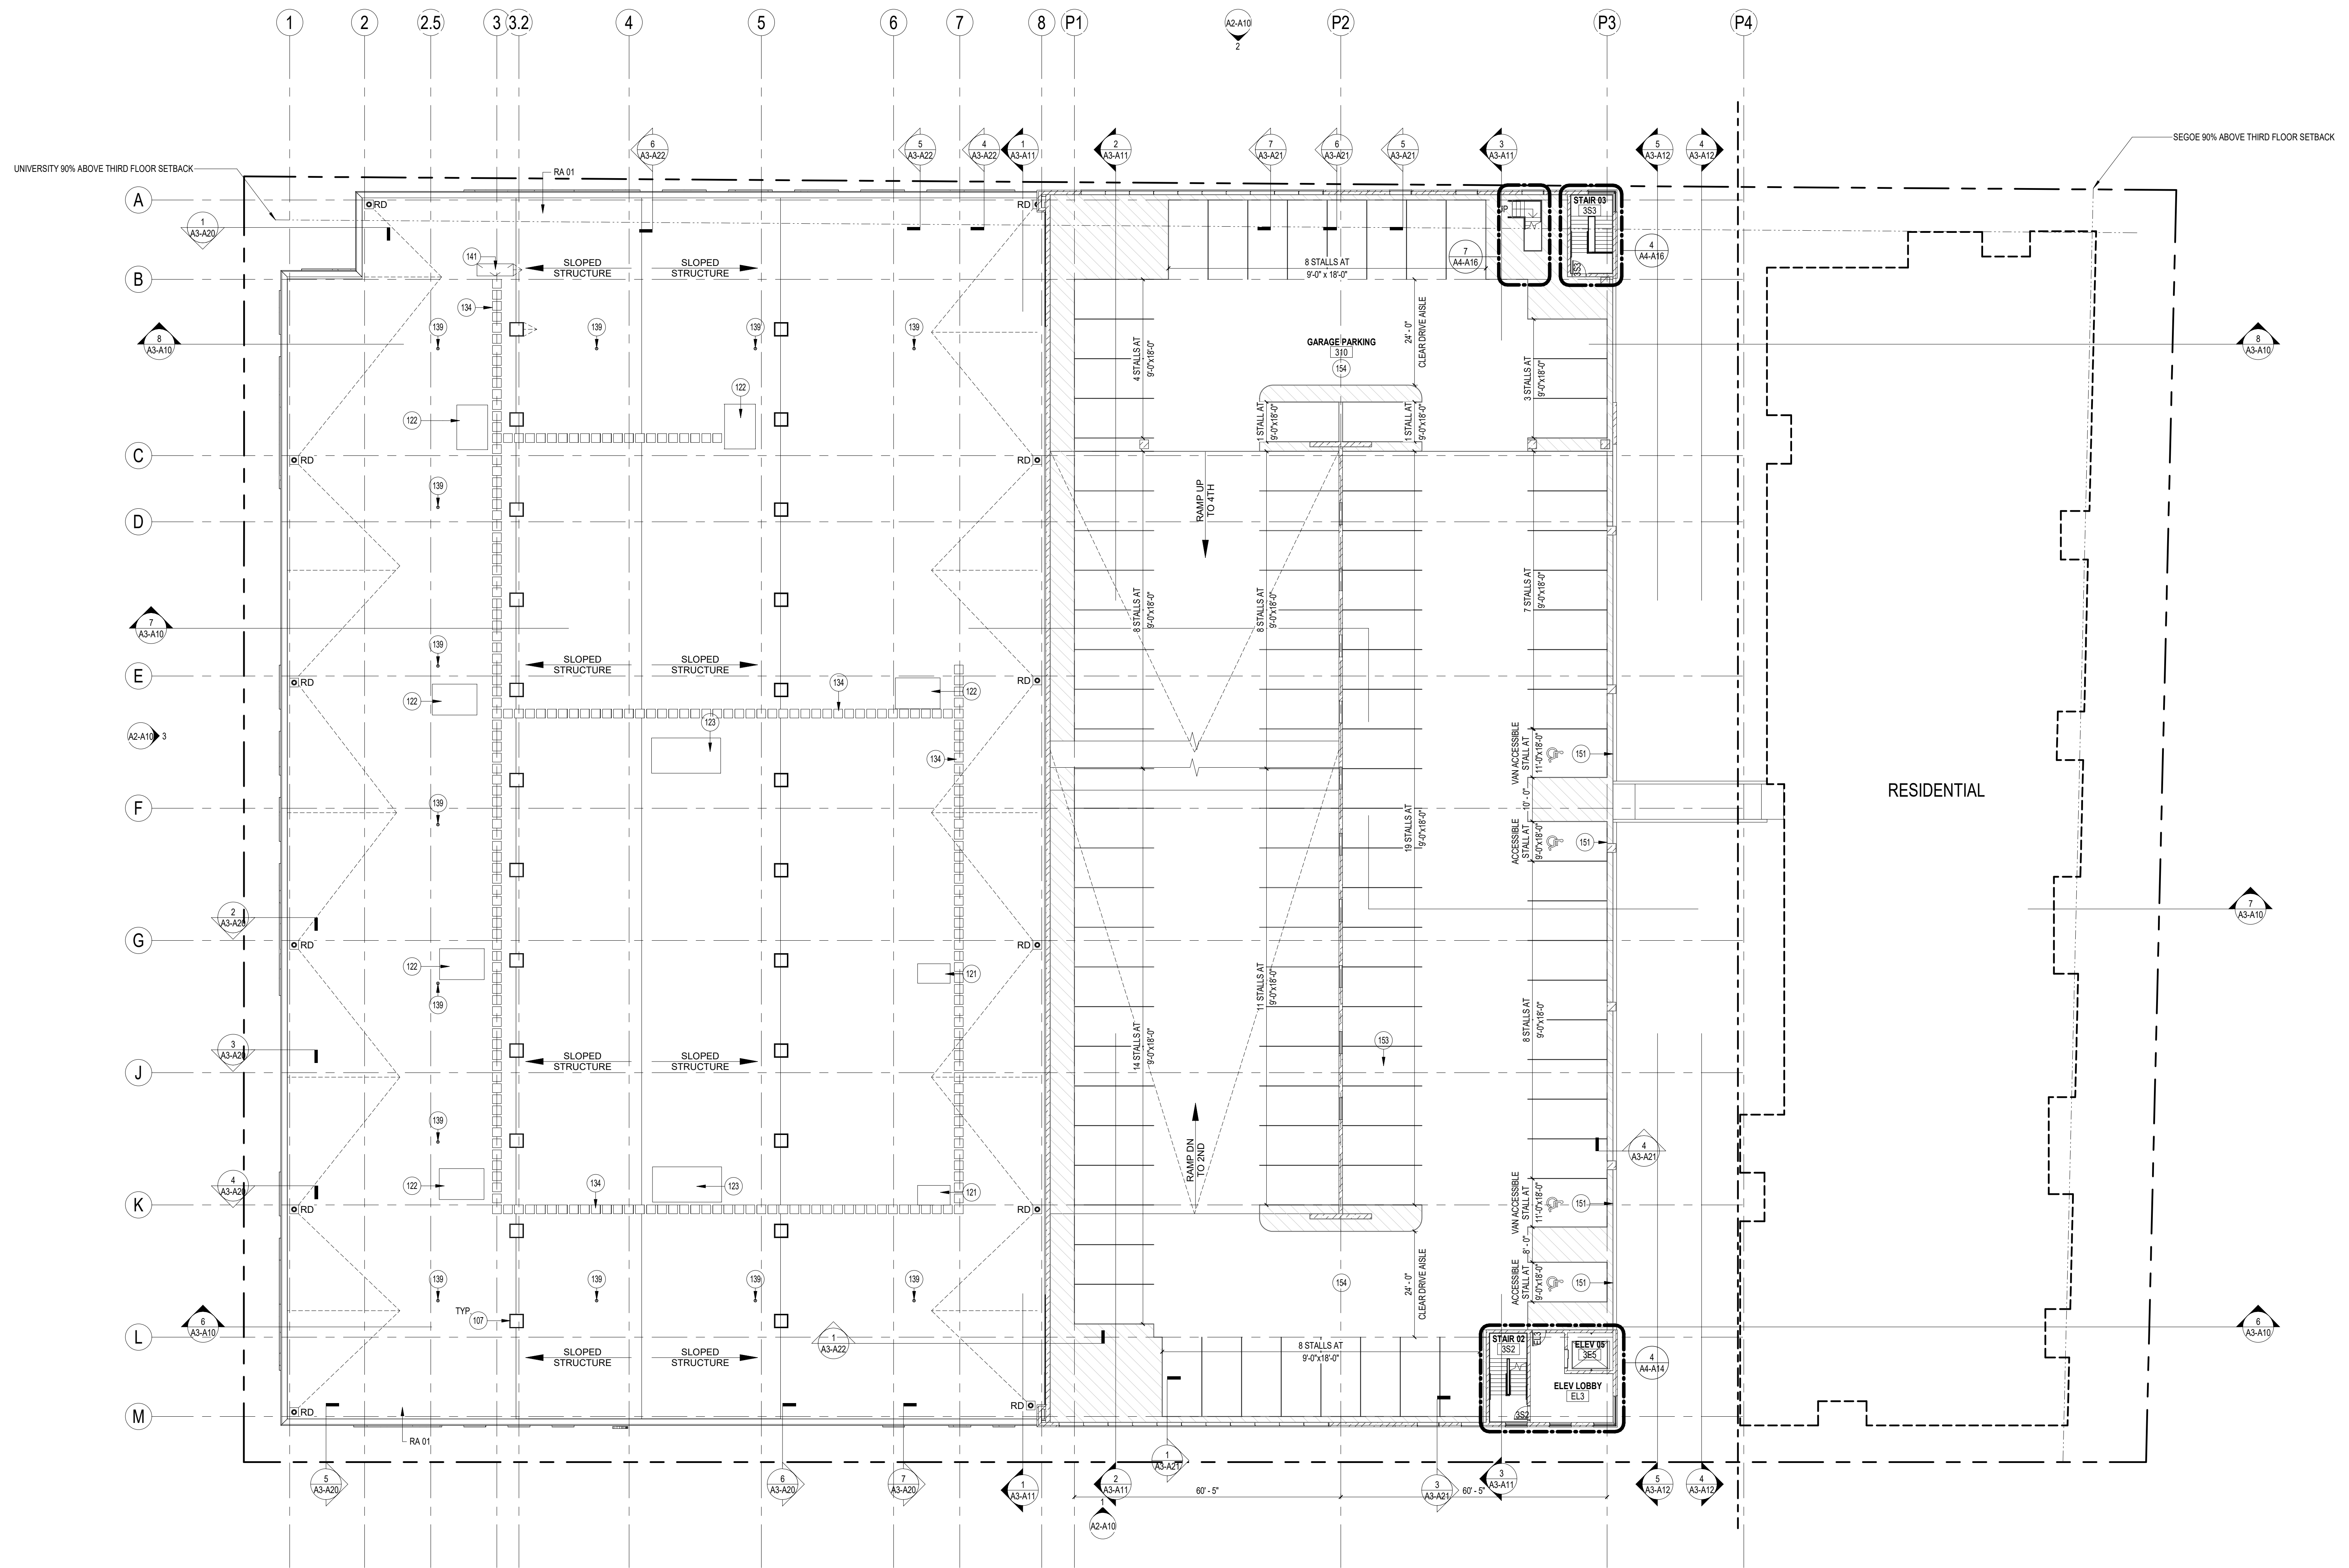ASSEMBLIES & COMPONENTS	
RA 01	FULLY ADHERED TPO MEMBRANE ON RIGID INSULATION, VAPOR RETARDER, COVERBOARD, METAL DECK OVER STRUCTURAL STEEL JOISTS WITH SPRAY APPLIED FIREPROOFING (1-HOUR FIRE RATING MINIMUM)

KEYNOTES - FLOOR PLAN	
107	36" X36" DOUBLE DOME CLEAR ACRYLIC SKYLIGHT WITH INTERIOR SECURITY BARS. BASIS OF DESIGN: VELLUX CT2 TRADITIONAL DOME SKYLIGHT WITH CRGA B8 SECURITY BARS
121	ROOFTOP UNIT - 2,000 LBS
122	ROOFTOP UNIT - 2,000 LBS
123	ROOFTOP UNIT - 6,000 LBS
134	MANUFACTURER'S STANDARD WALKWAY ROOF PADS. EXTEND FROM ROOF HATCH TO AND AROUND ALL ROOF TOP EQUIPMENT
139	ROOF TIE OFF POSTS SPACED 36" MAX AT PERIMETER OF ROOF. BASIS OF DESIGN: MILLER FUSION ROOF ANCHOR POST OR EQUAL
141	30"x6" LOCKABLE ROOF HATCH W/ SAFETY EXTENSION POLE. BASIS OF DESIGN: BABCOCK DAVIS BRHP
151	HANDICAP STALL SIGNAGE
153	4" HEAVY DUTY, DURABLE WHITE, 2 COAT STRIPING TYPICAL
154	TRAFFIC BEARING MEMBRANE COATING

PARKING MATRIX - GROCER	
STALL TYPE	NO. OF STALLS
LOWER LEVEL (PARKING)	
ACCESSIBLE PARKING STALL	3
COMPACT PARKING STALL	6
STANDARD PARKING STALL	139
VAN ACCESSIBLE PARKING STALL	1
1ST FLOOR	
ACCESSIBLE PARKING STALL	3
STANDARD PARKING STALL	86
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TOTAL STALLS	239


PARKING MATRIX - RESIDENTIAL	
STALL TYPE	NO. OF STALLS
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ACCESSIBLE PARKING STALL	2
STANDARD PARKING STALL	69
VAN ACCESSIBLE PARKING STALL	2
3RD FLOOR (PARKING)	
ACCESSIBLE PARKING STALL	2
STANDARD PARKING STALL	100
VAN ACCESSIBLE PARKING STALL	2
4TH FLOOR (PARKING)	
STANDARD PARKING STALL	108
4.5 FLOOR (PARKING)	
STANDARD PARKING STALL	30
TOTAL STALLS	313

FLOOR PLAN SYMBOL LEGEND	
ALIGN	ALIGN FACE OF INDICATED ELEMENTS
PLAN KEYNOTE	SEE KEYNOTE LEGEND
FEC	FIRE EXTINGUISHER CABINET (FEC)
FE	FIRE EXTINGUISHER (FE)
RD	ROOF DRAIN
FD	FLOOR DRAIN
SKYLIGHT	SKYLIGHT


FLOOR PLAN GENERAL NOTES	
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2.	DO NOT SCALE FROM DRAWINGS. BRING ANY DISCREPANCIES TO ARCHITECT'S ATTENTION IMMEDIATELY.
3.	COORDINATE LOCATIONS AND QUANTITY OF WORK WITH MECHANICAL, ELECTRICAL AND PLUMBING CONTRACTORS.
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5.	SLOPE ALL ROOF INSULATION 1/4" PER 1'-0" TOWARDS ROOF DRAINS PER PLAN ANNOTATIONS. MAINTAIN MINIMUM 4" INSULATION.

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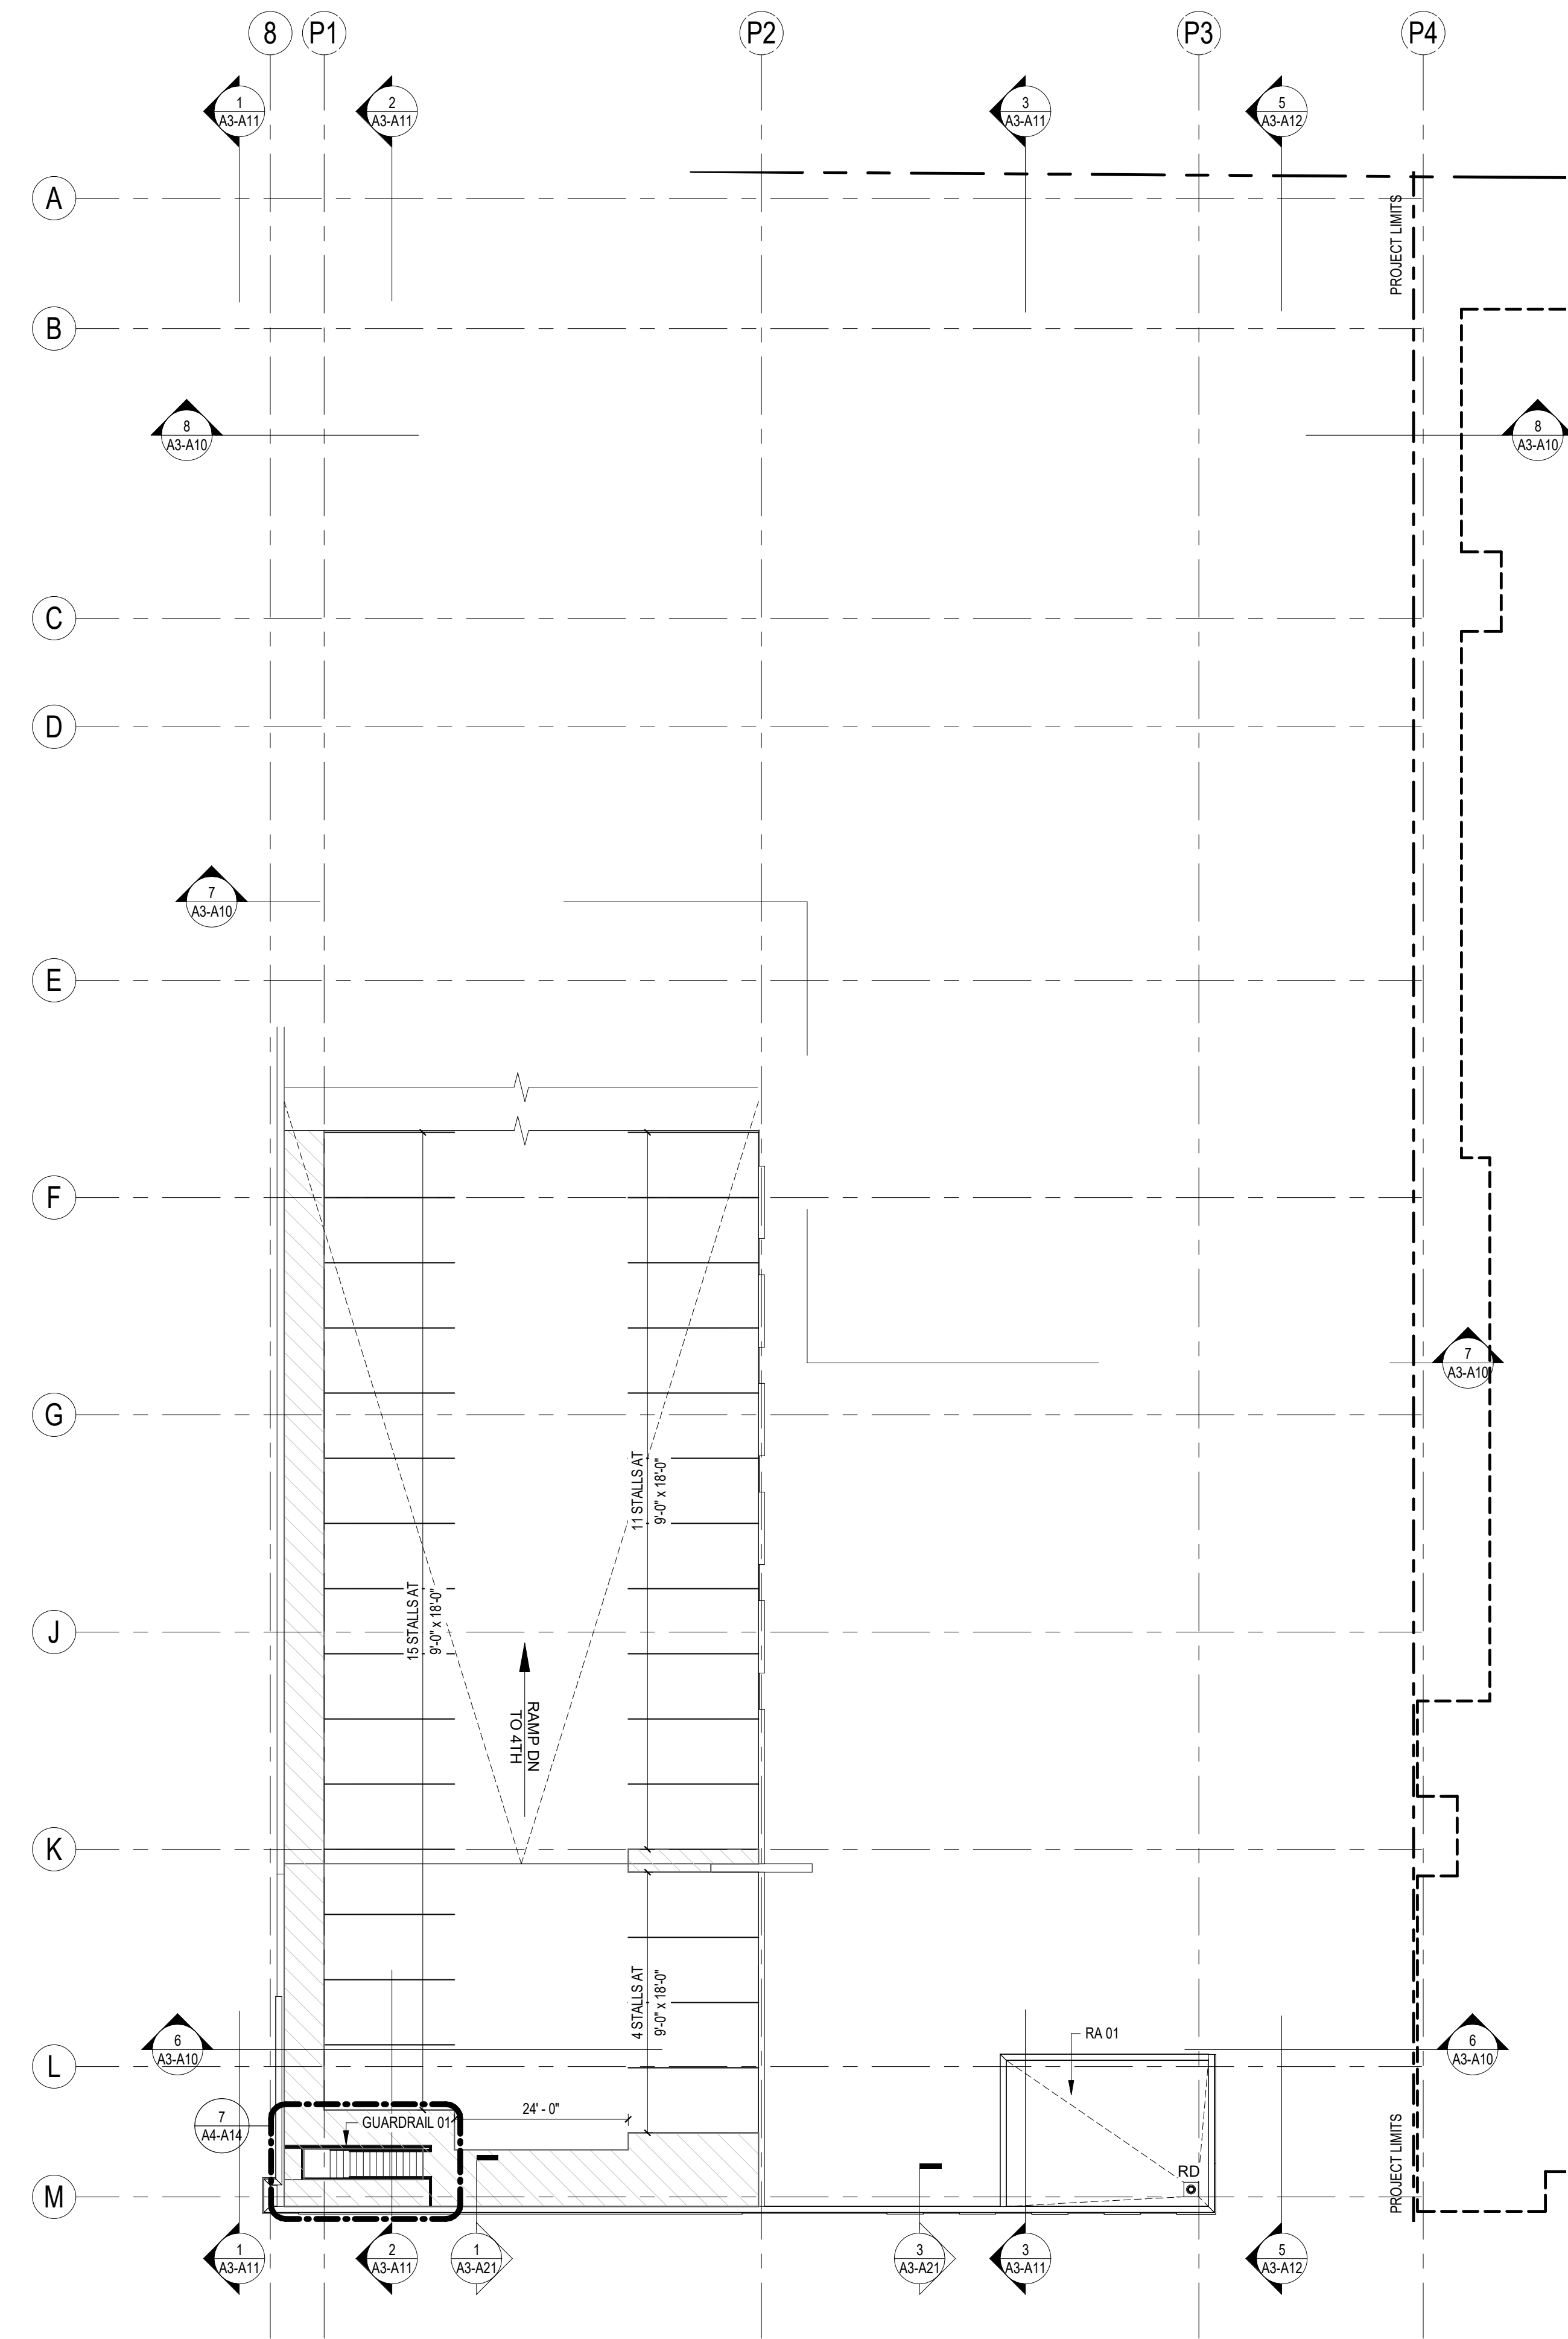
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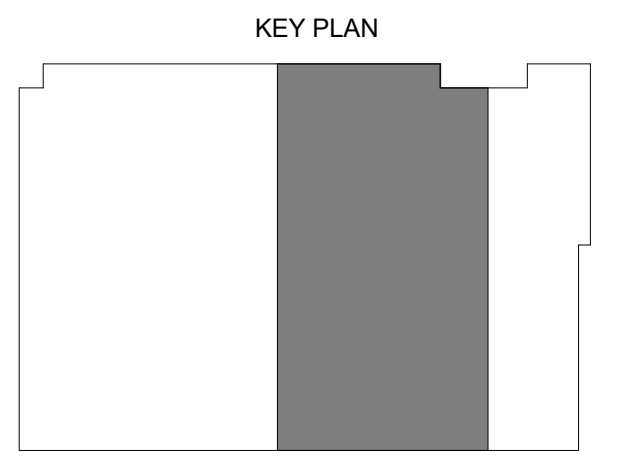
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1 04 - 4TH FLOOR OVERALL  
SCALE: 1/16" = 1'-0"

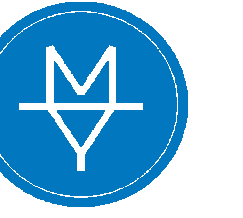

2 4.5 - 5TH FLOOR OVERALL  
SCALE: 1/16" = 1'-0"

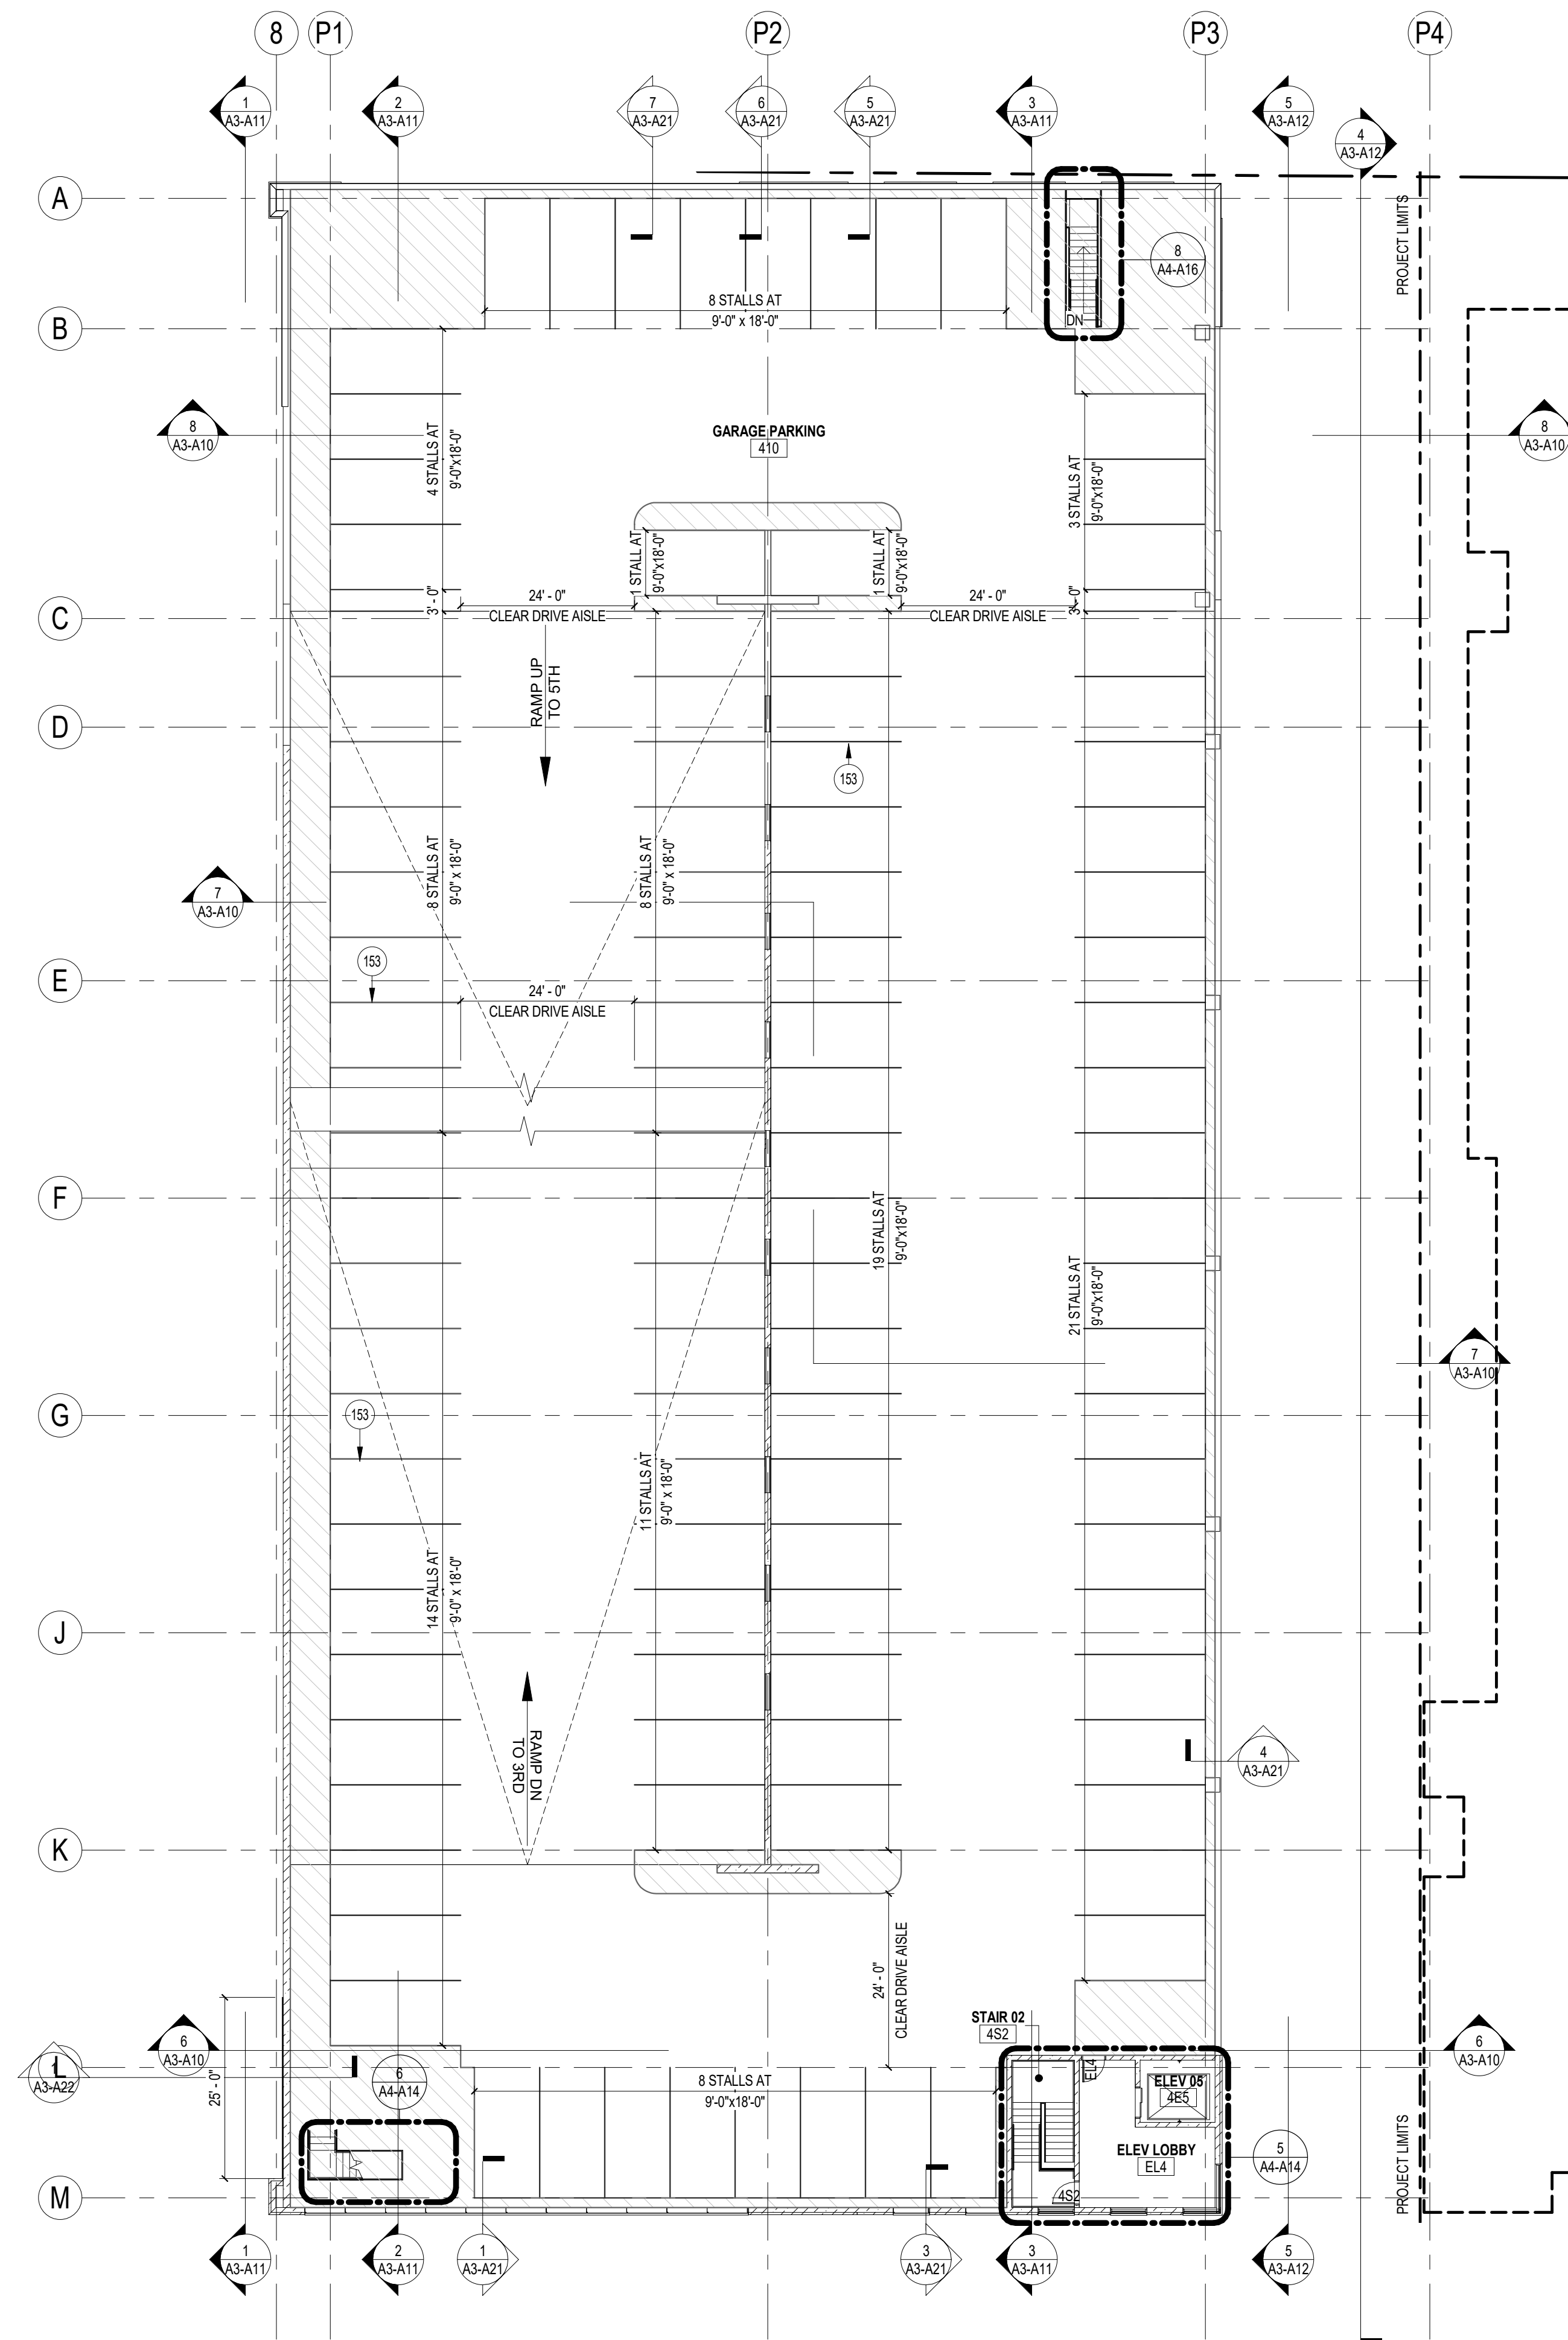

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4TH FLOOR & ROOF  
PLANS

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Sheet No.  
A1-A14

ASSEMBLIES & COMPONENTS	
GUARDRAIL 01	PREFABRICATED PAINTED STEEL GUARDRAIL, 42", STRINGER MOUNTED, 12" EXTENSIONS AT BOTH ENDS
RA 01	FULLY ADHERED TPO MEMBRANE ON RIGID INSULATION, VAPOR RETARDER COVERBOARD, METAL DECK OVER STRUCTURAL STEEL JOISTS WITH SPRAY APPLIED FIREPROOFING (1-HOUR FIRE RATING MINIMUM)

KEYNOTES - FLOOR PLAN	
153	4" HEAVY DUTY, DURABLE WHITE, 2 COAT STRIPING TYPICAL

PARKING MATRIX - GROCER	
STALL TYPE	NO. OF STALLS
LOWER LEVEL (PARKING)	
ACCESSIBLE PARKING STALL	3
STANDARD PARKING STALL	6
STANDARD PARKING STALL	139
VAN ACCESSIBLE PARKING STALL	1
1ST FLOOR	
ACCESSIBLE PARKING STALL	3
STANDARD PARKING STALL	86
VAN ACCESSIBLE PARKING STALL	1
TOTAL STALLS	239

PARKING MATRIX - RESIDENTIAL	
STALL TYPE	NO. OF STALLS
2ND FLOOR (PARKING)	
ACCESSIBLE PARKING STALL	2
STANDARD PARKING STALL	69
VAN ACCESSIBLE PARKING STALL	2
3RD FLOOR (PARKING)	
ACCESSIBLE PARKING STALL	2
STANDARD PARKING STALL	100
VAN ACCESSIBLE PARKING STALL	2
4TH FLOOR (PARKING)	
STANDARD PARKING STALL	108
4.5 FLOOR (PARKING)	
STANDARD PARKING STALL	30
TOTAL STALLS	313

FLOOR PLAN SYMBOL LEGEND	
ALIGN	ALIGN FACE OF INDICATED ELEMENTS
PLAN KEYNOTE	SEE KEYNOTE LEGEND
FEC	FIRE EXTINGUISHER CABINET (FEC)
FE	FIRE EXTINGUISHER (FE)
ROOF DRAIN	ROOF DRAIN
FLOOR DRAIN	FLOOR DRAIN
SKYLIGHT	SKYLIGHT

FLOOR PLAN GENERAL NOTES	
1.	VERIFY DIMENSIONS, CONDITIONS, AND FINISHES PRIOR TO PRICING OR PROCEEDING WITH WORK.
2.	DO NOT SCALE FROM DRAWINGS. BRING ANY DISCREPANCIES TO ARCHITECTS' ATTENTION IMMEDIATELY.
3.	COORDINATE LOCATIONS AND QUANTITY OF WORK WITH MECHANICAL, ELECTRICAL AND PLUMBING CONTRACTORS.
4.	REFER TO PARTITION SCHEDULE ON G005 FOR TYPICAL PARTITION TYPES, STAIRS, ELEVATORS, MECHANICAL AND OTHER SHAFT WALLS TO HAVE A 1-HOUR FIRE RATING WHERE INDICATED. TYPICAL PARTITION WALLS TO BE 01D U.N.O.
5.	SLOPE ALL ROOF INSULATION 1/4" PER 1'-0" TOWARDS ROOF DRAINS PER PLAN ANNOTATIONS. MAINTAIN MINIMUM 4" INSULATION.




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CONSTRUCTION

EXTERIOR ELEVATION GENERAL NOTES


1. ALL SIGNAGE SUBJECT TO APPROVAL BY CITY OF MADISON
2. ALL METAL SURFACES EXPOSED TO VIEW (INCLUDING MISCELLANEOUS METALS, PIPING, MECHANICAL EQUIPMENT, LADDERS, STAIRS, RAILING, COLUMNS, PLATFORMS, ETC.) SHALL BE PAINTED U.N.O.
3. WINDOWS ARE ALUMINUM STOREFRONT U.N.O.
4. CONTROL JOINTS IN CMU BACKUP TO BE OFFSET FROM CONTROL JOINTS IN MASONRY/STONE VENEER. CONTROL JOINTS AT CMU BACKUP MAXIMUM 26" SPACING.
5. PROVIDE CONTROL JOINTS AT INSIDE CORNERS OF BRICK AND STONE.

ASSEMBLIES & COMPONENTS


ALUM LOUVER 01	DECORATIVE HORIZONTAL EXTRUDED ALUMINUM WOOD-LOOK LOUVER. BASIS OF DESIGN: LONGBOARD FIXED LOUVER SYSTEM
ALUM LOUVER 02	DECORATIVE VERTICAL EXTRUDED ALUMINUM WOOD-LOOK LOUVER. BASIS OF DESIGN: LONGBOARD FIXED LOUVER SYSTEM
ALUM SIDING 01	ALUMINUM WOOD-LOOK SIDING SYSTEM - SEE ELEVATIONS FOR SIZE AND COURSING. COLOR TBD. BASIS OF DESIGN: LONGBOARD PLANK SYSTEM
CAST STN 01	CAST STONE MASONRY - SEE ELEVATIONS FOR SIZE AND COURSING. COLOR TBD. BASIS OF DESIGN: STONECAST PRODUCTS FULL DEPTH VENEER
CAST STN 02	CAST STONE MASONRY - SEE ELEVATIONS FOR SIZE AND COURSING. COLOR TBD. BASIS OF DESIGN: STONECAST PRODUCTS FULL DEPTH VENEER
EXTERIOR LIGHT 01	EXTERIOR DOWN-LIGHT SCONCE
GA 01	ALUMINUM FRAMED ENTRANCES AND STOREFRONTS. BASIS OF DESIGN: KAWNEER 601T GLAZING SYSTEM
GL 01	GLAZING - VISION GLASS: 1" INSULATED GLAZING UNIT
PRECAST PNL 01	PRE-CAST PANEL 01 - PRECAST WALL PANEL W/ MASONRY LOOK FORMLINER COLOR AND TEXTURE TO MATCH CAST STN 01
PRECAST PNL 02	PRE-CAST PANEL 02 - PRECAST WALL PANEL W/ MASONRY LOOK FORMLINER COLOR AND TEXTURE TO MATCH CAST STN 02
RTU 01	ROOFTOP UNIT - COORDINATE w/MECHANICAL
SCUPPER 01	PREFINISHED ALUMINUM SCUPPER TO MATCH ALUM SIDING 01

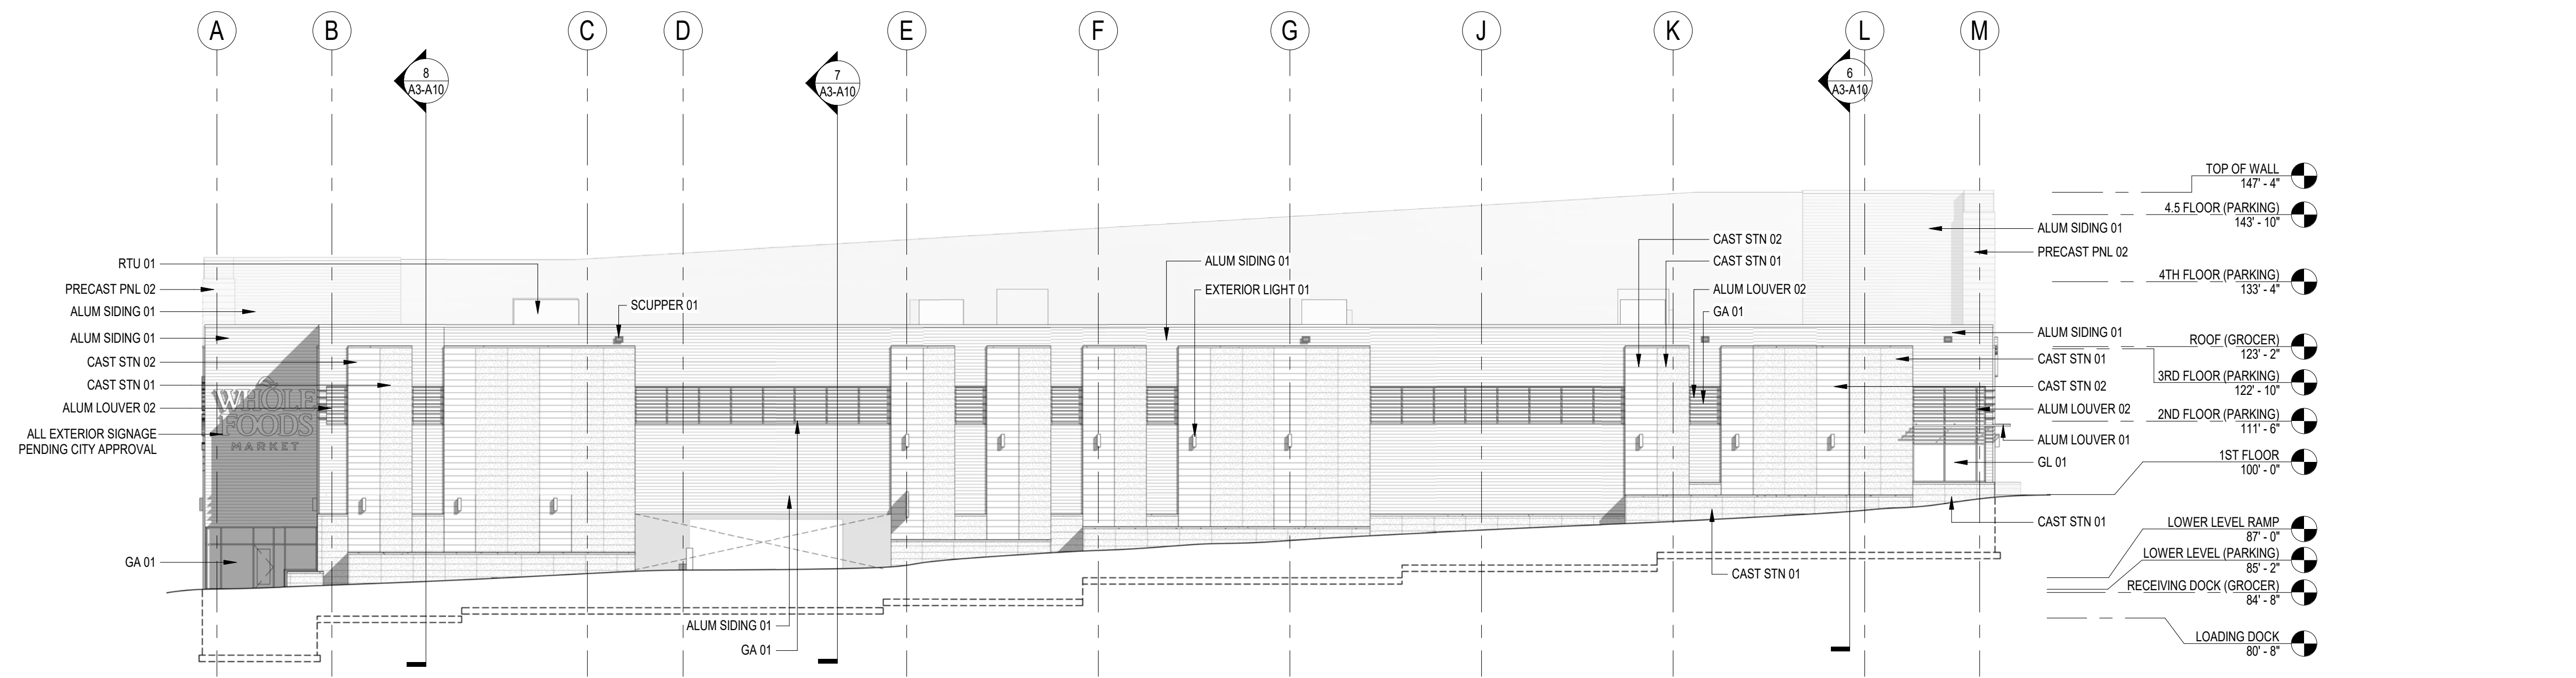

3 WEST ELEVATION  
1/16" = 1'-0"  
SCALE: 1/16" = 1'-0"

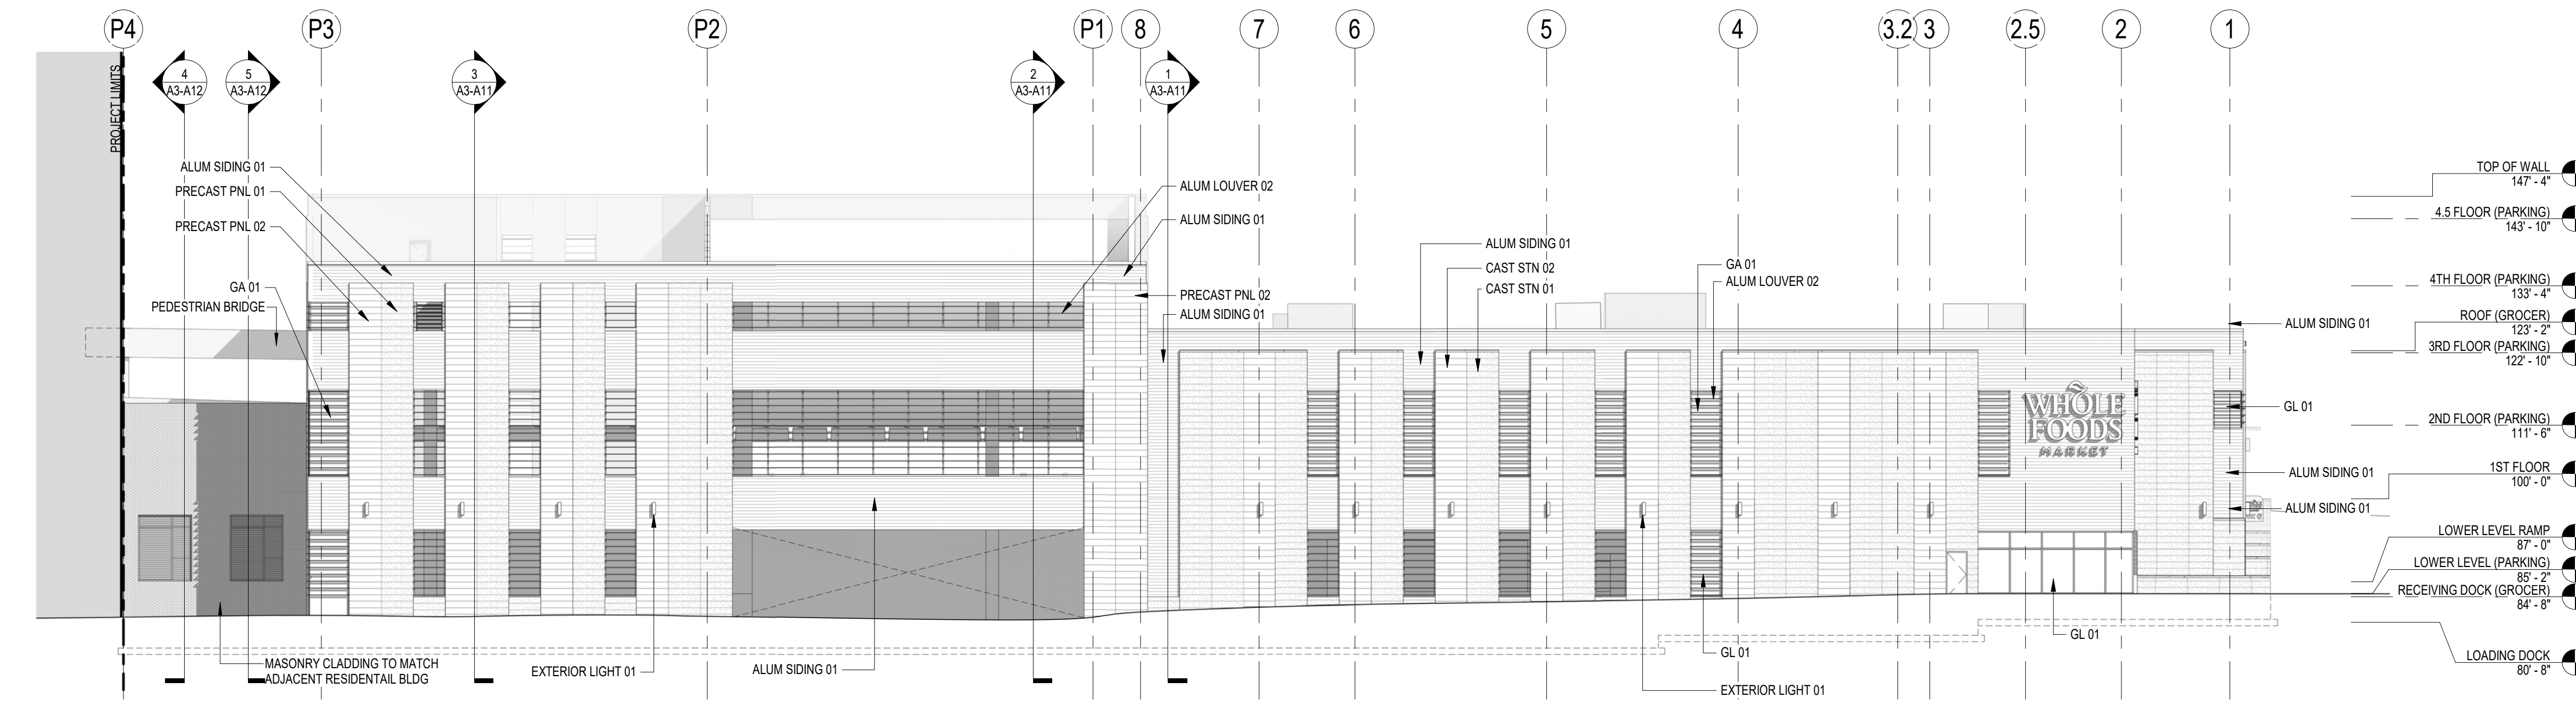

2 NORTH ELEVATION  
1/16" = 1'-0"  
SCALE: 1/16" = 1'-0"

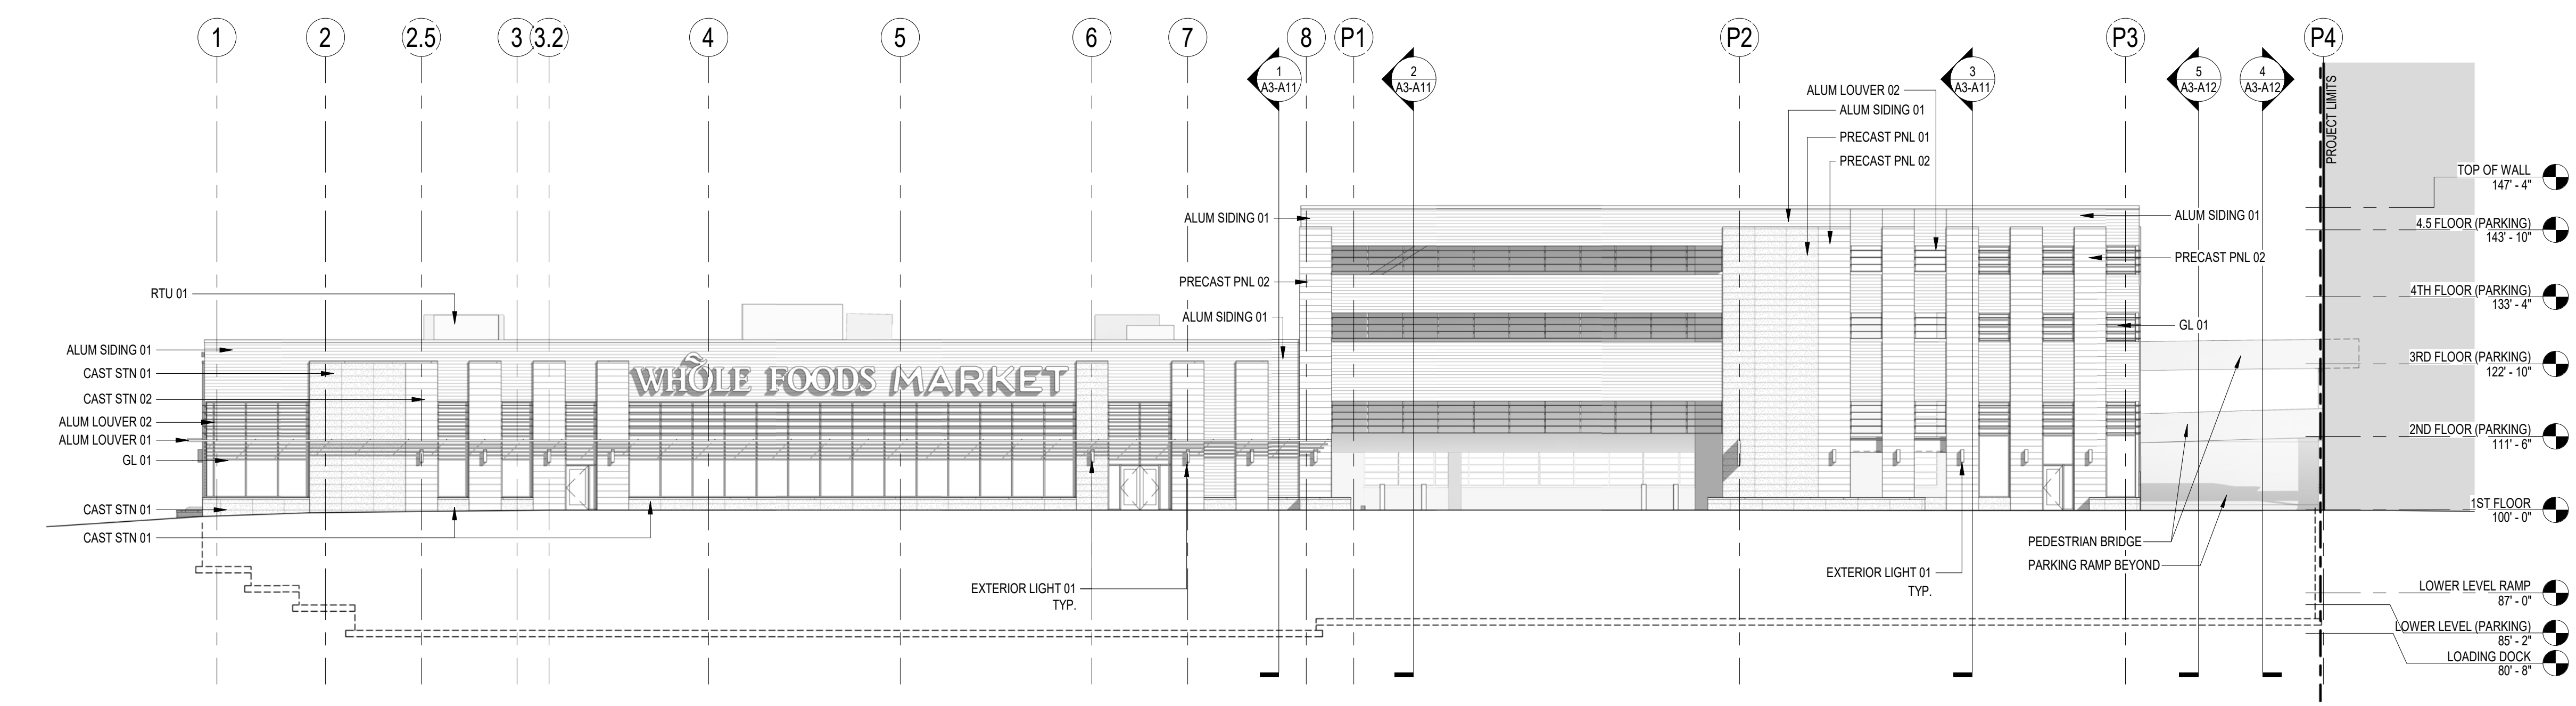

1 SOUTH ELEVATION  
1/16" = 1'-0"  
SCALE: 1/16" = 1'-0"

Revisions

GMP/SIP PACKAGE

Drawing Date  
NOVEMBER 17, 2020

MADISON YARDS:  
BLOCK 2 - GROCER  
BASE CORE & SHELL

UNIVERSITY AVENUE AT GARDNER ROAD


Project No. SUMMIT SMITH/GILBANE  
219143.00

Sheet Title  
EXTERIOR ELEVATIONS

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Sheet No.  
A2-A10



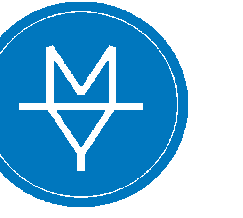


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EXTERIOR ELEVATION GENERAL NOTES


1. ALL SIGNAGE SUBJECT TO APPROVAL BY CITY OF MADISON
2. ALL METAL SURFACES EXPOSED TO VIEW (INCLUDING MISCELLANEOUS METALS, PIPING, MECHANICAL EQUIPMENT, LADDERS, STAIRS, RAILING, COLUMNS, PLATFORMS, ETC.) SHALL BE PAINTED, U.N.O.
3. WINDOWS ARE ALUMINUM STOREFRONT U.N.O.
4. CONTROL JOINTS IN CMU BACKUP TO BE OFFSET FROM CONTROL JOINTS IN MASONRY/STONE VENEER. CONTROL JOINTS AT CMU BACKUP MAXIMUM 20' SPACING.
5. PROVIDE CONTROL JOINTS AT INSIDE CORNERS OF BRICK AND STONE.

ASSEMBLIES & COMPONENTS


ALUM LOUVER 01	DECORATIVE HORIZONTAL EXTRUDED ALUMINUM WOOD-LOOK LOUVER. BASIS OF DESIGN: LONGBOARD FIXED LOUVER SYSTEM
ALUM LOUVER 02	DECORATIVE VERTICAL EXTRUDED ALUMINUM WOOD-LOOK LOUVER. BASIS OF DESIGN: LONGBOARD FIXED LOUVER SYSTEM
ALUM SIDING 01	ALUMINUM WOOD-LOOK SIDING SYSTEM - SEE ELEVATIONS FOR SIZE AND COURSING. COLOR TBD. BASIS OF DESIGN: LONGBOARD PLANK SYSTEM
CAST STN 01	CAST STONE MASONRY - SEE ELEVATIONS FOR SIZE AND COURSING. COLOR TBD. BASIS OF DESIGN: STONECAST PRODUCTS FULL DEPTH VENEER
CAST STN 02	CAST STONE MASONRY - SEE ELEVATIONS FOR SIZE AND COURSING. COLOR TBD. BASIS OF DESIGN: STONECAST PRODUCTS FULL DEPTH VENEER
EXTERIOR LIGHT 01	EXTERIOR DOWN-LIGHT SCOOPE
GA 01	ALUMINUM FRAMED ENTRANCES AND STOREFRONTS. BASIS OF DESIGN: KAWNEER 601T GLAZING SYSTEM
GL 01	GLAZING - VISION GLASS: 1" INSULATED GLAZING UNIT
PRECAST PNL 01	PRE-CAST PANEL 01 - PRECAST WALL PANEL W/ MASONRY LOOK FORMLINER COLOR AND TEXTURE TO MATCH CAST STN 01
PRECAST PNL 02	PRE-CAST PANEL 02 - PRECAST WALL PANEL W/ MASONRY LOOK FORMLINER COLOR AND TEXTURE TO MATCH CAST STN 02
RTU 01	ROOFTOP UNIT - COORDINATE w/MECHANICAL
SCUPPER 01	PREFINISHED ALUMINUM SCUPPER TO MATCH ALUM SIDING 01

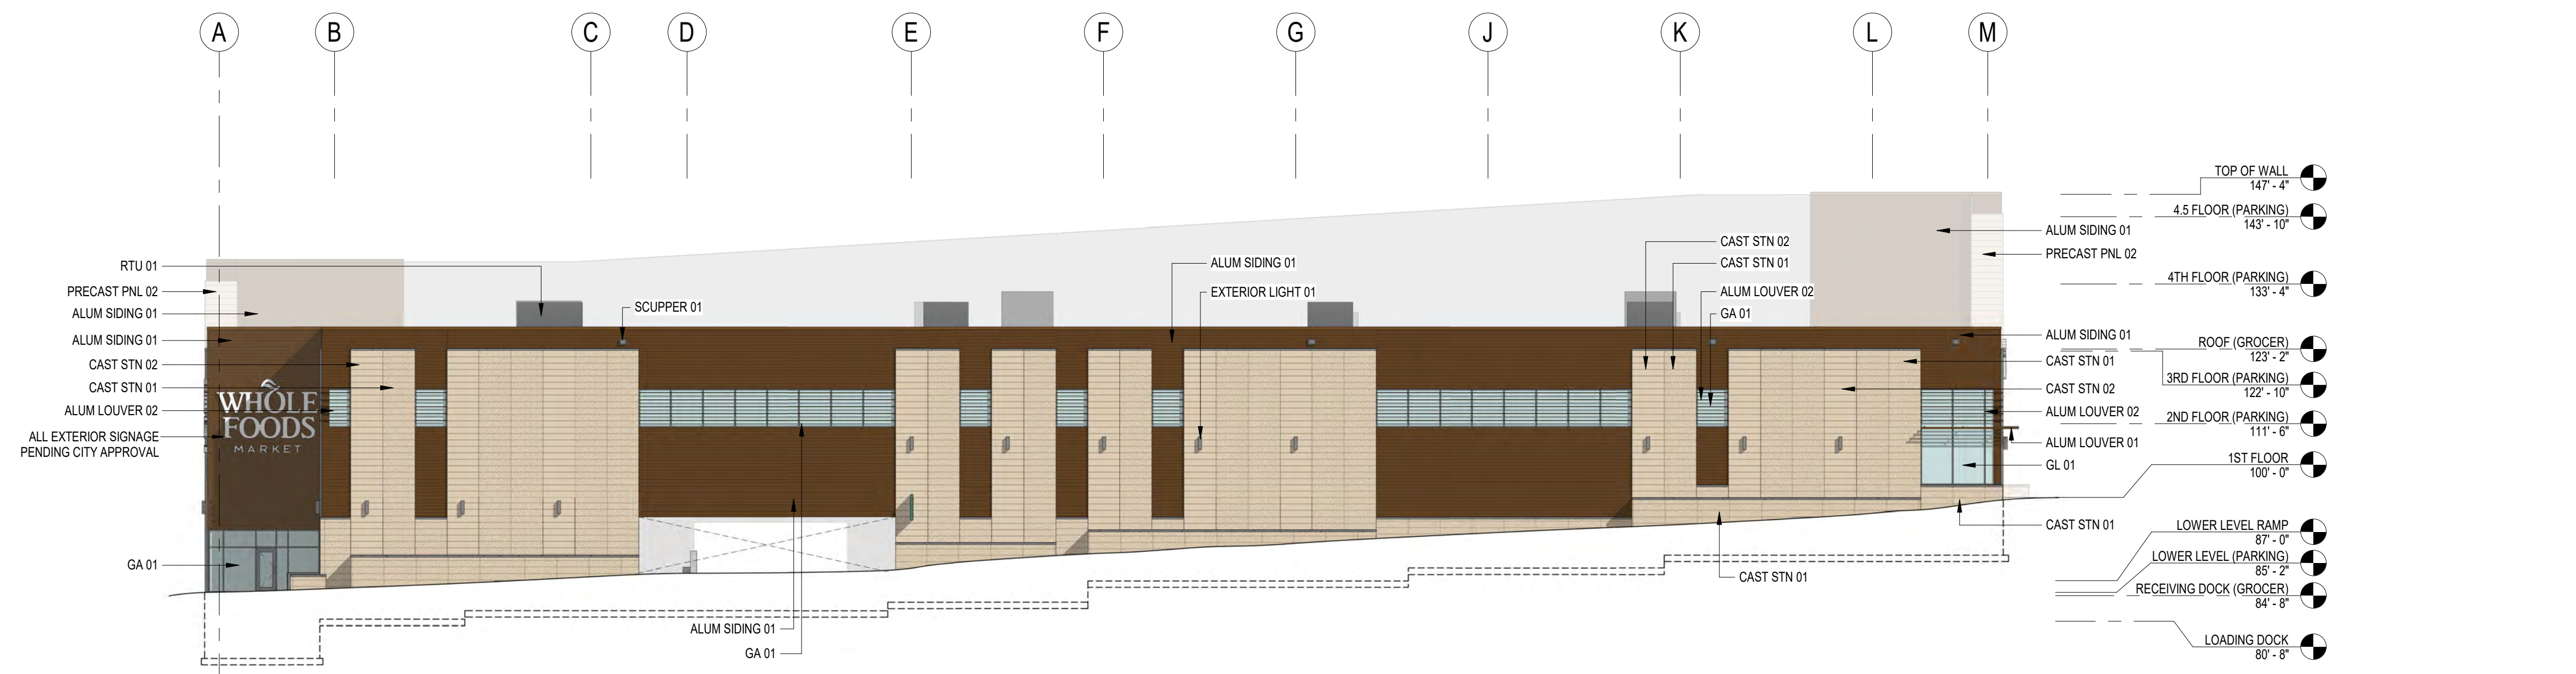

3 COLOR - WEST ELEVATION  
1/16" = 1'-0"  
SCALE: 1/16" = 1'-0"

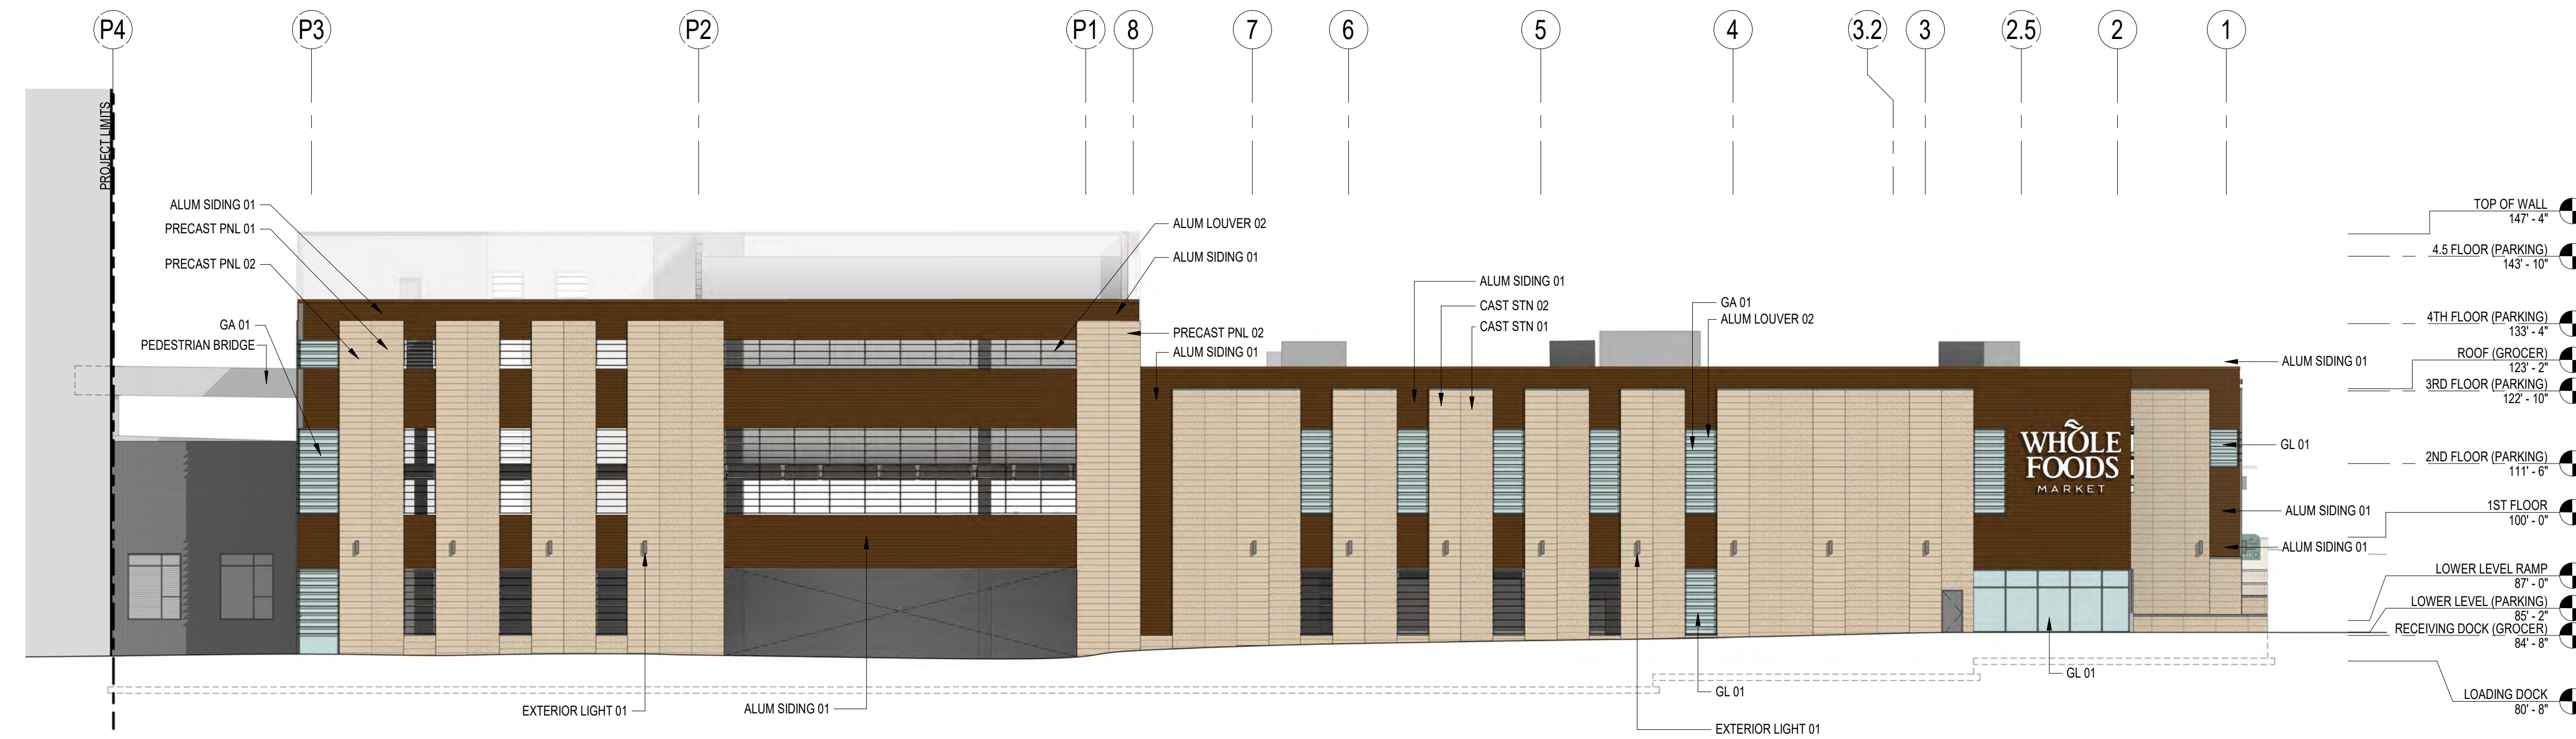

2 COLOR - NORTH ELEVATION  
1/16" = 1'-0"  
SCALE: 1/16" = 1'-0"

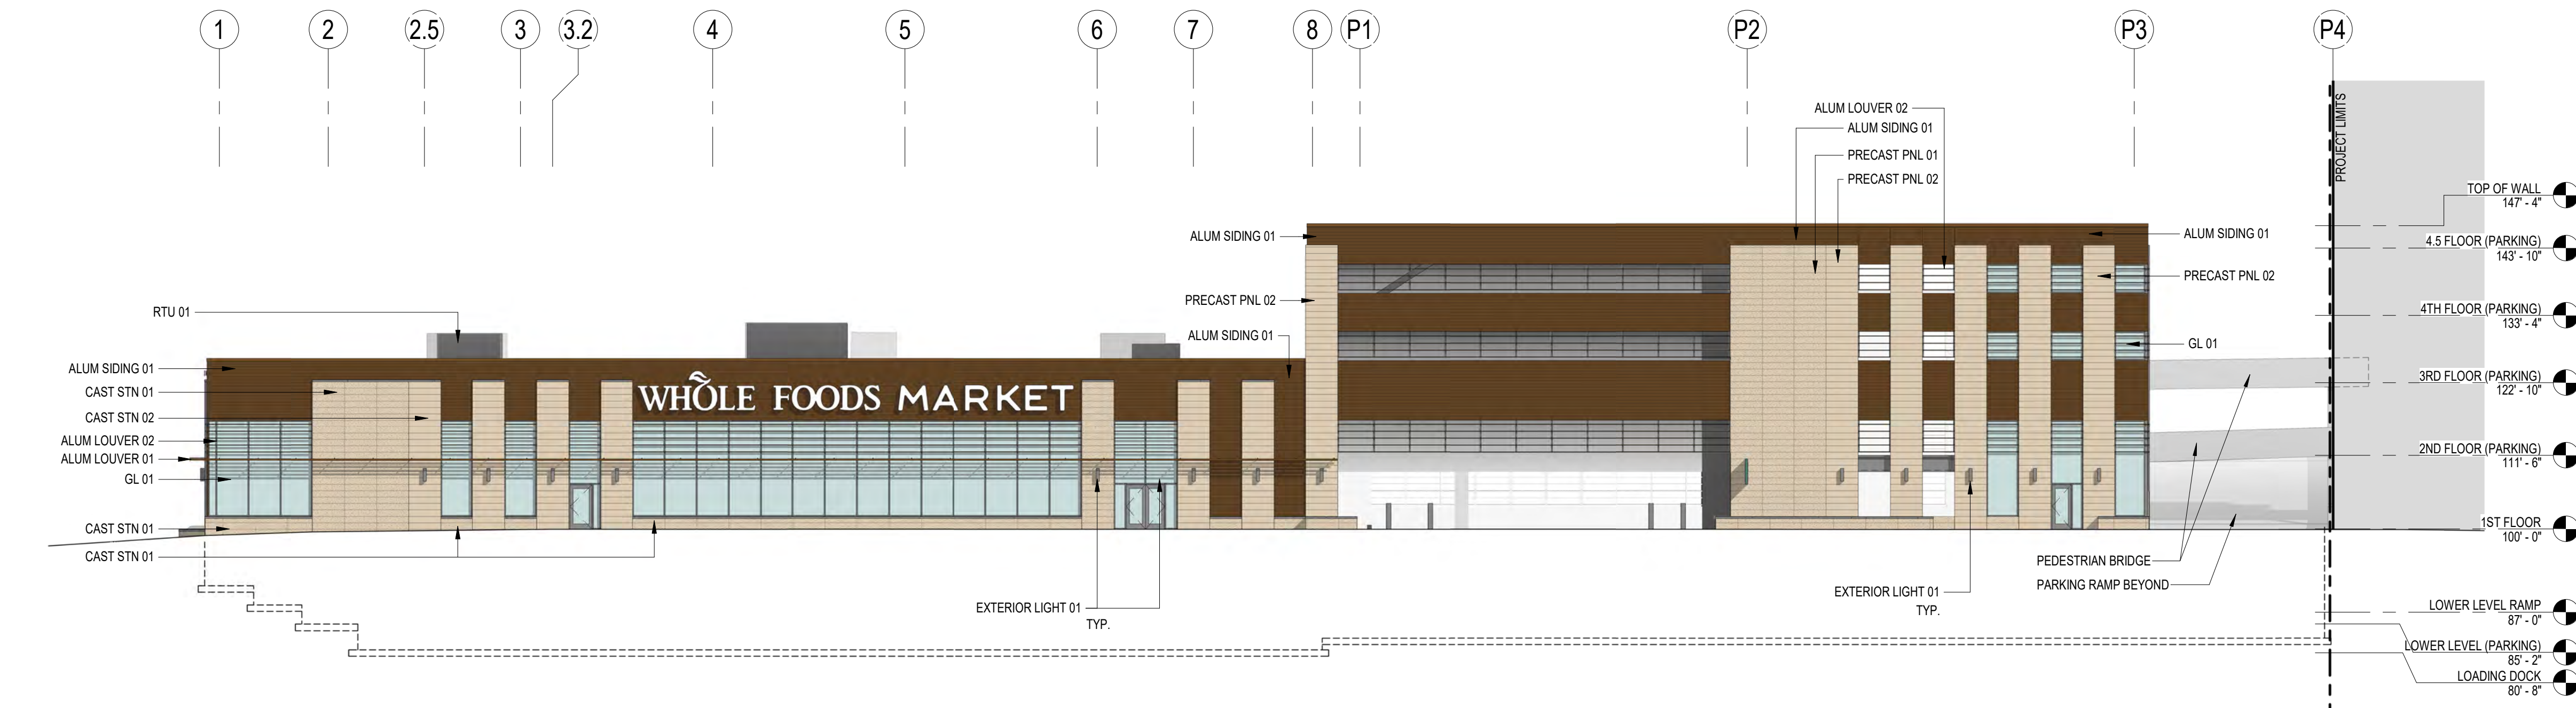

1 COLOR - SOUTH ELEVATION  
1/16" = 1'-0"  
SCALE: 1/16" = 1'-0"

Revisions

GMP/SIP PACKAGE

Drawing Date  
NOVEMBER 17, 2020

MADISON YARDS:  
BLOCK 2 - GROCER  
BASE CORE & SHELL  
UNIVERSITY AVENUE AT GARDNER ROAD

Project No. SUMMIT SMITH/GILBANE  
219143.00

Sheet Title  
EXTERIOR ELEVATIONS

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Sheet No.  
A2-A10C



EXTERIOR ELEVATION GENERAL NOTES

1. ALL SIGNAGE SUBJECT TO APPROVAL BY CITY OF MADISON
2. ALL METAL SURFACES EXPOSED TO VIEW (INCLUDING MISCELLANEOUS METALS, PIPING, MECHANICAL EQUIPMENT, LADDERS, STAIRS, RAILING, COLUMNS, PLATFORMS, ETC.) SHALL BE PAINTED U.N.O.
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5. PROVIDE CONTROL JOINTS AT INSIDE CORNERS OF BRICK AND STONE.

ASSEMBLIES & COMPONENTS

ALUM LOUVER 01	DECORATIVE HORIZONTAL EXTRUDED ALUMINUM WOOD-LOOK LOUVER. BASIS OF DESIGN: LONGBOARD FIXED LOUVER SYSTEM
ALUM LOUVER 02	DECORATIVE VERTICAL EXTRUDED ALUMINUM WOOD-LOOK LOUVER. BASIS OF DESIGN: LONGBOARD FIXED LOUVER SYSTEM
ALUM SIDING 01	ALUMINUM WOOD-LOOK SIDING SYSTEM - SEE ELEVATIONS FOR SIZE AND COURSING. COLOR TBD. BASIS OF DESIGN: LONGBOARD PLANK SYSTEM
CAST STN 01	CAST STONE MASONRY - SEE ELEVATIONS FOR SIZE AND COURSING. COLOR TBD. BASIS OF DESIGN: STONECAST PRODUCTS FULL DEPTH VENEER
CAST STN 02	CAST STONE MASONRY - SEE ELEVATIONS FOR SIZE AND COURSING. COLOR TBD. BASIS OF DESIGN: STONECAST PRODUCTS FULL DEPTH VENEER
EXTERIOR LIGHT 01	EXTERIOR DOWN-LIGHT SCONCE
GA 01	ALUMINUM FRAMED ENTRANCES AND STOREFRONTS. BASIS OF DESIGN: KAWNEER 601T GLAZING SYSTEM
ROOF EDGE 01	PREFINISHED METAL ROOF EDGE SYSTEM. COLOR TO MATCH MF-1



- ROOF EDGE 01
- ALUM SIDING 01
- CAST STN 01
- CAST STN 02
- ALUM LOUVER 02
- ALUM LOUVER 01
- EXTERIOR LIGHT 01
- GA 01
- CAST STN 01

1 SOUTHWEST PERSPECTIVE  
NOT TO SCALE



- ROOF EDGE 01
- ALUM SIDING 01
- ALUM LOUVER 02
- ALUM LOUVER 01
- GA 01
- CAST STN 01
- CAST STN 02

2 SOUTHEAST PERSPECTIVE  
NOT TO SCALE



- ALUM SIDING 01
- ALUM LOUVER 02

3 SOUTHEAST PERSPECTIVE 2  
NOT TO SCALE

NOT FOR CONSTRUCTION

Revisions

GMP/SIP PACKAGE

Drawing Date  
NOVEMBER 17, 2020


**MADISON YARDS:  
BLOCK 2 - GROCER  
BASE CORE & SHELL**  
UNIVERSITY AVENUE AT GARDNER ROAD

Project No. SUMMIT SMITH/GILBANE  
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**EXTERIOR  
PERSPECTIVES**

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Sheet No.  
**A2-A20**



EXTERIOR ELEVATION GENERAL NOTES
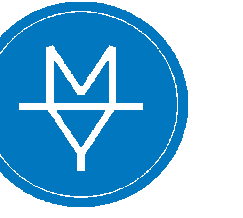
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5. PROVIDE CONTROL JOINTS AT INSIDE CORNERS OF BRICK AND STONE.

ASSEMBLIES & COMPONENTS

ALUM LOUVER 01	DECORATIVE HORIZONTAL EXTRUDED ALUMINUM WOOD-LOOK LOUVER. BASIS OF DESIGN: LONGBOARD FIXED LOUVER SYSTEM
ALUM LOUVER 02	DECORATIVE VERTICAL EXTRUDED ALUMINUM WOOD-LOOK LOUVER. BASIS OF DESIGN: LONGBOARD FIXED LOUVER SYSTEM
ALUM SIDING 01	ALUMINUM WOOD-LOOK SIDING SYSTEM - SEE ELEVATIONS FOR SIZE AND COURSING. COLOR TBD. BASIS OF DESIGN: LONGBOARD PLANK SYSTEM
CAST STN 01	CAST STONE MASONRY - SEE ELEVATIONS FOR SIZE AND COURSING. COLOR TBD. BASIS OF DESIGN: STONECAST PRODUCTS FULL DEPTH VENEER
CAST STN 02	CAST STONE MASONRY - SEE ELEVATIONS FOR SIZE AND COURSING. COLOR TBD. BASIS OF DESIGN: STONECAST PRODUCTS FULL DEPTH VENEER
EXTERIOR LIGHT 01	EXTERIOR DOWN-LIGHT SCIENCE
GA 01	ALUMINUM FRAMED ENTRANCES AND STOREFRONTS. BASIS OF DESIGN: KAWNEER 601T GLAZING SYSTEM
ROOF EDGE 01	PREFINISHED METAL ROOF EDGE SYSTEM. COLOR TO MATCH MF-1



3 NORTHWEST PERSPECTIVE  
NOT TO SCALE

ROOF EDGE 01  
ALUM SIDING 01  
CAST STN 02  
CAST STN 01  
GA 01  
ALUM LOUVER 02  
EXTERIOR LIGHT 01

NOT FOR  
CONSTRUCTION

Revisions

GMP/SIP PACKAGE

Drawing Date  
NOVEMBER 17, 2020

MADISON YARDS:  
BLOCK 2 - GROCER  
BASE CORE & SHELL

UNIVERSITY AVENUE AT GARDNER ROAD

Project No. SUMMIT SMITH/GILBANE  
219143.00

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EXTERIOR  
PERSPECTIVES

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Sheet No.  
A2-A21




ROOF EDGE 01  
ALUM SIDING 01  
ALUM LOUVER 02  
CAST STN 01  
CAST STN 02  
EXTERIOR LIGHT 01  
GA 01

2 NORTHWEST PERSPECTIVE  
NOT TO SCALE



ROOF EDGE 01  
ALUM SIDING 01  
CAST STN 01  
CAST STN 02  
ALUM LOUVER 02  
ALUM LOUVER 01  
EXTERIOR LIGHT 01  
GA 01  
CAST STN 01


1 SOUTHWEST PERSPECTIVE  
NOT TO SCALE

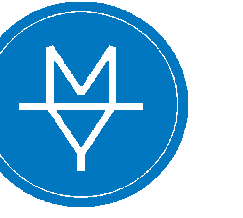


ASSEMBLIES & COMPONENTS

FA 01A	6" CONCRETE SLAB ON GRADE OVER VAPOR RETARDER OVER COMPACTED GRANULAR FILL
FA 01B	8" CONCRETE SLAB ON GRADE OVER VAPOR RETARDER OVER COMPACTED GRANULAR FILL
FA 02	6" CONCRETE SLAB ON GRADE ON 2" OF EXTRUDED POLYSTYRENE INSULATION WITH RADIANT HEAT SNOW MELT SYSTEM OVER VAPOR RETARDER OVER COMPACTED GRANULAR FILL
FA 03A	7" CONCRETE ON COMPOSITE METAL DECK ON STEEL BEAMS WITH SPRAY APPLIED FIREPROOFING (1-HOUR FIRE RATING)
FA 04	PRECAST CONCRETE DOUBLE TEE - SEE STRUCTURAL
FA 05B	4" CONCRETE SLAB ON 2" OF EXTRUDED POLYSTYRENE INSULATION WITH RADIANT HEAT SNOW MELT SYSTEM ON PRECAST CONCRETE PLANK - SEE STRUCTURAL
FA 06	5" CONCRETE SLAB (BY TENANT) ON 4" OF 40 PSI EXTRUDED POLYSTYRENE INSULATION (R-20 MINIMUM) & WATERPROOFING MEMBRANE, OVER FLOOR ASSEMBLY 03A
RA 01	FULLY ADHERED TPO MEMBRANE ON RIGID INSULATION, VAPOR RETARDER, COVERBOARD, METAL DECK OVER STRUCTURAL STEEL JOISTS WITH SPRAY APPLIED FIREPROOFING (1-HOUR FIRE RATING MINIMUM)
WA 07	PRECAST CONCRETE WALL - PAINTED - REFER TO ASSEMBLIES SHEET FOR MORE INFORMATION


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8 BUILDING SECTION 8 - E/W AT LOADING DOCK  
1/16" = 1'-0"

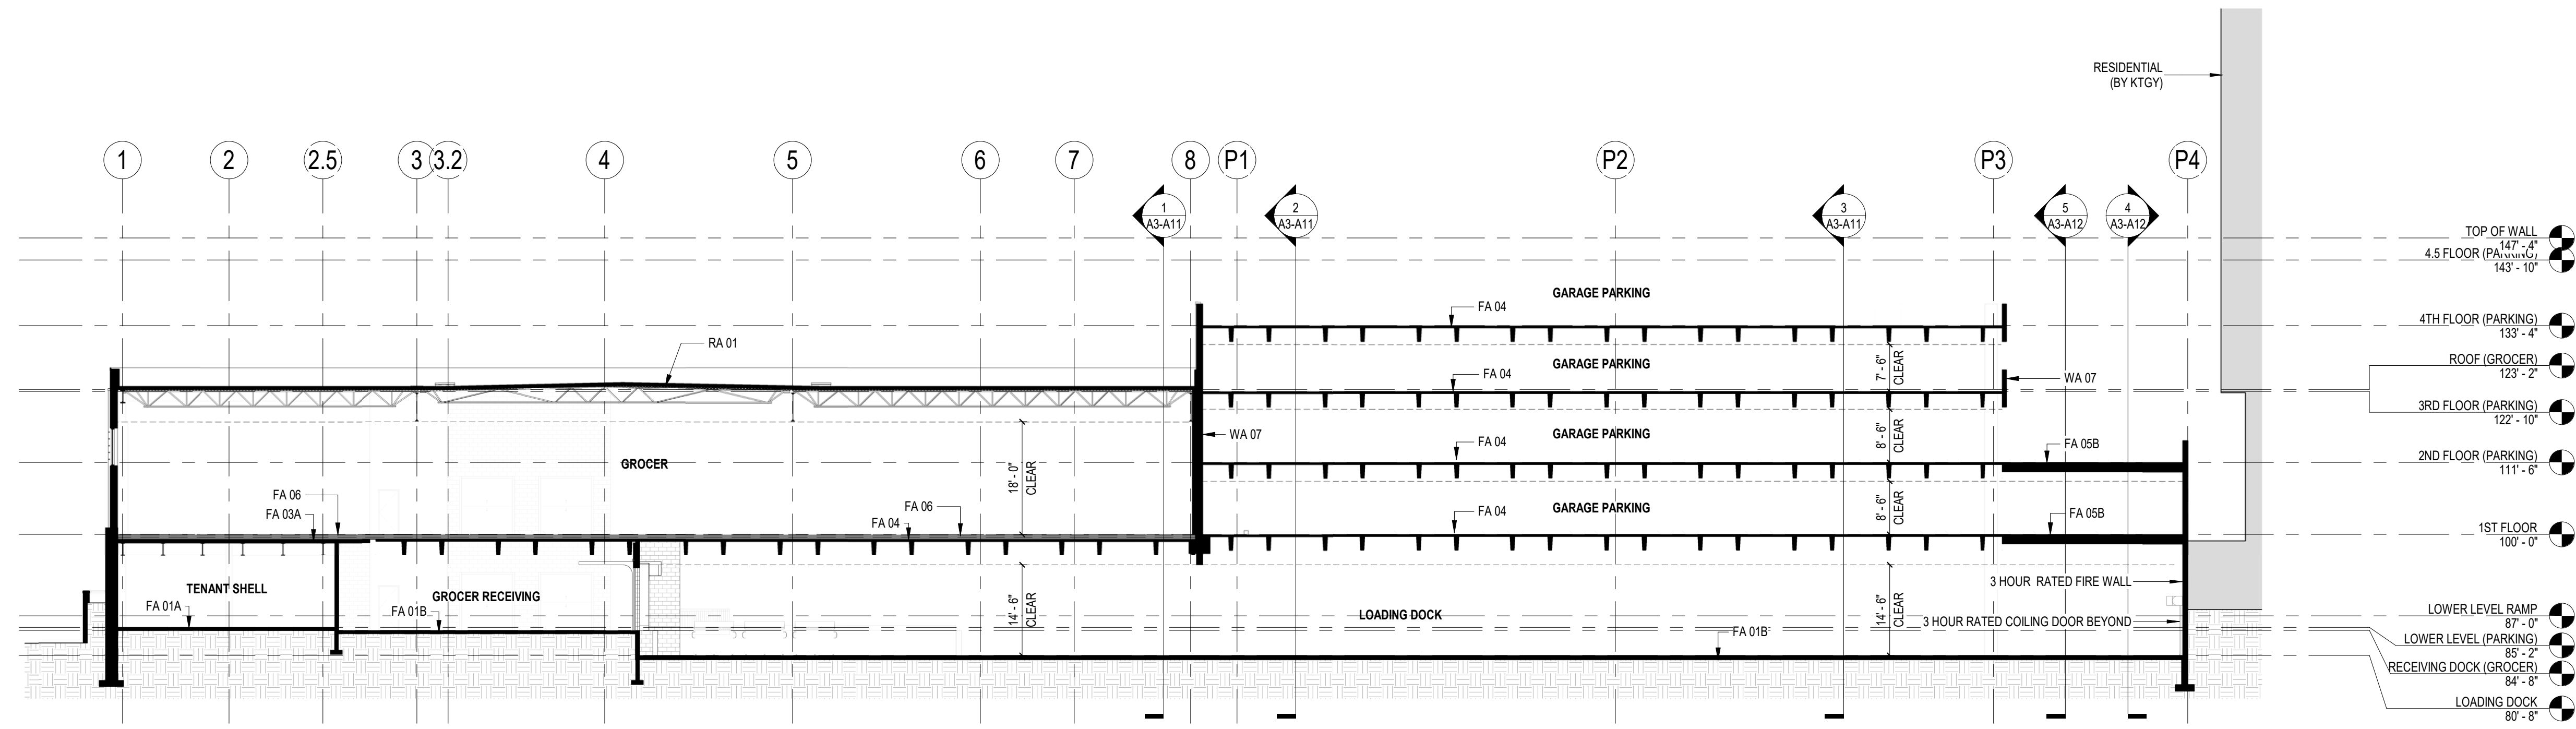

7 BUILDING SECTION 7 - E/W AT ENTRY RAMPS  
1/16" = 1'-0"

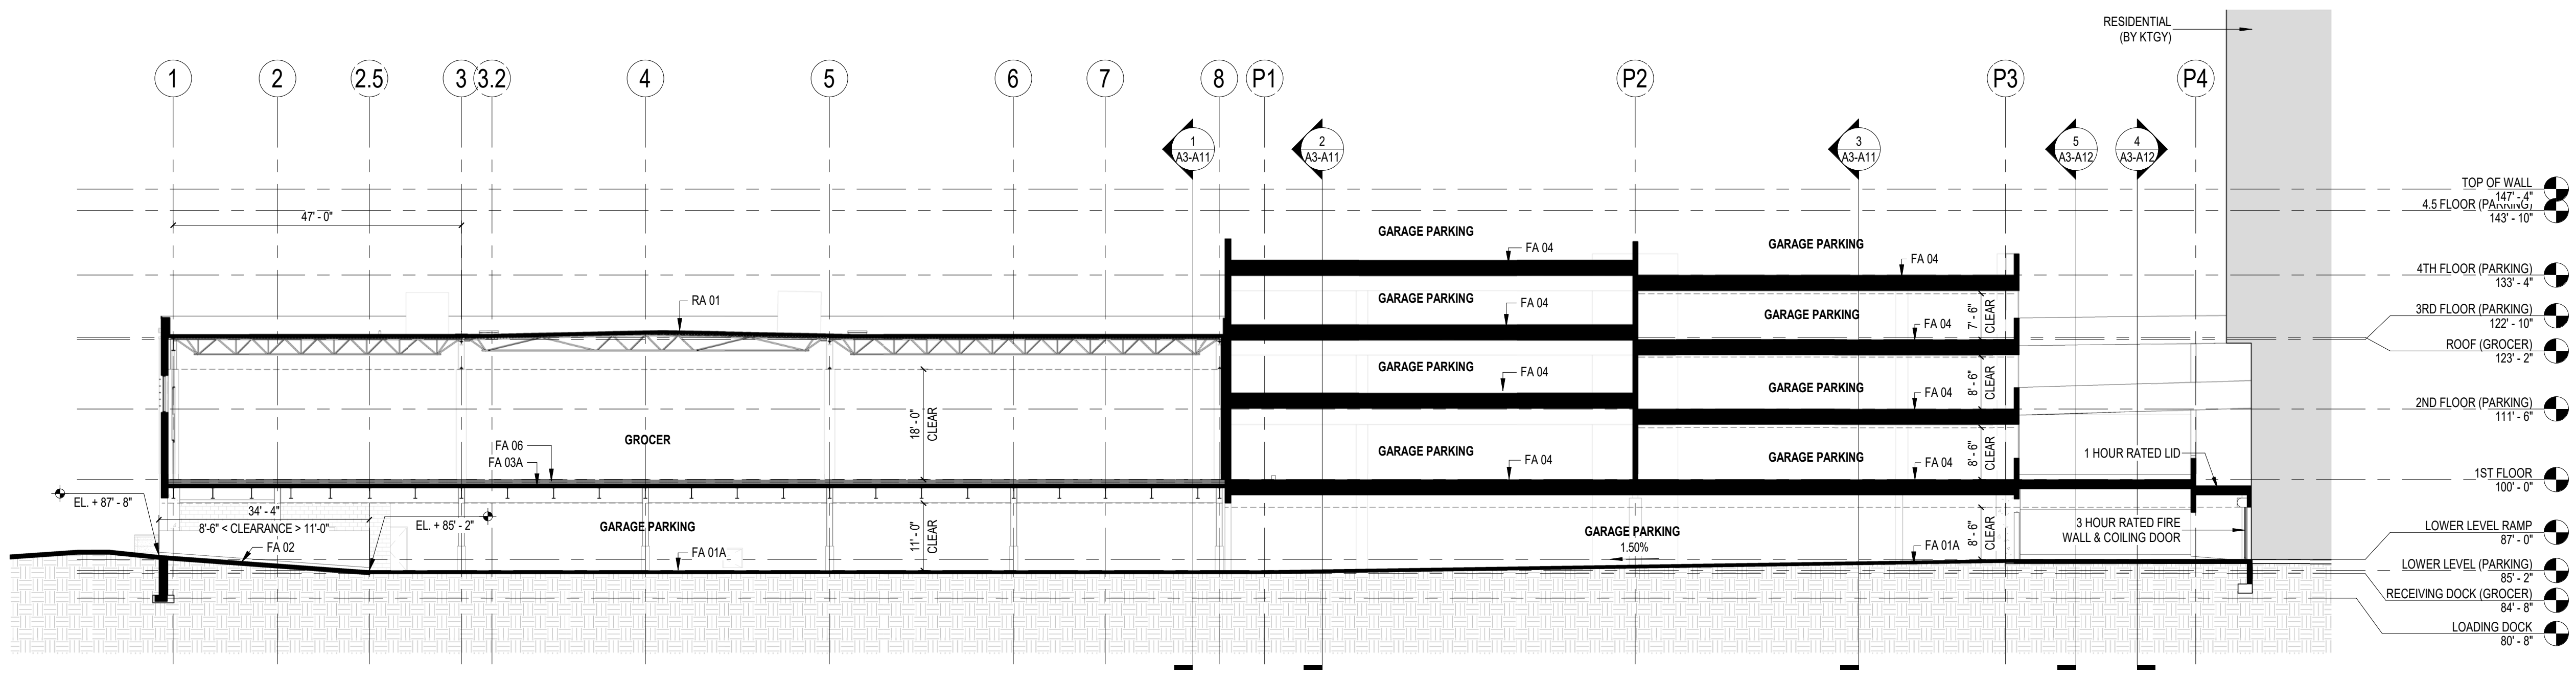

6 BUILDING SECTION 6 - E/W  
1/16" = 1'-0"

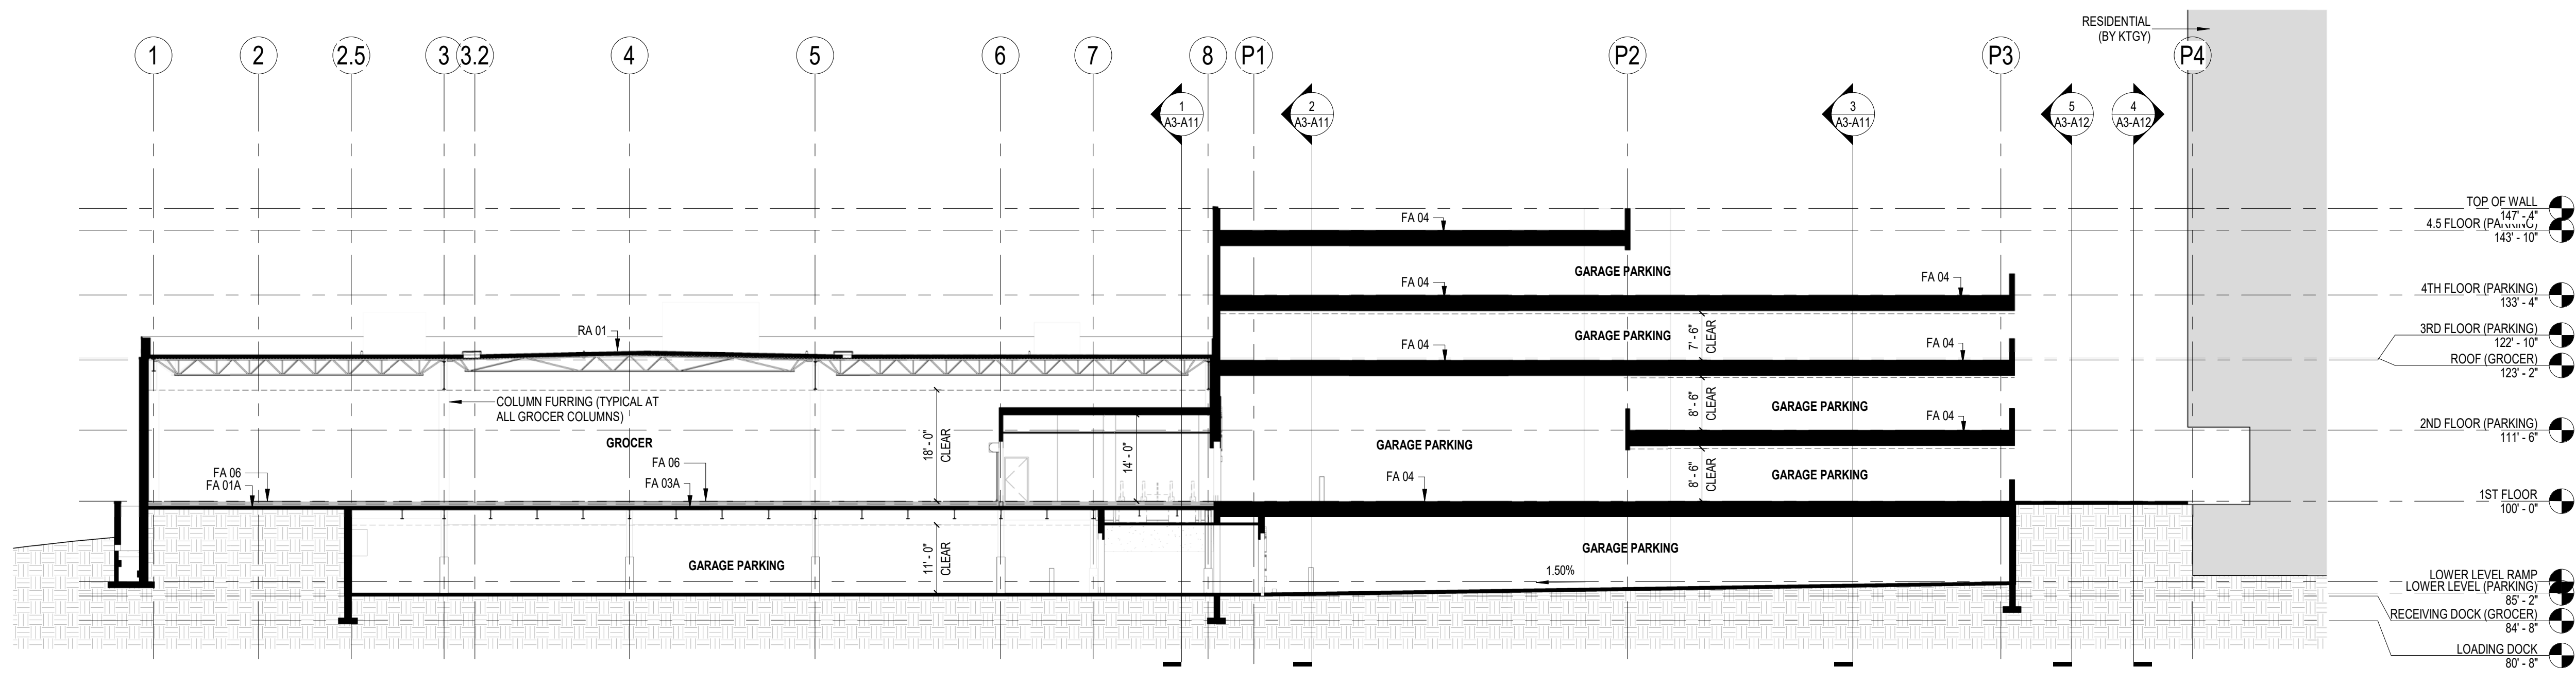Revisions

GMP/SIP PACKAGE

Drawing Date  
NOVEMBER 17, 2020

**MADISON YARDS:  
BLOCK 2 - GROCER  
BASE CORE & SHELL**

UNIVERSITY AVENUE AT GARDNER ROAD

Project No. SUMMIT SMITH/GILBANE  
219143.00

Sheet Title  
**BUILDING SECTIONS**

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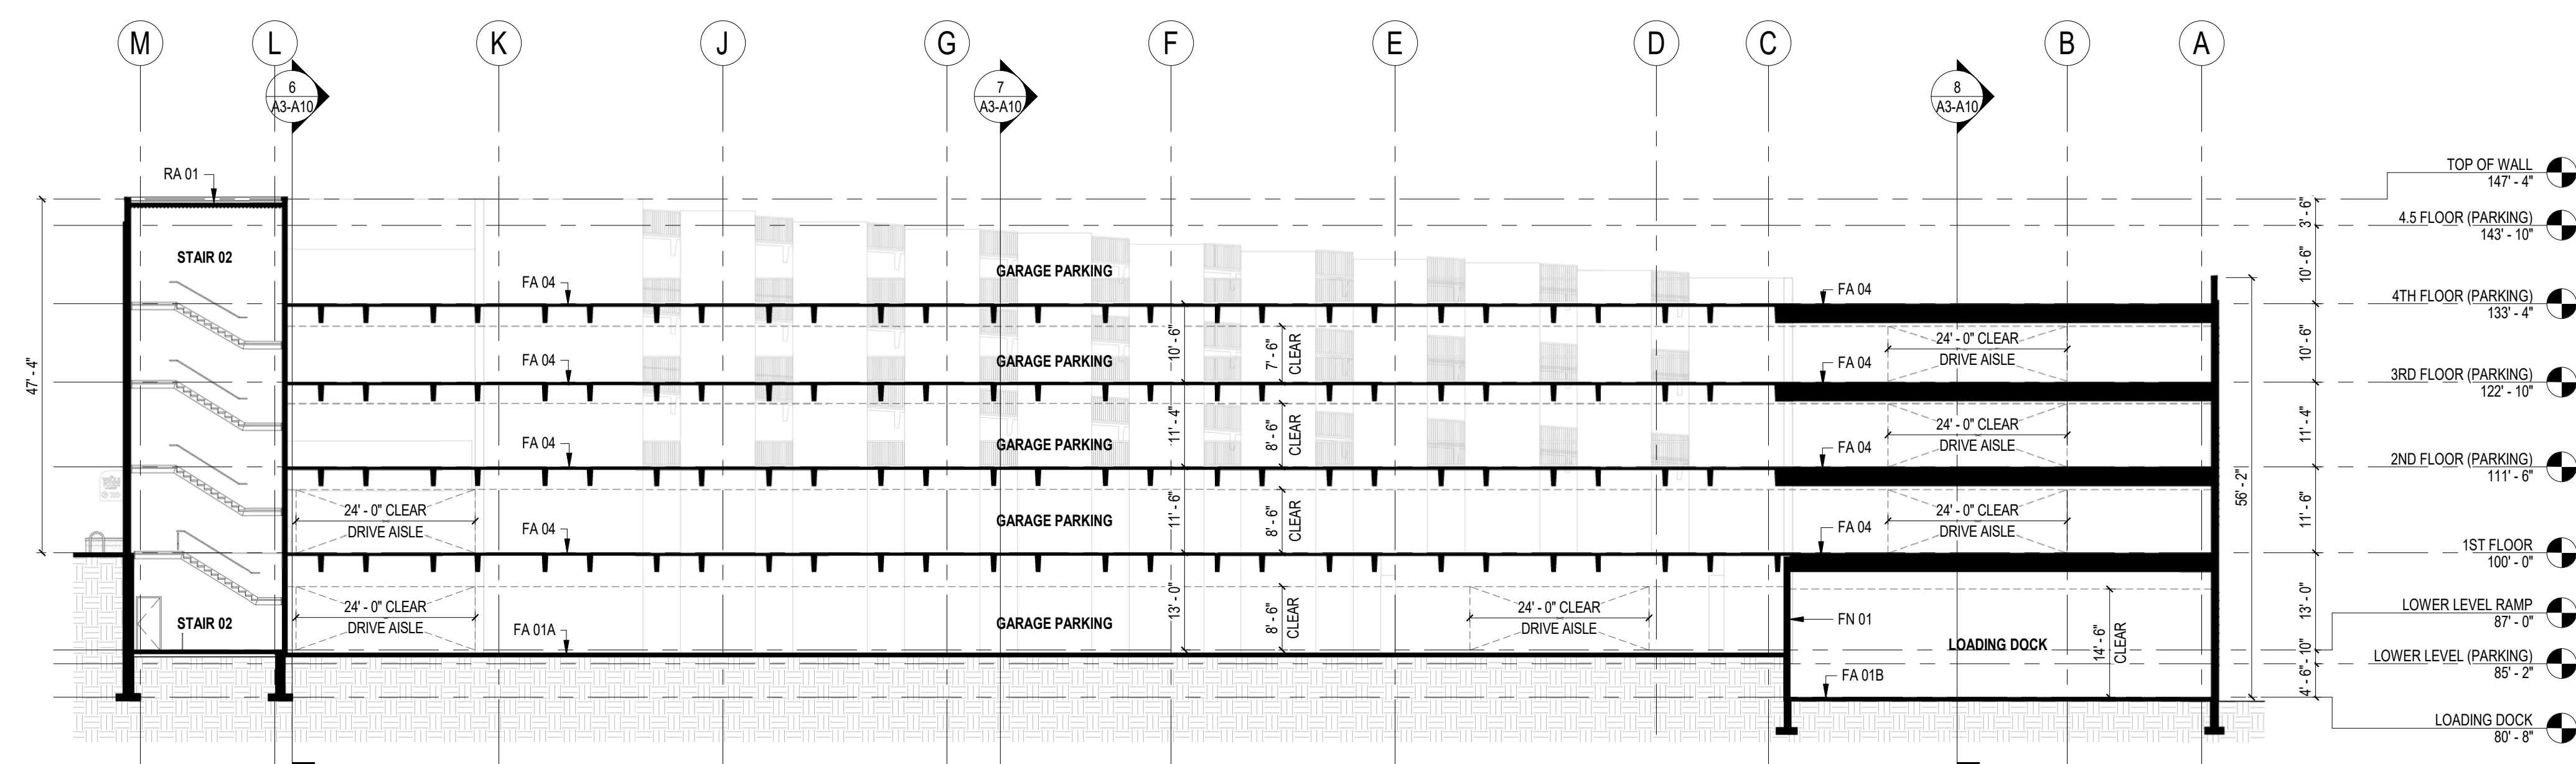
Sheet No.  
**A3-A10**

ASSEMBLIES & COMPONENTS


FA 01A	8" CONCRETE SLAB ON GRADE OVER VAPOR RETARDER OVER COMPACTED GRANULAR FILL
FA 01B	8" CONCRETE SLAB ON GRADE OVER VAPOR RETARDER OVER COMPACTED GRANULAR FILL
FA 03A	7" CONCRETE ON COMPOSITE METAL DECK ON STEEL BEAMS WITH SPRAY APPLIED FIREPROOFING (1-HOUR FIRE RATING)
FA 04	PRECAST CONCRETE DOUBLE TEE - SEE STRUCTURAL
FA 06	5" CONCRETE SLAB (BY TENANT) ON 4" OF 40 PSI EXTRUDED POLYSTYRENE INSULATION (R-20 MINIMUM) & WATERPROOFING MEMBRANE OVER FLOOR ASSEMBLY 03A
FN 01	CAST-IN-PLACE CONCRETE FOUNDATION WALL - REFER TO ASSEMBLIES SHEET FOR MORE INFORMATION
RA 01	FULLY ADHERED TPO MEMBRANE ON RIGID INSULATION, VAPOR RETARDER, COVERBOARD, METAL DECK OVER STRUCTURAL STEEL JOISTS WITH SPRAY APPLIED FIREPROOFING (1-HOUR FIRE RATING MINIMUM)




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3 BUILDING SECTION 3 - N/S AT PARKING  
1/16" = 1'-0"



2 BUILDING SECTION 2 - N/S AT PARKING  
1/16" = 1'-0"

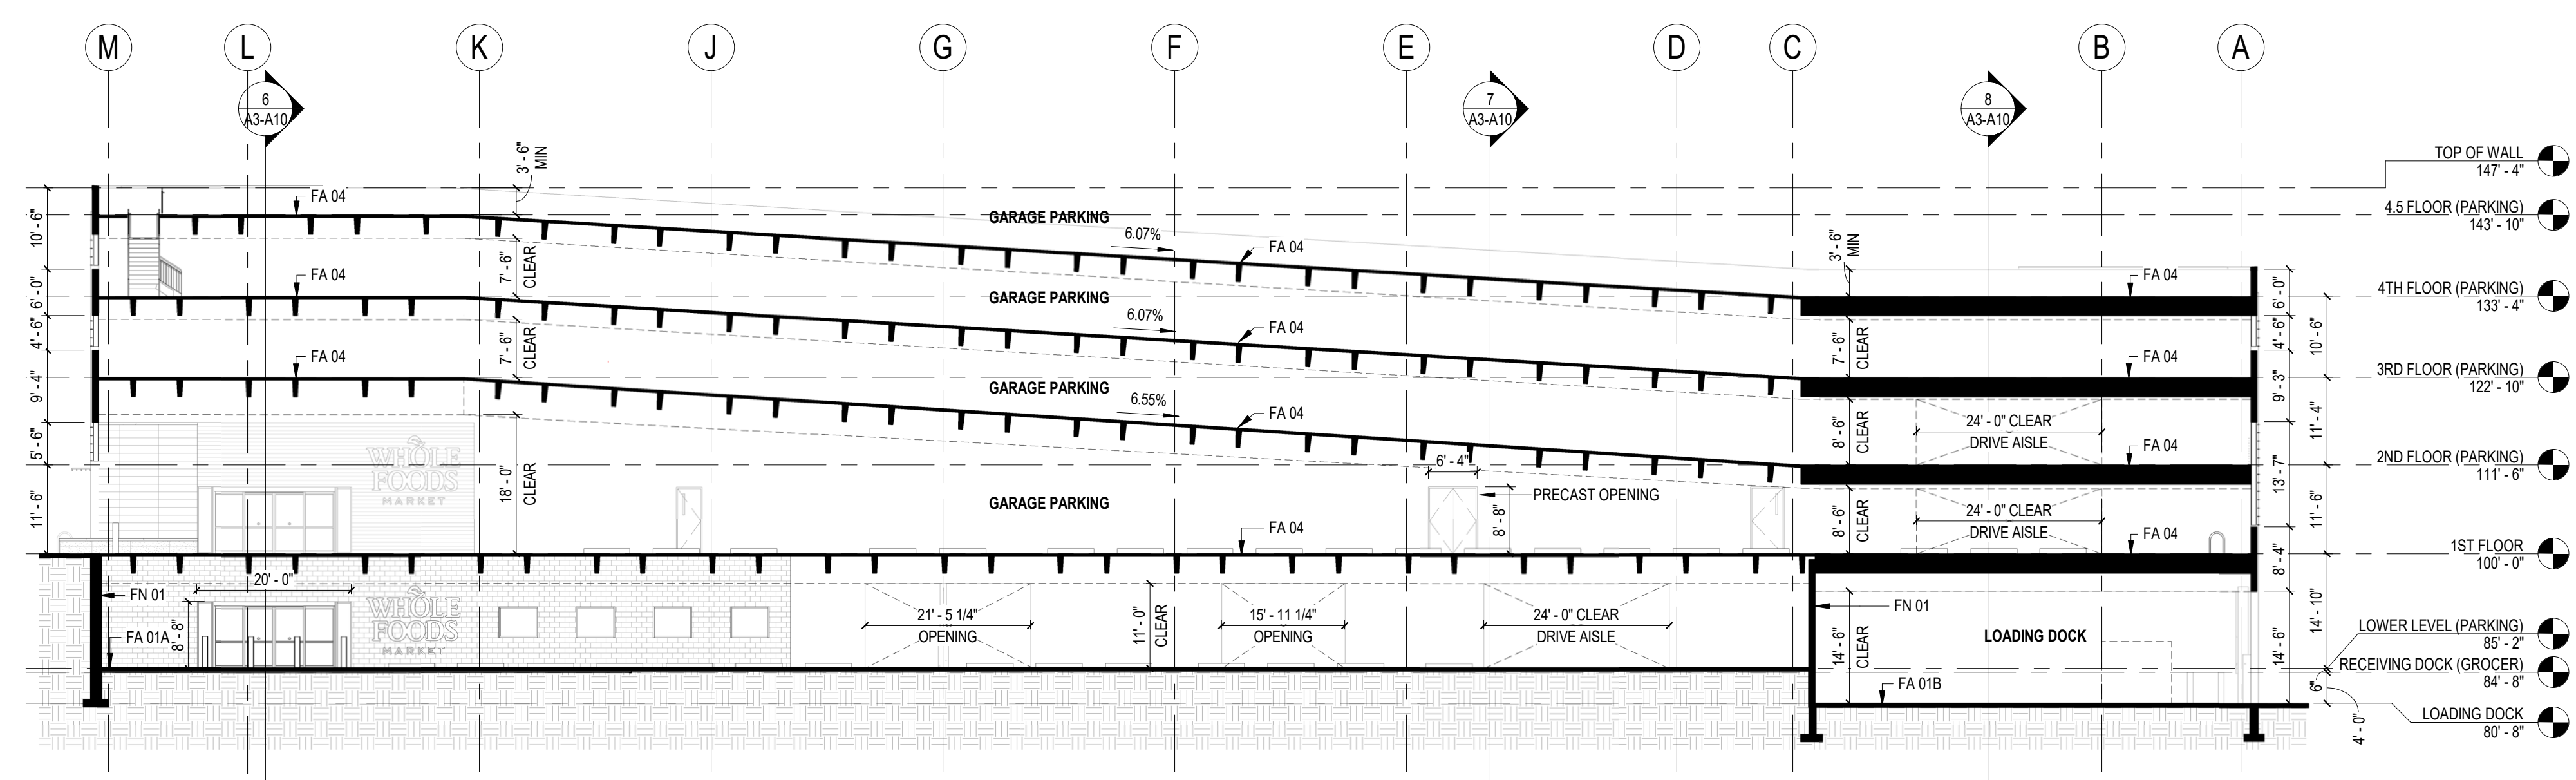

1 BUILDING SECTION 1 - N/S AT GROCER  
1/16" = 1'-0"

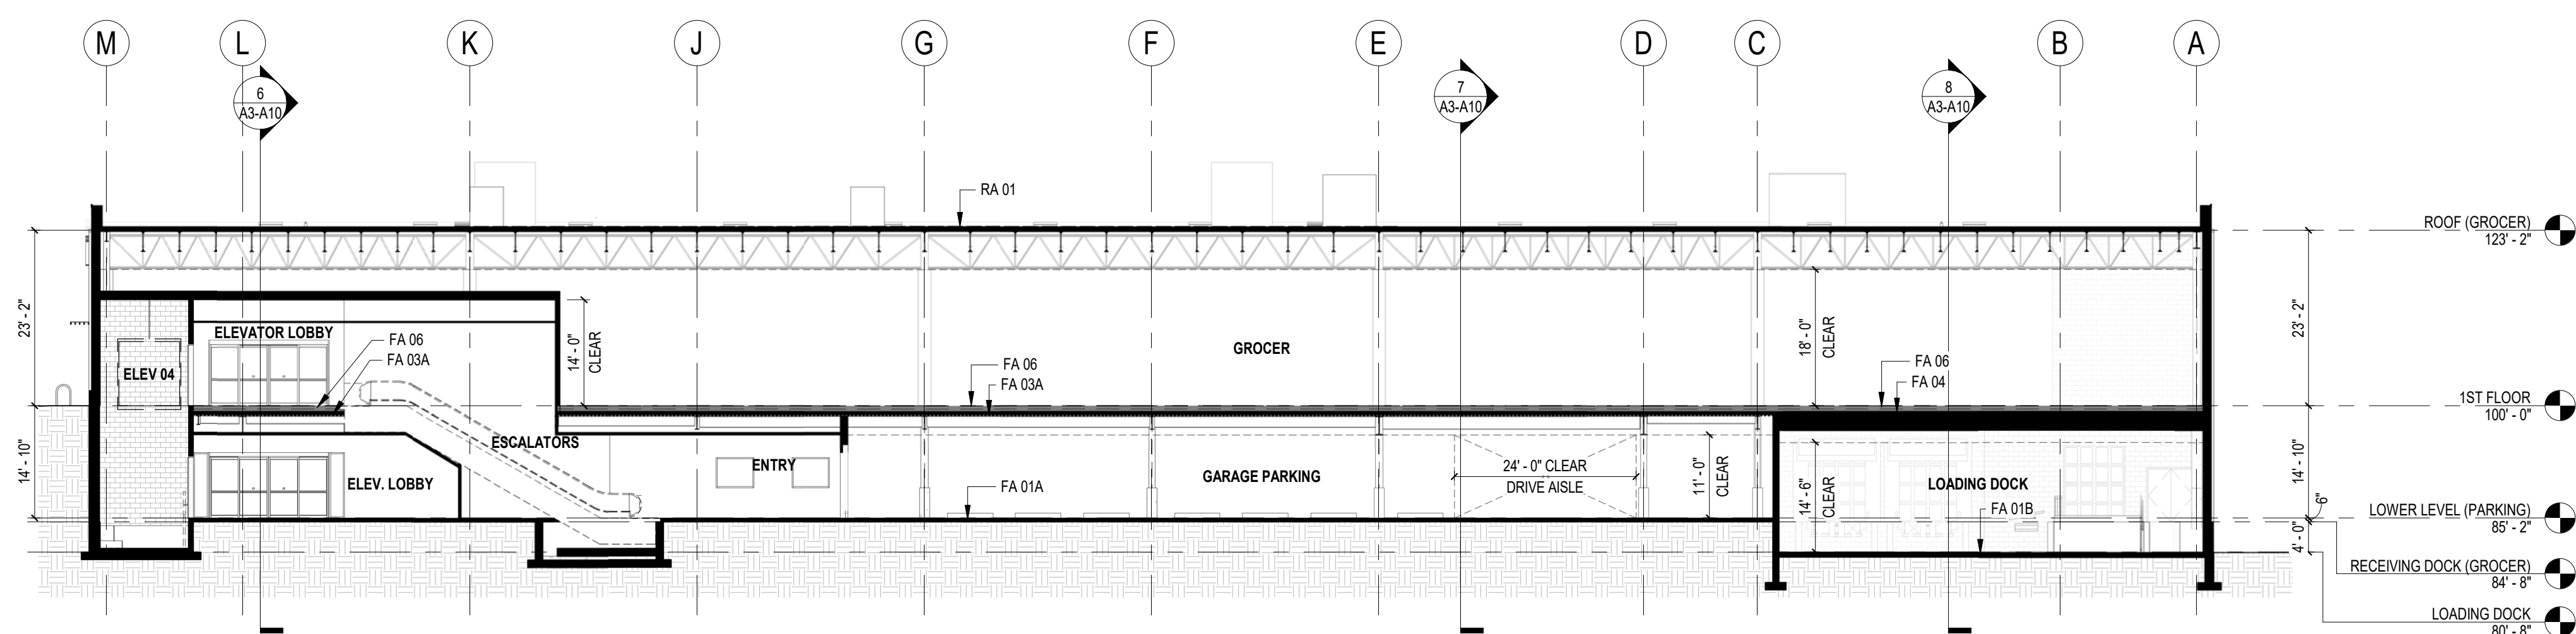Revisions

GMP/SIP PACKAGE

Drawing Date  
NOVEMBER 17, 2020

MADISON YARDS:  
BLOCK 2 - GROCER  
BASE CORE & SHELL


UNIVERSITY AVENUE AT GARDNER ROAD

Project No. SUMMIT SMITH/GILBANE  
219143.00

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BUILDING SECTIONS

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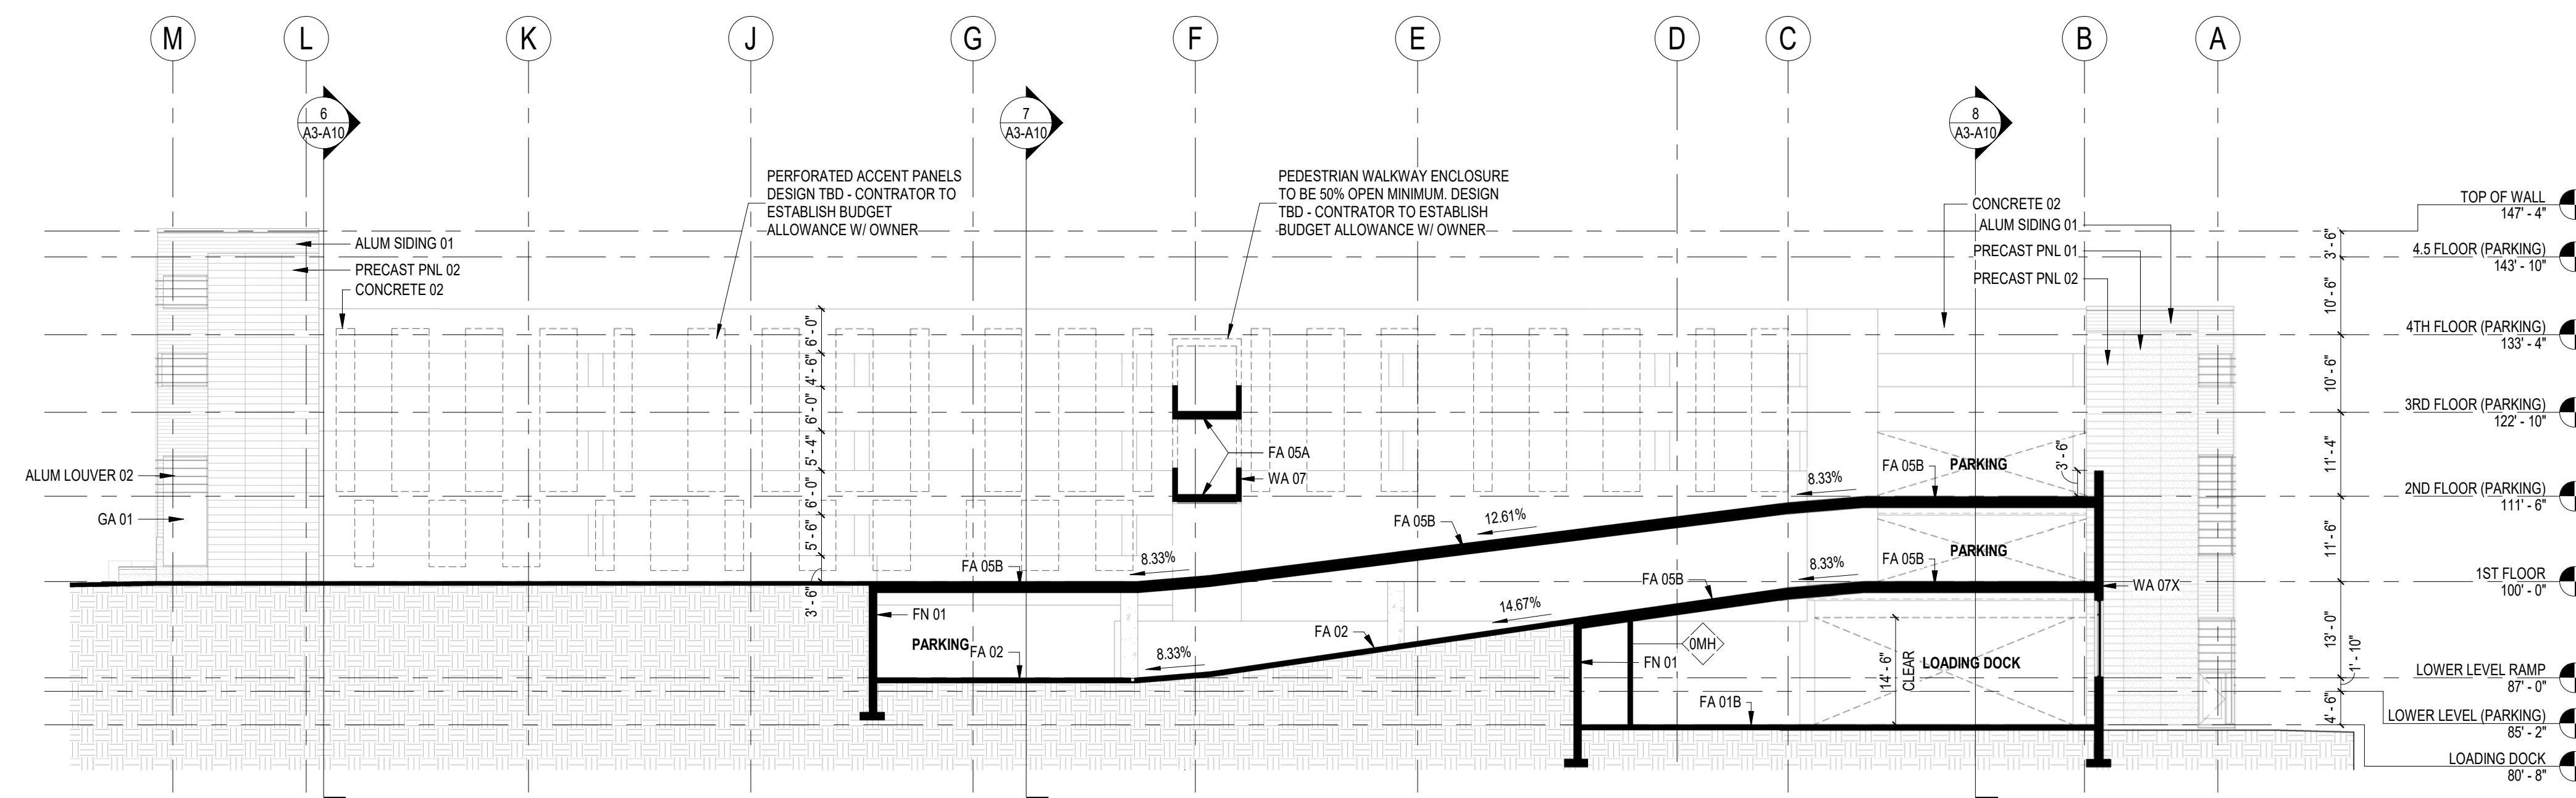
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A3-A11

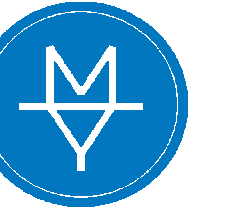


ASSEMBLIES & COMPONENTS

ALUM LOUVER 02	DECORATIVE VERTICAL EXTRUDED ALUMINUM WOOD-LOOK LOUVER. BASIS OF DESIGN: LONGBOARD FIXED LOUVER SYSTEM
ALUM SIDING 01	ALUMINUM WOOD-LOOK SIDING SYSTEM - SEE ELEVATIONS FOR SIZE AND COURSEING. COLOR TBD. BASIS OF DESIGN: LONGBOARD PLANK SYSTEM
CONCRETE 02	PRE-CAST CONCRETE
FA 01A	6" CONCRETE SLAB ON GRADE OVER VAPOR RETARDER OVER COMPACTED GRANULAR FILL
FA 01B	8" CONCRETE SLAB ON GRADE OVER VAPOR RETARDER OVER COMPACTED GRANULAR FILL
FA 02	6" CONCRETE SLAB ON GRADE ON 2" OF EXTRUDED POLYSTYRENE INSULATION WITH RADIANT HEAT SNOW MELT SYSTEM OVER VAPOR RETARDER OVER COMPACTED GRANULAR FILL
FA 05A	PRECAST CONCRETE PLANK - SEE STRUCTURAL
FA 05B	4" CONCRETE SLAB ON 2" OF EXTRUDED POLYSTYRENE INSULATION WITH RADIANT HEAT SNOW MELT SYSTEM ON PRECAST CONCRETE PLANK - SEE STRUCTURAL
FN 01	CAST-IN-PLACE CONCRETE FOUNDATION WALL - REFER TO ASSEMBLIES SHEET FOR MORE INFORMATION
GA 01	ALUMINUM FRAMED ENTRANCES AND STOREFRONTS. BASIS OF DESIGN: KAWNEER 8017 GLAZING SYSTEM
PRECAST PNL 01	PRE-CAST PANEL 01 - PRECAST WALL PANEL W/ MASONRY LOOK FORMLINER COLOR AND TEXTURE TO MATCH CAST STN 01
PRECAST PNL 02	PRE-CAST PANEL 02 - PRECAST WALL PANEL W/ MASONRY LOOK FORMLINER COLOR AND TEXTURE TO MATCH CAST STN 02
WA 07	PRECAST CONCRETE WALL - PAINTED - REFER TO ASSEMBLIES SHEET FOR MORE INFORMATION
WA 07X	FULL DEPTH BRICK MASONRY VENEER (MATCH RESIDENTIAL BUILDING) ON PRECAST CONCRETE BACKUP WALL - REFER TO ASSEMBLIES SHEET FOR MORE INFORMATION

NOT FOR CONSTRUCTION



5 BUILDING SECTION 4 - N/S AT SPEED RAMP  
1/16" = 1'-0"

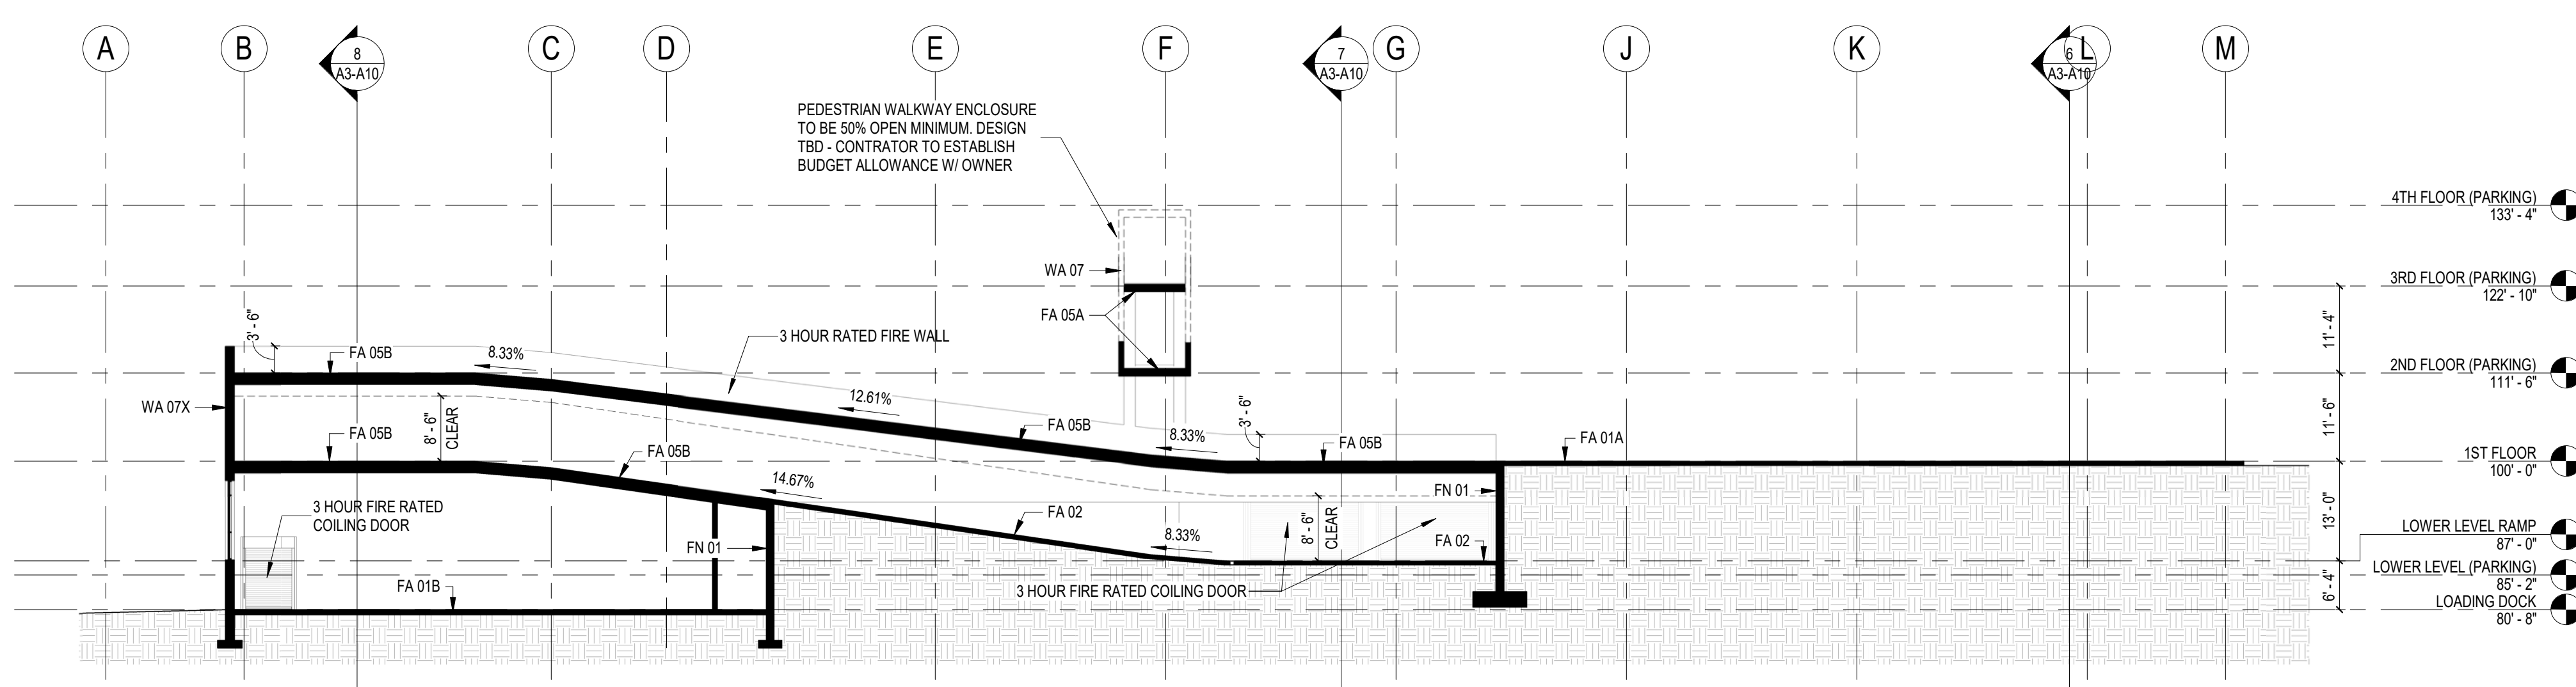

4 BUILDING SECTION 5 - N/S AT SPEED RAMP  
1/16" = 1'-0"

Revisions

GMP/SIP PACKAGE

Drawn Date  
NOVEMBER 17, 2020

MADISON YARDS:  
BLOCK 2 - GROCER  
BASE CORE & SHELL

UNIVERSITY AVENUE AT GARDNER ROAD

Project No. SUMMIT SMITH/GILBANE  
219143.00

Sheet Title  
BUILDING SECTIONS

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Sheet No.  
A3-A12





MADISON YARDS HILL FARMS

KTGY Project No: 20200326

Project Contact: Eric Lukacsik
Email: elukacsik@ktgy.com
Principal: Craig Pryde
Project Designer: Demetrios Stavrianos

Developer



PHONE NO.

MADISON YARDS BLOCK 2 BUILDING B

UNIVERSITY AVE AT SEGOE ROAD

Table with columns: Elevators (Section 3006), Required, Provided. Rows include Emergency Communication, Number of Elevator cars, Elevator Car to Accommodate Ambulance Stretcher, Elevator Lobbies and Hoistway Protection, Rated Corridor, Hoistway Opening Protection, Number of Evacuation Elevators, Fire Service Access Elevators Lobby, Lobby Enclosure, Lobby Doors, Lobby Size, Two-way Communication, Protected Duct Penetrations, Automatic Sprinkler System.

Table with columns: Mean of Egress (Section 10), Occupant Load (Section 1004.5), Spaces with one Exit / Exit Access Doorway, Remoteness of Exits, Length of Exit Access Travel, Dead End Corridor, Corridor Continuity, Egress through intervening Spaces, Exit Discharge, Accessible Means of Egress, Stairs Accessible Requirements, Stair Width, Area of Refuge Stairs, Elevators Accessible Requirements, Stand-by Power, Area of Refuge Elevators, Two-way Communication Elevators, Stairways, Corridors, Corridor Width, Doors, Door Headroom, Door Width, Door Swing, Door Encroachment, Door Hardware, Door Arrangement.

Table with columns: Project Name, Project Address, Project Description, Applicable Code, Project is fully Sprinkled as per Use and Occupancy, Group Classification, High Rise Buildings, Reduction in Fire resistance Rating, Fire Service access elevators, Remoteness of interior Exit stairways, Separations of Occupancies, Types of Construction, Maximum area of Exterior Wall Opening Based on fire Distance, Vertical Exposure Separation of Openings, Vertical Exposure Buildings on Same lot, Fire Protection and Life Safety, Automatic Sprinkler System, Standpipe System, Portable Fire Extinguishers, Smoke Detection, Fire Alarm System, Fire Command Center, Fire Department Connection.

Table with columns: No., Date, Description. Includes dates 09/20/20 and 10/17/20, and descriptions like PRELIMINARY PRICING and ISSUE FOR BIP REVIEW.

It is the client's responsibility prior to or during construction to notify the architect in writing of any personnel errors or omissions in the plans and specifications of which a contractor thorough knowledge with the building codes and methods of construction should reasonably be aware.

BUILDING B

CODE MATRIX

A0-B10





































































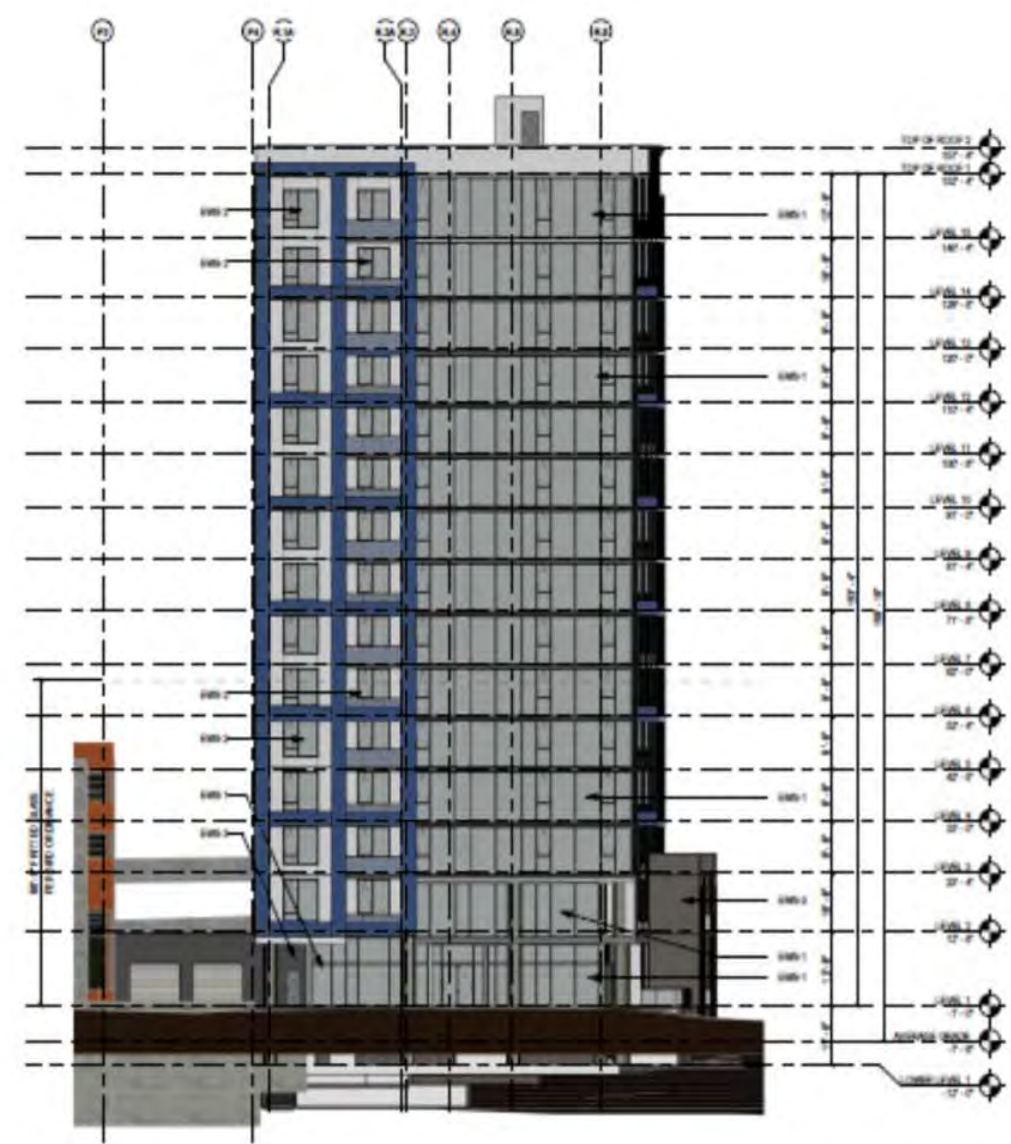


SOUTH ELEVATION



WEST ELEVATION

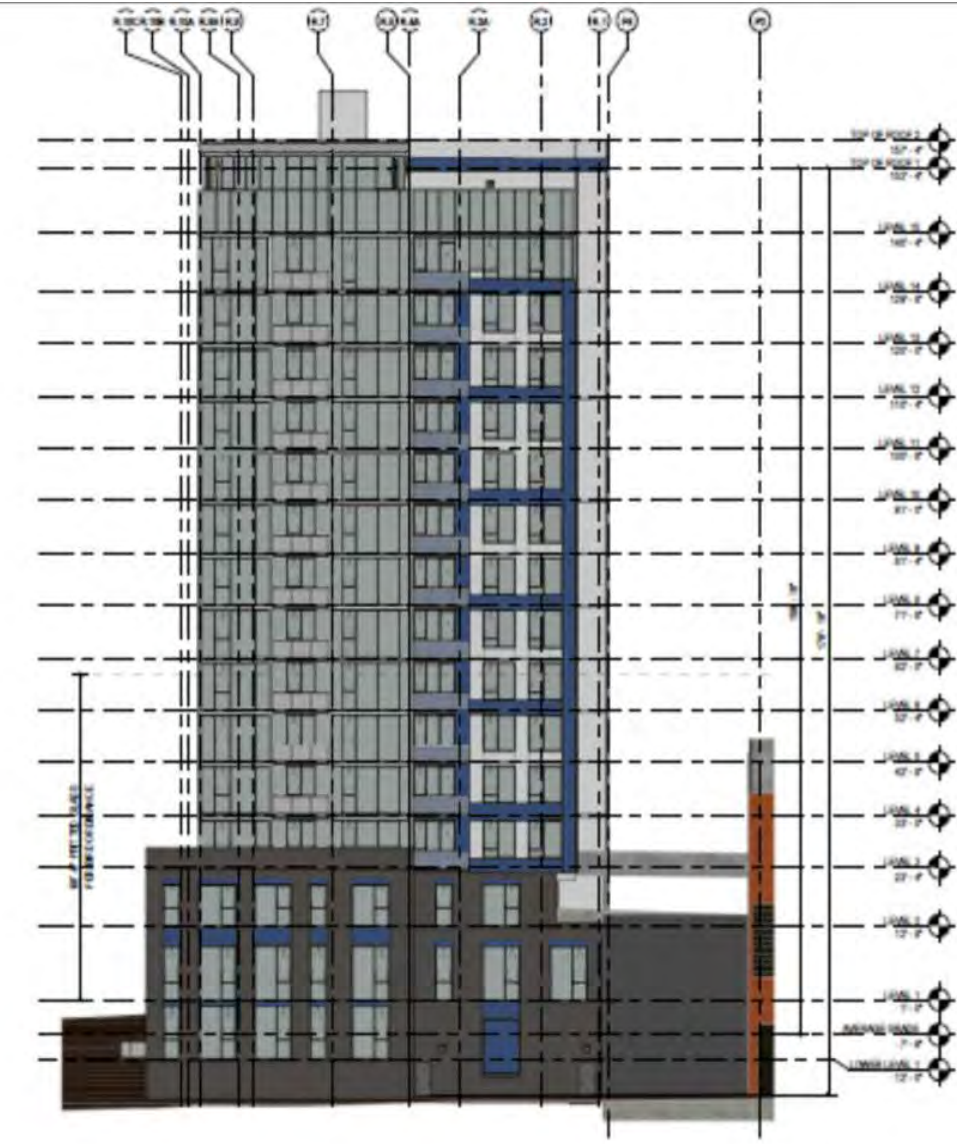

NORTH ELEVATION

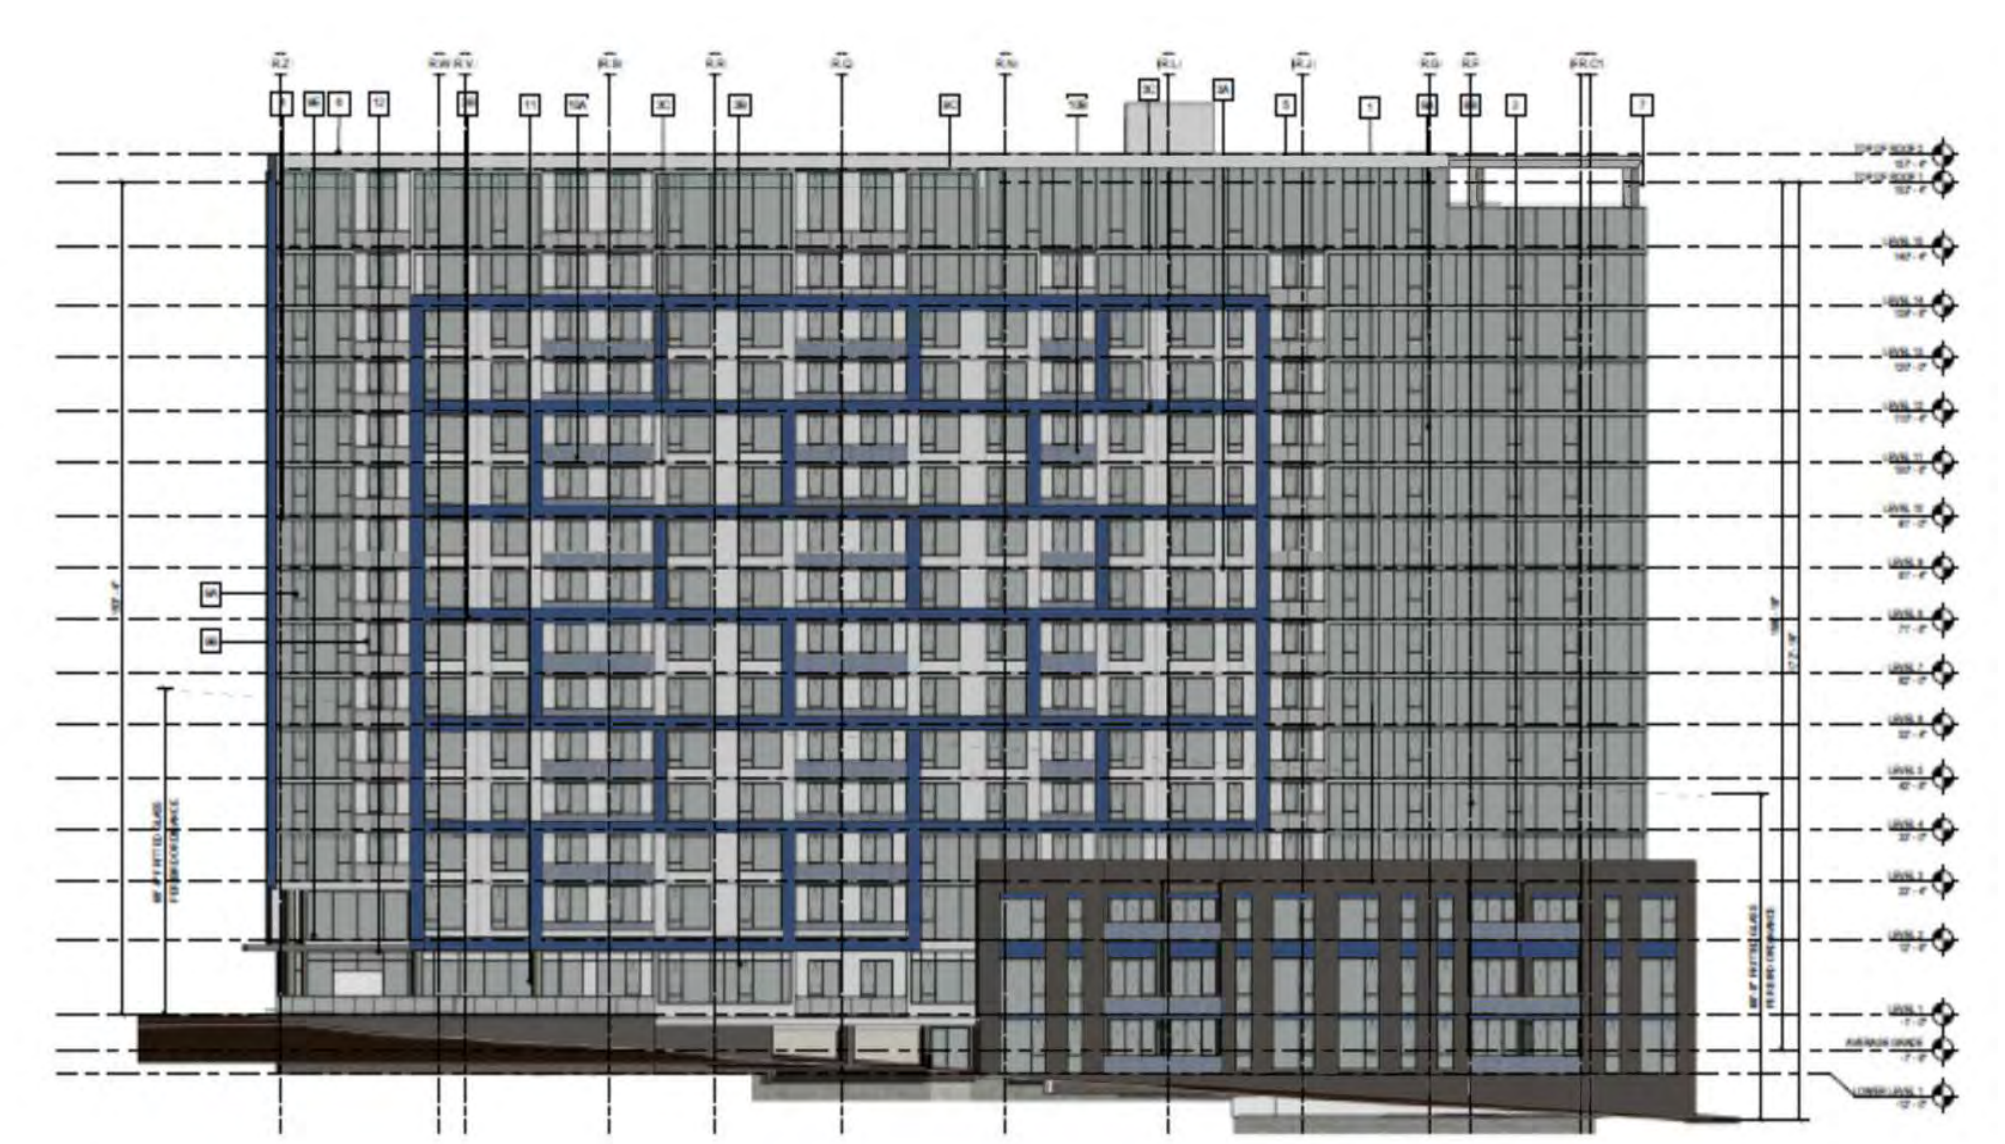


EAST ELEVATION



EWS-1 ALUMINUM AND GLASS WINDOW WALL /SLAB EDGE COVER SYSTEM (SIM)



EWS-2 INSULATED METAL PANEL/ALUMINUM WINDOWS (SIM)

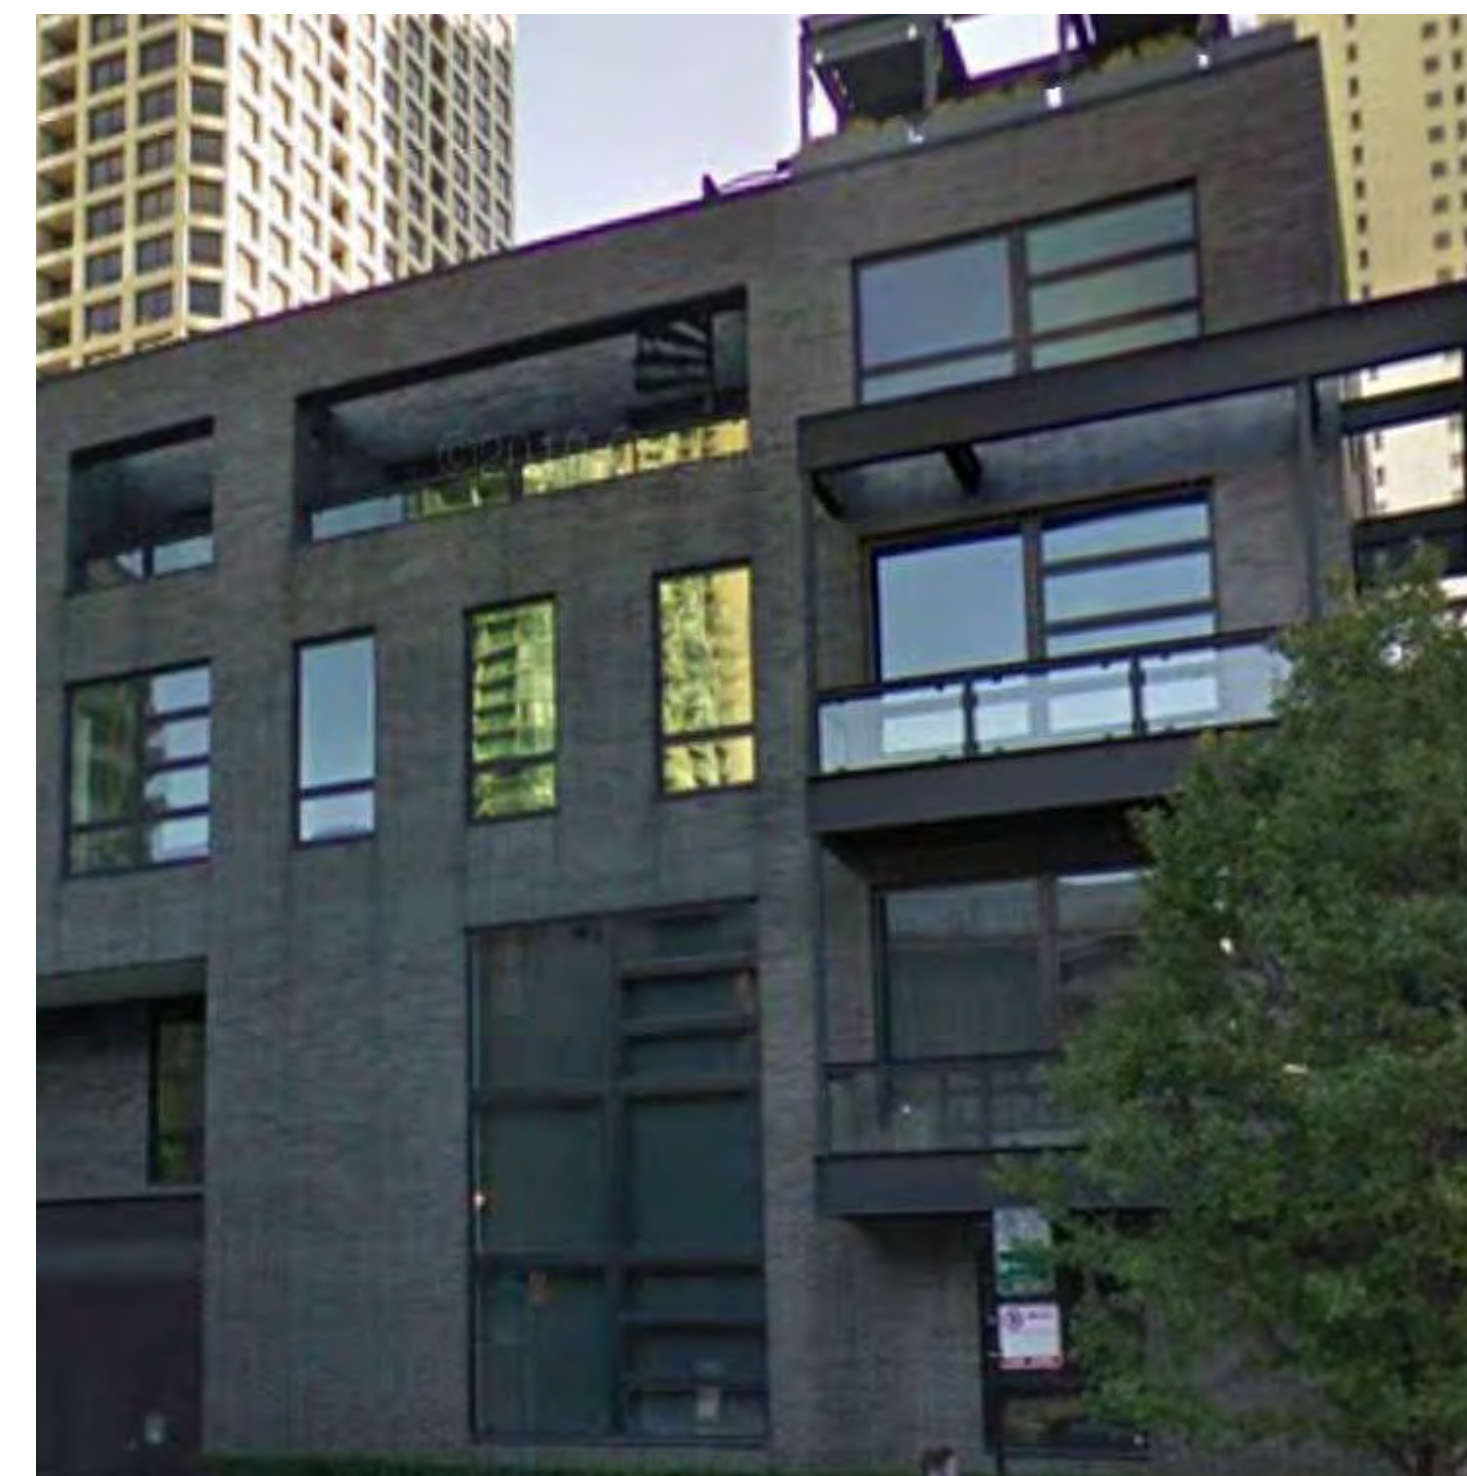

EWS-3 BRICK VENEER BASE DETAIL (SIM)



EWS-4 METAL WALL PANEL (SIM)



DECORATIVE LIGHT FIXTURE AT RESIDENTIAL BALCONY




GUARDIAN SunGuard - AG 43



GUARDIAN SunGuard - AG 50



ALUMINUM STOREFRONT AT RETAIL BASE

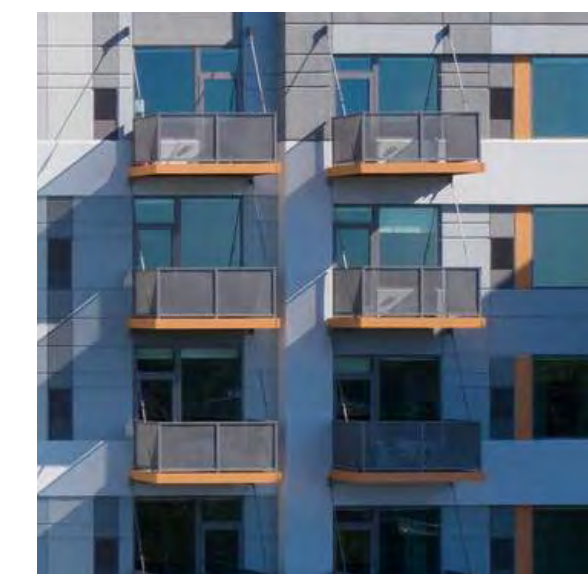

PREFINISHED PERFORATED METAL PANEL RAILING SYSTEM - DARK GRAY



CORRUGATED ARCHITECTURAL METAL PANEL - MEDIUM GRAY



MODULAR BRICK - GRAY BLEND