SCHEMATIC DESIGN





Revisio

SCHEMATIC DESIGN

Drawing Date 09.04.2015

704 WILLIAMSON ST

704 WILLIAMSON ST MADISON, WI 53701

Project No. 215074.00


Sheet Title

COVER SHEET


111 West Wisconsin Avenue, Milwaukee, Wisconsin 53203 Telephone 414.272.2000 Fax 414.272.2001 44 East Mifflin Street, Suite 700, Madison, Wisconsin 53703 Telephone 608.283.6300 Fax 608.283.6317


DEVELOPMENT

Sheet No.

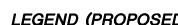

LEGEND (PROPOSED) ----- EASEMENT LINE ----st -----st ----- STORM SEWER — SILT FENCE

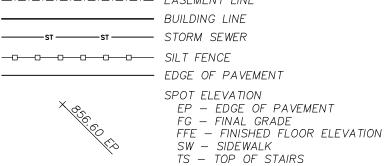

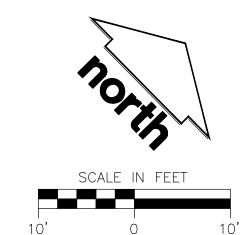

GENERAL NOTES

- 1. REFER TO THE TOPOGRAPHIC AND UTILITY SURVEY FOR EXISTING CONDITIONS NOTES AND LEGEND. 2. ALL WORK IN THE ROW SHALL BE IN ACCORDANCE WITH THE CITY OF MADISON STANDARD SPECIFICATIONS FOR PUBLIC WORKS CONSTRUCTION.
- 3. JSD SHALL BE HELD HARMLESS AND DOES NOT WARRANT ANY DEVIATIONS BY THE OWNER/CONTRACTOR FROM THE APPROVED CONSTRUCTION PLANS THAT MAY RESULT IN DISCIPLINARY ACTIONS BY ANY OR ALL REGULATORY AGENCIES.
- 4. DRAWING FOR REVIEW NOT FOR CONSTRUCTION UNLESS OTHERWISE NOTED IN THE TITLE BLOCK.

CONSTRUCTION SITE EROSION CONTROL REQUIREMENTS

- 1. ALL EROSION AND SEDIMENT CONTROL PRACTICES SHALL BE DESIGNED AND IMPLEMENTED IN ACCORDANCE WITH THE CURRENT DEPARTMENT OF NATURAL RESOURCES EROSION AND SEDIMENT CONTROL TECHNICAL STANDARDS WHICH ARE AVAILABLE AT: http://www.dnr.state.wi.us/runoff/stormwater/techstds.htm
- 2. INSTALL EROSION CONTROL MEASURES PRIOR TO ANY SITE WORK, INCLUDING GRADING OR DISTURBANCE OF EXISTING SURFACE MATERIALS AS SHOWN ON PLAN. MODIFICATIONS TO SEDIMENT CONTROL DESIGN MAY BE CONDUCTED TO MEET UNFORESEEN FIELD CONDITIONS IF MODIFICATIONS CONFORM TO WDNR TECHNICAL
- 3. INSPECTIONS AND MAINTENANCE OF ALL EROSION CONTROL MEASURES SHALL BE ROUTINE (ONCE PER WEEK MINIMUM) TO ENSURE PROPER FUNCTION OF EROSION CONTROLS AT ALL TIMES. EROSION CONTROL MEASURES ARE TO BE IN WORKING ORDER AT THE END OF EACH WORK DAY. ONLINE REPORTING OF INSPECTIONS AND MAINTENANCE IS REQUIRED TO BE SUBMITTED TO THE CITY OF MADISON.
- 4. INSPECT EROSION CONTROL MEASURES AFTER EACH 1/2" OR GREATER RAINFALL. REPAIR ANY DAMAGE OBSERVED DURING THE INSPECTION.
- 5. EROSION CONTROL MEASURES SHALL BE REMOVED ONLY AFTER SITE CONSTRUCTION IS COMPLETE WITH ALL SOIL SURFACES HAVING AN ESTABLISHED VEGETATIVE COVER.
- 6. INSTALL A TRACKING PAD, 50' LONG AND NO LESS THAN 12" THICK BY USE OF 3" CLEAR STONE. TRACKING PADS ARE TO BE MAINTAINED BY THE CONTRACTOR IN A CONDITION WHICH WILL PREVENT THE TRACKING OF MUD OR DRY SEDIMENT ONTO THE ADJACENT PUBLIC STREETS AFTER EACH WORKING DAY OR MORE FREQUENTLY AS REQUIRED BY THE CITY OF MADISON.
- 7. INSTALL EROSION CONTROLS ON THE DOWNSTREAM SIDE OF STOCKPILES AND PROVIDE TEMPORARY SEEDING ON STOCKPILES WHICH ARE TO REMAIN IN PLACE FOR MORE THAN 7 DAYS.
- 8. INSTALL CHECK DAMS WITHIN DRAINAGE DITCHES AND IN FRONT OF SILT FENCING IN ANY LOW AREA ALL IN ACCORDANCE WITH WDNR TECHNICAL STANDARDS.
- 9. EROSION CONTROL FOR UTILITY CONSTRUCTION (STORM SEWER, SANITARY SEWER, WATER MAIN, ETC.): A. PLACE EXCAVATED TRENCH MATERIAL ON THE HIGH SIDE OF THE TRENCH. B. BACKFILL, COMPACT, AND STABILIZE THE TRENCH IMMEDIATELY AFTER PIPE CONSTRUCTION. C. DISCHARGE TRENCH WATER INTO A SEDIMENTATION BASIN OR FILTERING TANK IN ACCORDANCE WITH THE DEWATERING TECHNICAL STANDARD NO. 1061 PRIOR TO RELEASE INTO THE STORM SEWER, RECEIVING STREAM, OR DRAINAGE DITCH.
- 10. INSTALL TYPE D INLET PROTECTION AROUND ALL STORM SEWER INLETS AND CATCH BASINS THAT MAY RECEIVE RUNOFF FROM AREAS UNDER CONSTRUCTION. REFER TO WISDOT FDM FOR RESPECTIVE DETAILS.
- 11. APPLY ANIONIC POLYMER TO DISTURBED AREAS IF EROSION BECOMES PROBLEMATIC.
- 12. ADDITIONAL EROSION CONTROL MEASURES, AS REQUESTED BY STATE INSPECTORS, LOCAL INSPECTORS, AND/OR ENGINEER SHALL BE INSTALLED WITHIN 24 HOURS OF REQUEST.
- 13 ALL SLOPES EXCEPDING 5:1 (20%) SHALL BE STABILIZED WITH A CLASS IL TYPE B EROSION MATTING AND DRAINAGE SWALES SHALL BE STABILIZED WITH CLASS I, TYPE B EROSION MATTING OR APPLICATION OF A WDOT APPROVED POLYMER SOIL STABILIZATION TREATMENT OR A COMBINATION THEREOF, AS REQUIRED. CONTRACTOR SHALL PROVIDE PRODUCT SPECIFICATIONS TO PROJECT ENGINEER FOR APPROVAL.
- 14. CONTRACTOR/OWNER SHALL FILE A NOTICE OF TERMINATION UPON VEGETATIVE STABILIZATION AND/OR PROPERTY SALE IN ACCORDANCE WITH WDNR REQUIREMENTS.
- 15. IT IS ACCEPTABLE TO SUBSTITUTE INTERIM MANUFACTURED PERIMETER CONTROL AND SLOPE INTERRUPTION
- PRODUCTS PER WDNR TECHNICAL STANDARD 1051 FOR SILT FENCING. 16. CONTRACTOR SHALL TAKE ALL NECESSARY STEPS TO CONTROL DUST ARISING FROM CONSTRUCTION OPERATIONS. REFER TO WDNR TECHNICAL STANDARD 1068.
- 17. CONTRACTOR TO PROVIDE SOLID LID OR METAL PLATE ON ALL OPEN MANHOLES DURING CONSTRUCTION TO MINIMIZE SEDIMENT FROM ENTERING THE STORM SEWER SYSTEM.

GRADING AND SEEDING NOTES

- 1. ALL DISTURBED AREAS SHALL BE SEEDED AND MULCHED IMMEDIATELY FOLLOWING GRADING ACTIVITIES. SEED MIX TO BE IN ACCORDANCE WITH LANDSCAPE PLAN.
- 2. CONTRACTOR SHALL STABILIZE ANY EXPOSED SOIL SURFACES ON THE SITE WITH MULCH PRIOR TO WINTER.
- 3. ALL PROPOSED GRADES SHOWN ARE FINISHED GRADES. CONTRACTOR SHALL VERIFY ALL GRADES, MAKE SURE ALL AREAS DRAIN PROPERLY AND SHALL REPORT ANY DISCREPANCIES TO THE ENGINEER PRIOR TO
- 4. CONTRACTOR SHALL PROTECT ADJACENT PROPERTIES WITH SILT FENCING FOR EROSION CONTROL UNTIL CONSTRUCTION IS COMPLETED AND NOTICE OF TERMINATION FILED.
- 5. CONTRACTOR SHALL WATER ALL NEWLY SEEDED AREAS DURING THE SUMMER MONTHS WHENEVER THERE IS A 7 DAY LAPSE WITH NO SIGNIFICANT RAINFALL.
- 6. CONTRACTOR TO DEEP TILL ALL COMPACTED PERVIOUS SURFACES PRIOR TO SEEDING AND MULCHING. THIS MUST BE VERIFIED BY THE ENGINEER AS PART OF THE AS-BUILT CERTIFICATION.
- 7. THE CONTRACTOR SHALL NOTIFY THE CITY OF MADISON A MINIMUM OF TWO (2) WORKING DAYS IN ADVANCE OF ANY SOIL DISTURBING ACTIVITY.

UTILITY NOTES

- 1. DIMENSIONS TAKE PRECEDENCE OVER SCALE. CONTRACTOR TO VERIFY ALL DIMENSIONS IN FIELD. 2. IF ANY ERRORS, DISCREPANCIES, OR OMISSIONS WITHIN THE PLAN BECOME APPARENT, IT SHALL BE BROUGHT TO THE ATTENTION OF THE ENGINEER PRIOR TO CONSTRUCTION SO THAT CLARIFICATION OR
- 3. LENGTHS OF ALL UTILITIES ARE TO CENTER OF STRUCTURES OR FITTINGS AND MAY VARY SLIGHTLY FROM PLAN. LENGTHS SHALL BE VERIFIED IN THE FIELD DURING CONSTRUCTION.
- 4. ALL CONSTRUCTION SIGNING TO BE IN ACCORDANCE WITH THE CITY OF MADISON AND WISCONSIN DEPARTMENT OF TRANSPORTATION REQUIREMENTS.
- 5. THE CONTRACTOR SHALL INSTALL A PEDESTRIAN FENCE AROUND ALL EXCAVATIONS TO BE LEFT OPEN OVER NIGHT AS REQUIRED.
- 6. THE PROPOSED IMPROVEMENTS MUST BE CONSTRUCTED IN ACCORDANCE WITH ENGINEERING PLANS DESIGNED TO MEET ORDINANCES AND REQUIREMENTS OF THE MUNICIPALITY AND WISDOT, WDSPS, AND
- 7. PRIOR TO CONSTRUCTION, THE CONTRACTOR IS RESPONSIBLE FOR:
- * EXAMINING ALL SITE CONDITIONS RELATIVE TO THE CONDITIONS INDICATED ON THE ENGINEERING DRAWINGS. ANY DISCREPANCIES ARE TO BE REPORTED TO THE ENGINEER AND RESOLVED PRIOR TO * OBTAINING ALL PERMITS INCLUDING PERMIT COSTS, TAP FEES, METER DEPOSITS, BONDS, AND ALL OTHER FEES REQUIRED FOR PROPOSED WORK TO OBTAIN OCCUPANCY IN INCLUDING BUT NOT LIMITED TO EXISTING SERVICE ABANDONMENT. * VERIFYING UTILITY ELEVATIONS AND NOTIFYING ENGINEER OF ANY DISCREPANCY. NO WORK SHALL BE PERFORMED UNTIL THE DISCREPANCY IS RESOLVED.
- * NOTIFYING ALL UTILITIES PRIOR TO THE INSTALLATION OF ANY UNDERGROUND IMPROVEMENTS. * NOTIFYING THE DESIGN ENGINEER AND MUNICIPALITY 48 HOURS PRIOR TO THE START OF CONSTRUCTION TO ARRANGE FOR APPROPRIATE CONSTRUCTION OBSERVATION.
- THE CONTRACTOR IS RESPONSIBLE FOR PROVIDING THE ENGINEER WITH AS-BUILT CONDITIONS OF THE DESIGNATED IMPROVEMENTS IN ORDER THAT THE APPROPRIATE DRAWINGS CAN BE PREPARED, IF REQUIRED. ANY CHANGES TO THE DRAWINGS OR ADDITIONAL ITEMS MUST BE REPORTED TO THE ENGINEER AS WORK
- 9. THE PRIME CONTRACTOR IS RESPONSIBLE FOR COORDINATING ALL CONSTRUCTION WITH OTHER CONTRACTORS INVOLVED WITH CONSTRUCTION OF THE PROPOSED DEVELOPMENT AND FOR REPORTING ANY ERRORS OR DISCREPANCIES BETWEEN THESE PLANS AND PLANS PREPARED BY OTHERS.
- 10. ANY SANITARY SEWER, SANITARY SEWER SERVICES, WATER MAIN, WATER SERVICES, STORM SEWER, OR OTHER UTILITIES, WHICH ARE DAMAGED BY THE CONTRACTORS, SHALL BE REPAIRED TO THE OWNER'S SATISFACTION AT THE CONTRACTOR'S EXPENSE.
- 11. CONTRACTOR IS RESPONSIBLE FOR SITE SAFETY DURING THE CONSTRUCTION OF IMPROVEMENTS. 12. ALL PUBLIC IMPROVEMENTS SHALL BE IN ACCORDANCE WITH THE CITY OF MADISON PROJECT NUMBER 53B2326. PUBLIC IMPROVEMENTS ONLY SHOWN ON THIS PLAN FOR GRAPHIC PURPOSES. CONTRACTOR SHALL COORDINATE A PRECONSTRUCTION MEETING WITH CITY OF MADISON INSPECTION A MINIMUM OF 48 HOURS BEFORE CONNECTING TO PUBLIC UTILITIES OR DOING ANY OTHER WORK WITHIN THE PUBLIC RIGHT-OF-WAY. ALL WORK WITHIN THE PUBLIC RIGHT-OF-WAY SHALL BE IN ACCORDANCE WITH THE CITY
- OF MADISON STANDARD SPECIFICATIONS FOR PUBLIC WORKS CONSTRUCTION. 13. ALL PRIVATE STORM BUILDING PIPE AND TUBING SHALL CONFORM TO SPS 384.30, TABLE 384.30-6.
- 14. WATER SERVICE SHALL BE MAINTAINED AT ALL TIMES DURING CONSTRUCTION. CONTRACTOR TO FIELD VERIFY LOCATION AND SIZE. REPORT DISCREPANCIES TO ENGINEER PRIOR TO CONSTRUCTION.
- 15. ALL PRIVATE SANITARY SEWER BUILDING PIPE AND TUBING SHALL CONFORM TO SPS 384.30, TABLE
- 16. COORDINATE AND OBTAIN ALL PERMITS FOR EXISTING PRIVATE SERVICES TO BE ABANDONED WITH THE CITY
- 17. DEWATERING, IF APPLICABLE, SHALL BE CONDUCTED PER WDNR STORM WATER MANAGEMENT TECHNICAL

SCHEMATIC DESIGN

SCOPE DOCUMENTS

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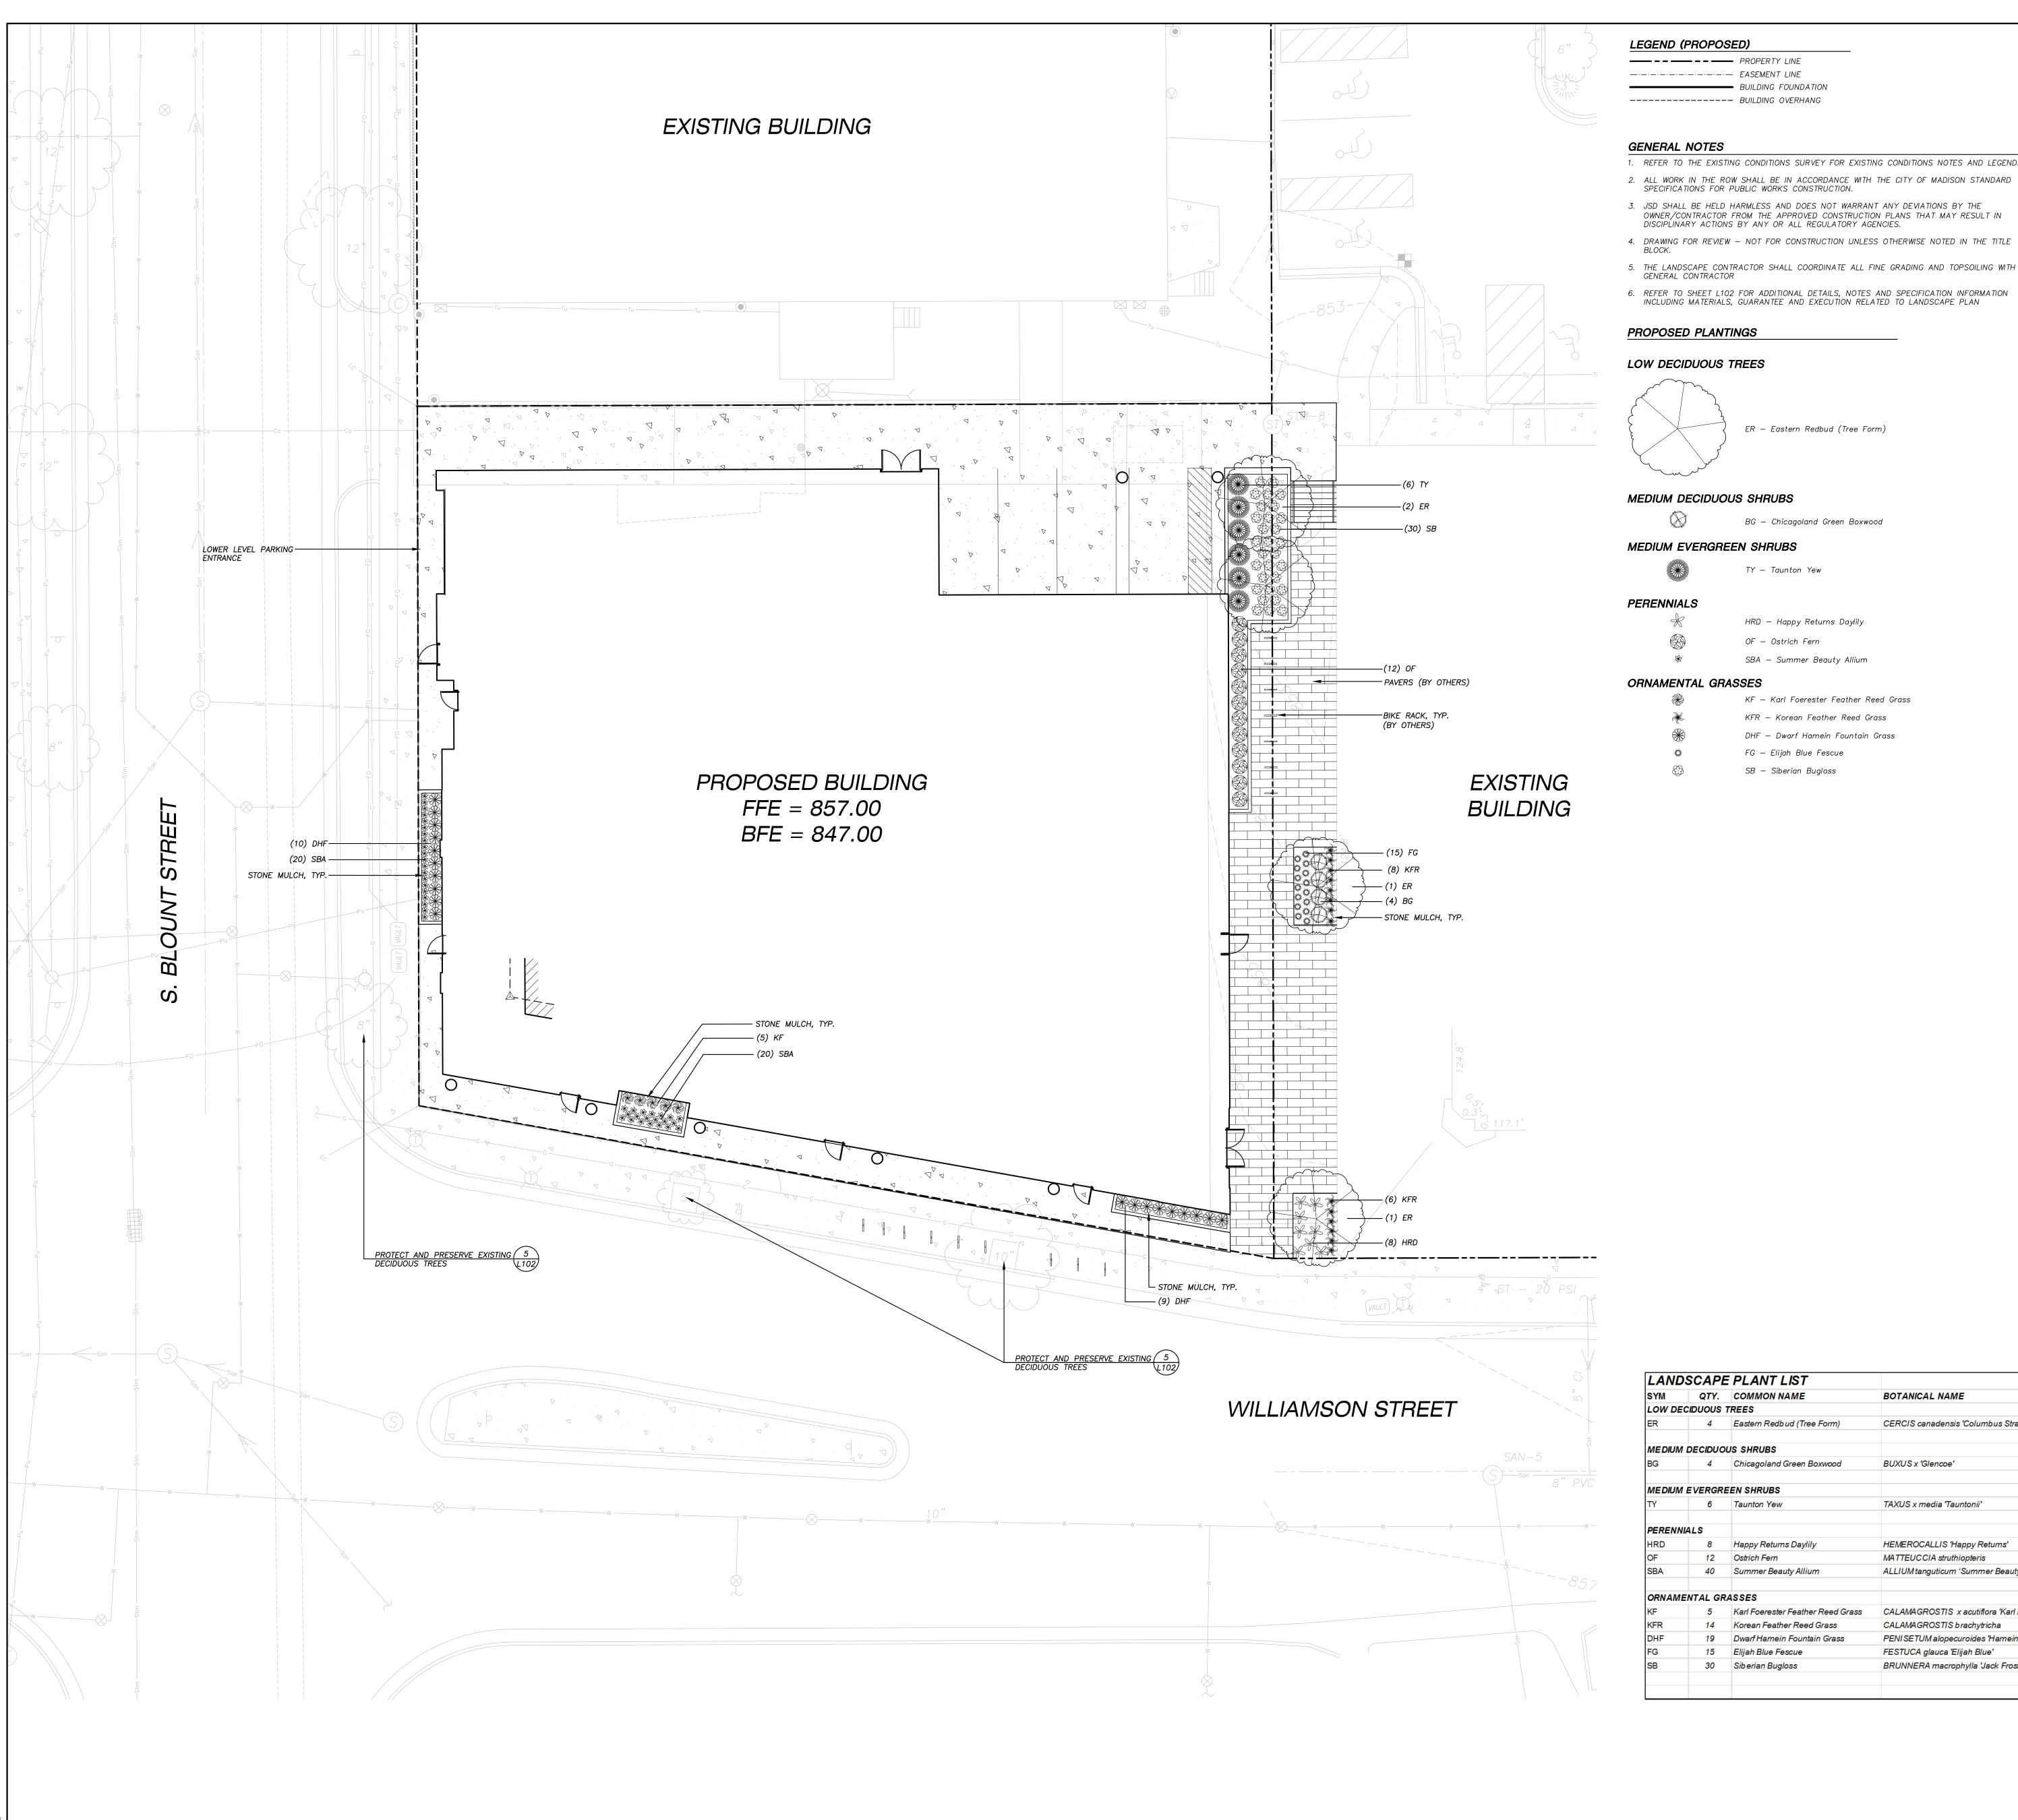
MADISON, WI RAINMAKER

DEVELOPMENT 215074.00 Sheet

Title SCHEMATIC GRADING AND UTILITY PLAN

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LEGEND (PROPOSED)

----- EASEMENT LINE BUILDING FOUNDATION ---- BUILDING OVERHANG


GENERAL NOTES

1. REFER TO THE EXISTING CONDITIONS SURVEY FOR EXISTING CONDITIONS NOTES AND LEGEND.

- ALL WORK IN THE ROW SHALL BE IN ACCORDANCE WITH THE CITY OF MADISON STANDARD SPECIFICATIONS FOR PUBLIC WORKS CONSTRUCTION.
- 3. JSD SHALL BE HELD HARMLESS AND DOES NOT WARRANT ANY DEVIATIONS BY THE
- OWNER/CONTRACTOR FROM THE APPROVED CONSTRUCTION PLANS THAT MAY RESULT IN DISCIPLINARY ACTIONS BY ANY OR ALL REGULATORY AGENCIES.
- 5. THE LANDSCAPE CONTRACTOR SHALL COORDINATE ALL FINE GRADING AND TOPSOILING WITH GENERAL CONTRACTOR
- 6. REFER TO SHEET L102 FOR ADDITIONAL DETAILS, NOTES AND SPECIFICATION INFORMATION INCLUDING MATERIALS, GUARANTEE AND EXECUTION RELATED TO LANDSCAPE PLAN

PROPOSED PLANTINGS

LOW DECIDUOUS TREES

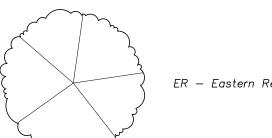

ER — Eastern Redbud (Tree Form)

MEDIUM DECIDUOUS SHRUBS

BG — Chicagoland Green Boxwood

MEDIUM EVERGREEN SHRUBS

TY — Taunton Yew

PERENNIALS

HRD — Happy Returns Daylily

OF — Ostrich Fern SBA — Summer Beauty Allium


ORNAMENTAL GRASSES

KF — Karl Foerester Feather Reed Grass

KFR — Korean Feather Reed Grass

DHF — Dwarf Hamein Fountain Grass FG — Elijah Blue Fescue

SB — Siberian Bugloss

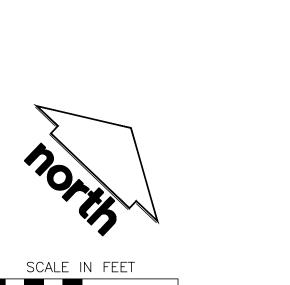

LANDSCAPE PLANT LIST QTY. COMMON NAME **BOTANICAL NAME** 4 Eastern Redbud (Tree Form) CERCIS canadensis 'Columbus Strain' MEDIUM DECIDUOUS SHRUBS 4 Chicagoland Green Boxwood BUXUS x 'Glencoe' 12-24" Min. Ht. #3 Cont. MEDIUM EVERGREEN SHRUBS 6 Taunton Yew TAXUS x media 'Tauntonii' 12-24" Min. Ht. #3 Cont. Happy Returns Daylily HEMEROCALLIS 'Happy Returns MATTEUCCIA struthiopteris 8 - 18" Ht. # 1 Cont. 12 Ostrich Fern 8 - 18" Ht. # 1 Cont. 40 Summer Beauty Allium ALLIUM tanguticum 'Summer Beauty' ORNAMENTAL GRASSES 5 Karl Foerester Feather Reed Grass 8 - 18" Ht. # 1 Cont. CALAMAGROSTIS x acutiflora 'Karl Foerester' 14 Korean Feather Reed Grass CALAMAGROSTIS brachytricha 8 - 18" Ht. # 1 Cont. 8 - 18" Ht. # 1 Cont. 19 Dwarf Hamein Fountain Grass PENI SETUM alopecuroides 'Hamein' 15 Elijah Blue Fescue FESTUCA glauca 'Elijah Blue' 8 - 18" Ht. # 1 Cont. BRUNNERA macrophylla 'Jack Frost' 8 - 18" Ht. # 1 Cont. 30 Siberian Bugloss TOTAL:



· Engineers · Surveyors · Planners MADISON REGIONAL OFFICE 161 HORIZON DRIVE, SUITE 101 VERONA, WISCONSIN 53593 608.848.5060 PHONE 608.848.2255 FAX

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Revisions

SCOPE DOCUMENTS Drawing Date 09.04.2015

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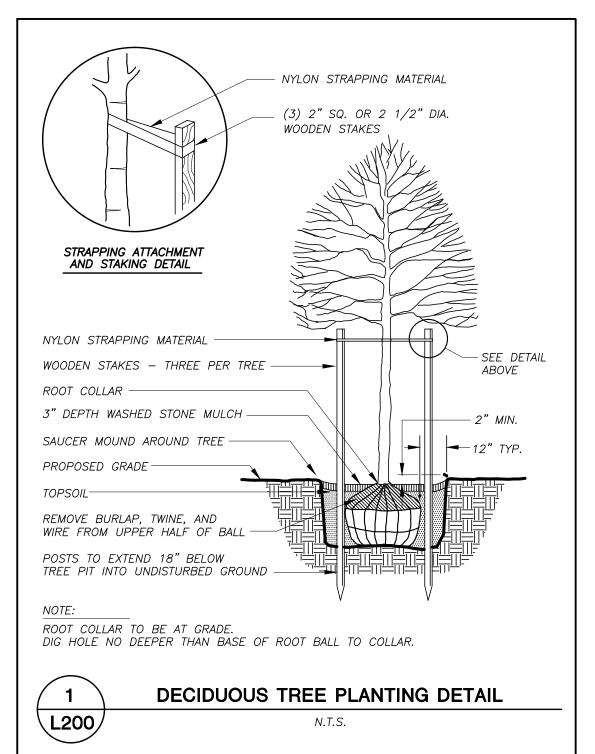
MADISON, WI RAINMAKER DEVELOPMENT


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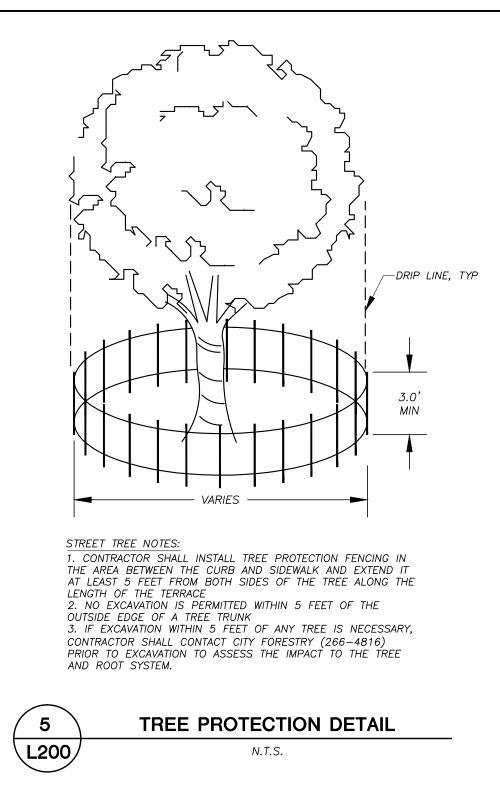
LANDSCAPE PLAN


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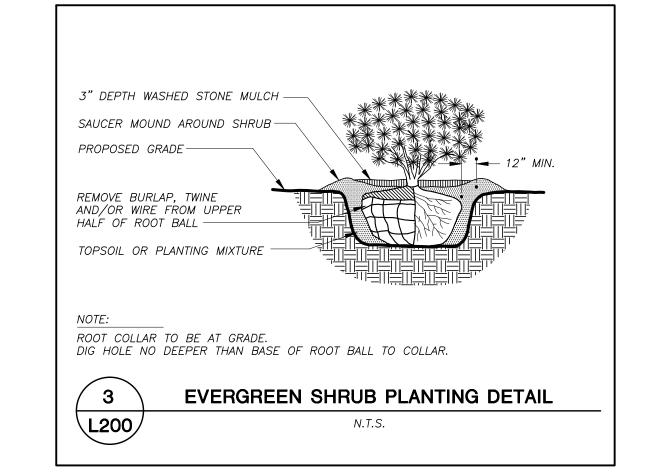
111 West Wisconsin Avenue, Milwaukee, Wisconsin Telephone 414.272.2000 Fax 414.272.2001 44 East Mifflin Street, Suite 700, Madison, Wisconsin 53703 Telephone 608.283.6300 Fax 608.283.6317 Sheet L1.00








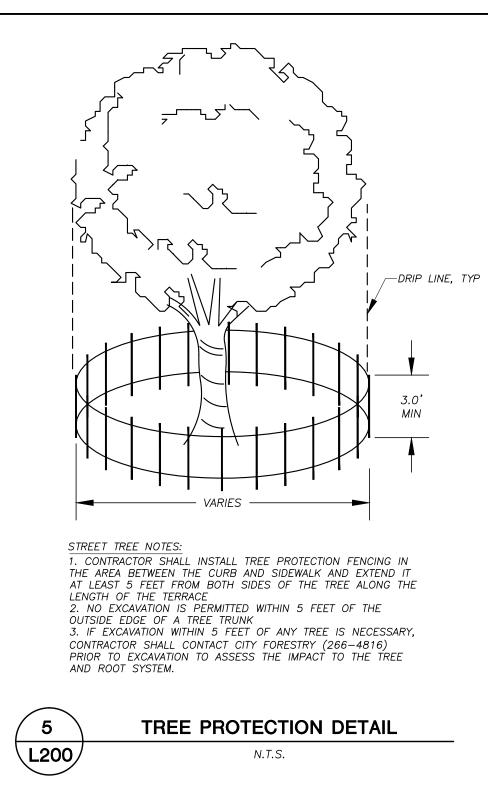

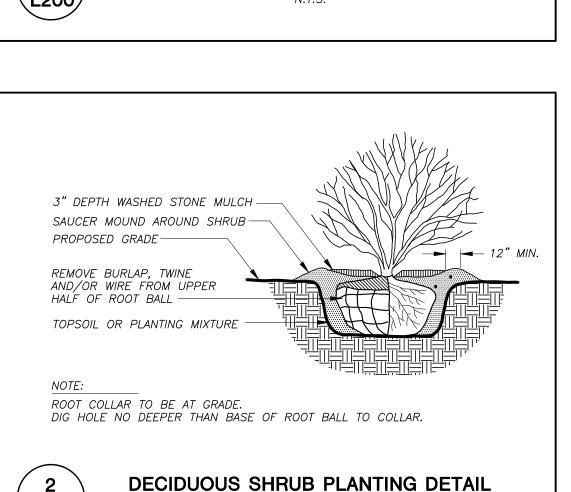

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LANDSCAPE NOTES AND SPECIFICATIONS

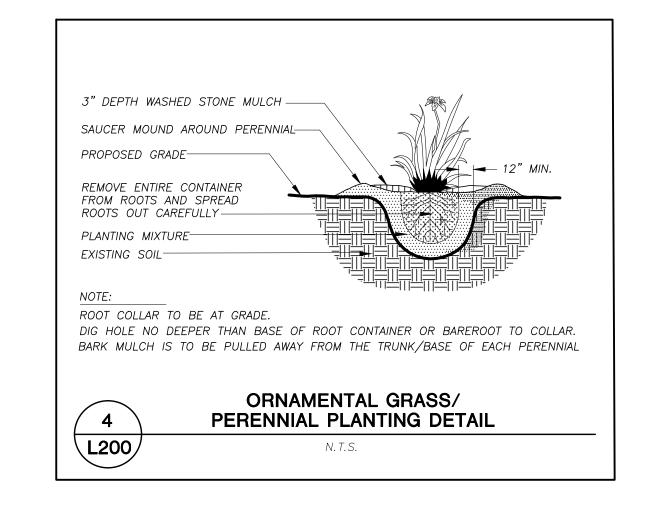- 1. GENERAL: ALL WORK IN THE R-O-W AND PUBLIC EASEMENTS SHALL BE IN ACCORDANCE WITH THE CITY OF MADISON REQUIREMENTS. JSD SHALL BE HELD HARMLESS AND DOES NOT WARRANT ANY DEVIATIONS BY THE OWNER/CONTRACTOR FROM THE APPROVED CONSTRUCTION PLANS THAT MAY RESULT IN DISCIPLINARY ACTIONS BY ANY OR ALL REGULATORY AGENCIES. LOCATE ALL UTILITIES PRIOR TO CONSTRUCTION. THE CONTRACTOR IS RESPONSIBLE FOR REPAIRING ANY DAMAGE DONE TO UTILITIES. CONTRACTOR MUST CALL 1-800-382-5544 FOR UTILITY LOCATIONS AT LEAST THREE DAYS PRIOR TO DIGGING. HAND DIG AND INSTALL ALL PLANTS THAT ARE NEAR EXISTING UTILITIES. PROTECT PREVIOUSLY INSTALLED WORK OF OTHER TRADES. CONTRACTOR IS RESPONSIBLE FOR STAKING THE PLANT MATERIALS FOR REVIEW BY OWNER PRIOR TO DIGGING AND PLACEMENT. THE LANDSCAPE CONTRACTOR SHALL COORDINATE ALL FINE GRADING AND
- 2. DELIVERY AND HANDLING: DO NOT DELIVER MORE PLANT MATERIALS THAN CAN BE PLANTED IN ONE DAY. DELIVER PLANTS WITH LEGIBLE IDENTIFICATION LABELS. PROTECT PLANTS DURING DELIVERY AND DO NOT PRUNE PRIOR TO DELIVERY. ALL TREES AND SHRUBS SHALL BE PLANTED ON THE DAY OF DELIVERY; IF THIS IS NOT POSSIBLE, PROTECT THAT STOCK NOT PLANTED BY STORING STOCK IN A SHADED AREA PROTECTING THE ROOT MASS WITH WET SOIL, MOSS OR OTHER SUITABLE MEDIA AND KEEPING WELL WATERED. DO NOT REMOVE CONTAINER GROWN STOCK FROM CONTAINERS BEFORE TIME OF PLANTING. DO NOT PICK UP CONTAINER OR BALLED PLANTS BY STEM OR ROOTS. ALL PLANTS SHALL BE LIFTED AND HANDLED FROM THE BOTTOM OF THE BALL. PERFORM ACTUAL PLANTING ONLY WHEN WEATHER AND SOIL CONDITIONS ARE SUITABLE IN ACCORDANCE WITH LOCALLY ACCEPTED PRACTICES.
- 3. GUARANTEE: THE CONTRACTOR SHALL GUARANTEE ALL PLANTS THROUGH ONE (1) YEAR AFTER ACCEPTANCE BY OWNER. PLANTS SHALL BE ALIVE AND IN GOOD HEALTHY AND FLOURISHING CONDITION AT THE END OF THE GUARANTEE PERIOD. THE CONTRACTOR SHALL REPLACE WITHOUT COST TO THE OWNER ANY PLANTS THAT ARE DEAD OR NOT IN A VIGOROUS THRIVING CONDITION. REPLACEMENT PLANTS SHALL BE OF THE SAME KIND AND SIZE AS ORIGINALLY SPECIFIED UNLESS OTHERWISE DIRECTED BY OWNER. RESTORE BEDS AS NECESSARY FOLLOWING PLANT REPLACEMENT, INCLUDING BUT NOT LIMITED TO BEDDING, EDGING, MULCH, ETC. REPAIR DAMAGE TO OTHER PLANTS OR PLANTING AREAS DURING PLANT REPLACEMENT AT NO COST TO OWNER. CONTRACTOR SHALL PROVIDE A TWO (2)—YEAR STRAIGHTENING GUARANTEE FOR ALL TREES.
- 4. MATERIALS PLANTS: ALL PLANTS SHALL CONFORM TO THE AMERICAN STANDARD FOR NURSERY STOCK ANSI Z60.1-2004. PLANTS SHALL BE TRUE TO SPECIES AND VARIETY SPECIFIED AND NURSERY GROWN IN ACCORDANCE WITH GOOD HORTICULTURAL PRACTICES UNDER CLIMATIC CONDITIONS SIMILAR TO THOSE IN THE LOCALITY OF THE PROJECT FOR AT LEAST 2 YEARS. PLANTS SHALL BE FRESHLY DUG (DURING THE MOST RECENT FAVORABLE HARVEST SEASON). PLANTS SHALL BE SO TRAINED IN DEVELOPMENT AND APPEARANCE AS TO BE UNQUESTIONABLY SUPERIOR IN FORM, COMPACTNESS, AND SYMMETRY. PLANTS SHALL BE SOUND, HEALTHY, VIGOROUS, WELL BRANCHED AND DENSELY FOLIATED WHEN IN LEAF, AND FREE OF DISEASE AND INSECTS (ADULT EGGS, PUPAE OR LARVAE). THEY SHALL HAVE HEALTHY, WELL-DEVELOPED ROOT SYSTEMS AND SHALL BE FREE FROM PHYSICAL DAMAGE OR OTHER CONDITIONS THAT WOULD PREVENT THRIVING GROWTH. PLANTS SHALL BE OF THE HIGHEST QUALITY, HAVE TYPICAL GROWTH HABITS FOR THEIR SPECIES, BE SOUND, HEALTHY, VIGOROUS AND FREE OF INJURY. PARKWAY TREES AND PARKING LOT TREES SHALL HAVE A MINIMUM BRANCHING HEIGHT OF SIX (6) FEET ABOVE THE GROUND TO ALLOW ADEQUATE VISUAL AND PHYSICAL CLEARANCE.
- 5. MATERIALS SOIL: PLANTING SOIL/COMPACTED TOPSOIL SHALL MEET THESE REQUIREMENTS: 1. PLANTING AREAS = 24"

AND COAT THE TREATED AREA WITH AN APPROVED ANTISEPTIC TREE PAINT.

2. TREE PITS = SEE DETAILS

- PLANTING SOIL TO BE A MINIMUM 30" DEPTH, UNLESS OTHERWISE SPECIFIED AS ABOVE OR ON DETAILS. TOPSOIL TO BE CLEAN, FRIABLE LOAM FROM LOCAL SOURCE, FREE FROM STONES OR DEBRIS OVER 3/4" IN DIAMETER, AND FREE FROM TOXINS. TOPSOIL SHALL HAVE A pH VALUE BETWEEN 6 AND 7. TOPSOIL AND PLANTING SOIL SHALL BE TESTED TO CONFORM TO THESE SPECIFICATIONS AND SHALL BE AMENDED TO MEET THESE SPECIFICATIONS. DO NOT PLACE FROZEN OR MUDDY TOPSOIL. APPLY SOIL AMENDMENTS TO ALL LANDSCAPE BEDS PER SOIL TEST.
- 6. MATERIALS ALL PLANTING AREAS SHALL RECEIVE WASHED STONE MULCH SPREAD TO A CONSISTENT DEPTH OF THREE INCHES OVER ENTIRE PLANTING AREA, UNLESS OTHERWISE SPECIFIED ON PLANS. FERTILIZER SHALL BE IN ACCORDANCE WITH APPLICABLE LOCAL, COUNTY AND STATE OF WISCONSIN REQUIREMENTS. WASH STONE MULCH COLOR, TEXTURE, AND SIZE TO BE DETERMINED BY OWNER OR OWNER'S REPRESENTATIVE PRIOR TO INSTALLATION.
- 8. PRUNING: THE CONTRACTOR SHALL PRUNE ALL TREES AND REPAIR ANY INJURIES THAT OCCURRED DURING THE PLANTING PROCESS. DOUBLE LEADERS, DEAD BRANCHES, AND LIMBS DAMAGED OR BROKEN DURING THE PLANTING PROCESS SHALL BE PRUNED. THIS SHALL BE THE ONLY PRUNING ALLOWED AT PLANTING. PRUNING SHALL CONFORM TO AMERICAN STANDARD FOR TREE CARE OPERATIONS, ANSI A300. PRUNE TREES IN ACCORDANCE WITH NAA GUIDELINES. DO NOT TOP TREES. PRUNE SHRUBS ACCORDING TO STANDARD HORTICULTURAL PRACTICES. ON CUTS OVER 3/4" IN DIAMETER AND BRUISES OR SCARS ON BARK, TRACE THE INJURED CAMBIUM LAYER BACK TO LIVING TISSUE AND REMOVE. SMOOTH AND SHAPE WOUNDS SO AS NOT TO RETAIN WATER

7. MATERIALS — WEED BARRIER FABRIC: ALL PLANTING BEDS SHALL BE INSTALLED WITH WOVEN WEED BARRIER FABRIC. NO PLASTIC/IMPERVIOUS BARRIERS WILL BE PERMITTED. EXAMPLE: BLACK

- 9. CLEANUP: DISPOSED OF EXCESS SOIL. REMOVE ALL CUTTINGS AND WASTE MATERIALS. SOIL, BRANCHES, BINDING AND WRAPPING MATERIALS, REJECTED PLANTS, OR OTHER DEBRIS RESULTING FROM ANY PLANTING SHALL BE PROMPTLY CLEANED UP AND REMOVED. THE WORK AREA SHALL BE KEPT SAFE AND NEAT AT ALL TIMES UNTIL THE CLEANUP OPERATION IS COMPLETED. UNDER NO CONDITION SHALL THE ACCUMULATION OF SOIL, BRANCHES OR OTHER DEBRIS BE ALLOWED UPON A PUBLIC PROPERTY IN SUCH A MANNER AS TO RESULT IN A PUBLIC HAZARD. LIKEWISE, UNDER NO CIRCUMSTANCES SHALL ANY DEBRIS OR INCIDENTAL MATERIALS BE ALLOWED UPON ADJACENT PRIVATE PROPERTY.
- 10. MAINTENANCE: (CONTRACTOR) FOR ALL PLANTINGS AND BUFFER AREAS: THE CONTRACTOR SHALL MAINTAIN ALL PLANTINGS AREAS FOR AT LEAST A PERIOD OF 30 DAYS, OR UNTIL FINAL ACCEPTANCE FROM THE OWNER. THE CONTRACTOR IS RESPONSIBLE FOR ADEQUATELY WATERING PLANTS DURING THIS 30 DAY ESTABLISHMENT PERIOD. CONTRACTOR IS RESPONSIBLE FOR THE ESTABLISHMENT OF HEALTHY VIGOROUS PLANT MATERIAL GROWTH. CONTRACTOR IS ALSO RESPONSIBLE FOR ANY PRUNING OF PLANT MATERIALS, AND SHAPING AND/OR REPLACEMENT OF DEFICIENT MULCH DURING THIS PERIOD. LONG TERM PLANT MATERIALS MAINTENANCE AND ANY PROGRAM FOR SUCH IS THE RESPONSIBILITY OF THE OWNER. ALL PLANTING AREAS SHALL BE MAINTAINED IN
- 11. MAINTENANCE: (OWNER) THE OWNER IS RESPONSIBLE FOR THE CONTINUED MAINTENANCE, REPAIR AND REPLACEMENT OF ALL LANDSCAPING MATERIALS AND WEED BARRIER FABRIC AS NECESSARY FOLLOWING THE ONE (1) YEAR CONTRACTOR GUARANTEE PERIOD.



CITY OF MADISON LANDSCAPE WORKSHEET

Section 28.142 Madison General Ordinance

Project Location	/ Address	704 WILLIAMSON	I STEET, MADIS	SON, WI 53703
Name of Project	<u>704 WIL</u>	LIAMSON STREE	T	
Owner / Contact				
Contact Phone	(608) 8	348-5060	Contact Email	il KEVIN.YESKA@JSDINC.COM
, —				

** Landscape plans for zoning lots greater than ten thousand (10,000) square feet in size MUST be prepared by a registered landscape architect. **

The following standards apply to all exterior construction and development activity, including the expansion of existing buildings, structures and parking lots, except the construction of detached single-family and two-family dwellings and their accessory structures. The entire development site must be brought up to compliance with this section unless all of the following conditions apply, in which case only the affected areas need to be brought up to compliance:

- (a) The area of site disturbance is less than ten percent (10%) of the entire development site during any ten-(10)
- (b) Gross floor area is only increased by ten percent (10%) during any ten-(10) year period.
- (c) No demolition of a principal building is involved.
- (d) Any displaced landscaping elements must be replaced on the site and shown on a revised landscaping plan.

Landscape Calculations and Distribution

Required landscaped areas shall be calculated based upon the total developed area of the property. Developed area is defined as that area within a single contiguous boundary which is made up of structures, parking, driveways and docking/loading facilities, but excluding the area of any building footprint at grade, land designated for open space uses such as athletic fields, and undeveloped land area on the same zoning lot. There are three methods for calculating landscape points depending on the size of the lot and Zoning District.

(a) For all lots except those described in (b) and (c) below, five (5) landscape points shall be provided for each three hundred (300) square feet of developed area.

Total square footage of developed area 4,912 Total landscape points required _____ 82

(b) For lots larger than five (5) acres, points shall be provided at five (5) points per three hundred (300) square feet for the first five (5) developed acres, and one (1) point per one hundred (100) square feet for all additional

Total square footage of developed area _____ Five (5) acres = 217,800 square feet First five (5) developed acres = 3,630 points

Remainder of developed area Total landscape points required

(c) For the Industrial – Limited (IL) and Industrial – General (IG) districts, one (1) point shall be provided per one hundred (100) square feet of developed area.

Total square footage of developed area _ Total landscape points required

10/2013

Tabulation of Points and Credits

Use the table to indicate the quantity and points for all existing and proposed landscape elements.

Dland Tana / Elassa d	Minimum Size at Installation	Points	Credits/ Existing Landscaping		New/ Proposed Landscaping	
Plant Type/ Element			Quantity	Points Achieved	Quantity	Points Achieved
Overstory deciduous tree	2½ inch caliper measured diameter at breast height (dbh)	35				
Tall evergreen tree (i.e. pine, spruce)	5-6 feet tall	35				
Ornamental tree	1 1/2 inch caliper	15			4	60
Upright evergreen shrub (i.e. arborvitae)	3-4 feet tall	10				
Shrub, deciduous	#3 gallon container size, Min. 12"-24"	3			4	12
Shrub, evergreen	#3 gallon container size, Min. 12"-24"	4			6	24
Ornamental grasses/ perennials	#1 gallon container size, Min. 8"-18"	2			143	286
Ornamental/ decorative fencing or wall	n/a	4 per 10 lineal ft.				
Existing significant specimen tree	Minimum size: 2 ½ inch caliper dbh. *Trees must be within developed area and cannot comprise more than 30% of total required points.	14 per caliper inch dbh. Maximum points per tree: 200				
Landscape furniture for public seating and/or transit connections	* Furniture must be within developed area, publically accessible, and cannot comprise more than 5% of total required points.	5 points per "seat"				
Sub Totals						382

Total Number of Points Provided 382

* As determined by ANSI, ANLA- American standards for nursery stock. For each size, minimum plant sizes shall conform to the specifications as stated in the current American Standard for Nursery Stock.



VERONA, WISCONSIN 53593

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SCOPE DOCUMENTS

Drawing

09.04.2015

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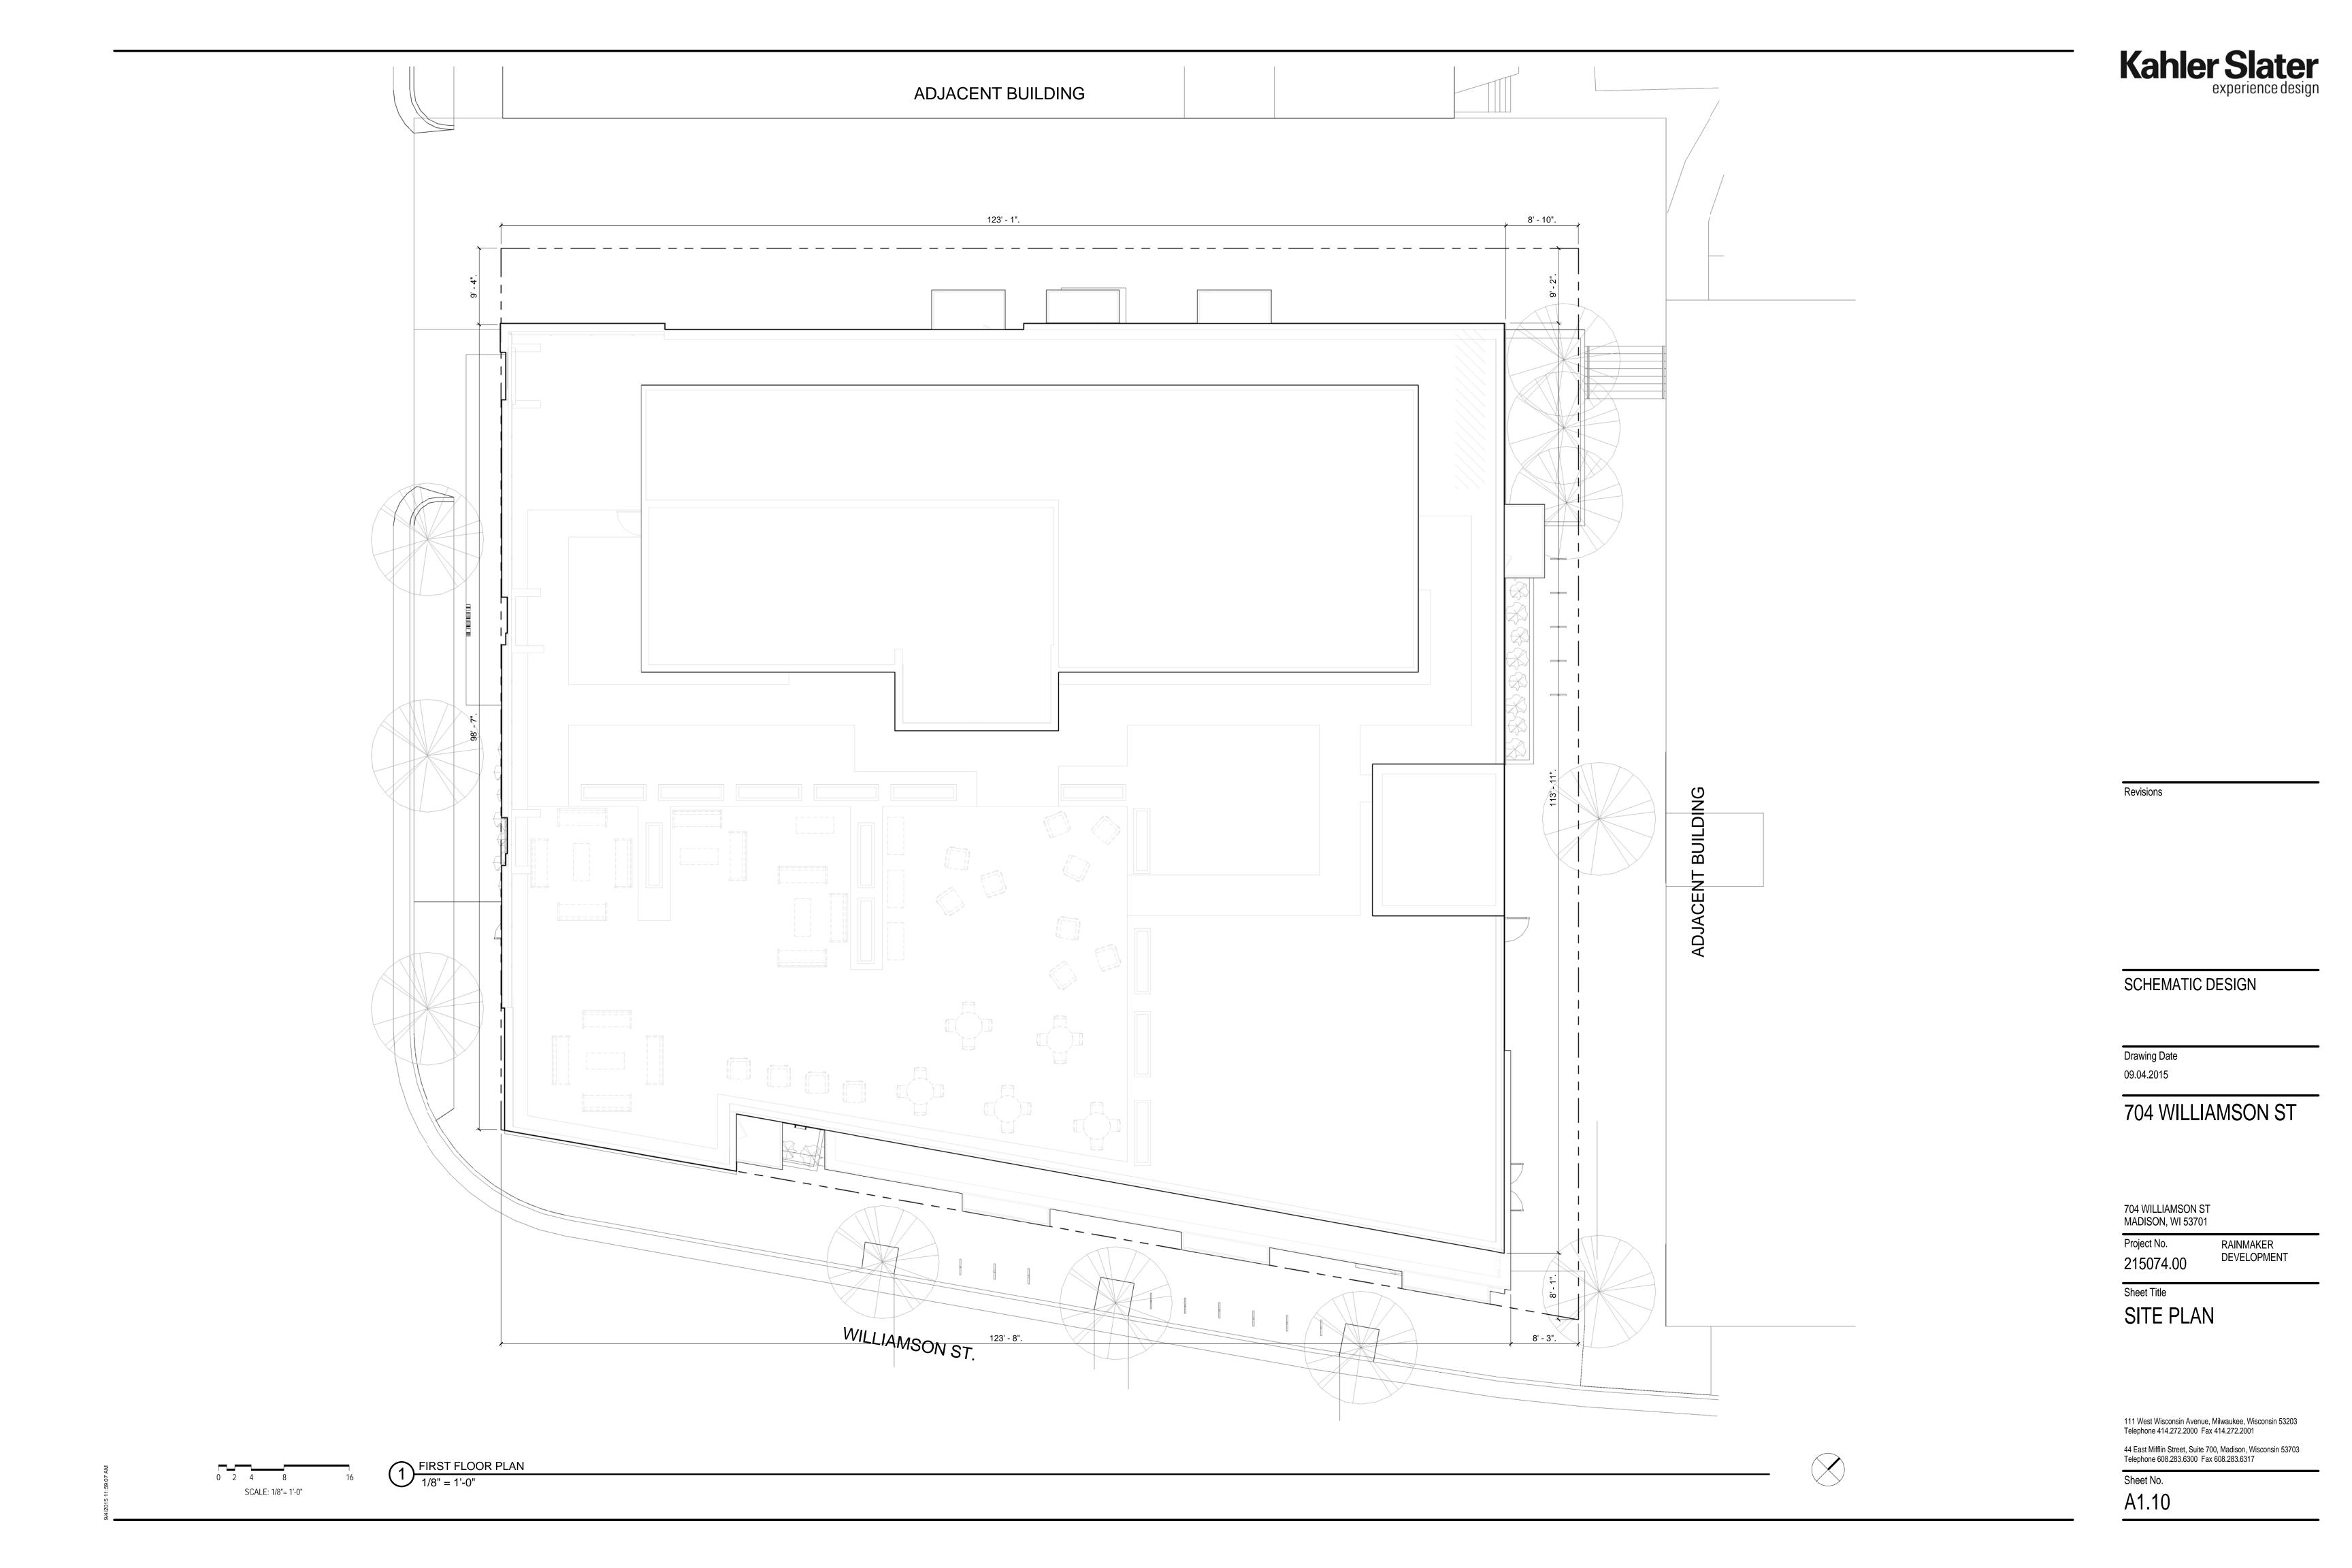
MADISON, WI

RAINMAKER DEVELOPMENT 215074.00

LANDSCAPE DETAILS, NOTES AND SPECS

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111 West Wisconsin Avenue, Milwaukee, Wisconsin Telephone 414.272.2000 Fax 414.272.2001 44 East Mifflin Street, Suite 700, Madison, Wisconsin 53703 Telephone 608.283.6300 Fax 608.283.6317







RDRAIL 2 METAL TUBE SECTION GUARDRAILS AT BALCONIES, PRIMED AND PAINTED

GUARDRAIL 2

TYPICAL SECTION @ GUARDRAIL

3/4" = 1'-0"

VEHICLE PARKING

BASEMENT LEVEL -2: 28
BASEMENT LEVEL -1: 27
-ADA VAN SPOT: 1
-ADA SPOT: 1
-CAR SHARE SPOT: 1
-TENANT PARKING: 24
LEVEL 1: 4
-ADA SPOT: 1

TOTAL: 59 PARKING SPOTS

BASEMENT LEVEL -2: 32
BASEMENT LEVEL -1: 29
TOTAL: 61 SPOTS

SHORT TERM BIKE PARKING

LEVEL 1: 10

TOTAL: 10 SPOTS

NOT FOR CONSTRUCTION

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Drawing Date 09.04.2015

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704 WILLIAMSON ST MADISON, WI 53701

Project No. RAINMAKER
DEVELOPMENT


Sheet Title

FLOOR PLAN -BASEMENT ONE

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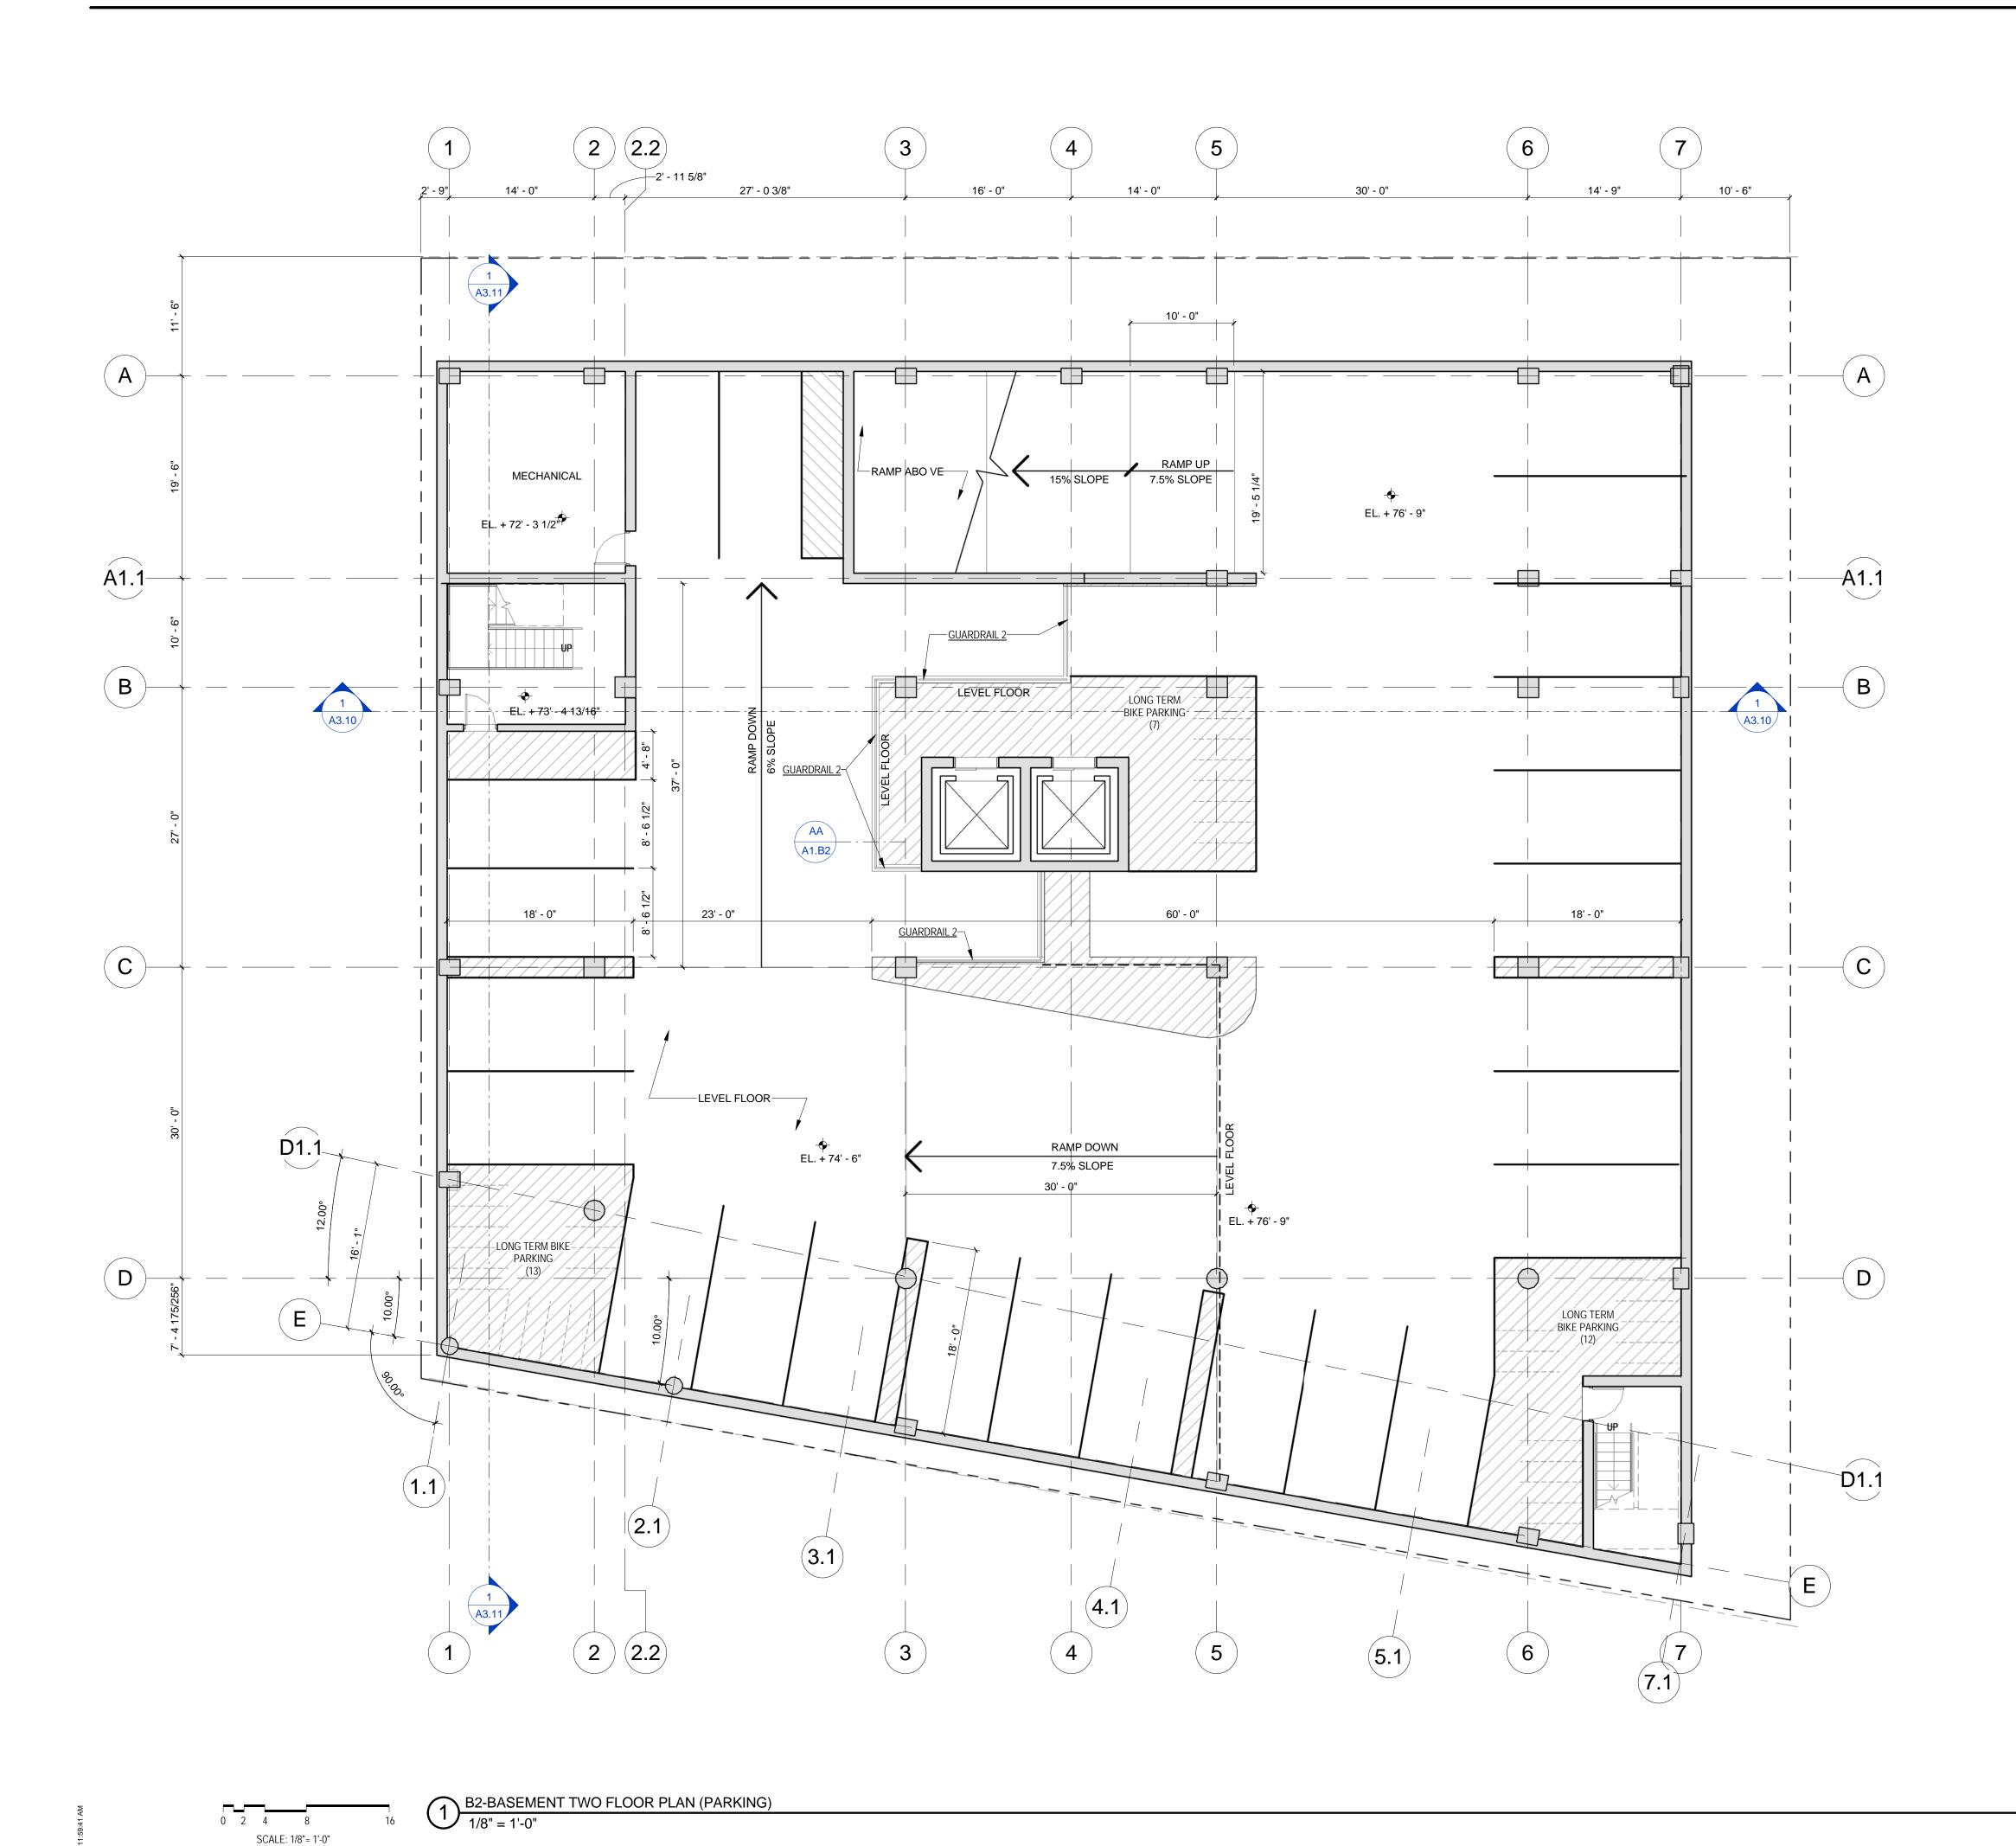
Sheet No.
A1.B1

TRUE NORTH

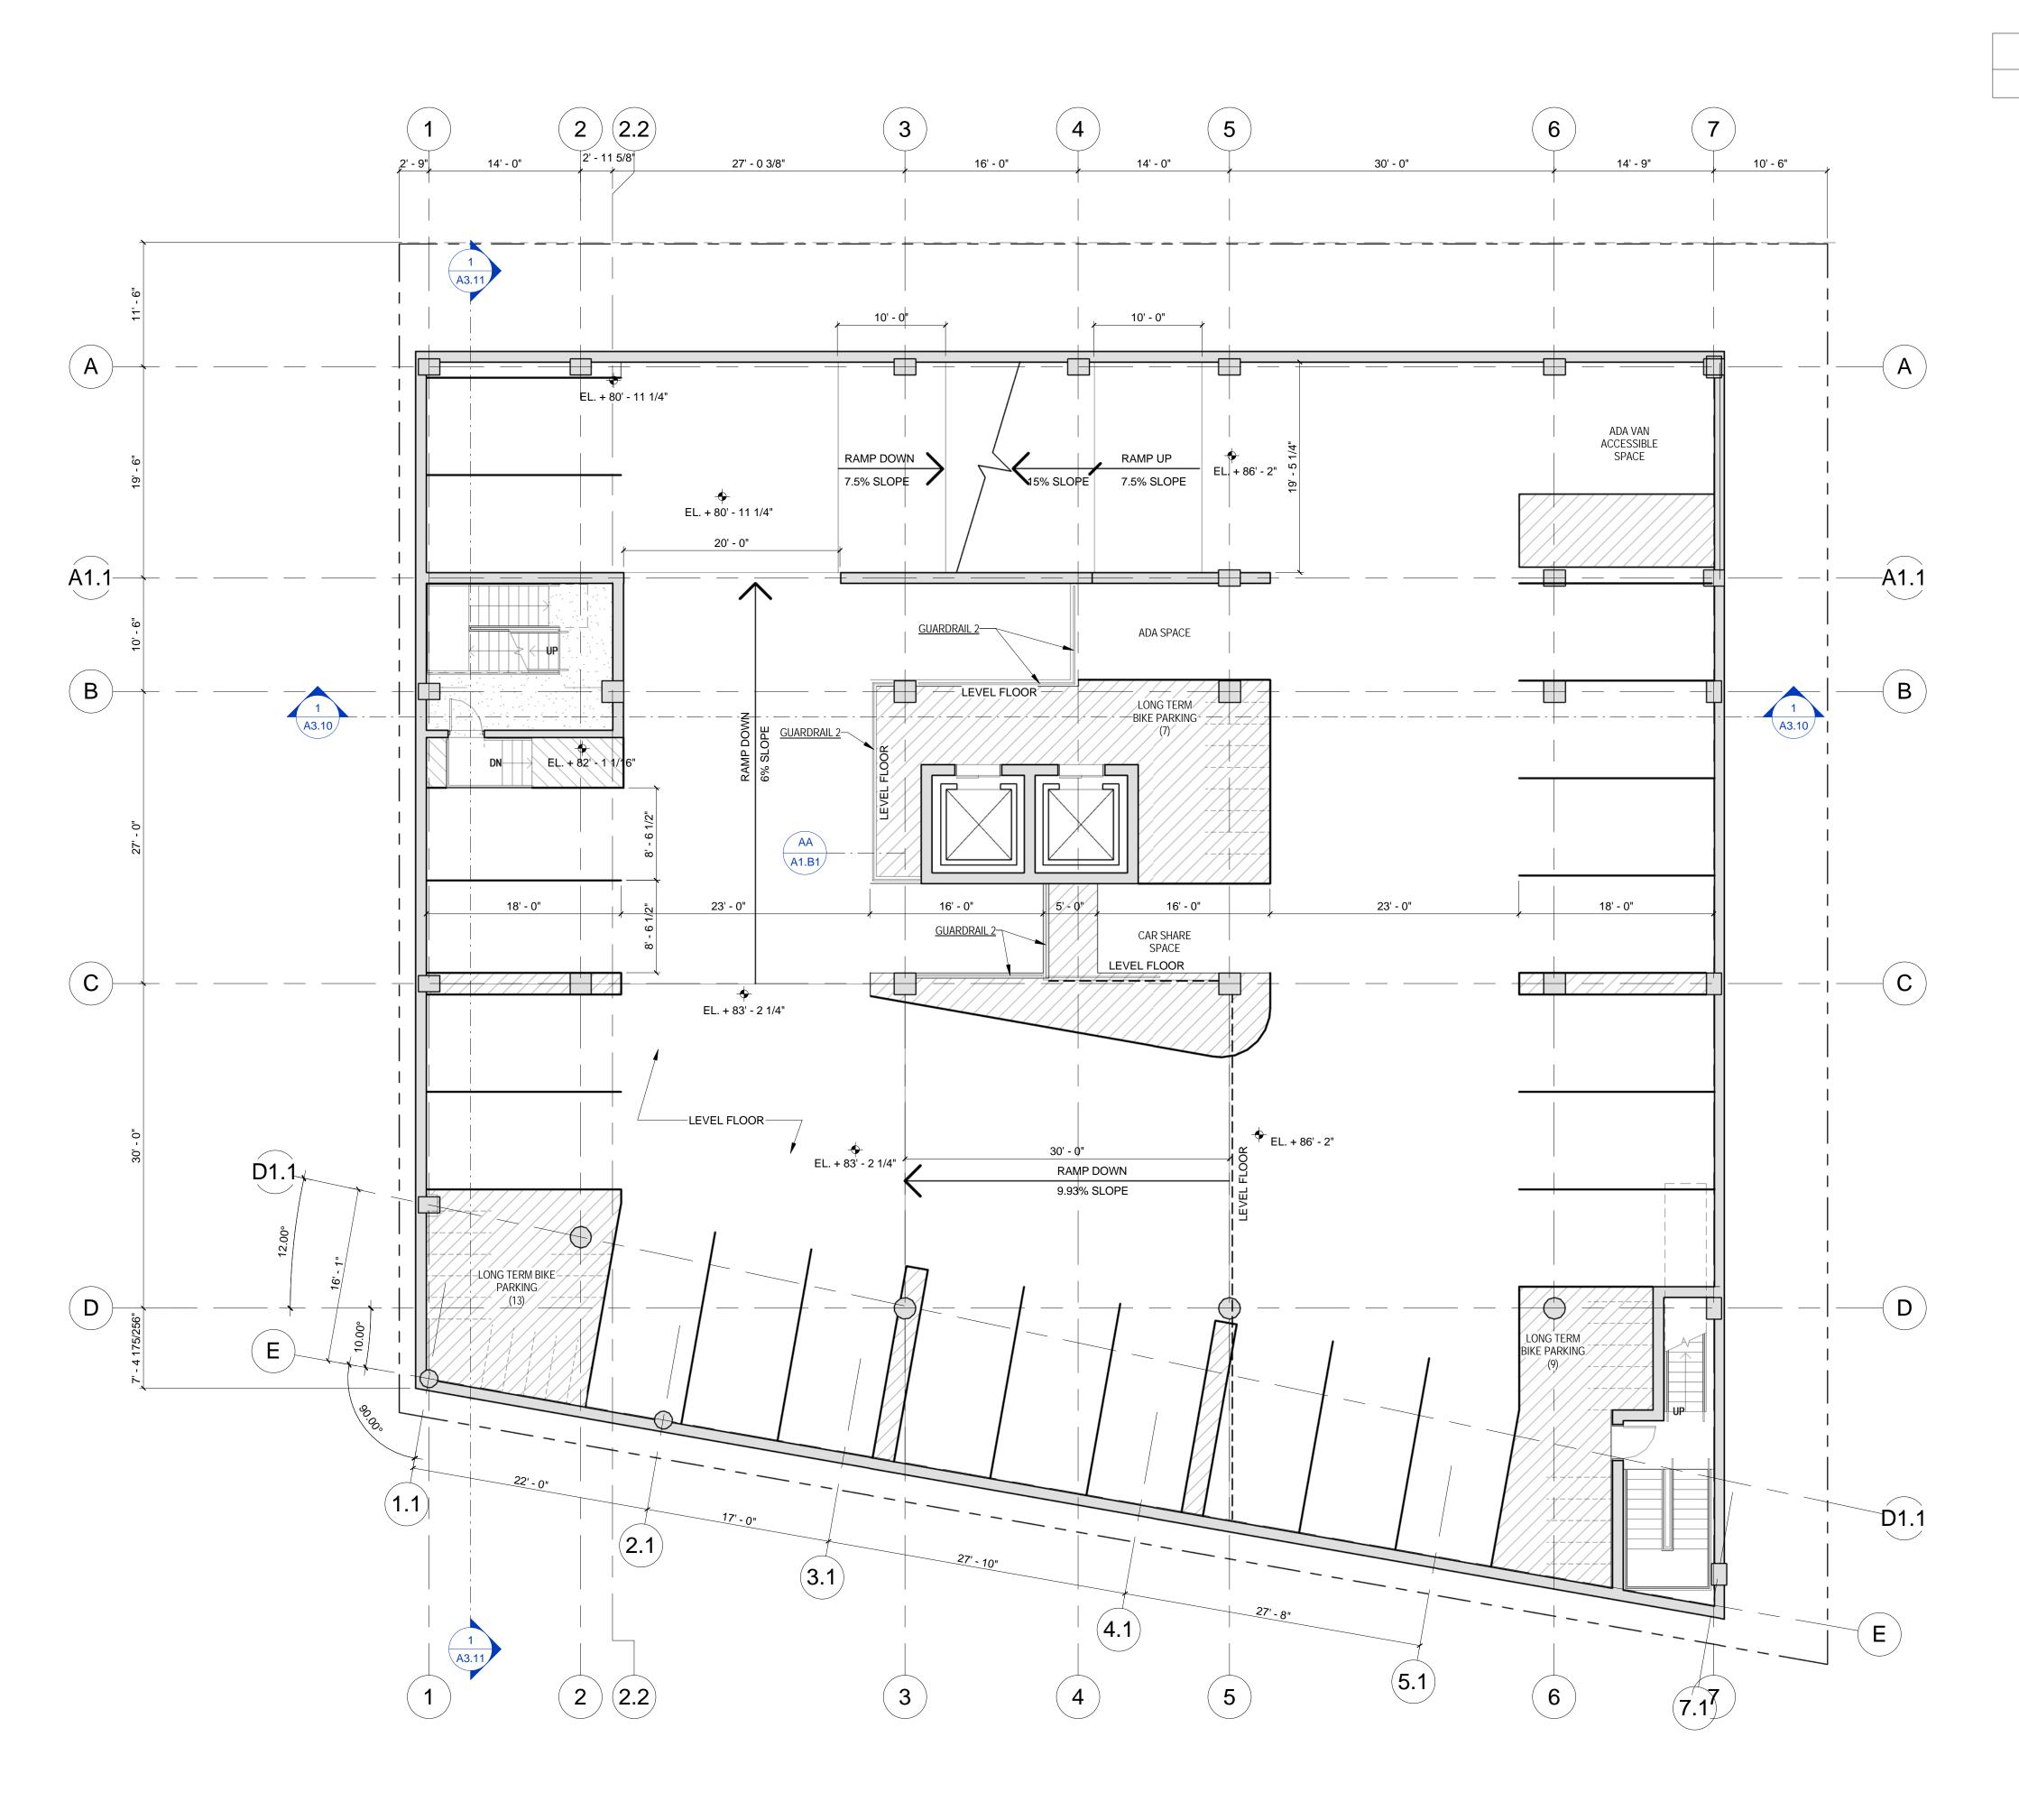

SCALE: 1/8"= 1'-0"





ASSEMBLIES & COMPONENTS

METAL TUBE SECTION GUARDRAILS AT BALCONIES, PRIMED AND PAINTED

VEHICLE PARKING BASEMENT LEVEL -2: 28 BASEMENT LEVEL -1: 27 -ADA VAN SPOT: 1 -ADA SPOT: 1 -CAR SHARE SPOT: 1 -TENANT PARKING: 24 LEVEL 1: 4 -ADA SPOT: 1 TOTAL: 59 PARKING SPOTS

LONG TERM BIKE PARKING BASEMENT LEVEL -2: 32 BASEMENT LEVEL -1: 29

TOTAL: 61 SPOTS

SHORT TERM BIKE PARKING LEVEL 1: 10 TOTAL: 10 SPOTS

GUARDRAIL 2-TYPICAL SECTION @ GUARDRAIL

3/4" = 1'-0"

Revisions

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RAINMAKER DEVELOPMENT 215074.00


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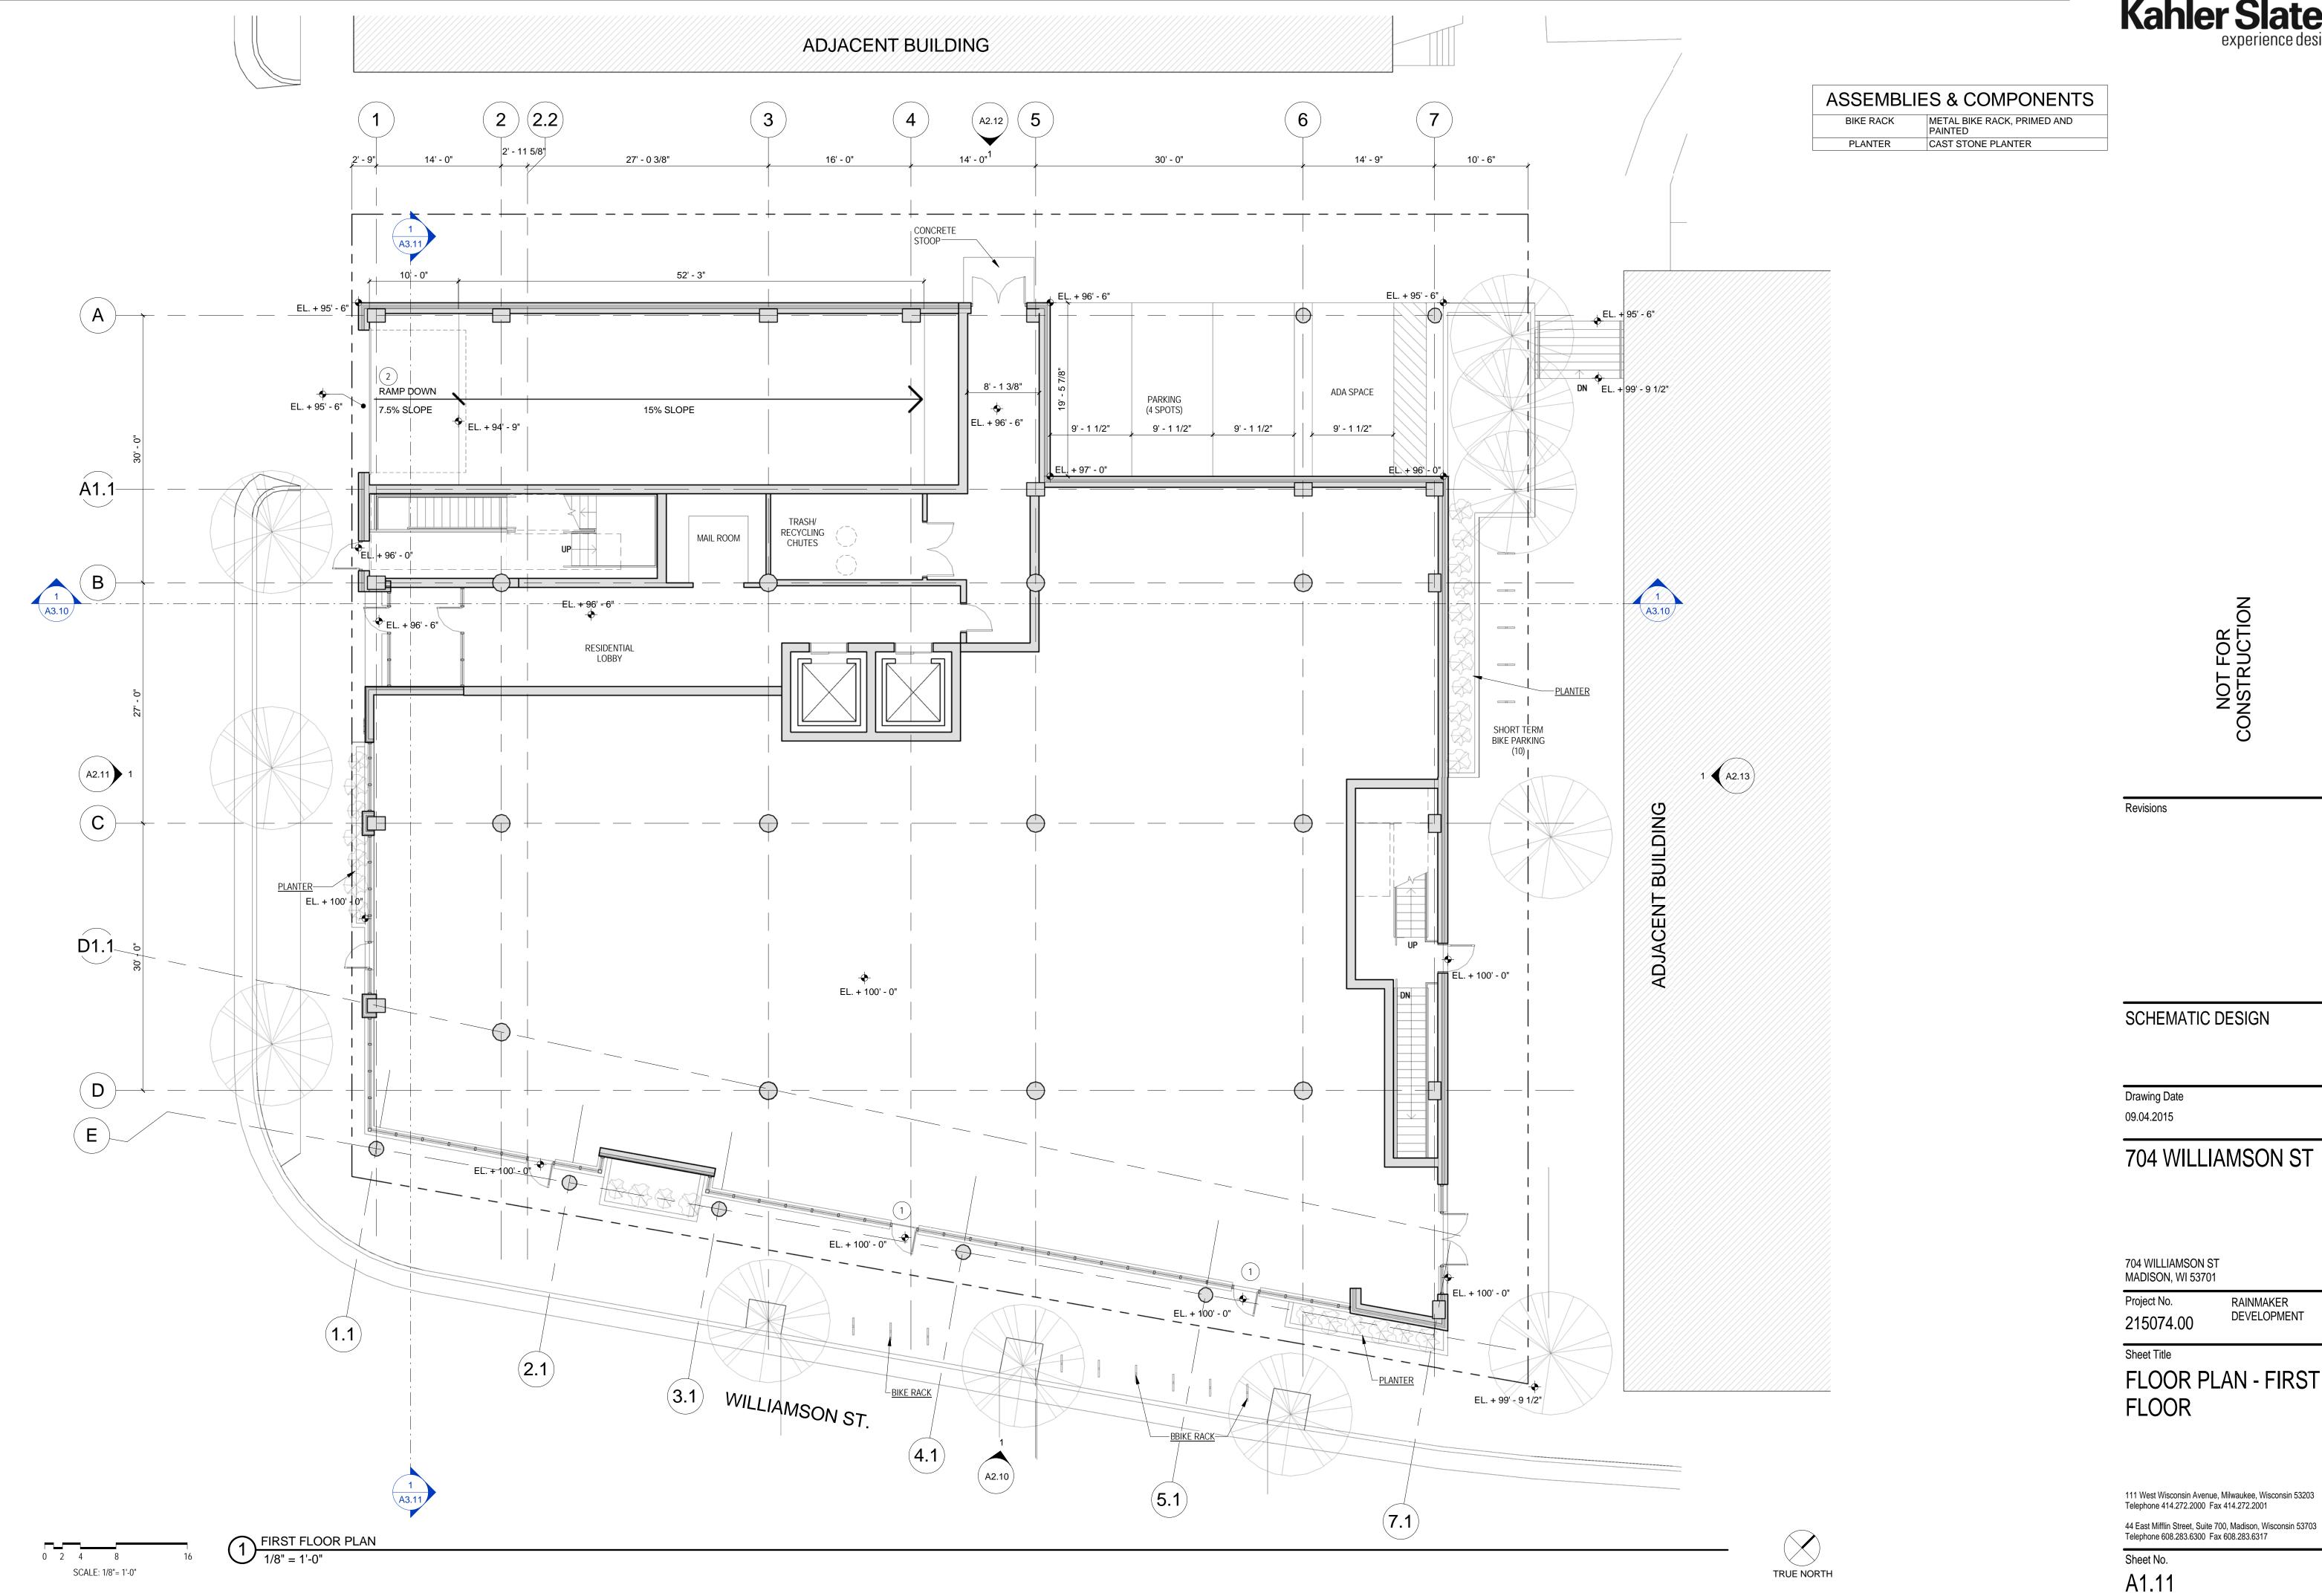
FLOOR PLAN -**BASEMENT TWO**

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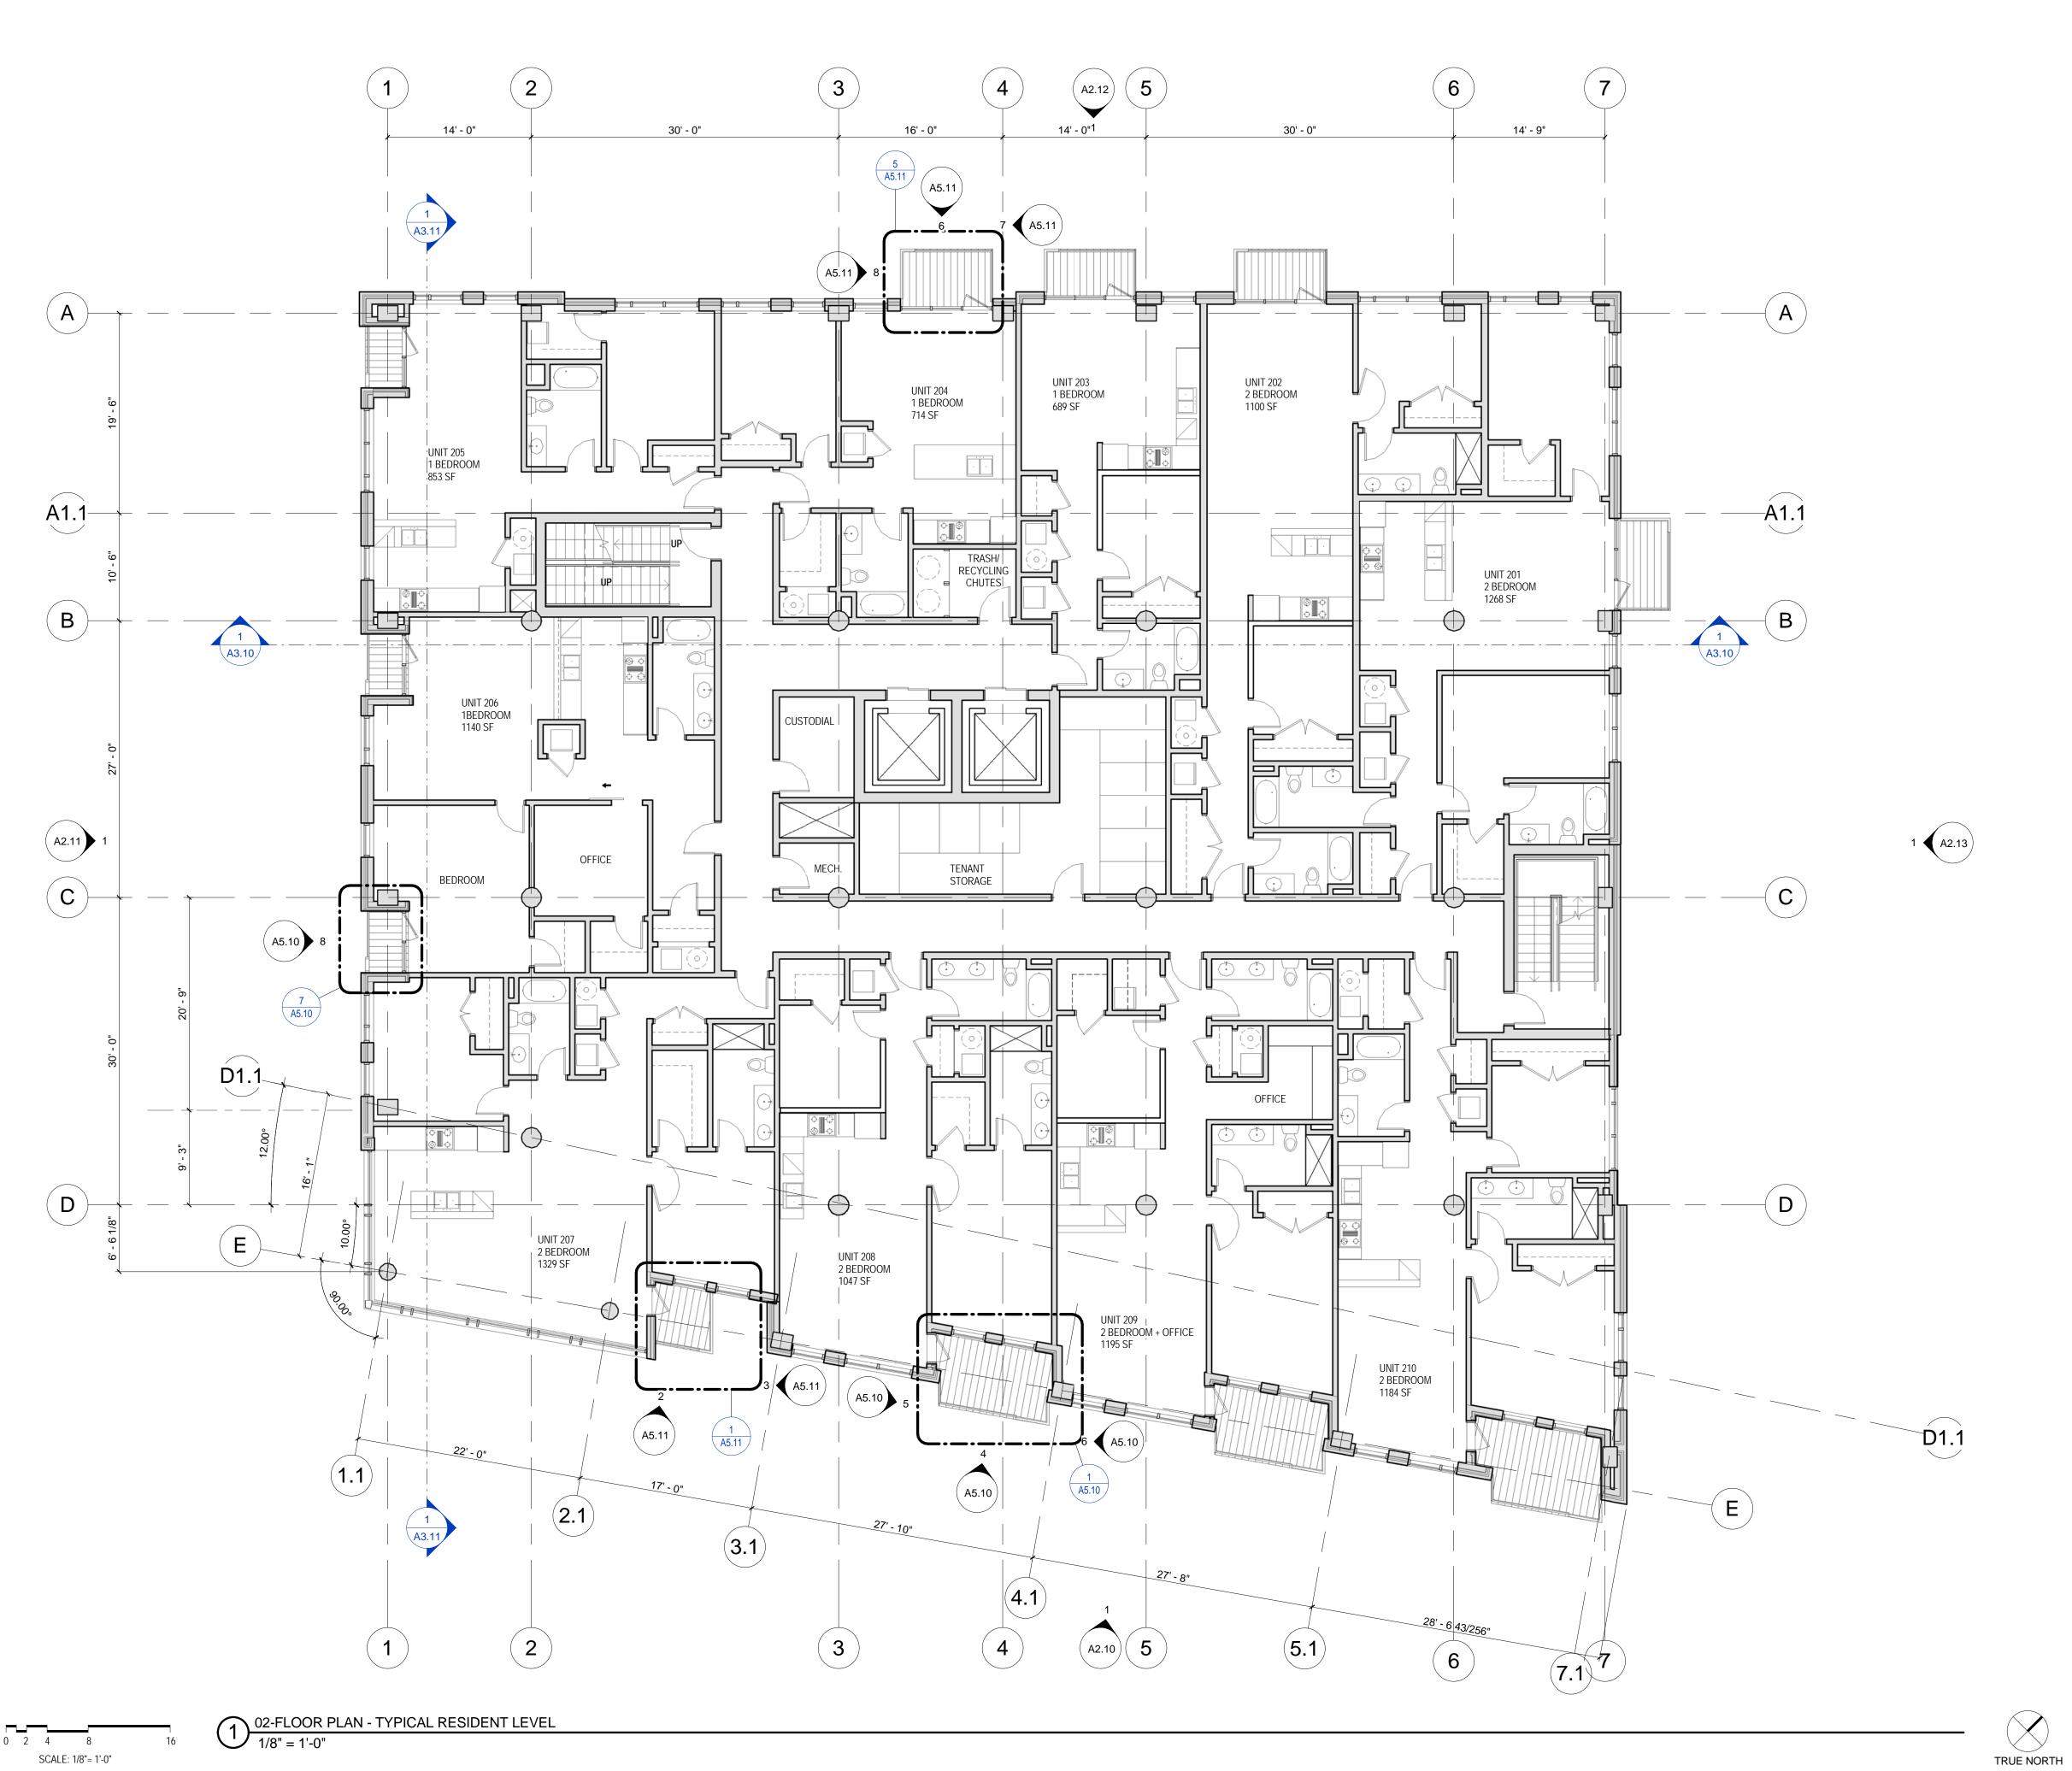
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TRUE NORTH







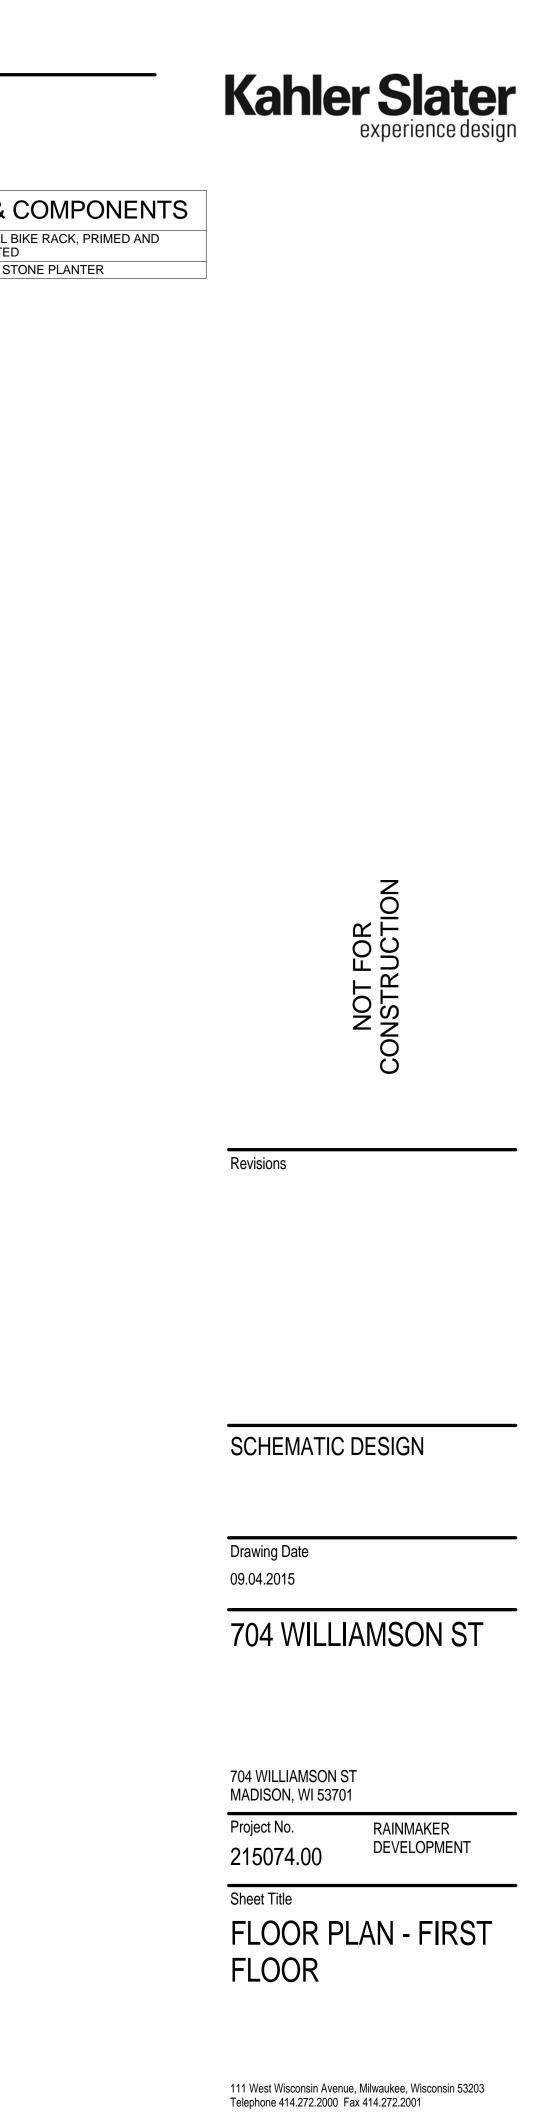

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FLOOR PLAN -TYPICAL RESIDENT LEVEL


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A1.12

SCALE: 1/8"= 1'-0"





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Sheet Title

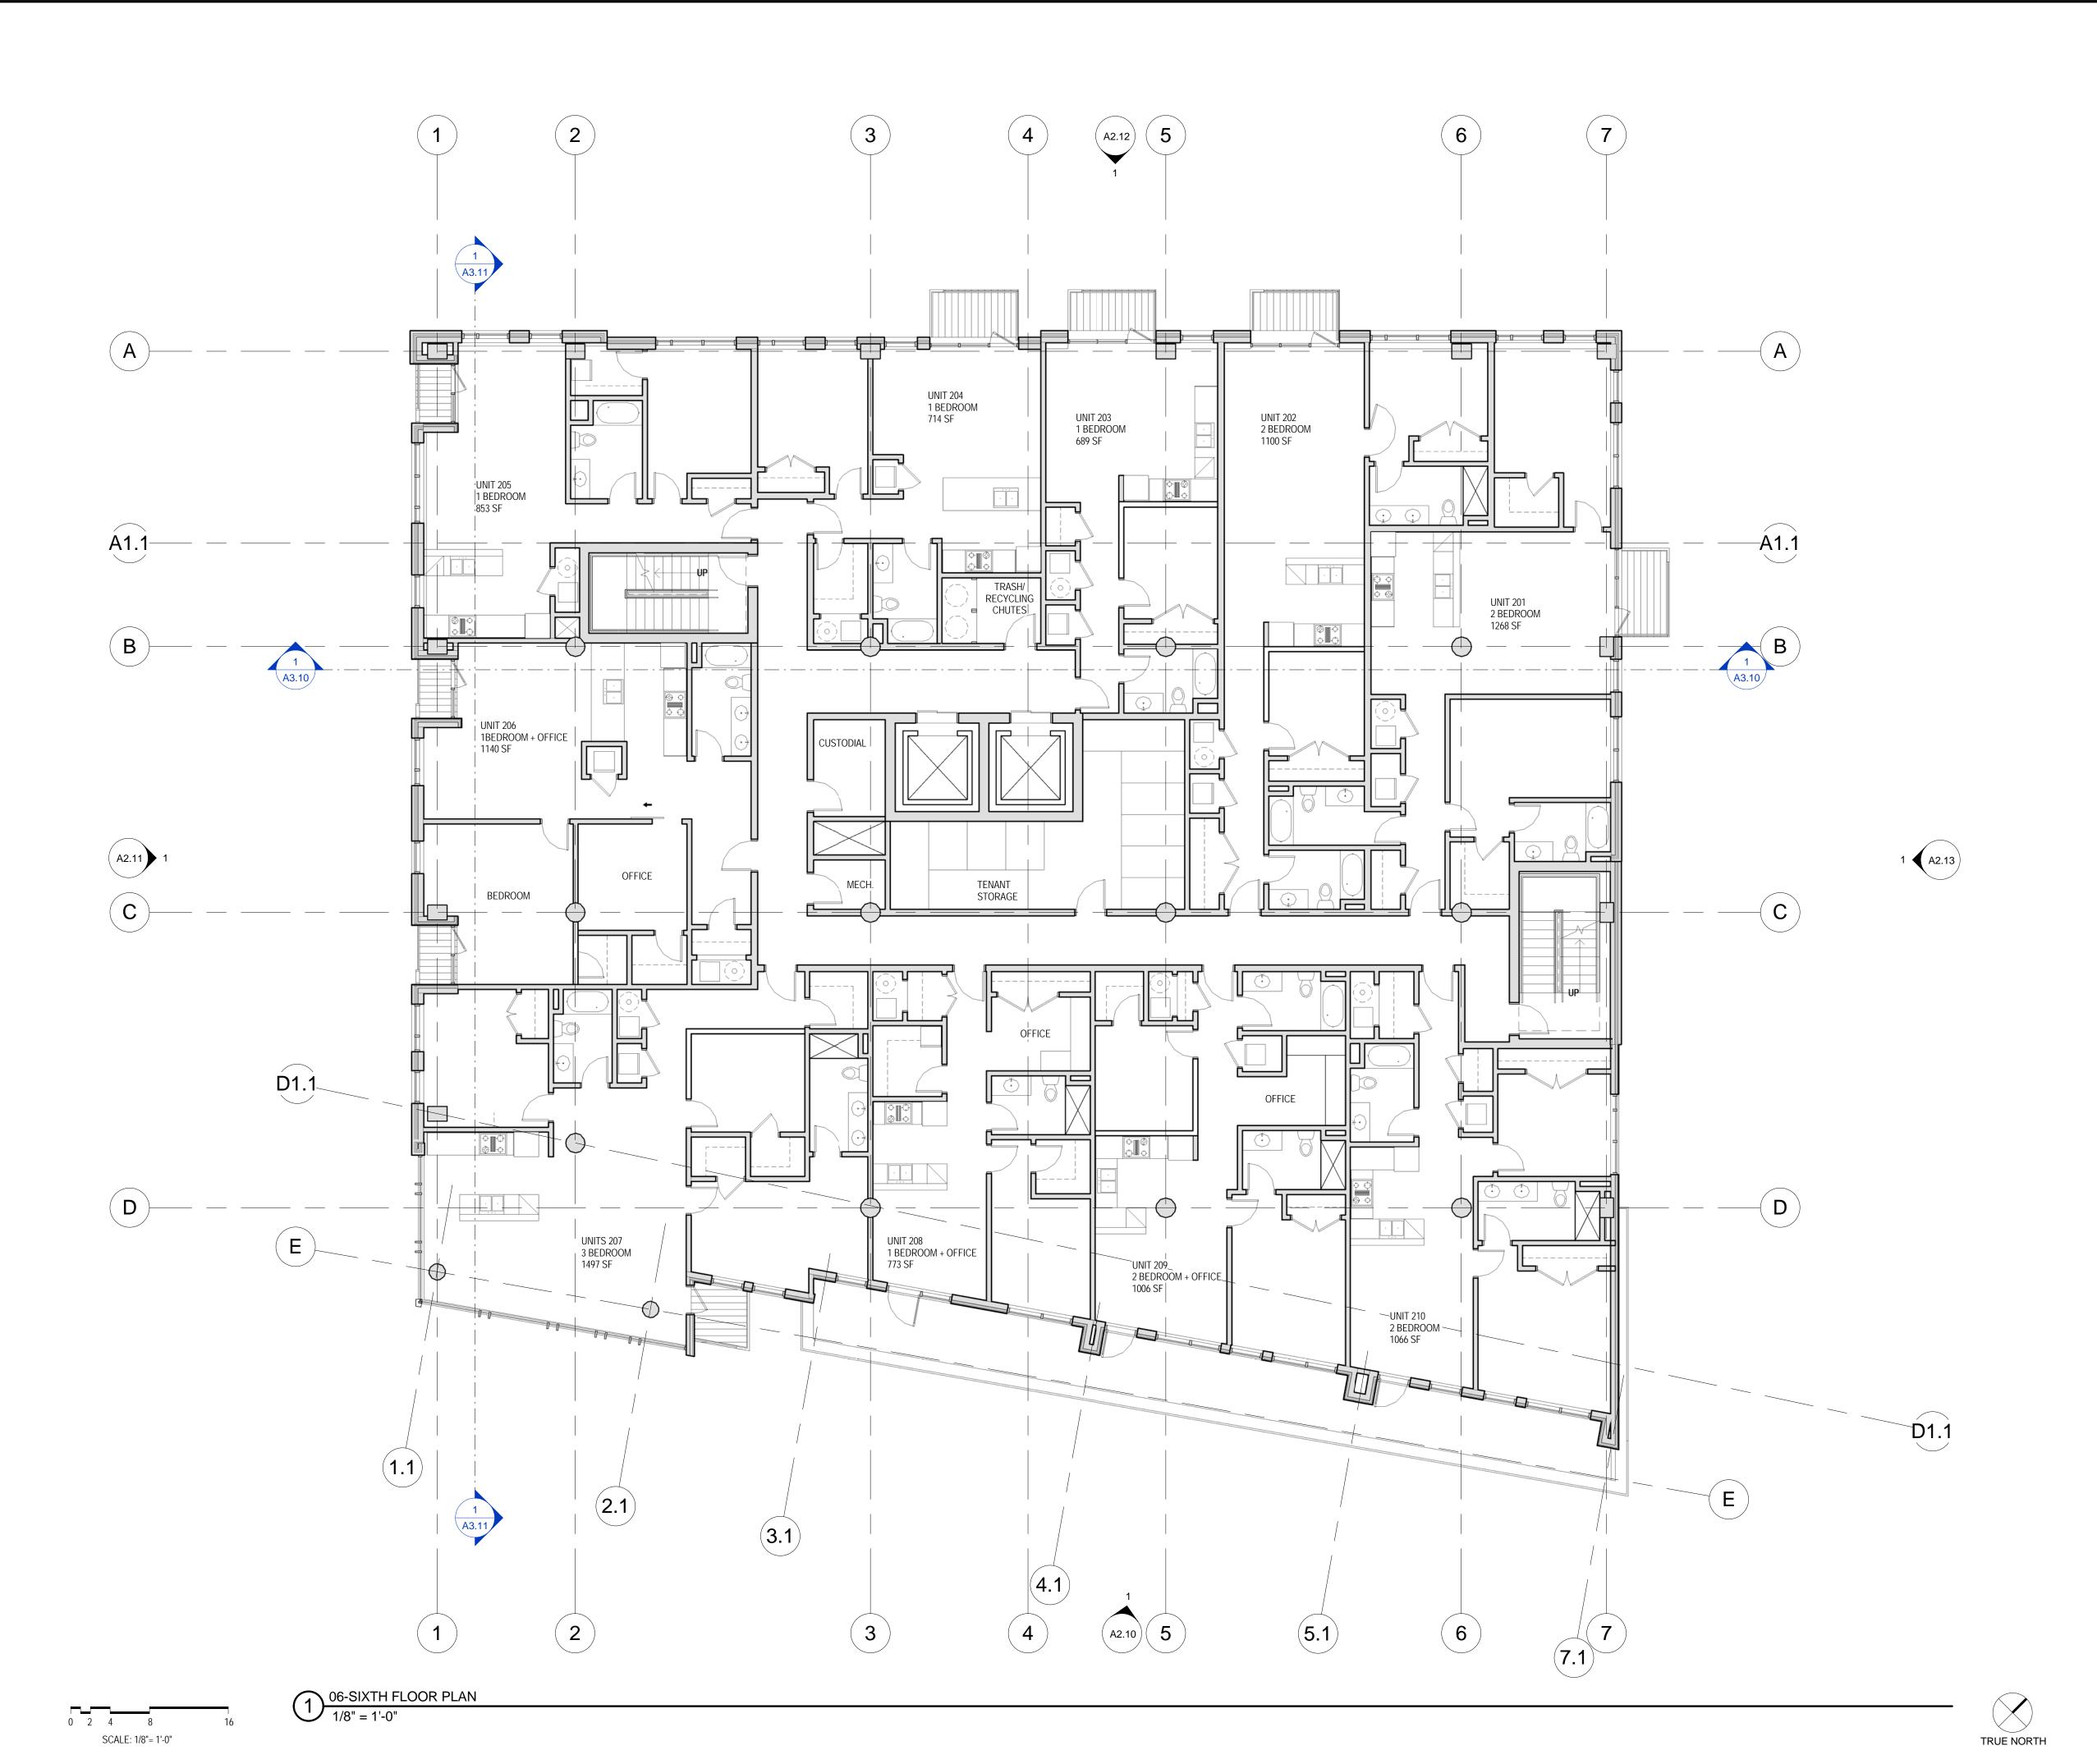FLOOR PLAN - LEVEL 6


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FLOOR PLAN - ROOF TERRACE

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Sheet No.

A1.17

ASSEN	MBLIES & COMPONENTS
BURNISHED BLOCK 1	3-5/8"x15-5/8"x7-5/8" BURNISHED BLOCK UNITS WITH TINTED MORTAR COLOR; BASIS OF DESIGN PREMIER ULTRA BURNISHED MASONRY UNITS COLOR GALAXY
GLAZING 1	VISION GLASS; 1" DUAL PANE INSULATED GLAZING WITH LOW-E COATING ON #2 SURFACE; BASIS OF DESIGN IS PPG SOLARBAN 60 ON CLEAR
GLAZING 3	TRANSLUCENT GLASS; GLAZING 1 WITH OPAQUE GREEN ACCENT FILM ON #3 SURFACE
GUARDRAIL 1	METAL TUBE SECTION GUARDRAILS w/ HANDRAILS AT STAIRS, PRIMED AND PAINTED
GUARDRAIL 2	METAL TUBE SECTION GUARDRAILS AT BALCONIES, PRIMED AND PAINTED
METAL PANEL 1	PREFINISHED METAL PANEL
WINDOW 1	ALUMINUM FRAMED FIXED WINDOW UNIT; BASIS OF DESIGN IS EFCO T325 TERRASTILE; SEE WINDOW FRAME ELEVATIONS; MATCH METAL PANEL COLOR
WINDOW 2	ALUMINUM FRAMED STICK-BUILT STOREFRONT SYSTEM; BASIS OF DESIGN IS KAWNEER 451T, SEE WINDOW FRAME ELEVATIONS; MATCH METAL PANEL COLOR
WOOD CLADDING 1	PAINTED WOOD CLADDING @ BALCONY



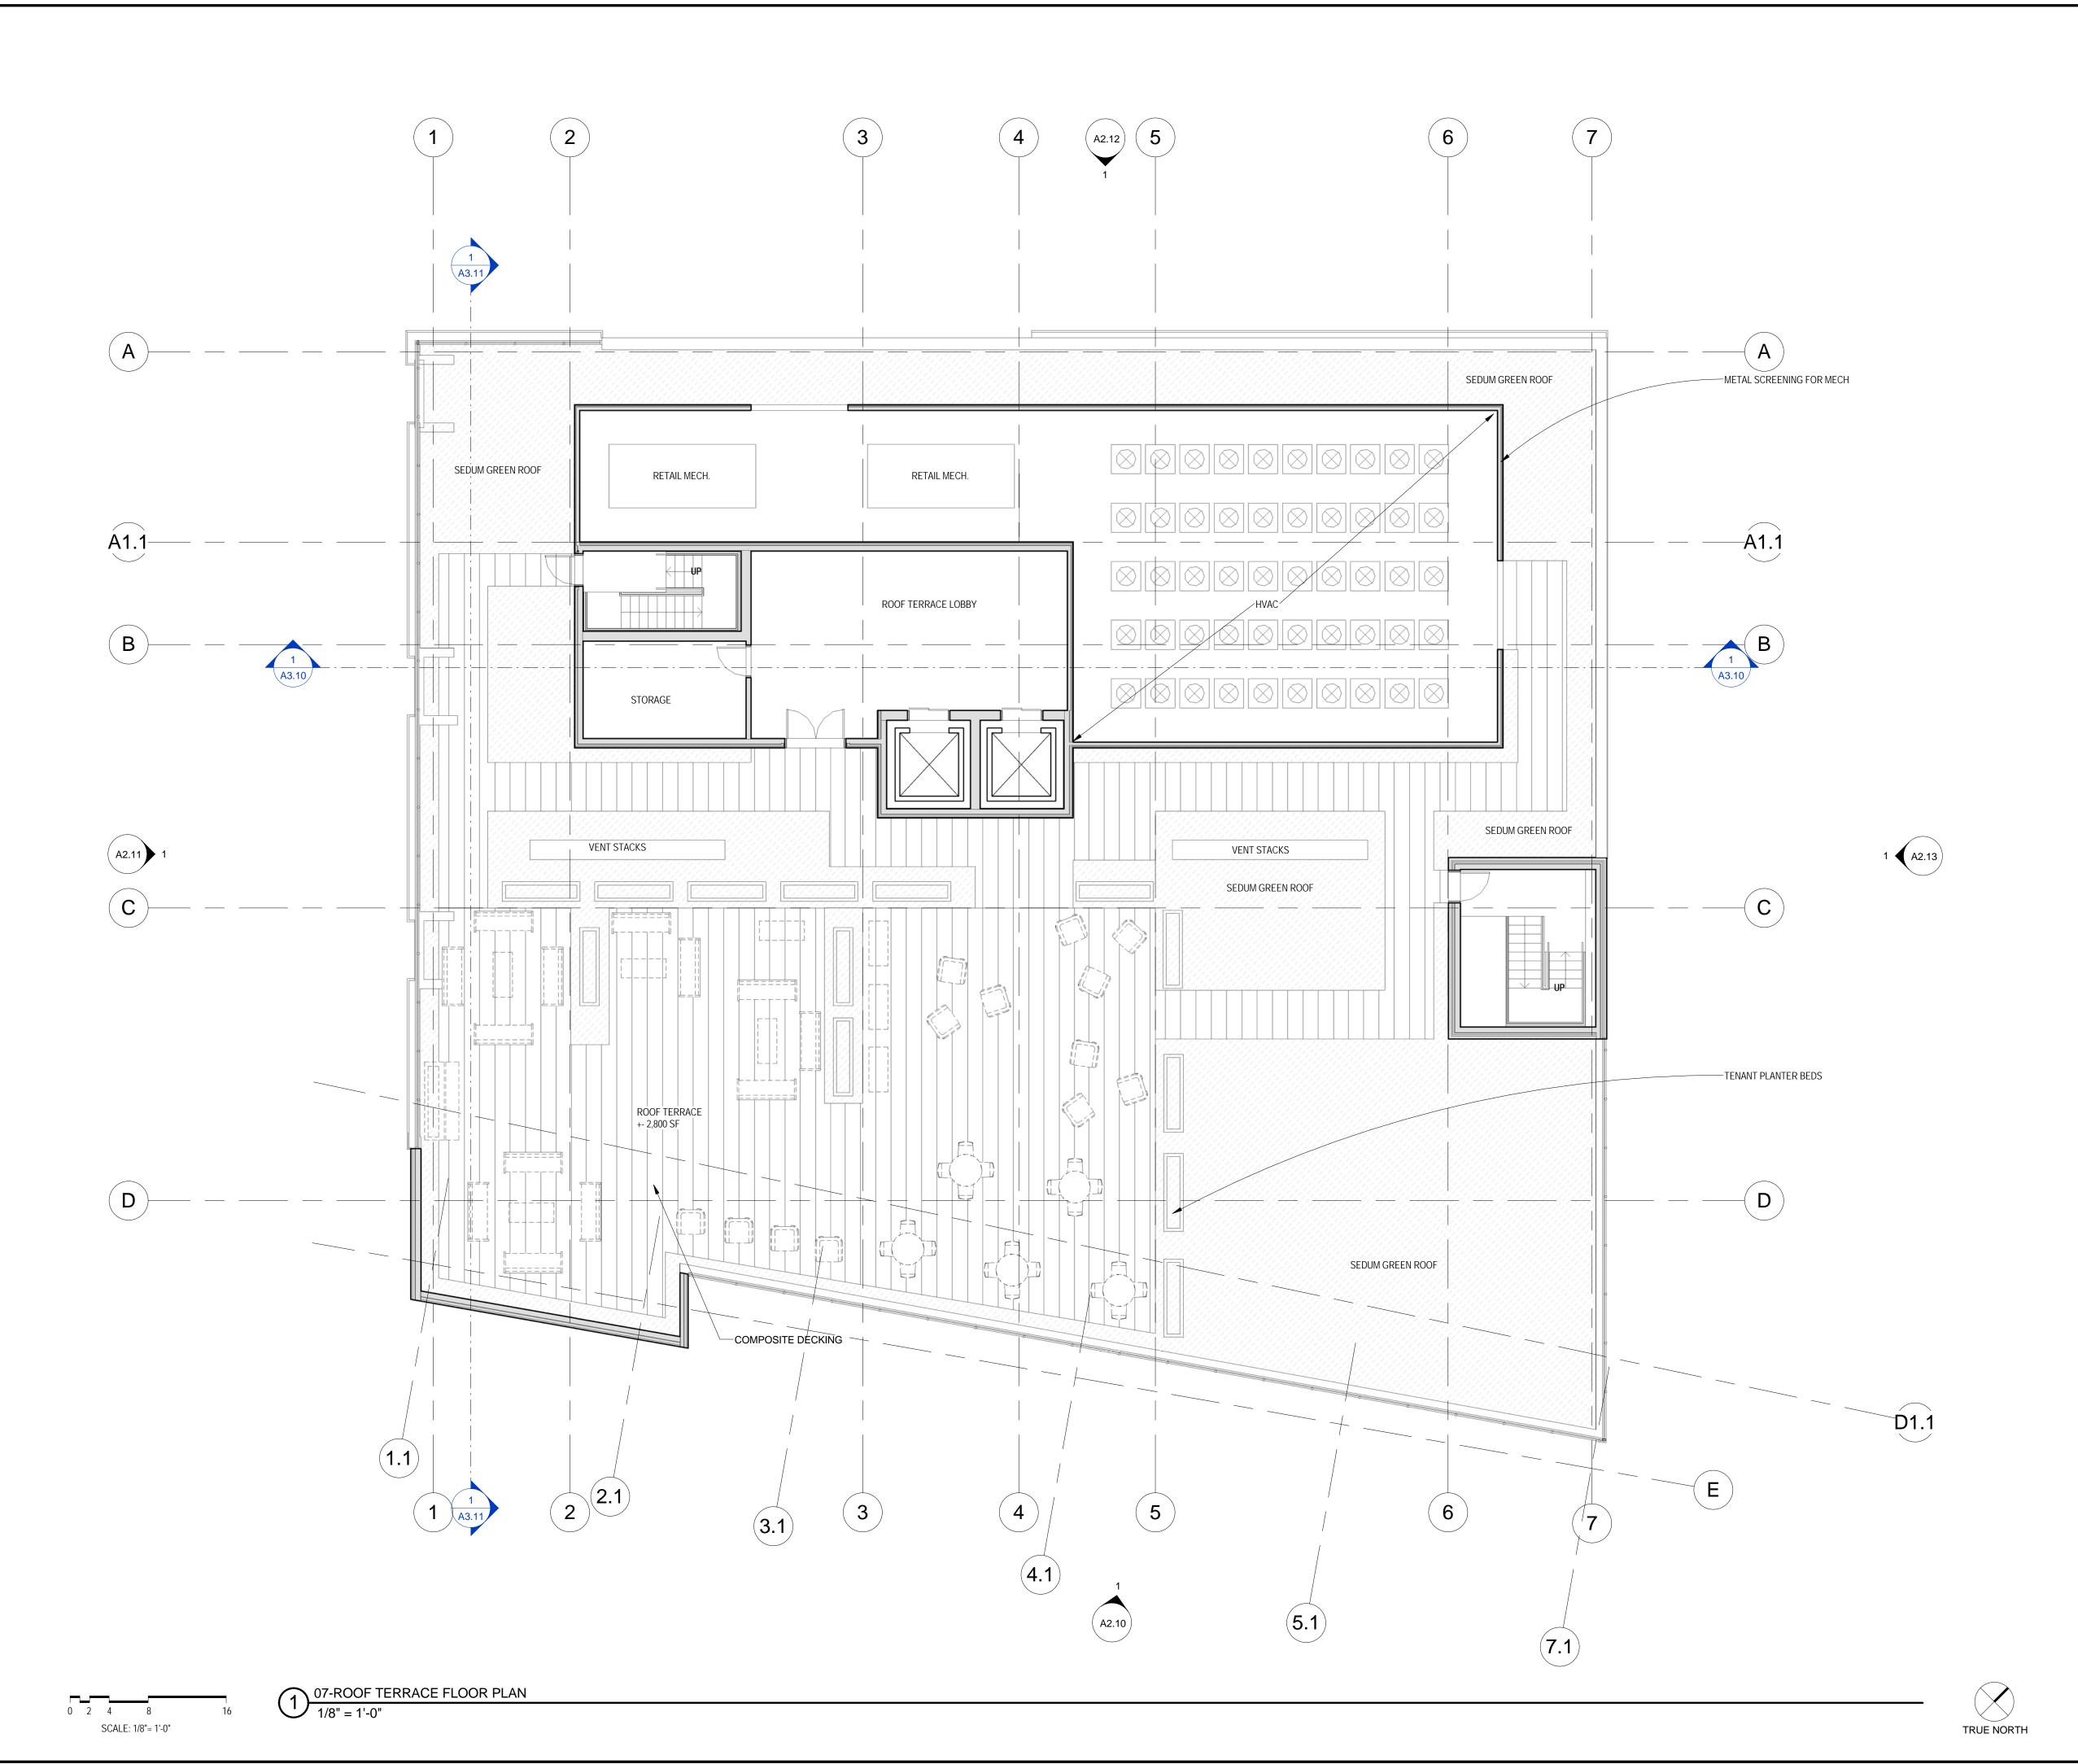

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EXTERIOR ELEVATION - SOUTH

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A2.10







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Drawing Date 09.04.2015

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Project No. RAINMAKER

DEVELOPMENT 215074.00

Sheet Title

EXTERIOR ELEVATION - WEST

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Sheet No.

A2.11

WEST ELEVATION

1/8" = 1'-0"

ASSEN	MBLIES & COMPONENTS
BRICK 1	MODULAR CLAY BRICK MASONRY IN RUNNING BOND WITH TINTED MORTAR COLOR; BASIS OF DESIGN IS ENDICOTT'S LIGHT SANDSTONE VELOUR
BURNISHED BLOCK 1	3-5/8"x15-5/8"x7-5/8" BURNISHED BLOCK UNITS WITH TINTED MORTAR COLOR; BASIS OF DESIGN PREMIER ULTRA BURNISHED MASONRY UNITS COLOR GALAXY
GLAZING 1	VISION GLASS; 1" DUAL PANE INSULATED GLAZING WITH LOW-E COATING ON #2 SURFACE; BASIS OF DESIGN IS PPG SOLARBAN 60 ON CLEAR
GLAZING 3	TRANSLUCENT GLASS; GLAZING 1 WITH OPAQUE GREEN ACCENT FILM ON #3 SURFACE
GUARDRAIL 2	METAL TUBE SECTION GUARDRAILS AT BALCONIES, PRIMED AND PAINTED
METAL PANEL 1	PREFINISHED METAL PANEL
WALL ASSEMBLY 3	6" METAL STUD, 5/8" SHEATHING, WEATHER BARRIER, 2" RIGID INSULATION, AIR SPACE, BURNISHED BLOCK 1





SCALE: 1/8"= 1'-0"

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EXTERIOR ELEVATION - NORTH

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A2.12

ASSEMBLIES & COMPONENTS		
BRICK 1	MODULAR CLAY BRICK MASONRY IN RUNNING BOND WITH TINTED MORTAR COLOR; BASIS OF DESIGN IS ENDICOTT'S LIGHT SANDSTONE VELOUR	
BURNISHED BLOCK 1	3-5/8"x15-5/8"x7-5/8" BURNISHED BLOCK UNITS WITH TINTED MORTAR COLOR; BASIS OF DESIGN PREMIER ULTRA BURNISHED MASONRY UNITS COLOR GALAXY	
GLAZING 1	VISION GLASS; 1" DUAL PANE INSULATED GLAZING WITH LOW-E COATING ON #2 SURFACE; BASIS OF DESIGN IS PPG SOLARBAN 60 ON CLEAR	
GLAZING 3	TRANSLUCENT GLASS; GLAZING 1 WITH OPAQUE GREEN ACCENT FILM ON #3 SURFACE	
GUARDRAIL 1	METAL TUBE SECTION GUARDRAILS W/ HANDRAILS AT STAIRS, PRIMED AND PAINTED	
GUARDRAIL 2	METAL TUBE SECTION GUARDRAILS AT BALCONIES, PRIMED AND PAINTED	
METAL PANEL 1	PREFINISHED METAL PANEL	
WALL ASSEMBLY 1	6" METAL STUD, 5/8" SHEATHING, WEATHER BARRIER, 2" RIGID INSULATION, AIR SPACE, BRICK 1	
WALL ASSEMBLY 3	6" METAL STUD, 5/8" SHEATHING, WEATHER BARRIER, 2" RIGID INSULATION, AIR SPACE, BURNISHED BLOCK 1	





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Drawing Date 09.04.2015

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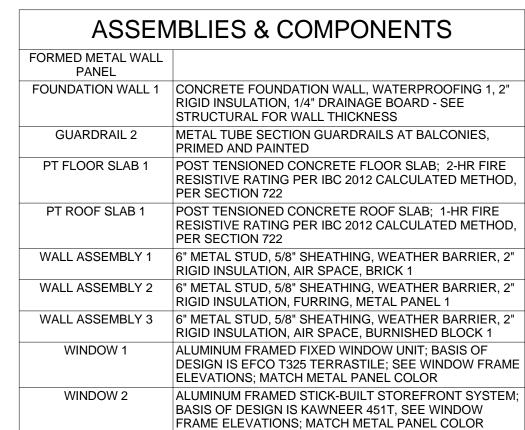
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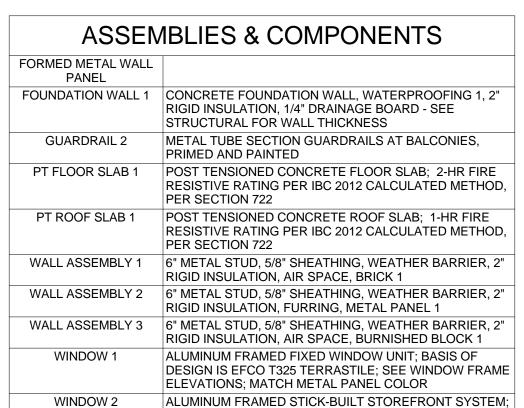
EXTERIOR ELEVATION - EAST

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A2.13





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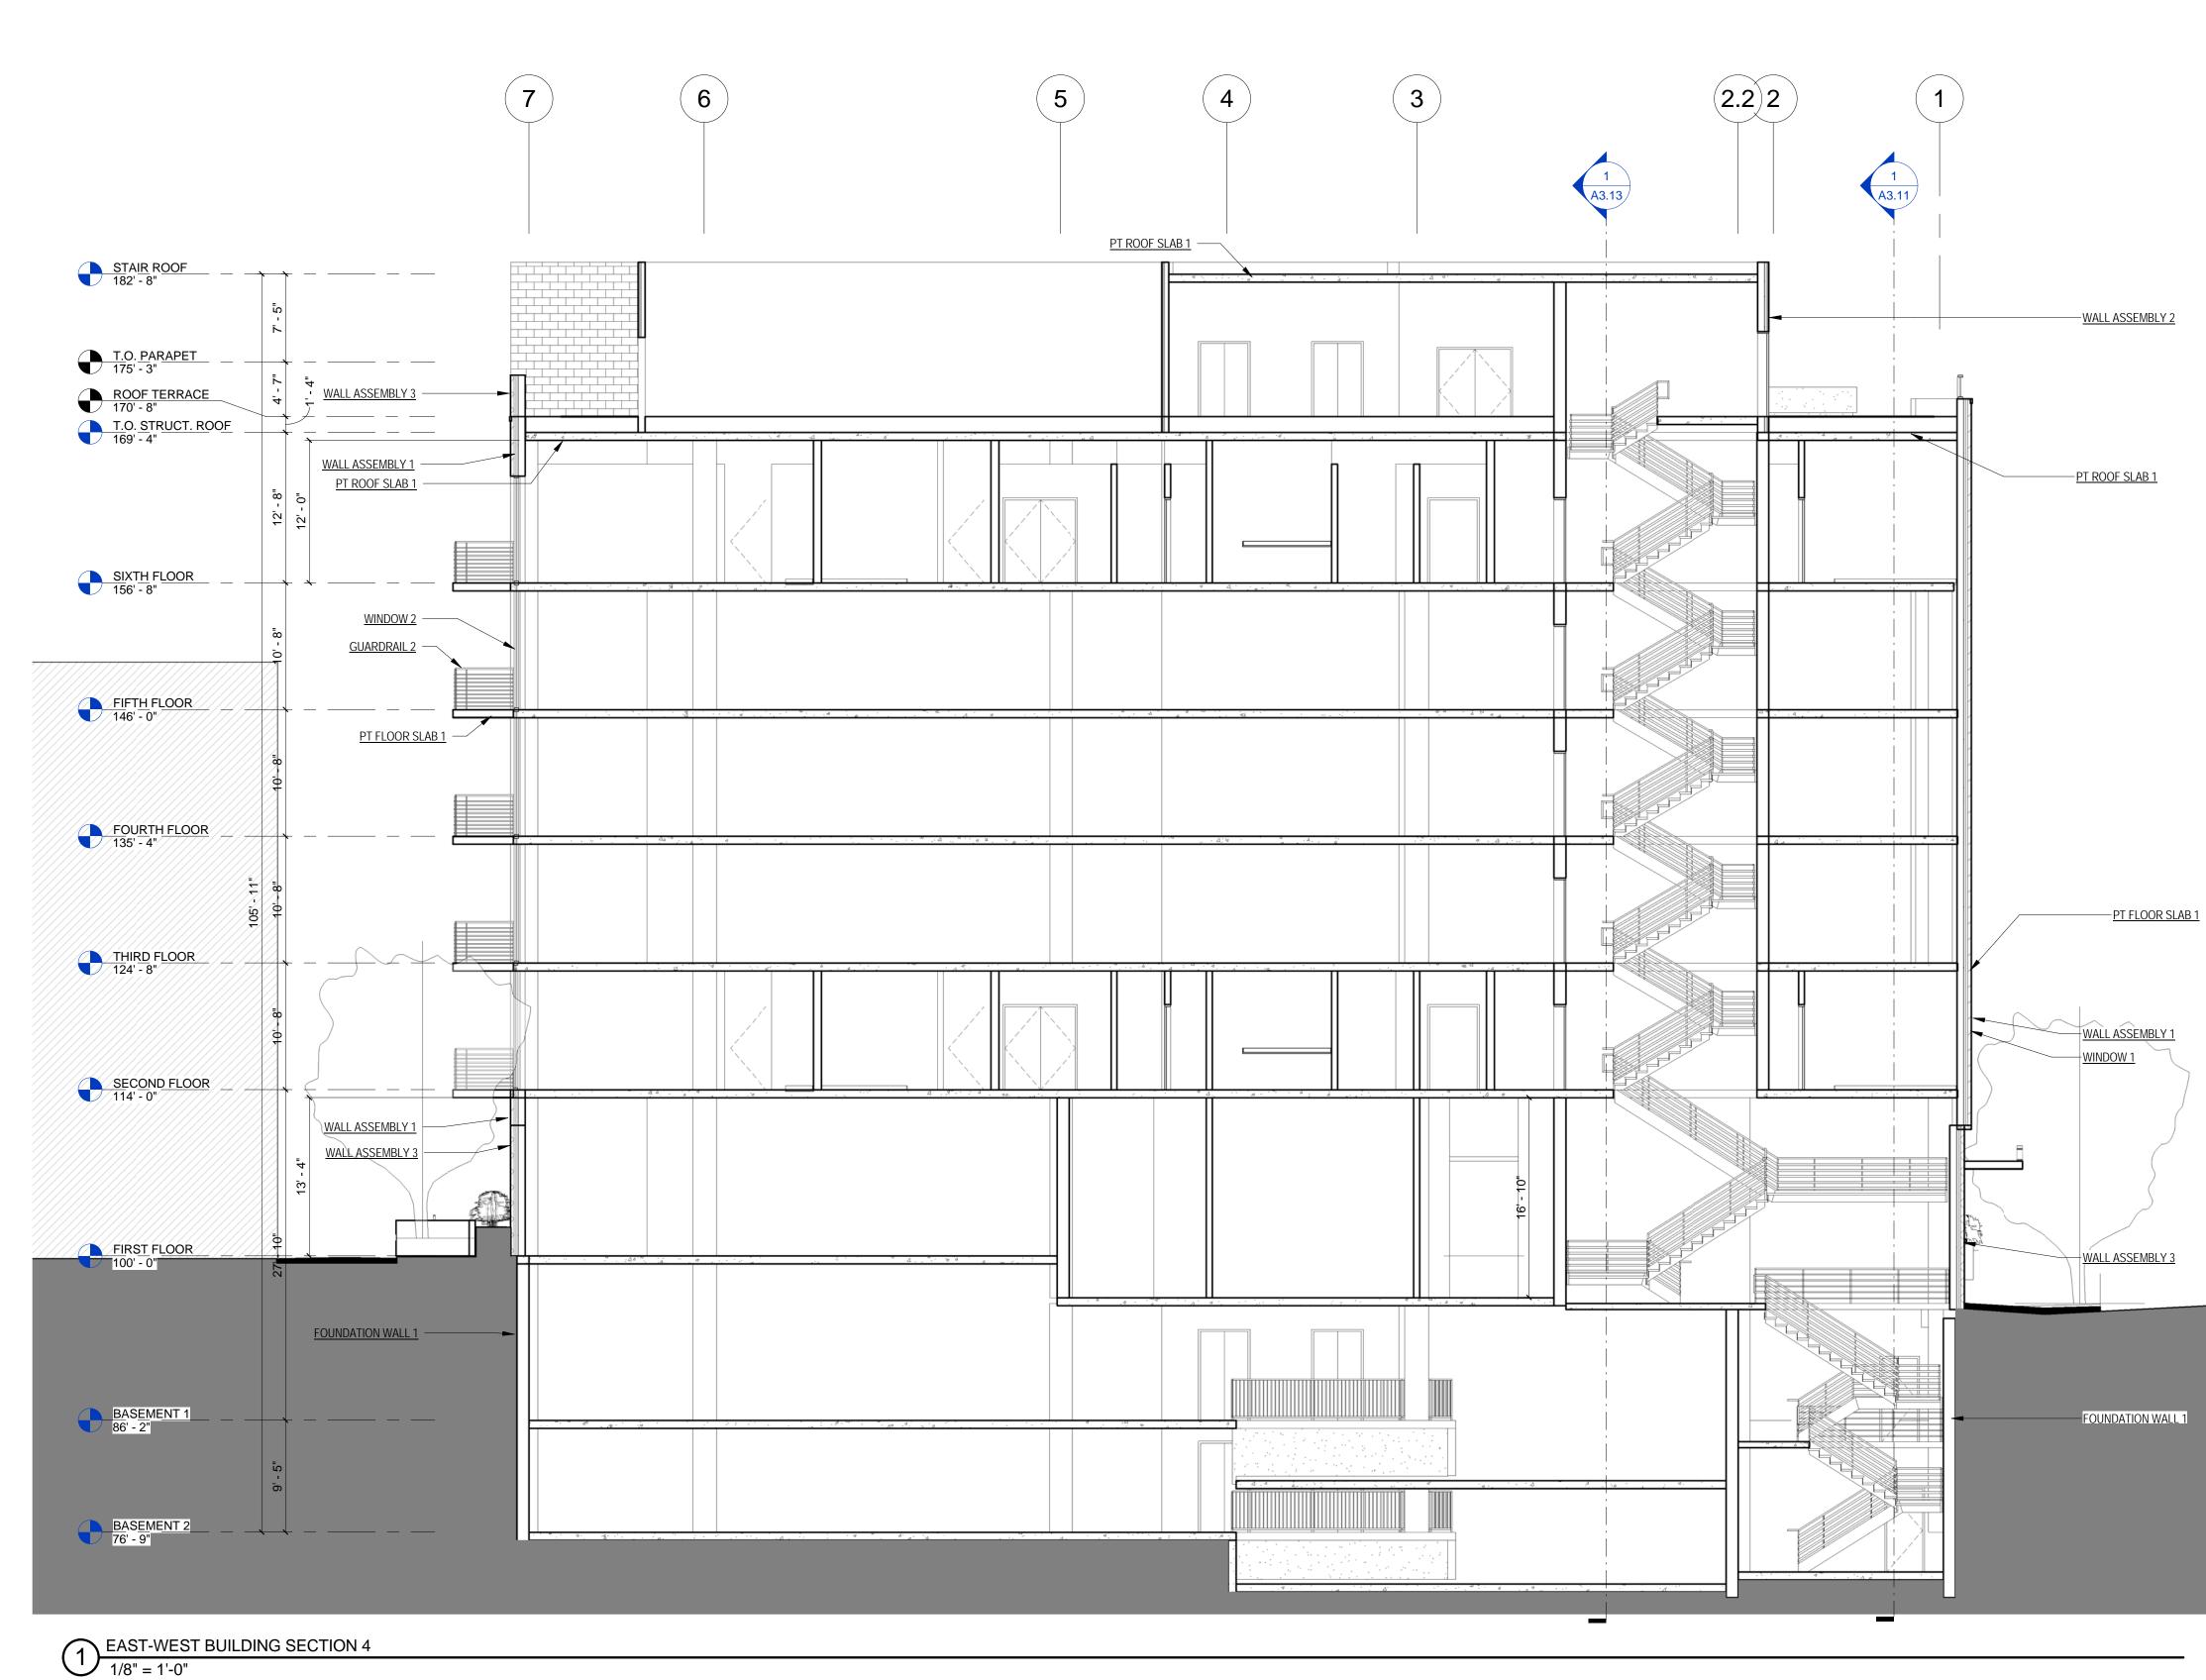
BUILDING SECTIONS

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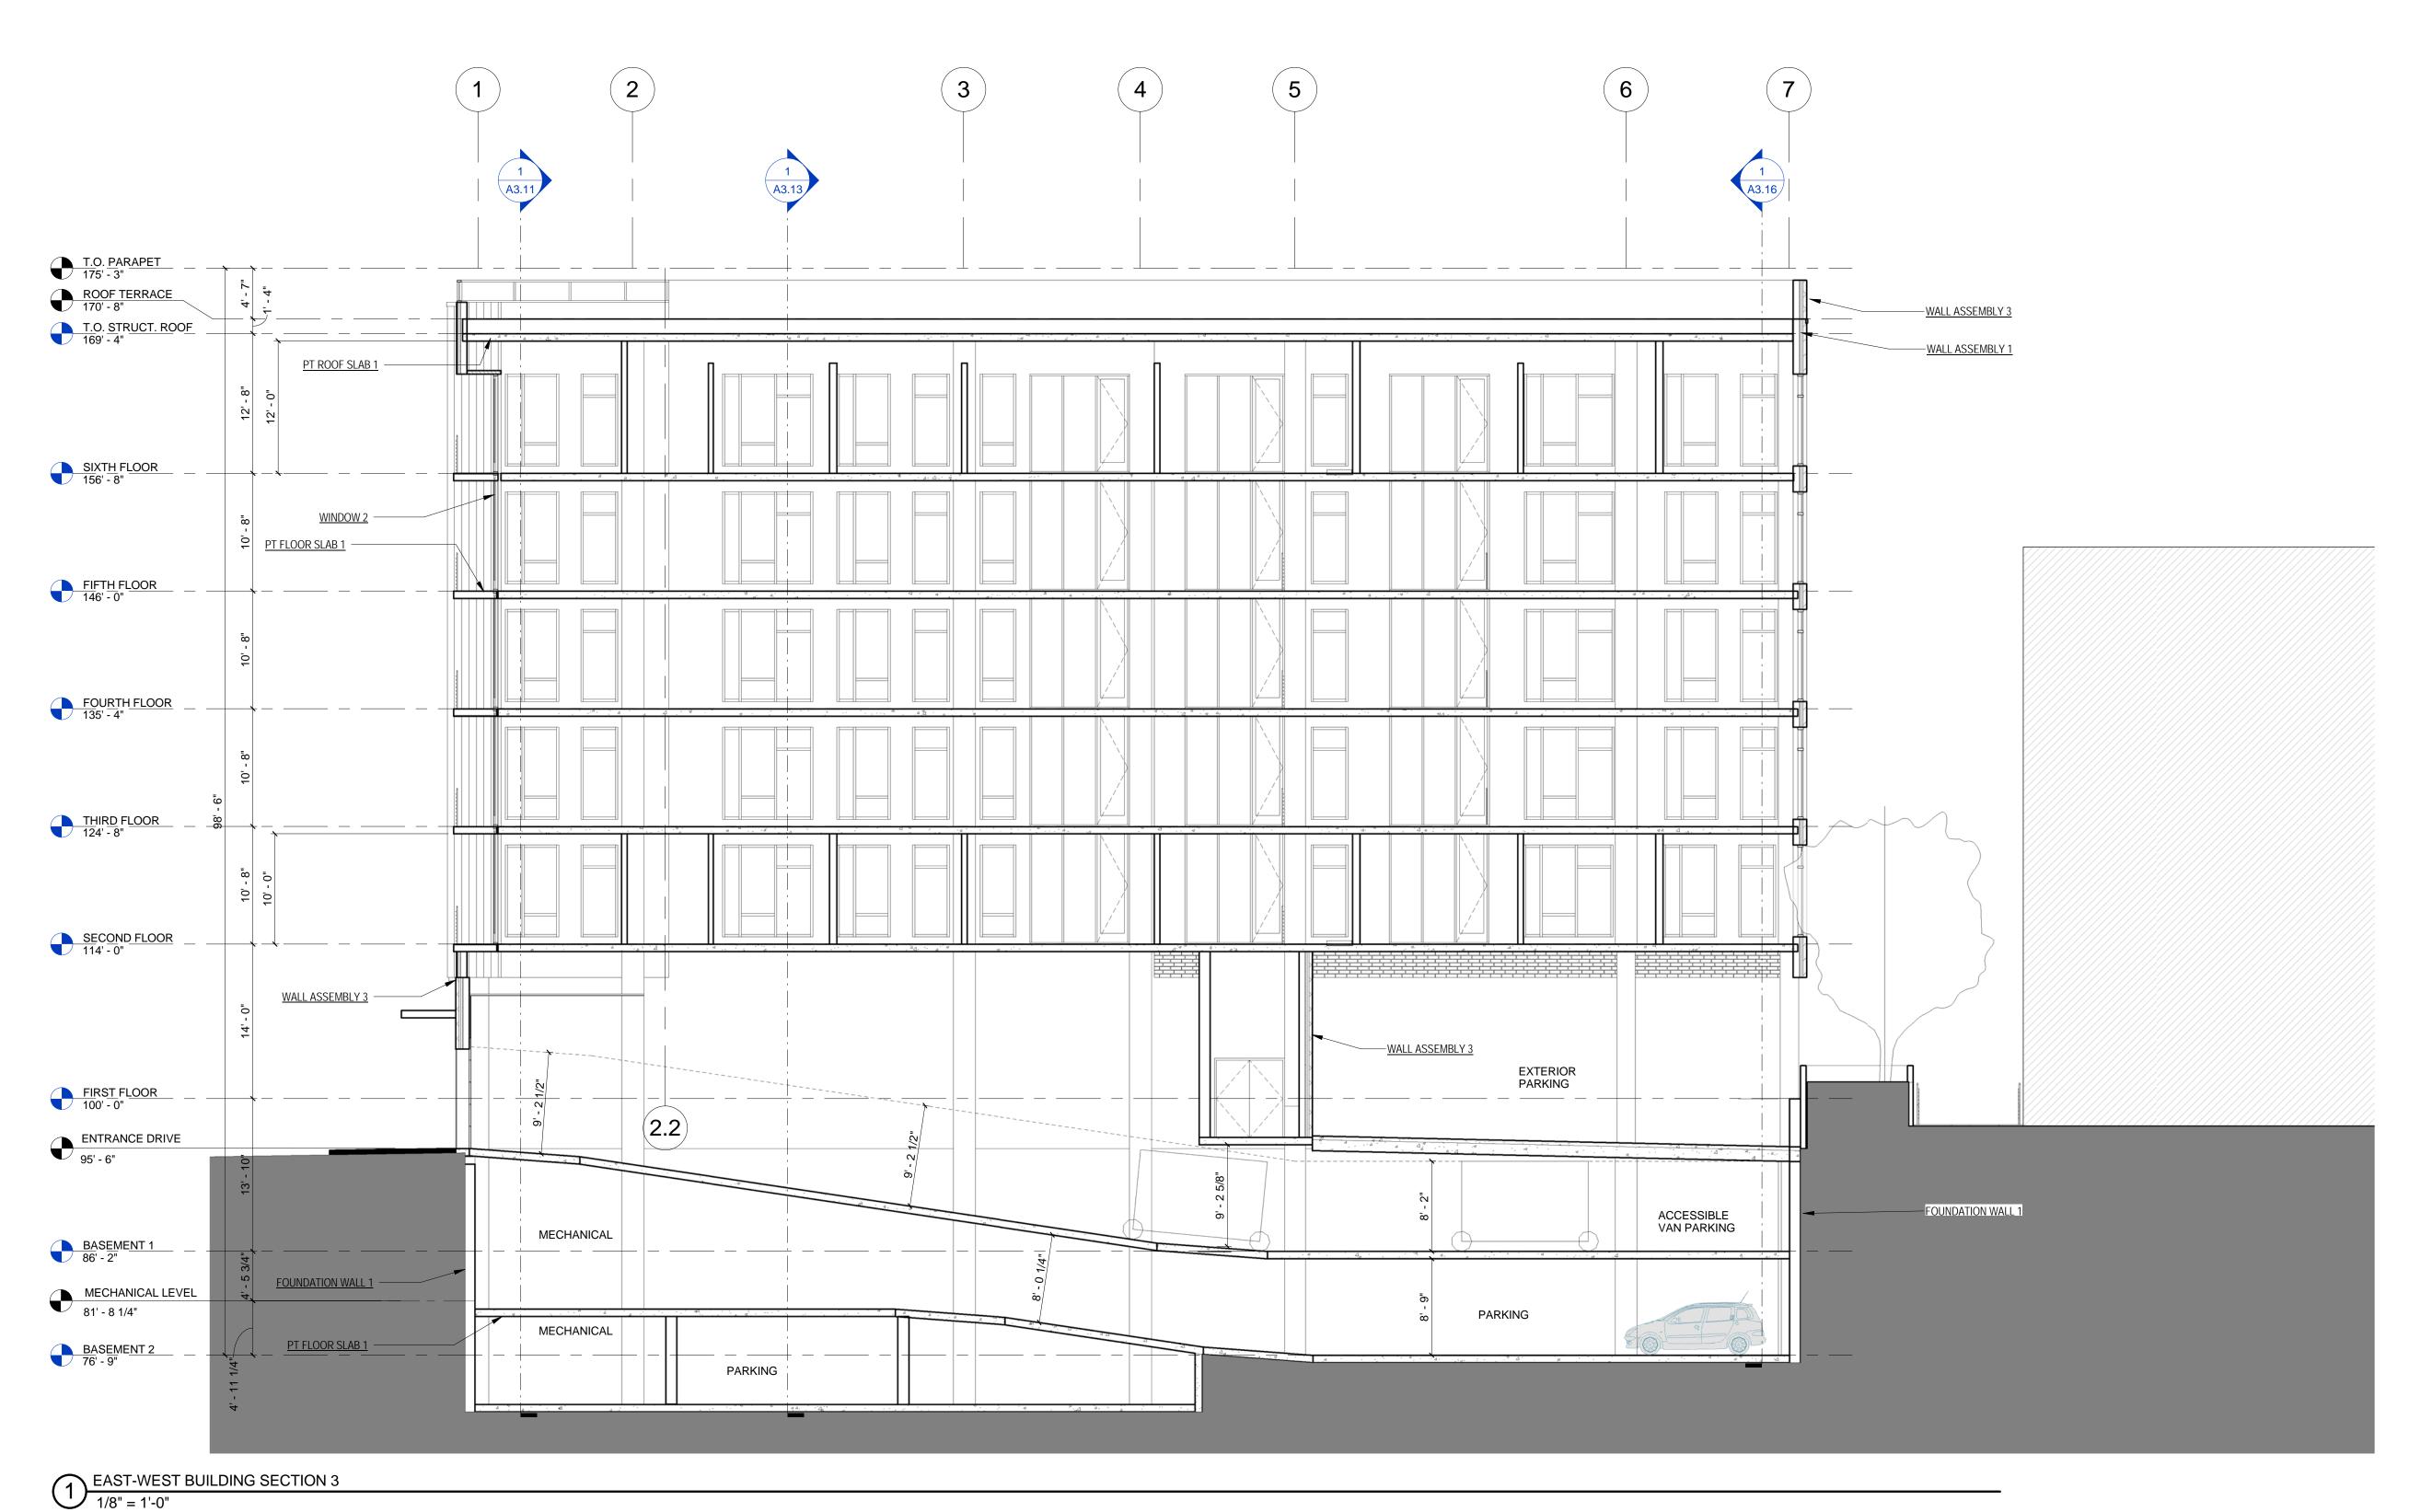
A3.12



ASSEMBLIES & COMPONENTS FOUNDATION WALL 1 CONCRETE FOUNDATION WALL, WATERPROOFING 1, 2" RIGID INSULATION, 1/4" DRAINAGE BOARD - SEE STRUCTURAL FOR WALL THICKNESS GUARDRAIL 3 GLASS GUARDRAIL SYSTEM POST TENSIONED CONCRETE FLOOR SLAB; 2-HR FIRE RESISTIVE RATING PER IBC 2012 CALCULATED METHOD, PER SECTION 722 PT FLOOR SLAB 1 POST TENSIONED CONCRETE ROOF SLAB; 1-HR FIRE RESISTIVE RATING PER IBC 2012 CALCULATED METHOD, PER SECTION 722 PT ROOF SLAB 1 WALL ASSEMBLY 1 6" METAL STUD, 5/8" SHEATHING, WEATHER BARRIER, 2" RIGID INSULATION, AIR SPACE, BRICK 1 WALL ASSEMBLY 3 6" METAL STUD, 5/8" SHEATHING, WEATHER BARRIER, 2" RIGID INSULATION, AIR SPACE, BURNISHED BLOCK 1

ALUMINUM FRAMED STICK-BUILT STOREFRONT SYSTEM; BASIS OF DESIGN IS KAWNEER 451T, SEE WINDOW FRAME ELEVATIONS; MATCH METAL PANEL COLOR





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BUILDING SECTIONS

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Sheet No.

A3.14





NW CORNER





1) BACK CORNER

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PERSPECTIVE VIEWS

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Sheet No.

A5.00



SMOOTH METAL PANEL (WHITE)



ACCENT STOREFRONT GLAZING (DARK ORANGE)



STANDING SEAM METAL PANEL (WHITE) *MATCH METAL PANEL



ALUMINUM STOREFRONT GLAZING (CLEAR ANODIZED)



WOOD RAINSCREEN (TEAK)



MASONRY BRICK COURSE (SMOOTH FINISH - CREAM)



BURNISHED CMU BLOCK (CHARCOAL/BLACK)





MATERIAL SAMPLE IMAGES