

ELECTRICAL SYMBOL LEGEND WIRING SYSTEM: CONTINUOUS LINE INDICATES WIRING SYSTEM CONCEALED IN WALL OR CEILING. DASHED LINES INDICATES WIRING SYSTEM RUN BELOW SLABIGRADE. WIRING SYSTEM: CONTINUOUS LINE INDICATES WIRING SYSTEM TO BE RUN EXPOSED DASHED LINES INDICATES WIRING SYSTEM RUN BELOW SLABIGRADI BRANCH CIRCUIT HOMERUN TO PANEL NUMBER OF ARROWHEADS INDICATE NUMBER OF CIRCUITS, THREE CIRCUITS OF ALTERNATING PHASES MAY BE COMBINED IN ONE CONDUIT, HOWEVER THEY SMALL EITHER BE EQUIPPED WITH DEDICATED NEUTRALS, COMMON TRIP CIRCUIT BREAKERS, OR HANDLE-TIES ON THEIR Φ WALL MOUNTED JUNCTION BOX Ю SINGLE POLE SWITCH, 20A, 120/277 VOLT, +48° A.F.F. TO CENTER. "3" INDICATES 3-WAY SWITCH "3" INDICATES 4-WAY SWITCH "OC" INDICATES 4-WAY SWITCH OCCUPANCY SENSOR WITH MANUAL OVERRIDE CEILING MOUTED INFRAREDULTRASONIC (DUAL TECHNOLOGY) 360° MOTION SENSOR EQUAL TO WATTSTOPPER DT-300. PROVIDE ALL NECESSARY COMPONENTS TO INSURE PROPER OPERATION (POWER PACKS, SLAVE PACKS, ETC.). OCC DUPLEX RECEPTACLE, 15 AMP, 120 VOLT, +16" A.F.F. TO CENTER. FOR SINGLE RECEPTACLE ON A CIRCUIT, USE A 20A RECEPTACLE. "GF! INDICATES AROUND FAULT PROTECTION "AF! INDICATES ARC FAULT PROTECTION "WP! INDICATES WAS THE PROOF **₽** "EX" INDICATES EXISTING TO BE REUSED "IG" INDICATES ISOLATED GROUND SHADING INDICATES DEVICE TO BE MOUNTED 6" ABOVE COUNTER TOP BACKSPLASH TO CENTER U.O.N. ALL 15 AND 20 AMP, 125 VOLT RECEPTACLES IN THE KITCHEN AND FOOD PREPARATION AREAS SHALL BE GFC! DOUBLE DUPLEX (QUAD) RECEPTACLE **=**Φ HEAVY DUTY DISCONNECT SWITCH MOTOR PROVIDED AND INSTALLED BY MECH, CONTRACTOR, WIRED BY ELEC. CONTRACTOR NUMERAL INDICATE HORSEPOMER NELBOARD, SURFACE OR RECESS MOUNTED. SEE SCHEDULE FOR DETAILS. 2'X 4' FLUORESCENT LIGHTING FIXTURE. SEE FIXTURE SCHEDULE FOR DETAILS. DIAGONAL SHADING INDICATES NIGHT LITE (NL) FIXTURE SURFACE MOUNTED "ROPE" LIGHTING 0 PENDANT SHADE FIXTURE. SEE FIXTURE SCHEDULE FOR DETAILS. RECESSED DOWNLIGHT FIXTURE, SEE FIXTURE SCHEDULE FOR DETAILS, DIAGONAL SHADING INDICATES NIGHT LITE INLI FIXTURE Ø 0 MINI PENDANT FIXTURE. SEE FIXTURE SCHEDULE FOR DETAILS. 모 WALL MOUNTED LIGHT FIXTURE. SEE FIXTURE SCHEDULE FOR DETAILS. L.E.D. EXIT LIGHT, SHADING INDICATES ILLUMINATED FACE, ARROWS INDICATE CHEVRONS. SEE FIXTURE SCHEDULE FOR DETAILS. 8 \Box CEILING MOUNTED EMERGENCY EGRESS LIGHT. SEE FIXTURE SCHEDULE FOR DETAILS. TELEPHONE OUTLET, SAME HEIGHT AS ADJACENT RECEPTACLE, WITH 34" CONDUIT STUBBED OUT ABOVE ACCESSIBLE CEILING. "W" INDICATES 60" AFF MOUNTING. ⋖ COMPUTER OUTLET, SAME HEIGHT AS ADJACENT RECEPTACLE, WITH 3/4" CONDUIT ◁ STUBBED OUT ABOVE ACCESSIBLE CEILING. "W" INDICATES 60" AFF MOUNTIN COMBINATION TELEDATA OUTLET, SAME HEIGHT AS ADJACENT RECEPTACLE, WITH 4 DB DOOR BELL FLUSH MOUNTED AT 72" A.F.F.

ELECTRICAL ABBREVIATIONS

120V STAND ALONE DUCT SMOKE DETECTOR FIRE ALARM PULL STATION

CEILING MOUNTED SMOKE DETECTOR

CEILING MOUNTED SMOKE DETECTOR

D

	A	AMPERE	нт	HEIGHT
1	AF.F.	ABOVE FINISHED FLOOR	J.B.	JUNCTION BOX
ı	A.F.G.	ABOVE FINISHED GRADE	KVA	KILOVOLT-AMPERE
1	AWG	AMERICAN WIRE GAGE	M.C.	MECHANICAL CONTRACTOR
	С	CONDUIT	NEC	NATIONAL ELECTRICAL CODE
١	CB, CKT BKR	CIRCUIT BREAKER	N/L	NIGHT LIGHT
ı	CLG	CEILING	PNL	PANEL
	E.C.	ELECTRICAL CONTRACTOR	PVC	POLY-VINYL-CHLORIDE (SCHEDULE 40, U.O.N.)
i	ES	ENERGY SAVING	U.O.N.	UNLESS OTHERWISE NOTED.
١	EMT	ELECTRICAL METALLIC TUBING	V	VOLT
١	FACP	FIRE ALARM CONTROL PANEL	VA	VOLT-AMPERE
1	GFI	GROUND FAULT CIRCUIT INTERRUPTER	w	WATT
١	HOA	HAND-OFF-AUTOMATIC	WP	WEATHERPROOF
ı	HP	HORSEPOWER		

	SAFETY SWITCH TYPE SCHEDULE										
NAME	AMPS	POLES	NEMA	NAME	AMPS	POLES	NEMA	NAME	AMPS	POLES	NEMA
S1	30	2	1	S7	200	2	1	S13	100	3	1
S2	30	2	3R	\$8	200	2	3R	S14	100	3	3R
S3	60	2	1	59	30	3	1	S15	200	3	1
S4	60	2	3R	S10	30	3	3R	S16	200	3	3R
S5	100	2	1	S11	60	3	1	\$17	30	1	1
S6	100	2	3R	S12	60	3	3R	S18	30	1	3R

*** NOT ALL SAFETY SWITCHES SCHEDULED MAY APPEAR IN PLANS ***

GENERAL ELECTRICAL NOTES

- ALL ELECTRICAL WORK SHALL BE IN ACCORDANCE WITH THE APPLICABLE EDITION OF THE NATIONAL ELECTRICAL CODE AND ALL LOCAL AND STATE CODES.
- ALL MATERIAL SHALL BE NEW AND SHALL CONFORM TO THE STANDARDS OF THE UNDERWRITER'S LABORATORIES, INC., AND THE NATIONAL MANUFACTURERS ASSOCIATION.
- ALL ELECTRICAL PERMITS AND INSPECTION FEES SHALL BE OBTAINED AND PAID FOR BY THE ELECTRICAL
- DRAWINGS ARE DIAGRAMMATIC ONLY AND INDICATE ONLY THE GENERAL ARRANGEMENT. SEE ARCHITECTURAL DRAWINGS FOR EXACT DIMENSIONS.
- ELECTRICAL CONTRACTOR SHALL GUARANTEE ALL WORK AND MATERIALS FOR ONE YEAR EFFECTIVE THE
- ELECTRICAL CONTRACTOR SHALL MAKE ALL ELECTRICAL POWER CONNECTIONS TO HVAC, PLUMBING, AND
- A COMPLETE GROUNDING SYSTEM SHALL BE PROVIDED AND INSTALLED IN ACCORDANCE WITH ARTICLE 250 OF THE NEC, AND AS SHOWN ON THE DRAWINGS.
- ALL CUTTING AND PATCHING OF WALLS AND FLOORS FOR ELECTRICAL EQUIPMENT SHALL BE THE RESPONSIBILITY OF THE ELECTRICAL CONTRACTOR.
- ALL WIRING SHALL BE INSTALLED IN GALVANIZED RIGID CONDUIT, INTERMEDIATE METAL CONDUIT, OR EMT. EMT SHALL NOT BE USED IN OR UNDER CONCRETE SLABS, OR IN MASORITY WALLS. USE SCHEDULE 40 PVC OUTDOORS WHERE NOT SUBLECT TO PHYSICAL DAMAGE OR BELOW FLOOR SLAD.

BRANCH CIRCUITS RATED 30 AMPS OR LESS MAY UTILIZE TYPE MC FLEXIBLE NETAL CABLE. SUPPORT WITHIN 12" OF ALL CONNECTIONS AND NOT MORE THAN 4-6" ON CENTER.

ALL RACEWAYS (EXCEPT THOSE BELOW SLAB OR GRADE) SHALL BE INSTALLED PARALLEL OR

CONDUCTORS SHALL BE COPPER RATED AT NOT LESS THAN 600 VOLTS. MINIMUM SIZE SHALL BE #12 AWG UNLESS OTHERWISE NOTED ON THE DRAWINGS. ALL WIRE #8 AWG AND LARGER SHALL BE STRANDED, ALL CONDUCTORS #10 AND SMALLER SHALL BE SOLID, UNLESS OTHERWISE NOTED.

FEEDERS RATED GREATER THAN 150 AMPERES MAY UTILIZE 75'C COMPACT ALUMINUM CONDUCTORS OF EQUIVALENT AMPACITY, TYPE XHHMY OR XHHMY2 INSULATION, EQUIVALENT TO ALCAN SERIES 8000 CONDUCTORS. CONTRACTOR TO VERIEY CONDUCT SIZES REQUIRED FOR ALUMINUM FEEDERS.

- BRANCH CIRCUIT CONDUCTORS SHALL BE TYPE THHN OR THWN AS REQ'D.
- 12. PROVIDE A PULLWIRE IN ALL EMPTY CONDUITS.
- PROVIDE A TYPED DIRECTORY IN ALL PANELBOARDS CLEARLY DESCRIBING THE LOCATION OF AND TYPE OF
- PROVIDE ENGRAVED PHENOLIC NAMEPLATES FOR ALL PANELBOARDS AND DISCONNECT SWITCHES, BLACK LETTERS ON WHITE BACKGROUND.
- FUSES 0 600 AMPS SHALL BE UL CLASS "RK-1" LOW PEAK DUAL ELEMENT TIME DELAY WITH 200,000 AMPERE INTERRUPTING RATING AS MANUFACTURED BY BUSS, UNLESS NOTED OTHERWISE.
- VERIFY ALL REQUIREMENTS AND COORDINATE EXACT LOCATION OF INCOMING ELECTRICAL SERVICE WITH OWNER AND LOCAL POWER COMPANY PRIOR TO PROJECT START-UP. NOTIFY ENGINEER OF ANY CHANGES AS MAY BE REQUIRED.
- PROVIDE 1-1/2" CONDUIT FROM TELEPHONE EQUIPMENT ROOM TO CONNECTION POINT AS DIRECTED
- ALL TERMINALS, SPLICING CONNECTORS, LUGS, ETC. SHALL BE IDENTIFIED FOR USE WITH THE MATERIAL (CU/AL) OF THE CONDUCTOR AND SHALL BE PROPERLY INSTALLED.
- THE ELECTRICAL CONTRACTOR SHALL BE RESPONSIBLE FOR PROTECTING ALL ELECTRICAL EQUIPMENT FROM
- PENETRATIONS OF REQUIRED SMOKE PARTITIONS SHALL BE SEALED USING METHODS APPROVED UNDER THE
- STATE BUILDING CODE, COORDINATION WITH THE GENERAL CONTRACTOR SHALL BE MAINTAINED TO INSURE THAT THIS SMOKE STOPPING IS ACCOMPLISHED.
- WHERE PENETRATIONS ARE MADE THROUGH A REQUIRED FIRE-RESISTINE WALL, FLOOR, OR PARTITION FOR THE PURPOSE OF RUNNING RACEWAY CARRYING ELECTRICAL, TELEPHONE, TELEVISION, OR LOCAL COMMUNICATION AND/OR SIGNALING CIRCUITS, THE OPENING AROUND THE FACEWAY SHALL BE FIRE STOPPED FER THE STATE BUILDING GODE. COORDINATION MITH THE GENERAL CONTRACTOR SHALL BE MAINTAINED TO INSURE THAT THIS FIRE STOPPING IS ACCOMPLISHED. USE APPROVED ASSEMBLIES SUCH AS THE FOLLOWING:

 UP TO 1" PERETRATIONS OF 1, 2, 3, 4 4 HOUR GYPSUL WALLS ULLWAL1001

 UP TO 4" PENETRATIONS OF 1, 52 HOUR GYPSUL WALLS ULLWAL1001

 UP TO 4" PENETRATIONS OF 1, 52 HOUR GONE, OR BLOCK WALLS & FLOORS ULLSCA11008

 UP TO 4" PENETRATIONS OF 1, 52 HOUR CONC. OR BLOCK WALLS & FLOORS ULLSCA11008

 UP TO 4" PENETRATIONS OF 1, 52 HOUR GONE, OR BLOCK WALLS & FLOORS ULLSCA11008
- UP TO 4" PENETRATIONS OF 3 & 4 HOUR CONC. OR BLOCK WALLS & FLOORS ULL#CBJ1020
- IN REQUIRED FIRE RATED WALLS AND PARTITIONS, OPENINGS FOR INSTALLATION OF BOXES THAT ARE GREATER THAN 16 SQUARE INCHES SHALL BE PROTECTED AS REQ'D BY U.L. COORDINATE CLOSELY WITH THE GENERAL CONTRACTOR TO INSURE THAT THE INTEGRITY OF THE U.L. RATING IS MAINTAINED.
- UNLESS SPECIFICALLY NOTED AS DEDICATED, HOMERUNS MAY BE COMBINED AS MULTI-MIRE BRANCH CIRCUITS. UNLESS OTHERWISE INDICATED, HOMERUN RACEWAYS SHALL NOT SERVE MORE THAN 3 CIRCUITS. A MAXIMUM OF THREE 20A BRANCH CIRCUITS MAY BE COMBINED IN A COMMON HOMERUN SHARING A COMMON HOTTAL (PROVIDE CIRCUIT BEAKER HANCE TES). AT CONTRACTORS OFFICIA, SEPARATE NEUTRALS MAY BE PROVIDED FOR MULTI-MIRE BRANCH CIRCUITS FOR A MAXIMUM TOTAL OF SIX CURRENT UCTORS IN THE RACEWAY (NO HANDLE TIES REQUIRED.) UNLESS OTHERWISE NOTED, ALL S LARGER THAN 20A SHALL BE SEPARATELY HOMERUN TO THE PANEL.
- ALL RACEWAYS SHALL BE CONCEALED UNLESS OTHERWISE NOTED AND THAT THE ELECTRICAL CONTRACTOR SHALL BE RESPONSIBLE FOR ALL COSTS ASSOCIATED WITH CONCEAUNG RACEWAYS AFTER (INITIAL) BLOCK CONSTRUCTION.

HVAC CONDITIONING UNIT ELECTRICAL CONNECTION SCHEDULE

NON-FUSED DISCONNECT SWITCHES ARE FACTORY PROVIDED.

LLLO II (IO)		011011001	, LDOLL	
DESIGNATION	RTU-1	RTU-2	RTU-3	
Tonnage	10	10	10 🔏	
/OLTAGE/PHASE	208V/3PH	208V/3PH	208V3PH A	λ
MIN. CIRCUIT AMPACITY (MCA)	47.2	47.2	47.2	77
WAX FUSE SIZE (AMPS)	ζ 60	60	. 60	
SERVING PANEL-CIRCUIT	MDF-+:3,5	MDP-2,4,6	MDP-7,9,11	
NOTES:				

	LIGHT		TIN	ING FIXTURE SCHEDULE							
	MARK	MANUFACTURER	CATALOG NUMBER	NO.	AMP DATA TYPE	VOLTS	BA NO.	LLAST DATA TYPE	FIXTURE	MOUNTING	DESCRIPTION
Δ	С	CON-TECH	LA-18-B	₩A	N/A	120	N/A	N/A	N/A	SURFACE	MONOPOINT CANOPY, BLACK FINISH
	C30	CONTECH	CTL830-B - LF20-CL	1	LED14E26P30- 27KFL [TCP]	120		-	14 NOTE 13	CANOPY	14W PAR30 LED TRACK HEAD, BLACK FINISH, MONOPOINT MTD, TEMPERED GLASS LENS
	C38	CON-TECH	CTL838/2-B	-	LED17E26P38- 27KNFLB [TCP]	120	-	-	17 NOTE 14	TRACK	17W PAR38 LED TRACK HEAD, BLACK FINISH, TRACK MOUNTED
	СТ	CON-TECH	TRACK: LT-4-B POMER FEED: LA-8-B CONNECTOR: LA-2-B	₩A	N/A	120	N/A	N/A	N/A	SUSPENDED	4 SINGLE CIRCUIT TRACK, POWER SUPPLY, CONNECTOR, BLACK FINISH SEE NOTES 1 & 2
	cv	MORGAN HOPE	MHCB5050	-	LED	120	-	-	1.6W/FT	COVE	LED TAPE LIGHT, 24V
	ED	INTENSE	HOUSING: IFH626-E TRIM: IC610C FLAT BAR HANGERS: IC200	1	PLC 26W/835/ 4P/ALTO	120	1	ELEC	30	RECESSED	1-LAMP, 6" CFL DOMNILIGHT, HORIZONTAL LAMP, DAMP LABEL
	EG	BKLIGHTING	HP2-T4535-FL-TR-0-BZP-120-ICEE	1	CDM ELITE 35/TC/930	120	-	1	35	IN-GROUND	1-LAMP, IN-GRADE UPLIGHT, INTEGRAL BALLAST, METAL HALIDE, SEE NOTE 15
	EL	LED POWER	AL-HB4046-WASP-120-24	1	LED	120	1	1	32	SURFACE	LINEAR UPLIGHTING LED, 2800K, 120 DEGREE BEAM SPREAD, WET LABEL, SEE NOTES 2 & 16
	EW	STONCO	WPM-71-PMA-8	1	70W MH	120	1	HPF	85	WALL	1-LAMP, SURFACE MOUNTED METAL HALIDE WALL PACK, OPEN FACE
	LFI	CRESCENT	SCF232BK2Y	2	F32T8/ADV835/ ALTO	120	1	ELEC	58	SURFACE	2-LAMP, 4' STRIP LIGHT
\wedge	MW	LED POWER	FIXTURE: AL-HB4048-WASP-25-24 BRACKET: AL-HB40 POWER SUPPLY: PS-LEDINTA-0024V-41FO	1	LED	120	1	-	32	COVE	46" LED WALL WASHER, 2800K, 25 DEG BEAM
213	RC1-EM	CON-TECH	HOUSING: RA6142VEMC-EB4IS TRIM: CTR6322V-CLR	1	32W/835/4P/ ALTO	120	1	ELEC	35	RECESSED	6" CFL DOWNLIGHT, SEMI-DIFFUSED WITH 90 MINUTE BATTERY BACK-UP
	RL1	CON-TECH	HOUSING: RL38 TRIM: CTR3002-CLR	1	LED17E26P38- 27KNFL [TCP]	120	-	-	17 NOTE 14	RECESSED	6" DOWNLIGHT, PAR38 LED LAMP, NARROW FLOOD, FIXTURE TO BE LENSED
	RL2	CON-TECH	HOUSING: RL38 TRIM: CTR3002-CLR	1	LED17E26P38- 27KFL [TCP]	120	-	_	17 NOTE 14	RECESSED	6" DOWNLIGHT, PAR38 LED LAMP
Δ	RUM	HI-LITE	H-15117-119/36°ST-HSC-119/LCGU-119- FR/26/32/42/CFL/BCM-M	1	32W/835/4P/ ALTO	120	1	ELEC	35	PENDANT	PENDANT SHADE CFL, STEMS TO BE RIGID CONDUIT
	RP1	BESA	1JC-412318-H1-SN	1	26W 4-PIN CFL	120	1	ELEC	30	PENDANT/ CABLE	MINI PENDANT CFL
	RP2	TECH	700TDPLAP-B-S-CF	1	PL-T26A/830/ 4P/ALTO	120	1	ELEC	30	PENDANT/ CABLE	MINI PENDANT CFL
	RT3	TEXAS	131A-332-NV	3	F32T8/ADV835/ ALTO	120	1	ELEC	88	RECESSED	3-LAMP, 2x4 LENSED TROFFER
Δ	RT3-EM	TEXAS	131A-332-MV-EM14	3	F32T8/ADV835/ ALTO	120	1	ELEC	88	RECESSED	SAME AS TYPE RT3 EXCEPT WITH 90 MINUTE BATTERY BACK-UP
	RV3	EVERGREEN	GR225-AB-A	2	25W T8	120	1	ELEC	46	SURFACE	2-LAMP, 3' VANITY SCONCE
Α	SW1	CRESCENT	SLT2321UNIV	2	F32T8/ADV835/ ALTO	120	1	ELEC	58	SURFACE	2-LAMP, INDUSTRIAL FLUORESCENT, VAPOR TIGHT, SEE NOTE 3
دے	EM-1	EXTRONIX	П90	2	5.4W	120	-	-	20	WALL	EMERGENCY LIGHT WITH 90 MINUTE BATTERY BACK-UP
	EM-2	EXTRONIX	HOUSING: LED-90 BL (NOTE 17) REMOTE HEADS: 2HLED	2	LED	120	-	-	-	UNIVERSAL	REMOTE EMERGENCY DUAL HEAD UNIT WITH 90-MIN. BATTERY BACK-UP - SEE NOTE 17
	EX-1	EXTRONIX	VEX-U-BP-WB-WH	-	LED	120	-	-	<5	UNIVERSAL	LED EXIT SIGN

CATALOG NUMBERS AND MANUFACTURERS ARE TO INDICATE TYPE AND QUALITY OF FIXTURE DESIRED, SUBMIT CUTSHEETS OF ALTERNATE MANUFACTURERS FOR ARCHITECT AND OWNER APPROVAL PRIOR TO PURCHASE OF ANY PIXTURES, ALL RUORESCENT LAWPS SHALL BE ENERGY SAVING TYPE, ALL INCANDESCENT LAWPS SHALL BE 1307 RATED.

LIGHTING FIXTURE SCHEDULE NOTES:

- REFER TO LIGHTING PLAN FOR QUANTITY OF TRACK TO DETERMINE TYPES AND QUANTITY OF LIVE END FEEDS & CONNECTORS REQUIRED.

 E.C. TO DETERMINE TYPES AND QUANTITIES OF LIVE END FEEDS, CONNECTORS, POWER SUPPLIES, MOUNTING HARDWARE, ETC., FOR SYSTEM TO FUNCTION PROPERLY.

 COORDINATE MOUNTING OF FUTURE INSIDE EQUIPMENT BY OWNER.

 PROVIDE SALL REQUIRED COMPONENTS FOR MOUNTING, CONNECTING AND SUPPORTING TRACK RUNS AS INDICATED FOR COMPLETE AND WORKING OPERATION.

 PROVIDE EAL REQUIRED COMPONENTS FOR MOUNTING, CONNECTING SUPPORTING TRACK RUNS AS INDICATED FOR COMPLETE AND WORKING OPERATION.

 PROVIDE LENGTH, PROVIDE ALL COMPONENTS NECESSARY FOR COMPLETE AND WORKING OPERATION.

 PROVIDE LENGTHS, SOF FAUTURES AS REQUIRED FOR CONTINUOUS MOUNTING, UTILIZE MAXIMUM BYTAINE LENGTH ALLOWABLE IN LINEAR RUNS TO MINIMIZE QUANTITY OF FIXTURES AND BALLASTS, PROVIDE ALL COMPONENTS NECESSARY FOR COMPLETE AND WORKING OPERATION.

 MOUNT BOTTOM OF RLM PROVIDE AT 10°C AFT.—COORDINATE MOUNTING AS REQUIRED WITH DESIRED AND SALLASTS.


 MOUNT STOTION OF RLM PROVIDE AT 10°C AFT.—COORDINATE MOUNTING AS REQUIRED WITH ELECTRICAL CONTRACTOR PRIOR TO GREENING SO THAT DESIRED HEIGHT IS ATTAINED.

 MOUNT FORTOWER AT HEIGHT AS INDICATED IN FEATURES AND NOOTHED AND SANDWARD AS INDICATED IN FELL BUT BY ARCHITECT, RAP I FUTURES ON BOOTH TABLES.

- COORDINATE MOUNTING OF FIXTURE INSIDE EQUIPMENT BY OWNER.
- COOKINATE MODIFIES OF PARTIES BADIE EQUIPMENT OF YOMEN.
 PROVIDE SINGLE OR DOUBLE FACE UNITS, WITH ARROMS) AS INDICATED ON PLANS, COORDINATE WALL OR CEILING MOUNTING WITH LOCATION(S) INDICATED ON DRAWINGS AND AS REQUIRED BY FIELD CONDITIONS, WALL MOUNT SHALL BE ABOVE DOOR AT 7-4" A.F.F. DOWN ROOS FOR INTURES BUT TO BE RISID CONDUIT SUPUL BE ABOVE LOCKAT I FG "A F.F. DOWN ROOS FOR INTURES BUT TO BE RISID CONDUIT SUPPLIED BY GENERAL CONTRACTOR AND PAINTED TO MATCH CEILING FINISH. COORDINATE EXACT COLOR OF FIXTURE WITH JASON'S DELI REPRESENTATIVE.

 DOWN ROOS FOR THE TRACE FOR THE PROPERTY BUT THE

- PROVIDE 17 WATTS MAX: LABEL.
 IN-GRADE LIGHT FIXTURE TO BE MOUNTED FLUSH TO GRADE.
 PROVIDE (1) 100W POWER SUPPLY FOR EACH (2) FIXTURES.
 ORDER LED-90 BL' LESS HEADS. UNIT IS TO OPERATE REMOTED HEADS AS SHOWN ON 1/E-1.0. Λ

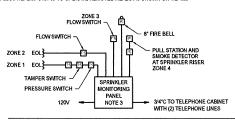

(MONITORING) SPRINKLER ALARM RISER DIAGRAM E0.0

SPRINKLER ALARM SYSTEM NOTES:

- ALARM DEVICES ARE TO BE INSTALLED IN ACCORDANCE WITH NFPA 72 AND ADA
- ACTUATION OF ANY PULL STATION, FLOW SWITCH OR SMOKE DETECTOR SHALL ACTIVATE ALARM
- MONITORING SYSTEM SHALL BE A COMPACT MULTIFACETED STAND-ALONE COMMUNICATOR FIS AND TWO MODILI AR PHONE CONNECTIONS (RJ31X OR RJ38X JACKS) WHICH SHALL BE CONSTANTLY SUPERVISED FOR PROPER VOLTAGE AND CURRENT. (14.5"H X 12.5"W X 2.875" DEEP) (NOTIFIER #411UDAC) OR EQUAL PROVIDE 60 HR. BATTERY STAND-BY.
- ALL FIRE ALARM SWITCHES, MODULES, AND WIRING SHALL BE PROVIDED BY THE FIRE ALARM SUB-CONTRACTOR. FIRE ALARM SYSTEM SUB-CONTRACTOR SHALL BE RESPONSIBLE TO SUBMIT DETAILED SYSTEM DRAWNOSS, CUTSHEETS, WIRNIO DAGRAMS, ETC. AS REQUIRED FOR FINAL PERMITTING, ALL OWPONEMTS NECESSARY FOR CERTIFICATE OF OCCUPANCY SHALL
- SEE PLANS FOR MINIMUM NUMBER OF DEVICES.
- ALL TAMPER AND FLOW SWITCH CONNECTION LOCATIONS TO BE FIELD VERIFIED WITH SPRINKLER SUB-CONTRACTOR AS REQ'D.
- COORDINATE DUAL LINE TELEPHONE CONNECTION FOR ULLISTED CENTRAL STATION MONITORING





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CONSTRUCTION SET

07-		
NO.	REASON	DAT
1	CODE COMMENTS / OWNER CHANGES	05/09/
3	CODE COMMENTS OWNER CHANGES	06/19/ 12

Project Address:


JASON'S DELI - MOBILE. 3756 AIRPORT BLVD

MOBILE, AL 36608

05-004-12 heet Title:


> LEGEND, NOTES AND LIGHTING FIXTURE SCHEDULE

E0.0

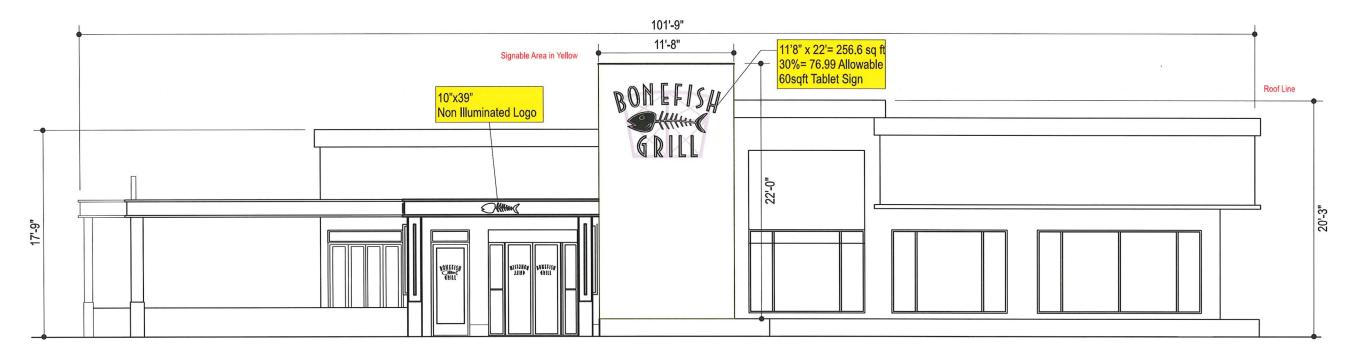

South/Front Elevation

Scale: 1/8" = 1' @ 11X17

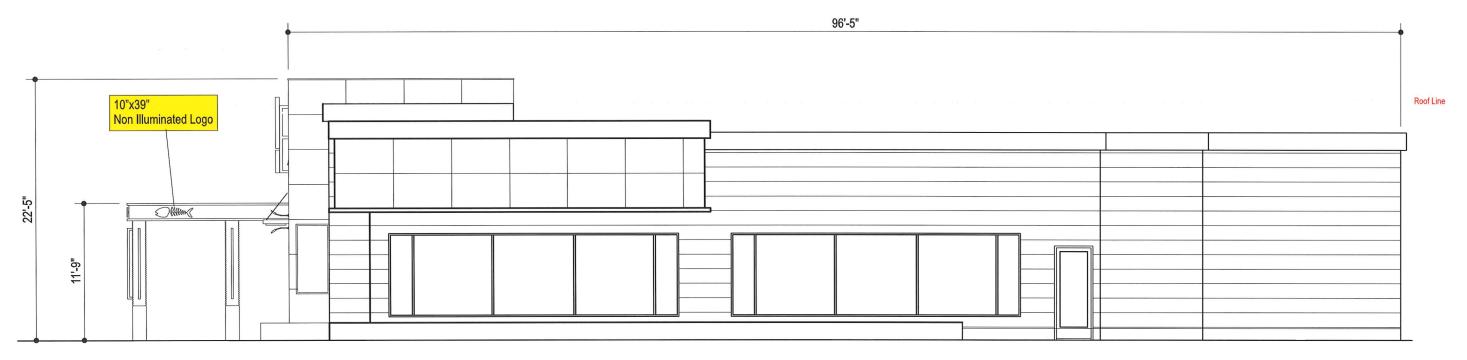

East/Right Side Elevation

Scale: 1/8" = 1' @ 11X17

CLIENT:	Bonefis	h Grill			
LOCATION:	Madison, WI				
DATE:	10.14.1	3	STORE #		
DRAWING #	BON-Madison-E1				
DRAWN BY:	СВ	APPROVED BY:	SHEET SIZE 11 x 17		

THIS DESIGN IS SUBMITTED AS PART OF OUR PROPOSAL AND IS TO REMAIN OUR PROPERTY EXCLUSIVELY UNTIL ACCEPTED AND APPROVED BY PURCHASE.

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1	REVISED PER CITY COMMENTS	10/15/13	DD	C
REV#	DESCRIPTION	DATE	BY	Ľ



THIS SIGN IS INTENDED TO BE INSTALLED IN ACCORDANCE WITH THE REQUIREMENTS OF ARTICLE 500 OF THE NATIONAL ELECTRICAL CODE AND / OR OTHER APPLICABLE LOCAL CODES. THIS INCLUDES PROPER GROUNDING AND BONDING OF THE SIGN.

CUSTOMER APPROVAL:

SIGNATURE

DATE: _____

APPROVAL RECEIVED BY UNITED


DATE: ____

IMPORTANT:

PERMANENT ACCESS TO THE BACK SIDE OF THE WALL IS REQUIRED FOR INSTALLATION AND WIRING OF THE SIGN.
IF IT IS NOT AVAILABLE IT MUST BE PROVIDED BY THE CUSTOMER BEFORE INSTALLATION.




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North/Rear Elevation

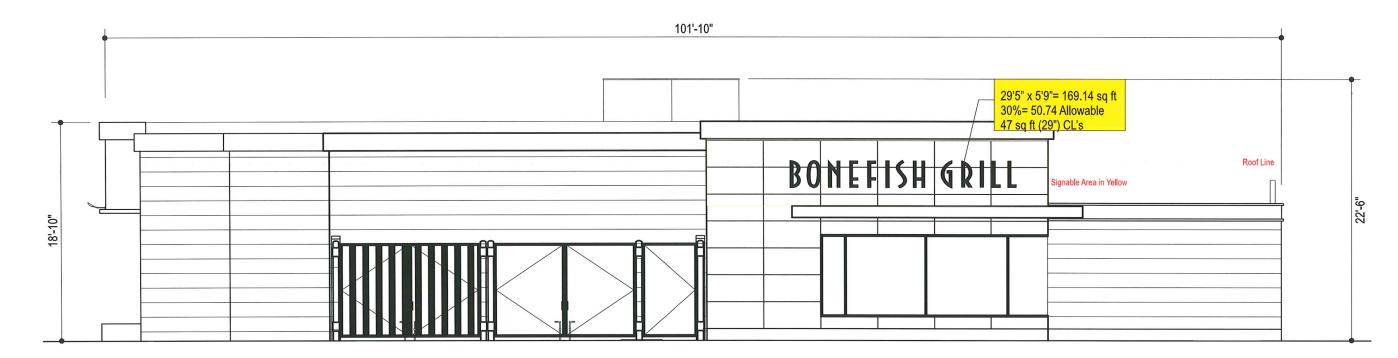Scale: 1/8" = 1' @ 11X17



West/Left Side Elevation

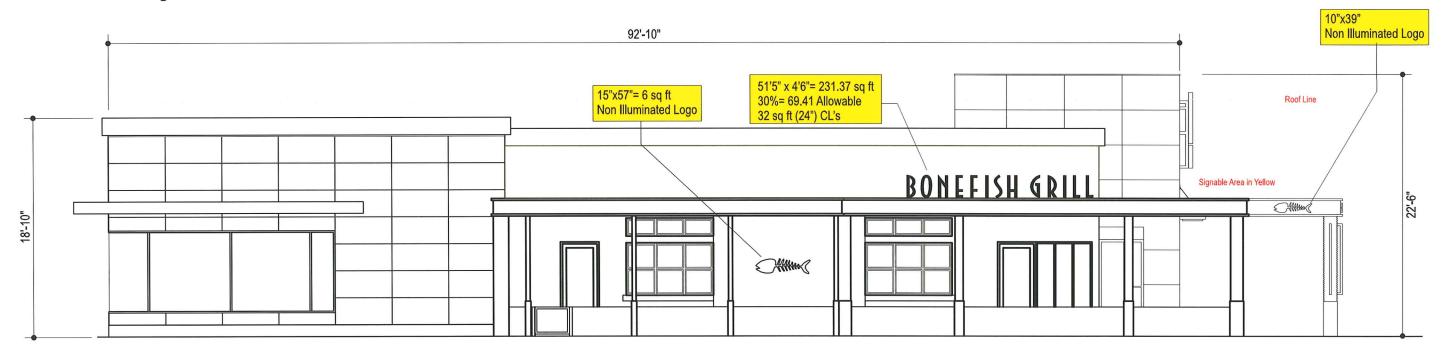Scale: 1/8" = 1' @ 11X17

CLIENT:	Bonefish	n Grill				
LOCATION:	Madisor	Madison, WI				
DATE:	10.14.13	3	STORE #			
DRAWING #	BON-Madison-E2					
DRAWN BY:	СВ	APPROVED BY:	SHEET SIZE 11 x 17			

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1	REVISED PER CITY COMMENTS	10/15/13	DD
REV#	DESCRIPTION	DATE	BY



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CUSTOMER APPROVAL:

SIGNATURE

DATE: _____


APPROVAL RECEIVED BY UNITED


DATE: ____

United Sign Systems

PERMANENT ACCESS TO THE BACK SIDE OF THE WALL IS REQUIRED FOR INSTALLATION AND WIRING OF THE SIGN, IF IT IS NOT AVAILABLE IT MUST BE PROVIDED BY THE CUSTOMER BEFORE INSTALLATION.

206 Tower Drive Oldsmar, Florida 34677 unitedsignsystems.com 888-704-1516 A Division of United Advantage Sign Companies, Inc.

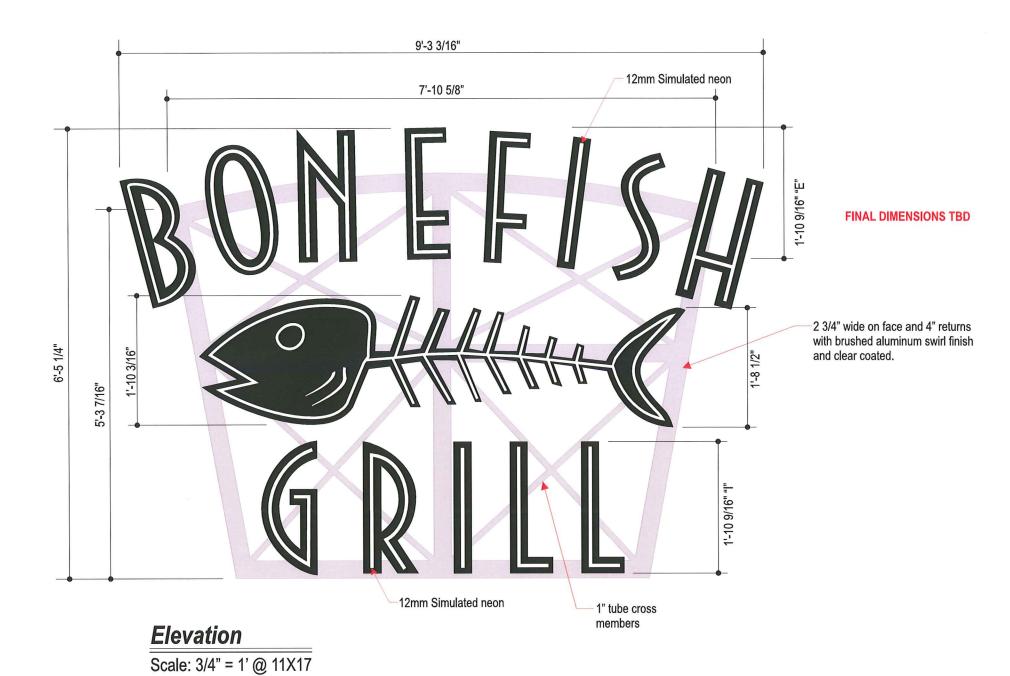

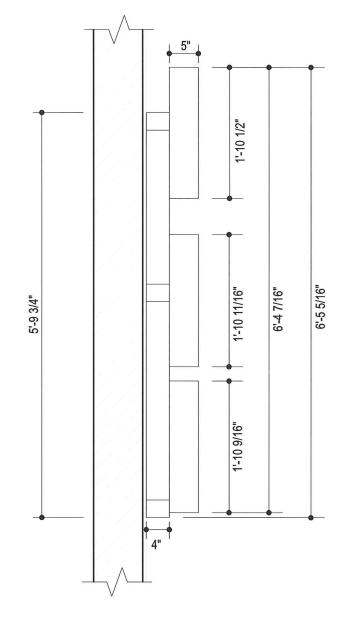

Section Through Centerline

Scale: 3/4" = 1' @ 11X17

CLIENT:	Bonefis	h Grill		
LOCATION:	Madison, WI			
DATE:	10.14.1	3	STORE #	
DRAWING #	BON-Madison-Tablet60			
DRAWN BY:	СВ	APPROVED BY:	SHEET SIZE 11 x 17	

THIS DESIGN IS SUBMITTED AS PART OF OUR PROPOSAL AND IS TO REMAIN OUR PROPERTY EXCLUSIVELY UNTIL ACCEPTED AND APPROVED BY PURCHASE.

REV#	DESCRIPTION	DATE	BY



THIS SIGN IS INTENDED TO BE INSTALLED IN ACCORDANCE WITH THE REQUIREMENTS OF ARTICLE 600 OF THE NATIONAL ELECTRICAL CODE AND / OR OTHER APPLICABLE LOCAL CODES. THIS INCLUDES PROPER GROUNDING AND BONDING OF THE SIGN.

CUSTOMER APPROVAL:


SIGNATURE

DATE: ____

APPROVAL RECEIVED BY UNITED


IMPORTANT:	
PERMANENT ACCESS TO THE BACK SIDE OF THE WALL IS REQUIRED FOR INSTALLATION AND WIRING OF THE SIGN, IF IT IS NOT AVAILABLE IT MUST BE PROVIDED BY THE CUSTOMER BEFORE INSTALLATION.	United Sign System
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206 Tower Drive
Oldsmar, Florida 34677
unitedsignsystems.com
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A Division of United Advantage
Sign Companies, Inc.

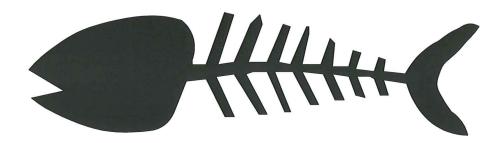


Elevation

Scale: 1 1/2" = 1' @ 11X17

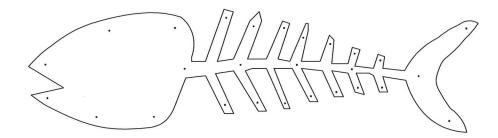


Mounting

Scale:1 1/2" = 1' @ 11X17

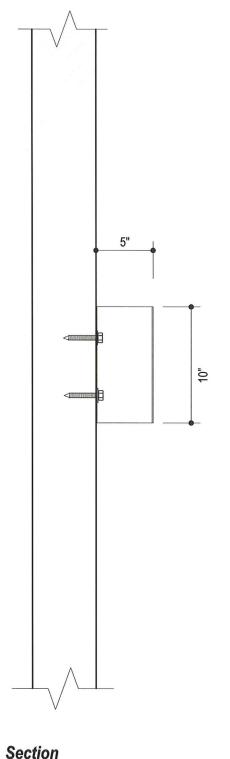

Section

Scale: 1 1/2" = 1' @ 11X17

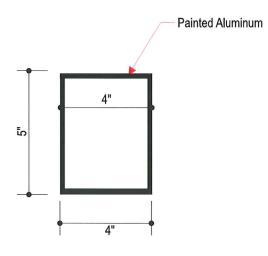

Section "A-A" Scale: 3" = 1' @ 11X17

CLIENT:	Bonefish Grill	
LOCATION:	Madison, WI	
DATE:	10/15/13	STORE #
DRAWING #	BON-2.7SQFT-LOGO	
DRAWN BY:	DD	SHEET SIZE 11 x 17

THIS DESIGN IS SUBMITTED
AS PART OF OUR PROPOSAL
AND IS TO REMAIN OUR
PROPERTY EXCLUSIVELY
UNTIL ACCEPTED AND
APPROVED BY PURCHASE.

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REV#	DESCRIPTION	DATE	BY	1



THIS SIGN IS INTENDED TO BE INSTALLED IN ACCORDANCE WITH THE REQUIREMENTS OF ARTICLE 600 OF THE NATIONAL ELECTRICAL CODE AND OR OTHER APPLICABLE LOCAL CODES. THIS INCLUDES PROPER GROUNDING AND BONDING OF THE SIGN.

CUSTOMER APPROVAL:

IMPORTANT:

PERMANENT ACCESS TO THE BACK SIDE OF THE WALL IS REQUIRED FOR INSTALLATION AND WIRING OF THE SIGN.
IF IT IS NOT AVAILABLE IT MUST BE PROVIDED BY THE CUSTOMER BEFORE INSTALLATION.

SIGNATURE DATE: _


APPROVAL RECEIVED BY UNITED DATE:

United
Sign
Systems

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BON- 2.7 SQFT LOGO 10" X 39" = 2.7 SQFT

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CLIENT:	Bonefish Grill	
LOCATION:	Various	
DATE:	6-04-13	STORE #
DRAWING #	BFG-Tablet-NEW 2	
DRAWN BY:	AGG	SHEET SIZE 11 x 17

THIS DESIGN IS SUBMITTED AS PART OF OUR PROPOSAL AND IS TO REMAIN OUR PROPERTY EXCLUSIVELY UNTIL ACCEPTED AND APPROVEDBY PURCHASE.
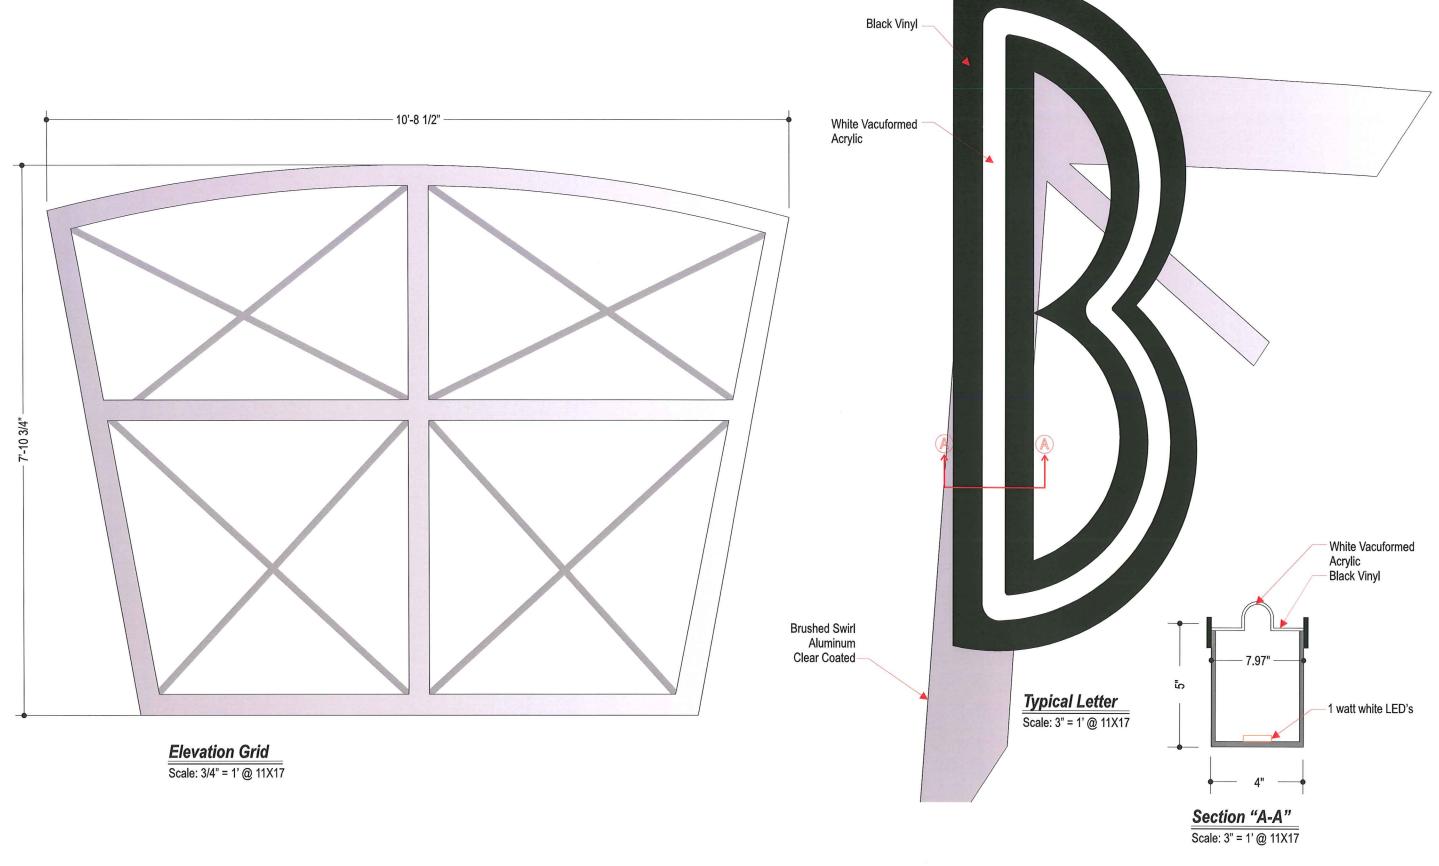
#1	Added 75sqft Tablet	11/12/10	JJM	9
REV#	DESCRIPTION	DATE	BY	



THIS SIGN IS INTENDED TO BE INSTALLED IN ACCORDANCE WITH THE REQUIREMENTS OF ARTICLE \$ 600 OF THE NATIONAL ELECTRICAL C O D E AND / O R O THE R APPLICABLE LOCAL CODES. THIS INCLUDES PROPER GROUNDING AND BONDING OF THE SIGN.

CUSTOMER APPROVAL:

SIGNATURE DATE:___

APPROVAL RECEIVED BY UNITED

DATE:

IMPORTANT:


PERMANENT ACCESS TO THE BACK SIDE OF THE WALL IS REQUIRED FOR INSTALLATION AND WIRING OF THE SIGN.

IF IT IS NOT AVAILABLE IT MUST BE PROVIDED BY THE CUSTOMER BEFORE INSTALLATION.




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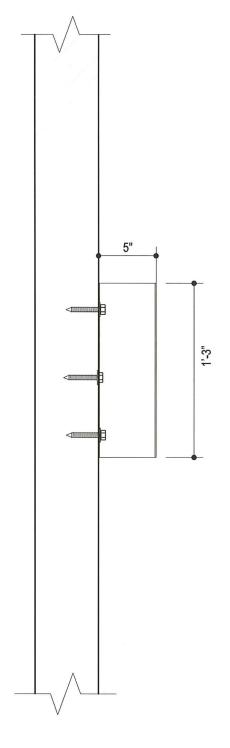
Elevation

Scale: 1 1/2" = 1' @ 11X17

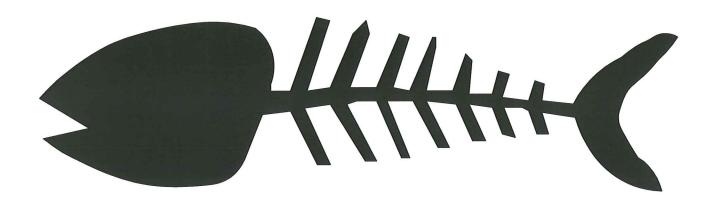


Mounting

Scale: 1 1/2" = 1' @ 11X17

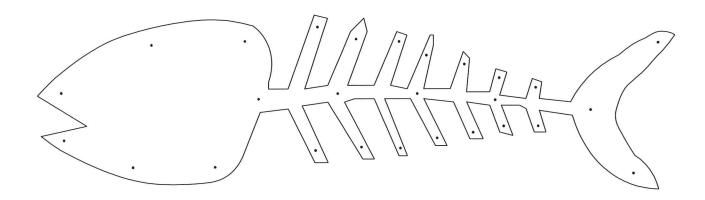

Section

Scale: 1 1/2" = 1' @ 11X17

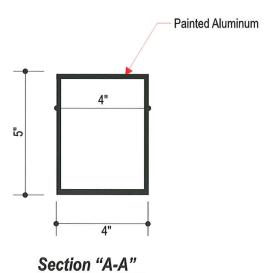

BON-6SQFT LOGO 1'-3" X 4'-9 = 6 SQFT

Scale: 3" = 1' @ 11X17

CLIENT:	Bonefish Grill	
LOCATION:	Madison, WI	
DATE:	10/15/13	STORE #
DRAWING #	BON-6SQFT-LOGO	
DRAWN BY:	DD	SHEET SIZE 11 x 17

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7	BY	DATE	DESCRIPTION	REV#



THIS SIGN IS INTENDED TO BE INSTALLED IN ACCORDANCE WITH THE REQUIREMENTS OF ARTICLE 600 OF THE NATIONAL LECTRICAL CODE AND / OR OTHER APPLICABLE LOCAL CODES. THIS INCLUDES PROPER GROUNDING AND BONDING OF THE SIGN.

CUSTOMER APPROVAL:

	SIGNATURE
DATE.	

DATE:	
APPROVAL RECEIVED BY UNITED	
DATE:	


IMPORTANT:

PERMANENT ACCESS TO THE BACK SIDE OF
THE WALL IS REQUIRED FOR INSTALLATION
AND WIRING OF THE SIGN.
IF IT IS NOT AVAILABLE IT MUST BE PROVIDE
BY THE CUSTOMER BEFORE INSTALLATION.



United

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CLIENT:	Bonefish Grill	
LOCATION:	Various	
DATE:	6-04-13	STORE #
DRAWING #	BFG-Tablet-NEW 2	
DRAWN BY:	AGG	SHEET SIZE 11 x 17

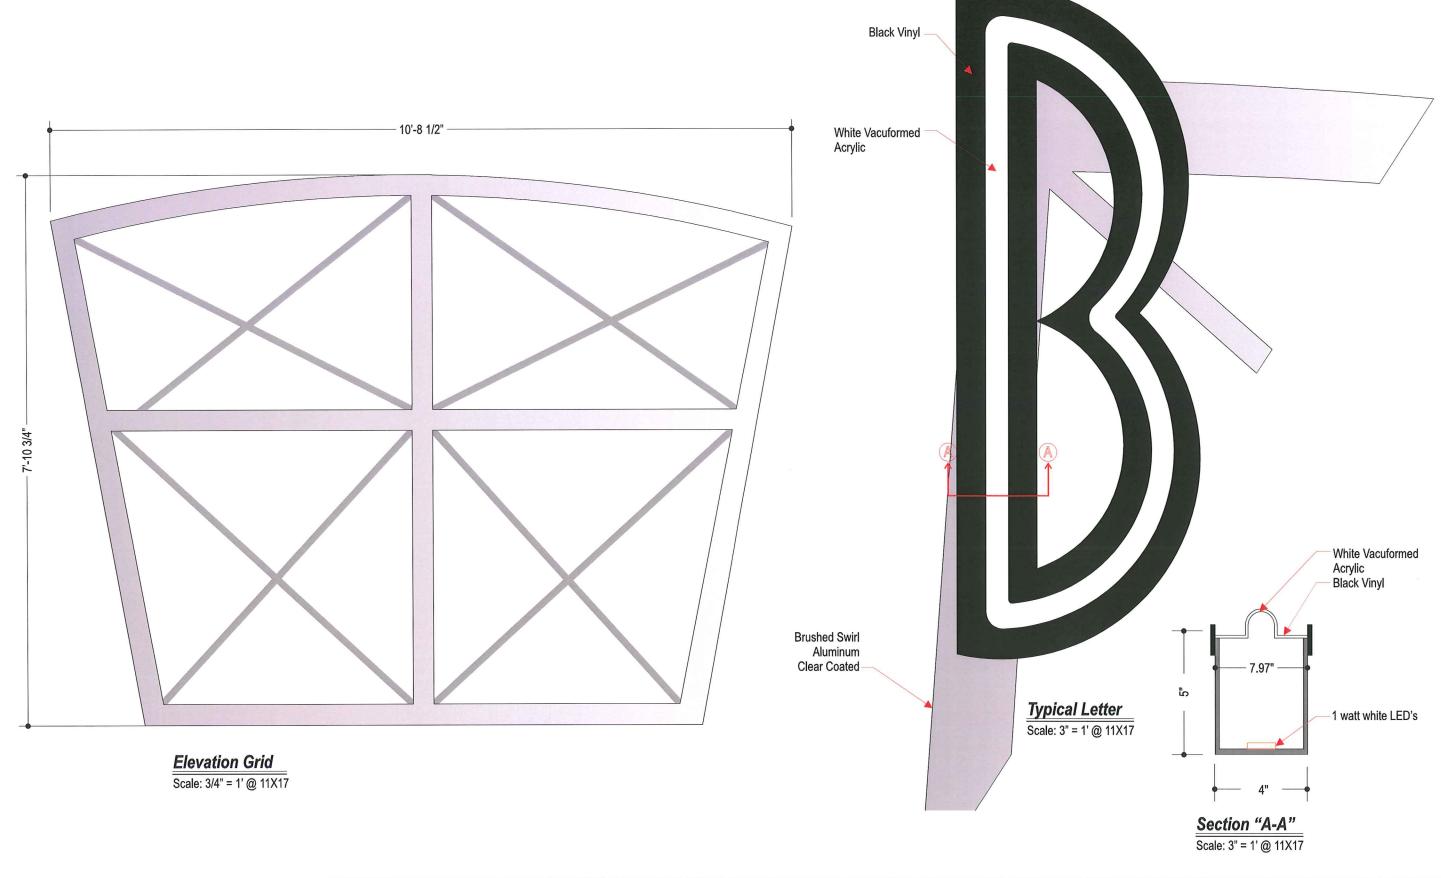THIS DESIGN IS SUBMITTED AS PART OF OUR PROPOSAL AND IS TO REMAIN OUR PROPERTY EXCLUSIVELY UNTIL ACCEPTED AND APPROVED BY PURCHASE.

				(
#1	Added 75sqft Tablet	11/12/10	JJM	C
REV#	DESCRIPTION	DATE	BY	



THIS SIGN IS INTENDED TO BE INSTALLED IN ACCORDANCE WITH THE REQUIREMENTS OF ARTICLE 600 OF THE NATIONAL ELECTRICAL CODE AND / OR OTHER APPLICABLE LOCAL CODES, THIS INCLUDES PROPER GROUNDING AND BONDING OF THE SIGN.

CUSTOMER APPROVAL:

SIGNATURE

DATE: _____
APPROVAL RECEIVED BY UNITED
DATE: ____


IMPORTANT:

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BONEFISH GRILL

-5" DEEP ALUMINUM CHANNEL LETTERS, PRE-COAT BLACK RETURNS.

-2447 WHITE ACRYLIC FACE WITH FIRST SURFACE #2625-222 DUAL-COLOR FILM (BLACK

DAY / WHITE NIGHT). RETAIN WITH 1" BLACK TRIMCAP.

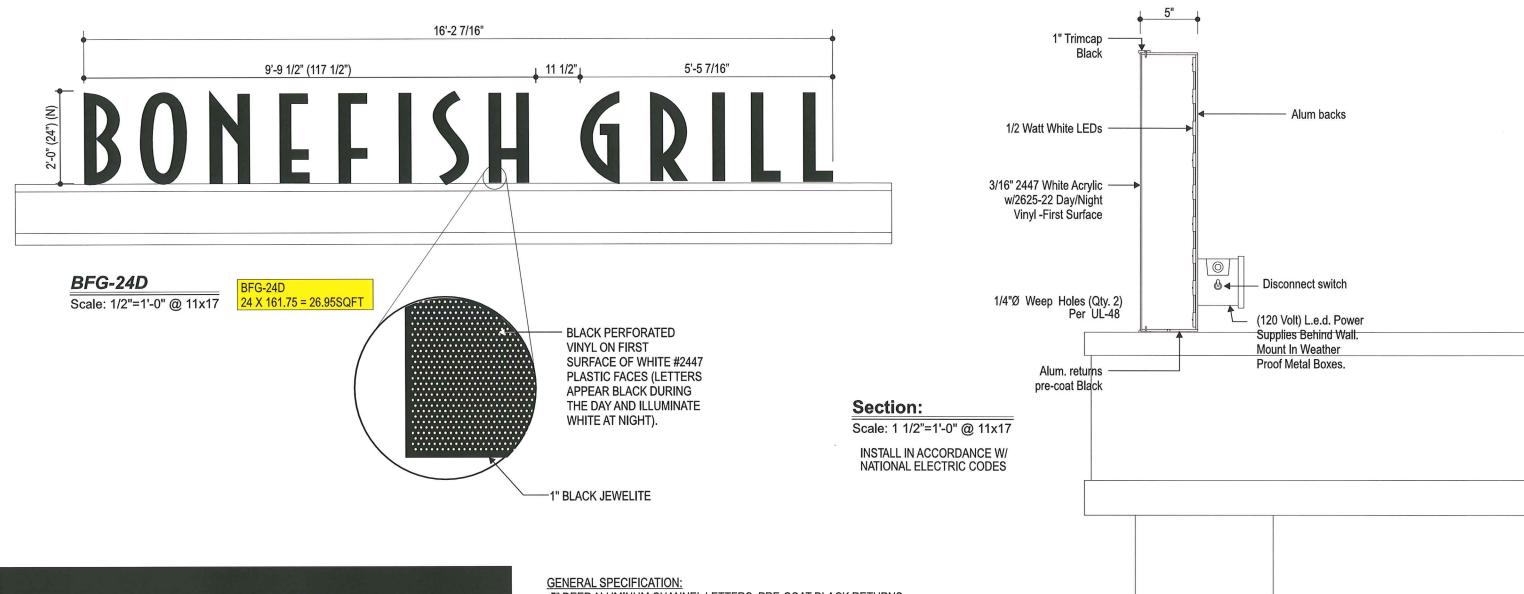-ILLUMINATE WITH 1/2 WATT WHITE VENTEX LED'S. REMOTE POWER SUPPLIES AS

-MOUNT FLUSH TO FASCIA.

NIGHT PERSPECTIVE

CLIENT:	Bonefish Grill	
LOCATION:	Madison, WI	
DATE:	10.14.13	STORE #
DRAWING #	BON-Madison-24CL	
DRAWN BY:	СВ	SHEET SIZE 11 x 17

THIS DESIGN IS SUBMITTED AS PART OF OUR PROPOSA AND IS TO REMAIN OUI PROPERTY EXCLUSIVEL UNTIL ACCEPTED ANI APPROVED BY PURCHASE.

1	REVISED FROM CITY COMMENTS	10/15/13	DD
REV#	DESCRIPTION	DATE	BY



THIS SIGN IS INTENDED TO BE INSTALLED IN ACCORDANCE WITH THE REQUIREMENTS OF ARTICLE 600 OF THE NATIONAL ELECTRICAL CODE AND / OR OTHER APPLICABLE LOCAL CODES. THIS INCLUDES PROPER GROUNDING AND BONDING OF THE SIGN.

CUSTOMER APPROVAL:

DATE:


APPROVAL RECEIVED BY UNITED


PERMANENT ACCESS TO THE BACK SIDE OF THE WALL IS REQUIRED FOR INSTALLATION. AND WIRING OF THE SIGN IF IT IS NOT AVAILABLE IT MUST BE PROVIDED BY THE CUSTOMER BEFORE INSTALLATION.



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GENERAL SPECIFICATION:

- -5" DEEP ALUMINUM CHANNEL LETTERS, PRE-COAT BLACK RETURNS.
- -2447 WHITE ACRYLIC FACE WITH FIRST SURFACE #2625-222 DUAL-COLOR FILM (BLACK DAY / WHITE NIGHT). RETAIN WITH 1" BLACK TRIMCAP.
- -ILLUMINATE WITH 1/2 WATT WHITE VENTEX LED'S. REMOTE POWER SUPPLIES AS REQUIRED.
- -MOUNT FLUSH TO FASCIA.

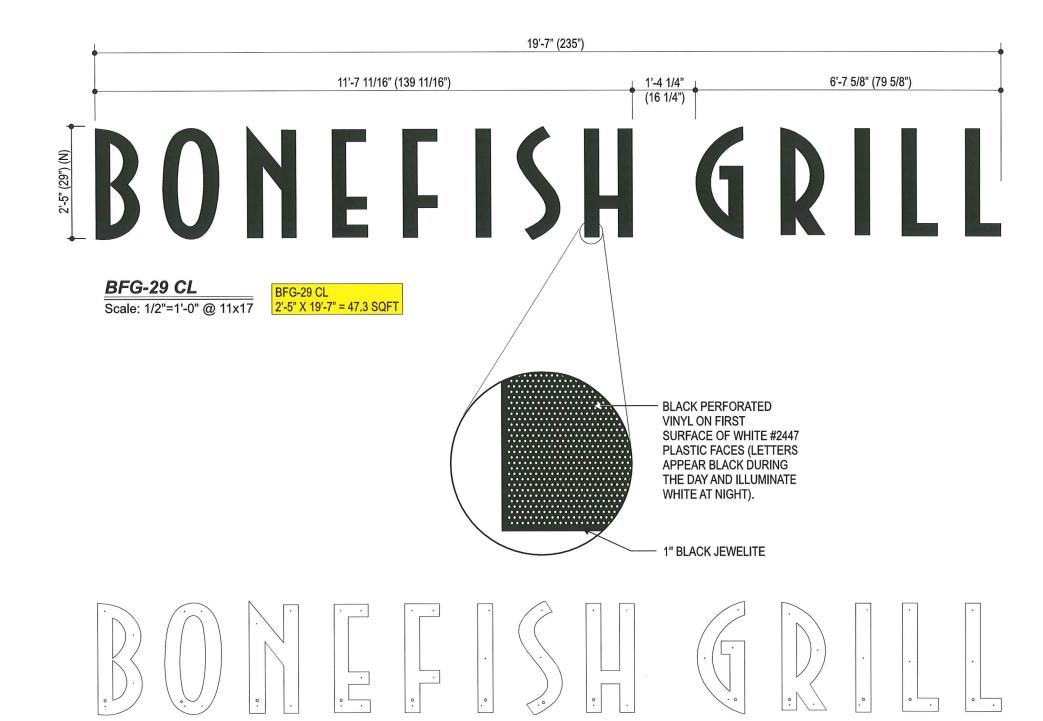
BONEFISH GRILL

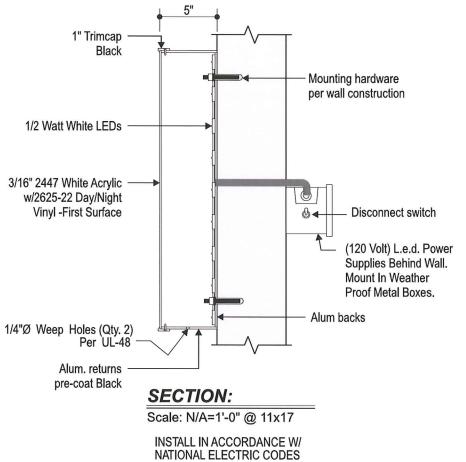NIGHT PERSPECTIVE

CLIENT:	Bonefish Grill	
LOCATION:	Madison, WI	
DATE:	10.14.13	STORE #
DRAWING #	BON-24D-LED	•
DRAWN BY:	СВ	SHEET SIZE 11 x 17

Mounting Detail Scale: 1/2"=1'-0" @ 11x17

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THIS SIGN IS INTENDED TO BE INSTALLED IN ACCORDANCE WITH THE REQUIREMENTS OF ARTICLE 600 OF THE NATIONAL ELECTRICAL CODE AND / OR OTHER APPLICABLE LOCAL CODES. THIS INCLUDES PROPER GROUNDING

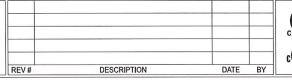CUSTOMER APPROVAL:

DATE:

APPROVAL RECEIVED BY UNITED DATE

IMPORTANT:

PERMANENT ACCESS TO THE BACK SIDE OF THE WALL IS REQUIRED FOR INSTALLATION AND WIRING OF THE SIGN.
IF IT IS NOT AVAILABLE IT MUST BE PROVIDED BY THE CUSTOMER BEFORE INSTALLA



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Jason's deli


	Si	qn	A
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Sign:	12" Jason's Deli w/ 11" ToGo letters
Sign Type:	Channel Letters on a shoebox pan/ Aluminum Frame and Reverse Lit Letters
Illumination:	Internally Illuminated LED
Square Footage:	21.29
To Grade:	Top of sign to grade = 13'-3"
	Bottom of sign to grade = 10'-2 1/2"

Sign B

Sign:	16" Jason's Deli	
Sign Type:	Channel Letters on a shoebox pan/ Aluminum Frame	
Illumination:	Internally Illuminated LED	
Square Footage:	25.08	
To Grade:	Top of sign to grade = 16'-9 1/2" Bottom of sign to grade = 14'-1 1/4"	

Sign C	
Sign:	Jason's Deli
Sign Type:	New Pole Sign
Illumination:	Internally Illuminated Fluorescent lamps
Square Footage:	192.66



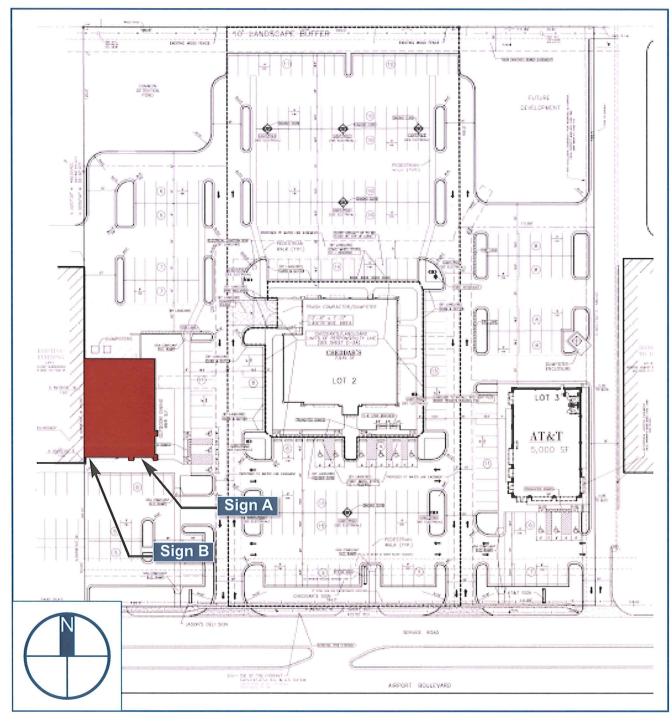

		_			
Client:	Jasons Deli	05/03/2012	Original Rendering	ВС	This
Site #:	JD-A16234	-			Sign
Address:	3756 Airport Road				unpu
1	Mobile AL 36608				distri
-	Mobile				Plea with



Sign A		Sign B	
Sign:	12" Jason's Deli w/ 11" ToGo letters	Sign:	16" Jason's Deli
Sign Type:	Channel Letters on a shoebox pan/ Aluminum Frame and Reverse Lit Letters	Sign Type:	Channel Letters on a shoebox pan/ Aluminum Frame
Illumination:	Internally Illuminated LED	Illumination:	Internally Illuminated LED
Square Footage:	21.29	Square Footage:	25.08
To Grade:	Top of sign to grade = 13'-3" Bottom of sign to grade = 10'-2 1/2"	To Grade:	Top of sign to grade = 16'-9 1/2" Bottom of sign to grade = 14'-1 1/4"



Scale: 3/32" = 1'-0"

Allowable Square Footage this Elevation:

350


Actual Square Footage this Elevation:

46.73



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Client:	Jasons Deli	05/03/2012	Original Rendering	BC	This Sign,
Site #:	JD-A16234	Z			Anch
Address:	3756 Airport Road	Ó			unpu
	Mobile AL 36608	$\stackrel{>}{\sim}$		-	distril
	Mobile	W			Pleas with



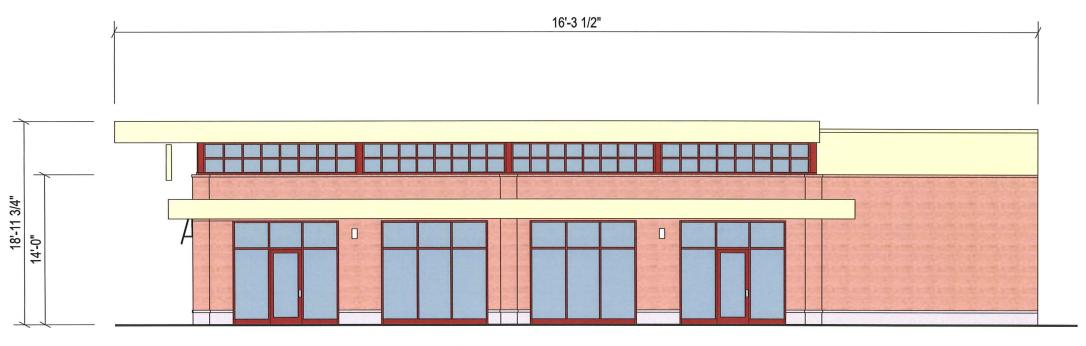

Side Elevation (East)

Scale: 3/32" = 1'-0"

Allowable Square Footage this Elevation: 350

Actual Square Footage this Elevation:

0.00



Client:	Jasons Deli	05/03/2012	Original Rendering	BC	This
Site #:	JD-A16234	<u> </u>		+-	Sign
Address:	3756 Airport Road	<u>o</u>			unpu
	Mobile AL 36608	$\frac{1}{8}$		-	distri with
	Mobile	<u> </u>			Plea with



Sign A

Sign: 12" Jason's Deli w/ 11" ToGo letters

Sign Type: Channel Letters on a shoebox pan/
Aluminum Frame and Reverse Lit Letters

Illumination: Internally Illuminated LED

Square Footage: 21.29

To Grade: Top of sign to grade = 13'-3"

Bottom of sign to grade = 10'-2 1/2"

Electrical Detail:

White LEDs (GE MiniMax)

(X) 60w Transformer @ 0.85 Amps Each Total Amps: X.XX

(1) 20 amp 120V Circuit Req.

General Notes:

This sign is to be installed in accordance with the requirements of Article 600 of the National Electrical Code.

- 1) Grounded and bonded per NEC 600.7/NEC 250
- 2) Existing branch circuit in compliance with NEC 600.5, not to exceed 20 amps
- 3) Sign is to be UL listed per NEC 600.3
- 4) UL disconnect switch per NEC 600.6- required per sign component before leaving manufacturer*

 *For multiple signs, a disconnect is permitted but not required for each section

Specifications: ToGo

- 1. Existing Facade: Brick
- 2. 0.065" Aluminum letter returns painted to match black
- 3. 0.125" x 1" Trim cap to match black
- 4. 3/16" Clear lexan backs

(interior of sign can painted ultra white for maximum illumination)

- 5. White LEDs
- 6. 3/16" White Acrylic
- 7. Waterproof disconnect switch per NEC 600-6
- 8. Primary electrical feed
- 9. Transformers
- 10. 2" Sleeve spacers w/ mounting hardware to suit
- 11. 0.75" x 0.0625" Aluminum angle pop-riveted to backs attached to returns via #8 Pan-head screws




Sign Layout Detail

Scale: 3/4" = 1'-0"

white vinyl applied to face of background




- 1. Existing Facade: TBD
- 0.040" Aluminum letter returns painted to match black (channel letters) and ptm PMS#1805 red (Perimeter Channel Trim)
- 3. 0.125" x 1" trim cap to match white (channel letters) and yellow (Perimeter Channel Trim)
- 4. 3mm Signabond Lite composite backs
- (interior of sign can painted ultra white for maximum illumination) 5. White LEDs
- 3/16" White Acrylic (Channel Letters) and 3/16" #2037 Yellow acrylic for the Perimeter Channel Trim
- 7. Waterproof disconnect switch per NEC 600-6
- 8. Primary electrical feed
- 9. Transformers
- 10. 0.080" Aluminum shoe-box ptm PMS# 1805 Red (all jumps contained within shoe-box)
- 11. #12 TEC screws fastening shoe-box to 3" x 1" Aluminum Square Tube Mounting Frame. (2" x 2" x 1/4" Aluminum mount tabs welded to frame)
- 12. #12 x 1" TEC screws with 11/4" fender washers
- 13. Mounting hardware to suit

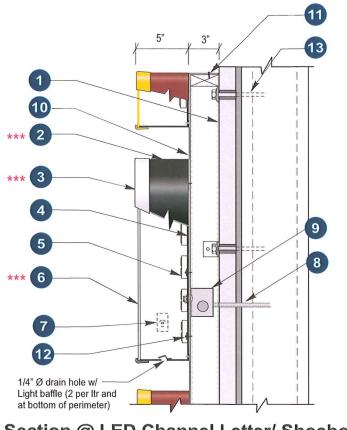

Section @ LED Channel Letter/ Shoebox Front-Lit (Self Contained)

Scale: N.T.S.

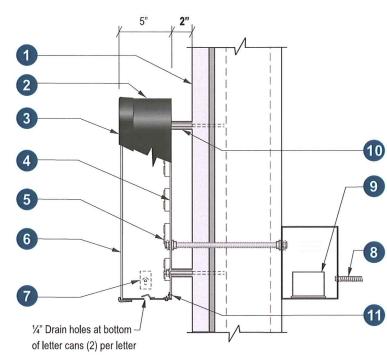

Section @ LED Channel Letter
Reverse-lit / Front-lit (Remote) Scale: N.T.S



Client:	Jasons Deli	05/03/2012	Original Rendering	ВС	This re
Site #:	JD-A16234	<u> </u>			Sign, In
Address:	3756 Airport Road	Ď			reques
-		<u>0</u>			distribu
_	Mobile	<u> Т</u>			Please with qu



Sign B	
Sign:	16" Jason's Deli
Sign Type:	Channel Letters on a shoebox pan/ Aluminum Frame
Illumination:	Internally Illuminated LED
Square Footage:	25.08
To Grade:	Top of sign to grade = 16'-9 1/2" Bottom of sign to grade = 14'-1 1/4"



Sign Layout Detail

Scale: 1/2" = 1'-0"

Note: Registration Mark to be white vinyl applied to face of background

Note: Attachment detail for this sign will be determined prior to permitting and production

Electrical Detail:

White LEDs (GE MiniMax)
(X) 60w Transformer @ 0.85 Amps Each
Total Amps: X.XX
(1) 20 amp 120V Circuit Req.


General Notes:

This sign is to be installed in accordance with the requirements of Article 600 of the National Electrical Code.

- 1) Grounded and bonded per NEC 600.7/NEC 250
- 2) Existing branch circuit in compliance with NEC 600.5, not to exceed 20 amps
- 3) Sign is to be UL listed per NEC 600.3
- 4) UL disconnect switch per NEC 600.6- required per sign component before leaving manufacturer*
 *For multiple signs, a disconnect is permitted but not required for each section

Specifications: Channel Letters


- 1. Existing Facade: TBD
- 2. 0.040" Aluminum letter returns painted to match black (channel letters) and ptm PMS#1805 red (Perimeter Channel Trim)
- 3. 0.125" x 1" trim cap to match white (channel letters) and yellow (Perimeter Channel Trim)
- 4. 3mm Signabond Lite composite backs (interior of sign can painted ultra white for maximum illumination)
- 5. White LEDs
- 6. 3/16" White Acrylic (Channel Letters) and 3/16" #2037 Yellow acrylic for the Perimeter Channel Trim
- 7. Waterproof disconnect switch per NEC 600-6
- 8. Primary electrical feed
- 9. Transformers
- 10. 0.080" Aluminum shoe-box ptm PMS# 1805 Red (all jumps contained within shoe-box)
- 11. #12 TEC screws fastening shoe-box to 3" x 1" Aluminum Square Tube Mounting Frame. (2" x 2" x 1/4" Aluminum mount tabs welded to frame)
- 12. #12 x 1" TEC screws with 11/4" fender washers
- 13. Mounting hardware to suit

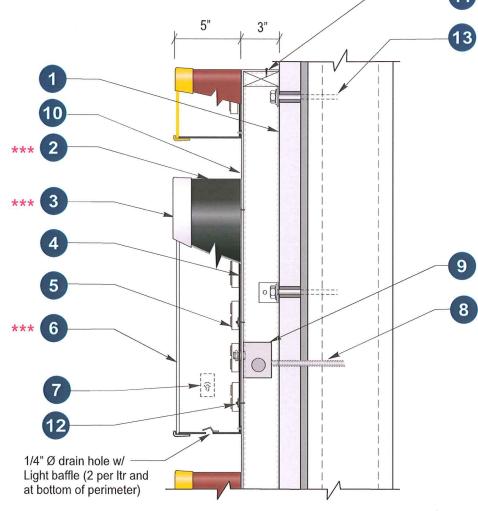


Section @ LED Channel Letter/ Shoebox Front-Lit (Self Contained) Scale: N.T.S.



Client:	Jasons Deli	05/03/2	2012	Original Rendering	BC	This r
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-	Mobile AL 36608	<u> </u>				distrib
	Mobile	# H				Pleas with o

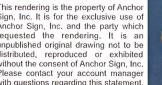




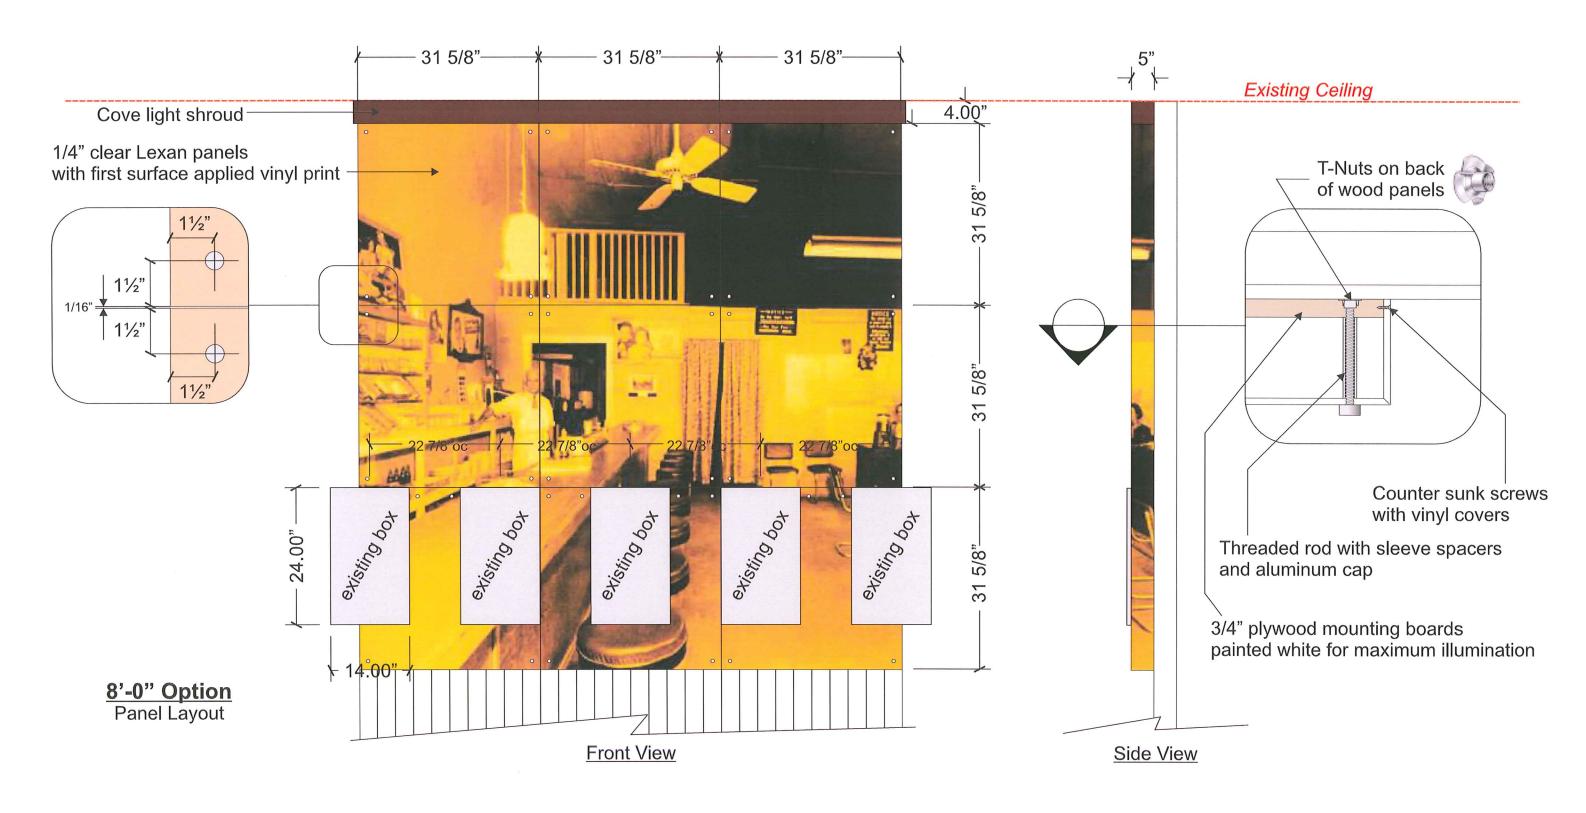






Client:	Jasons Deli	05/03/2012	Original Rendering	ВС	This re
Site #:	JD-A16234	록			Sign, I Ancho
Address:	3756 Airport Road	NO N			reques
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	Mobile	Ä			Please with qu




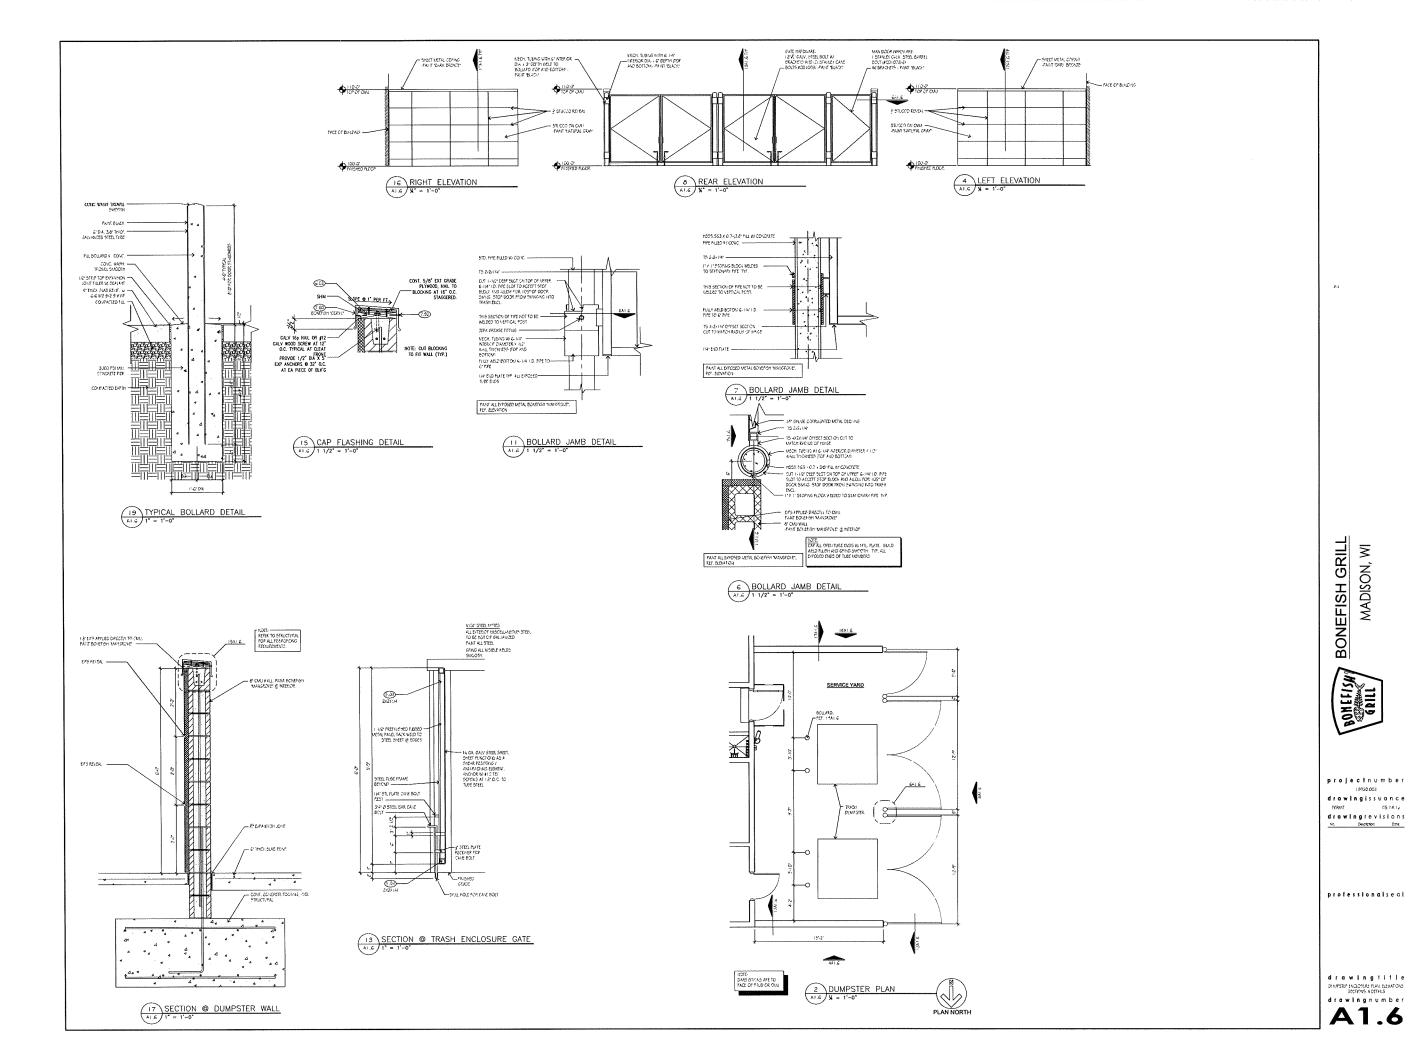

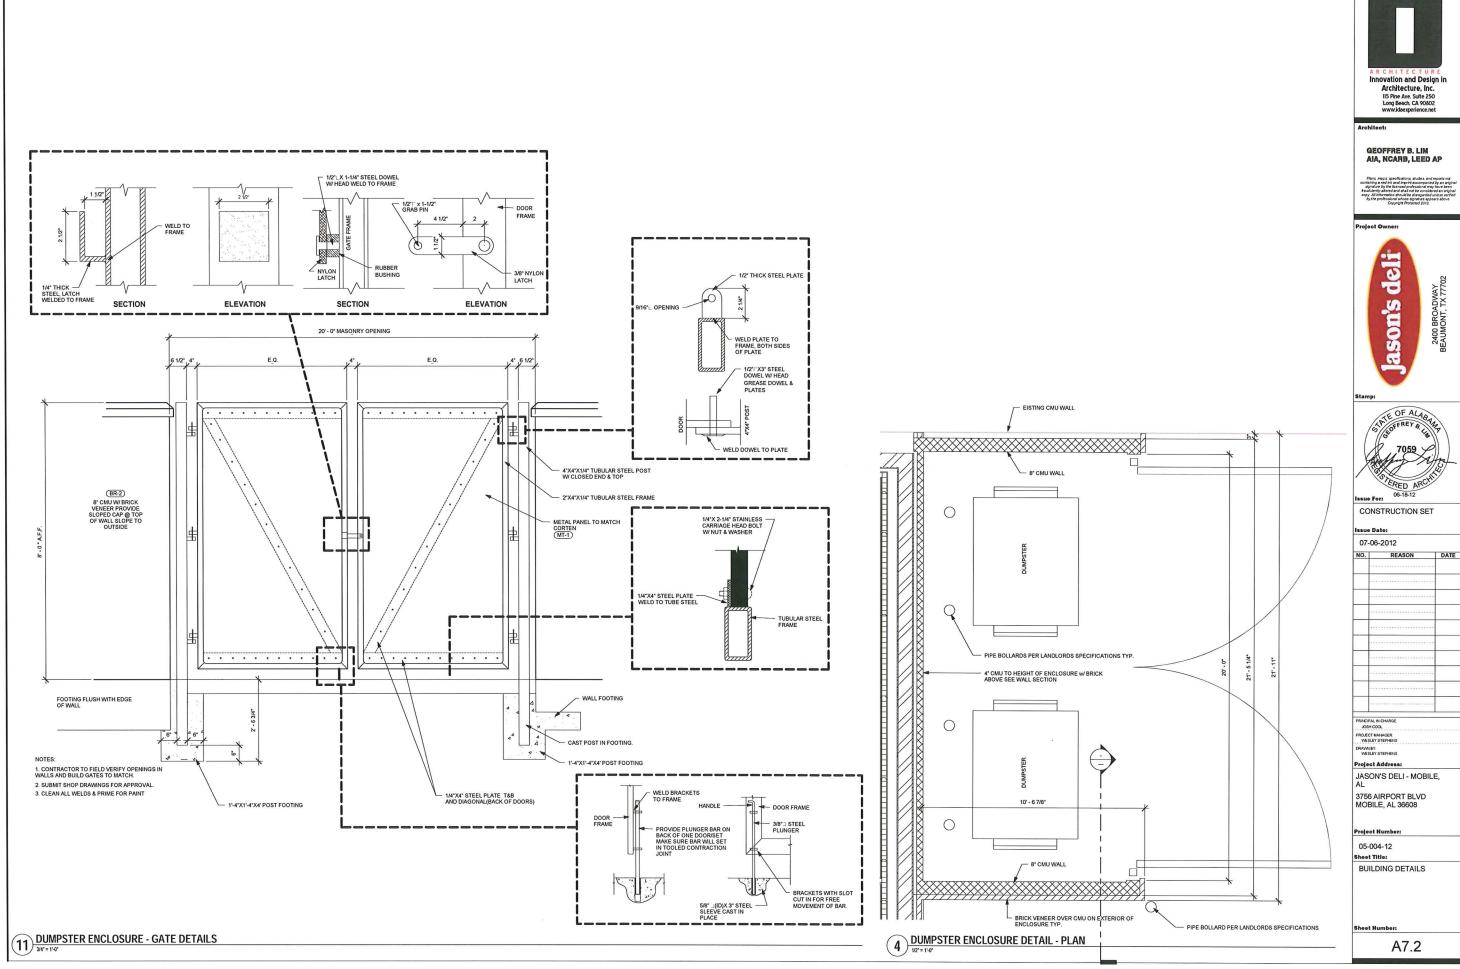

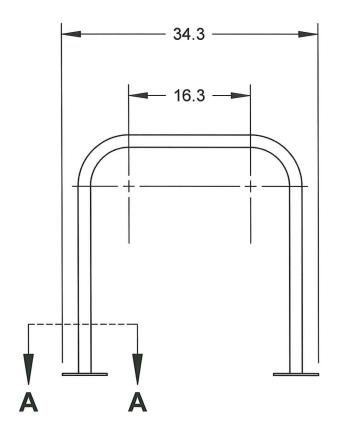

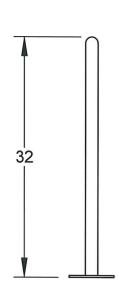

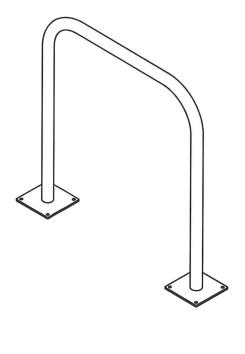



2X 6" X 6" X .25" SQUARE FLANGE MOUNTING PLATE WITH 4 ϕ 5/8" MOUNTING HOLES

NOTE:

- 1. DO NOT SCALE DRAWING.
- 2. INTALLATION TO BE COMPLETED IN ACCORDANCE WITH MANUFACTURER'S SPECIFICATIONS.



SARIS CYCLING GROUP

5253 VERONA RD., MADISON WI. 53711 1-800-783-7257 / 1-608-274-1702 WWW.SARISPARKING.COM

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TITLE:

6903 - 2 BIKE FM BIKE DOCK

WE BRING CYCLING TO LIFE.