

RWW

102 S. SPRECHER RD. MADISON, WI

SPRECHER AND MILWAUKEE DEVELOPMENT

AY PROJECT NUMBER: 72800

REGULATORY DATA:



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NO:	DESCRIPTION:	DATE:
1	CITY LU AND CUP SUBMITTAL	06/10/2022

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PRELIMINARY NOT FOR CONSTRUCTION ANGUS - YOUNG ASSOCIATES, INC.

*Date* 

#### **PROJECT TEAM**

ROSS RIKKERS

CONTACT: ROSS RIKKERS

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ARCHITECT: 16 N. CARROLL ST. MADISON, WI 53703

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CONTACT: JEFF DAVIS

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LANDSCAPE ARCHITECT / CIVIL ENGINEER: ANGUS-YOUNG ASSOCIATES, INC. 555 S. River St. Janesville, WI 53548

CONTACT: KATIE UDELL EMAIL: K.UDELL@ANGUSYOUNG.COM PHONE: (608)756-2326


35 30 25 20 15 10 05 www.angusyoung.com 34 | 29 | 24 | 19 | 14 | 09 | 04 | 33 | 28 | 23 | 18 | 13 | 08 | 03 | 32 | 27 | 22 | 17 | 12 | 07 | 02 | 31 | 26 | 21 | 16 | 11 | 06 | 01 | DETAILS IN THIS SET ARE PLACED ON THE SHEETS AND NUMBERED WITH RESPECT TO THE GRID ABOVE. CONSEQUENTLY,


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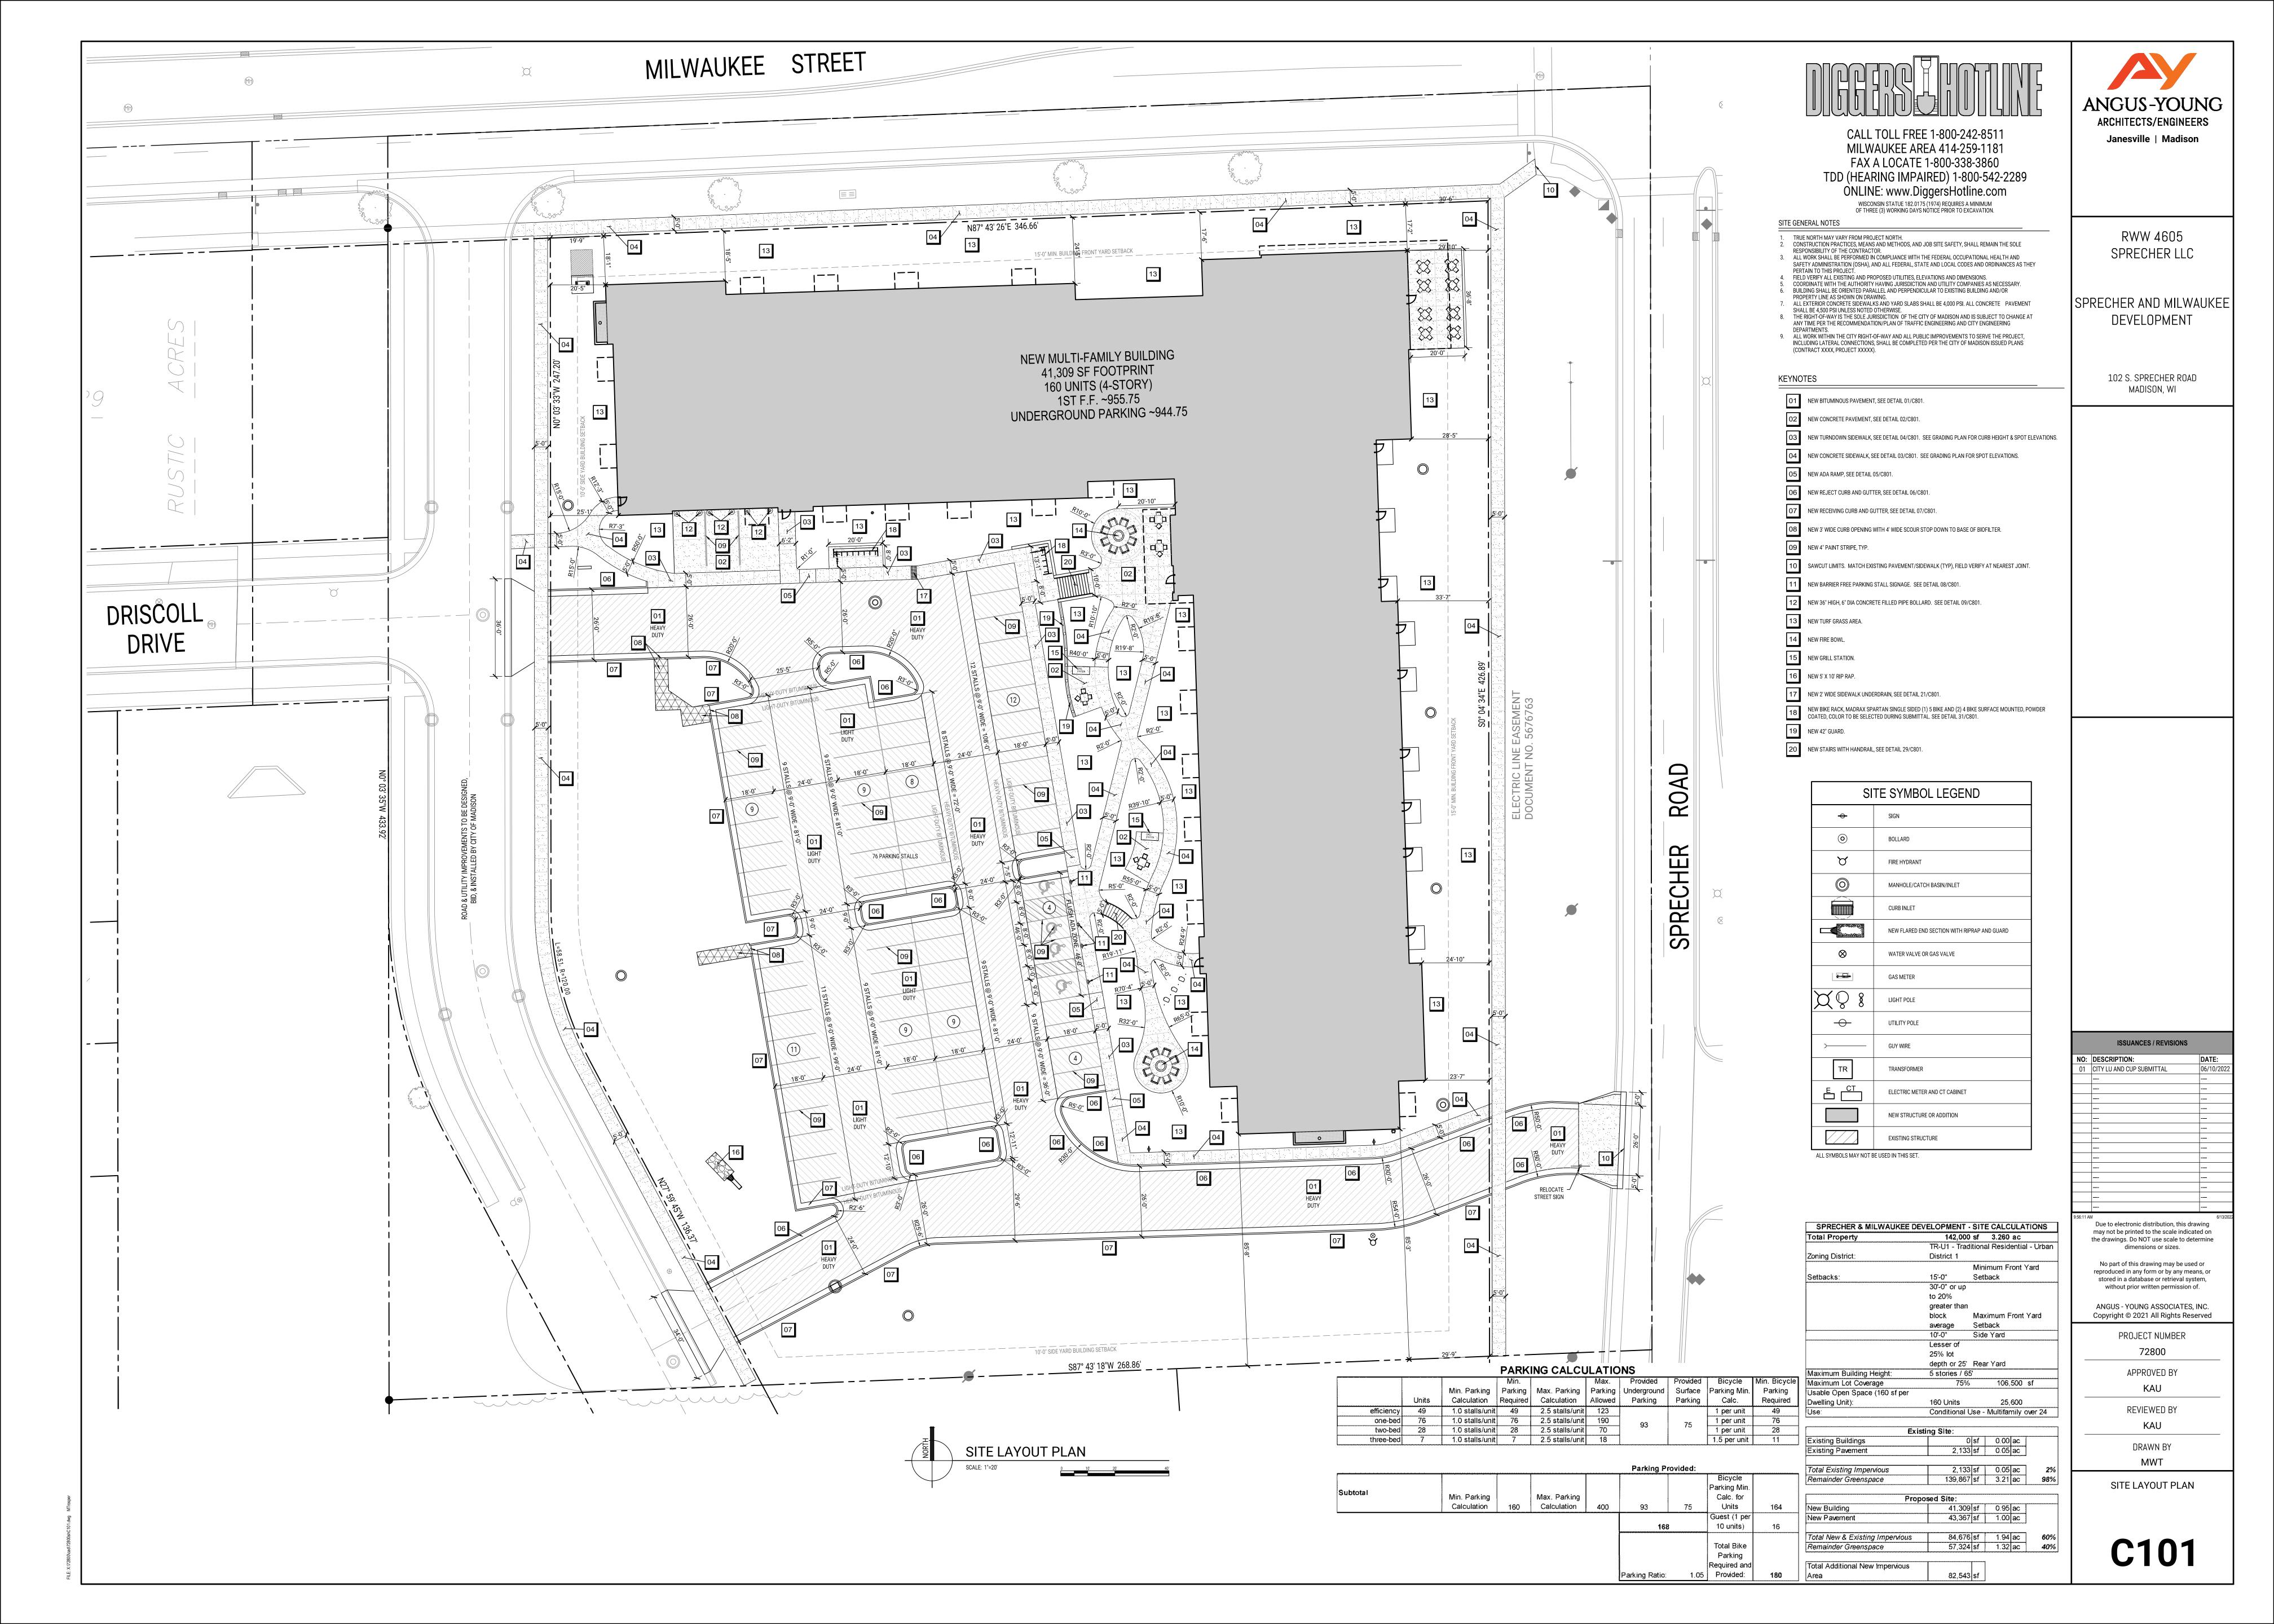
COVER SHEET


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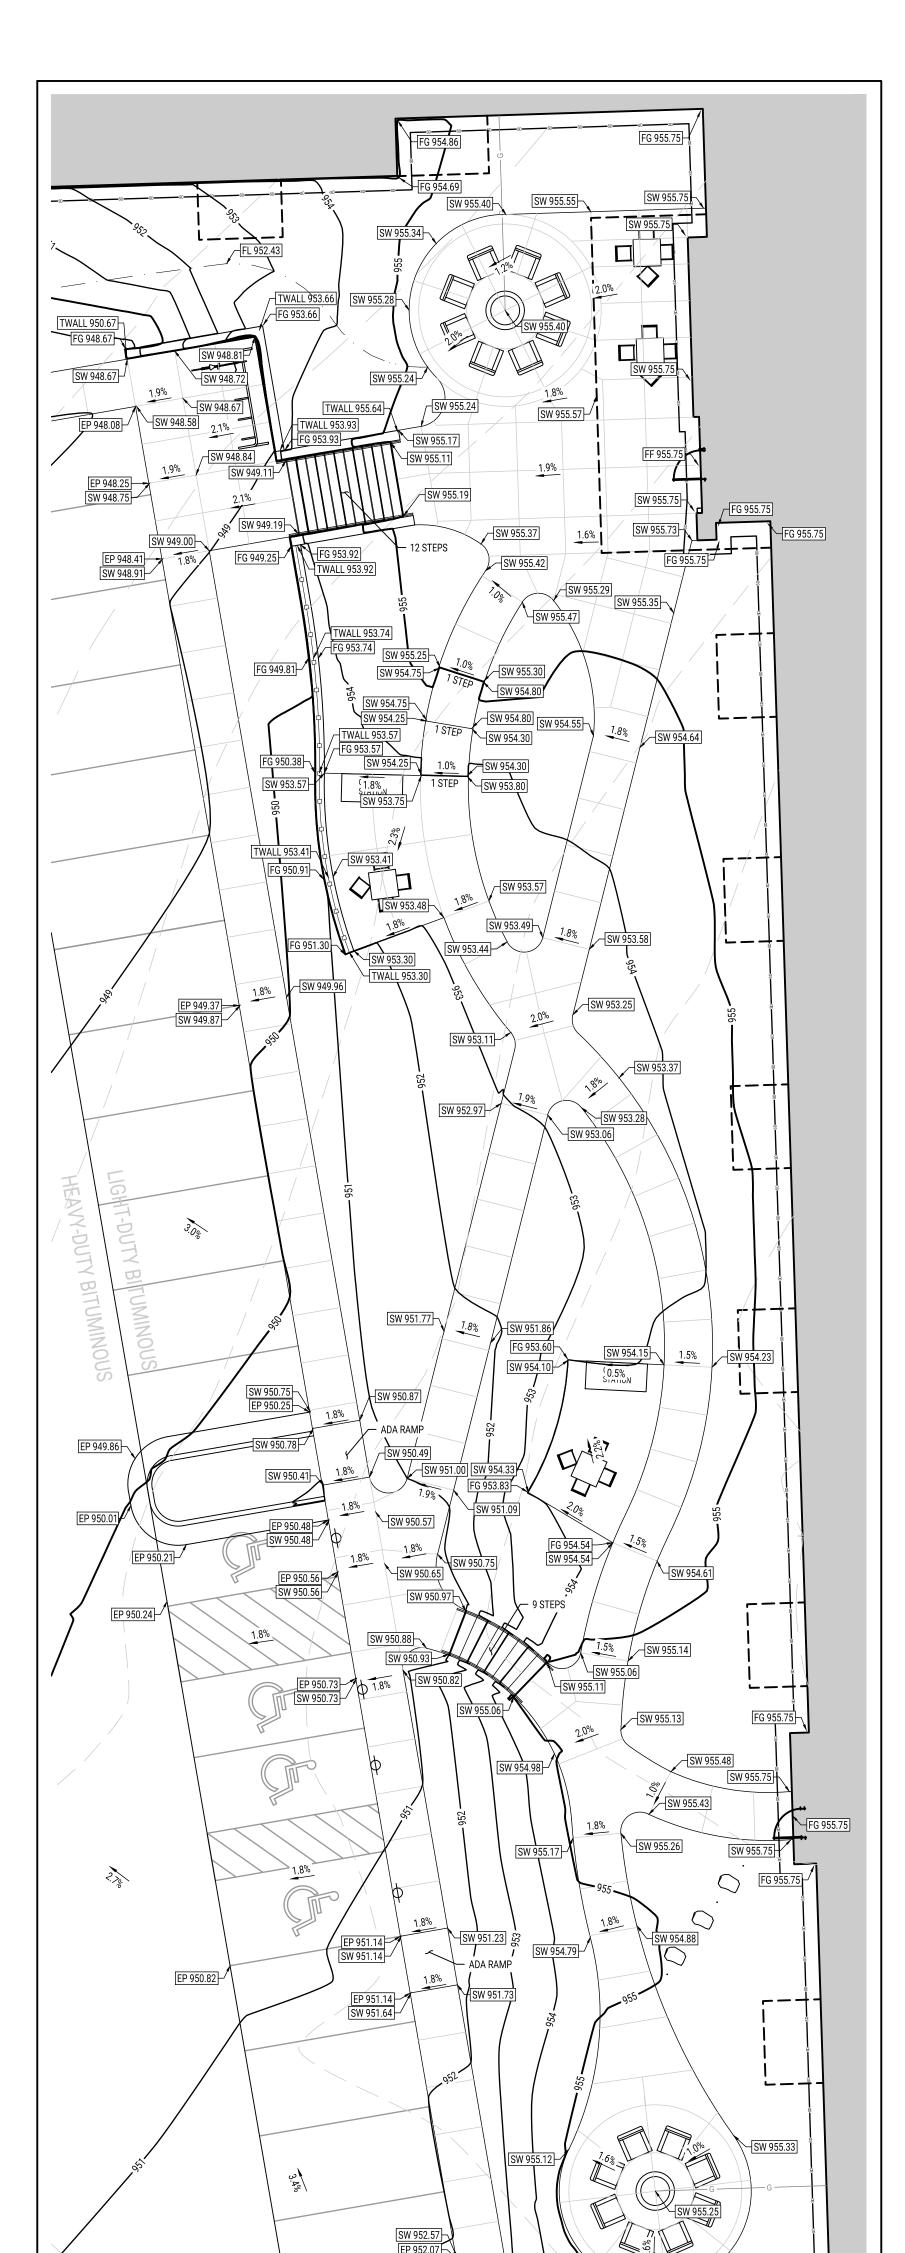
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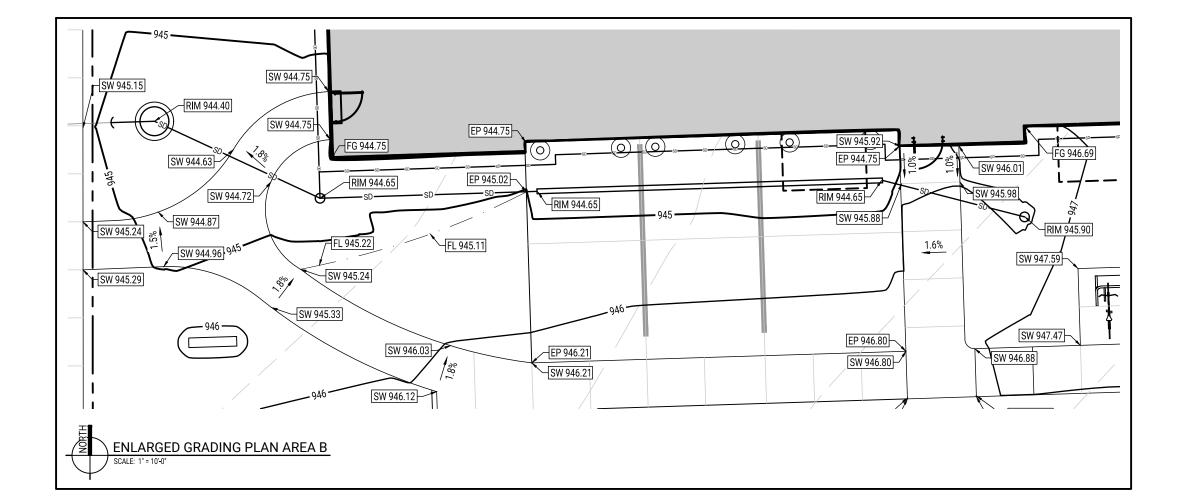






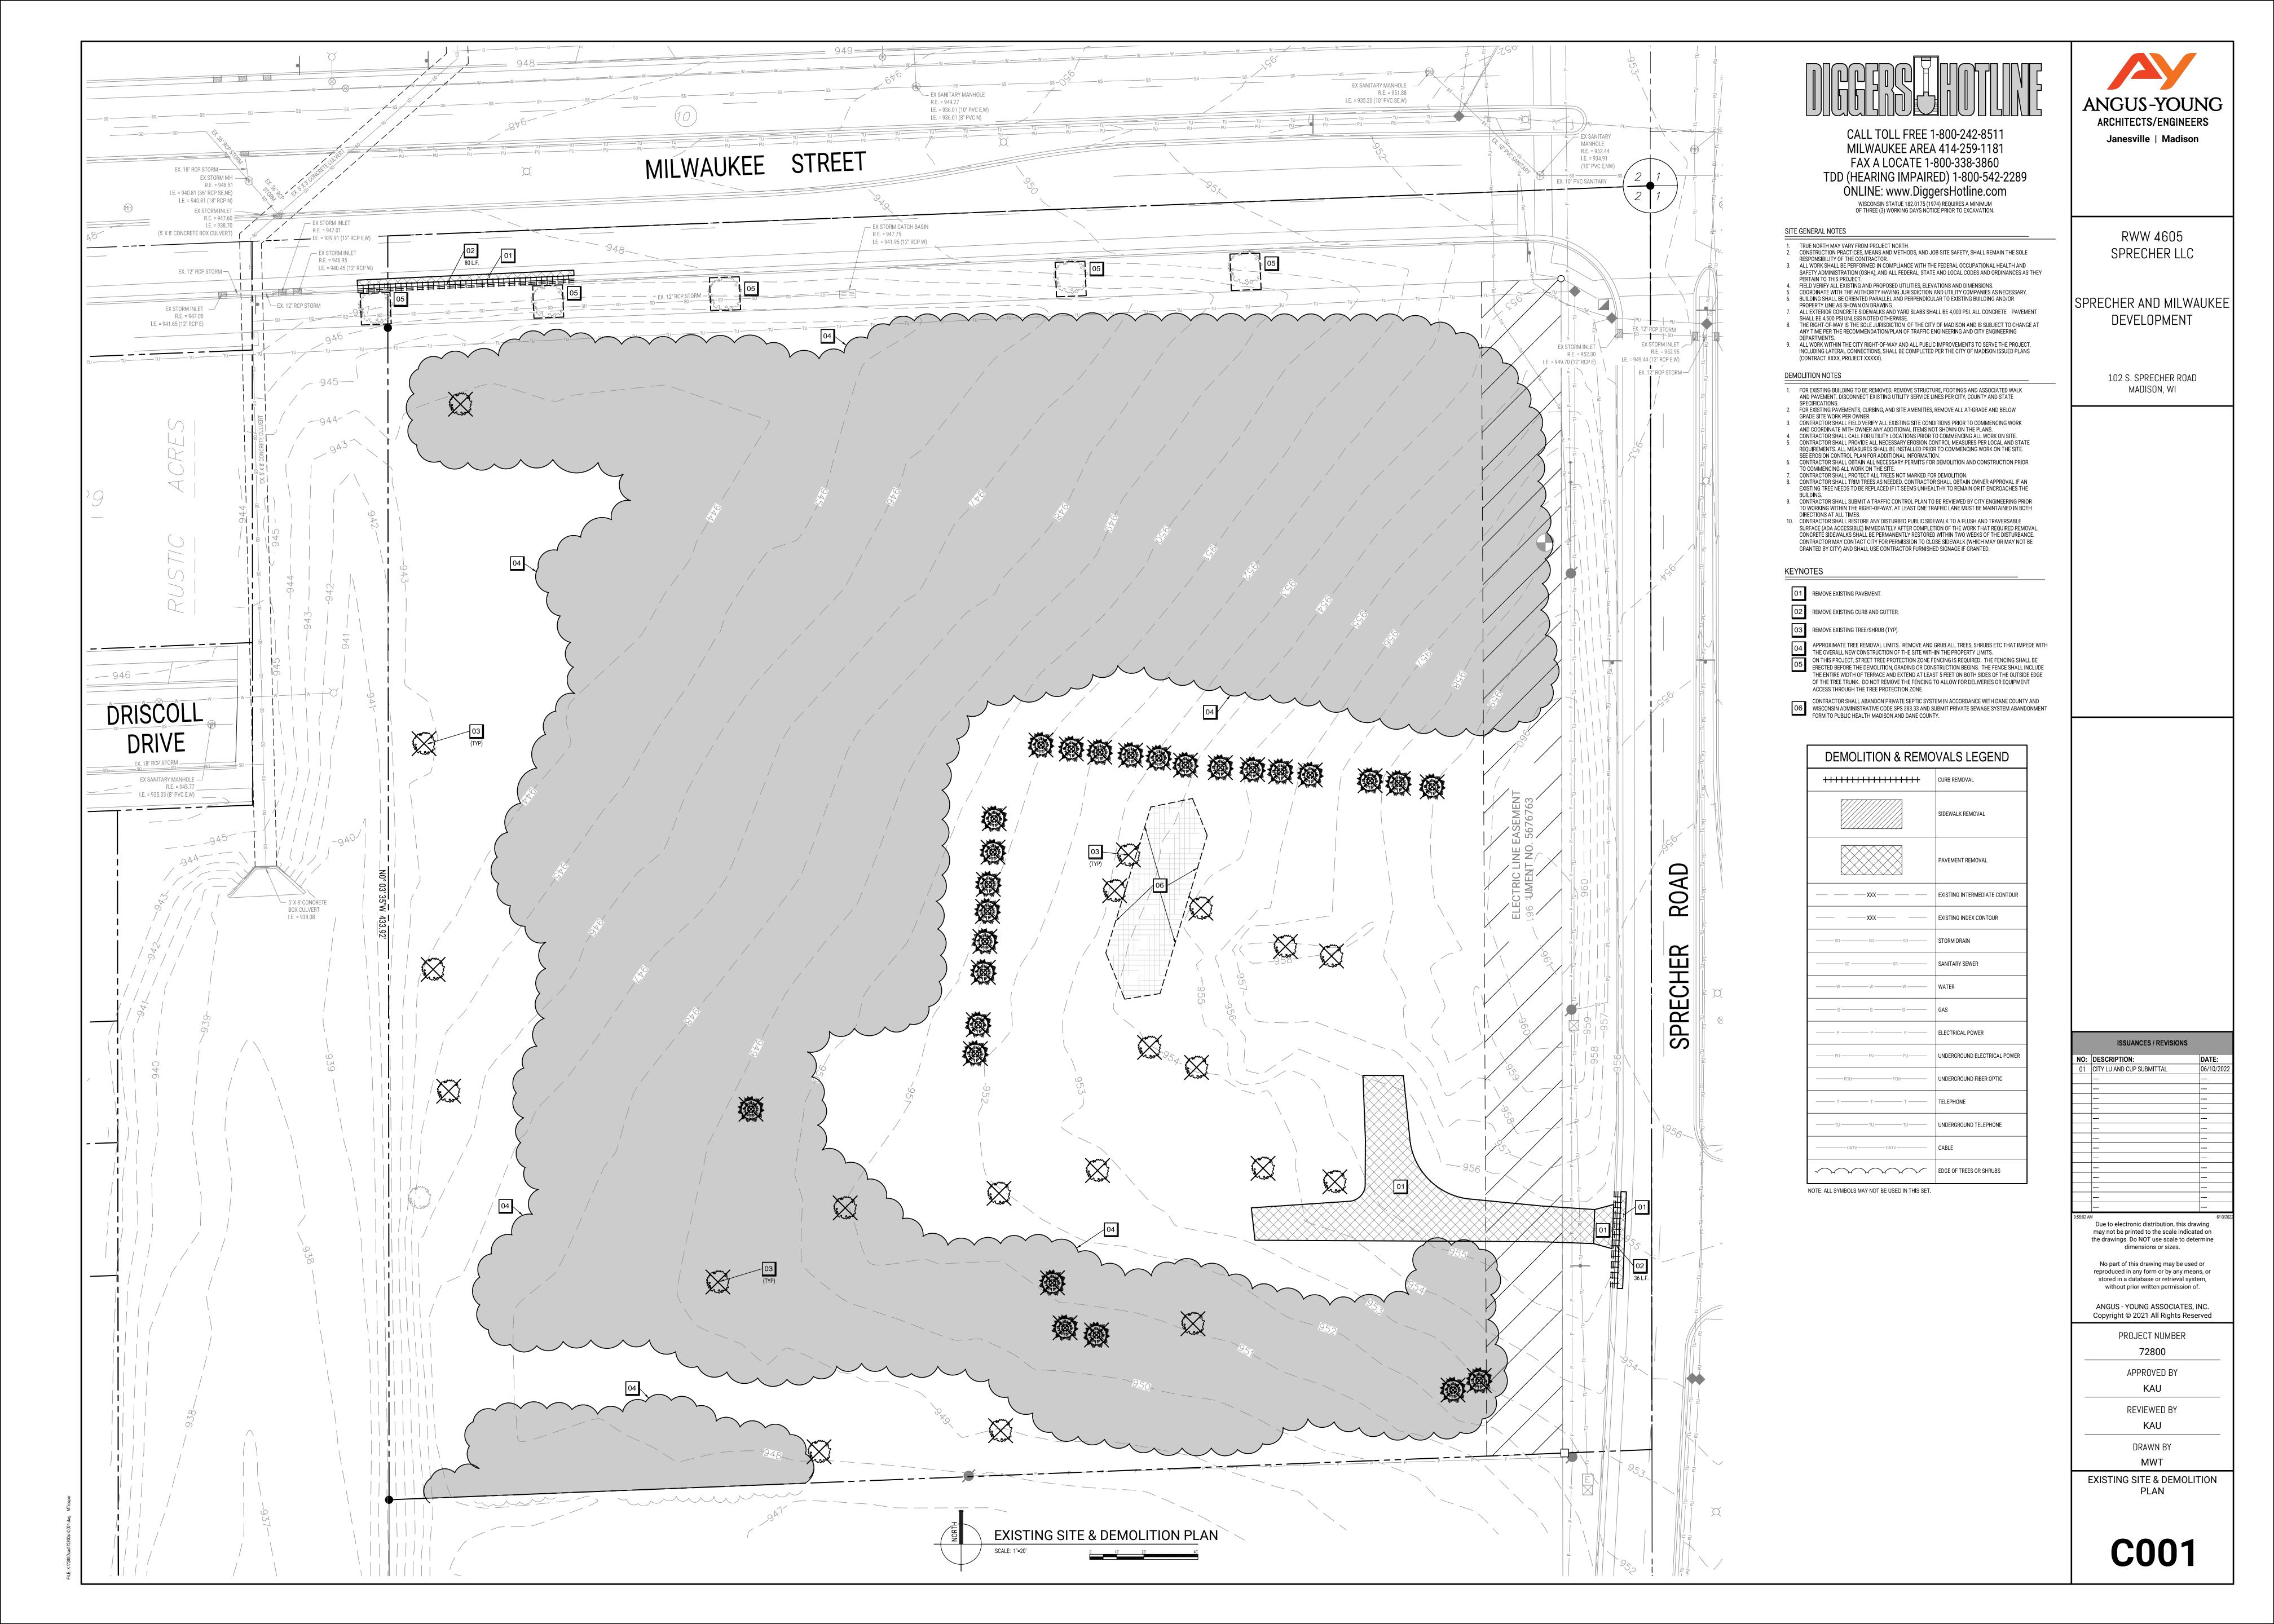

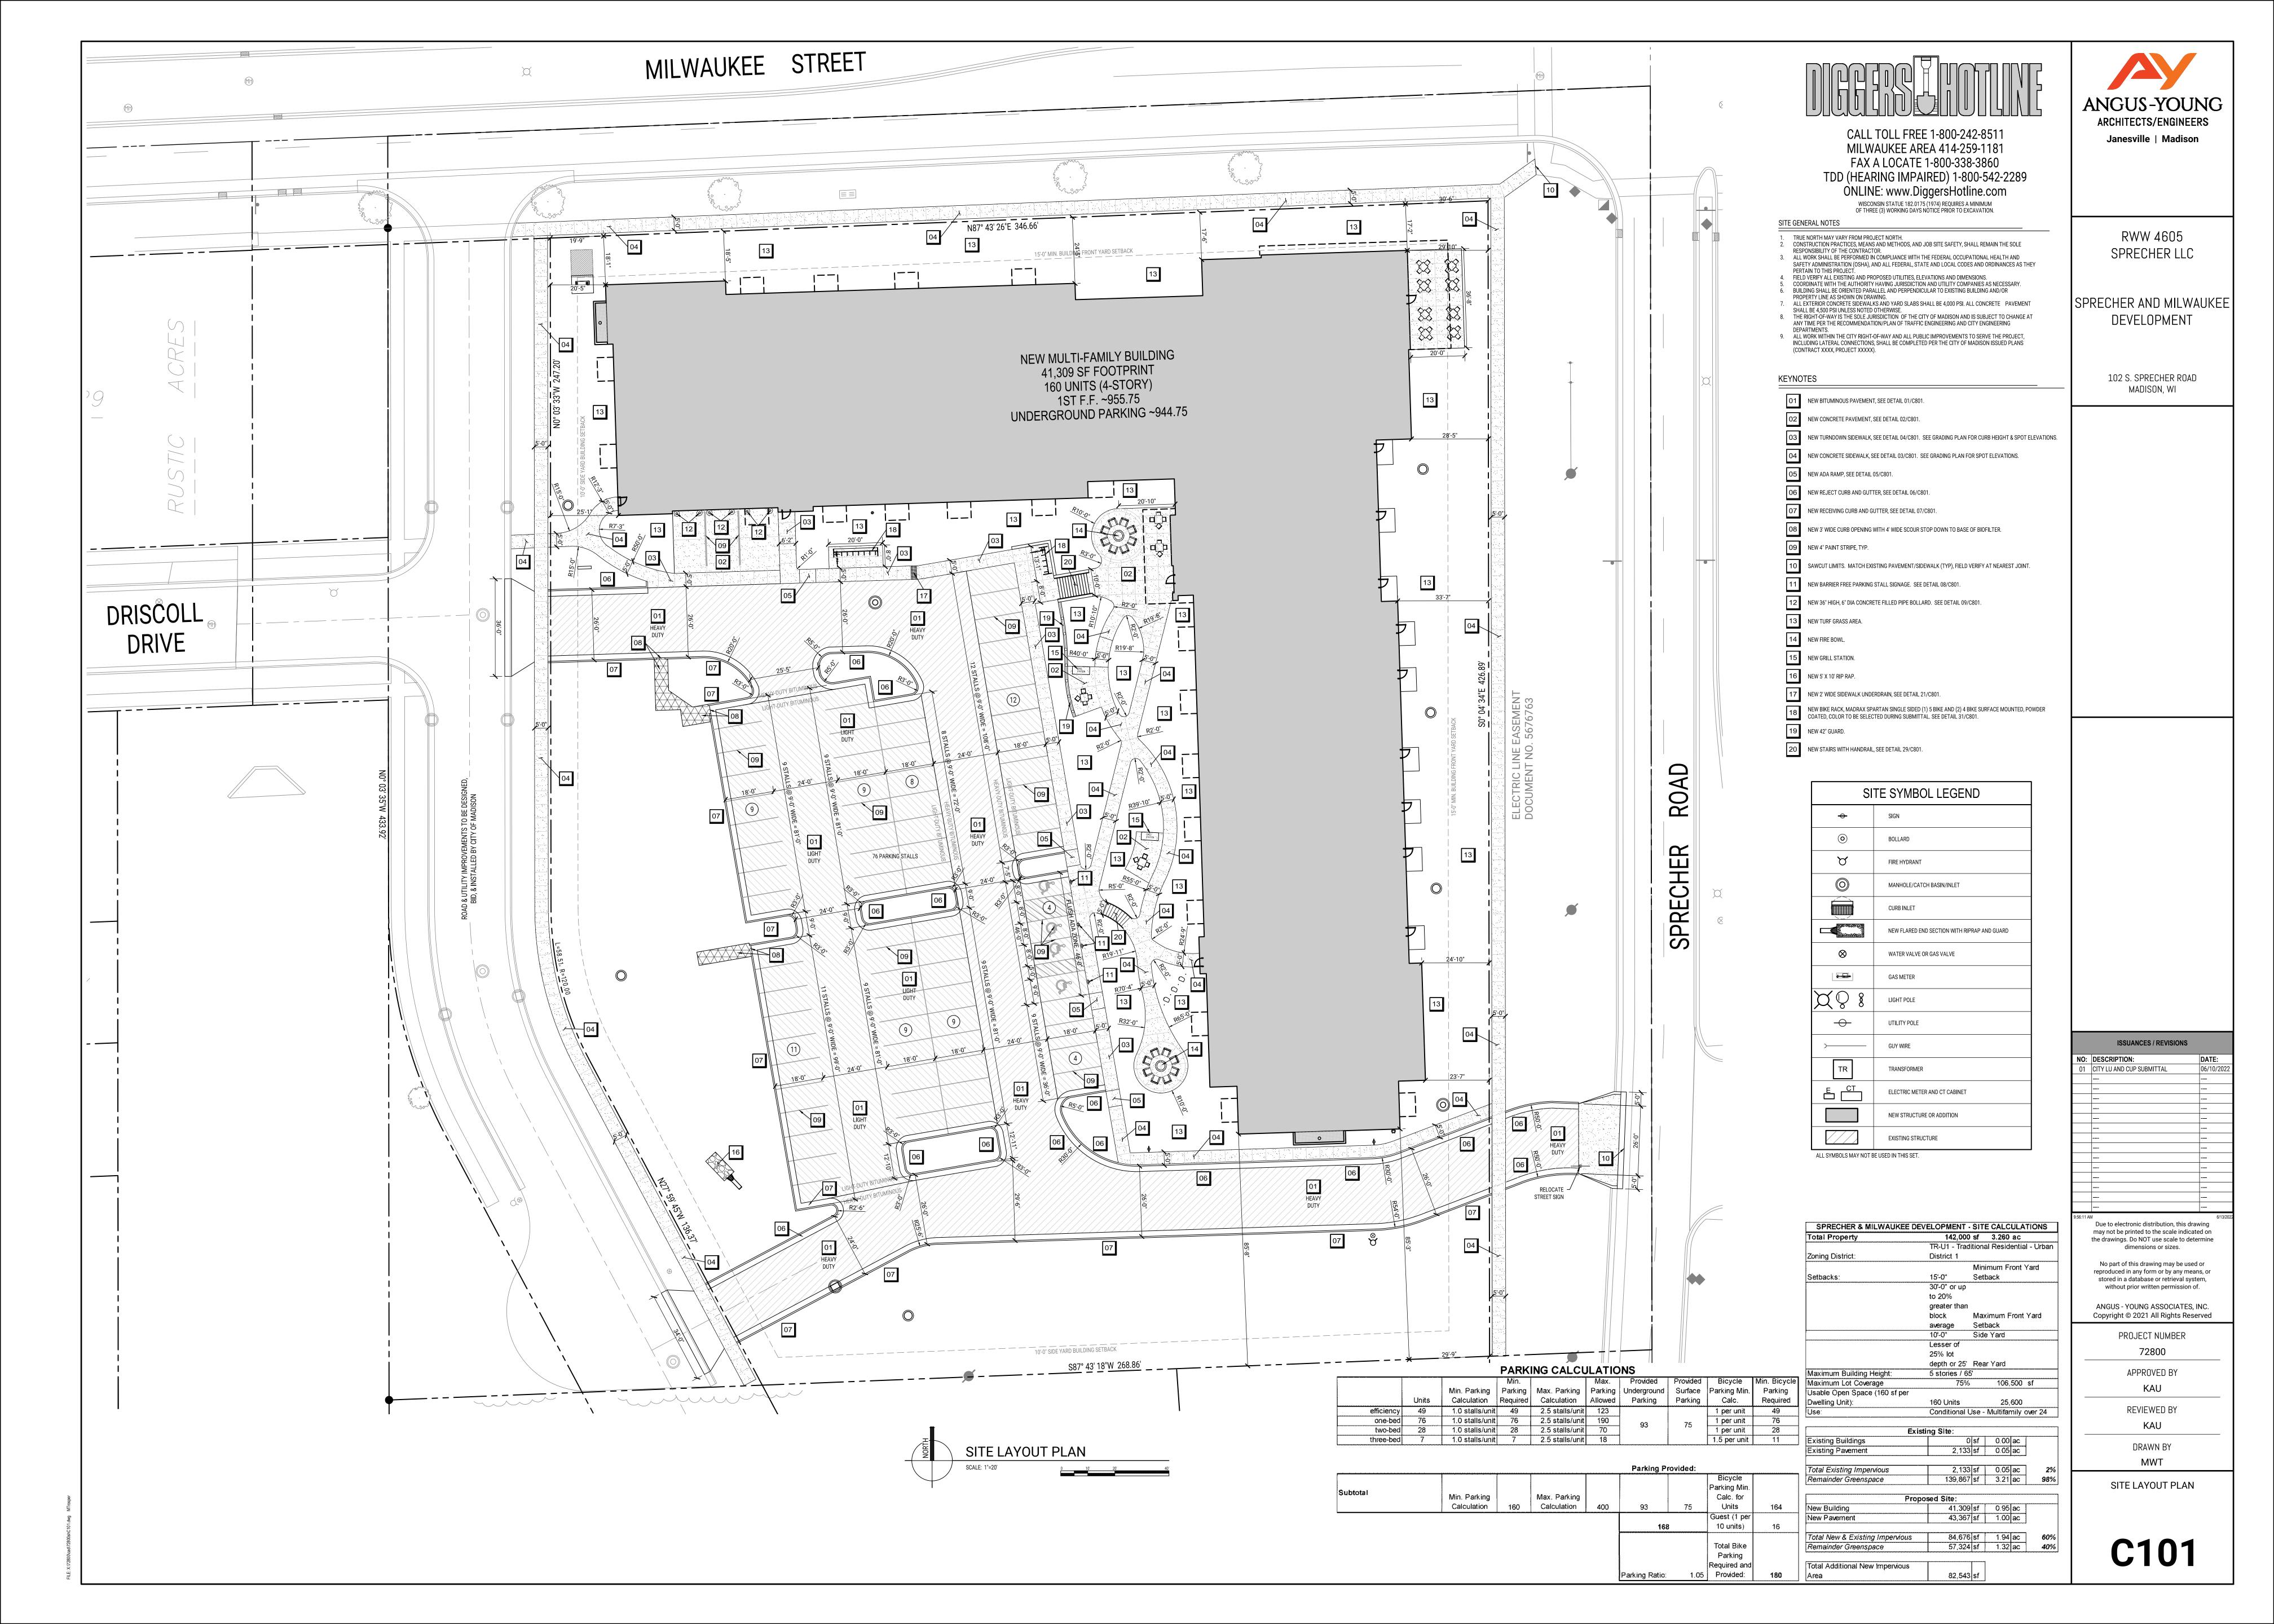ENLARGED GRADING PLAN AREA A

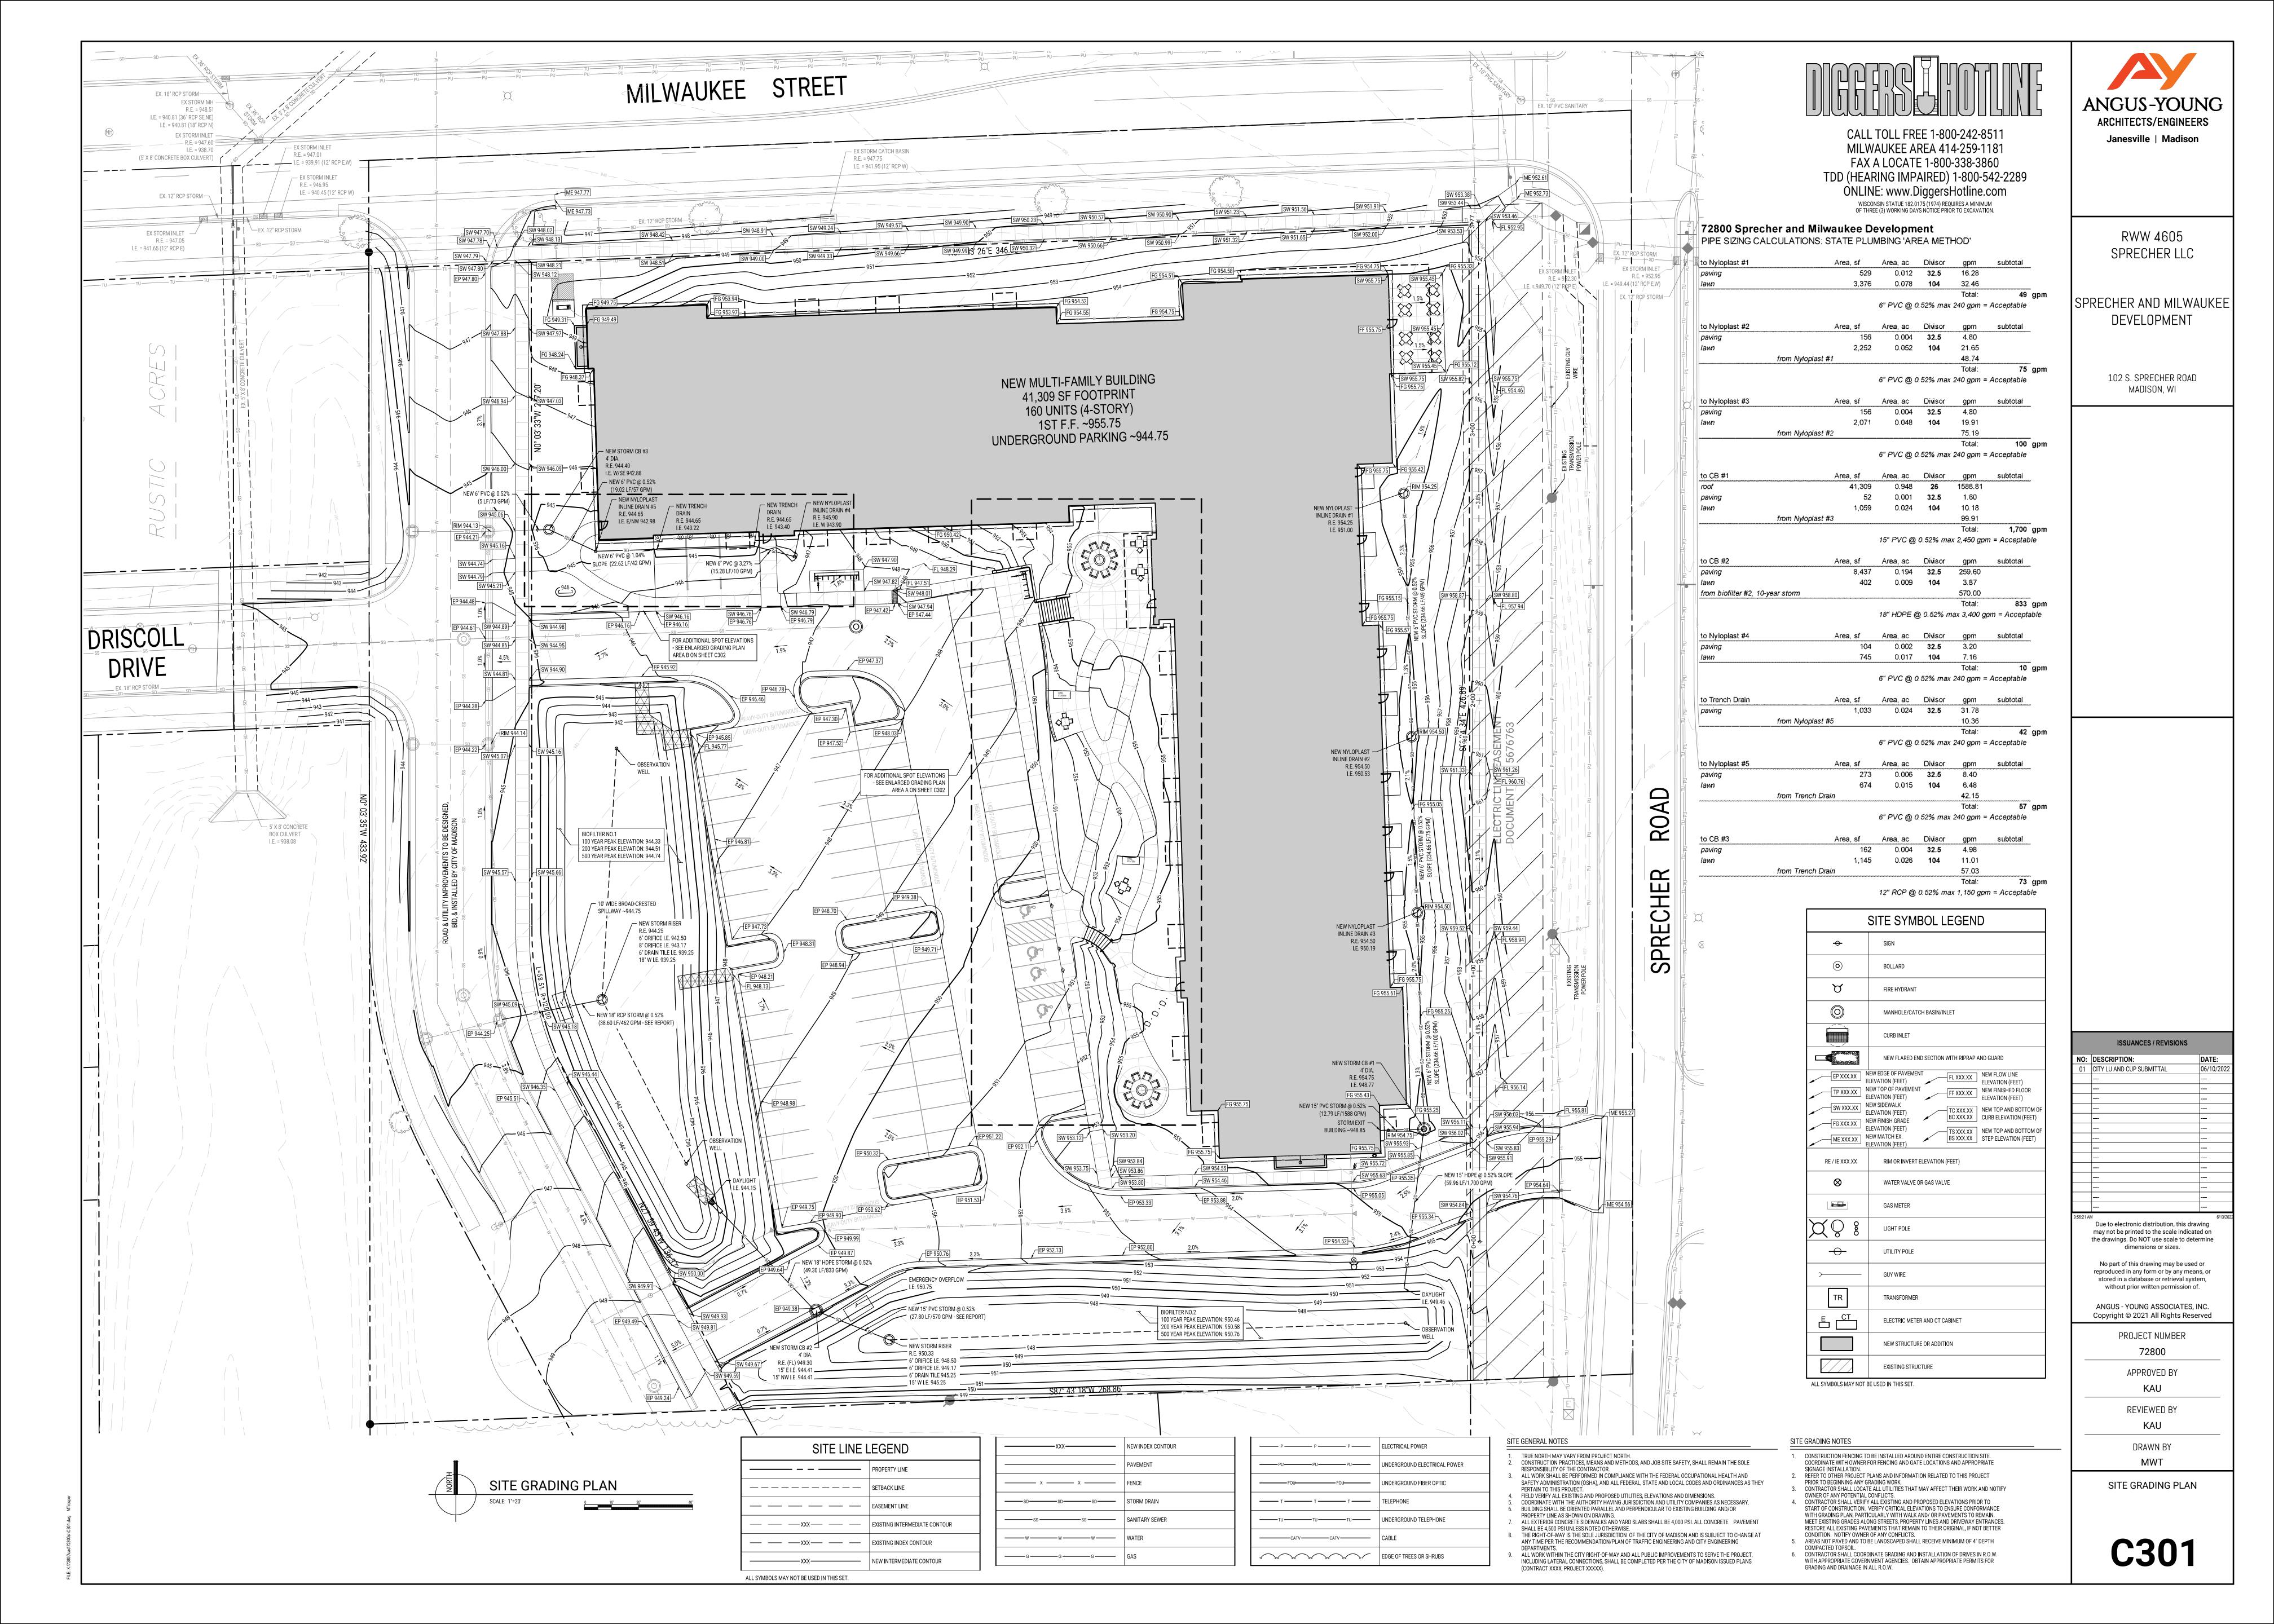

#### SITE GENERAL NOTES

- TRUE NORTH MAY VARY FROM PROJECT NORTH. CONSTRUCTION PRACTICES, MEANS AND METHODS, AND JOB SITE SAFETY, SHALL REMAIN THE SOLE RESPONSIBILITY OF THE CONTRACTOR. ALL WORK SHALL BE PERFORMED IN COMPLIANCE WITH THE FEDERAL OCCUPATIONAL HEALTH AND
- SAFETY ADMINISTRATION (OSHA), AND ALL FEDERAL, STATE AND LOCAL CODES AND ORDINANCES AS THEY PERTAIN TO THIS PROJECT. FIELD VERIFY ALL EXISTING AND PROPOSED UTILITIES, ELEVATIONS AND DIMENSIONS. COORDINATE WITH THE AUTHORITY HAVING JURISDICTION AND UTILITY COMPANIES AS NECESSARY.
  BUILDING SHALL BE ORIENTED PARALLEL AND PERPENDICULAR TO EXISTING BUILDING AND/OR
- PROPERTY LINE AS SHOWN ON DRAWING.
  7. ALL EXTERIOR CONCRETE SIDEWALKS AND YARD SLABS SHALL BE 4,000 PSI. ALL CONCRETE PAVEMENT SHALL BE 4,500 PSI UNLESS NOTED OTHERWISE. THE RIGHT-OF-WAY IS THE SOLE JURISDICTION OF THE CITY OF MADISON AND IS SUBJECT TO CHANGE AT ANY TIME PER THE RECOMMENDATION/PLAN OF TRAFFIC ENGINEERING AND CITY ENGINEERING
- 9. ALL WORK WITHIN THE CITY RIGHT-OF-WAY AND ALL PUBLIC IMPROVEMENTS TO SERVE THE PROJECT,
- INCLUDING LATERAL CONNECTIONS, SHALL BE COMPLETED PER THE CITY OF MADISON ISSUED PLANS (CONTRACT XXXX, PROJECT XXXXX).

#### SITE GRADING NOTES

SIGNAGE INSTALLATION.

- CONSTRUCTION FENCING TO BE INSTALLED AROUND ENTIRE CONSTRUCTION SITE. COORDINATE WITH OWNER FOR FENCING AND GATE LOCATIONS AND APPROPRIATE
- REFER TO OTHER PROJECT PLANS AND INFORMATION RELATED TO THIS PROJECT PRIOR TO BEGINNING ANY GRADING WORK.

  CONTRACTOR SHALL LOCATE ALL UTILITIES THAT MAY AFFECT THEIR WORK AND NOTIFY OWNER OF ANY POTENTIAL CONFLICTS. CONTRACTOR SHALL VERIFY ALL EXISTING AND PROPOSED ELEVATIONS PRIOR TO START OF CONSTRUCTION. VERIFY CRITICAL ELEVATIONS TO ENSURE CONFORMANCE WITH GRADING PLAN, PARTICULARLY WITH WALK AND/ OR PAVEMENTS TO REMAIN.
- RESTORE ALL EXISTING PAVEMENTS THAT REMAIN TO THEIR ORIGINAL, IF NOT BETTER CONDITION. NOTIFY OWNER OF ANY CONFLICTS. AREAS NOT PAVED AND TO BE LANDSCAPED SHALL RECEIVE MINIMUM OF 4" DEPTH COMPACTED TOPSOIL. CONTRACTOR SHALL COORDINATE GRADING AND INSTALLATION OF DRIVES IN R.O.W.
  WITH APPROPRIATE GOVERNMENT AGENCIES. OBTAIN APPROPRIATE PERMITS FOR
  GRADING AND DRAINAGE IN ALL R.O.W.

MEET EXISTING GRADES ALONG STREETS, PROPERTY LINES AND DRIVEWAY ENTRANCES.

CONSTRUCTION FOR SITE IMPROVEMENTS - CITY OF MADISON NOTES GRADING, EROSION CONTROL, BARRICADES, AND TRAFFIC CONTROL:

A. THE DEVELOPER SHALL GRADE OF THE TERRACES OF EXISTING STREETS TO A SIDEWALK GRADE ESTABLISHED BY THE CITY ENGINEER AND IN ACCORDANCE WITH THE MADISON STANDARD TYPICAL STREET SECTIONS AND STANDARD DETAIL DRAWINGS OF THE SPECIFICATIONS. B. THE DEVELOPER SHALL GRADE VISION CLEARANCE TRIANGLES ON CORNER LOTS TO A MAXIMUM

HEIGHT OF TWO (2) FEET ABOVE THE PROPOSED CURB ELEVATION WITHIN THE TRIANGULAR SPACE FORMED BY TWO INTERSECTING STREET LINES OR THEIR PROJECTIONS AND A LINE ADJOINING SAID POINTS ON SAID STREET LINES LOCATED A MINIMUM OF TWENTY-FIVE (25) FEET FROM SUCH STREE INTERSECTIONS. NO STRUCTURES, SCREENINGS, PLANTINGS, OR EMBANKMENTS OF ANY KIND ARE

ALLOWED WITHIN THIS TRIANGULAR AREA IF THEY VIOLATE SECTION 27.05(2)(BB), MGO. C. THE DEVELOPER SHALL FURNISH, INSTALL BARRICADES, SIGNS AND OTHER TRAFFIC CONTROL DEVICES AS SPECIFIED BY THE CITY TRAFFIC ENGINEER AT ALL STREET ENDS.

D. THE DEVELOPER SHALL PREPARE A TRAFFIC CONTROL PLAN, WHICH SHALL BE SUBMITTED FOR APPROVAL TO THE TRAFFIC ENGINEERING DIVISION. WORK SHALL NOT BEGIN UNTIL THE TRAFFIC CONTROL PLAN IS APPROVED BY THE TRAFFIC ENGINEERING DIVISION AND A COPY OF THE APPROVED TRAFFIC CONTROL PLAN HAS BEEN SUBMITTED TO THE CONSTRUCTION ENGINEER. THE DEVELOPER SHALL FURNISH, INSTALL AND MAINTAIN DURING CONSTRUCTION, BARRICADES, SIGNS, PAVEMENT MARKINGS AND OTHER TRAFFIC CONTROL DEVICES AS SPECIFIED ON THE APPROVED TRAFFIC CONTROL PLAN OR AS DIRECTED BY THE CITY TRAFFIC ENGINEER. SUBMIT PLANS FOR REVIEW OR QUESTIONS REGARDING THIS CONDITION TO MICHAEL DUHR (MDUHR@CITYOFMADISON.COM 267-8755 OR 267-4761).

E. THE DEVELOPER SHALL OBTAIN AN EROSION CONTROL AND STORMWATER MANAGEMENT PERMIT FOR THE EROSION AND RUNOFF CONTROL AS REQUIRED BY CHAPTER 37, M.G.O. PRIOR TO THE GRADING, UTILITY INSTALLATION OR OTHER LAND DISTURBANCE ACTIVITY. A PERMIT SHALL BE OBTAINED FOR EACH CONSTRUCTION PHASE. THE DEVELOPER SHALL ADHERE TO CONDITIONS SPECIFIED ON THE PERMIT AND GRANTS THE RIGHT-OF-ENTRY ON THE DEVELOPMENT TO DESIGNATED PERSONNEL OF THE CITY TO INSPECT AND MONITOR COMPLIANCE WITH THIS

PRIOR TO ACCEPTANCE. THE DEVELOPER SHALL SUBMIT A POST CONSTRUCTION EROSION CONTROL PLAN TO THE CITY. THIS PLAN SHALL ADDRESS EROSION CONTROL IN THE INTERIM BETWEEN THE COMPLETION OF THE PUBLIC WORKS IMPROVEMENTS SPECIFIED IN THIS CONTRACT AND ULTIMATE DEVELOPMENT. THE DEVELOPER SHALL INSTALL THOSE FACILITIES AND STRUCTURES REQUIRED BY THE POST DEVELOPMENT EROSION CONTROL PLAN.

F. THE DEVELOPER SHALL NOT DISTURB, GRADE, FILL OR STORE MATERIALS ON PUBLIC PROPERTY OR PROPERTY REQUIRED TO BE DEDICATED, UNLESS SPECIFICALLY APPROVED BY THE CITY'S REPRESENTATIVE. THE DEVELOPER SHALL CLEAN UP, TOPSOIL, SEED AND MULCH ANY PUBLIC PROPERTY, WHICH IS DISTURBED. THE DEVELOPER SHALL GRADE, TOPSOIL, SEED AND MULCH ALL PUBLIC OR DEDICATED FRONTAGE AT A 4.1 SLOPE TO MEET EXISTING GRADE, UNLESS IT IS SPECIFIED OTHERWISE OR PERMITTED BY THE CITY'S REPRESENTATIVE. THE DEVELOPER SHALL PROVIDE AND INSTALL ANY EROSION CONTROL MEASURES REQUIRED ON PUBLIC PROPERTY OR PROPERTY TO BE DEDICATED DUE TO THE GRADING SPECIFIED IN THIS CONTRACT. SANITARY SEWER FACILITIES

A. THE DEVELOPER SHALL INSTALL SANITARY SEWER MAINS, SANITARY SEWER ACCESS STRUCTURES AND LATERALS TO SERVE ALL LOTS WITHIN THE DEVELOPMENT. NO CONSTRUCTION SHALL COMMENCE UNTIL PLANS AND SPECIFICATIONS HAVE BEEN APPROVED BY THE MADISON METROPOLITAN SEWERAGE DISTRICT AND THE STATE OF WISCONSIN DEPARTMENT

OF NATURAL RESOURCES. IN ADDITION TO THE OTHER APPROVALS REQUIRED BY THIS AGREEMENT

B. IN ACCORDANCE WITH WISCONSIN STATE STATUTE 182.0175(2R), ANY PERSON WHO, AFTER DECEMBER 31, 2006, INSTALLS A NONCONDUCTIVE SEWER LATERAL SHALL ALSO INSTALL A LOCATING WIRE OR OTHER EQUALLY EFFECTIVE MEANS FOR MARKING THE LOCATION OF THE LATERAL. THE CITY OF MADISON HAS CHOSEN COMPLIANCE WITH THIS STATUTE BY THE USING AN ELECTRONIC BALL MARKER SYSTEM. THEREFORE, THE DEVELOPER SHALL INSTALL THE 3MTM ELECTRONIC MARKER SYSTEM (EMS) 4" EXTENDED RANGE 5" BALL MARKERS-WASTEWATER (MODEL #1404-XR) FOR EACH SANITARY SEWER LATERAL. THE CITY SHALL SUPPLY ALL THE REQUIRED MARKERS TO THE DEVELOPER OR HIS CONTRACTOR (GENERALLY REQUIRES 2 PER ATERAL) AND THE CONTRACTOR SHALL INSTALL THEM PER THE MANUFACTURER'S REQUIREMENTS OR AS DIRECTED BY THE CITY ENGINEER. COSTS OF SUPPLYING THE BALL MARKERS SHALL BE BILLED TO THE DEVELOPER IN ACCORDANCE WITH THE BILLING TERMS OF THIS AGREEMENT. IF THE DEVELOPER WISHES TO USE ALTERNATE MEANS OF COMPLYING WITH THIS STATE STATUTE, IT MUST BE APPROVED IN ADVANCE BY THE CITY ENGINEER.

3. STORM SEWER AND PUBLIC DRAINAGE SYSTEM:

A. THE DEVELOPER SHALL INSTALL STORM SEWER SERVICE LATERALS TO SERVE THE DEVELOPMENT IN ACCORDANCE WITH THE PLANS APPROVED BY THE CITY ENGINEER UNLESS OTHER ARRANGEMENTS HAVE BEEN APPROVED BY THE CITY ENGINEER AS DETAILED IN THE SUPPLEMENTAL CONDITIONS. ANY FIELD CHANGES BY THE CITY ENGINEER SHALL BECOME PART OF THE APPROVED PLAN AND SHALL BE INCORPORATED AT THE DEVELOPER'S EXPENSE

B. IN ACCORDANCE WITH WISCONSIN STATE STATUTE 182.0175(2R), ANY PERSON WHO. AFTER DECEMBER 31, 2006, INSTALLS A NONCONDUCTIVE SEWER LATERAL SHALL ALSO INSTALL A LOCATING WIRE OR OTHER EQUALLY EFFECTIVE MEANS FOR MARKING THE LOCATION OF THE ATERAL. THE CITY OF MADISON HAS CHOSEN COMPLIANCE WITH THIS STATUTE BY THE US. AN ELECTRONIC BALL MARKER SYSTEM. THEREFORE, THE DEVELOPER SHALL INSTALL THE 3MTM ELECTRONIC MARKER SYSTEM (EMS) 4" EXTENDED RANGE 5' BALL MARKERS- WASTEWATER (MODEL #1404-XR) FOR EACH STORM SEWER LATERAL. THE STORM SEWER ELECTRONIC MARKERS SHALL BE PROVIDED WHERE NON-METALLIC STORM SEWER PIPE IS INSTALLED IN THE PUBLIC RIGHT OF WAY, AND WHERE NO ACCESS OR INLET STRUCTURES ARE AVAILABLE ON THE SURFACE TO ALLOW THE PIPE TO BE VISUALLY LOCATED. CITY SHALL SUPPLY ALL THE REQUIRED MARKERS TO THE DEVELOPER OR HIS CONTRACTOR (GENERALLY REQUIRES 2 PER LATERAL) AND THE CONTRACTOR SHALL INSTALL THEM PER THE MANUFACTURER'S REQUIREMENTS OR AS DIRECTED BY THE CITY ENGINEER. COSTS OF SUPPLYING THE BALL MARKERS SHALL BE BILLED TO THE DEVELOPER IN ACCORDANCE WITH THE BILLING TERMS OF THIS AGREEMENT. IF THE DEVELOPER WISHES TO USE ALTERNATE MEANS OF COMPLYING WITH THIS STATE STATUTE, IT MUST BE APPROVED IN ADVANCE BY THE CITY ENGINEER.

4. WATER MAINS AND WATER SERVICE LATERALS: A. THE DEVELOPER SHALL INSTALL WATER SERVICE LATERALS TO SERVE THE DEVELOPMENT. ALL

WATER SERVICE LATERALS TWO (2) INCHES IN DIAMETER AND SMALLER SHALL BE COMPLETED WITH A CURB STOP AND BOX. ALL WATER SERVICE LATERALS THREE (3) INCHES AND LARGER SHALL BE COMPLETED WITH A CONTROLLING VALVE BOX. ALL MATERIALS USED SHALL CONFORM TO CITY OF MADISON STANDARD SPECIFICATIONS FOR PUBLIC WORKS CONSTRUCTION. 5. STREETS AND SIDEWALKS:

A. THE DEVELOPER SHALL INSTALL (OR REPLACE SIDEWALK THAT IS DAMAGED WITH) MADISON STANDARD SIDEWALK WITH MADISON STANDARD CROSSWALKS ON ALL STREETS ABUTTING THE DEVELOPMENT (ON THE ONE SIDE OF THE STREET ABUTTING THE DEVELOPMENT).

B. THE DEVELOPER SHALL COMPLETE RESTORATION OF STREET IMPROVEMENTS PER PLANS

C. THE DEVELOPER SHALL COMPLY WITH ALL PROVISIONS AS OUTLINED IN THE CITY OF MADISON STANDARDS FOR PUBLIC WORKS CONSTRUCTION. THE DEVELOPER OR HIS AGENT SHALL CONTACT CITY FORESTRY TO REVIEW THE TREES PRIOR TO ANY TRIMMING OR REMOVAL. PRIOR TO THE CLOSURE OF THIS CONTRACT CITY FORESTRY SHALL DO A FINAL INSPECTION OF THE TREES. A TREE REMOVAL PERMIT SHALL BE ISSUED BY CITY FORESTRY PRIOR TO REMOVAL OF ANY CITY OWNED

6. RUNOFF CONTROL STRUCTURES:

APPROVED BY THE CITY ENGINEER.

THE DEVELOPER SHALL INSTALL THE RUNOFF CONTROL STRUCTURES INCLUDING RELATED STORM SEWERS REQUIRED BY THE EROSION CONTROL AND STORMWATER MANAGEMENT PERMIT AND THE PLANS AND SPECIFICATIONS APPROVED BY THE CITY ENGINEER. 7. SECTION CORNERS:

ALL PLSS SECTION AND WITNESS CORNERS (INCLUDING CENTER OF SECTIONS) SITUATED WITHIN THE SUBDIVISION, OR WITHIN PLANNED IMPROVEMENT AREAS FOR THE DEVELOPMENT THEREOF, MUST BE INCLUDED IN FINAL SURVEY DATA TRANSMITTAL. ANY PLSS SECTION AND/OR WITNESS CORNERS, INCLUDING CENTER OF SECTIONS, MUST BE PERPETUATED BY THE DEVELOPER'S CONTRACTED PROFESSIONAL LAND SURVEYOR. IN THE EVENT ANY PLSS SECTION CORNER, INCLUDING CENTER OF SECTIONS, ARE DISTURBED OR DESTROYED AS A RESULT OF ANY FORM OF CONSTRUCTION INCLUDED IN THE PRIVATE CONTRACT AND PRIVATE CONSTRUCTION ASSOCIATED WITH THIS SUBDIVISION DEVELOPMENT, THE PLSS RESTORATION MUST BE COMPLETED BY THE DEVELOPER'S CONTRACTED PROFESSIONAL LAND SURVEYOR, AT THE SOLE COST OF THE DEVELOPER. NEW PLSS TIE SHEETS MUST BE FILED BY THE CONTRACTED PROFESSIONAL LAND SURVEYOR IN ACCORDANCE WITH WISCONSIN ADMINISTRATIVE CODE

THE DEVELOPER SHALL PAY ALL COSTS ASSOCIATED WITH THE INSTALLATION OF ALL TRAFFIC SIGNS AND STRUCTURES AS REQUIRED BY THE PLANS AND SPECIFICATIONS PREPARED BY THE CITY TRAFFIC ENGINEERING DIVISION, INCLUDING CITY FURNISHED MATERIALS, LABOR, INSPECTION AND ENGINEERING. THE DEVELOPER FOLLOWING THE PROVISIONS IN THE STANDARD SPECIFICATIONS FOR PUBLIC WORKS CONSTRUCTION MAY INSTALL TEMPORARY STREET NAME SIGNS. PAVEMENT MARKINGS:

THE DEVELOPER SHALL PAY ALL COSTS ASSOCIATED WITH THE INSTALLATION AND RESTORATION OF ALL PAVEMENT MARKINGS AS REQUIRED BY THE PLANS AND SPECIFICATIONS PREPARED BY THE CITY TRAFFIC ENGINEERING DIVISION, INCLUDING CITY FURNISHED MATERIALS, LABOR, INSPECTION, AND ENGINEERING. 10. STREET LIGHTS:


THE DEVELOPER SHALL PAY ALL COSTS ASSOCIATED WITH THE INSTALLATION OF STREET LIGHTING, CONDUIT

ENGINEERING. THE DEVELOPER SHALL INSTALL STREET LIGHTING FACILITIES PER THE CITY-PREPARED PLANS AND SPECIFICATIONS. THE DEVELOPER SHALL CONTACT AND COORDINATE THE INSTALLATION OF WIRING AND SERVICE FOR THE STREET LIGHTS WITH THE ENERGY UTILITY COMPANY PROVIDING POWER TO THE LIGHTS. THE DEVELOPER SHALL PAY ALL UTILITY COSTS ASSOCIATED WITH THE STREET LIGHT SERVICE DIRECTLY TO THE UTILITY.

AND STRUCTURES AS REQUIRED BY THE PLANS AND SPECIFICATIONS PREPARED BY THE CITY TRAFFIC

ENGINEERING DIVISION INCLUDING CITY FURNISHED MATERIALS. LABOR. INSPECTION AND

11. TRAFFIC SIGNALS: THE DEVELOPER SHALL PAY ALL COSTS ASSOCIATED WITH THE INSTALLATION OF TRAFFIC SIGNALS, CONDUIT, STRUCTURES AND RELATED EQUIPMENT AS REQUIRED BY THE PLANS AND SPECIFICATIONS PREPARED BY THE CITY TRAFFIC ENGINEERING DIVISION INCLUDING CITY FURNISHED MATERIALS, LABOR, INSPECTION, AND ENGINEERING. THE DEVELOPER SHALL INSTALL TRAFFIC SIGNAL FACILITIES PER THE CITY-PREPARED PLANS AND SPECIFICATIONS.

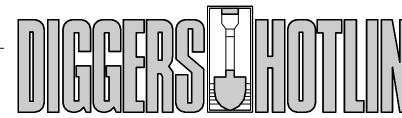

CALL TOLL FREE 1-800-242-8511 MILWAUKEE AREA 414-259-1181 FAX A LOCATE 1-800-338-3860 TDD (HEARING IMPAIRED) 1-800-542-2289 ONLINE: www.DiggersHotline.com WISCONSIN STATUE 182.0175 (1974) REQUIRES A MINIMUM OF THREE (3) WORKING DAYS NOTICE PRIOR TO EXCAVATION.

	SITE SYMBOL LEGEND
<b>+</b>	SIGN
<u> </u>	BOLLARD
Д	FIRE HYDRANT
0	MANHOLE/CATCH BASIN/INLET
	CURB INLET
	NEW FLARED END SECTION WITH RIPRAP AND GUARD
TP XXX.XX E  SW XXX.XX E  FG XXX.XX E	NEW EDGE OF PAVEMENT ELEVATION (FEET) NEW TOP OF PAVEMENT ELEVATION (FEET) NEW SIDEWALK ELEVATION (FEET) NEW FINISH GRADE ELEVATION (FEET) NEW FINISH GRADE ELEVATION (FEET) NEW MATCH EX. ELEVATION (FEET) NEW MATCH EX. ELEVATION (FEET)
RE / IE XXX.XX	RIM OR INVERT ELEVATION (FEET)
$\otimes$	WATER VALVE OR GAS VALVE
	GAS METER
XO 8	LIGHT POLE
<del>-</del>	UTILITY POLE
>	GUY WIRE
TR	TRANSFORMER
E CT	ELECTRIC METER AND CT CABINET
	NEW STRUCTURE OR ADDITION

EXISTING STRUCTURE

EXISTING STRUCTURE	
L SYMBOLS MAY NOT BE USED IN THIS SET.	
SITE LINE L	EGEND
	PROPERTY LINE
	SETBACK LINE
	EASEMENT LINE
	EXISTING INTERMEDIATE CONTOUR
	EXISTING INDEX CONTOUR
XXX	NEW INTERMEDIATE CONTOUR
-XXX	NEW INDEX CONTOUR
	PAVEMENT
х х	FENCE
SDSD	STORM DRAIN
	SANITARY SEWER
www	WATER
	GAS
P — P — P — P	ELECTRICAL POWER
PU——PU——PU——	UNDERGROUND ELECTRICAL POWER
FOU——FOU—	UNDERGROUND FIBER OPTIC
т — т — т — т —	TELEPHONE
TUTUTU	UNDERGROUND TELEPHONE
	CABLE
	İ

EDGE OF TREES OR SHRUBS

ALL SYMBOLS MAY NOT BE USED IN THIS SET.

ANGUS-YOUNG ARCHITECTS/ENGINEERS Janesville | Madison

> RWW 4605 SPRECHER LLC

SPRECHER AND MILWAUKEE DEVELOPMENT

> 102 S. SPRECHER ROAD MADISON, WI

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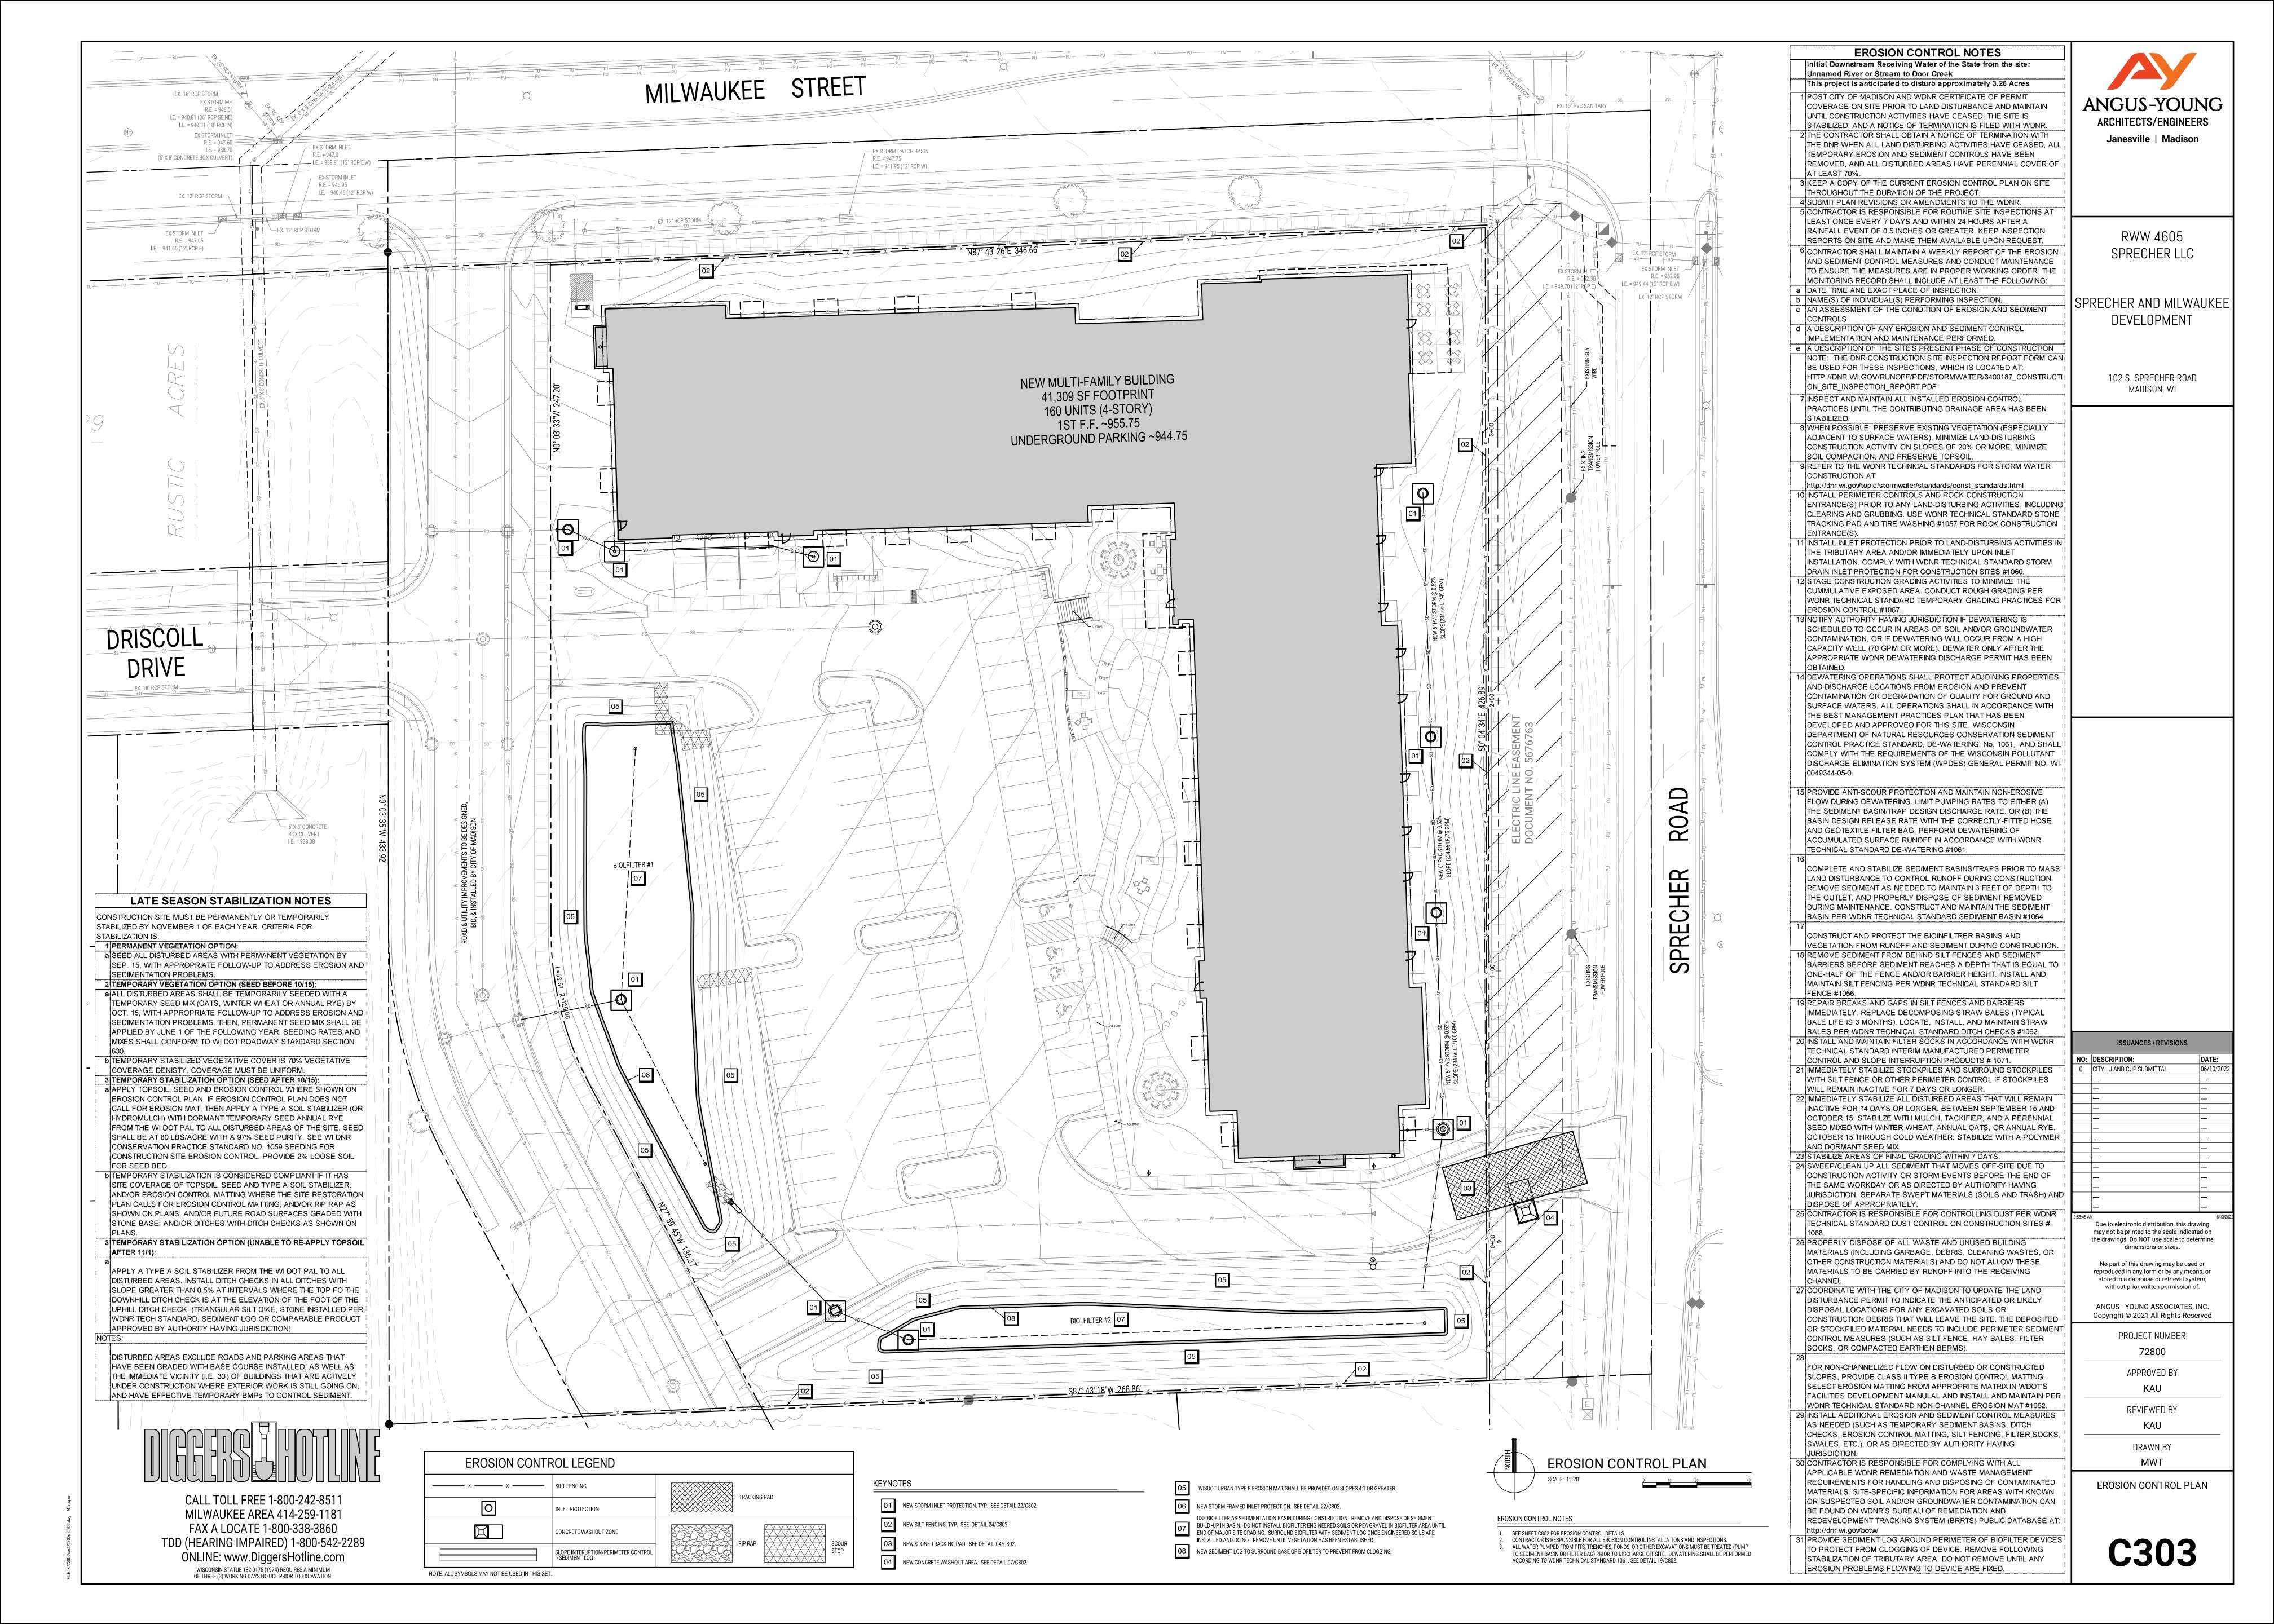
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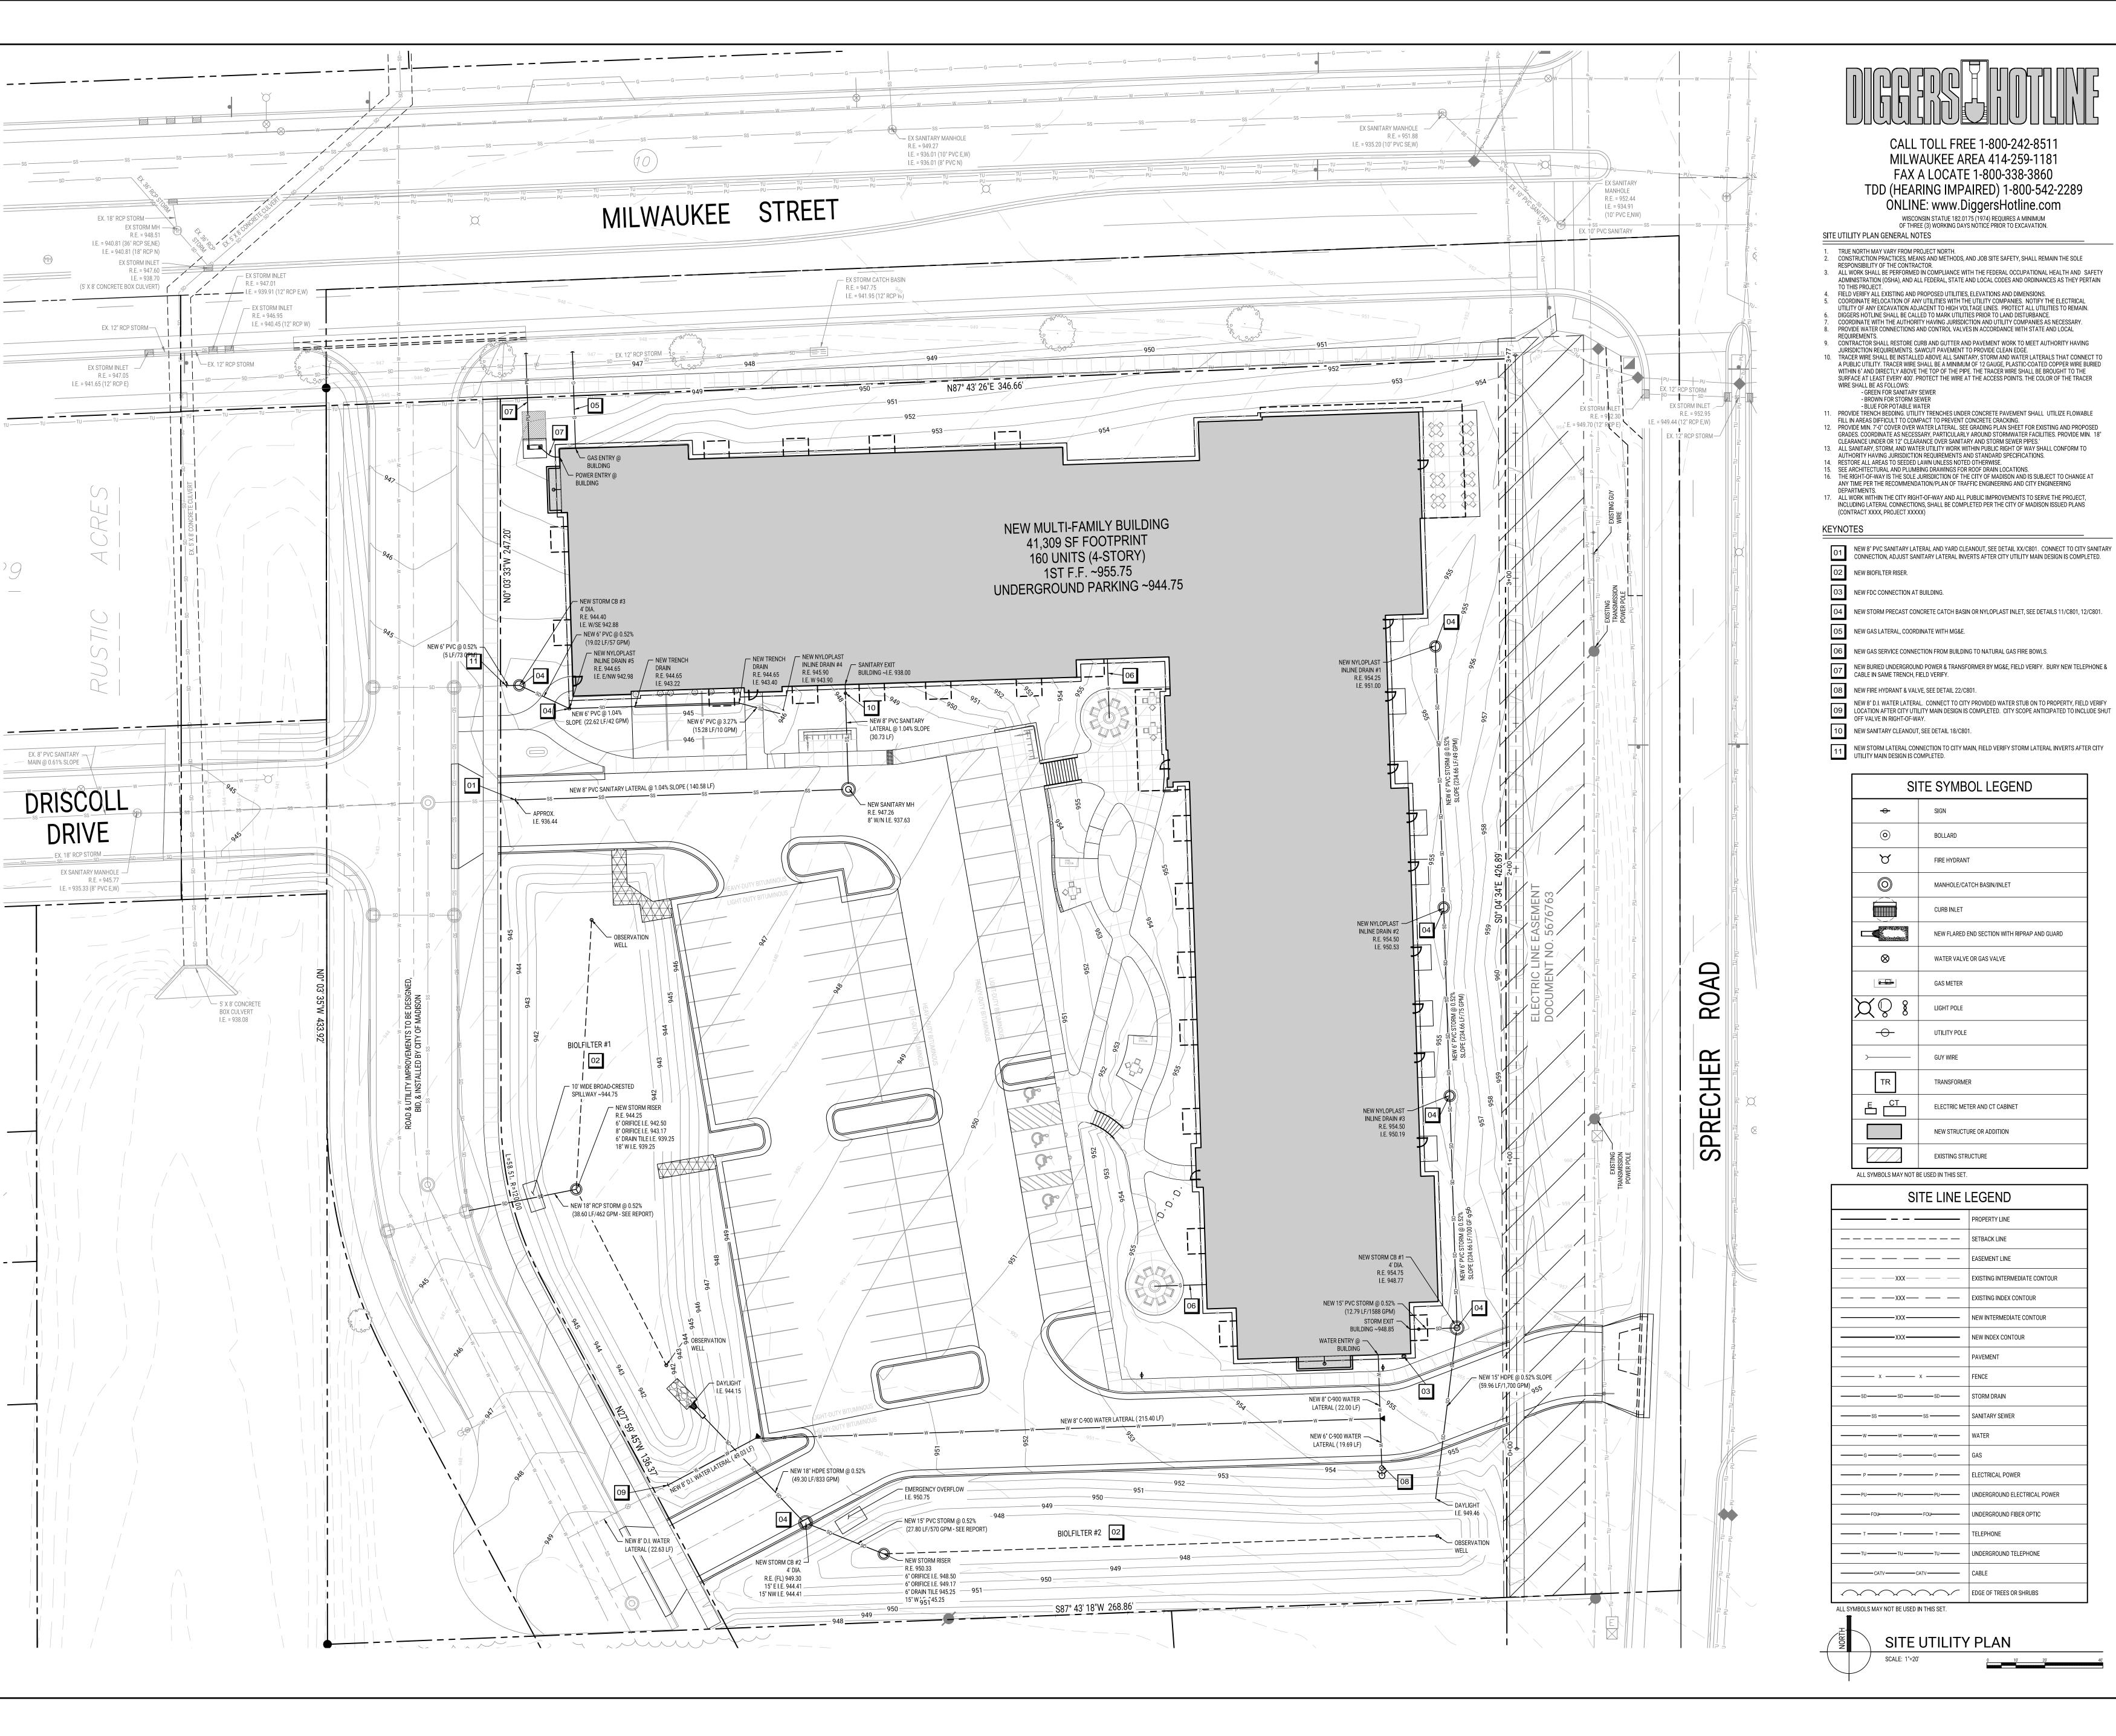
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ENLARGED GRADING PLAN

APPROVED BY

MWT





ANGUS-YOUNG
ARCHITECTS/ENGINEERS
Janesville | Madison

RWW 4605 SPRECHER LLC

SPRECHER AND MILWAUKEE DEVELOPMENT

102 S. SPRECHER ROAD

MADISON, WI

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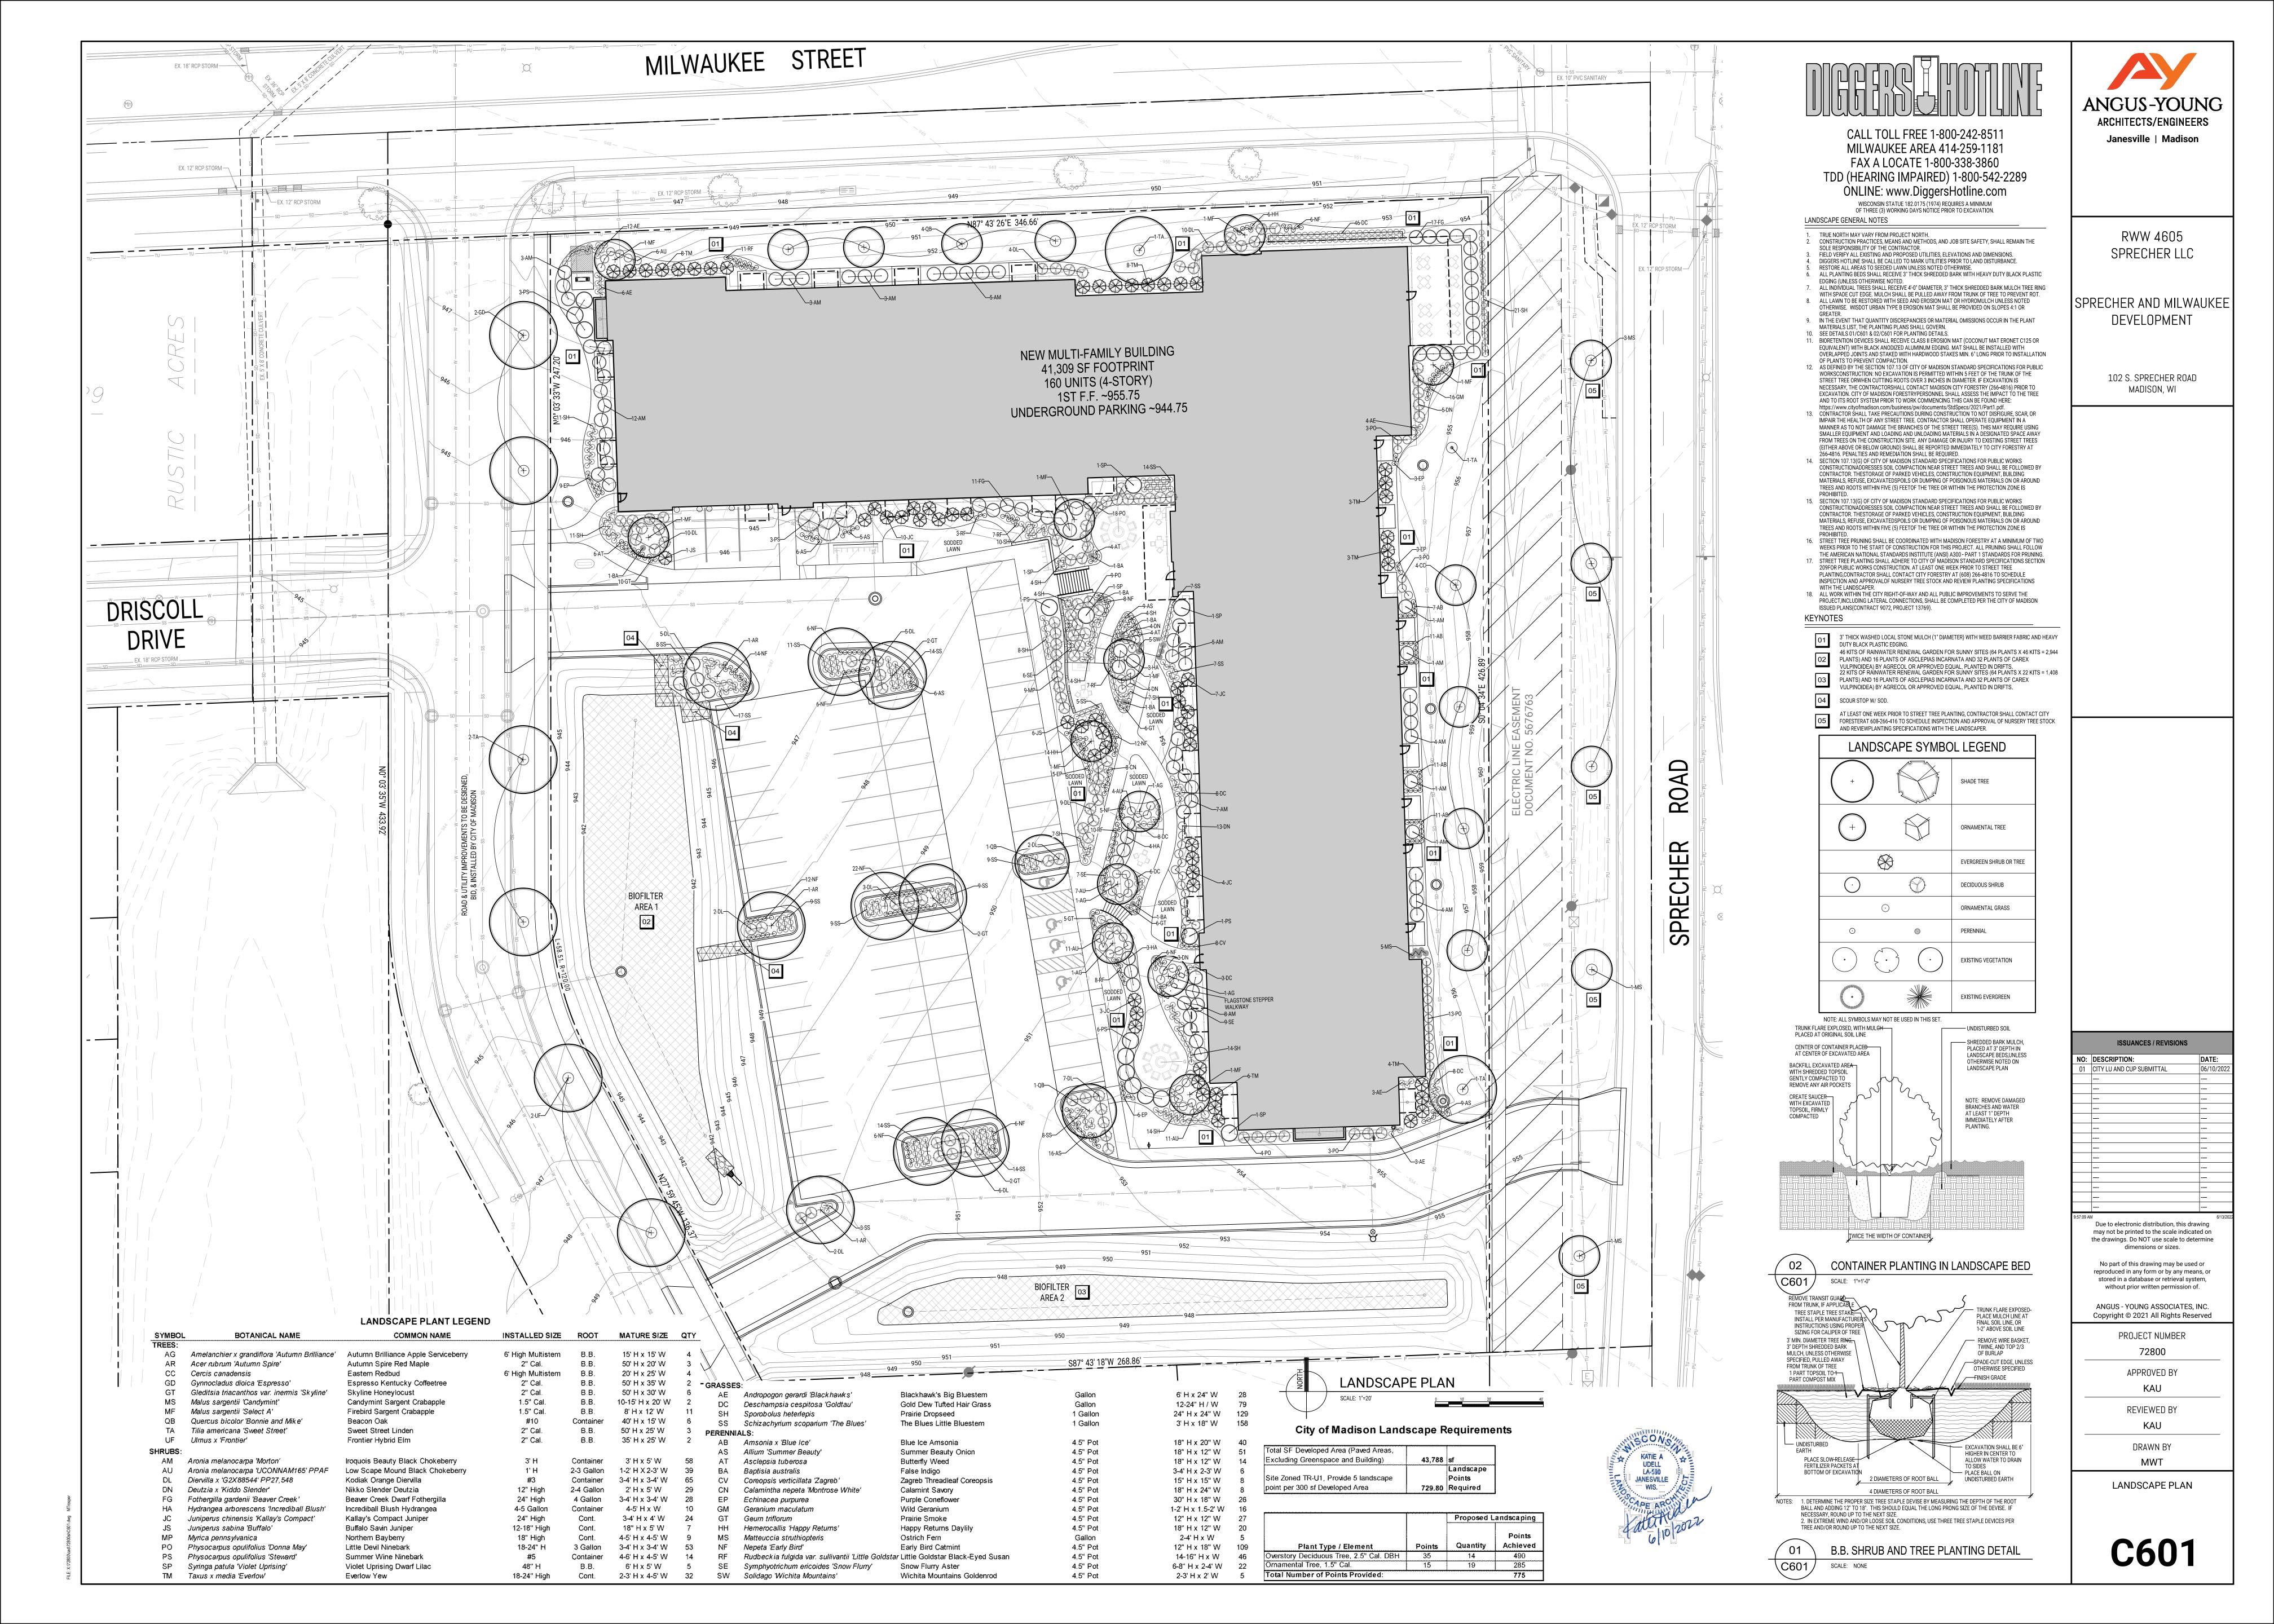
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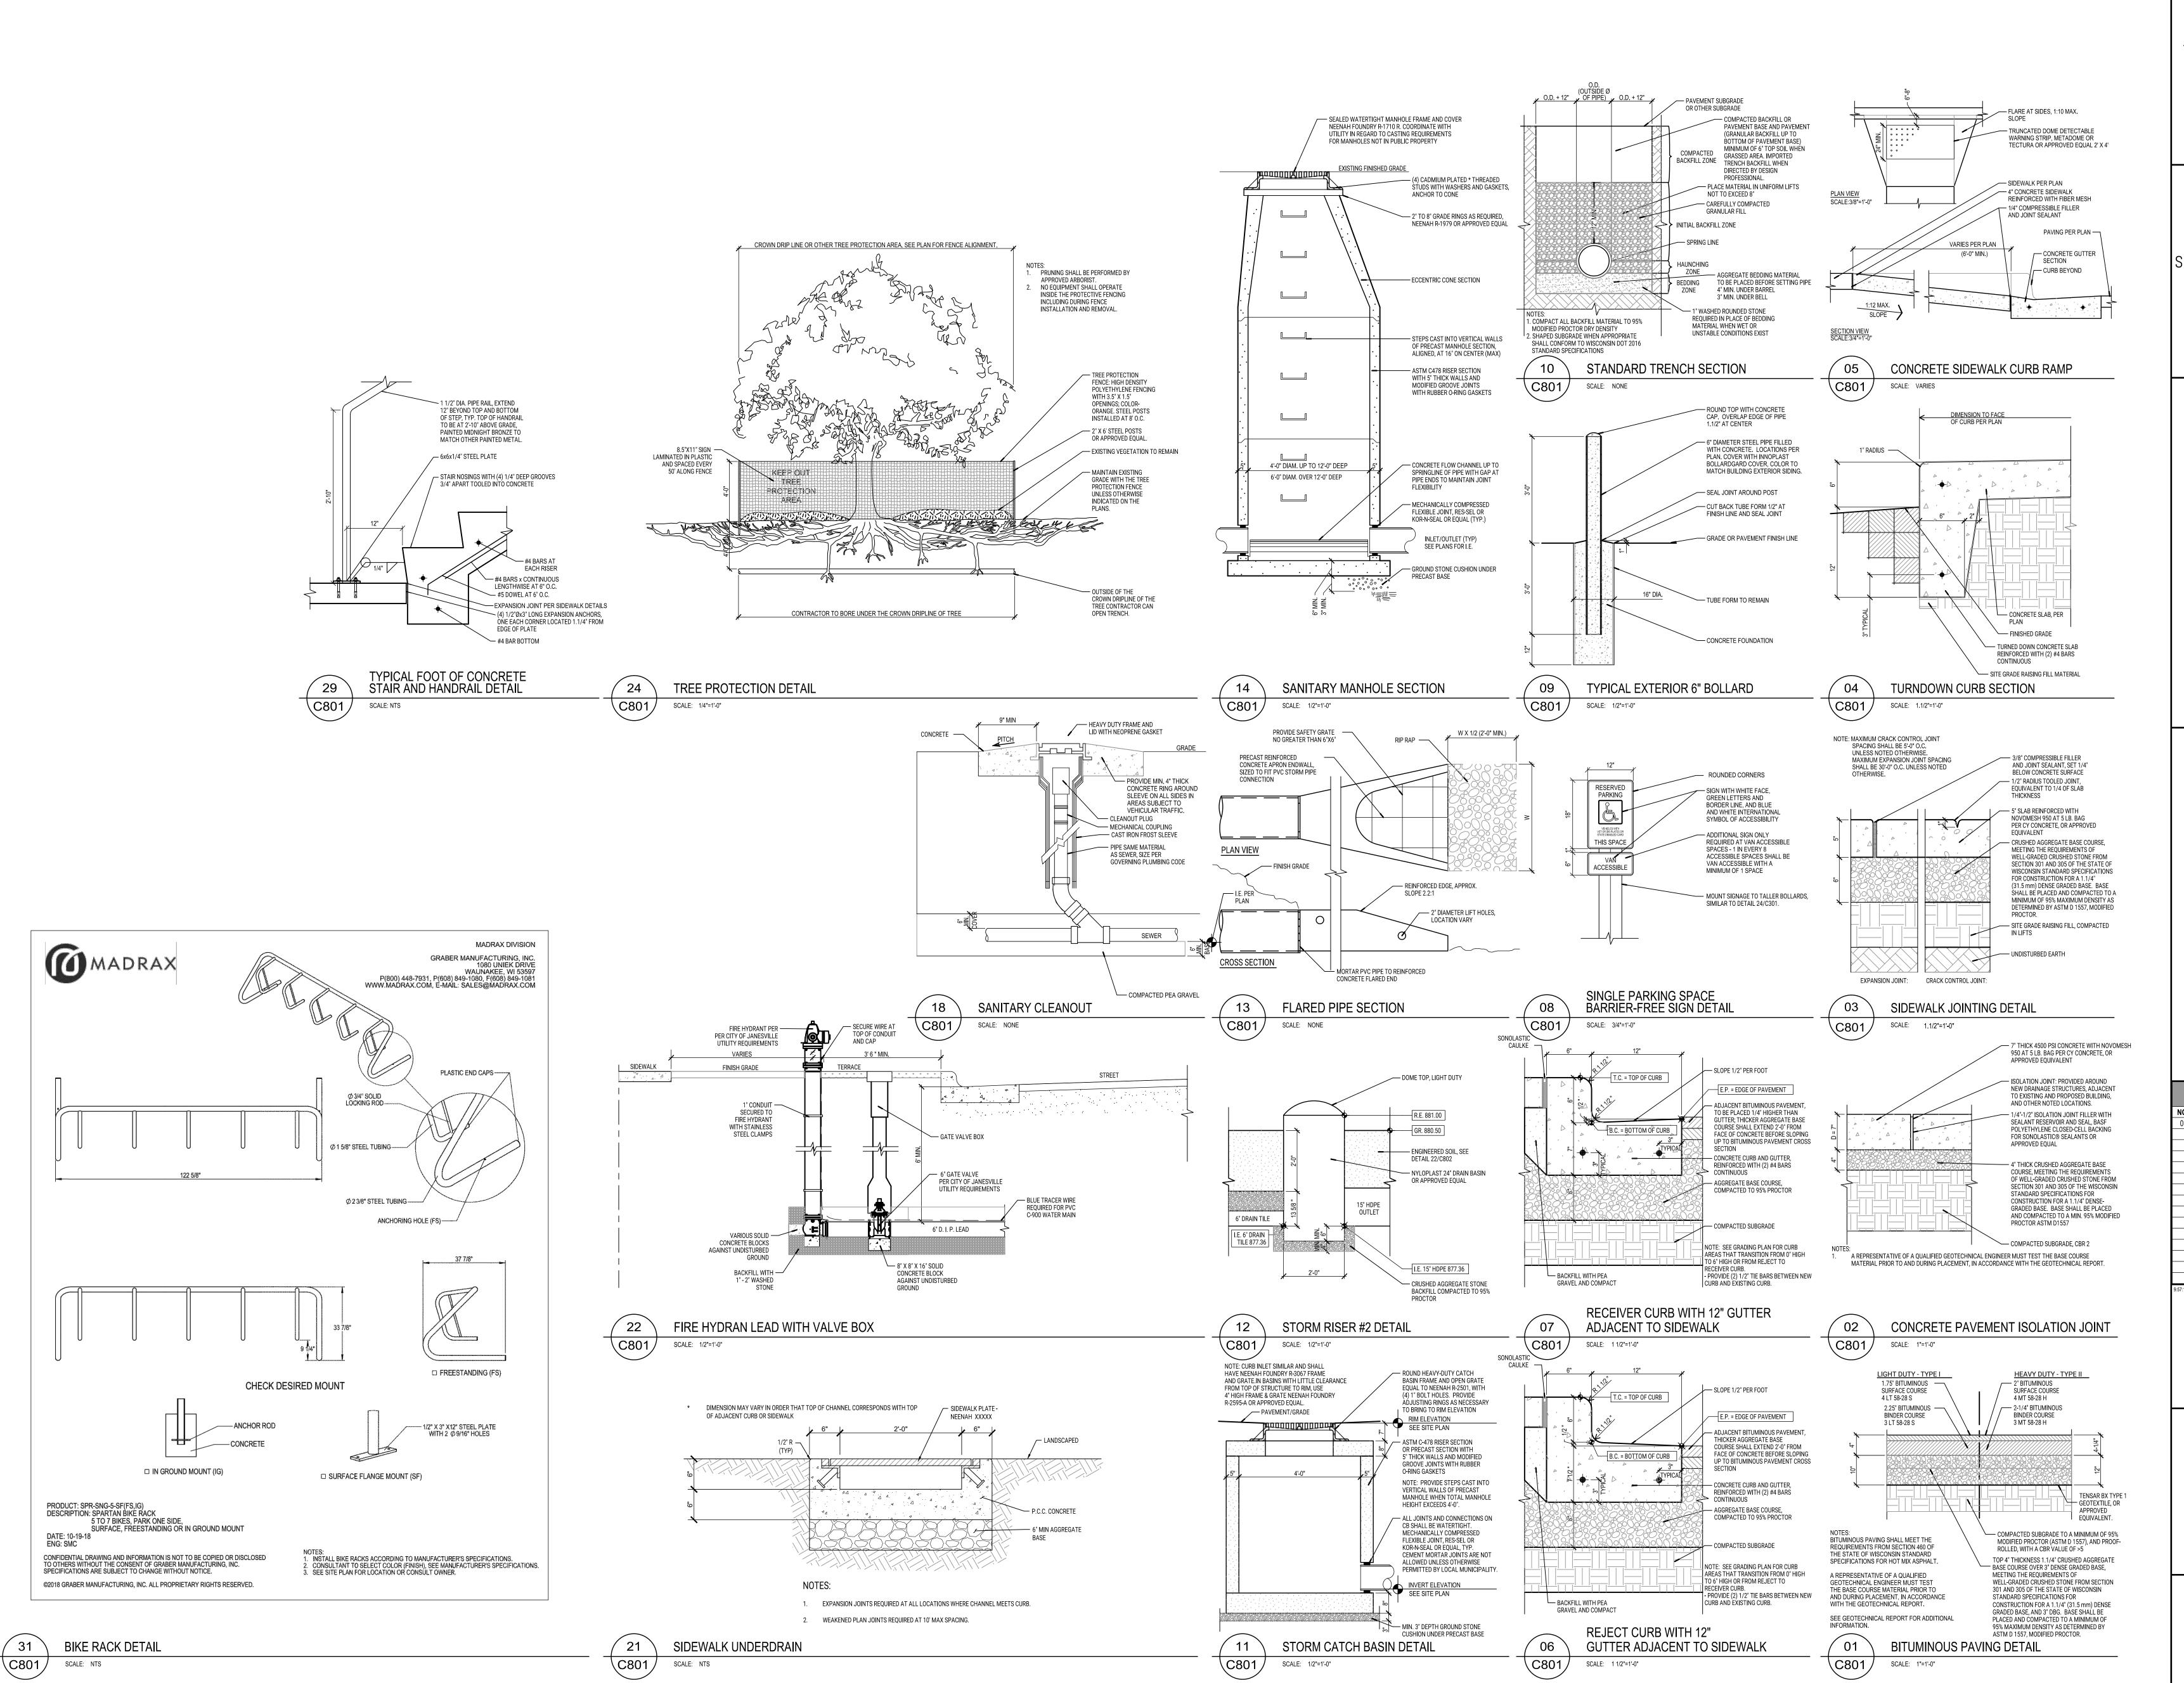
REVIEWED BY

DRAWN BY **MWT** 

SITE UTILITY PLAN

C401





ANGUS-YOUNG
ARCHITECTS/ENGINEERS
Janesville | Madison

RWW 4605 SPRECHER LLC

SPRECHER AND MILWAUKEE
DEVELOPMENT

102 S. SPRECHER ROAD MADISON, WI

ISSUANCES / REVISIONS

NO: DESCRIPTION: 06/10/2022

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SITE DETAILS

DRAWN BY

MWT

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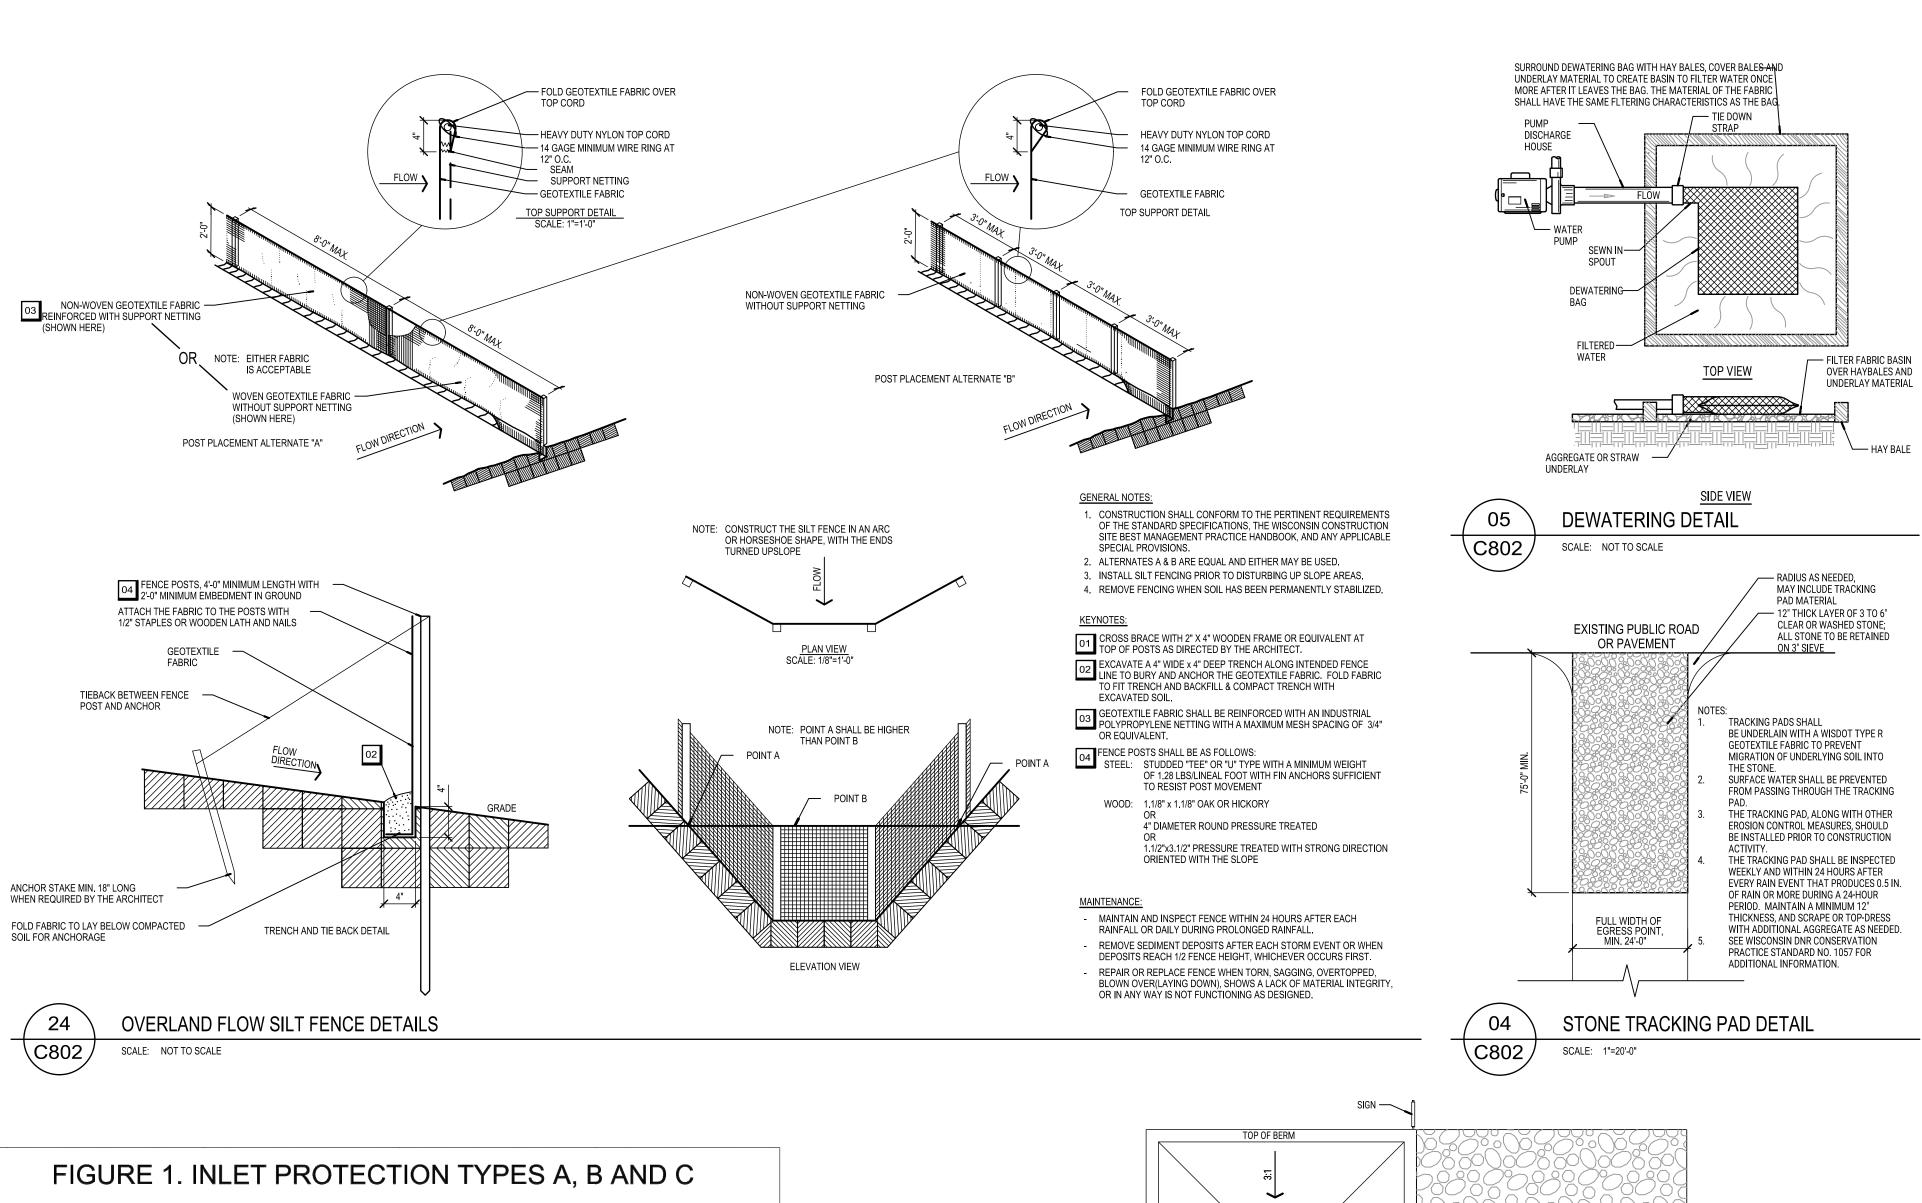
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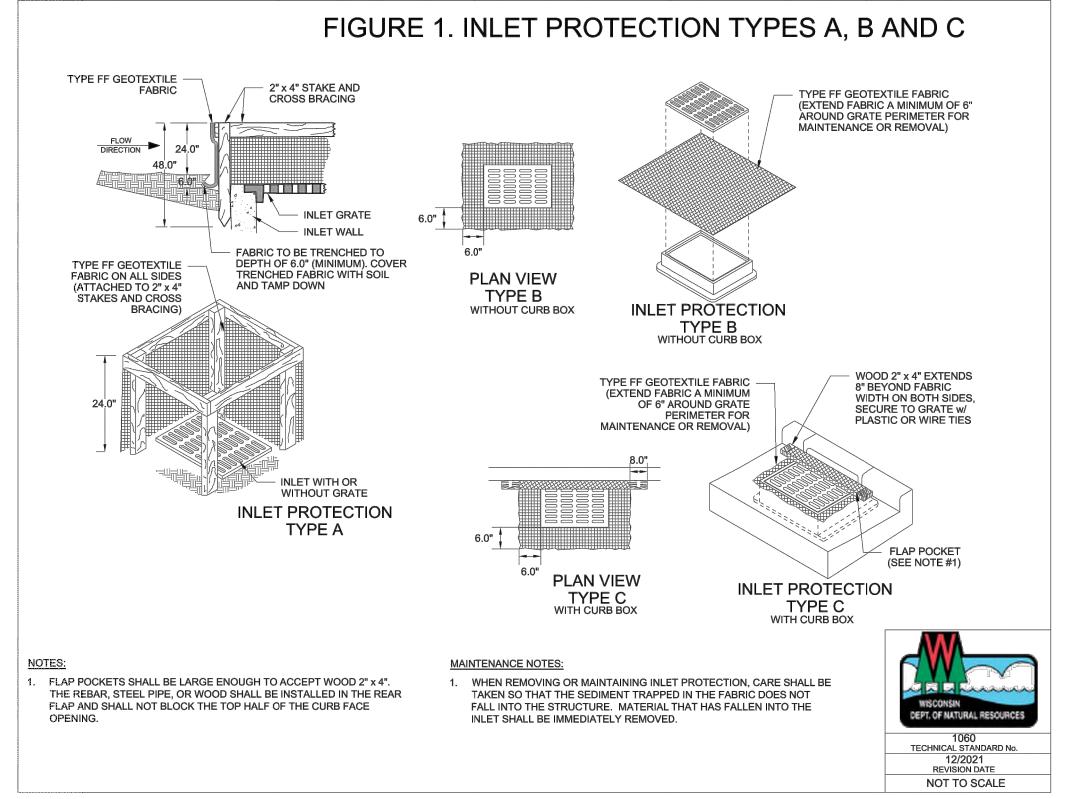
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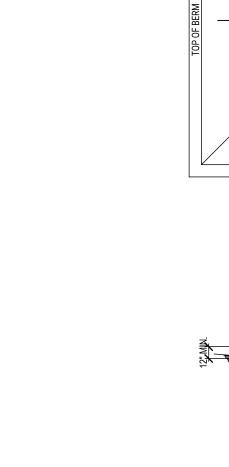
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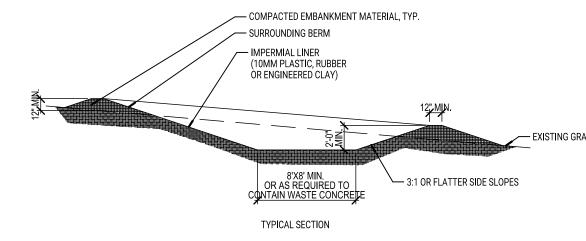




STORM DRAIN INLET PROTECTION - TYPES A, B, AND C

SCALE: N/A





VEHICLE TRACKING PAD

CONCRETE WASHOUT AREA INSTALLATION NOTES

SEE EROSION CONTROL PLAN FOR LOCATIONS OF CONCRETE WASHOUT AREA(S). TO BE PLACED A MIN. OF 50' FROM DRAINAGEWAYS, BODIES OF WATER, AND INLETS.
THE CONCRETE WASHOUT AREA(S) SHALL BE INSTALLED PRIOR TO ANY CONCRETE PLACEMENT

ON SITE.

VEHICLE TRACKING CONTROL PAD IS REQ'D AT THE ACCESS POINT(S).

SIGNS SHALL BE PLACED AT THE CONSTRUCTION ENTRANCE, AT THE WASHOUT AREA(S), AND ELSEWHERE AS NECESSARY TO CLEARLY INDICATE THE LOCATION OF THE CONCRETE WASHOUT

CONCRETE WASHOUT AREA MAINTENANCE NOTES

WHEN CONCRETE WASHOUT AREA(S) IS REMOVED, THE DISTURBED AREA SHALL BE STABILIZED PER SITE EROSION CONTROL MEASURES.

CONCRETE WASHOUT AREA ∖C802*∫* SCALE: NOT TO SCALE



TYPICAL PLAN


AREAS TO OPERATORS OF CONCRETE TRUCKS AND PUMP RIGS.

5. EXCAVATED MATERIAL SHALL BE UTILIZED IN PERIMETER BERM CONSTRUCTION.

THE CONCRETE WASHOUT AREA WASHOUT AREA SHALL BE REPAIRED AND ENLARGED OR CLEANED OUT AS NECESSARY TO MAINTAIN CAPACITY FOR WASTED CONCRETE.

THE END OF CONSTRUCTION, ALL CONCRETE SHALL BE REMOVED FROM SITE AND DISPOSED OF AT AN APPROVED WASTE SITE.

9. INSPECT WEEKLY AND DURING AND AFTER ALL STORM EVENTS. CLEAN-OUT OR COVER WASHOUT AREA PRIOR TO PREDICTED STORM EVENTS TO PREVENT OVER-FLOW.

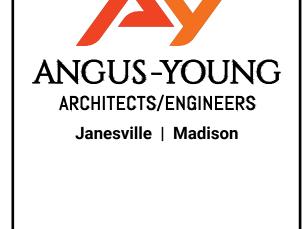

RWW 4605 SPRECHER LLC

SPRECHER AND MILWAUKEE DEVELOPMENT

> 102 S. SPRECHER ROAD MADISON, WI


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APPROVED BY

REVIEWED BY

DRAWN BY

SITE DETAILS

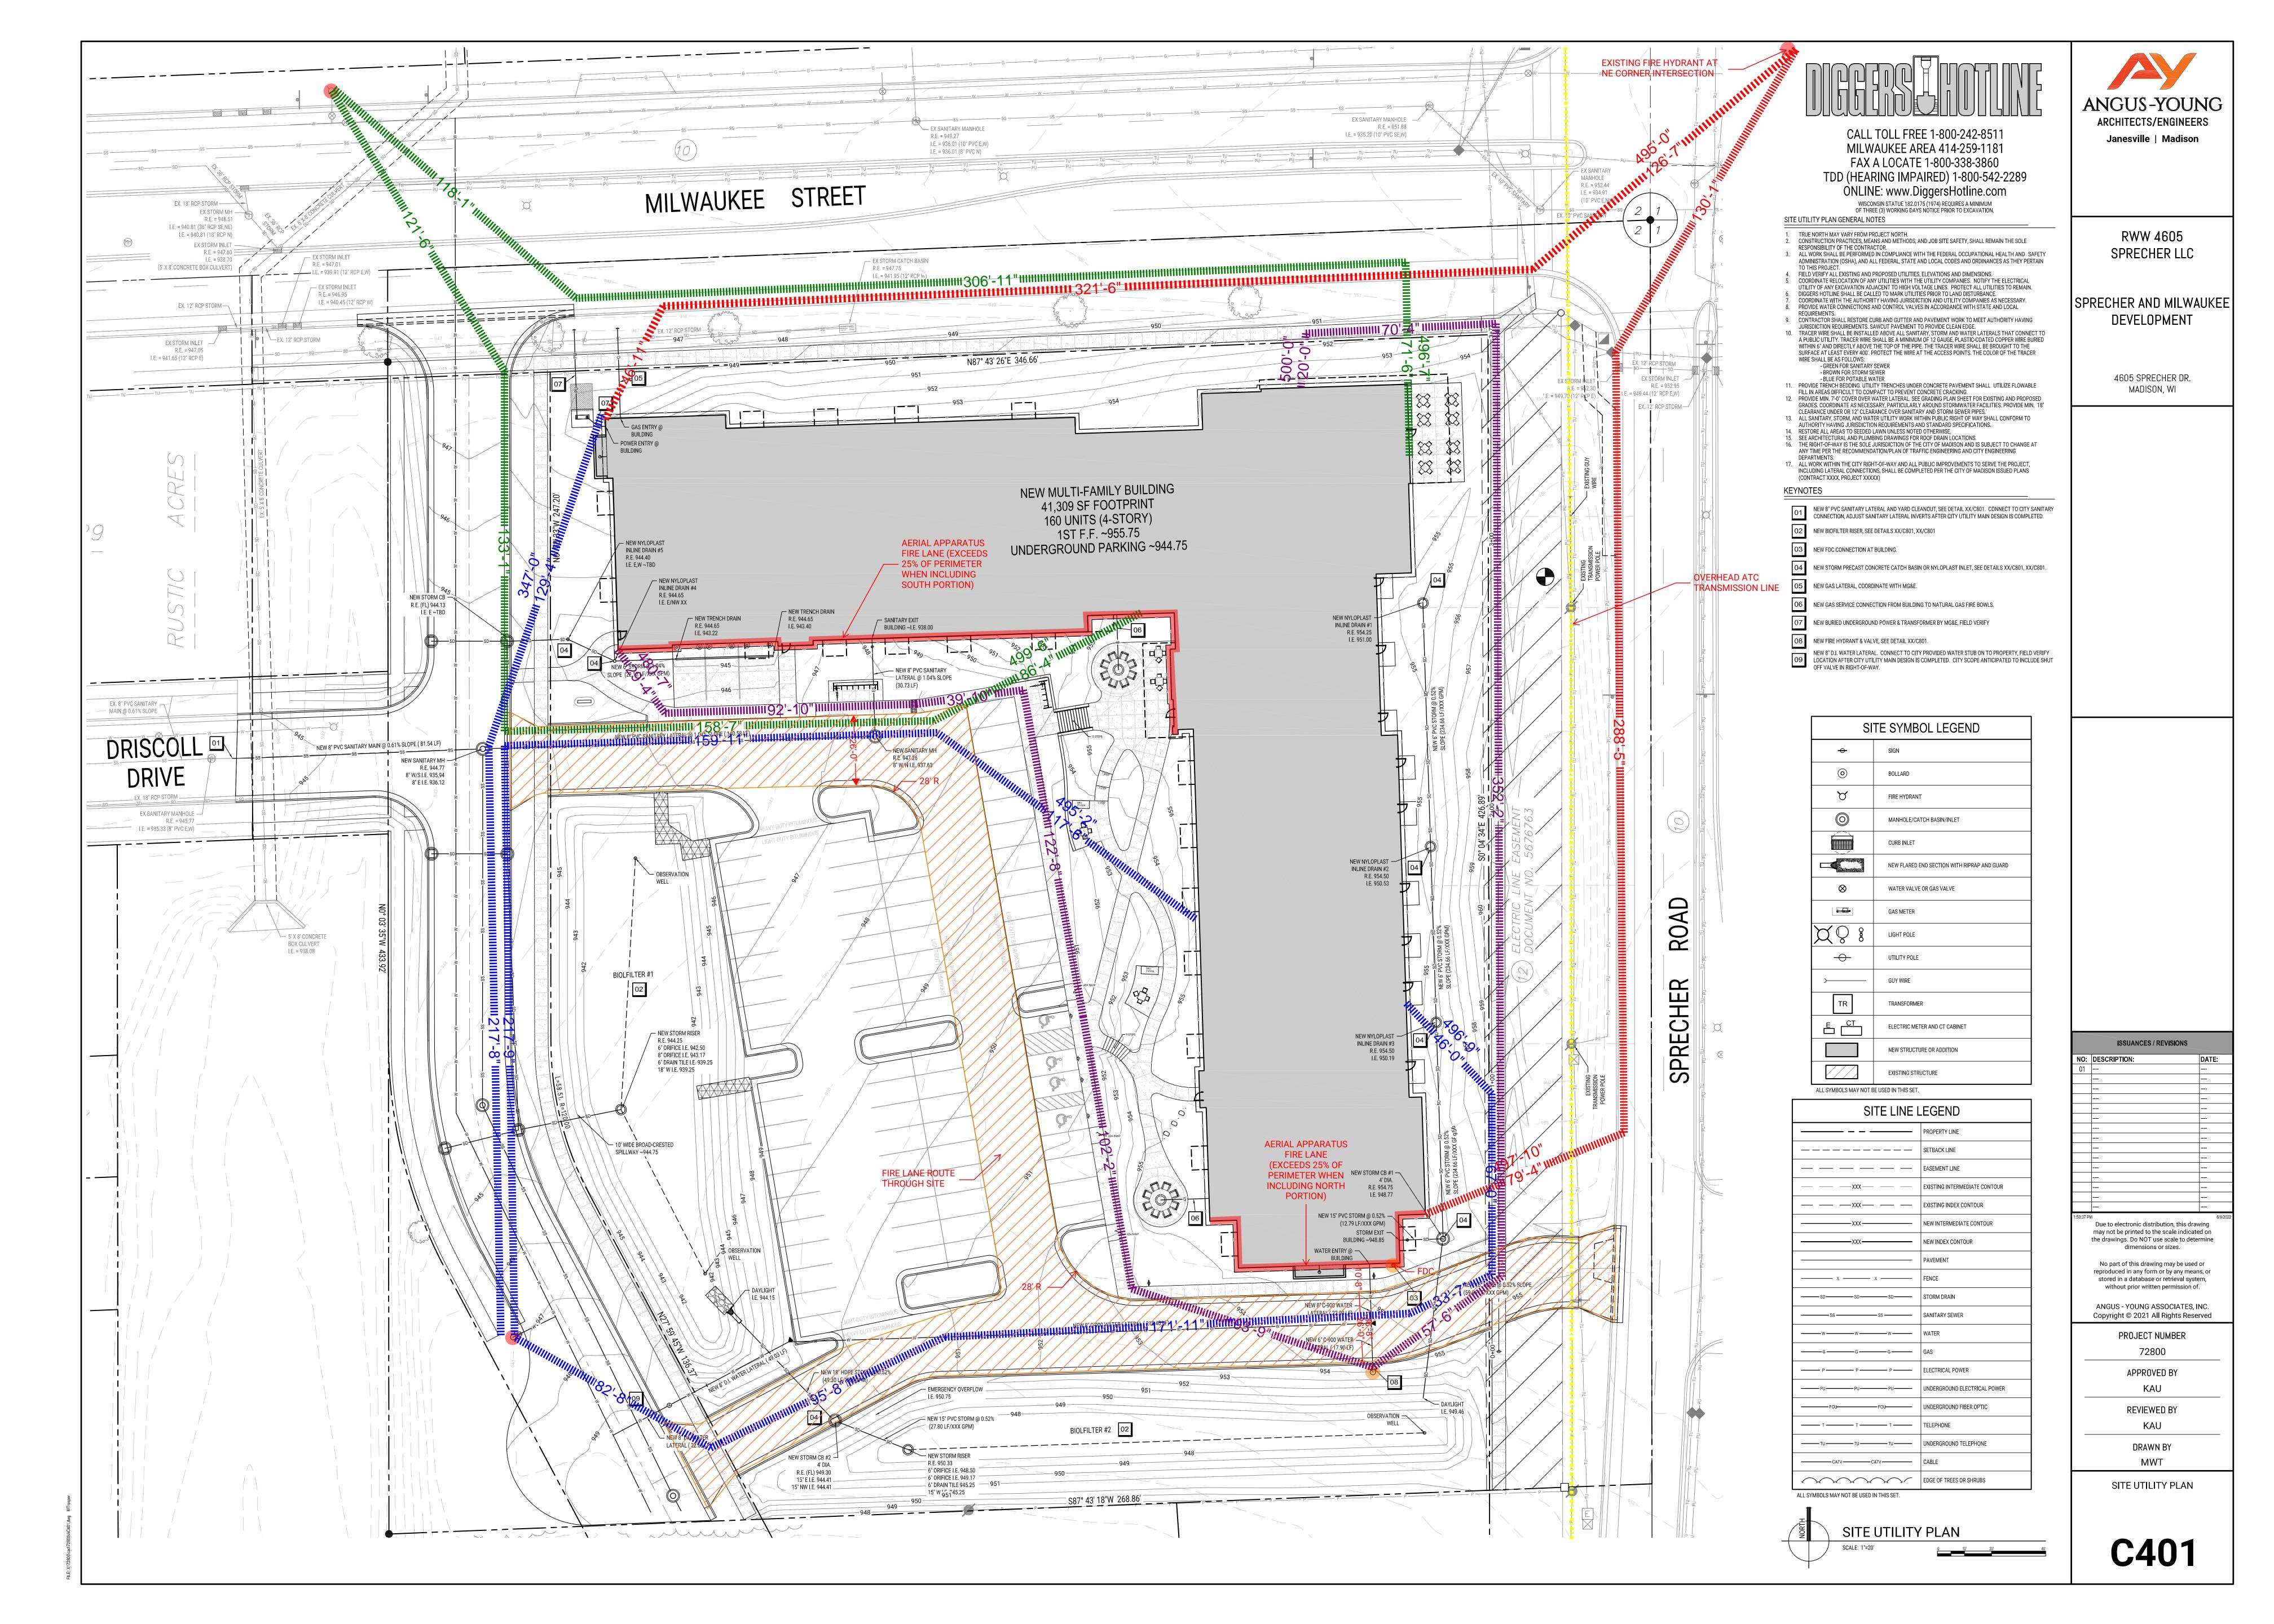


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A100

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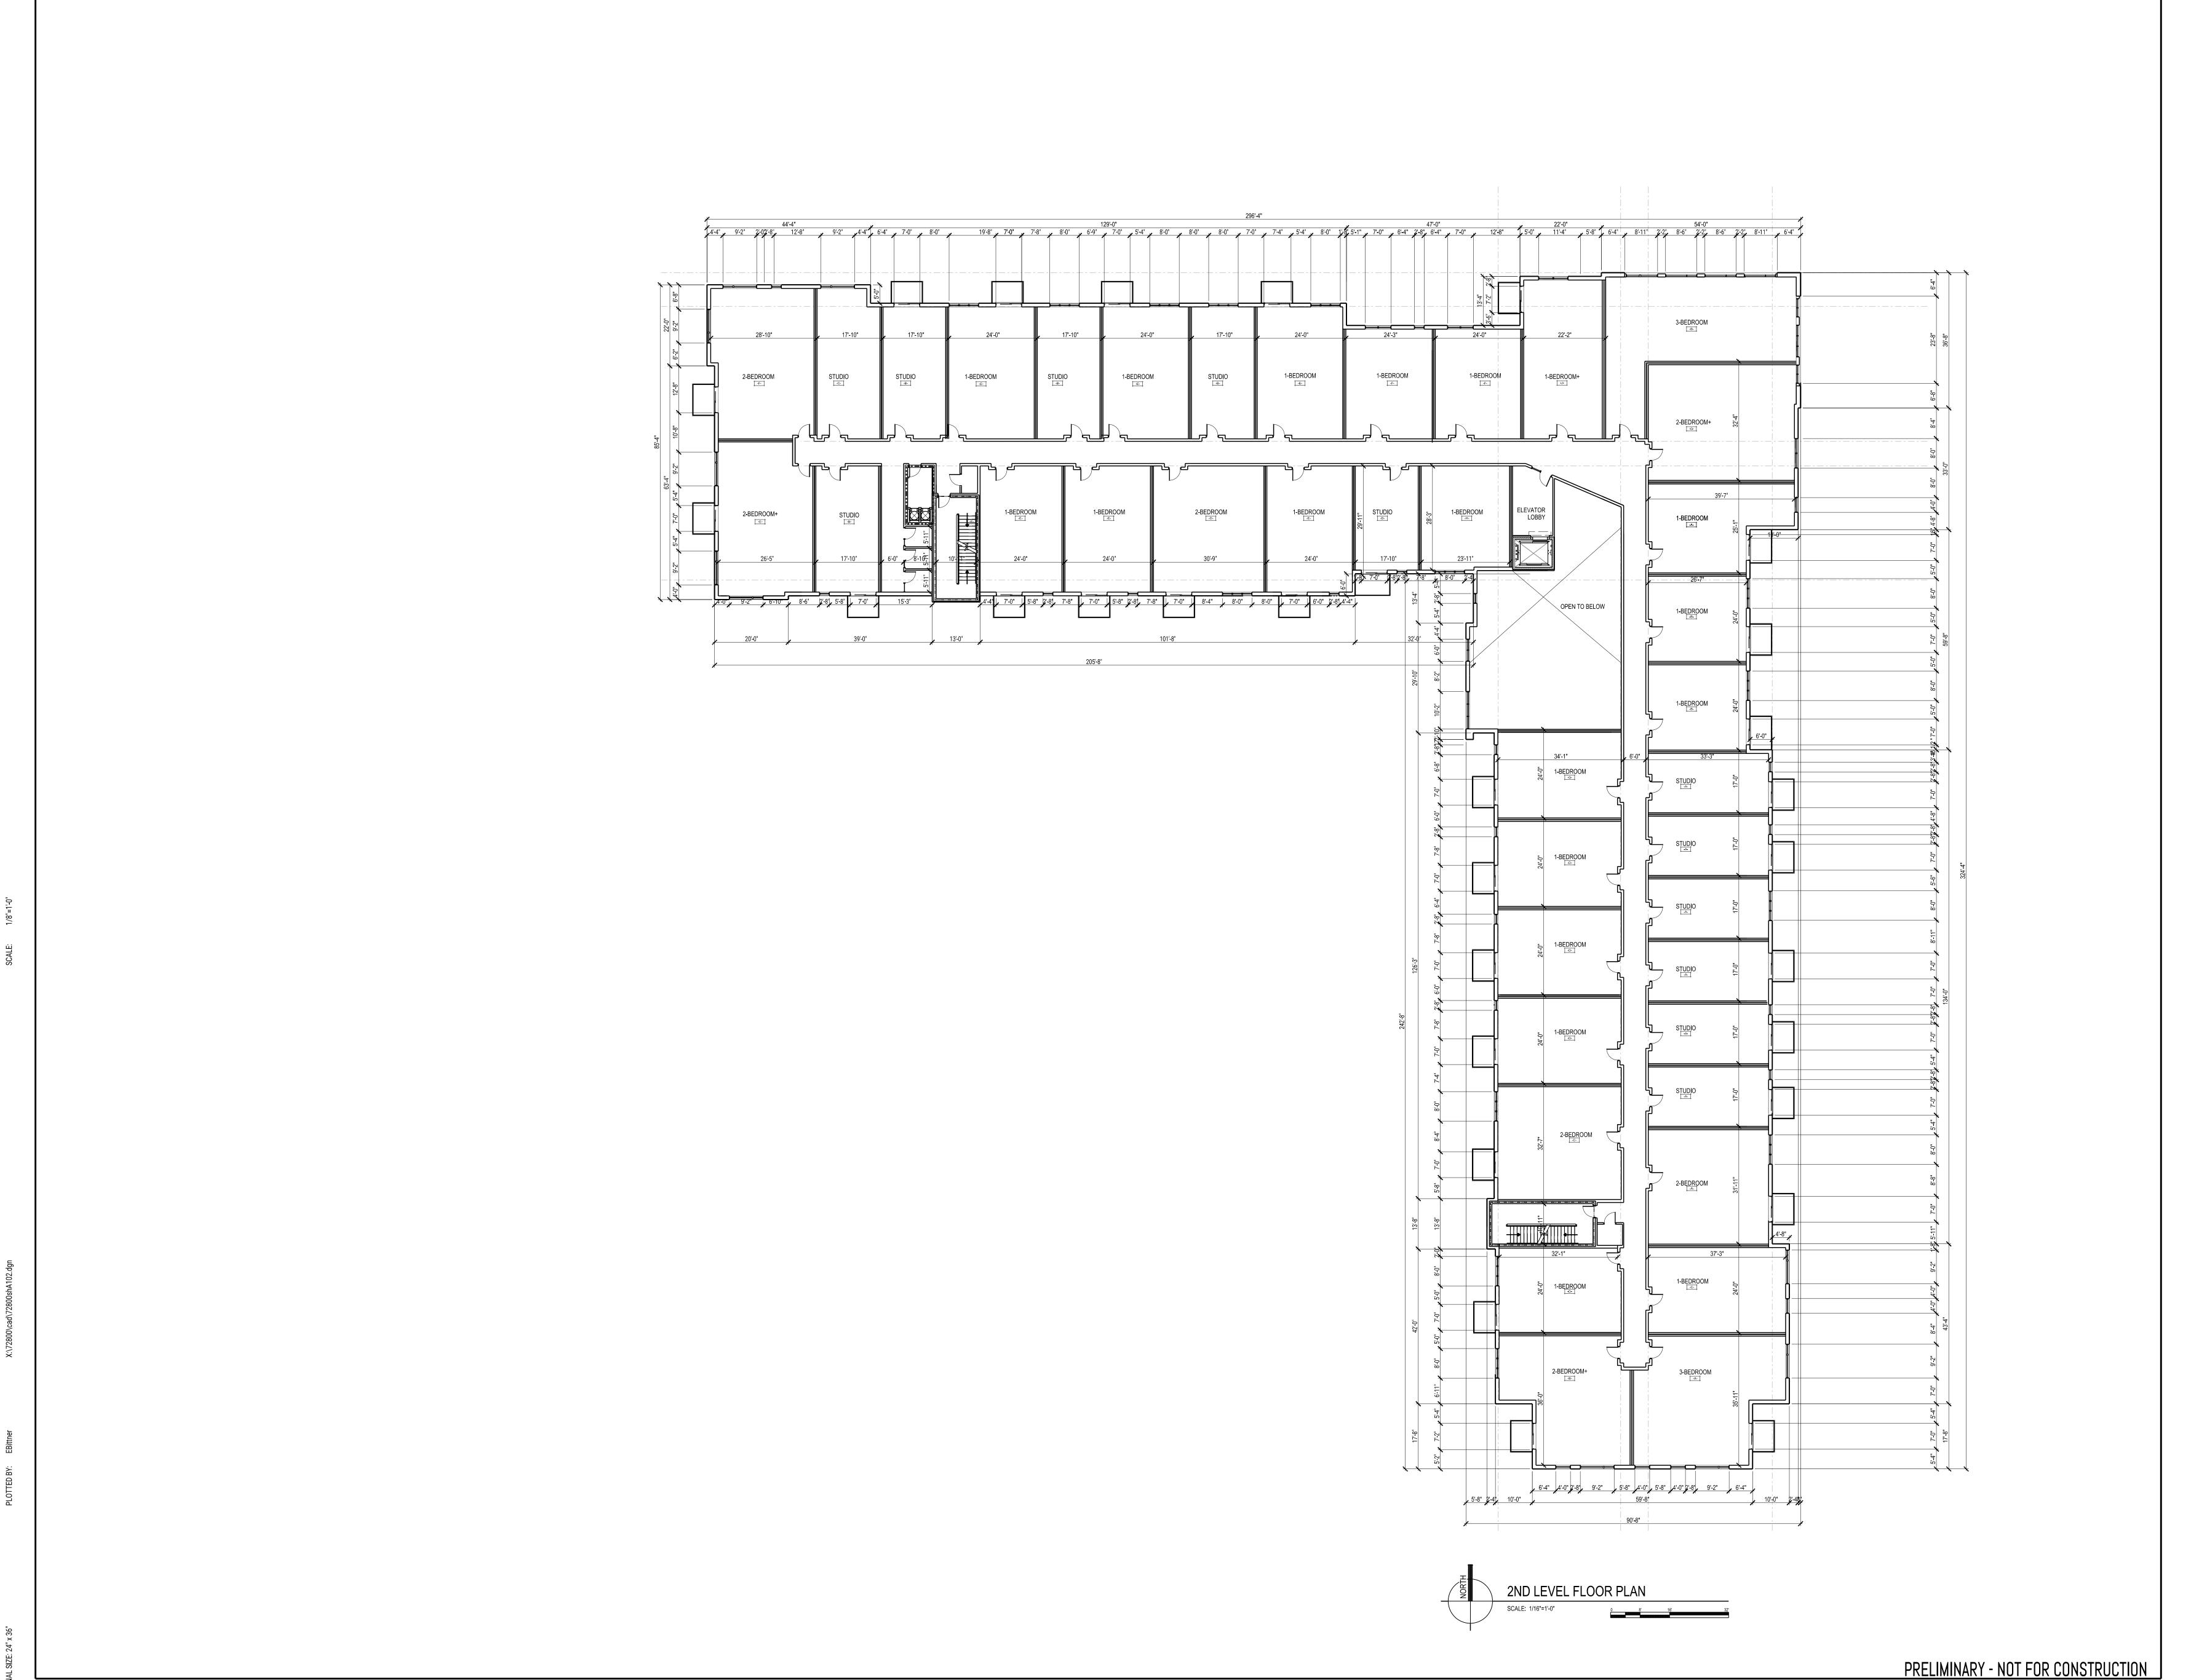
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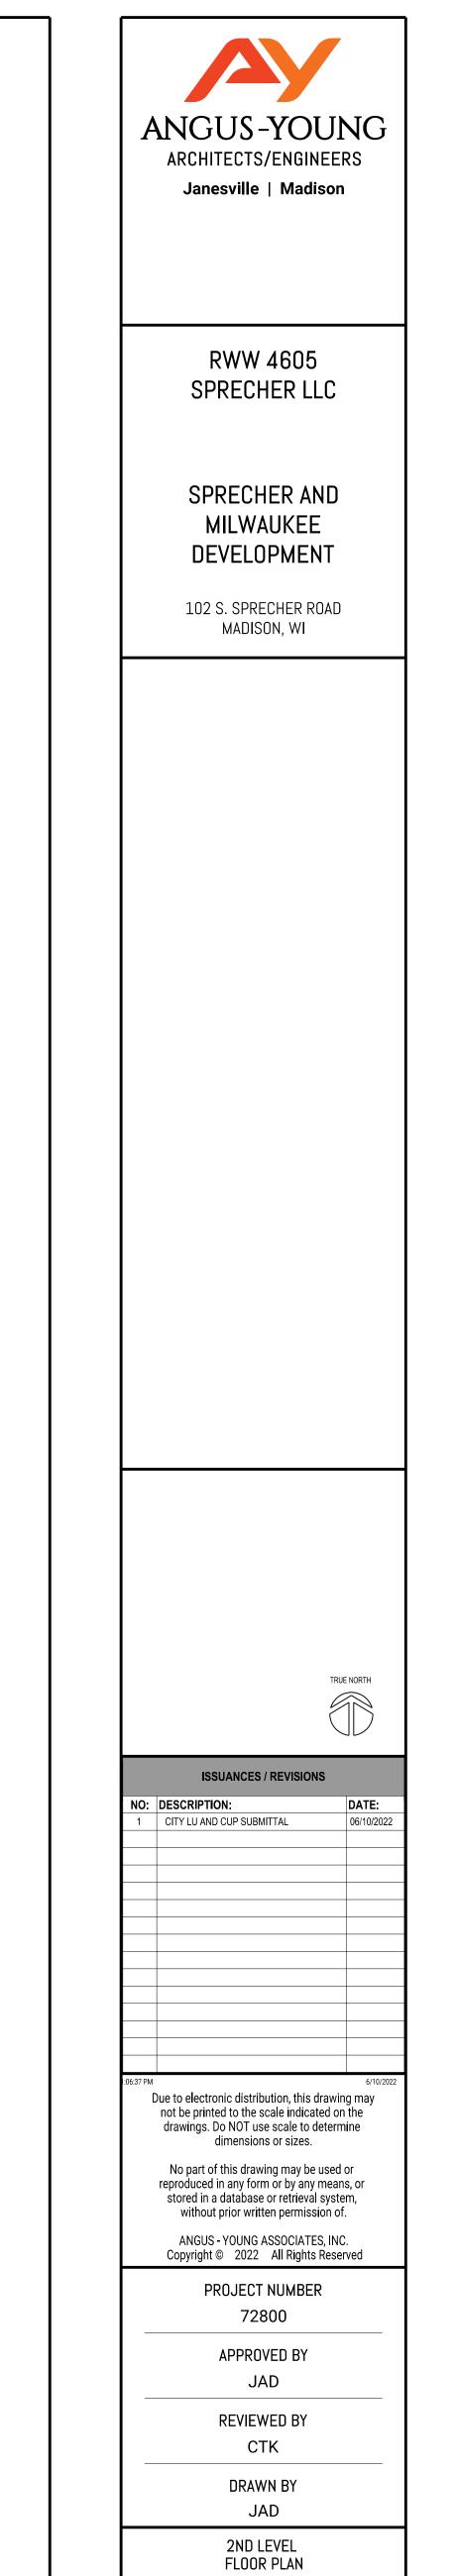
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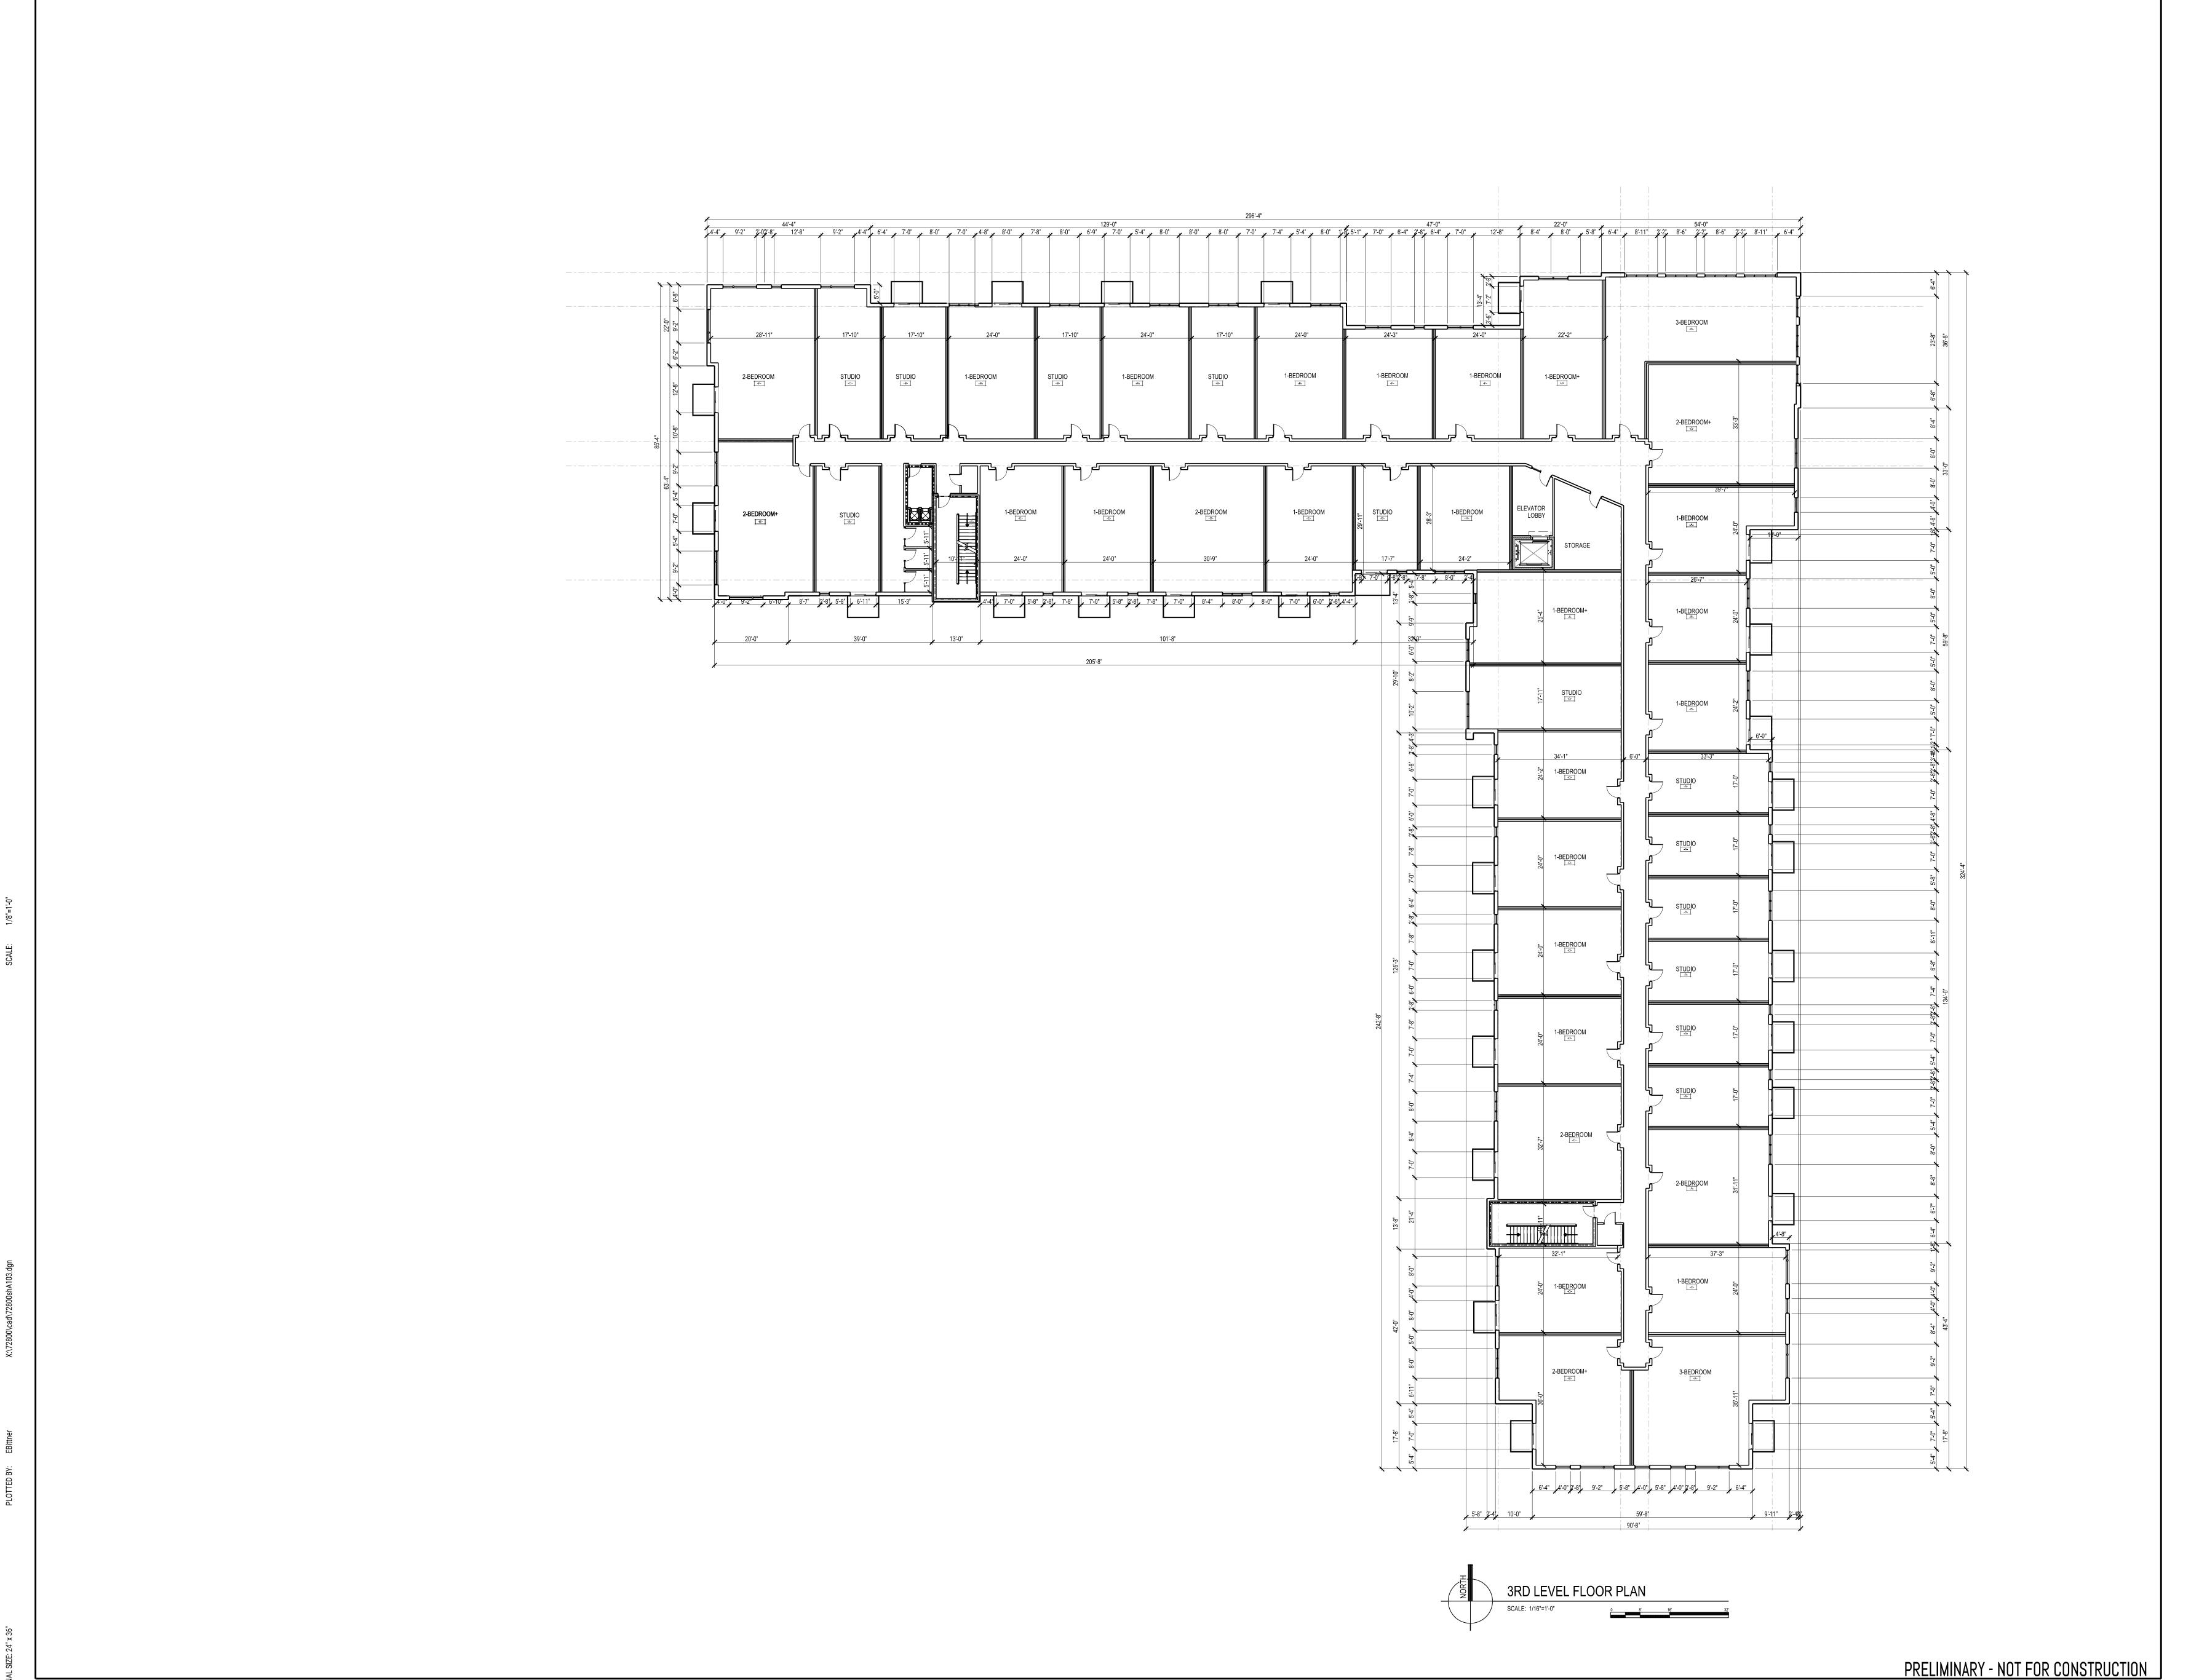
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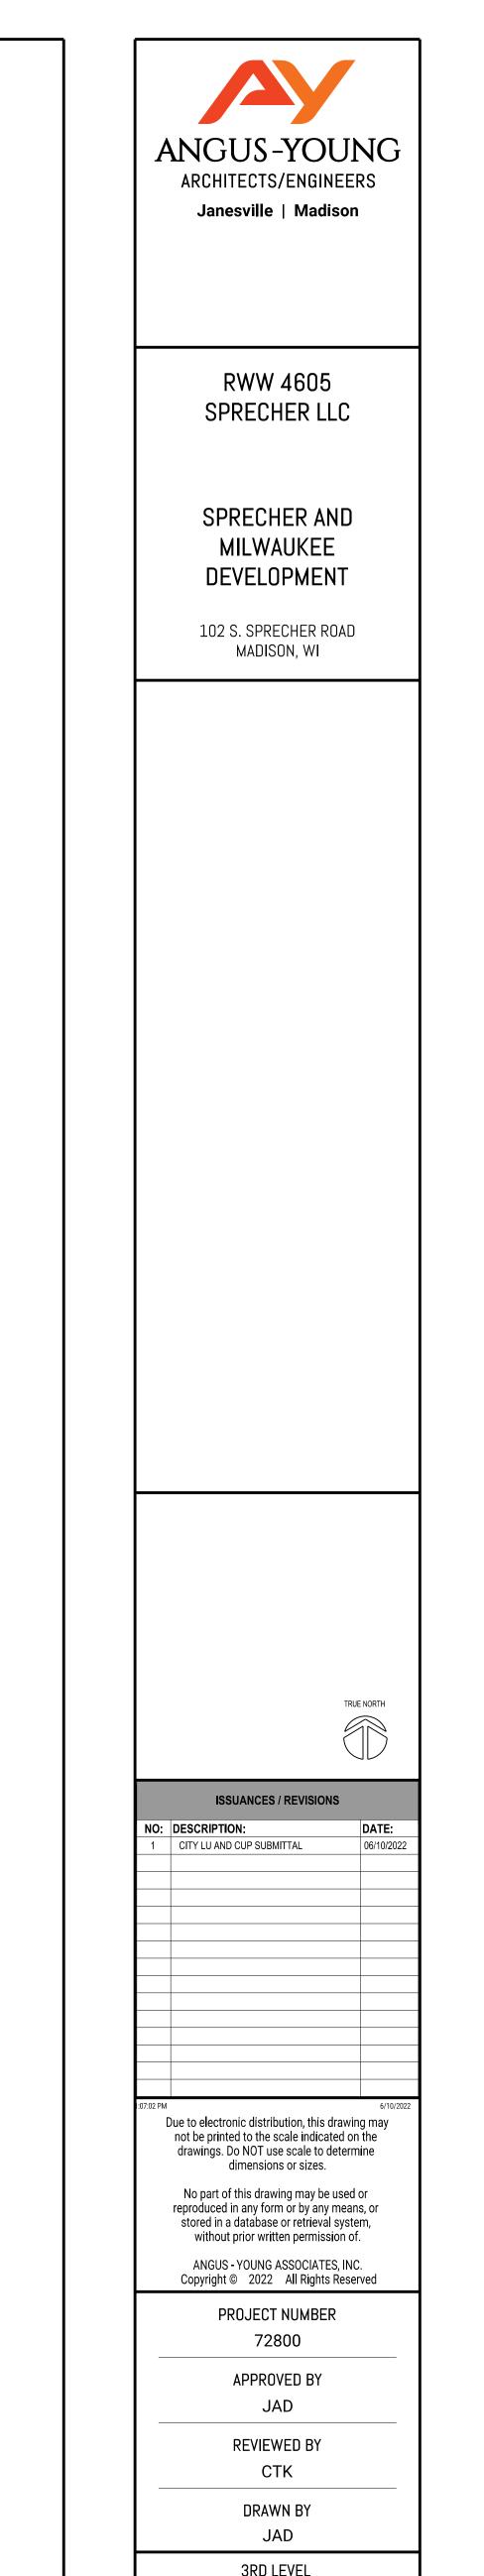
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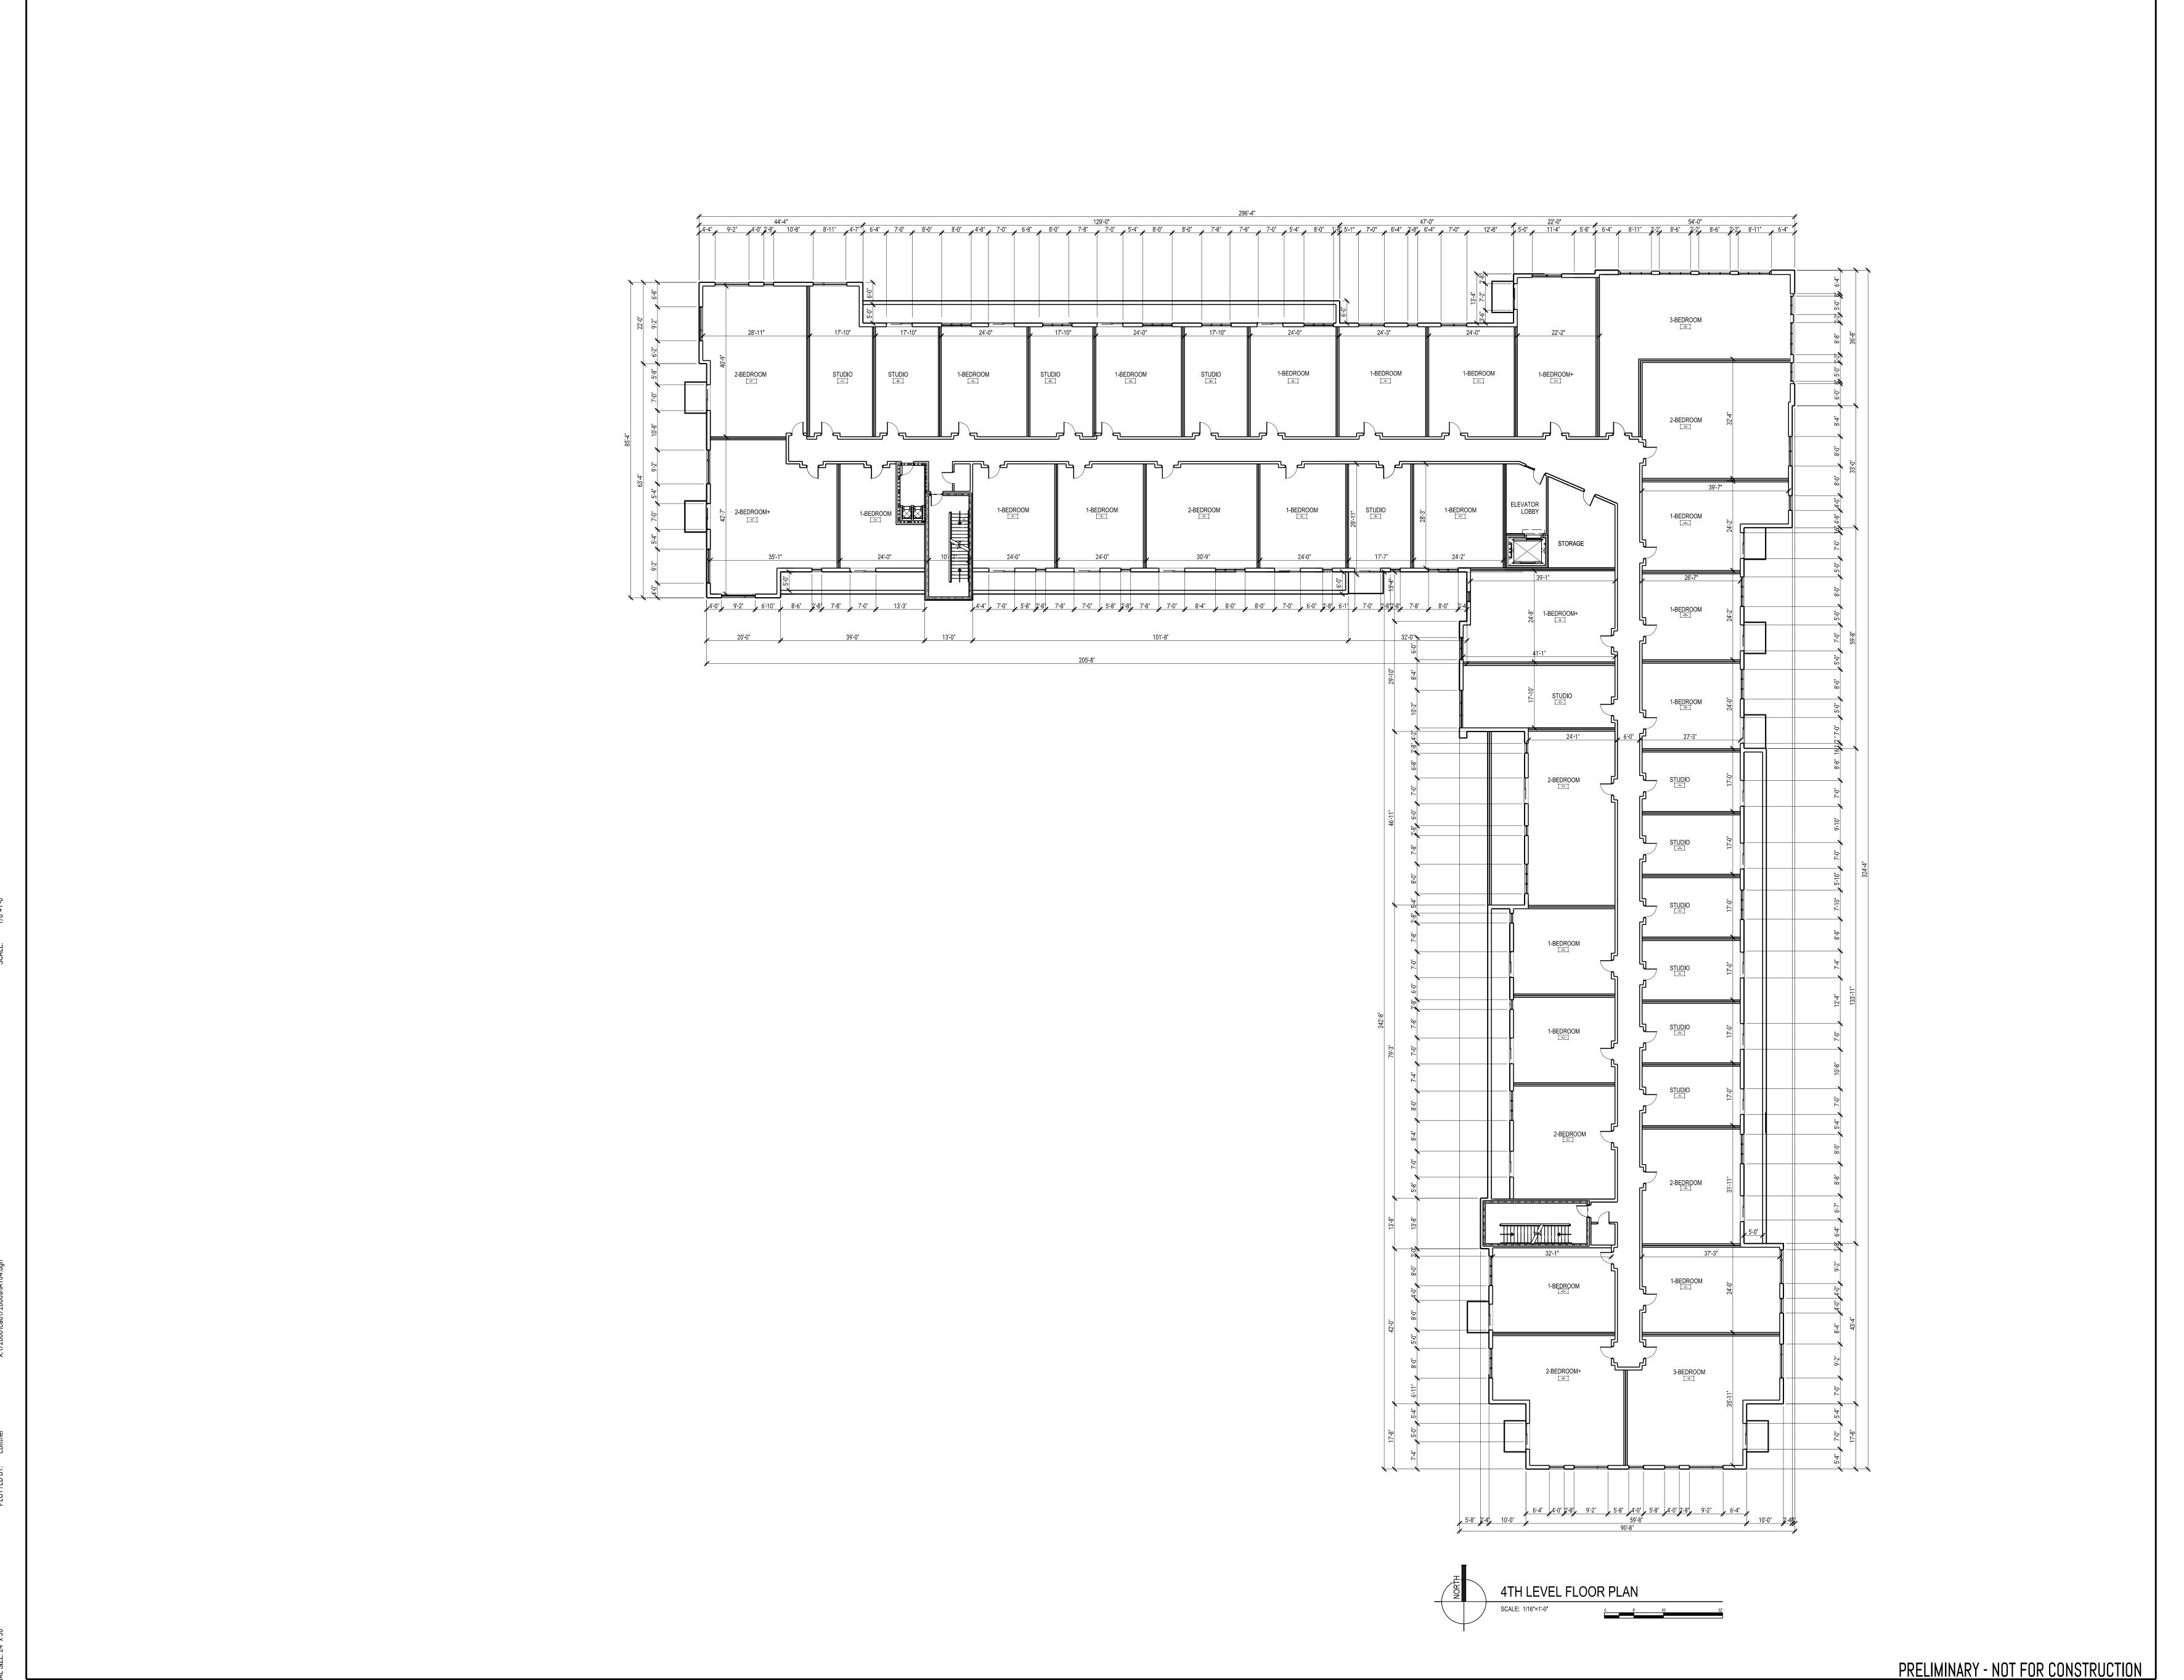
DRAWN BY JAD 1ST LEVEL FLOOR PLAN







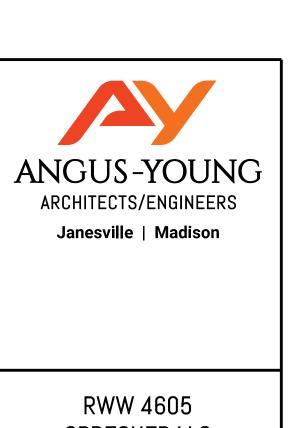





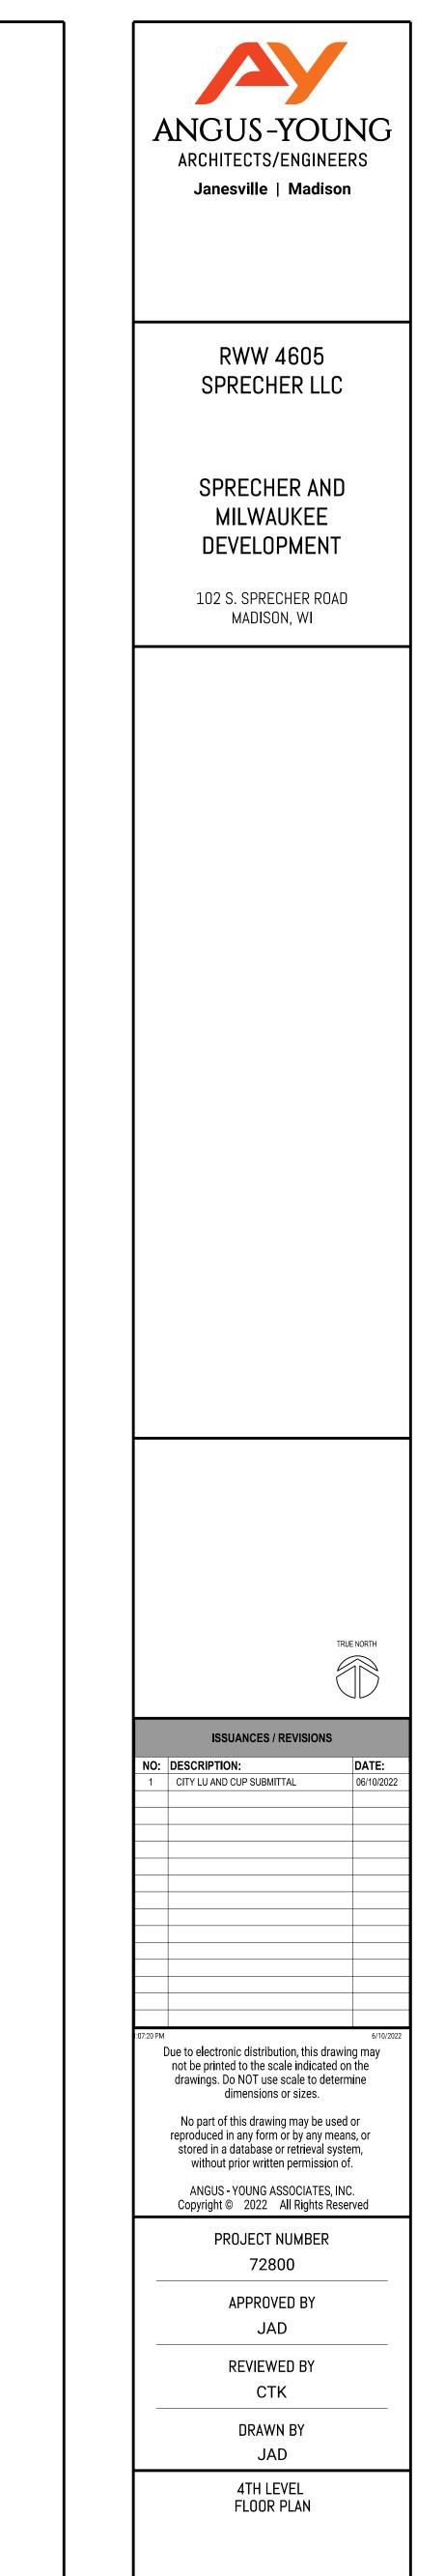

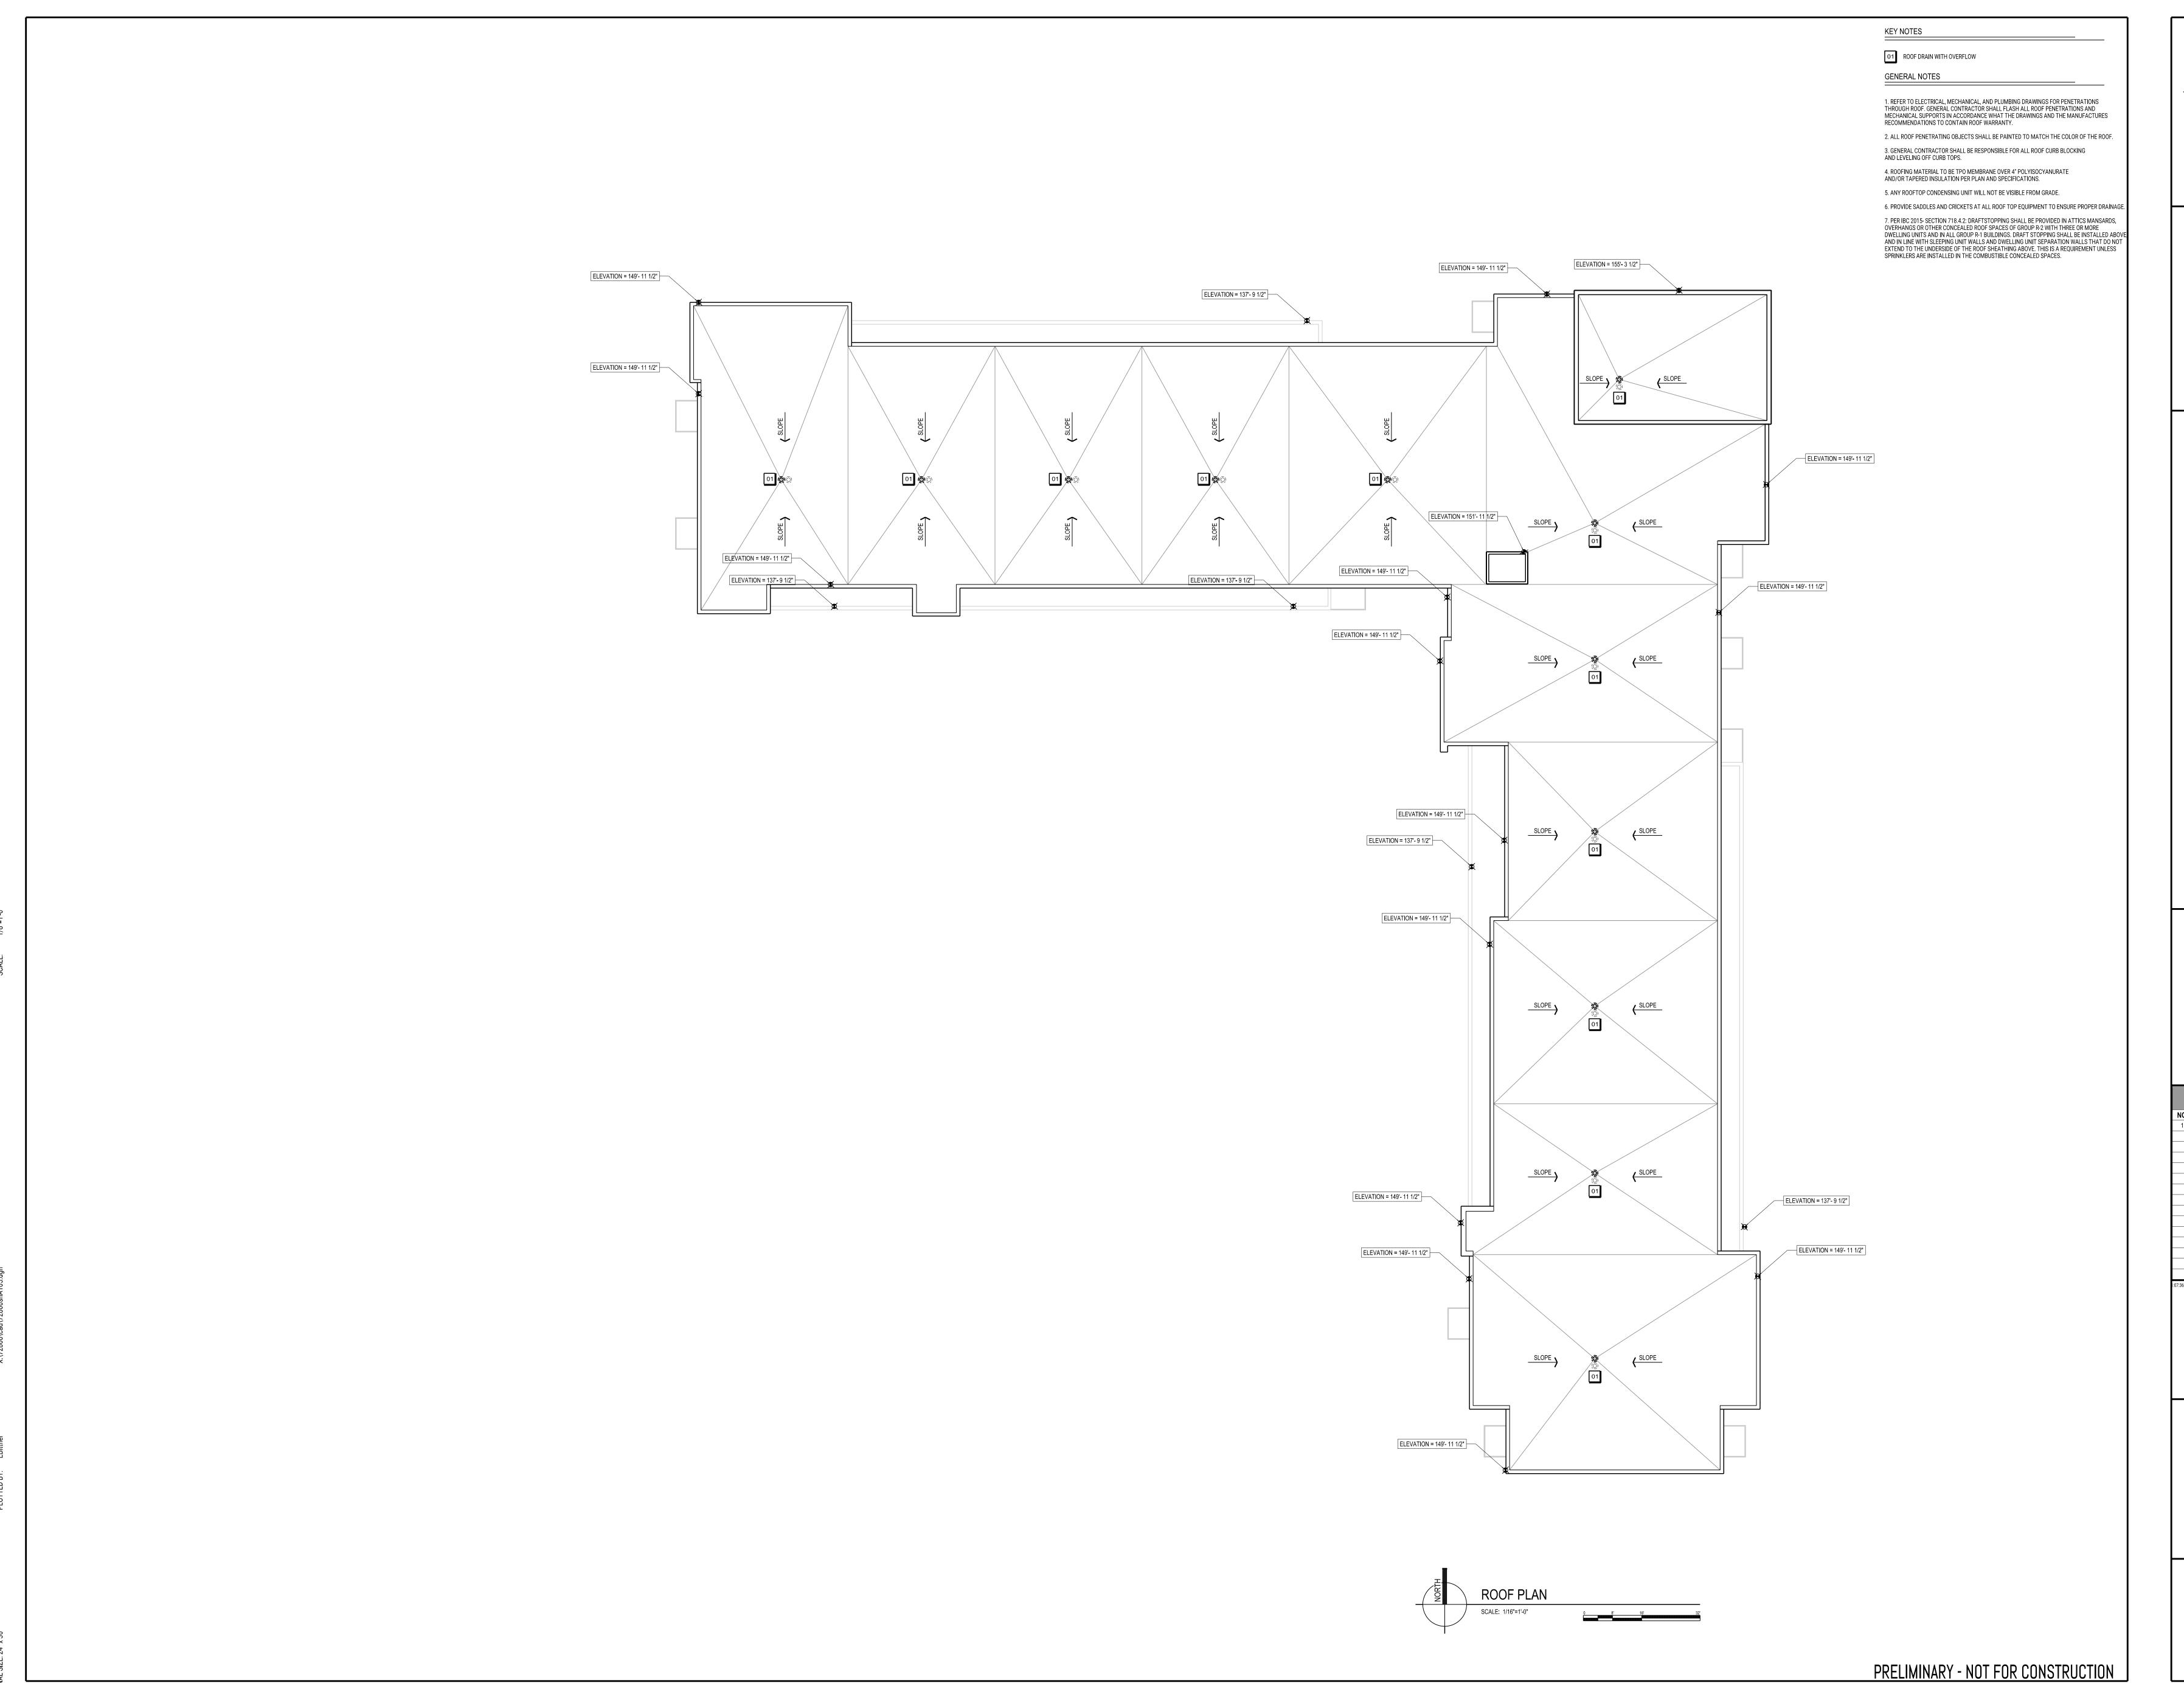

ARCHITECTS/ENGINEERS Janesville | Madison

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SPRECHER AND MILWAUKEE DEVELOPMENT

102 S. SPRECHER ROAD MADISON, WI

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ROOF PLAN

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SPRECHER AND
MILWAUKEE
DEVELOPMENT

102 S. SPRECHER ROAD
MADISON, WI

KEY NOTES

TRUE NORTH

SSUANCES / REVISIONS

NO: DESCRIPTION:

1 CITY LU AND CUP SUBMITTAL

06/10/2022

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72800


APPROVED BY

JAD
REVIEWED BY
CTK

EXTERIOR ELEVATIONS

DRAWN BY

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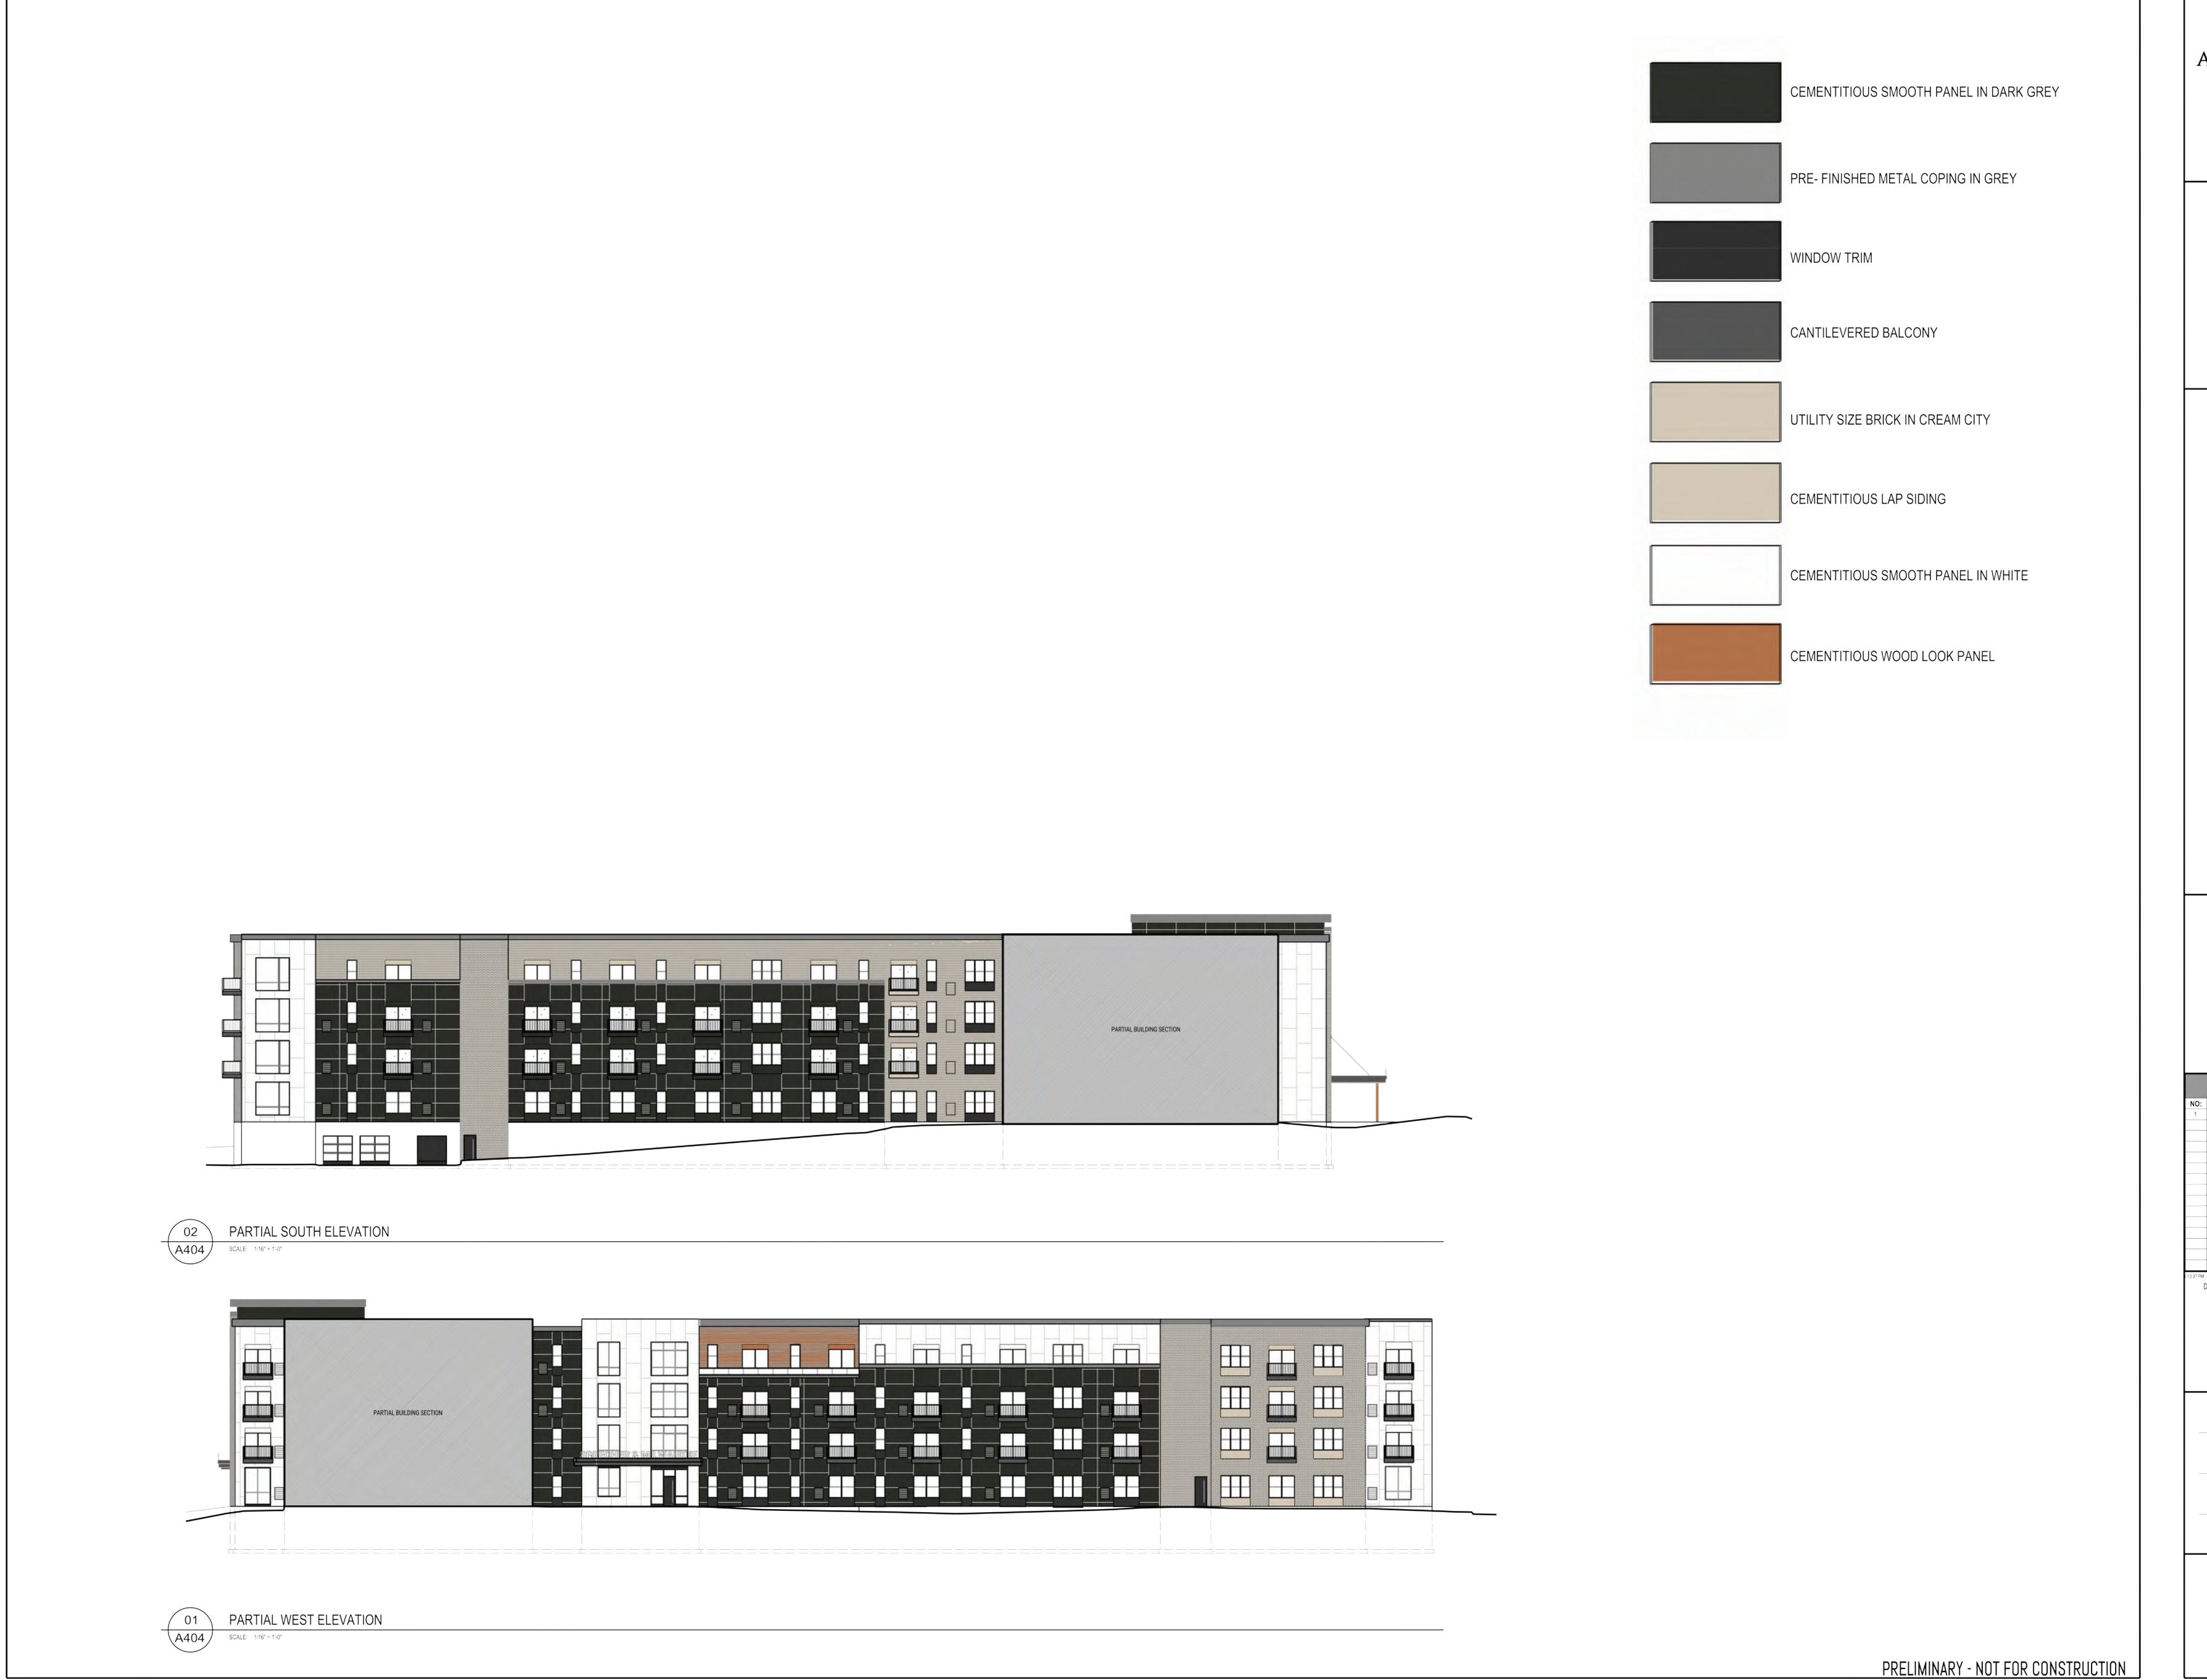
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EXTERIOR ELEVATIONS

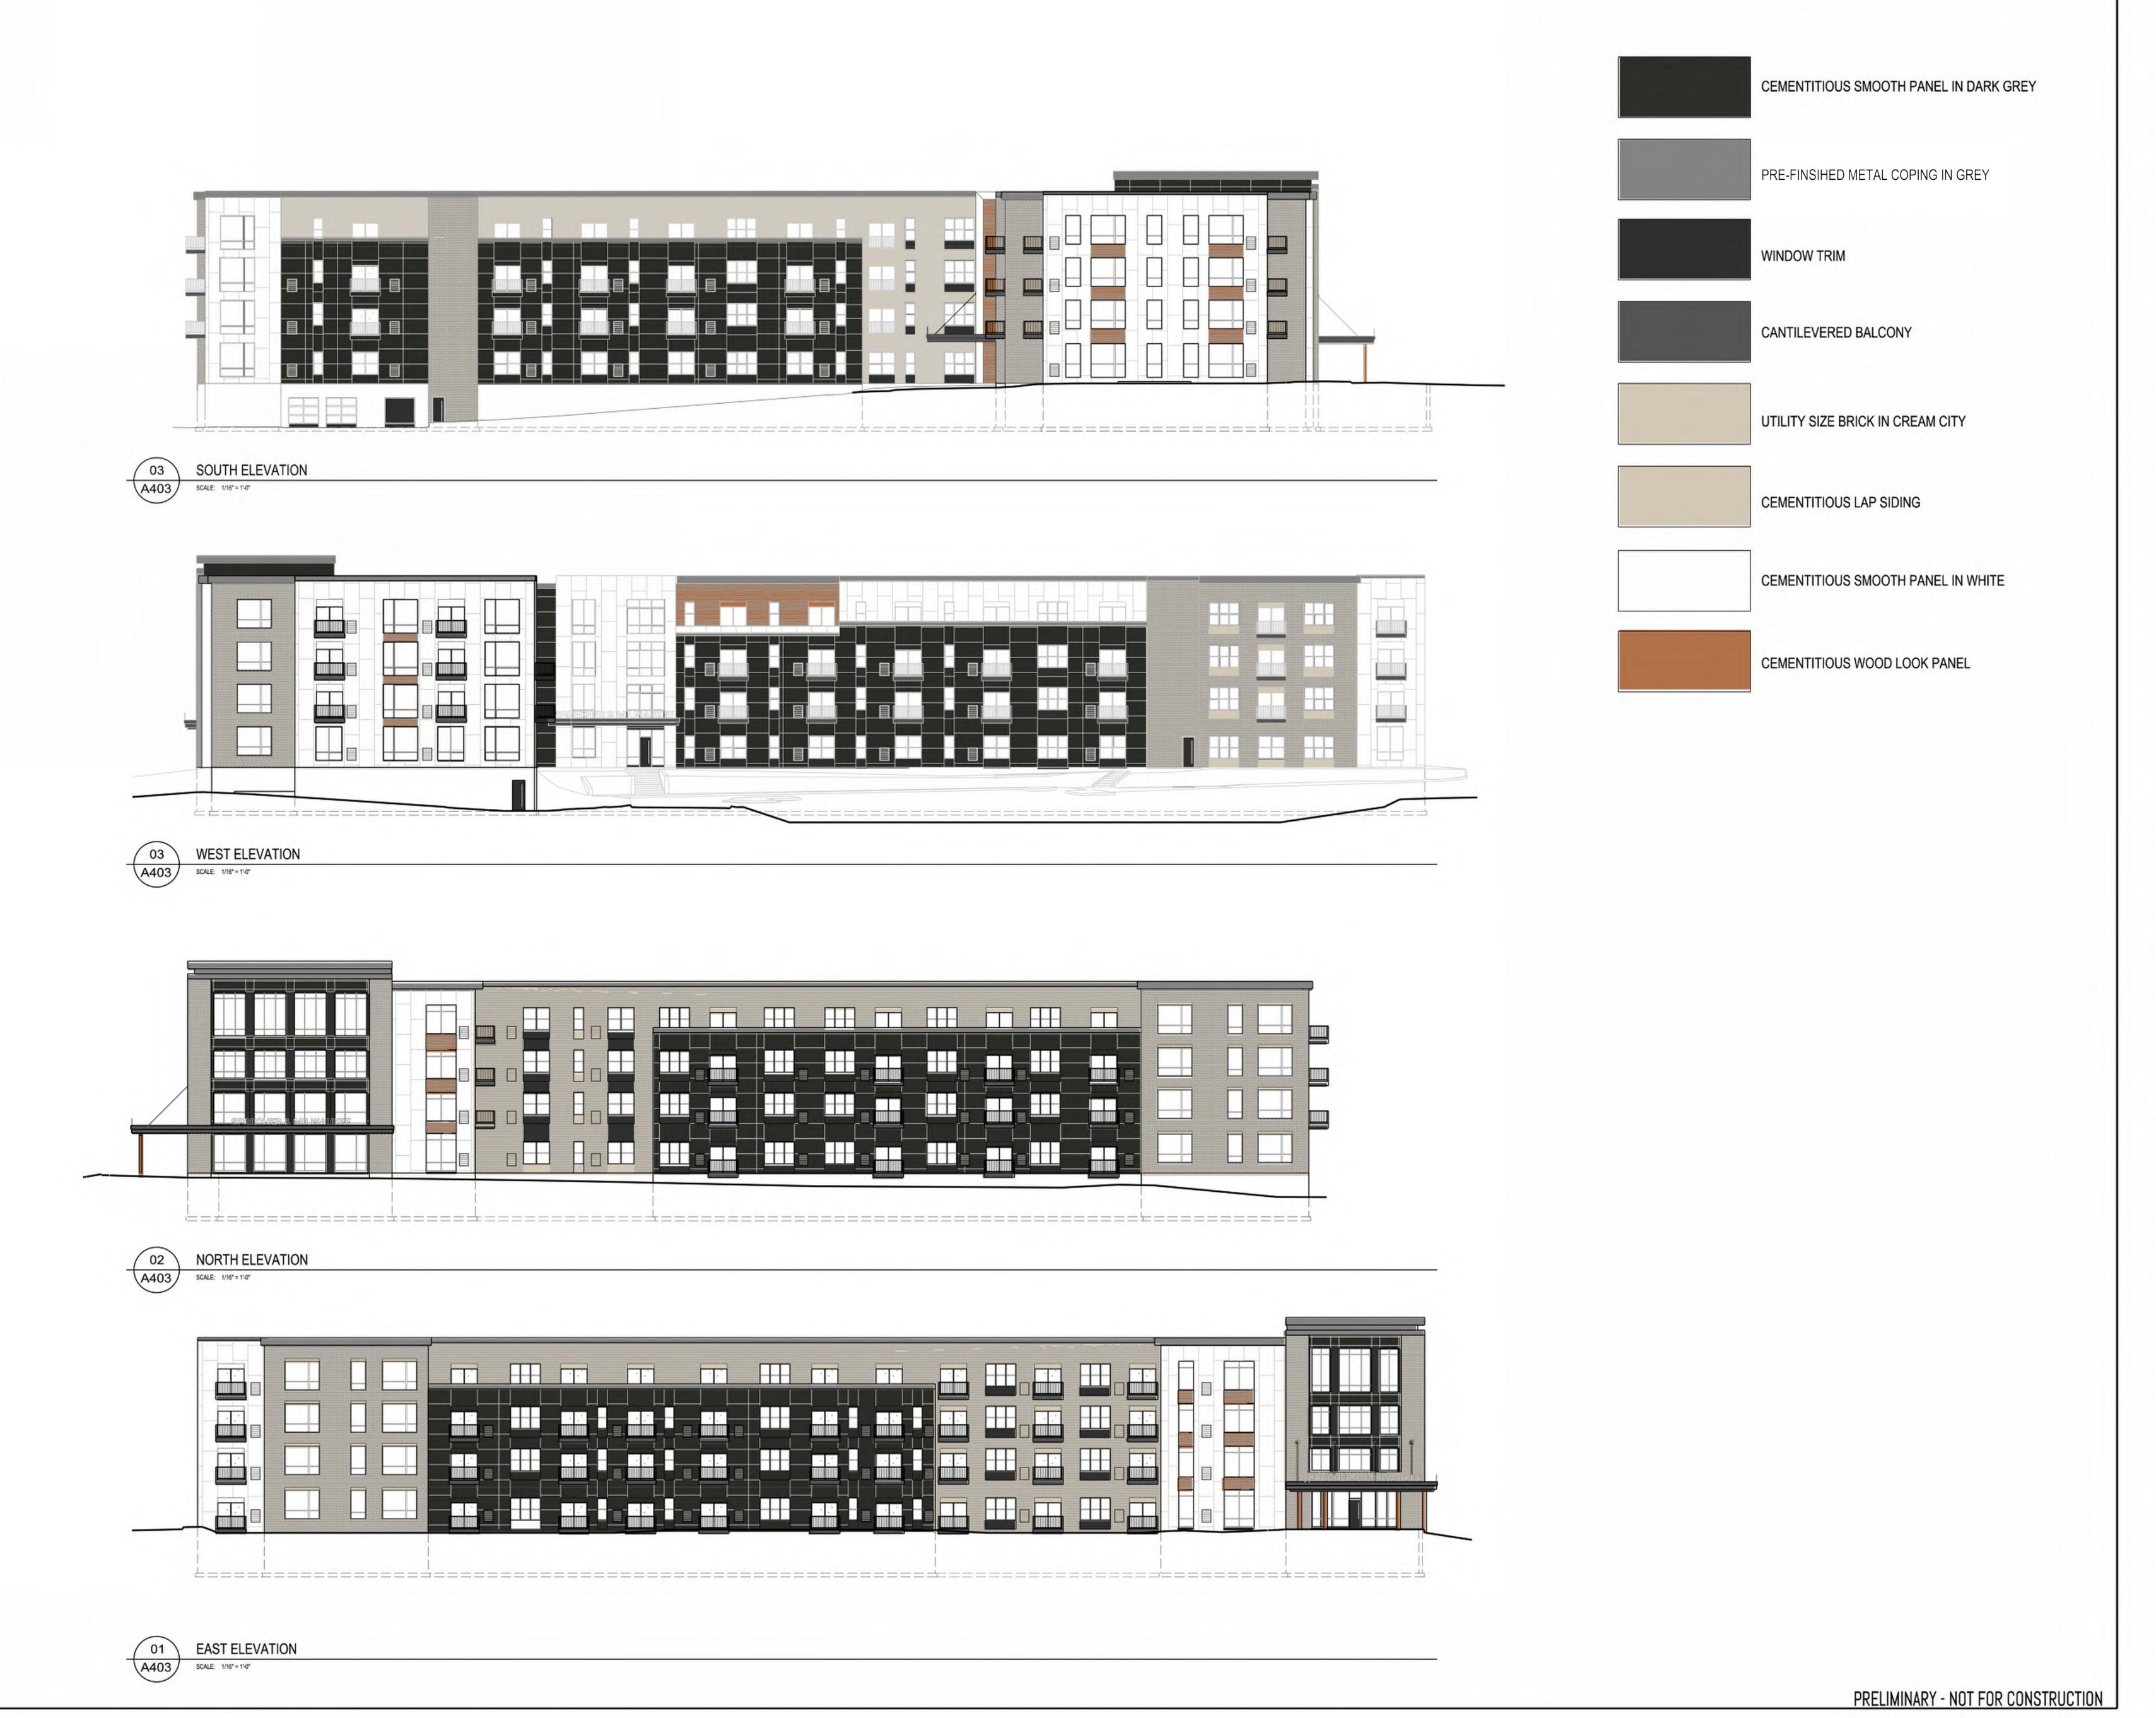A403

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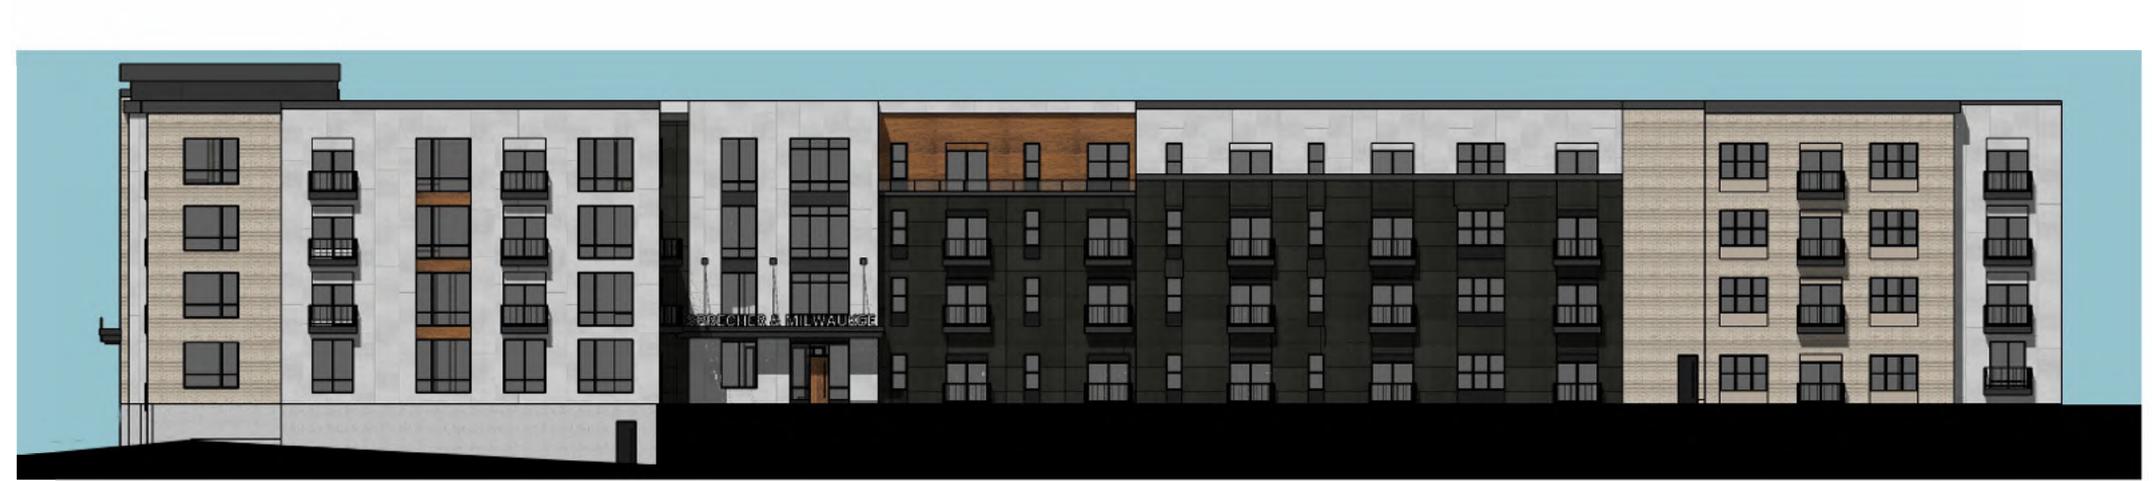
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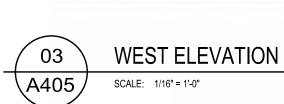


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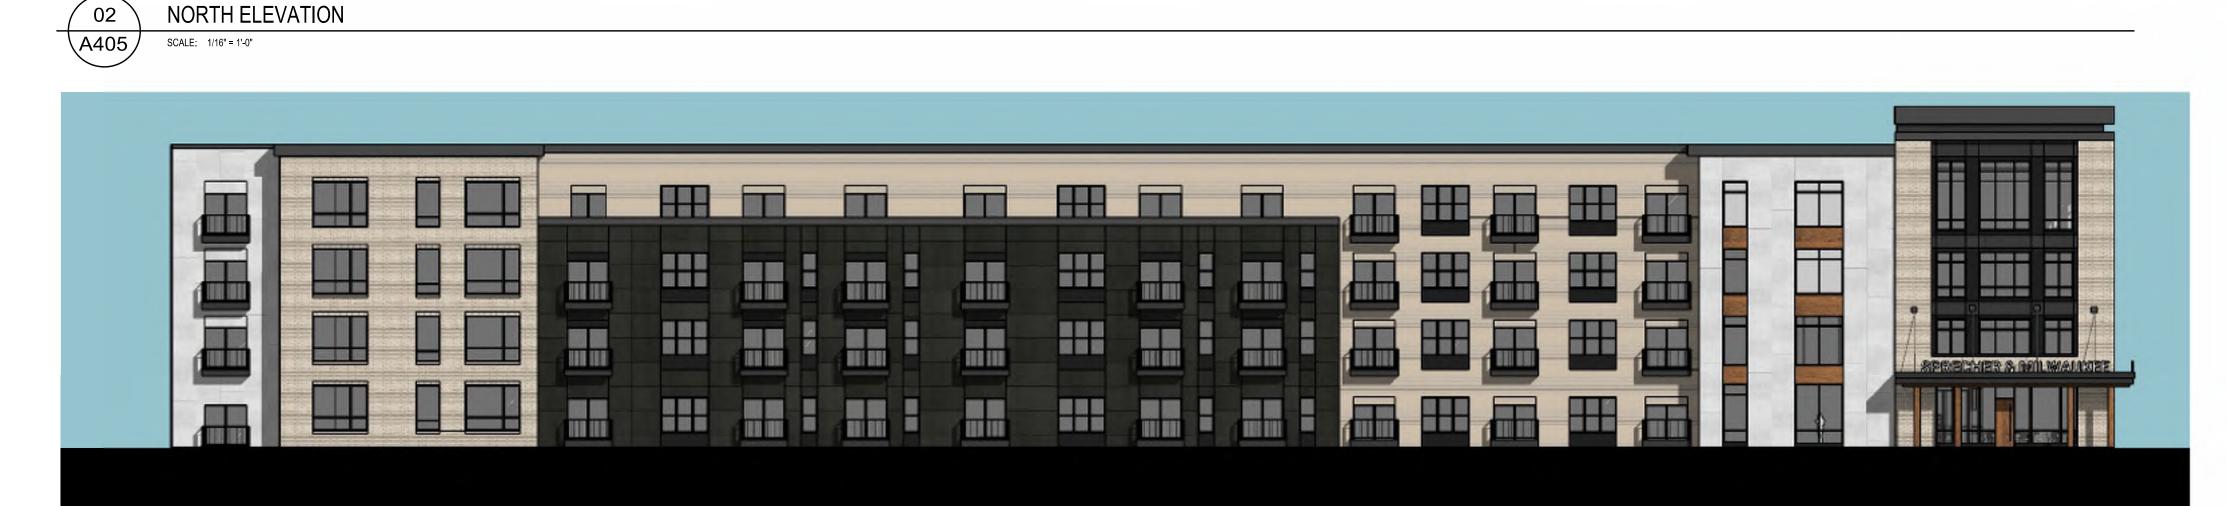








A405 SCALE: 1/16" = 1'-0"





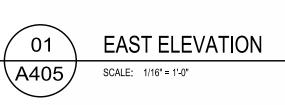

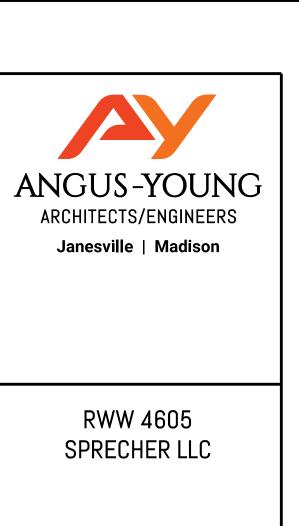

SPRECHER AND MILWAUKEE DEVELOPMENT

102 S. SPRECHER ROAD MADISON, WI

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PROJECT NUMBER 72800 APPROVED BY

JAD
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CTK

SHADED EXTERIOR ELEVATIONS


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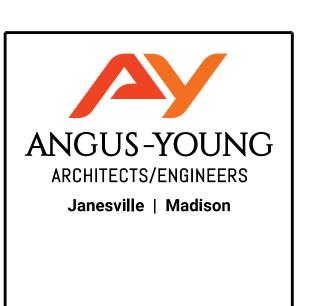








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102 S. SPRECHER ROAD MADISON, WI
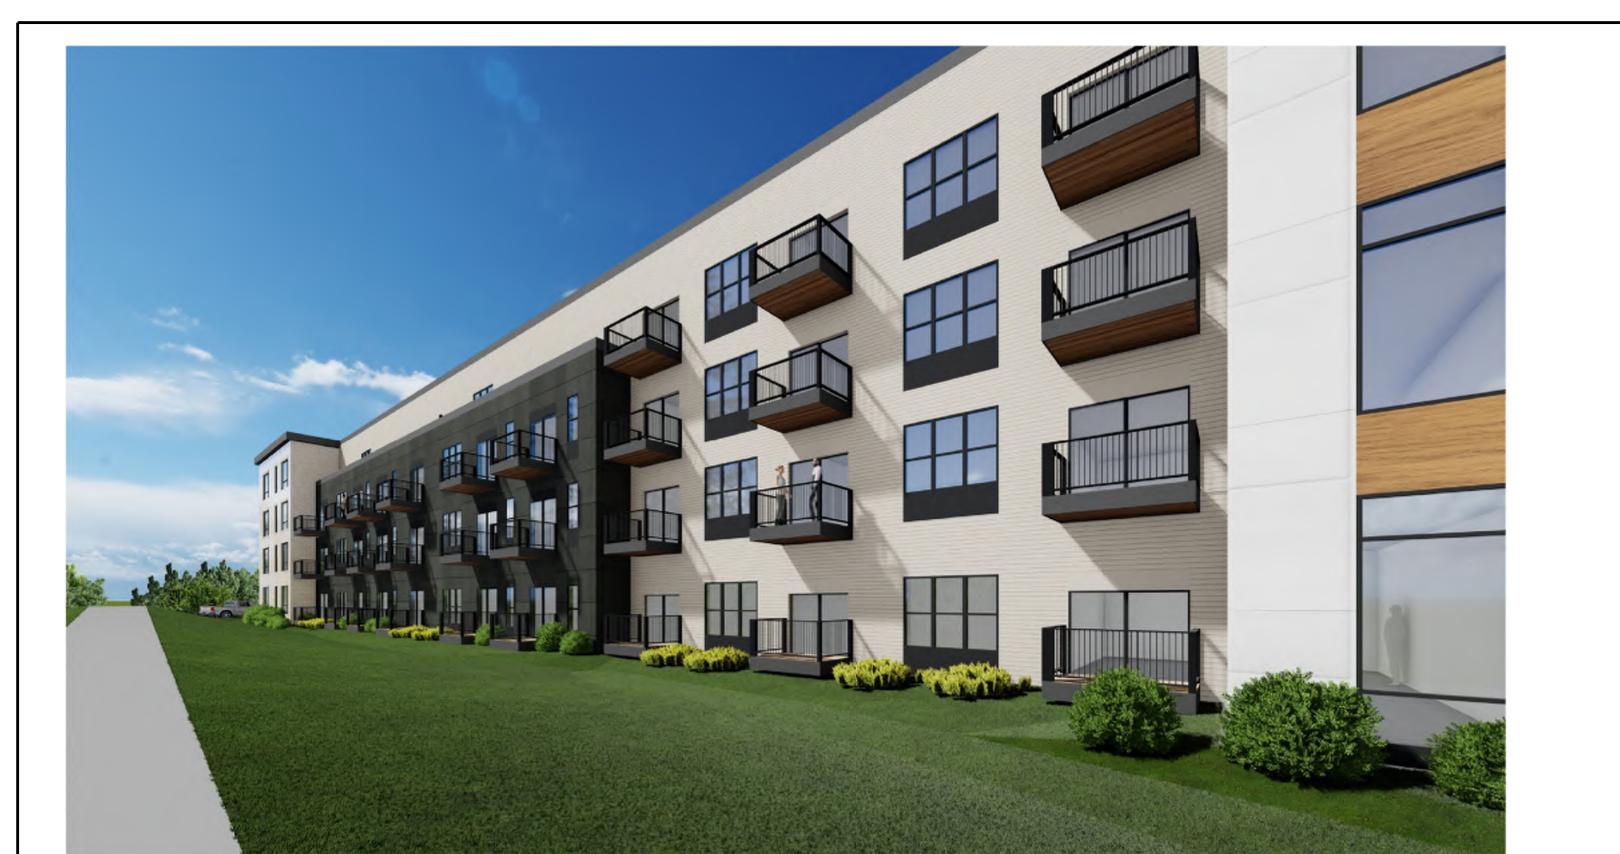
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RENDERINGS

G002



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NO: DESCRIPTION:

CITY LU AND CUP SUBMITTAL

ARCHITECTS/ENGINEERS

Janesville | Madison

RWW 4605

SPRECHER LLC

SPRECHER AND

MILWAUKEE

DEVELOPMENT

102 S. SPRECHER ROAD MADISON, WI














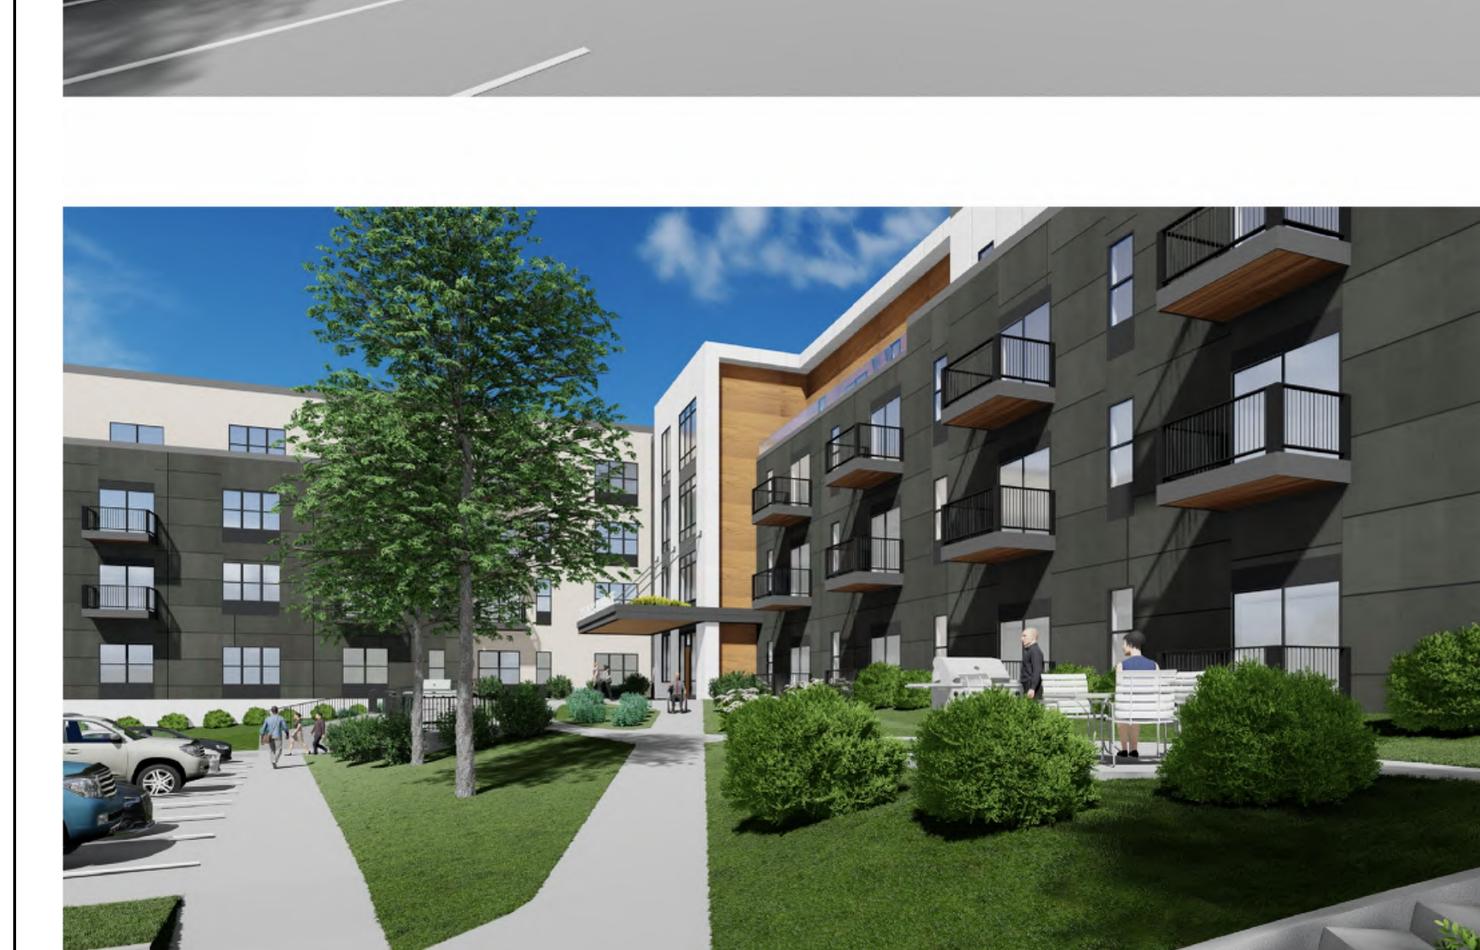

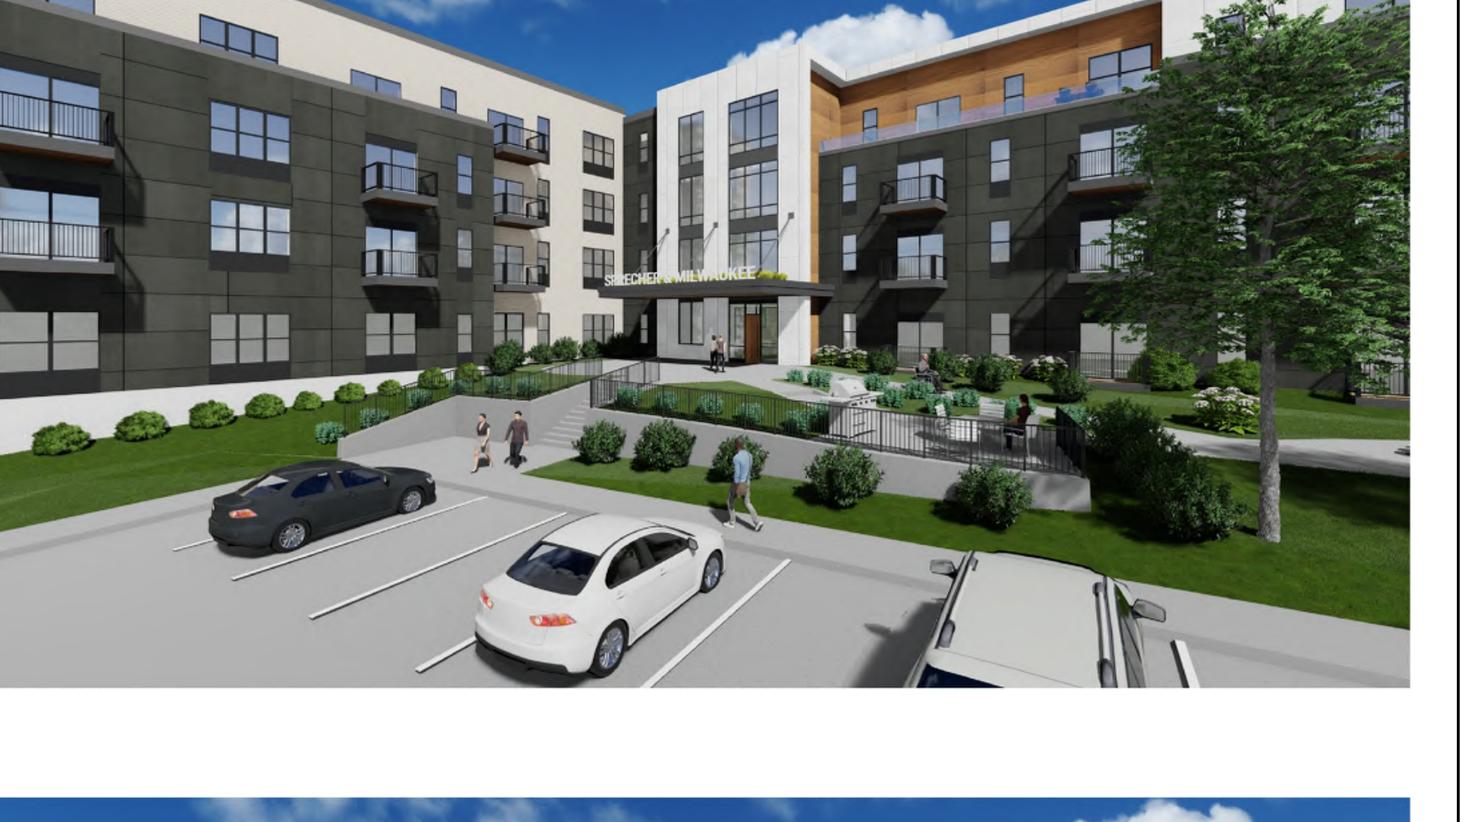



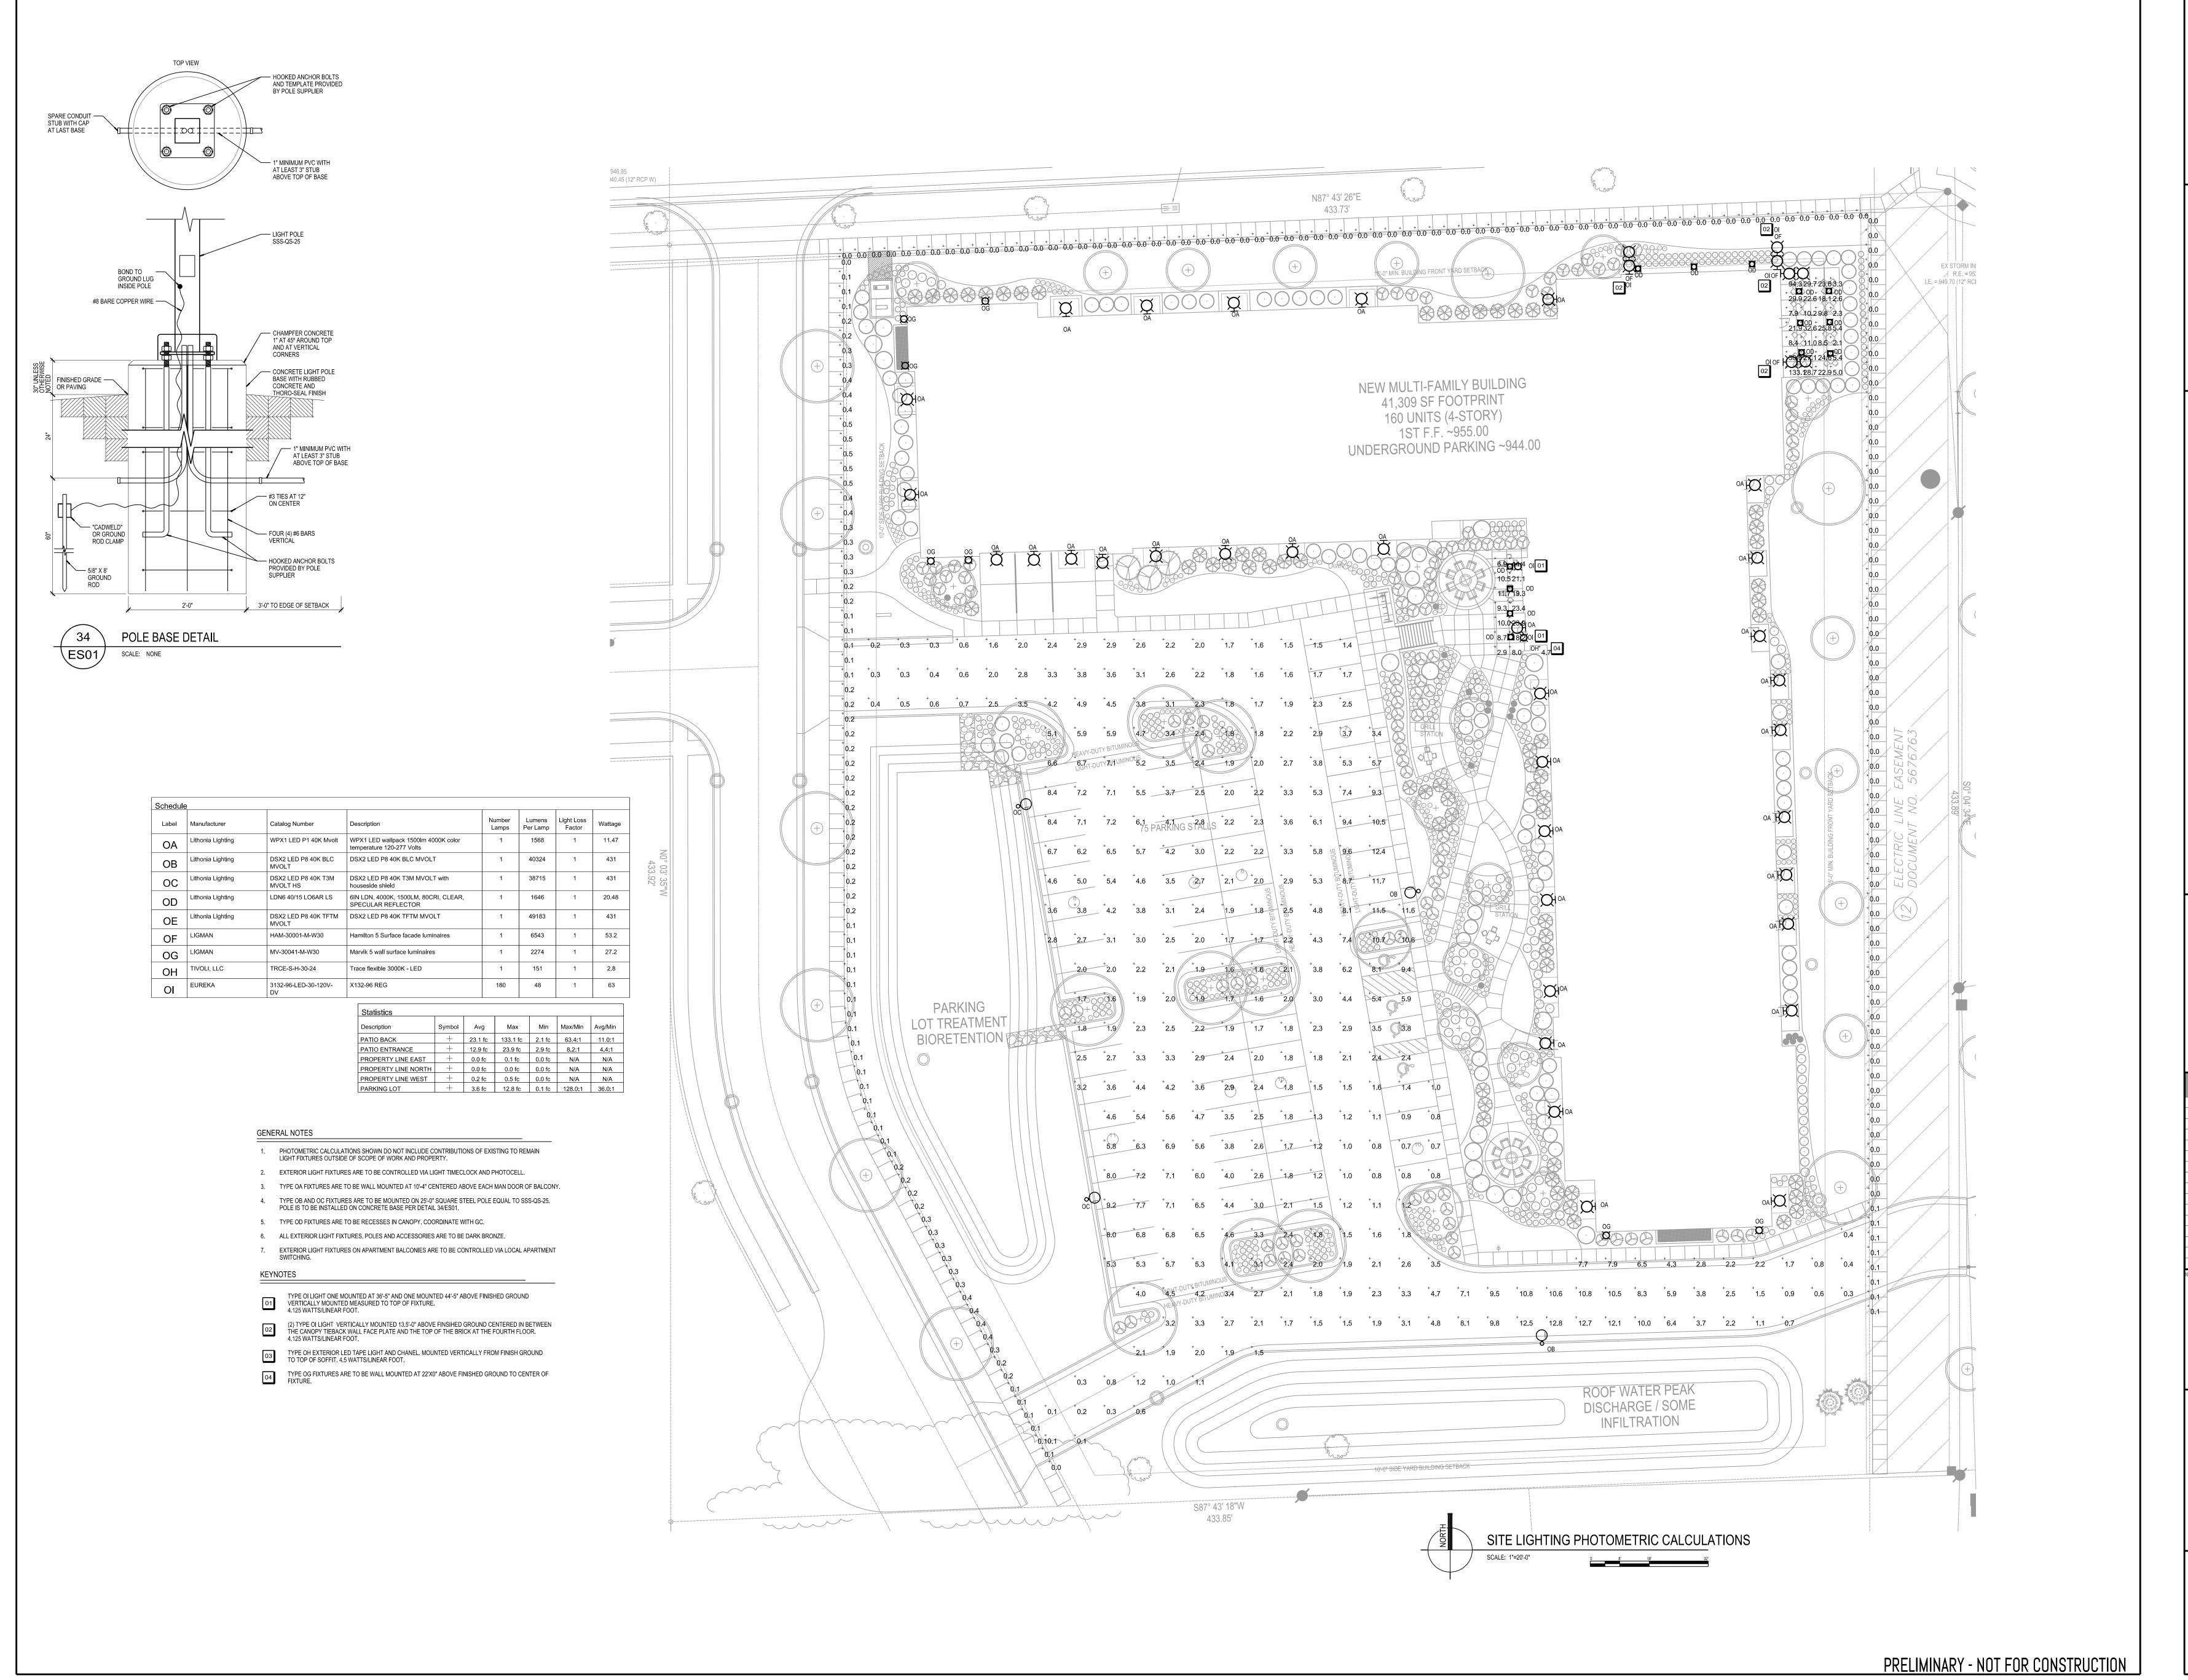

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### **City of Madison Fire Department**

30 West Mifflin Street, 8th & 9th Floors, Madison, WI 53703-2579 Phone: 608-266-4420 • Fax: 608-267-1100 • E-mail: fire@cityofmadison.com

Project Address:	4605 Specher (SW Quadrant of intersection of Sprecher & Milwaukee	
Contact Name & Pl	one #: Angus-Young, Jeff Davis & Katie Udell, 608-756-2326	

#### FIRE APPARATUS ACCESS AND FIRE HYDRANT WORKSHEET

1. Is the building completely protected by an NFPA 13 or 13R automatic fire sprinkler system?  If non-sprinklered, fire lanes extend to within 150-feet of all portions of the exterior wall?  If sprinklered, fire lanes are within 250-feet of all portions of the exterior wall?	X Yes Yes X Yes	☐ No ☐ No ☐ No	<ul><li>N/A</li><li>N/A</li><li>N/A</li></ul>
<ul> <li>2. Is the fire lane constructed of concrete or asphalt, designed to support a minimum load of 85,000 lbs? <ul> <li>a) Is the fire lane a minimum unobstructed width of at least 20-feet?</li> <li>b) Is the fire lane unobstructed with a vertical clearance of at least 13½-feet?</li> <li>c) Is the minimum inside turning radius of the fire lane at least 28-feet?</li> <li>d) Is the grade of the fire lane not more than a slope of 8%?</li> <li>e) Is the fire lane posted as fire lane? (Provide detail of signage.)</li> <li>f) Is a roll-able curb used as part of the fire lane? (Provide detail of curb.)</li> <li>g) Is part of a sidewalk used as part of the required fire lane? (Must support +85,000 lbs.)</li> </ul> </li> </ul>	X Yes   X Yes   X Yes   X Yes   X Yes   Yes	No   No   No   No   No   No   No   No	N/A   N/A   N/A   N/A   N/A   N/A   N/A   N/A
<ul><li>3. Is the fire lane obstructed by security gates or barricades? If yes:</li><li>a) Is the gate a minimum of 20-feet clear opening?</li><li>b) Is an approved means of emergency operations installed, key vault, padlock or key switch?</li></ul>	Yes Yes Yes	X No No No	<ul><li> N/A</li><li> N/A</li><li> N/A</li><li> N/A</li></ul>
4. Is the Fire lane dead-ended with a length greater than 150-feet?  If yes, does the area for turning around fire apparatus comply with IFC D103?	Yes Yes	☐ No ☐ No	X N/A X N/A
5. Is any portion of the building to be used for high-piled storage in accordance with IFC Chapter 3206.6 If yes, see IFC 3206.6 for further requirements.	Yes	X No	□ N/A
<ul> <li>6. Is any part of the building greater than 30-feet above the grade plane?  If yes, answer the following questions:  a) Is the aerial apparatus fire lane parallel to one entire side of the building and covering at least 25% of the perimeter?  b) Is the near edge of the aerial apparatus fire lane between 15' and 30' from the building?  c) Are there any overhead power or utility lines located across the aerial apparatus fire lane?  d) Are there any tree canopies expected to grow across the aerial fire lane? (Based on mature canopy width of tree species)  e) Does the aerial apparatus fire lane have a minimum unobstructed width of 26-feet?  f) Is the space between the aerial lane and the building free of trees exceeding 20' in heights?</li> <li>7. Are all portions of the required fire lanes within 500-feet of at least (2) hydrants?</li> </ul>	X Yes X Yes Yes Yes Yes Yes X Yes Yes	<ul> <li>No</li> <li>No</li> <li>No</li> <li>X No</li> <li>X No</li> <li>No</li> <li>No</li> <li>No</li> </ul>	<ul> <li>N/A</li> <li>N/A</li> <li>N/A</li> <li>N/A</li> <li>N/A</li> <li>N/A</li> <li>N/A</li> <li>N/A</li> </ul>

Attach an additional sheet if further explanation is required for any answers.

This worksheet is based on MGO 34.503 and IFC 2012 Edition Chapter 5 and Appendix D; please see the codes for further information.