

# **City of Madison Fire Department**

314 W Dayton Street, Madison, WI 53703-2506

Phone: 608-266-4420 • Fax: 608-267-1100 • E-mail: fire@cityofmadison.com

Project Address: 414 East Washington Avenue			
Contact Name & Phone #:	Duane Johnson 608-836-3690		

# FIRE APPARATUS ACCESS AND FIRE HYDRANT WORKSHEET

1. Is the building completely protected by an NFPA 13 or 13R automatic fire sprinkler system?  If non-sprinklered, fire lanes extend to within 150-feet of all portions of the exterior wall?  If sprinklered, fire lanes are within 250-feet of all portions of the exterior wall?	X Yes Yes Yes	☐ No ☐ No ☐ No	<ul><li>N/A</li><li>N/A</li><li>N/A</li></ul>
<ul> <li>2. Is the fire lane constructed of concrete or asphalt, designed to support a minimum load of 85,000 lbs? <ul> <li>a) Is the fire lane a minimum unobstructed width of at least 20-feet?</li> <li>b) Is the fire lane unobstructed with a vertical clearance of at least 13½-feet?</li> <li>c) Is the minimum inside turning radius of the fire lane at least 28-feet?</li> <li>d) Is the grade of the fire lane not more than a slope of 8%?</li> <li>e) Is the fire lane posted as fire lane? (Provide detail of signage.)</li> <li>f) Is a roll-able curb used as part of the fire lane? (Provide detail of curb.)</li> <li>g) Is part of a sidewalk used as part of the required fire lane? (Must support +85,000 lbs.)</li> </ul> </li> </ul>	<ul> <li>X Yes</li> <li>X Yes</li> <li>X Yes</li> <li>X Yes</li> <li>X Yes</li> <li>Yes</li> <li>Yes</li> <li>Yes</li> <li>Yes</li> </ul>	☐ No	<ul> <li>N/A</li> <li>N/A</li> <li>N/A</li> <li>N/A</li> <li>N/A</li> <li>N/A</li> <li>N/A</li> <li>N/A</li> <li>N/A</li> </ul>
<ul><li>3. Is the fire lane obstructed by security gates or barricades? If yes:</li><li>a) Is the gate a minimum of 20-feet clear opening?</li><li>b) Is an approved means of emergency operations installed, key vault, padlock or key switch?</li></ul>	☐ Yes ☐ Yes ☐ Yes	X No  No  No	N/A N/A N/A N/A
4. Is the Fire lane dead-ended with a length greater than 150-feet?  If yes, does the area for turning around fire apparatus comply with IFC D103?	☐ Yes ☐ Yes	X No No	□ N/A X N/A
5. Is any portion of the building to be used for high-piled storage in accordance with IFC Chapter 3206.6 If yes, see IFC 3206.6 for further requirements.	Yes	X No	□ N/A
6. Is any part of the building greater than 30-feet above the grade plane?	X Yes	☐ No	□ N/A
<ul> <li>6. Is any part of the building greater than 30-feet above the grade plane?  If yes, answer the following questions:  a) Is the aerial apparatus fire lane parallel to one entire side of the building and covering at least 25% of the perimeter?  b) Is the near edge of the aerial apparatus fire lane between 15' and 30' from the building?  c) Are there any overhead power or utility lines located across the aerial apparatus fire lane?  d) Are there any tree canopies expected to grow across the aerial fire lane? (Based on mature canopy width of tree species) need discussion with Forestry  e) Does the aerial apparatus fire lane have a minimum unobstructed width of 26-feet?  f) Is the space between the aerial lane and the building free of trees exceeding 20' in heights?</li> </ul>	X Yes Yes Yes Yes Yes Yes Yes Yes Yes	No No No No No No No No No	<ul> <li>N/A</li> <li>N/A</li> <li>N/A</li> <li>N/A</li> <li>N/A</li> <li>N/A</li> <li>N/A</li> <li>N/A</li> </ul>

Attach an additional sheet if further explanation is required for any answers.

This worksheet is based on MGO 34.503 and IFC 2015 Edition Chapter 5 and Appendix D; please see the codes for further information.

#### GENERAL NOTES:

I. THE APPLICANT SHALL REPLACE ALL SIDEWALK AND CURB AND GUTTER THAT ABUTS THE PROPERTY THAT B DAMAGED BY THE CONSTRUCTION. OR ANY SIDEWALK AND CURB AND GUTTER WHICH THE CITY RENOMERS DETERMINES DETERMINES OF THE REPLACED SECALSE (T. B. NOT AT A DESIRABLE GRADE, REGAMDIS OF WHETHER THE CONDITION BUTTED PRIOR TO SERVAINAS CONSTRUCTION OF WHETHER THE CONDITION SUSTED PRIOR TO SERVAINAS CONSTRUCTION

2. ALL WORK IN THE PUBLIC RIGHT OF WAY SHALL BE PERFORMED BY A CITY-LICENSED CONTRACTOR.

3.ALL DAMAGE TO THE PAVEMENT ON CITY STREETS, AND ADJACENT TO THIS DEVELOPMENT SHALL BE RESTORED IN ACCORDANCE WITH THE CITY OF MADISON'S PAVEMENT PATCHING CRITERIA.

4. ALL PROPOSED STREET THEE RENOVALS MITHIN THE RIGHT OF WAY SHALL BE REVEWED BY CITY FORESTIVE BEFORE THE FLAN COMMENSION MESTING. STREET RESERVOING SEQUELA PREPOVAL AND A TREE REPROVALS REQUELED AFTER A THOU PERSON OF THE REPROVALS REQUESTED AFTER THE DEVELOPMENT THAN STREET THE REPROVALS REQUESTED AFTER THE DEVELOPMENT AND A PROPOSED BY THE PRAN COMMENSION OF THE BORNO OF DUBLE WORKS AND CITY FORESTY WILL REQUIRE A PRIMITING OF A 72-HOUR REVEY WESTOON OFFINISHED AND ALL RECOURT OF THE STREET THE REPROVALS PROPERTY OF THE REPROVALS PROPERTY OF THE REPROPOSAL OF THE REPROVALS PROPERTY OF THE REPROPOSAL OF THE REPROPOSATION OF THE REPROPOSATION OF THE REPROPOSATION OF THE REPROPOSATION OF THE REPROPOSATIO

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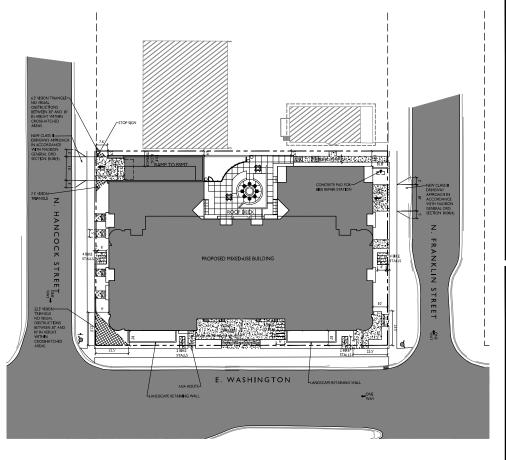
ACCONTRACTOR SHULL TAKE PRECAUTIONS DUMPIG CONSTRUCTION TO NOT DIPSCURE SCAR, OR PAPAR THE HEALTH OF ANY STREET TREE. CONTRACTOR SHALL OPERATE CONFIDENT IN A MANNES AT ON NOT DAMAGE OF THE SHARCHES OF THE STREET TREES, THE SWA REQUIRE LISHS SHALLES EQUIPMENT AND LOADING AND DUADAGE AND ATTEMPT AND ADEQUATE SHAPE SWAY FROM TREES ON THE CONSTRUCTION SITE ANY DAMAGE OR DUMPIT TO DESTINATION OF THE CONSTRUCTION SITE ANY DAMAGE OR DUMPIT TO DESTINATION OF THE CONSTRUCTION SITE ANY DAMAGE OR DUMPIT TO DESTINATION OF THE CONSTRUCTION SITE ANY DAMAGE OR DUMPIT TO DESTINATION OF THE CONSTRUCTION SITE ANY DAMAGE OR DUMPIT TO DESTINATION OF THE CONSTRUCTION SITE ANY DAMAGE. THE ANY DAMAGE OR DUMPIT TO DESTINATION OF THE CONSTRUCTION OF THE CONSTRU IMMEDIATELY TO CITY FORESTRY AT 266-4816. PENALTIES AND REMEDIATION SHALL BE REQUIRED.

7.SECTION 107 IJIG) OF CITY OF MADISON STANDARD SPECIFICATIONS FOR PUBLIC WORKS CONSTRUCTION ADDRESSES SIGL COMPACTION NEAR STREET THESE AND SHALL BE FOLLOWED BY CONTRACTOR. THE STORAGE OF PARKED VEHICLES CONSTRUCTION EQUIPMENT, BUILDING MATERIALS, REFUSE DECAYATED SPOULS OF DUMPHONG OF POSONOUS MATERIALS ON OR AROUND TRESS AND NOTS WHITHIN THE CHE TO THE RIFE OF WITHIN 11 THE PROTECTION ZONE IS PROHIBITED.

BON THE PROJECT, STREET TREE PROTECTION ZONE FENCING. IS REQUIRED. THE STRICKING SHALL BE RESCITED REFORE THE DEMOLITION, GRADING OR CONSTRUCTION BERKINS. THE FENCE SHALL INCLUDE THE BUTIES WIDTH OF TERRACE AND, DITAND AT LEAST SHEET ON BOTH SIDES OF THE OUTSIDE EDG OF THE TREE TRUME, DO NOT REPORT THE FENCING TO ALLOW FOR DELIVERIES OR SCHOOLSTONE THE STREAM OF THE CONTINUOUS THAT STREAM OF THE CONTINUOUS TO SOME

9.STREET TREE PRUNING SHALL BE COORDINATED WITH MADISON FORESTRY AT A MINIPUM OF TWO WEEKS PRIOR TO THE START OF CONSTRUCTION FOR THIS PROJECT. ALL RUNING SHALL FOLLOW THE AMERICAN NATIONAL STANDARDS INSTITUTE (ANSI) A300 - PART I STANDARDS FOR PRUNING.

- (0. APPROVAL OF PLANS FOR THIS PROJECT DOES NOT INCLUDE ANY APPROVAL TO PRUNE, REMOVE, OR PLANT TREES IN THE PUBLIC RIGHT-OF-WAY PERMISSION FOR SUCH ACTIVITIES MUST BE OBTAINED FROM THE CITY FORESTI (266-4816).
- II. THE PUBLIC RIGHT OF MAY IS THE SOLE JURISDICTION OF THE CITY OF MADISON AND IS SUBJECT TO CHANGE AT ANY TIME. NO ITEM SHOWN ON THIS SITE PLAN IN THE RIGHT COLWAY ARE PERMANENT AND MAY NEED TO BURENDWED AT THE APPLICANTS EXPENSE UPON NOTIFICATION BY THE CITY.





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SITE	
C-1.1	SITE PLAN
C-1.3	FIRE DEPARTMENT ACCESS
C-1.4	LOT COVERAGE
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C-1.0	EXISTING CONDITIONS
C-2.0	DEMOLITION PLAN
C-3.0	GRADING PLAN
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A-1.0	FRANKLIN ST LEVEL FLOOR PLAN
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A-3.12	HEIGHT LUSTRATION I
A-3.13	HEIGHT LLUSTRATION 2
A-3.14	SHADOW STLIDY
A-LI - A-3-Li	
77117-7-00	

Site Development Data: Zoning: UMX -URBAN MIXED-USE DISTRICT

Usable Open Space Lot Coverage

Building Height



SSUED Issued for Land Use Submittal - Sept. 2, 2020


Conditional UsE 26,329 S.F./.6 acres 148 units 178 S.F./unit 247 units/Acre 1,226 S.F. Approx. | PROVIDED | REQUIRED | 1,840 S.F./10 S.F./Bedroom) Min. | 22,541 S.F. (86%) | 23,696 S.F. (90%) Max. | 8+2 Dwelling Unit Mix
Efficiency
One Bedroom
One Bedroom + Den
Two bedroom
Total Dwelling Units THE Vehicle Parking Stalls
Underground Garage 146
Surface 0
Total 146 146 vehicle stalls .99 stall/unit PROVIDED Bicycle Parking Garage - wall mount REQUIRED Garage - floor mount Total Covered Secure Surface - Guest 148 15 (10% of units) 1 (1/2,000 S.F.) 164 bike stalls

PROJECT TITLE CONTINENTAL

BIKE RACKS: INTERIOR & EXTERIOR FLOOR MOUNTED: "INVERTED U" TYPE. MADRAX UX OR SARIS BIKE DOCK INTERIOR WALL MOUNTED: MADRAX VERTICAL RACK OR SARIS BIKE TRACK

414 E Washington Ave SHEET TITLE Site Plan

SHEET NUMBER

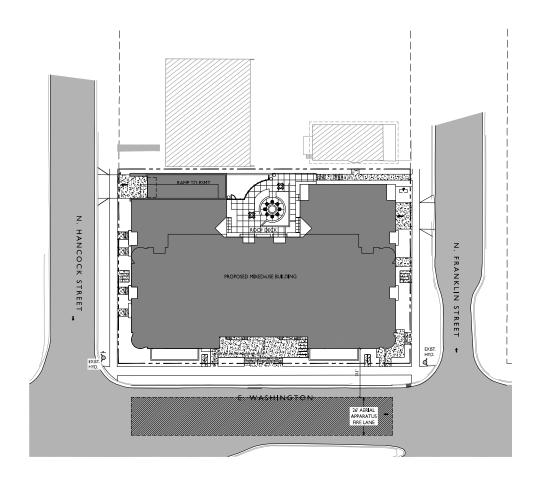









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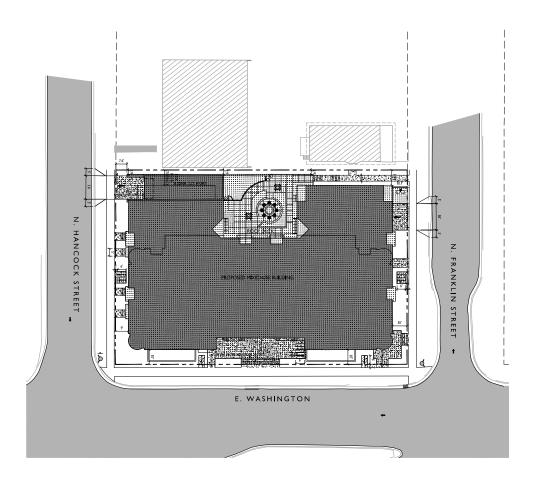
PROJECT TITLE
THE
CONTINENTAL

414 E Washington Ave
SHEET TITLE
Fire Department
Access Plan

SHEET NUMBER

C-1.3

PROJECT NO. 1972



LOT COVERAGE



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PROJECT TITLE
THE
CONTINENTAL

LOT COVERAGE

ZONING: UMX - URBAN MIXED-USE DISTRICT


ISE DISTRICT

TOTAL LOT AREA MAX. ALLOWED PROPOSED LOT COVERAGE 26,329 S.F. 23,696 S.F.(90%) 22,54**I** S.F. (86%) 4|4 E Washington Ave

SHEET TITLE
Lot Coverage

SHEET NUMBER

C-1.4

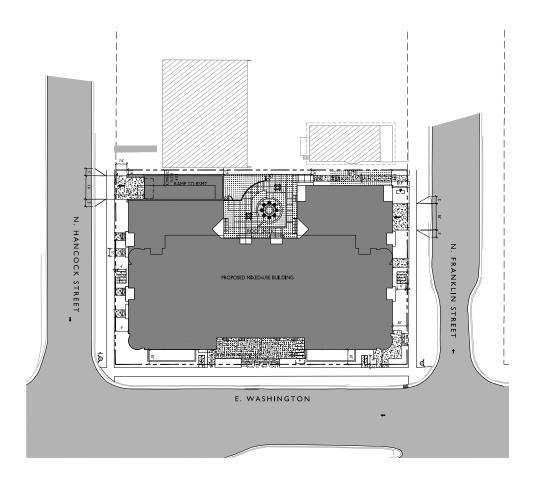



ISSUED Issued for Land Use -Sept. 2, 2020

PROJECT TITLE
THE

CONTINENTAL

 $\mathsf{GRAPH}\!\!\mathsf{IC}\;\mathsf{SCALE}$ USABLE OPEN SPACE

USABLE OPEN SPACE		000000
ZONING: UMX-URBAN MIXED-USE	DISTRICT	
REQUIRED OPEN SPACE	I0 S.F. / BEDROOM	
BEDROOMS	184	
	1,840 S.F. REQUIRED	
OPEN SPACE PROVIDED		
BALCONIES (54 S.F. X 148 S.F.)	7,992 S.F.	
ROOF DECKS/TERRACE	8,219 S.F.	
SURFACE	436 S.F.	
TOTAL	16.647 S.F. PROVIDE	)

414 E Washington Ave Space

SHEET NUMBER

1972

# INSTALL A 50'L X 20'W X 1.5'D TRACKING PAD AT THE SITE ENTRANCE. THE TRACKING PAD SHALL BE MAINTAINED/REPAIRED AS NECESSARY TO ACCOMMODATE CONSTRUCTION.

- THE CONTRACTOR IS REQUIRED TO MAKE EROSION CONTROL INSPECTIONS AT THE END OF EACH WEEK AND WHEN 0.5 INCHES OF RAIN FALLS WITHIN 24 HOURS. INSPECTION REPORTS SHALL BE PREPARED AND FILED AS REQUIRED BY THE DNR. ALL MAINTENANCE/REPAIR WILL FOLLOW AN INSPECTION WITHIN 24 HOURS.
- UTILITY STRUCTURE RIM AND TOP OF CURB ELEVATIONS ON PLANS ARE APPROXIMATE. UTILITY STRUCTURES SHALL BE SET TO FINAL ELEVATIONS AFTER THE CURB & GUTTER AND BASE COURSE HAVE BEEN INSTALLED.
- THE CONTRACTOR IS RESPONSIBLE FOR ANY DAMAGE CAUSED DURING CONSTRUCTION TO PUBLIC PROPERTY, PRIVATE PROPERTY OR UTILITIES.
- THE CONTRACTOR SHALL SUBMIT SHOP DRAWINGS FOR REVIEW BY THE ENGINEER, PRIOR TO PLACING AN ORDER OF ANY SUCH ITEM.
- 6. EXISTING TOPOGRAPHIC INFORMATION IS BASED ON FIELD OBSERVATIONS AND/OR PLAN OF RECORD DRAWNGS. CONTRACTOR SHALL VERIFY TOPOGRAPHIC INFORMATION PRIOR TO STARTING CONSTRUCTION.
- CONTRACTOR SHALL FELD VERFY LOCATION OF EXISTING SANTIARY SEVER, STOWN SEVER AND MATER MAN PRORT TO CONTRUCTION TO SESSION PROFESSION SEVER WITH LINES, CONTRACTOR MIGHT TAKE ALL INDECESSARY PRECAUTIONS TO PROTECT THE RESISTING UTILITIES DURING CONSTRUCTION. ANY DAMAGE TO THE EXISTING UTILITIES AND ANY REPARTS NEEDED AS A RESULT OF THE DAMAGE SHALL BE AT THE REPORTS OF THE CONTRACTOR REGARDLESS OF THE CONTRACTOR REFORM THE FIGURE OF SHOWN ON THE
- THE LOCATIONS OF EXISTING UTILITY INSTALLATIONS AS SHOWN ON THE PLAN ARE APPROXIMATE. THERE MAY BE OTHER UTILITY INSTALLATIONS WITHIN THE PROJECT AREA THAT ARE NOT SHOWN. CONTRACTOR SHALL BE RESPONSIBLE FOR CONTACTION GIOGERS HOTLINE AND LOCATING ALL EXISTING UTILITIES AND ENSURE PROPER CLEARANCE OF NEW UTILITIES.
- SEE DETAIL SHEETS FOR EROSION CONTROL NOTES AND CONSTRUCTION SEQUENCE.
- THE CONTRACTOR SHALL REMOVE ANY SEDIMENT TRACKED ONTO ADJACENT ROADS BY MEANS OF STREET SWEEPING (NOT FLUSHING) AT A MINIMUM OF THE END OF EACH WORK DAY OR MORE AS NEEDED.
- RIGHT OF WAY (ROW) AND PROPERTY LINES ARE APPROXIMATE. CONTRACTOR SHALL BE RESPONSIBLE FOR PROTECTING EXISTING PROPERTY CORNER MONUMENTATION. ANY MONUMENTS DISTURBED BY CONTRACTOR SHALL BE REPLACED AT THE CONTRACTORS EXPENSE.
- 12. CONTRACTOR SHALL COORDINATE WITH DRY UTILITY COMPANY'S REGARDING ANY POTENTIAL CONFLICTS AND COORDINATE RELOCATIONS AS MAY BE REQUIRED. CONTRACTOR SHALL ALSO COORDINATE THE PROPOSED INSTALLATION OF NEW FACILITIES
- 13. INSTALL WATER MAIN AT ADEQUATE DEPTH (MIN 6.5" OF COVER) TO AVOID CONFLICT WITH PROPOSED SANITARY SEWER AND STORM SEWER PER DNR STANDARDS EXCEPT WHERE NOTED ON THE PLANS. MANTAM MINIMUM 1.5" CLEAR SEPARATION IF WATER CROSSES BELOW SEWER AND MINIMUM 0.5" IF WATER CROSSES ABOVE.
- SANITARY MANHOLES WITH SEWER MAIN CONNECTIONS GREATER THAN 2' ABOVE THE LOWEST INVERT SHALL BE CONSTRUCTED WITH AN EXTERNAL DROP. MANHOLES WITH SEWER LATERAL CONNECTIONS GREATER THAT 2' ABOVE THE LOWEST INVERT SHALL BE CONSTRUCTED WITH AN INTERNAL DROP.
- INSTALL 1 SHEET OF 4'x8'x4" HIGH DENSITY STYROFOAM INSULATION AT ALL LOCATIONS WHERE STORM SEWER CROSSES WATER MAIN OR WATER LATERALS.
- 16. DIMENSIONS RELATING TO CURB ARE TO FACE OF CURB.
- CONTOURS ARE SHOWN FOR PURPOSES OF INDICATING ROUGH GRADING. FINAL GRADES SHALL BE ESTABLISHED ON PAVED SURFACES BY USING SPOT GRADES ONLY.
- 18. CROSS-SLOPE OF SIDEWALKS SHALL BE 2% UNLESS OTHERWISE NOTED.
- LONGITUDINAL GRADE OF SIDEWALK RAMPS SHALL NOT EXCEED 8.33% (1:12) AND SHALL BE IN ACCORDANCE WITH ADA REQUIREMENTS.
- LONGITUDINAL GRADE OF SIDEWALK SHALL NOT EXCEED 5.0% OR THE ADJACENT STREET GRADE WHICHEVER IS GREATER.
- 21. ACCESSIBLE ROUTES SHALL BE 5% MAX LONGITUDINAL SLOPE AND 2% MAX CROSS SLOPE. ACCESSIBLE JOADING AREAS OR LANDINGS SHALL BE 2% MAX SLOPE IN ANY DIRECTION. RAMPS SHALL BE 3.3% MAX SLOPE.
- 22. ADJUST ALL EXISTING MANHOLE AND VALVE RIMS TO FINAL GRADE.

- CONCRETE SIDEWALK TO BE  $5\mbox{"}$  THICK, CONSTRUCTED ON A BASE OF  $4\mbox{"}$  COMPACTED SAND OR CRUSHED STONE.
- CONCRETE FOR DRIVEWAYS AND SIDEWALK AT DRIVEWAY ENTRANCES SHALL BE 7" THICK, CONSTRUCTED ON A BASE OF 5" COMPACTED SAND OR CRUSHED STONE.
- 3. CURB FACE HEIGHT ON SITE SHALL BE 6 INCHES.
- CONTRACTOR TO OBTAIN ANY NECESSARY UTILITY CONNECTION, DEMOLITION, DRIVEWAY CONNECTION, RIGHT-OF-WAY AND EXCAVATION PERMITS PRIOR TO CONSTRUCTION.
- . CONTOURS ARE SHOWN FOR PURPOSES OF INDICATING ROUGH GRADING. FINAL GRADE SHALL BE ESTABLISHED ON PAVED SURFACES BY USING SPOT GRADES ONLY.
- ANY SIDEWALK AND CURB & GUTTER ABUTTING THE PROPERTY SHALL BE REPLACED IF IT IS DAMAGED DURING CONSTRUCTION OR IF THE CITY ENGINEERING DEPARTMENT GETERMINES THAT IT IS NOT AT A DESTRABLE GRADE, REGARDLESS OF WHETHER THE CONDITION EXISTED PRIOR TO BEGINNING CONSTRUCTION.

#### UTILITY NOTES:

- SANITARY & STORM SEWER LENGTHS SHOWN ARE FROM CENTER OF STRUCTURE TO CENTER OF STRUCTURE. STORM SEWER END SECTIONS ARE INCLUDED IN THE LENGTH AND SLOPE OF THE PIPE.
- 2. CONTRACTOR SHALL INVESTIGATE ALL UTILITY CROSSINGS PRIOR TO CONSTRUCTION AND NOTIFY ENGINEER OF ANY CONFLICTS.
- CONTRACTOR SHALL BE RESPONSIBLE FOR ADJUSTING ALL UTILITY STRUCTURES (MANHOLE RIMS, WATER VALVES, AND CURB STOPS), IF NECESSARY.
- CONTRACTOR SHALL OBTAIN ANY NECESSARY WORK IN RIGHT-OF WAY, EXCAVATION, UTILITY CONNECTION, PLUGGING, ABANDONMENT, AND DRIVEWAY CONNECTION PERMITS PRIOR TO CONSTRUCTION.
- FOR ALL SEWER AND WATER MAIN CROSSINGS: PROVIDE MINIMUM 18" SEPARATION WHEN WATER MAIN CROSSES BELOW SEWER AND MINIMUM 6" SEPARATION WHEN WATER MAIN CROSSES ABOVE SEWER.
- IF DEWATERING OPERATIONS EXCEED 70 GALLONS PER MINUTE OF PUMPING CAPACITY, A DEWATERING WELL PERMIT SHALL BE OBTAINED FROM THE DEPARTMENT PRIOR TO STARTING ANY DEWATERING ACTIVITIES.
- A COPY OF THE APPROVED UTILITY PLANS, SPECIFICATIONS AND PLUMBING PERMIT APPROVAL LETTER SHALL BE ON-SITE DURING CONSTRUCTION AND OPEN TO INSPECTION BY AUTHORIZED REPRESENTATIVES OF THE DEPARTMENT OF SAFETY AND PROFESSIONAL SERVICES AND OTHER LOCAL INSPECTOR.
- 8. STORM BUILDING SEWER PIPE SHALL CONFORM TO ONE OF THE STANDARDS LISTED IN TABLE 384.30-6 OF
- 9. PRIVATE WATER SERVICES AND PRIVATE WATER MAINS SHALL CONFORM TO ONE OF THE STANDARDS LISTED IN TABLE 384.30-7 OF SPS 384.30(4)(d).
- 10. PRIVATE SANITARY SEWER AND LATERALS SHALL BE POLYVINYL CHLORIDE (PVC) ASTM D3034 SDR 35 OR APPROVED EQUAL MATERIAL THAT CONFORMS TO ONE OF THE STANDARDS LISTED IN TABLE 384.30-3 OF
- 11. A MEANS TO LOCATE BURIED UNDERGROUND EXTERIOR NON METALLIC SEWERS/MAINS AND WATER SERVICES/MAINS MUST BE PROVIDED WITH TRACER WIRE OR OTHER METHODS IN ORDER TO BE LOCATED PER SPS 382:10(11)(n) AND SPS 382:40(6)(k).
- 12. EXTERIOR WATER SUPPLY PIPING SETBACKS AND CROSSINGS SHALL BE IN ACCORDANCE WITH SPS
- NO PERSON MAY ENGAGE IN PLUMBING WORK IN THE STATE UNLESS LICENSED TO DO SO BY THE DEPARTMENT OF SAFETY AND PROFESSIONAL SERVICES PER S.145.06.
- 14. SITE CONTRACTOR SHALL LEAVE SANITARY AND WATER LATERALS FIVE (5) FEET SHORT (HORIZONTALLY) FROM THE BUILDING. BUILDING PLUMBER SHALL VERIFY SIZE, LOCATION, AND INVERT ELEVATION OF PROPOSED SANITARY AND WATER LATERALS.
- 15. CONTRACTOR SHALL FIELD VERIFY THE SIZE, TYPE, LOCATION, AND ELEVATION OF EXISTING UTILITIES PRIOR TO INSTALLING ANY ON-SITE UTILITIES OR STRUCTURES. CONTACT ENGINEER PRIOR TO INSTALLATION IF DISCREPANCY EXISTS WITHIN THESE PLANS.
- 16. PROPOSED UTILITY SERVICE LINES SHOWN ARE APPROXIMATE. COORDINATE THE EXACT LOCATIONS WITH THE PLUMBING DRAWNISS. COORDINATE THE LOCATIONS WITH THE PLUMBING CONTRACTOR AND/OR OWNER'S CONSTRUCTION REPRESENTATIVE PRIOR TO INSTALLATION OF ANY NEW UTILITIES.
- 17. CONTRACTOR SHALL BE RESPONSIBLE FOR COORDINATING THE RELOCATION OF ANY UTILITIES ENCOUNTERED AND REPLACEMENT OF ANY UTILITIES DAMAGED WITHIN INFLUENCE ZONE OF NEW CONSTRUCTION. CONTACT ENGINEER IF THE EXISTING UTILITIES VARY APPRECIABLY FROM THE PLANS.
- 18. ALL WATER MAIN AND SERVICES SHALL BE INSTALLED AT A MINIMUM DEPTH OF 6.5' FROM TOP OF FINISHED GROUND ELEVATION TO TOP OF MAIN.
- 19. IT IS THE CONTRACTOR'S RESPONSIBILITY TO VERIFY THAT THE EXISTING VALVES WILL HOLD THE PRESSURE TEST PRIOR TO CONNECTION. THE CITY IS NOT RESPONSIBLE FOR ANY COSTS INCURRED DUE TO THE CONTRACTOR NOT VERIFYING THAT THE EXISTING VALVE WILL HOLD THE PRESSURE TEST PRIOR TO CONNECTION. IF A NEW VALVE IS REQUIRED, THE APPLICANT WILL BE REQUIRED TO INSTALL ONE AT THEIR EXPENSE, AT THE POINT OF CONNECTION.
- 20. CLEAN OUT ALL EXISTING AND PROPOSED STORM INLETS AND CATCH BASINS AT THE COMPLETION OF CONSTRUCTION.

#### DEMOLITION/EROSION CONTROL NOTES:

- CONTRACTOR SHALL KEEP ALL CITY STREETS FREE AND CLEAR OF CONSTRUCTION RELATED DIRT/DUST/DEBRIS.
- COORDINATE EXISTING UTILITY REMOVAL/ABANDONMENT WITH LOCAL AUTHORITIES AND UTILITY COMPANIES HAVING JURISDICTION.
- 3. ALL SAWCUTTING SHALL BE FULL DEPTH TO PROVIDE A CLEAN EDGE TO MATCH NEW CONSTRUCTION. MATCH EXISTING ELEVATIONS AT POINTS OF CONNECTION FOR NEW AND EXISTING PAVEMENT, CURB, SIDEWALKS, ETC. ALL SAWCUT LOCATIONS SHOWN ARE APPROXIMATE AND MAY BE FIELD ADJUSTED TO ACCOMMODIST CONDITIONS, JONTS, MATERIAL TYPE, ETC. REMOVE MINIMUM AMOUNT NECESSARY FOR INSTALLATION OF PROPOSED IMPROVEMENTS.
- CONTRACTOR SHALL PROVIDE AND SHALL BE RESPONSIBLE FOR ANY NECESSARY TRAFFIC CONTROL SIGNAG AND SAFETY MEASURES DURING DEMOLITION AND CONSTRUCTION OPERATIONS WITHIN OR NEAR THE PUBLIC ROADWAY.
- COORDINATE TREE REMOVAL WITH LANDSCAPE ARCHITECT. ALL TREES TO BE REMOVED SHALL BE REMOVED IN THEIR ENTIRETY AND STUMPS SHALL BE GROUND TO 12" BELOW PROPOSED SUBGRADE.
- 6. IF APPLICABLE, PROVIDE TREE PROTECTION FENCING PRIOR TO CONSTRUCTION OPERATIONS. MAINTAIN THROUGHOUT CONSTRUCTION.
- ALL LIGHT POLES TO BE REMOVED FROM PRIVATE PROPERTY SHALL BE REMOVED IN THEIR ENTIRETY, INCLUDING BASE AND ALL APPURTENANCES. COORDINATE ABANDONMENT OF ELECTRICAL LINES WITH ELECTRICAL ENGINEER AND OWNER PRIOR TO DEMOUTION.
- 8. CONTRACTOR SHALL OBTAIN ANY NECESSARY DEMOLITION AND UTILITY PLUGGING PERMITS.
- . THE LOCATION OF EXISTING UNDERGROUND UTILITIES AS SHOWN ON THE PLANS HAS BEEN DETERMINED FROM THE BEST AVAILABLE INFORMATION AND IS GIVEN FOR THE CONVENIENCE OF THE CONTRACTOR. THE OWNER AND THE ENGINEER DO NOT ASSUME RESPONSIBILITY IN THE EVENT THAT DURING CONSTRUCTION, UTILITIES OTHER THAN THOSE SHOWN MAY BE ENCOUNTERED, AND THAT THE ACTUAL LOCATION OF THOSE WHICH ARE SHOWN MAY BE OFFERENT FROM THE LOCATION AS SHOWN ON THE PLANS.
- ANY DAMAGE TO THE CITY PAVEMENT, INCLUDING DAMAGE RESULTING FROM CURB REPLACEMENT, WILL REQUIRE RESTORATION IN ACCORDANCE WITH THE CITY ENGINEERING PATCHING CRITERIA.

#### SURVEY LEGEND

- BENCHMARK
- x FOUND CHISELED "X"
- O FOUND 1" # IRON PIPE
- ⊗ FOUND 2" ø IRON PIPE ▲ FOUND P.K. NAIL
- FOUND 1 1/4" Ø IRON ROD
- FOUND 3/4" ø IRON ROD
- SET NAII

#### TOPOGRAPHIC SYMBOL LEGEND

- EXISTING BOLLARD
- EXISTING MAILBOXES
- **"EXISTING MONITORING WELL**
- EXISTING POST EXISTING SIGN
- EXISTING PARKING METER
- EXISTING CURB INLET
- EXISTING ROOF DRAIN
- EXISTING STORM MANHOLE
- EXISTING STORM MANHOLE RECTANGULAR
- EXISTING SANITARY CLEANOUT
- T EXISTING FIRE HYDRANT
- EXISTING WATER MAIN VALVE
- EXISTING CURB STOP
- EXISTING WATER MANHOLE
- M EXISTING GAS VALVE EXISTING GAS METER
- EXISTING DOWN GUY
- EXISTING ELECTRIC RECTANGULAR MANHOLE

  EXISTING ELECTRIC METER
- CEXISTING LIGHT POLE EXISTING UTILITY POLE
- M EXISTING TV PEDESTAL
- EXISTING TELEPHONE PEDESTAL ⊕ EXISTING UNIDENTIFIED MANHOLE
- EXISTING SHRUB
- EXISTING DECIDUOUS TREE

## TOPOGRAPHIC LINEWORK LEGEND

- " EXISTING FIBER OPTIC LINE EXISTING WOOD FENCE
- « EXISTING UNDERGROUND ELECTRIC LINE - ON - ON - EXISTING OVERHEAD GENERAL UTILITIES
- \_\_\_\_\_\_ SAVE \_\_\_\_ EXISTING 8" SANITARY SEWER LINE
- \$7 —— \$7 EXISTING STORM SEWER EXISTING 12" STORM SEWER LINE
- -sr - EXISTING 18" STORM SEWER LINE
- EXISTING 6" WATER MAIN EXISTING 12" WATER MAIN
  - - - 820 - EXISTING MAJOR CONTOUR
  - --- 818 --- EXISTING MINOR CONTOUR TOPOGRAPHIC HATCHING LEGEND
  - DETECTABLE WARNING PAVER CONCRETE PAVEMENT OR CONCRETE SIDEWALK ASPHALT PAVEMENT
    - CONRETE WALL

- GRADING LEGEND
- −820 EXISTING MAJOR CONTOURS <del>-(820)</del>-- PROPOSED MAJOR CONTOURS
- 2.92% PROPOSED SLOPE ARROWS ·b-1048.61
- EXISTING SPOT ELEVATIONS 1048.61 PROPOSED SPOT ELEVATIONS
- 0 INLET PROTECTION SILT FENCE - - - DISTURBED LIMITS  $\Rightarrow$ DRAINAGE DIRECTION
- EROSION MAT CLASS 1, TYPE A
- TRACKING PAD

## PROPOSED UTILITY LEGEND

- WATER SERVICE LATERAL PIPE SANITARY SEWER LATERAL PIPE
- σ σ GAS MAIN - w - w - ELECTRIC SERVICE

# ABBREVIATIONS STMH — STORM MANHOLE FI — FIELD INLET CI — CURB INLET CB — CATCH BASIN EW — ENDWALL SMH — SANITARY MANHOL

# DEMOLITION PLAN LEGEND



— — SAWCUT

#### X UTILITY STRUCTURE REMOVAL - UTILITY LINE REMOVAL

SITE PLAN LEGEND PROPERTY BOUNDARY CURB AND GUTTER (REVERSE CURB HATCHED)

PROPOSED CONCRETE PROPOSED SIGN PROPOSED LIGHT POLE PROPOSED BOLLARD

PROPOSED ADA DETECTABLE WARNING FIELD



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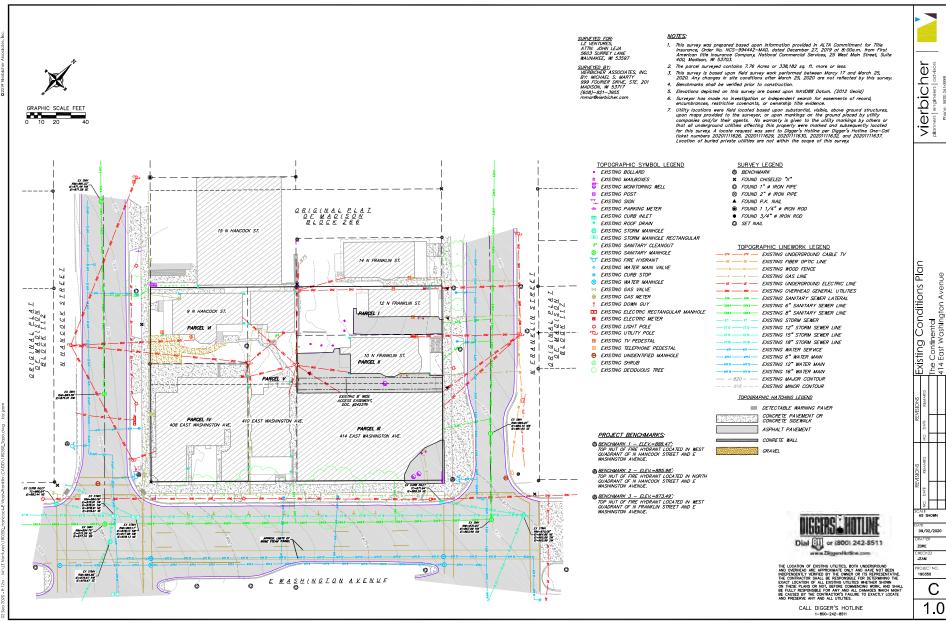
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Legends ∞ŏ Votes Cont ₽ 7

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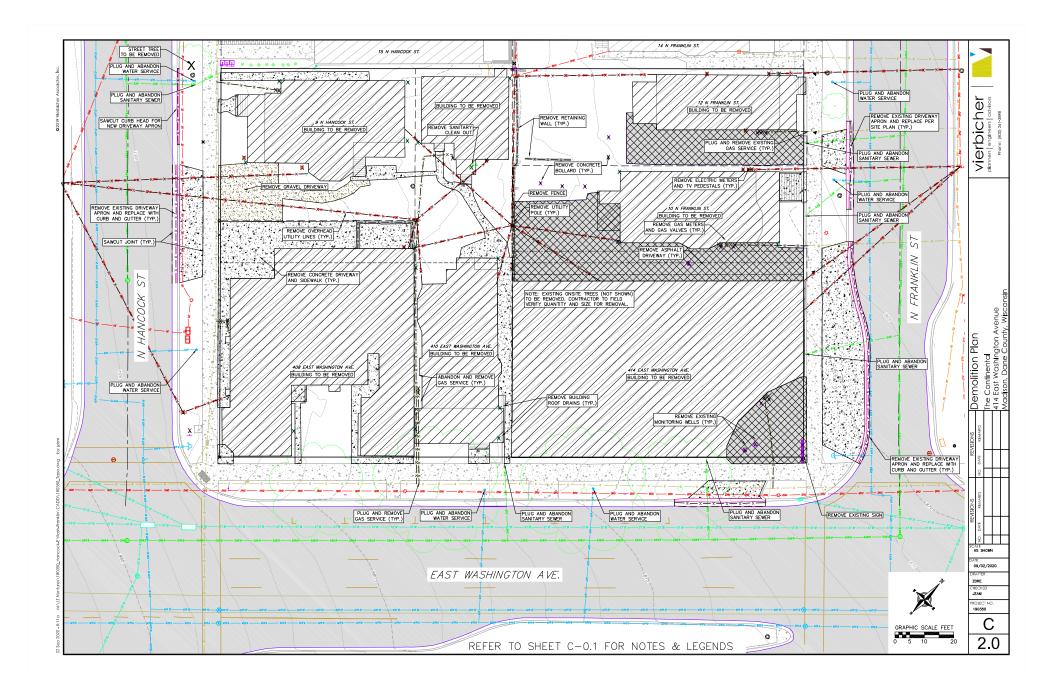
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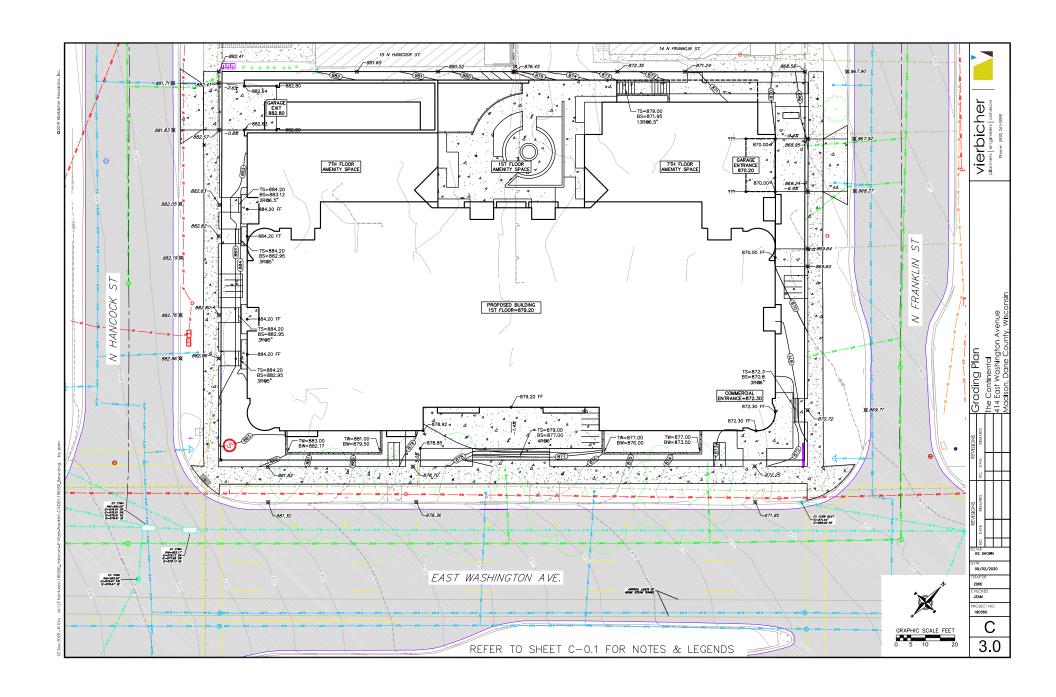
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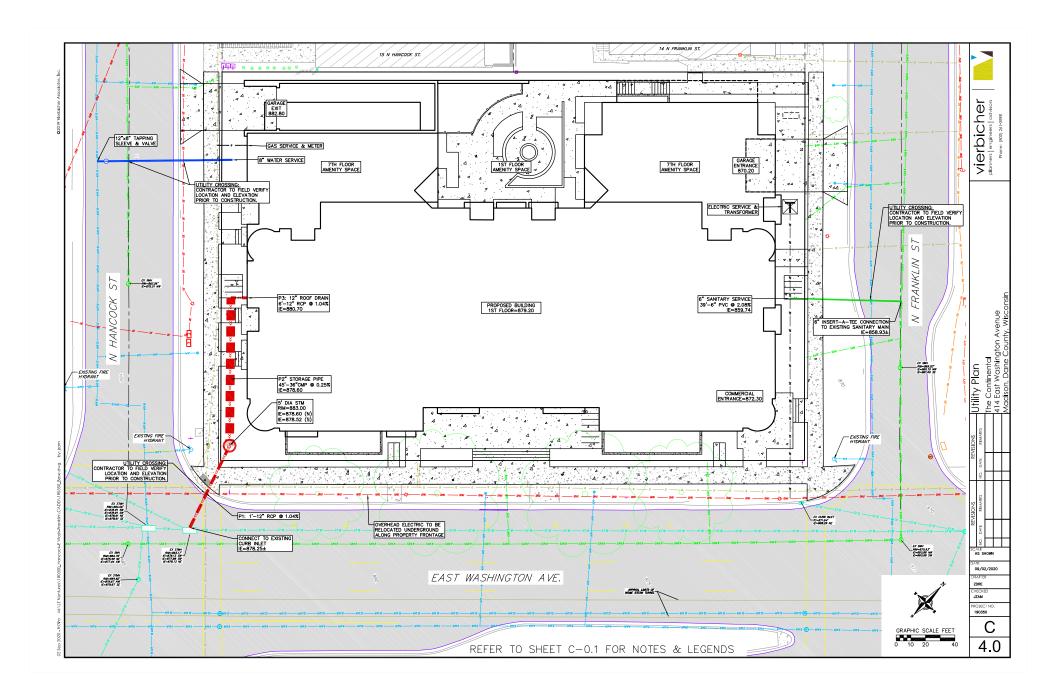



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kisting Conditions Plan
e Continental
4 East Washington Avenue
adison, Dane County, Wisconsin he 14 6







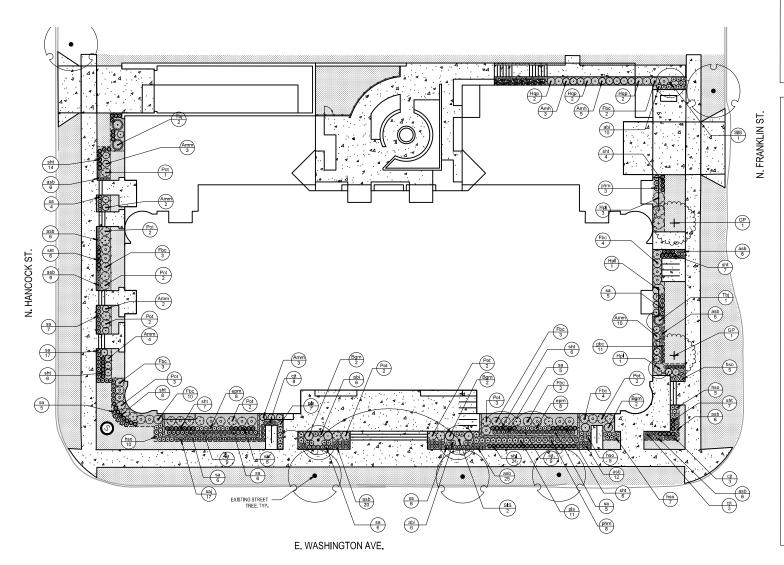

### LEGEND

 TURE HARDWOOD BARK MULCH

ALUMINUM EDGING DECORATIVE STONE MULCH

#### NOTES

- ALL PROPOSED STREET TREE REMOVALS WITHIN THE RIGHT OF WAY SHALL BE REVIEWED BY CITY FORESTRY BEFORE THE PLAN COMMISSION MEETING, STREET TREE REMOVALS REQUIRE APPROVAL AND A TREE REMOVAL PERMIT ISSUED BY CITY FORESTRY, ANY STREET TREE REMOVALS REQUESTED AFTER THE DEVELOPMENT PLAN IS APPROVED BY THE PLAN COMMISSION OR THE BOARD OF PUBLIC WORKS AND CITY FORESTRY WILL REQUIRE A MINIMUM OF 72-HOUR REVIEW PERIOD WHICH SHALL INCLUDE THE NOTIFICATION OF THE ALDERPERSON WITHIN WHO'S DISTRICT IS AFFECTED BY THE STREET TREE REMOVAL(S) PRIOR TO A TREE REMOVAL PERMIT BEING
- ISSUED.

  AS DEFINED BY THE SECTION 107.13 OF CITY OF MADISON STANDARD SPECIFICATIONS FOR PUBLIC WORKS STANDARD SPECIFICATIONS FOR PUBLIC WORKS
  CONSTRUCTION NO EXCAVATION IS PERMITTED WITHIN 5
  FEET OF THE TRUNK OF THE STREET TREE OR WHEN
  CUTTING ROOTS OVER 3 INCHES IN DIAMETER, IF EXCAVATION IS NECESSARY, THE CONTRACTOR SHALL CONTACT MADISON CITY FORESTRY (266-4916) PRIOR TO EXCAVATION. CITY OF MADISON FORESTRY PERSONNEL SHALL ASSESS THE IMPACT TO THE TREE AND TO ITS ROOT SYSTEM PRIOR TO WORK COMMENCING, TREE PROTECTION SPECIFICATIONS CAN BE FOUND ON THE FOLLOWING WEBSITE: HTTP://WWW.CITYOFMADISON.COM/BUSINESS/PW/SPECS.CFM
- CONTRACTOR SHALL TAKE PRECAUTIONS DURING CONSTRUCTION TO NOT DISFIGURE, SCAR, OR IMPAIR THE HEALTH OF ANY STREET TREE. CONTRACTOR SHALL PREALTH OF ANY SIRGEL TIRES, CONTRACT ORS WALL OPERATE EQUIPMENT IN A MANNER AS TO NOT DAMAGE THE BRANCHES OF THE STREET TREE(S), THIS MAY REQUIRE USING SMALLER EQUIPMENT AND LOADING AND UNLOADING MATERIALS IN A DESIGNATED SPACE AWAY FROM TREES ON THE CONSTRUCTION SITE. ANY DAMAGE OR INJURY TO EXISTING STREET TREES (EITHER ABOVE OR BELOW GROUND) SHALL BE REPORTED IMMEDIATELY TO
- BELOW GROUND, SHALL BE REPORTED IMMEDIATELY TO CITY FORESTRY AT 268-446, PENALTIES AND REMODIATION SHALL BE REDULRED. SECTION 1072 145(9) OF CITY OF MADISON STANDARD SPECIFICATIONS FOR PUBLIC WORKS CONSTRUCTION ADDRESSES SIG. COMPACTION HEAR STREET TREES AND SHALL BE FOLLOWED BY CONTRACTOR. THE STORKE OF PARKED VEHICLES, CONSTRUCTION COLIFIENT, BUILDING MATERNALS, REFUSE, EXCAVATED SPOLIS OR DUMPING OF
- MATERIALS, REPUSE, DICAVATED SPOLLS OR DUMPNSO OF POISONOUS MATERIALS ON OR AROUND TREES AND ROOTS WITHIN THE (5) FEET OF THE TREE OR MITHIN THE PROTECTION ZOWES IS PROHIBITED. ON THIS PROJECT, STREET TREE PROTECTION ZOWE FEMOLIS ES PROJUBED. THE FEBOR'S HALL BE FERCE'ED BEFORE THE DEMOLITED WEB THE DEMOLIS FOR CONSTRUCTION BEGINS. FROMING OR CONSTRUCTION BEGINS. THE FENCE SHALL INCLIDE THE SWITKE WIDTH OF TERRACE AND. EXTEND AT LEAST 5 FEET ON BOTH SIDES OF THE OUTSIDE EDGE OF THE TREE TRUNK, DO NOT REMOVE THE FENCING TO ALLOW FOR DELIVERIES OR EQUIPMENT ACCESS
- THROUGH THE TREE PROTECTION ZONE.

  STREET TREE PRUNING SHALL BE COORDINATED WITH
  MADISON FORESTRY AT A MINIMUM OF TWO WEEKS PRIOR TO THE START OF CONSTRUCTION FOR THIS PROJECT, ALL PRUNING SHALL FOLLOW THE AMERICAN NATIONAL STANDARDS INSTITUTE (ANSI) A300 - PART 1 STANDARDS FOR PRUNING.
- AT LEAST ONE WEEK PRIOR TO STREET TREE PLANTING. CONTRACTOR SHALL CONTACT CITY FORESTRY AT (608)266-4816 TO SCHEDULE INSPECTION AND APPROVAL OF NURSERY TREE STOCK AND REVIEW PLANTING SPECIFICATIONS WITH THE LANDSCAPER.





Issued for Land Use Submittal -September 2, 2020

PROJECT TITLE THE CONTINENTAL

414 E Washington Ave SHEET TITLE

Landscape Plan

SHEET NUMBER

Landscape Plan

SCALE: 1" = 10'-0'



PLANT SCHEDULE					
ORNAMENTAL TREES	CODE	BOTANICAL / COMMON NAME	CONT	SIZE	QTY
$(\cdot)$	SIS	Syringa reticulata "Ivory Silk" / Ivory Silk Japanese Tree Lilac	B & B	1.5°Cal	3
DECIDUOUS TREES	CODE	BOTANICAL / COMMON NAME	CONT	SIZE	QTY
(+)	GP	Ginkgo biloba 'Princeton Sentry' / Princeton Sentry Ginkgo	B & B	2,5*Cal	2
DECIDUOUS SHRUBS	CODE	BOTANICAL / COMMON NAME	SIZE	SIZE	QTY
0	Amh	Aronia melanocarpa 'Low Scape Hedger' / Low Scape Hedger Chokeberry	3 gal	18" HT (MIN.)	8
<b>O</b>	Amm	Aronia melanocarpa "UCONNAM165" TM / Low Scape Mound Chokeberry	3 gal	12" HT (MIN.)	27
<b>(</b>	Fbc	Fothergilla gardenii 'Beaver Creek' / Dwarf Witchalder	3 gal	18" HT, (MIN.)	32
(±)	Hpl	Hydrangea paniculata 'Little Quick Fire' / Little Quick Fire Hydrangea	3 gal	18" HT (MIN.)	5
⊙	Нզр	Hydrangea quercifolia "Pee Wee" / Pee Wee Oakleaf Hydrangea	3 gal	18" HT (MIN.)	6
$\odot$	Pat	Physocarpus opulfolius "Tiny Wine" / Tiny Wine Ninebark	3 gal	18" HT (MIN.)	28
EVERGREEN SHRUBS	CODE	BOTANICAL / COMMON NAME	SIZE	SIZE	QTY
$\odot$	Bgm	Buxus x 'Green Mound' / Green Mound Boxwood	5 gal	18" HT (MIN.)	6
O	Tbj	Thuja occidenta Is `Bail John` / Technito Arborvitae	8&8	4' HT, (MIN.)	3
HERBACEOUS PERENNIALS	CODE	BOTANICAL / COMMON NAME	SIZE	SIZE	QTY
$\odot$	asb	Allium tanguticum 'Summer Beauty' / Summer Beauty Allium	1 gal		110
$\oplus$	abi	Amsonia tabernaemontana 'Blue Ice' / Blue Ice Blue Star	1 gal		22
<b>£</b> 3	cjt	Coreopsis x 'Jethro Tull' / Jethro Tull Tickseed	1 gal		32
$\odot$	epm	Echinacea x "Pixie Meadowbrite" / Pixie Meadowbrite Purple Conefigwer	1 gal		16
€3	gbc	Geranium x cantabrigiense 'Blokovo Carmina' / Carmine Blokovo Geranium	1 gal		11
$\odot$	hso	Hemerocallis x "Stella de Oro" / Stella de Oro Daylily	1 gal		32
0	pls	Perovskia atripficifofa 'Little Spire' TM / Little Spire Russian Sage	1 gal		18
$\oplus$	saj	Sedum x 'Autumn Joy' / Autumn Joy Sedum	1 gal		17
ORNAMENTAL GRASSES	CODE	BOTANICAL / COMMON NAME	SIZE	SIZE	QTY
☺	phm	Panicum virgatum 'Heavy Metal' / Blue Switch Grass	1 gal		11
0	sa	Seslería autumnalis / Autumn Moor Grass	1 gal		68
0	sht	Sporobolus heterolepis 'Tara' / Prairie Dropseed	1 gal		102

Plant Schedule

				Landscape Point
Developed Lots	SF	Acres		Subtotal
Total Developed Area(Lot - Building Area)	5,647	0.13		
Landscape Points (5 pts/300 SF for firs: 5 ac	res, 1 pt/100 SF fe	or additional)		9
		Lands	cape Points Required	
Development Frontage - N. Franklin			Overstery Trees	
St.	LF			Shrubs Required
Total LF of Street Frontage Between Parking/Builling & Street	132		4	22
	T	Quantity	Quantity	
Element	Point Value	Proposed	Existing	Points Achieved
Overstory Deciduous Free	35	2		70
Tall Evergreen Tree Ornamental Tree	35 15	1		15
Upright Evergreen Shrub	10	1		10
Shrub, deciduous	3	21	-	63
Shrub, deciduous Shrub, evergreen	4	41		0
Ornamental Grass/Perennial	2	89	-	178
under contra			Frontage Foints Total	336
Development Frontage - E.				
Washington Ave.	LF		Overstery Trees Required*	Shrubs Required
Total LF of Street Frontage				
Between Parking/Building & Street	200		7	33
		Quantity	Quantity	
Element	Point Value	Proposed	Existing	Points Achieved
Overstory Deciduous Free	35		•	0
Tall Evergreen Tree	35			0
Ornamental Tree	15	2		30
Upright Evergreen Shrub	10			0
Shrub, deciduous	3	33		99
Shrub, evergreen	4	6		24
Ornamental Grass/Perennial	2	275	Frontage Foints Total	550 <b>703</b>
		Development	riontage roints rotal	703
Development Frontage - N. Hancock St.	LF		Overstery Trees Required*	Shrubs Required
Total LF of Street Frontage	132		4	22
Between Parking/Builting & Street	132		4	22
Element	Point Value	Quantity Proposed	Quantity Existing	Points Achieved
Overstory Deciduous Free	35 35			0
Tall Evergreen Tree Ornamental Tree	15			0
Upright Evergreen Shrub	10	2		20
Shrub, deciduous	3	37	-	111
Shrub, decidoous Shrub, evergreen	4			0
Ornamental Grass/Perennial	2	94		188
		Development	Frontage Foints Total	319
General Site, Foundation, Screening				
	I	Quantity	Quantity	
Element Ourseless Desidues a Free	Point Value	Proposed	Existing	Points Achieved
Overstory Deciduous Free Tall Evergreen Tree	35			0
Ornamental Tree	15			0
Upright Evergreen Shrub	10			0
Shrub, deciduous	3	14		42
Shrub, evergreen	4			0
Ornamental Grass/Perennial	2			0
Ornamental/Decorative Fence				
or Wall (4 pts/10 LF)	4			0

\* Tao (2) or namental trees or two (2) evergreen rees may be used in place of one (1) overstoy deciduous tree.
\*\* Two (2) omamental deciduous trees may be substitute for one (1) carcopy tree, but ornamental trees shall constitute no more than twenty-five-general (25%) of the required trees.

Landscape Worksheet






ISSUED Issued for Land Use Submittal — September 2, 2020

PROJECT TITLE THE CONTINENTAL

414 E Washington Ave SHEET ΠΤΙΕ Plant Schedule and Landscape Worksheet

SHEET NUMBER

PROJECT NO. 1972 Knothe & Bruce Architects,

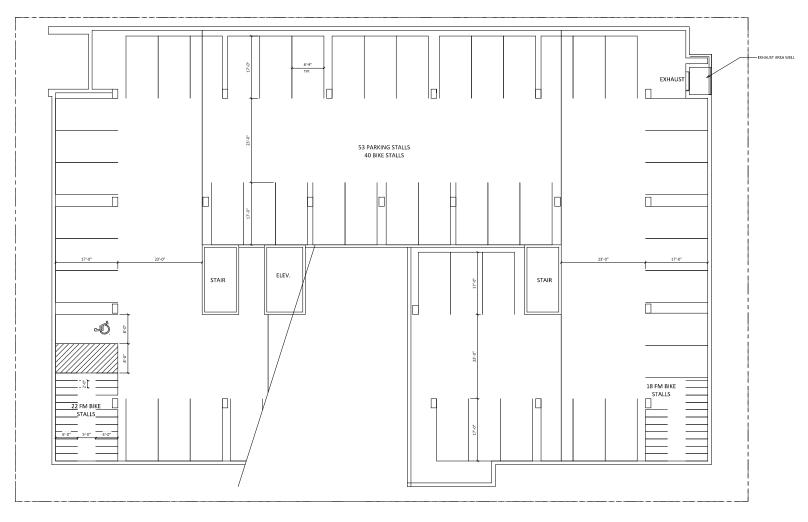

UNDERGROUND PARKING LEVEL 2



ISSUED Issued for Land Use April 1, 2020


PROJECT TITLE
THE
CONTINENTAL

Ave
SHEETTITLE
UNDERGROUND

PARKING LEVEL
2

SHEET NUMBER

A-1.P2

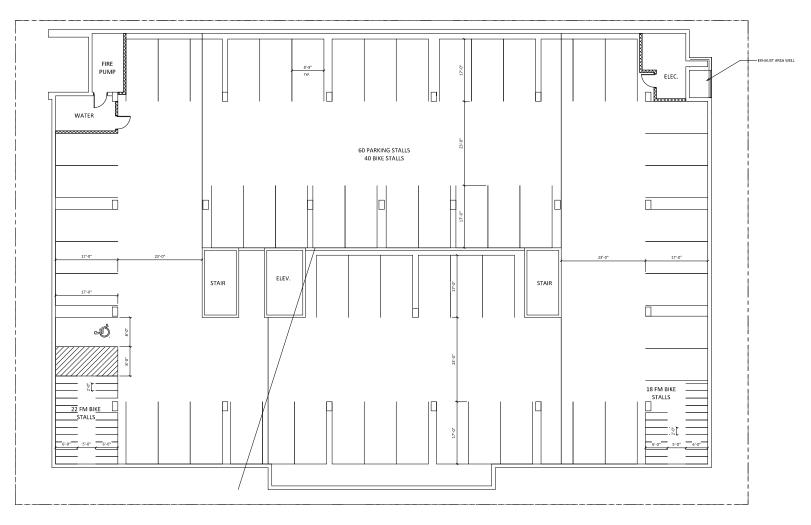

UNDERGROUND PARKING LEVEL 1




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PROJECT TITLE
THE
CONTINENTAL

Ave
SHEETTITLE
UNDERGROUND

UNDERGROUND PARKING LEVEL 1

SHEET NUMBER

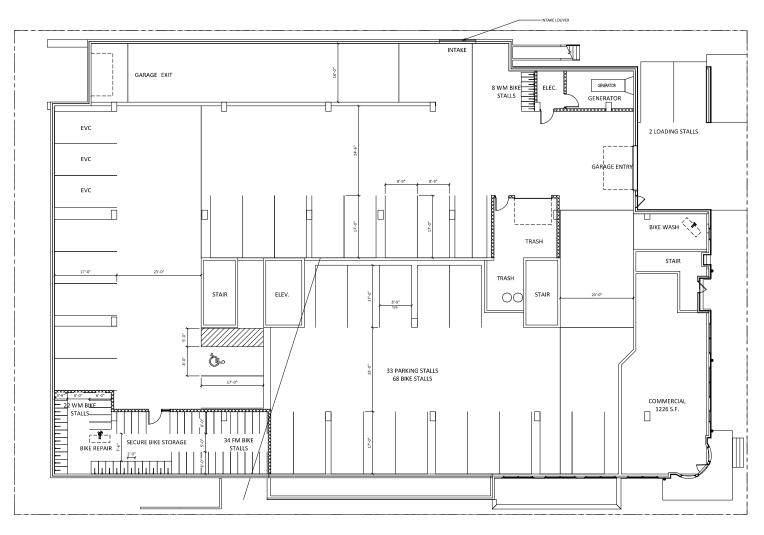

FRANKLIN ST. LEVEL FLOOR PLAN



ISSUED Issued for Land Use April 1, 2020

THE CONTINENTAL


PROJECT TITLE

414 E Washington Ave

SHEET TITLE FRANKLIN ST.

LEVEL FLOOR PLAN

SHEET NUMBER

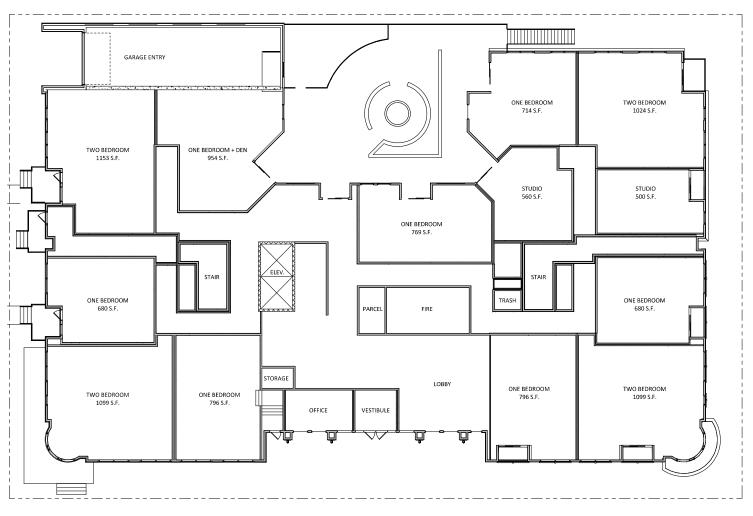

FIRST FLOOR PLAN



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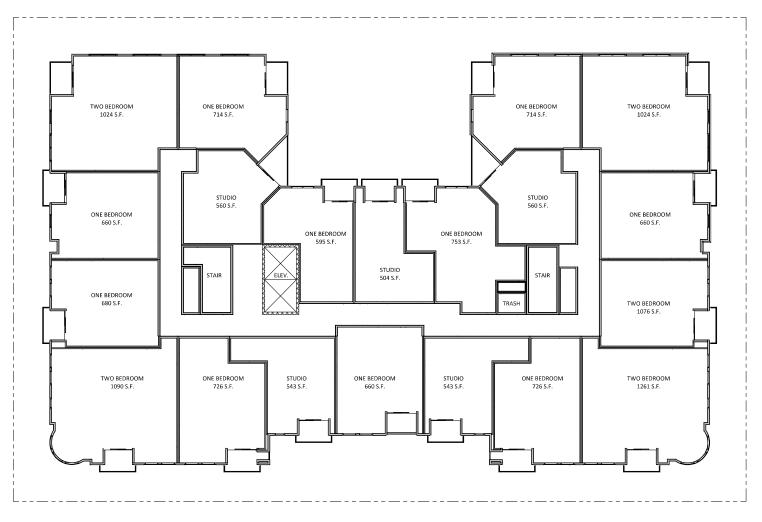
PROJECT TITLE

THE CONTINENTAL

414 E Washington

Ave
SHEET TITLE
FIRST FLOOR PLAN

SHEET NUMBER



SECOND - FIFTH FLOOR PLAN



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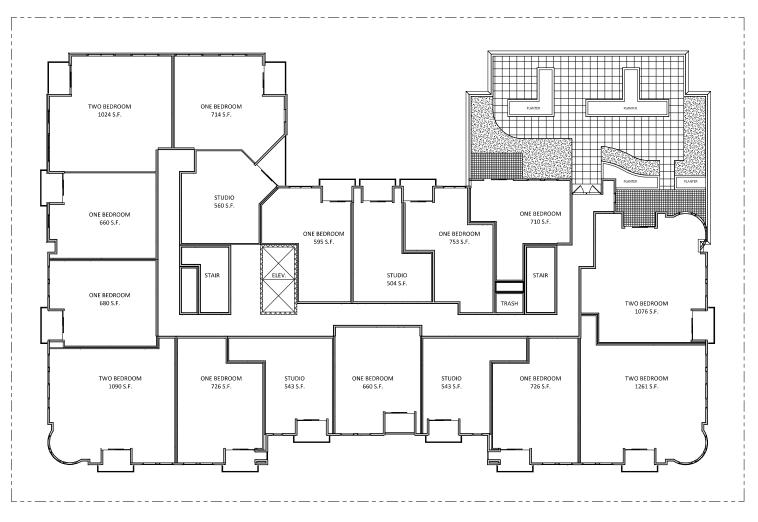
PROJECT TITLE

THE CONTINENTAL

414 E Washington

Ave
SHEET TITLE
FIFTH FLOOR PLAN

SHEET NUMBER







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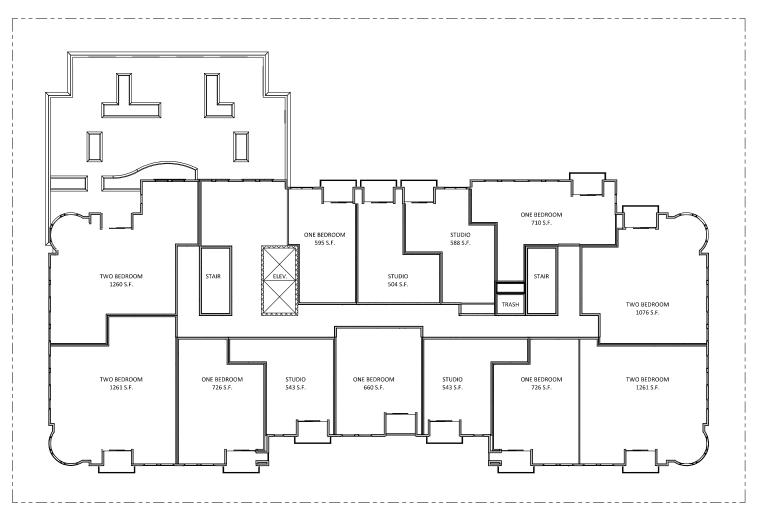
PROJECT TITLE

THE CONTINENTAL

414 E Washington Ave

SHEET TITLE SIXTH FLOOR PLAN

SHEET NUMBER



SEVENTH FLOOR PLAN




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PROJECT TITLE
THE
CONTINENTAL

414 E Washington
Ave
SHEET TITLE
SEVENTH FLOOR

SEVENTH FLOO PLAN

SHEET NUMBER



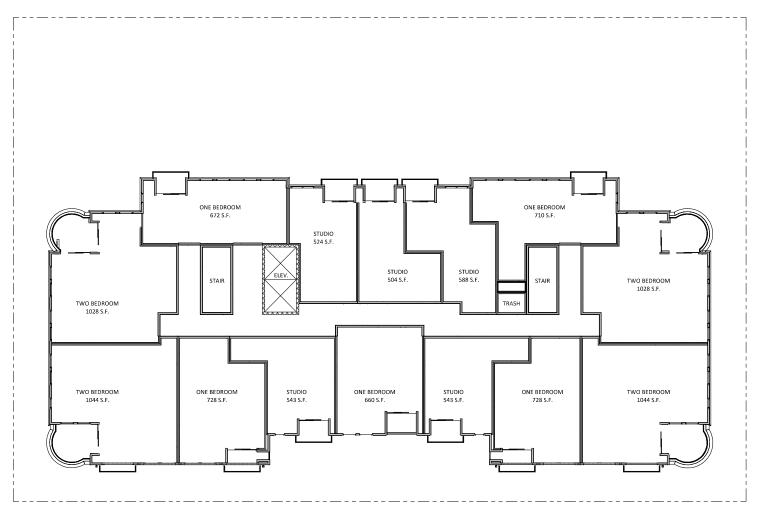



ISSUED Issued for Land Use April 1, 2020 Issued for Land Use September 2, 2020


PROJECT TITLE

THE CONTINENTAL

414 E Washington

Ave
SHEET TITLE
EIGHTH FLOOR PLAN

SHEET NUMBER

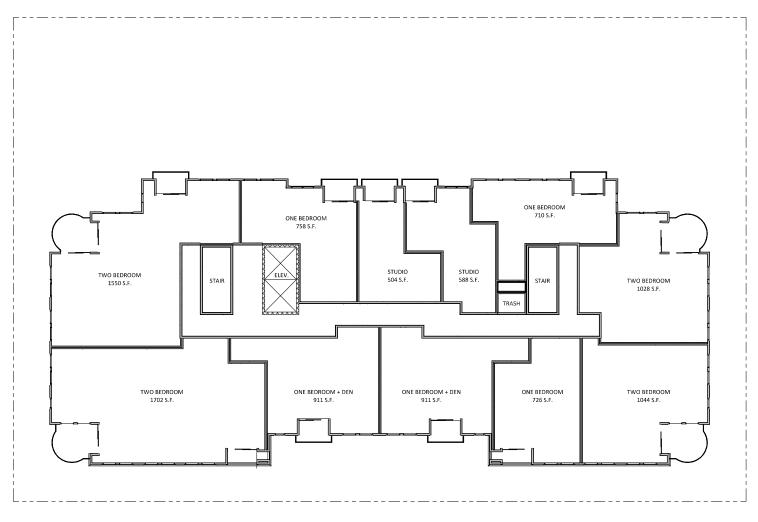





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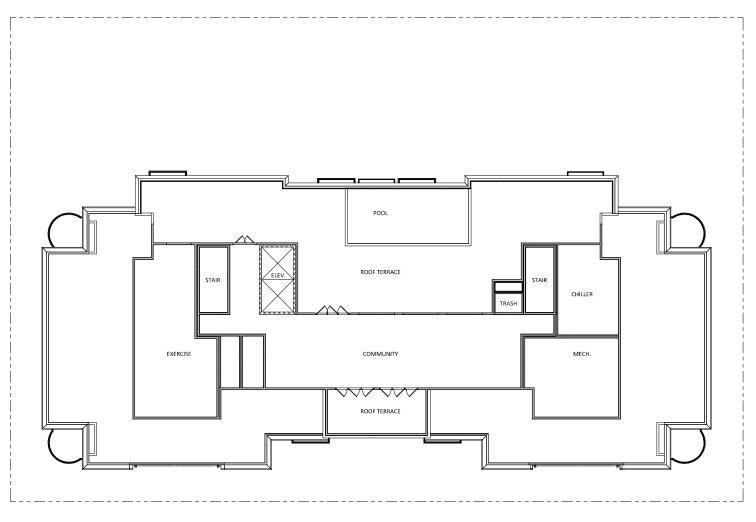
PROJECT TITLE THE

CONTINENTAL

414 E Washington

Ave
SHEET TITLE
NINTH FLOOR PLAN

SHEET NUMBER



PENTHOUSE PLAN




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PROJECT TITLE THE CONTINENTAL

414 E Washington Ave SHEET TITLE

PENTHOUSE PLAN

SHEET NUMBER

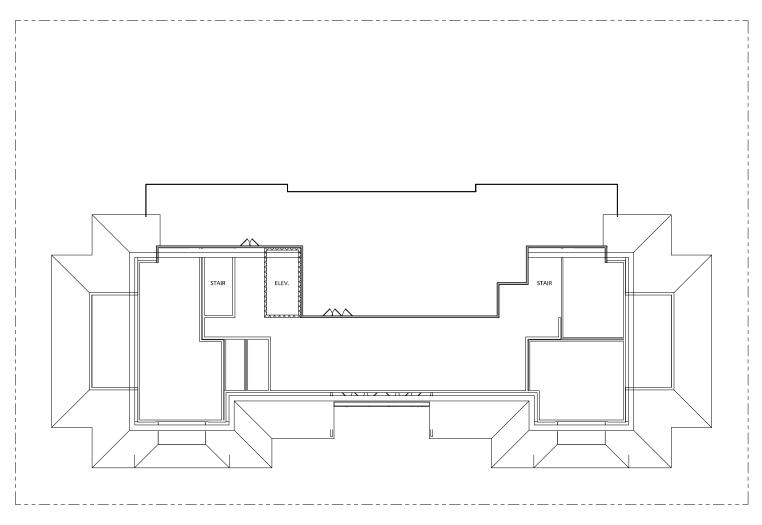

MECHANICAL PENTHOUSE FLOOR PLAN



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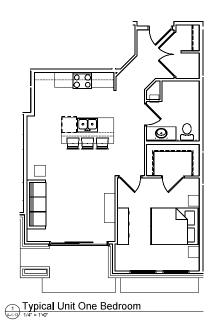
PROJECT TITLE THE


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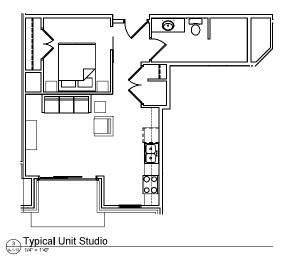
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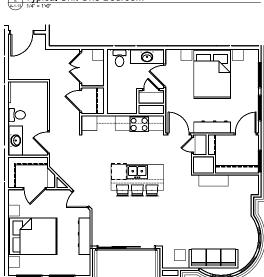
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SHEET TITLE
ROOF PLAN

SHEET NUMBER







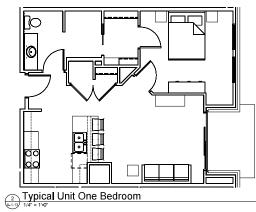

Typical Unit Two Bedroom



ISSUED May 20, 2020

PROJECT TITLE THE

CONTINENTAL

414 E Washington

Ave


SHEET TITLE

Typical Unit

Type

SHEET NUMBER

A-1.13

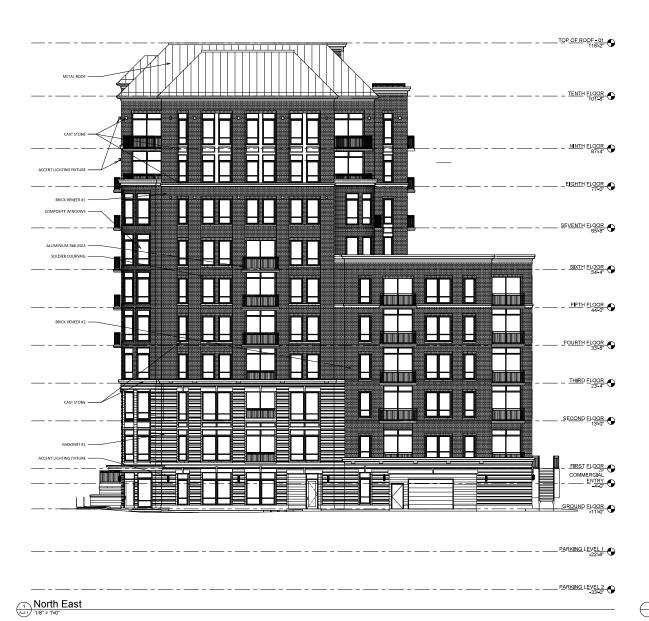



ISSUED

PROJECT TITLE THE

CONTINENTAL

EXTERIOR MATERIAL SCHEDULE					
BUILDING ELEMENT	MANUFACTURER	COLOR			
BRICK VENEER - (#1)	SUMMIT	FAWN SMOOTH			
BRICK VENEER - (#2)	CLOUD CERAMICS	KANSAS GOLD			
MASONRY - (II1) - ARRISCRAFT RENAISSANCE STONE OR CORDOVA STONE BUFF	ARRISCRAFT	SANDRIFT			
STANDING SEAM METAL ROOF	(TBD)	SLATE			
WINDOWS	N/A	CAMEO			
STOREFRONT	FIBERGLASS OR ALUMINIUM	BLACK			
METAL DOORS/FRAMES	N/A	(TBD)			
STONE SILLS & BANDS	EDWARDS	COLOR TO MATCH STONE VENEER			
SOFFITS & FASCIA	N/A	(TBO)			
RAILINGS	N/A	BLACK			

Elevations - Exterior Material Schedule

414 E Washington Ave

SHEET TITLE
EXTERIOR
ELEVATIONS

SHEET NUMBER



North West

Knothe \* bruce
A R G H I T E G T B
Indian to hill Make W NH

ISSUED Issued for Land Use April 1, 2020

PROJECT TITLE THE

CONTINENTAL

414 E Washington Ave

SHEET TITLE
EXTERIOR
ELEVATIONS

SHEET NUMBER

PROJECT NUMBER 1972

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Elevations - Exterior Material Schedule

FIBERGLASS OR ALUMINIUM BLACK

EDWARDS

(TBD)

COLOR TO MATCH STONE VENEER

TOREFRONT

SOFFITS & FASCIA

METAL DOORS/FRAMES

STONE SILLS & BANDS



Elevations - Exterior Material Schedule

Inothebreca.com 608.836.3680 7601 Mildennity Ave. 1 Saite 701 1 Middletes WI 53567 KEY PLAN

ISSUED Issued for Land Use April 1, 2020 Issued for Land Use September 2, 2


PROJECT TITLE THE

CONTINENTAL

414 E Washington Ave

SHEET TITLE **EXTERIOR ELEVATIONS** 

SHEET NUMBER

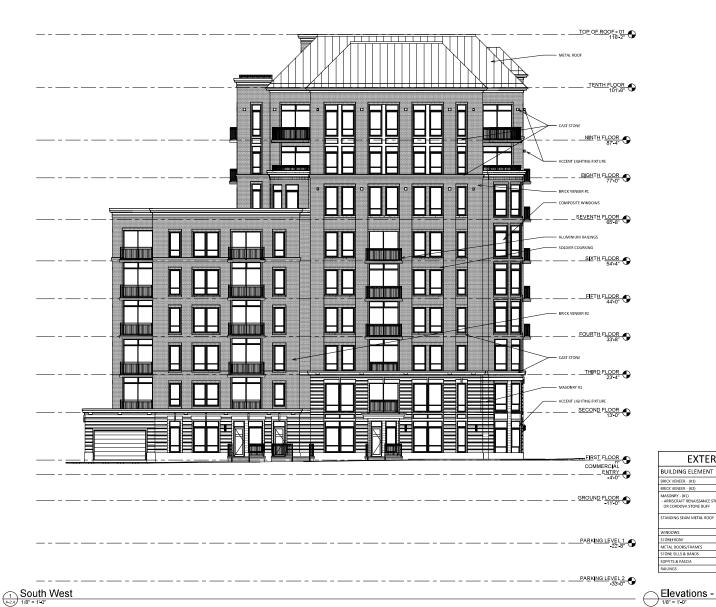



ISSUED Issued for Land Use April 1, 2020 Issued for Land Use September 2, 2020

PROJECT TITLE THE CONTINENTAL

414 E Washington Ave SHEET TITLE

**EXTERIOR ELEVATIONS** 

SHEET NUMBER

PROJECT NUMBER 1972

Elevations - Exterior Material Schedule

(TBD)

N/A FIBERGLASS OR ALL

BRICK VENEER - (#1) RICK VENEER - (W2)

TANDING SEAM METAL ROOF

METAL DOORS/FRAMES

**EXTERIOR MATERIAL SCHEDULE** 

MANUFACTURER

COLOR

COLOR TO MATCH STONE VENEER (TBD)

SLATE

NIUM BLACK





ISSUED

PROJECT TITLE

THE CONTINENTAL

414 E Washington Ave

SHEET TITLE
EXTERIOR
ELEVATIONS COLORED

SHEET NUMBER

PROJECT NUMBER 1972

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**EXTERIOR MATERIAL SCHEDULE** BUILDING ELEMENT MANUFACTURER COLOR BRICK VENEER - (#1) CLOUD CERAMICS KANSAS GOLD SANDRIFT MASONRY - (#1)
- ARRISCRAFT RENAISSANCE STONE
OR CORDOVA STONE BUFF STANDING SEAM METAL ROOF STOREFRONT FIBERGLASS OR ALUMINIUM BLACK METAL DOORS/FRAMES STONE SILLS & BANDS N/A EDWARDS (TBD)
COLOR TO MATCH STONE VENEER SOFFITS & FASCIA RAILINGS (TBD)

Elevations - Exterior Material Schedule

Colored - North East



EXTERIOR MATERIAL SCHEDULE

BUILDING ELEMENT MANUFACTURER COLOR

BURKE YEBER. (#1) SUMMIT ARMY MANUFACTURER

BURKE YEBER. (#2) COLOR CRISANICS

MANUFACTURER. (#2) SUMMIT ARMY MANUS GOLD

MANDRINY (\*18)

- ARRISCARAF RENABLASIANICS STONE)

OR CORIDONA STONE BUFF

STANDING SEAM METAL BOOF

(TBD)

SATE

WINDOWS N/A CAMEO

STOMEROUS N/A CAMEO

STOMEROUS BURKER

STONE BURKER (\*18)

STONE

Elevations - Exterior Material Schedule



ISSUED Issued for Land Use April 1, 2020

PROJECT TITLE
THE
CONTINENTAL

414 E Washington Ave

SHEET TITLE
EXTERIOR
ELEVATIONS COLORED

SHEET NUMBER

A-2.6



Knothe \* bruce
ARCHITECT 8
Intelligence 10
INT

ISSUED Issued for Land Use April 1, 2020 Issued for Land Use September 2, 2020

PROJECT TITLE
THE

CONTINENTAL

414 E Washington

SHEET TITLE
EXTERIOR
ELEVATIONS COLORED

SHEET NUMBER

A-2.7





ISSUED Issued for Land Use April 1, 2020 Issued for Land Use September 2, 2020

PROJECT TITLE
THE
CONTINENTAL

414 E Washington Ave


EXTERIOR ELEVATIONS -COLORED

SHEET NUMBER

A-2.8






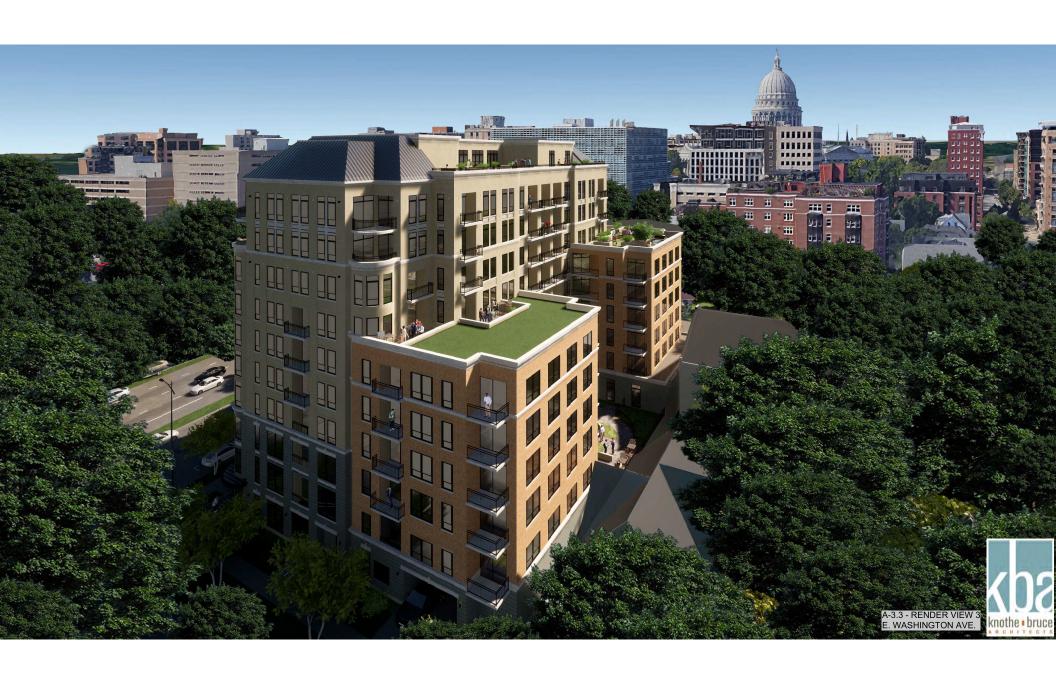








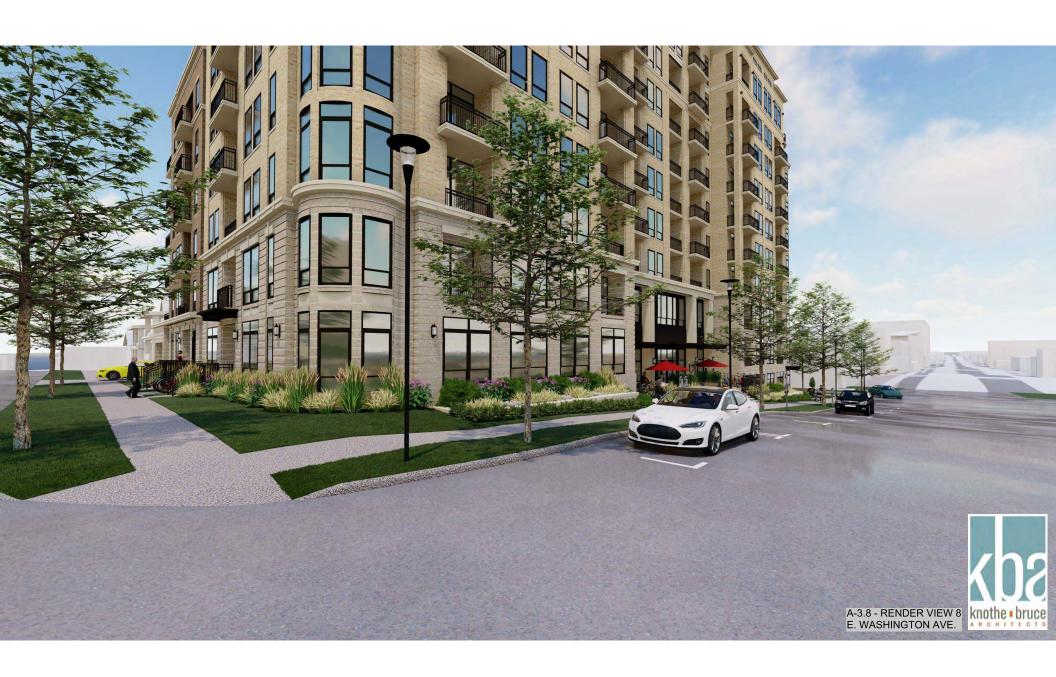

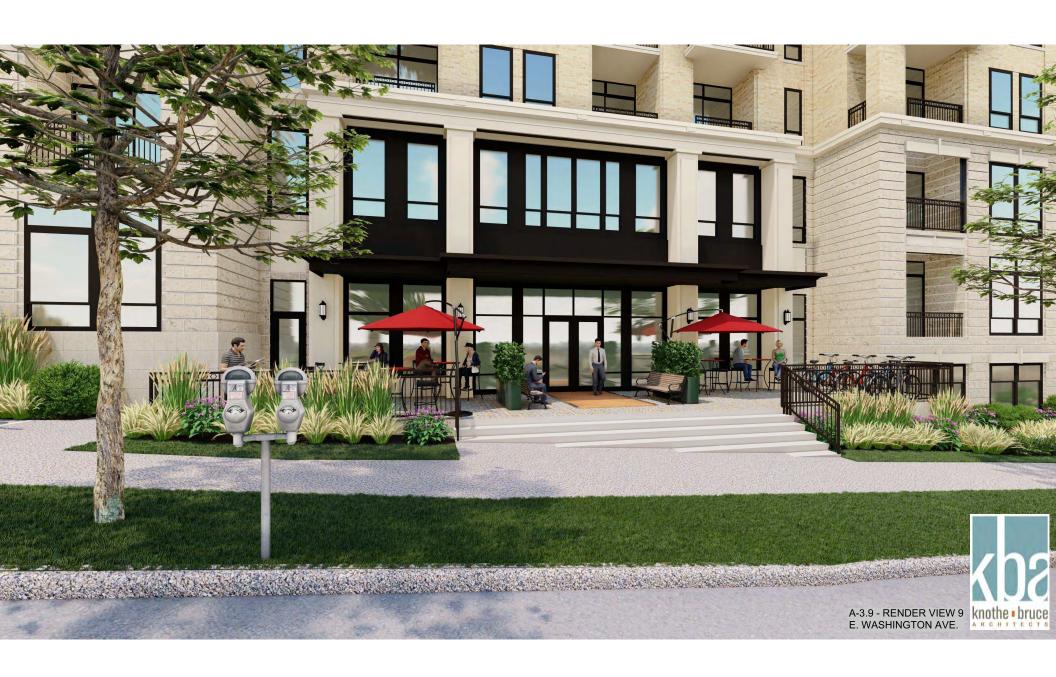











## SPRING EQUINOX

## SUMMER SOLSTICE


## **FALL EQUINOX**

WINTER SOLSITCE







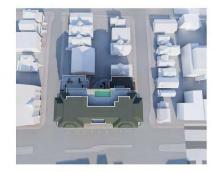
























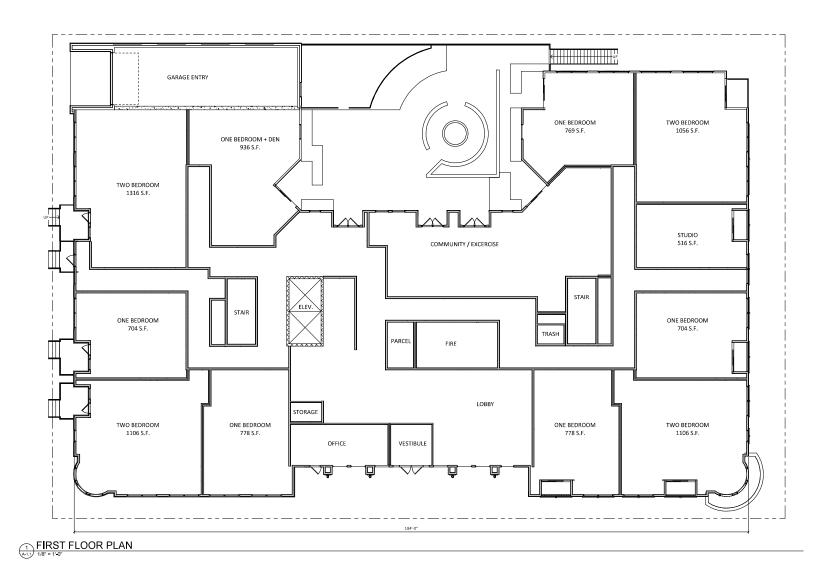



ISSUED Issued for Land Use April 1, 2020 Issued for Land Use September 2, 2020

PROJECT TITLE


THE CONTINENTAL

414 E Washington Ave

SHEET TITLE
FIRST FLOOR
PLAN

SHEET NUMBER 8 STORY

A-1.1

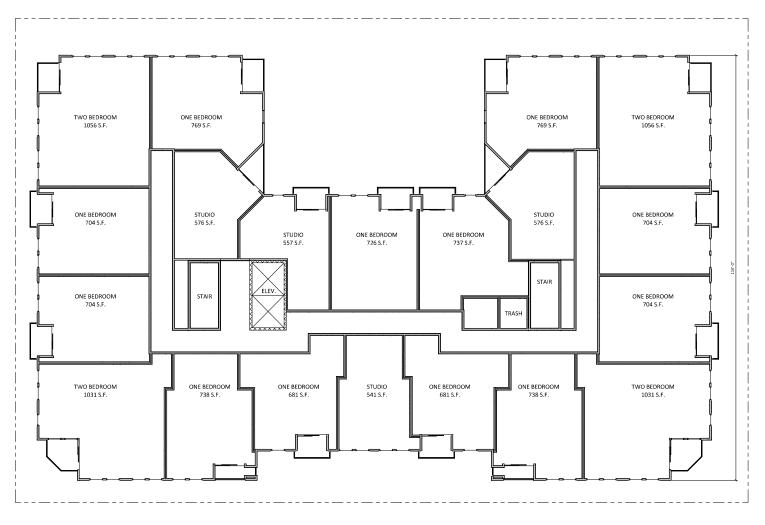

SECOND - EIGHTH FLOOR PLAN



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PROJECT TITLE THE


CONTINENTAL

414 E Washington Ave
SHEET TITLE
EIGHTH FLOOR

PLAN

SHEET NUMBER 8 STORY

PROJECT NUMBER 1972 © Knothe & Bruce Architects, LLC

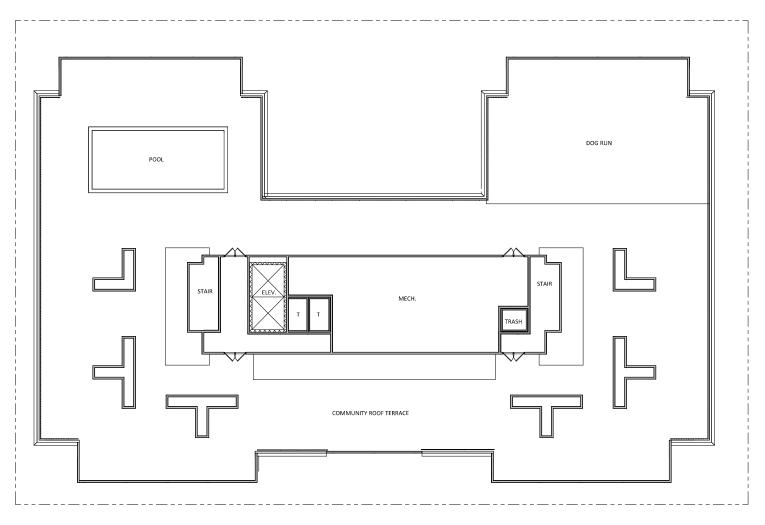

PENTHOUSE PLAN



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PROJECT TITLE THE CONTINENTAL

414 E Washington Ave SHEET TITLE

PENTHOUSE PLAN

SHEET NUMBER 8 STORY

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PROJECT TITLE THE CONTINENTAL

414 E Washington Ave SHEET TITLE

**EXTERIOR ELEVATIONS -**COLORED

SHEET NUMBER 8 STORY

Elevations - Exterior Material Schedule

EDWARDS

**EXTERIOR MATERIAL SCHEDULE** 

BRICK VENEER - (#1)

BRICK VENEER - (#2)

STOREFRONT

MASONRY - (#1)
- ARRISCRAFT RENAISSANCE STONE
OR CORDOVA STONE BUFF

TANDING SEAM METAL ROOF

MANUFACTURER

FIBERGLASS OR ALUMINIUM BLACK

COLOR

(TBD)
COLOR TO MATCH STONE VENEER

KANSAS GOLD SANDRIFT

SLATE

(TBD)

Colored - North East

PROJECT NUMBER 1972 © Knothe & Bruce Architects, LLC



Knothe \* bruce
ARCHITECT 8

Windows ARCHITECT 8

WEYPLAN 100

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PROJECT TITLE
THE
CONTINENTAL

414 E Washington Ave

SHEET TITLE
EXTERIOR
ELEVATIONS COLORED

SHEET NUMBER 8 STORY

A-2.6



Knothe \* bruce
ARCHITECT 8
Intelligence OF THE COLUMN T

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PROJECT TITLE
THE

CONTINENTAL

414 E Washington Ave

SHEET TITLE
EXTERIOR
ELEVATIONS COLORED

SHEET NUMBER

A-2.7





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PROJECT TITLE
THE
CONTINENTAL

414 E Washington Ave

EXTERIOR ELEVATIONS -COLORED

SHEET NUMBER 8 STORY

A-2.8





