MAPLE GROVE DRIVE RESIDENTIAL



MADISON, WISCONSIN




UDC INITIAL




J L A ARCHITECTS

ABBREVIATIONS

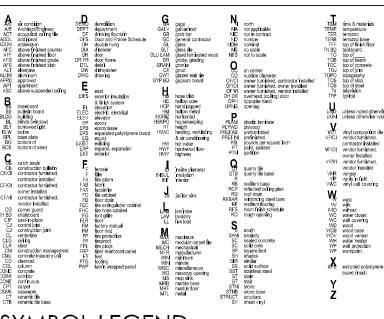

SYMBOL LEGEND

TITLE- VIEW NAME

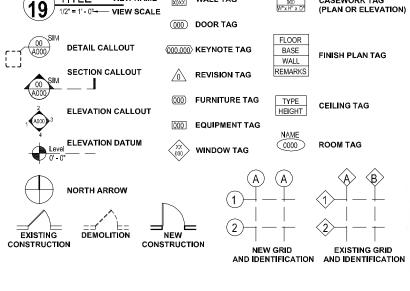

PROJECT ADDRESS

MAPLE GROVE DRIVE RESIDENTIAL MADISON, WISCONSIN

OWNER INFORMATION

FIDUCIARY REAL ESTATE DEVELOPMENT, INC.

789 NORTH WATER STREET - SUITE 200 MILWAUKEE, WISCONSIN 53202 CONTACT: MR. CRAIG RADDATZ CRADDATZ@FRED-INC.COM P 414,226,4535

PROJECT TEAM

ARCHITECTURAL



CASEWORK TAG

JLA ARCHITECTS & PLANNERS

2418 CROSSROADS DRIVE - SUITE 2300 MADISON, WISCONSIN 53718 CONTACT: MR. MARC OTT MOTT@JLA-AP.COM OFFICE: 608.241.9500 DIRECT: 608.442.3867


CIVIL ENGINEERING



D'ONOFRIO KOTTKE AND ASSOCIATES

7530 WESTWARD WAY MADISON, WISCONSIN 53717 CONTACT: MR. BRUCE HOLLAR BHOLLAR@DONOFRIO.CC 608.833.7530

VICINITY MAP

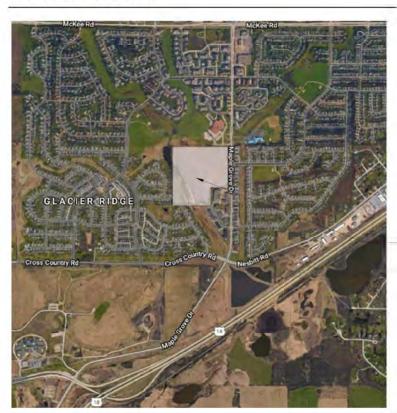

EXTENTS OF DEVELOPMENT

SHEET INDEX

G000 G001 G002 G003	COVER INDEX CONTEXTUAL SITE INFORMATION CONTECTUAL SITE INFORMATION
C-001 C-100 C-101 C-102 C-201 C-202 C-301 C-302 C-500	EXISTING CONDITIONS SITE PLAN SITE PLAN SITE PLAN GRADING PLAN GRADING PLAN UTILITY PLAN UTILITY PLAN FIRE ACCESS PLAN
P-1.0	SITE LIGHTING PHOTOMETRIC
L-1.0 L-1.1 L-1.2 L-1.3 L-1.4 L-1.5 L-1.6 L-1.7 L-1.8 L-1.9 L-1.10	OVERALL LANDSCAPE PLAN OVERALL EXISTING TREE INVENTORY OVERALL LANDSCAPE PLAN: LOT 1 FOUNDATION LANDSCAPE PLAN: CLUBHOUSE & TOWNHOMES ENLARGED LANDSCAPE FOUNDATION PLANS: LOT 1 OVERALL LANDSCAPE PLAN: LOT 2 ENLARGED APARTMENT FOUNDATION LANDSCAPE PLAN: OPTION ENLARGED APARTMENT FOUNDATION LANDSCAPE PLAN: OPTION OVERALL LANDSCAPE PLAN: LOT 3 ENLARGED LANDSCAPE FOUNDATION PLANS: OPTION A & B OVERALL LANDSCAPE PLAN: OUTLOT 1 & 2
T-A101 T-A102 T-A200 T-A201 T-A202	FLOOR PLANS FLOOR PLANS EXTERIOR ELEVATIONS EXTERIOR ELEVATIONS EXTERIOR PERSPECTIVES
A-A100 A-A101 A-A102 A-A103 A-A104 A-A200 A-A201 A-A202	FIRST FLOOR PLAN SECOND FLOOR PLAN THIRD FLOOR PLAN ROOF PLAN
S-A101 S-A102 S-A103 S-A200 S-A201 S-A202	FIRST FLOOR PLAN SECOND FLOOR PLAN ROOF PLAN EXTERIOR ELEVATIONS EXTERIOR ELEVATIONS EXTERIOR PERSPECTIVES
CH-A20 CH-A20	1 FIRST FLOOR PLANS 0 EXTERIOR ELEVATIONS 1 EXTERIOR ELEVATIONS 2 EXTERIOR PERSPECTIVES



JLA PROJECT NUMBER:17-1018



MAPLE GROVE DRIVE RESIDENTIAL

UDC INITIAL

PROGRESS DOCUMENTS

These documents reflect progress and intent and may subject to change, including additional detail. These a final construction documents and should not be used final bidding or construction-related purposes.

DATE OF ISSUANCE FEBRUARY 3, 2020

REVISION SCHEDULE

MARK DESCRIPTION DATE

SHEET TITLE

INDEX SHEET

SHEET NUMBER

G001



CHAVEZ ELEMENTARY - NORTHSIDE OF PROPERTY



VIEW OF PROPERTY FROM NORTHEAST CORNER OF MAPLE GROVE DRIVE



VIEW OF PROPERTY FROM SOUTHEAST CORNER OF MAPLE GROVE DRIVE



VIEW OF PROPERTY OF SOURTH NEIGHBOR FROM MAPLE GROVE DRIVE



MADISON : MILWAUKE jla-ap.com

JLA PROJECT NUMBER: XX-XXXX-XX

MAPLE GROVE DRIVE RESIDENTIAL

PROGRESS DOCUMENTS

These documents reflect progress and intent and may be subject to change, including additional detail. These are not final construction documents and should not be used for final bidding or construction related purposes.

DATE O	FEBRUARY 3, 2020						
REVISION SCHEDULE							
Mark	Date						

SHEET TITLE

CONTEXTUAL SITE INFORMATION

SHEET NUMBER

G002



VIEW OF NEIGHBOR ON THE EAST SIDE OF MAPLE GROVE DRIVE



EXAMPLE NEIGHBORHOOD BUILDING ALONG MAPLE GROVE DRIVE



EXAMPLE NEIGHBORHOOD BUILDING ALONG MAPLE GROVE DRIVE



EXAMPLE NEIGHBORHOOD BUILDING ALONG MAPLE GROVE DRIVE



MADISON : MILWAUKEE jla-ap.com

JLA PROJECT NUMBER: XX-XXXX-XX

MAPLE GROVE DRIVE RESIDENTIAL

PROGRESS DOCUMENTS

subject to change, including additional detail. These are not final construction documents and should not be used for final bidding or construction-related purposes.

DATE OF ISSUANCE FEBRUARY 3, 2020

REVISION SCHEDULE

Mark Description Date

SHEET TITL

CONTEXTUAL SITE INFORMATION

SHEET NUMBE

G003

FRED - Maple Grove Drive


4840 MAPLE GROVE DRIVE CITY OF MADISON, DANE COUNTY, WI CITY OF MADISON SITE PLAN REVIEW DOCUMENTS



SHEET INDEX

SHEE	I INDEX
C-000	COVER SHEET
C-001	EXISTING CONDITIONS
C-100	SITE PLAN OVERALL
C-101	SITE PLAN NORTH
C-102	SITE PLAN SOUTH
C-200	GRADING & EROSION CONTROL PLAN
C-201	GRADING PLAN NORTH
C-202	GRADING PLAN SOUTH
C-300	SITE UTILITY PLAN
C-301	UTILITY PLAN NORTH
C-302	UTILITY PLAN SOUTH



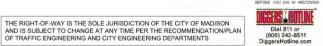



JLA PROJECT NUMBER: 17-1018





7530 Westward Way, Madison, WI 53717 Phone: 608.833.7530 • Fax: 608.833.1089 YOUR NATURAL RESOURCE FOR LAND DEVELOPMENT OKA PROJECT NUMBER: 19-05-101

MAPLE GROVE DRIVE RESIDENTIAL LAND DEVELOPMENT

LAND USE SUBMITTAL


PROGRESS DOCUMENTS


DATE OF ISSUANCE		February-27-2020		
	REVISIO	n schedu	LE	
Mark	Descri	iption	Date	


COVER SHEET

C-000

PROJECT LOCATION (NOT TO SCALE)

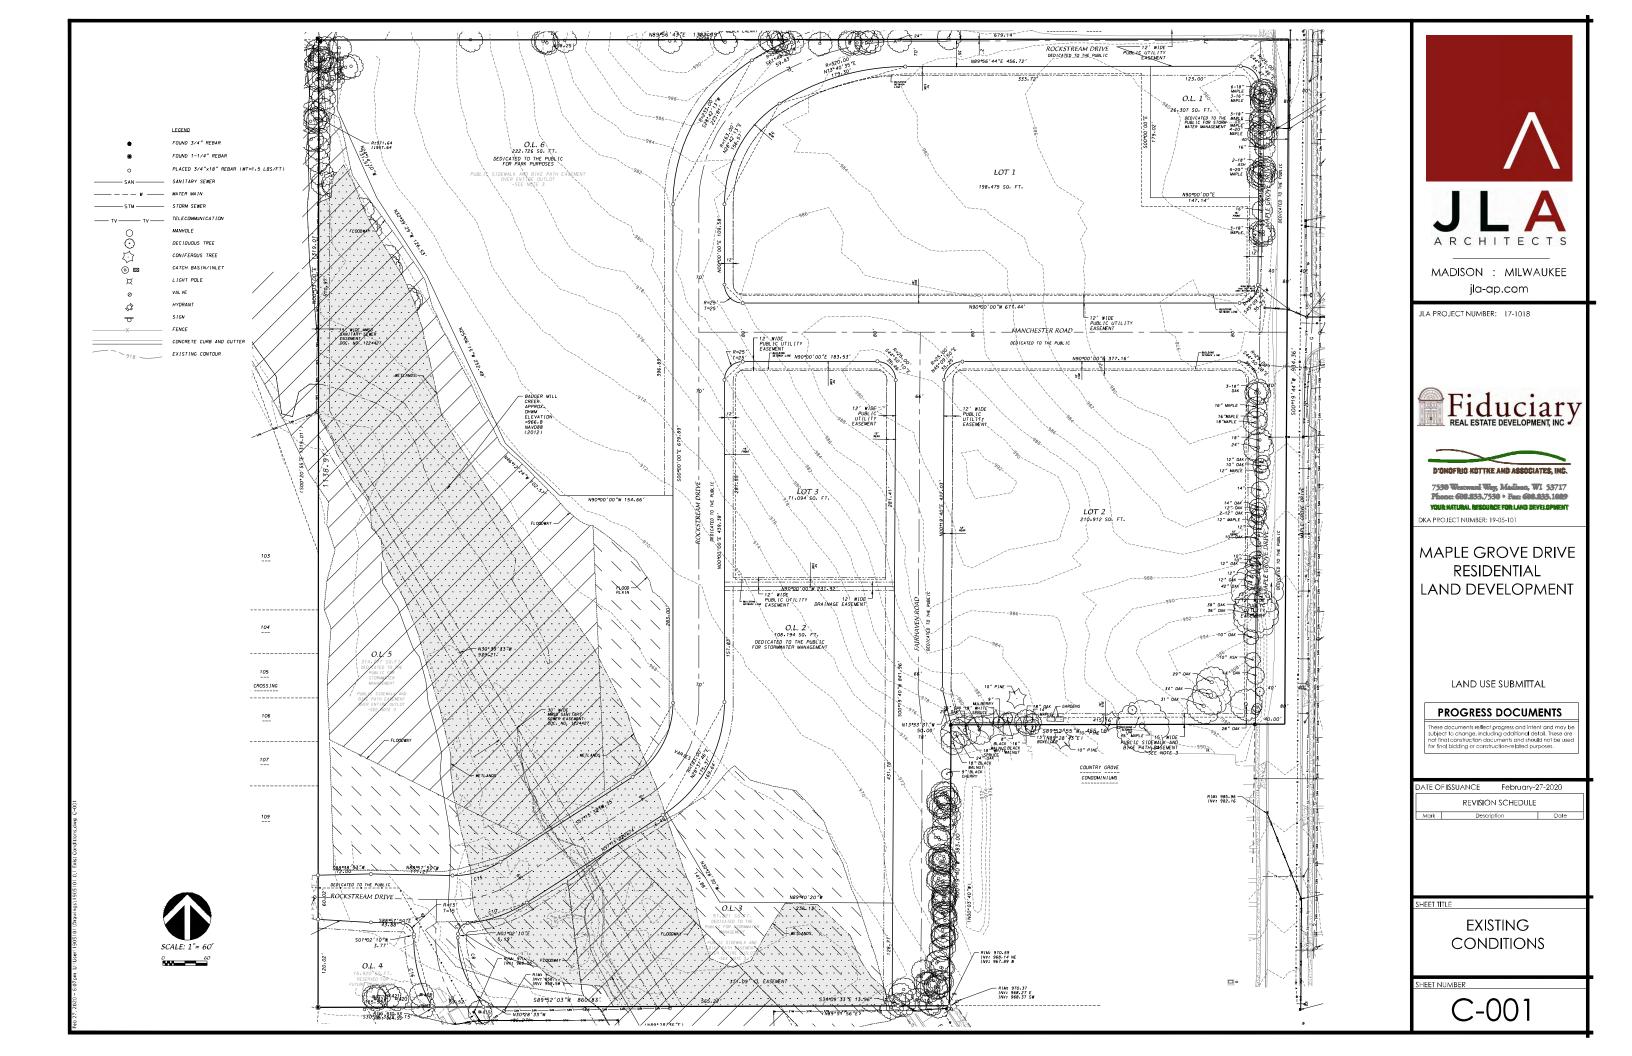

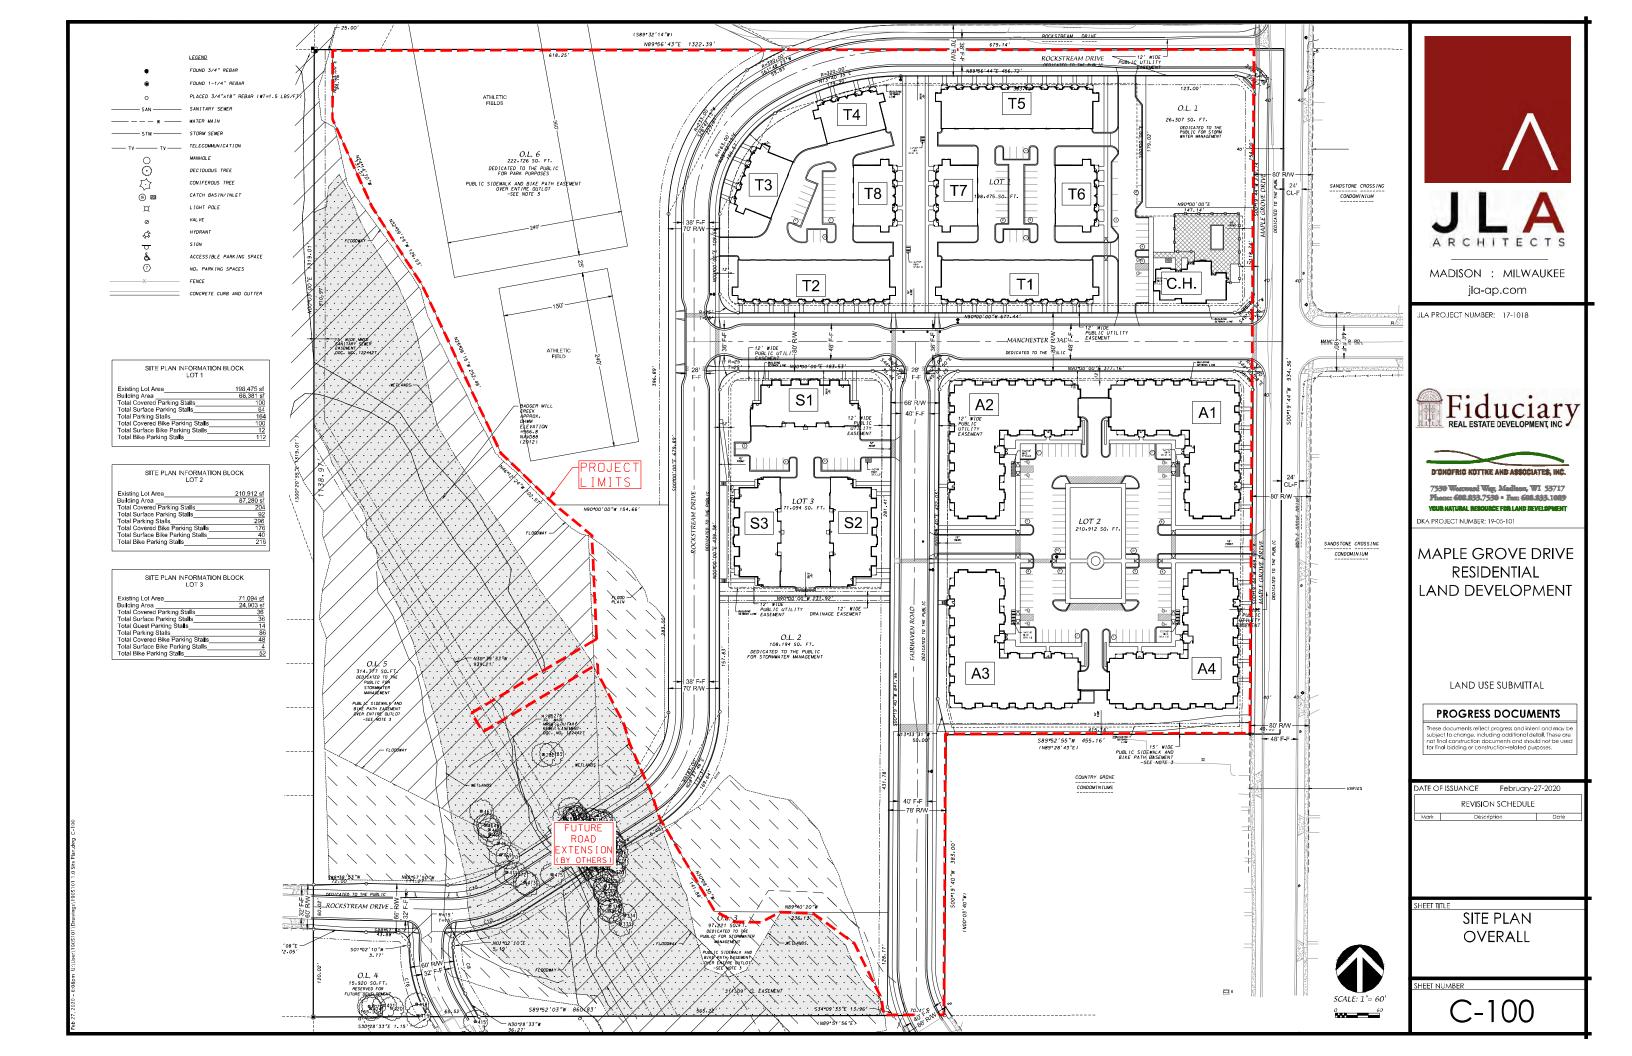

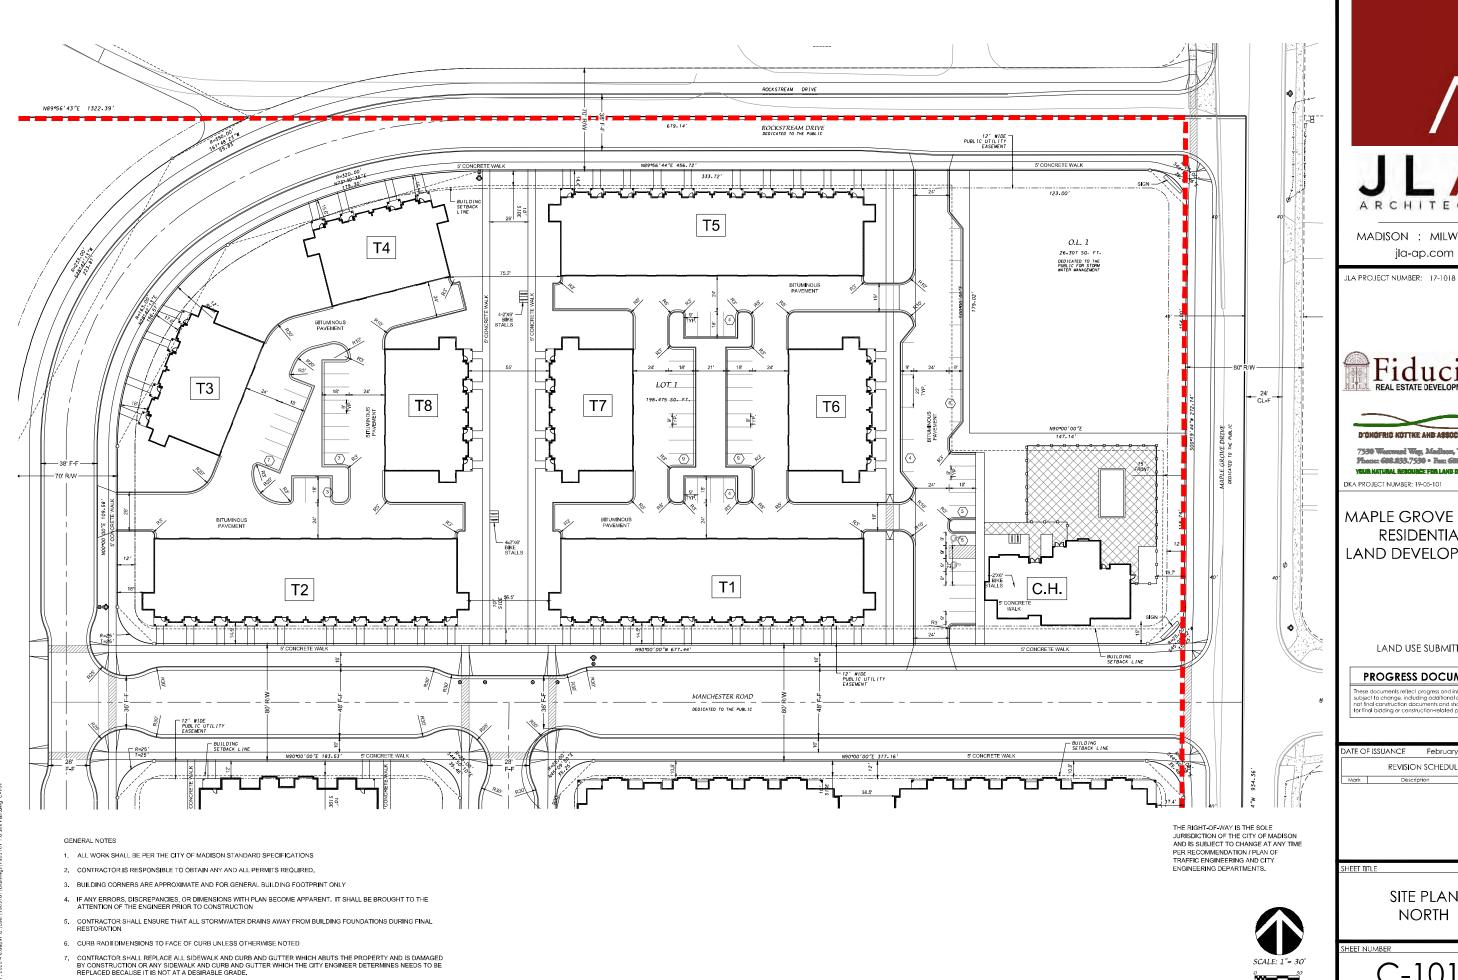

MADISON : MILWAUKEE





7530 Westweel Weg, Madhen, W1 53717 Phone: 606.233,7530 = Pars 606.233,1089 YOUR NATURAL RESOURCE FOR LAND DEVELOPMENT

MAPLE GROVE DRIVE RESIDENTIAL LAND DEVELOPMENT


LAND USE SUBMITTAL


PROGRESS DOCUMENTS


ATE OF ISSUANCE February-27-2020 REVISION SCHEDULE


SITE PLAN NORTH


C-101

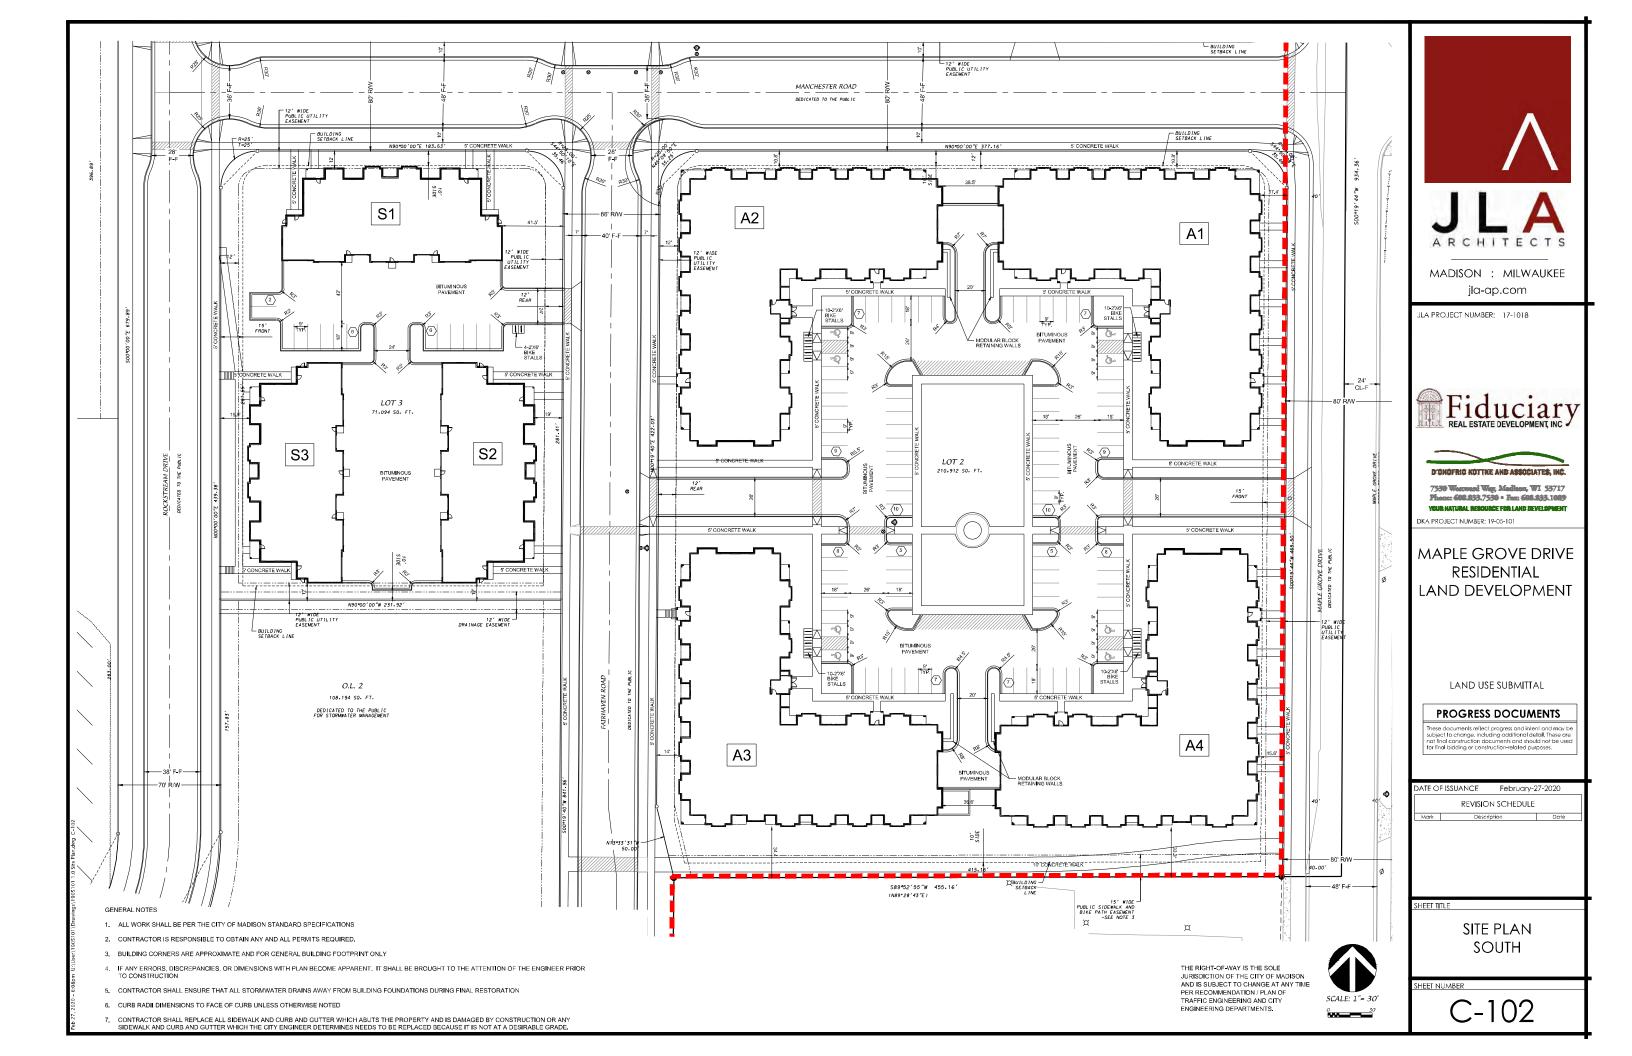


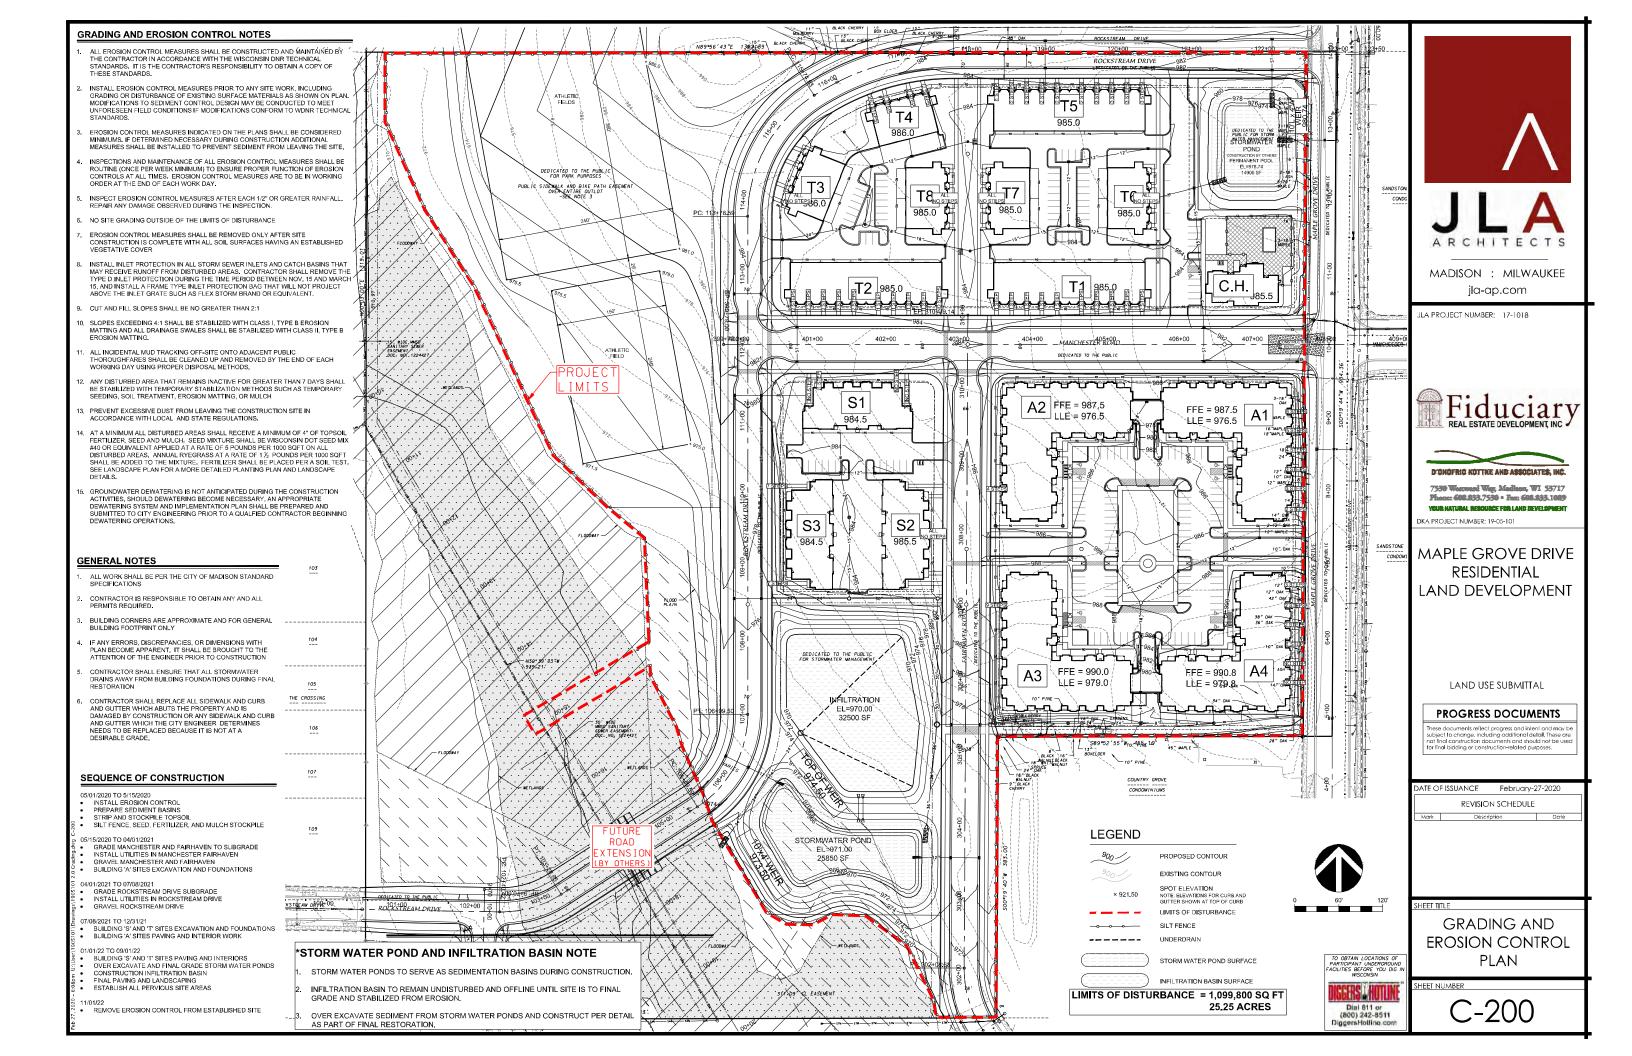


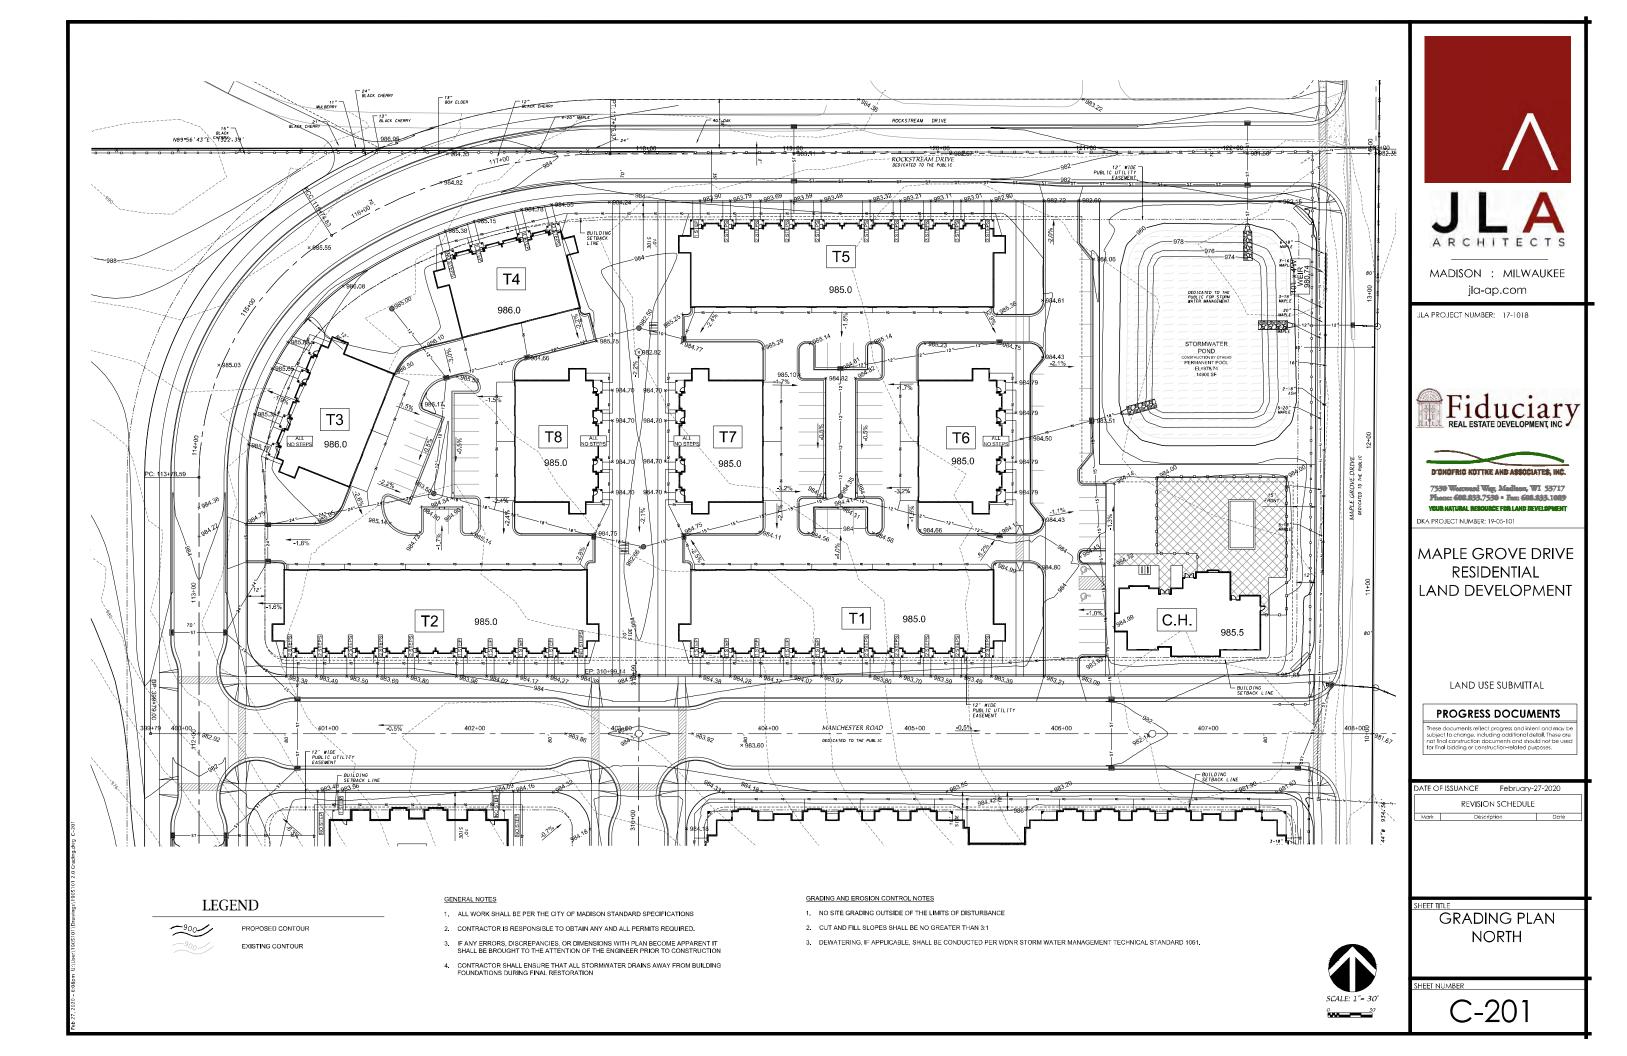

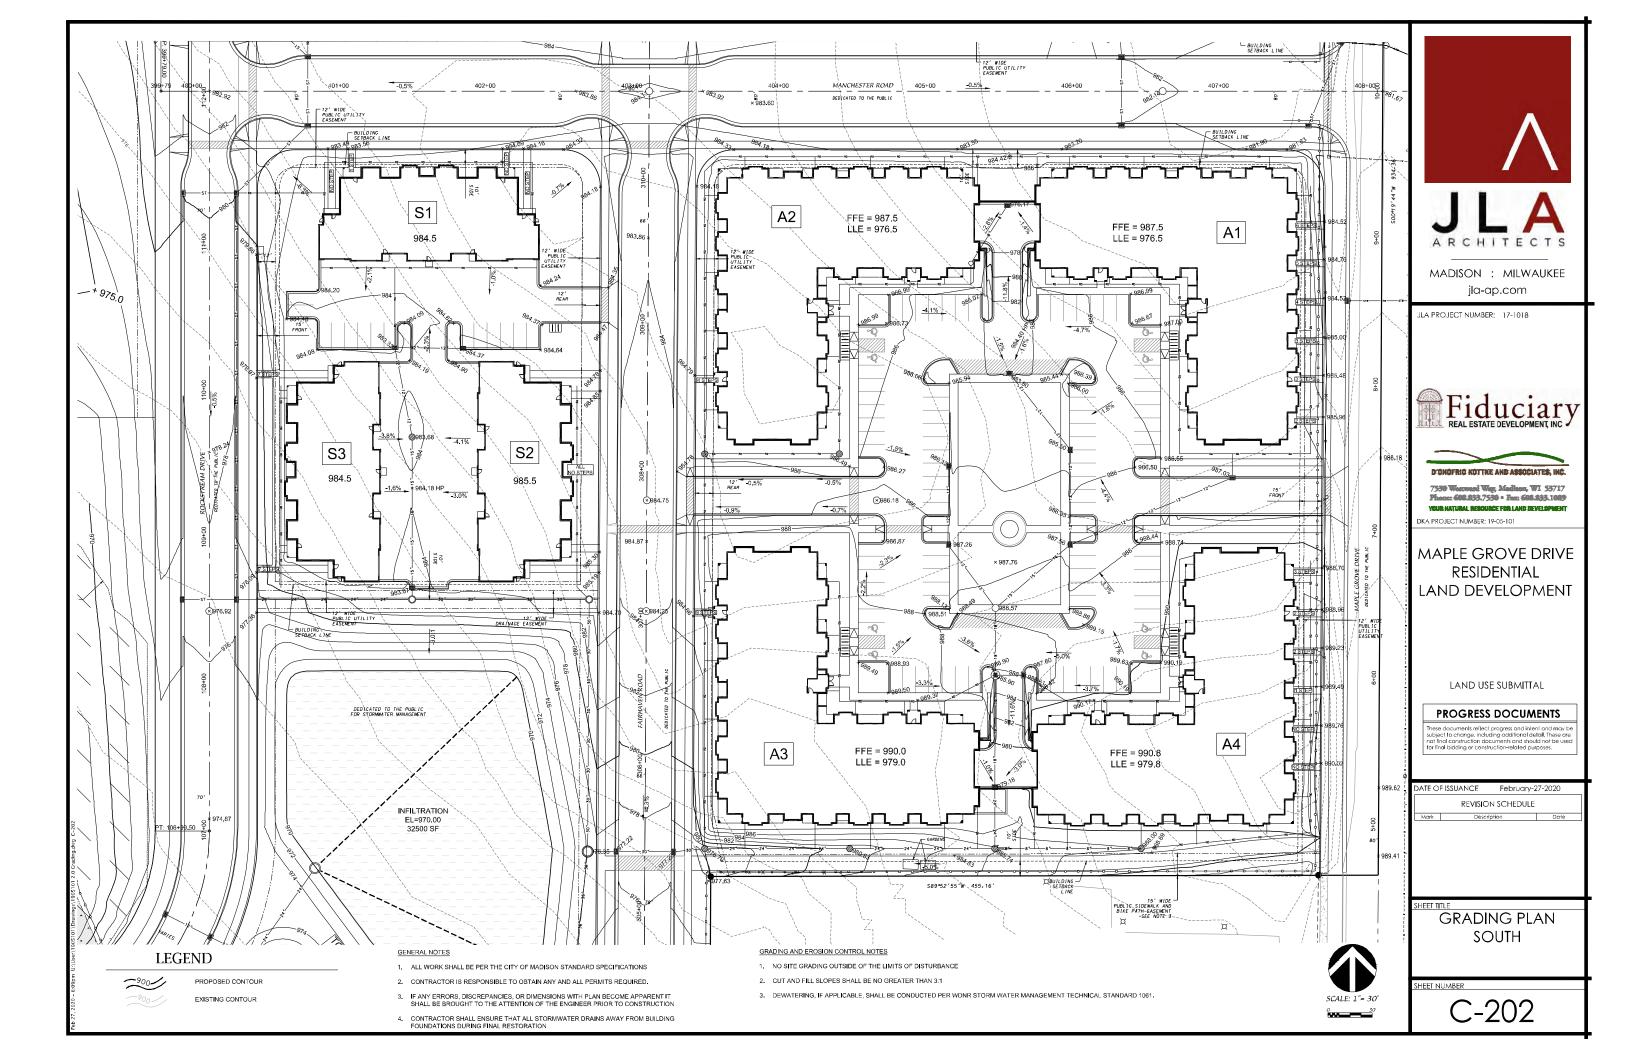


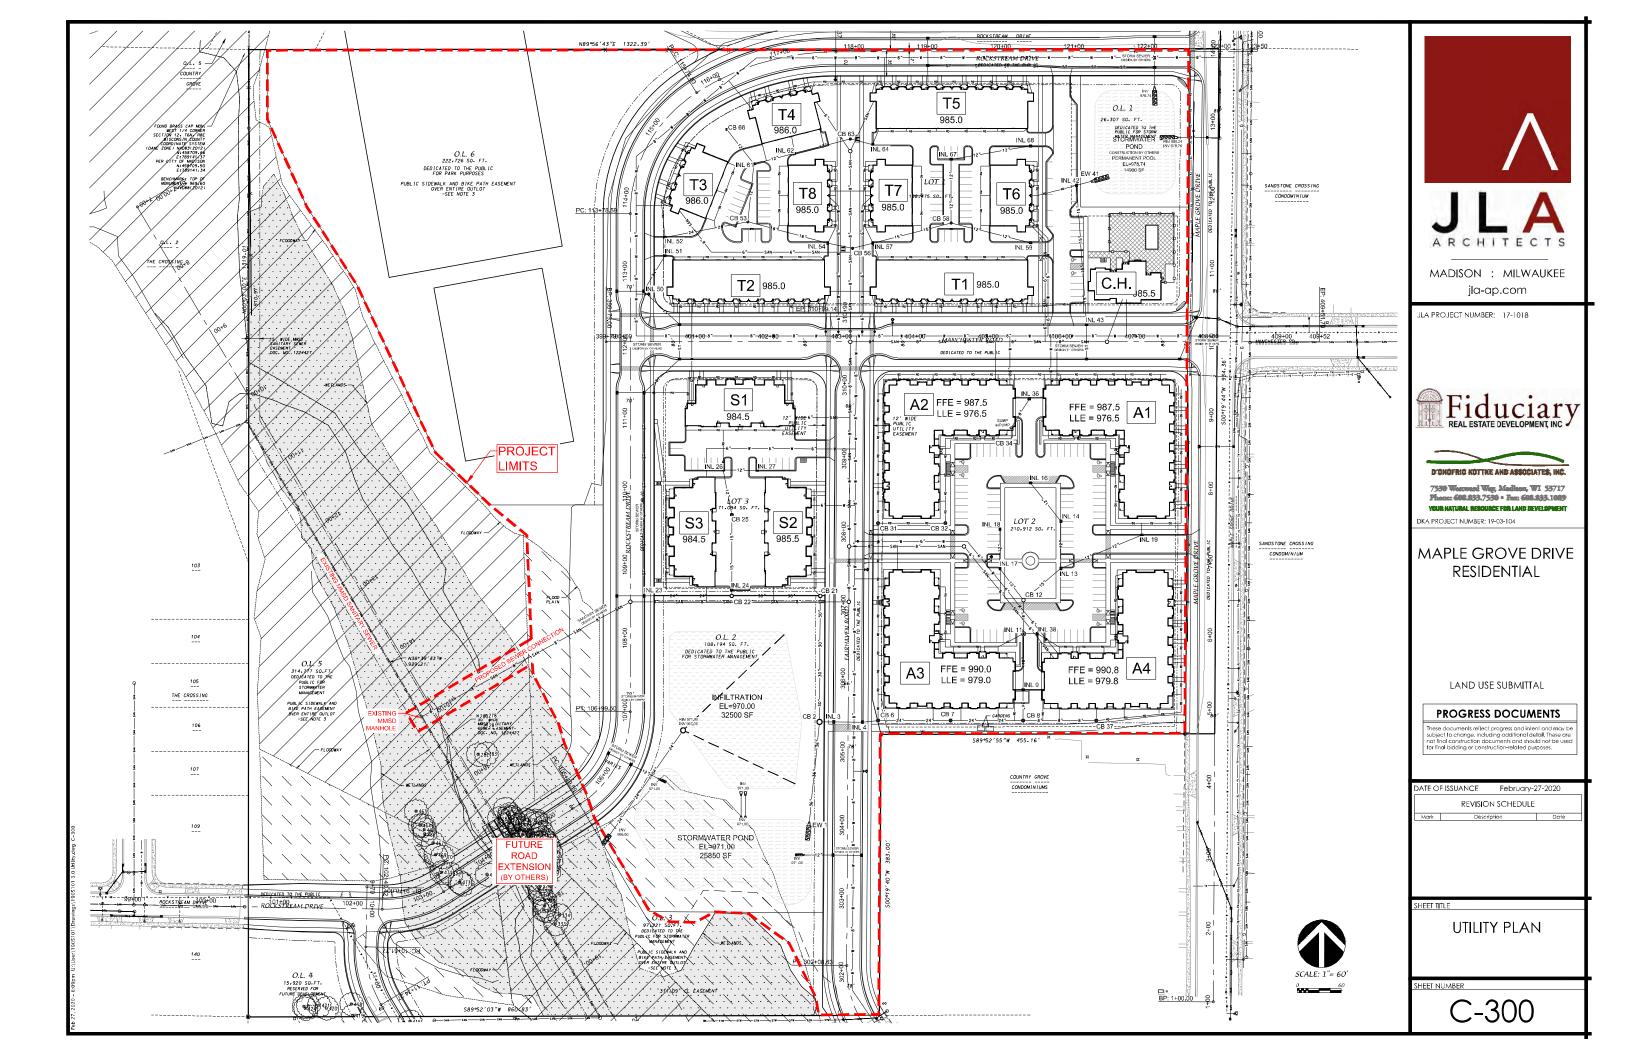

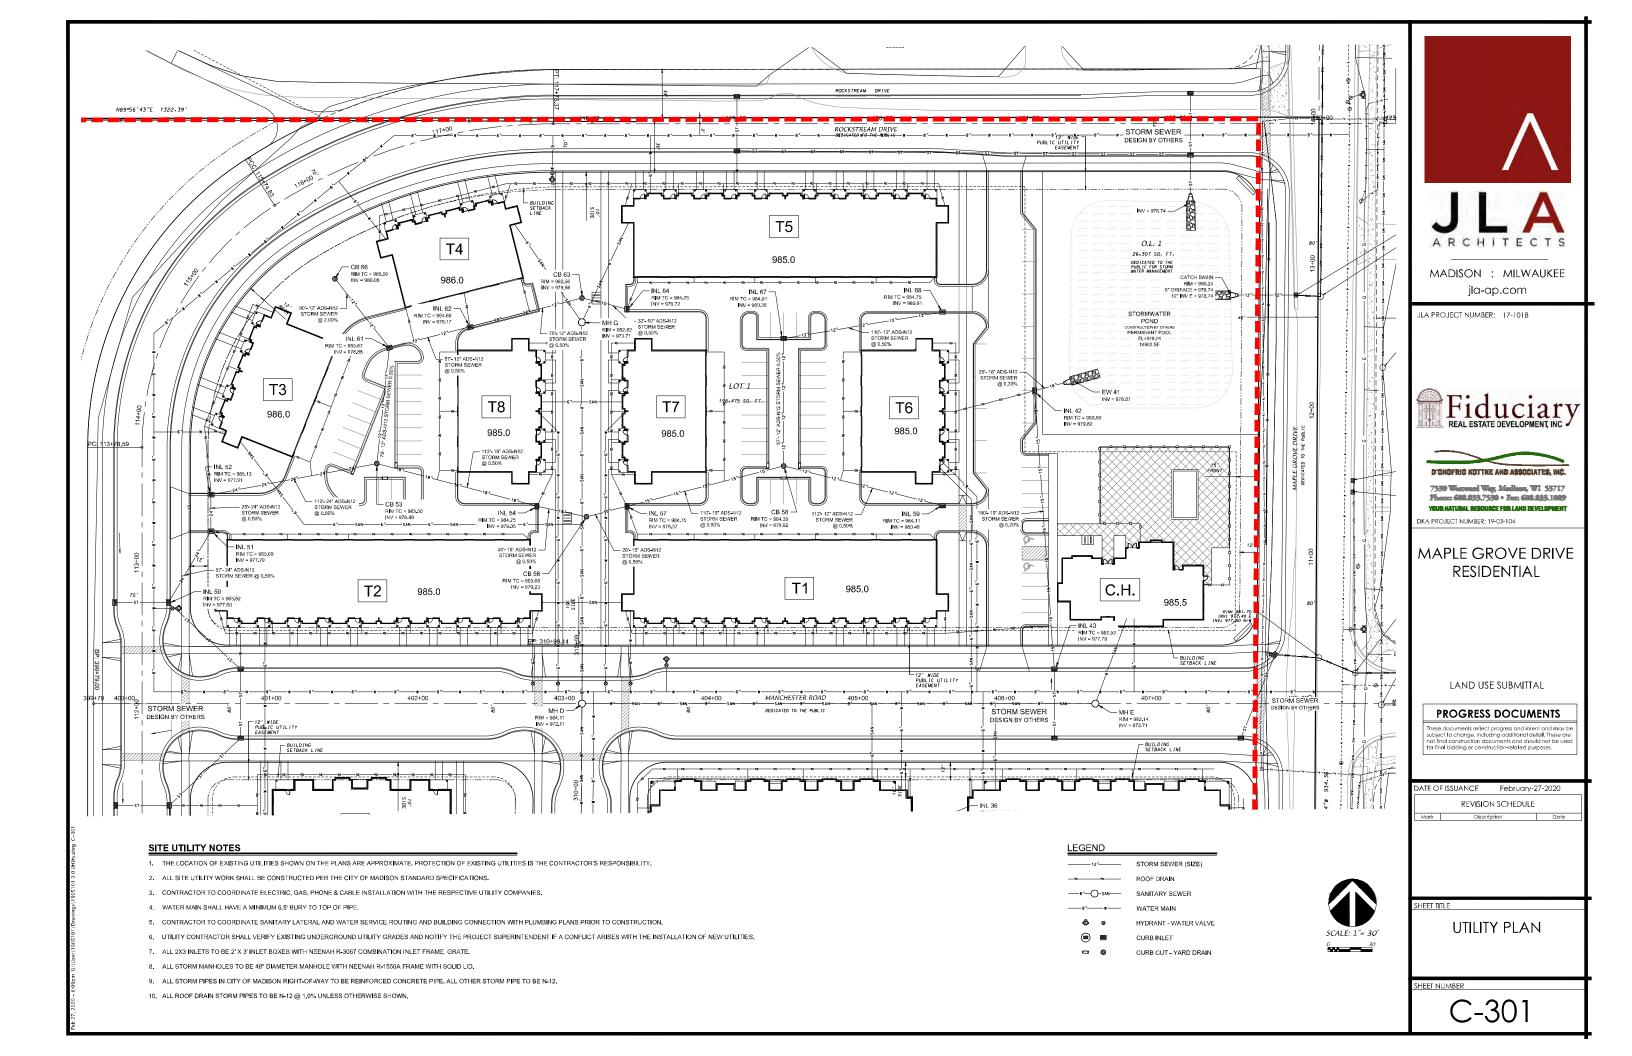

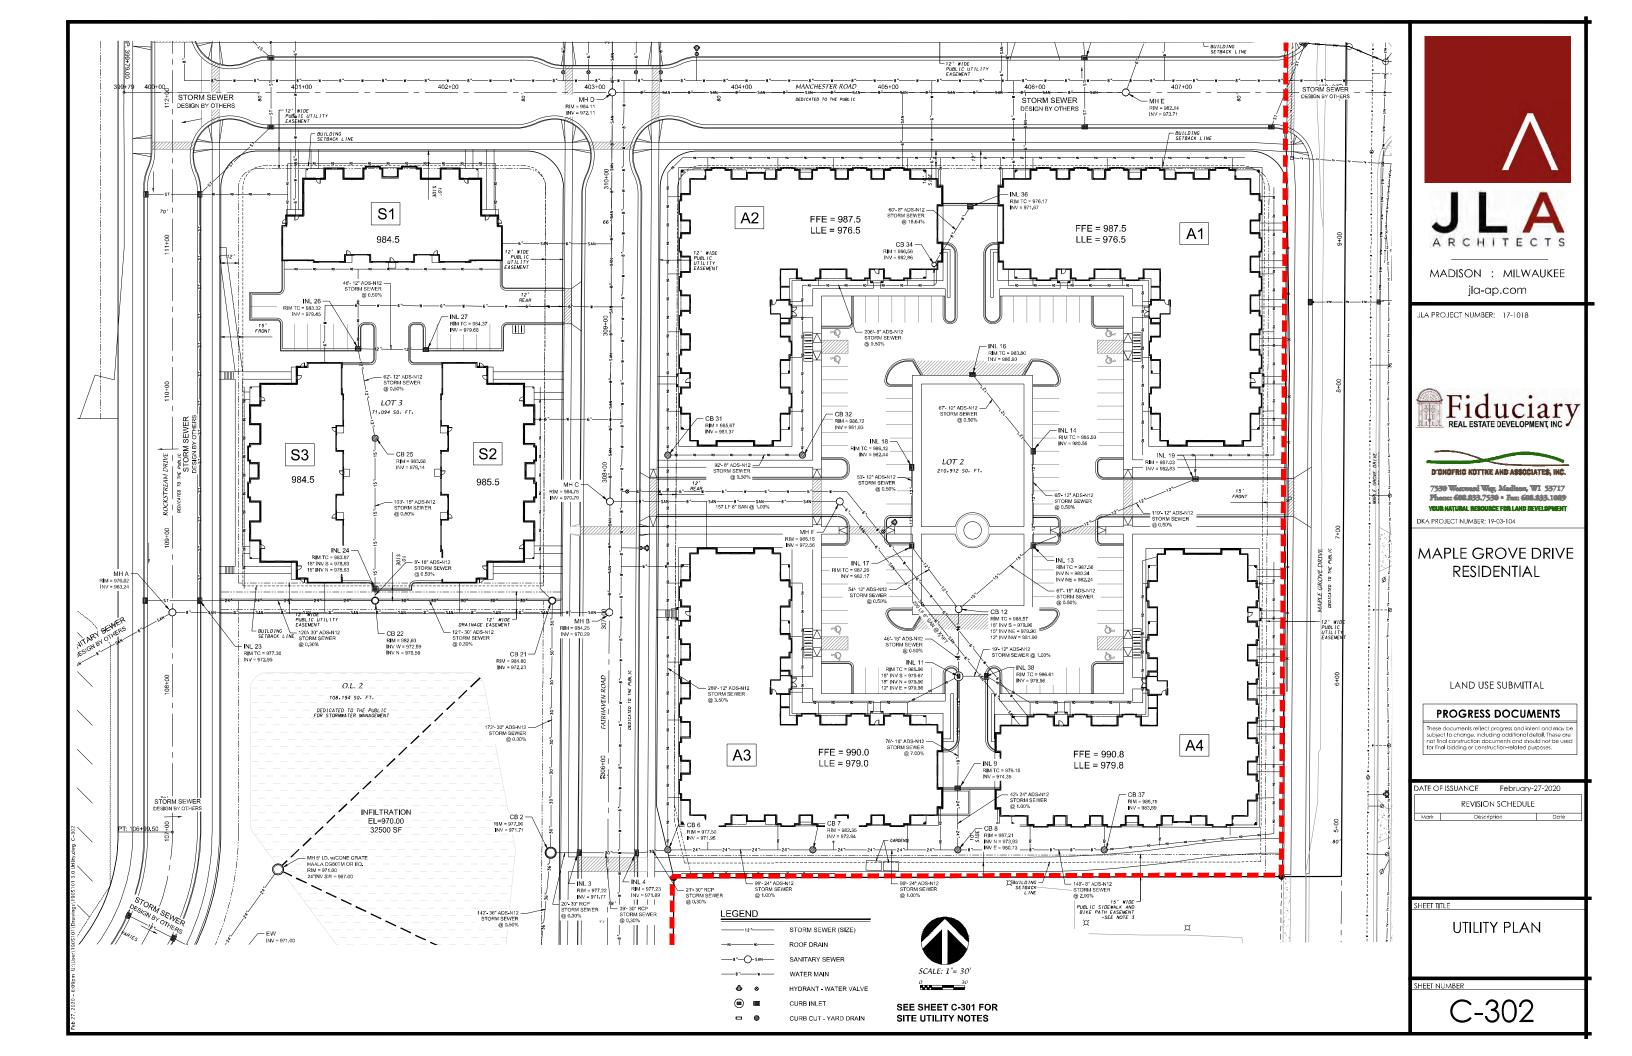

MAPLE GROVE SITE PLAN

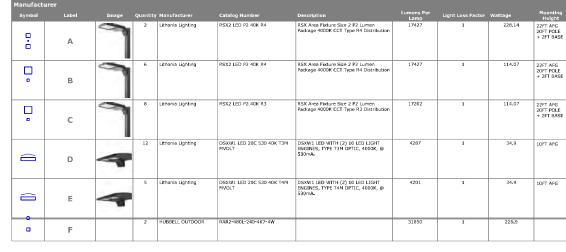

FC M	easured a	t O' AF	G	
Dor W	isconsin .	Admini	ctrative	Code
	90.16 (3			
	water ligh			no re an

Statistics						
Description	Symbol	Avg	Max		Max/Min	Avg/Min
BETWEEN T6 & C.H.	+	2.1 fc	6.3 fc	0.6 fc	10.5:1	3.5:1
LOT 1	+	2.2 fc	9.8 fc	0.5 fc	19.6:1	4.4:1
LOT 2		1.8 fc	7.4 fc	0.3 fc	24.7:1	5.9:1
LOT 3	+	1.8 fc	6.3 fc	0.3 fc	21.0:1	6.0:1
POOL	+	7.4 fc	11.6 fc	3.5 fc	3.3:1	2.1:1
T2/T3/T4/T8	+	2,5 fc	10.0 fc	0.5 fc	20,0:1	5.0:1

X 11 2 2 2 2 2 2 2 2 2 2 2 2 2 2 2 2 2 2	T2	
NEW PUBLIC STREET "B" ROCKSTREAM DRIVE DEDICATED TO THE PUBLIC	WASTREET IN A KINESTER ROAD WASTREET IN A KI	MAPLE GROVE DRIVE
	Plan View Scale • 1° = 50°t	

ROCKSTREAM DRIVE

WHELEC:

*2.4 *2.3 *1.8 *1

*1.8 *1.8 *1.6 *1.8 *2.2 *2.2 *1.9 *1.6 *3.0 *2.6 *2.2 *1.5 *3.3 *2.6 *2.0 *1.8 *3.8 *2.7 *2.0 *1.3 FOR STORMARTE

DRIVE

GROVE

MANAGEMENT

NEW PUBLIC STREET "B"

0.6 1.4 2.7 98 1.0 2.2 1.2 0.8 1.3 2.4 4.8 50 2.7 1.4 1.0 1.2 2.1 3.7 5.5 2.8 1.6


2.1 *2.7 *2.8 *2.6 *2.6 *2.0 *1.5 *1.3 *1. 1.5 *2.2 *2.5 *2.7 *3.1 *2.6 *1.9 *1.6 *1.


1 ha haz (Sa San ha ha ha ha ha ha 1 ha haz San San ha haz San San ha ha 1 ha haz San San ha haz San San haz 1 ha haz San San ha haz San ha haz 1 ha haz San San hay haz San ha haz 1 ha haz San San haz San ha haz 1 ha haz San San haz San ha haz 1 ha haz San haz San haz San haz 1 ha haz San haz San haz San haz 1 ha haz San haz San haz San haz San 1 ha haz San haz San haz San haz San 1 ha haz San haz San haz San haz San 1 ha haz San haz San haz San haz San 1 haz San San San 1 haz San ha


*0.7 *1.2 *2.0 *3.0 *3.0 *1.9 *1.2 *1.0 *1.1 *1.4 *2.4 *3.3 *3.2 *2.0 *1.7 *1.6 *1.8 *2.9 *3.0 *2.3 *1.3 *0

Designer
JAB
Date
12/5/2019
Scale
Not to Scale
Drawing No.



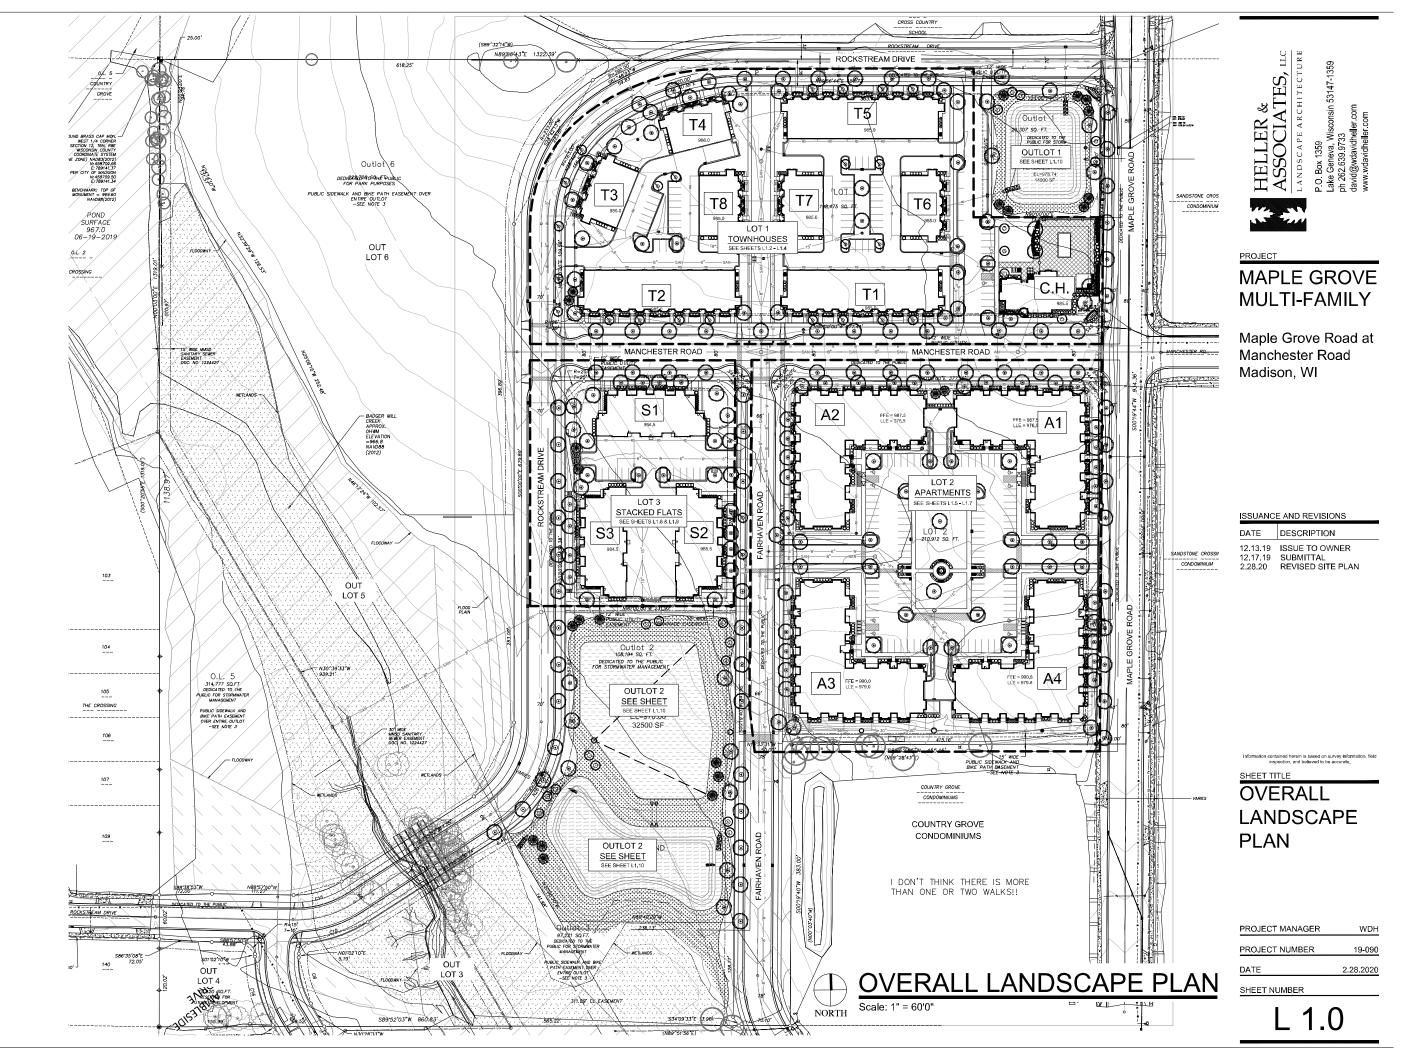

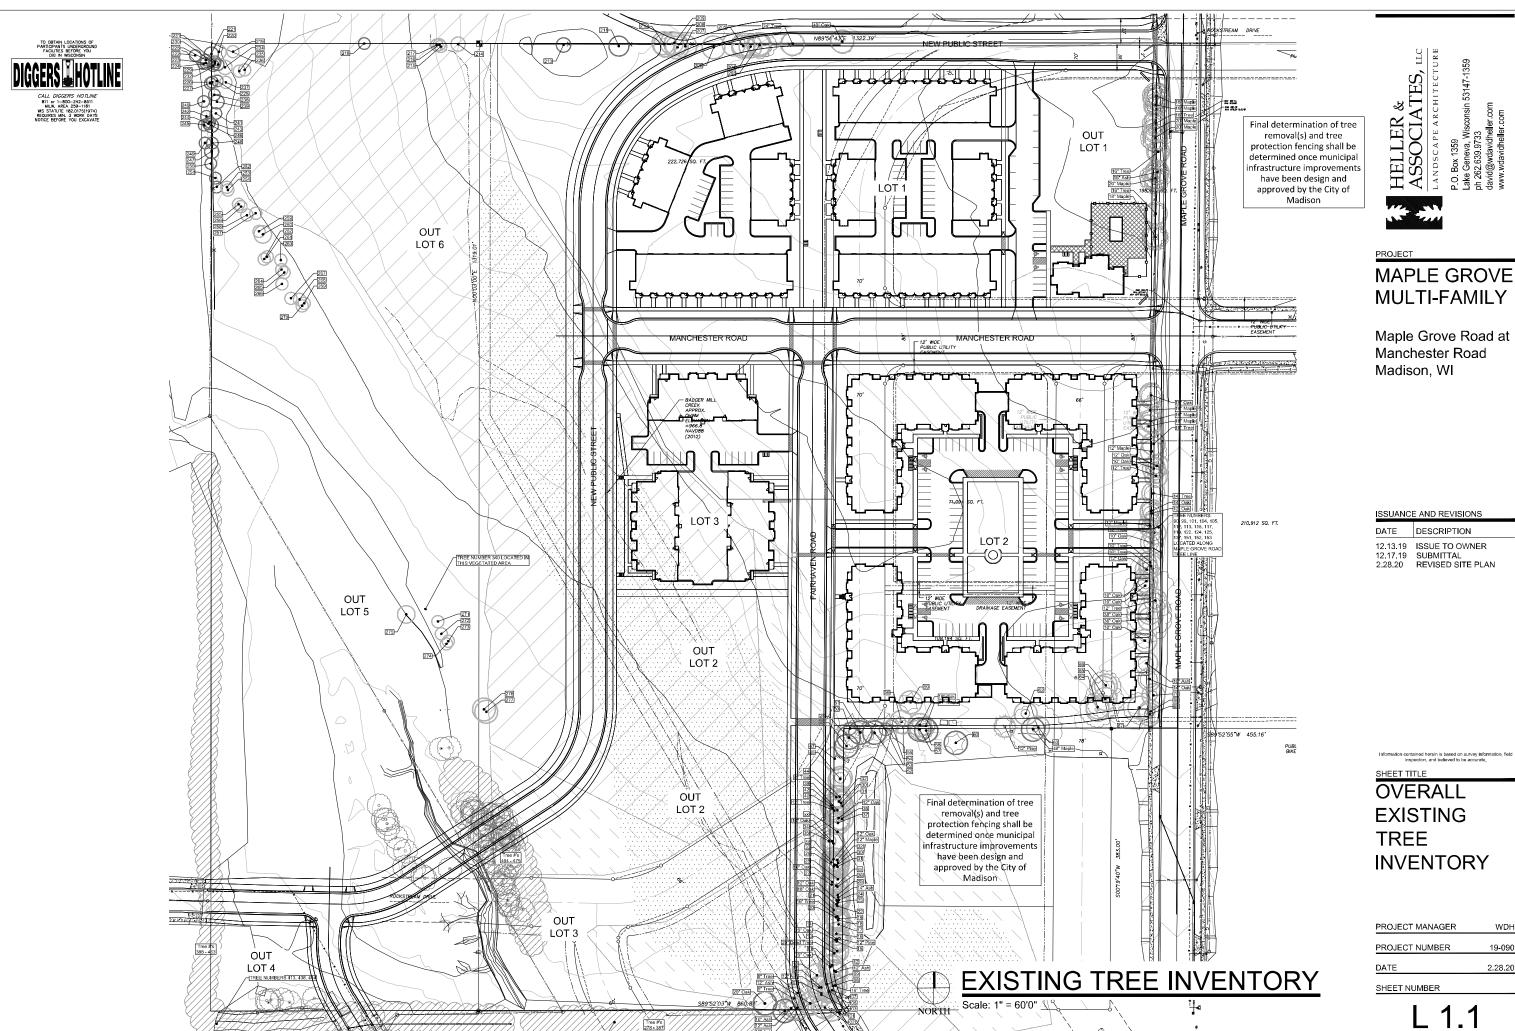

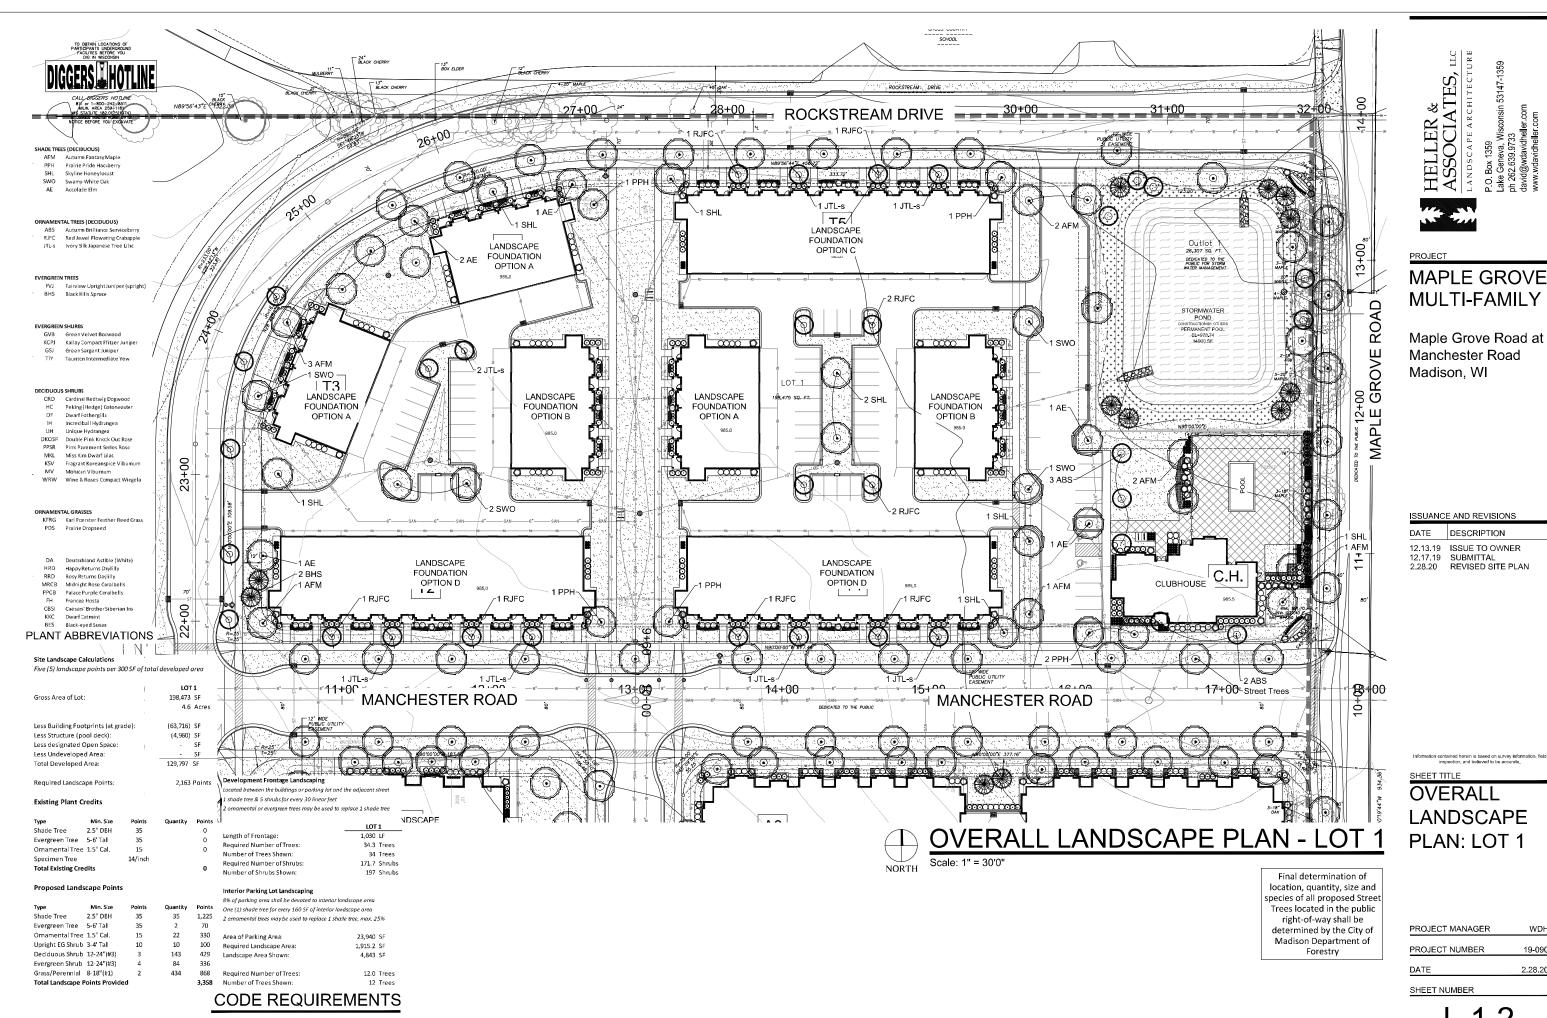



L 1.2

2.28.20

DESCRIPTION

REVISED SITE PLAN

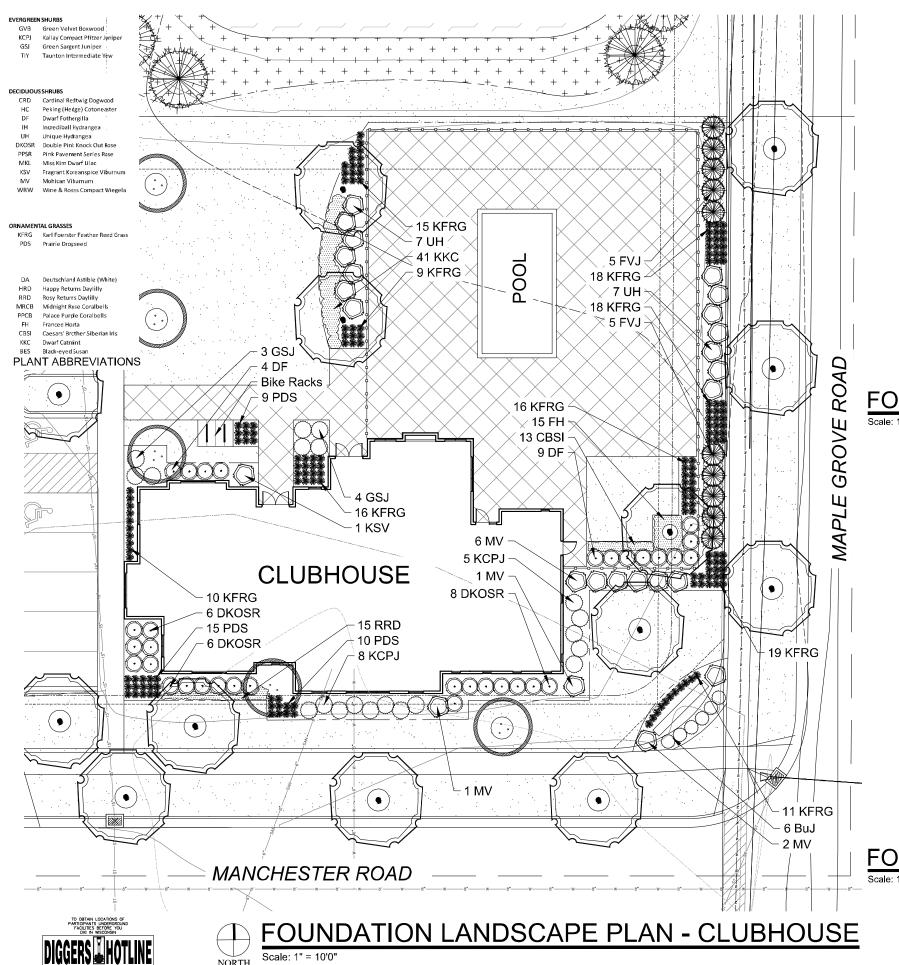

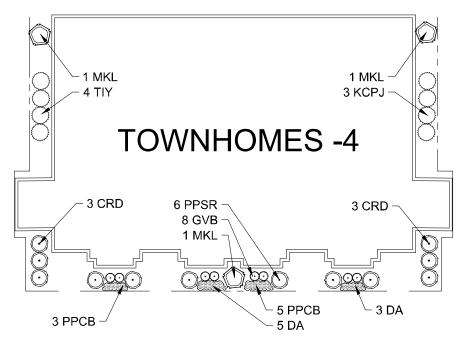


HELLER & ASSOCIATES, LLC LANDSCAPE ARCHITECTURE P.O. Box 1359 Lake Geneva. Wisconsin 53147-1359 ph 262.639.9733 david@waavidheller.com www.wdavidheller.com

PROJECT

MAPLE GROVE MULTI-FAMILY

Maple Grove Road at Manchester Road Madison, WI

FOUNDATION LANDSCAPE PLAN - OPTION "A"

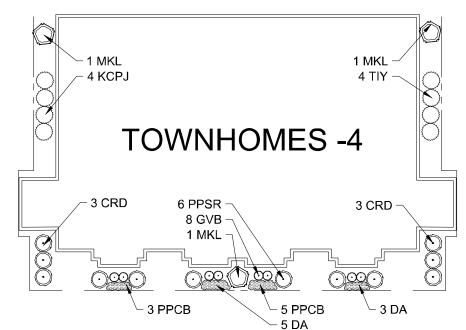

FOUNDATION LANDSCAPE PLAN - OPTION "B" Scale: 1" = 10'0"

ISSUANCE AND REVISIONS

 DATE
 DESCRIPTION

 12.13.19
 ISSUE TO OWNER

 12.17.19
 SUBMITTAL


 2.28.20
 REVISED SITE PLAN

Information contained herein is based on survey information, fi inspection, and believed to be accurate.


FOUNDATION
LANDSCAPE
PLANS:
CLUBHOUSE &
TOWNHOUSE

PROJECT MANAGER	WDH
PROJECT NUMBER	19-090
DATE	2.28.20
SHEET NUMBER	_



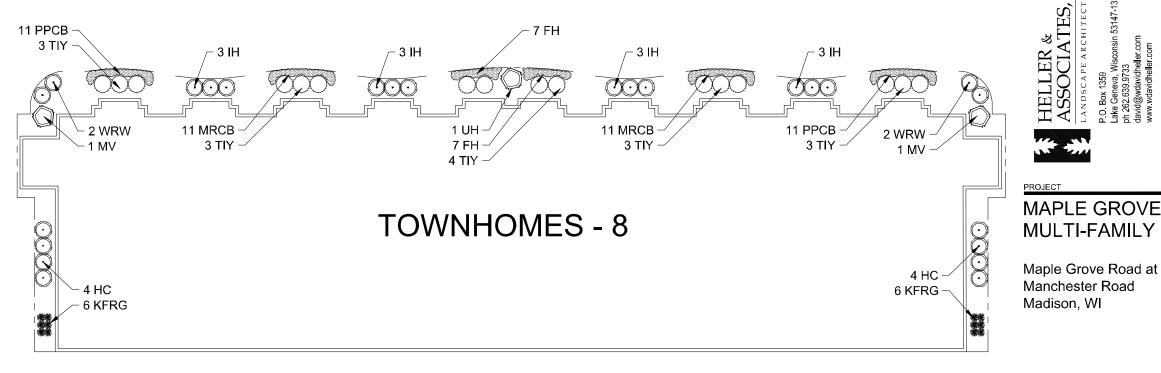



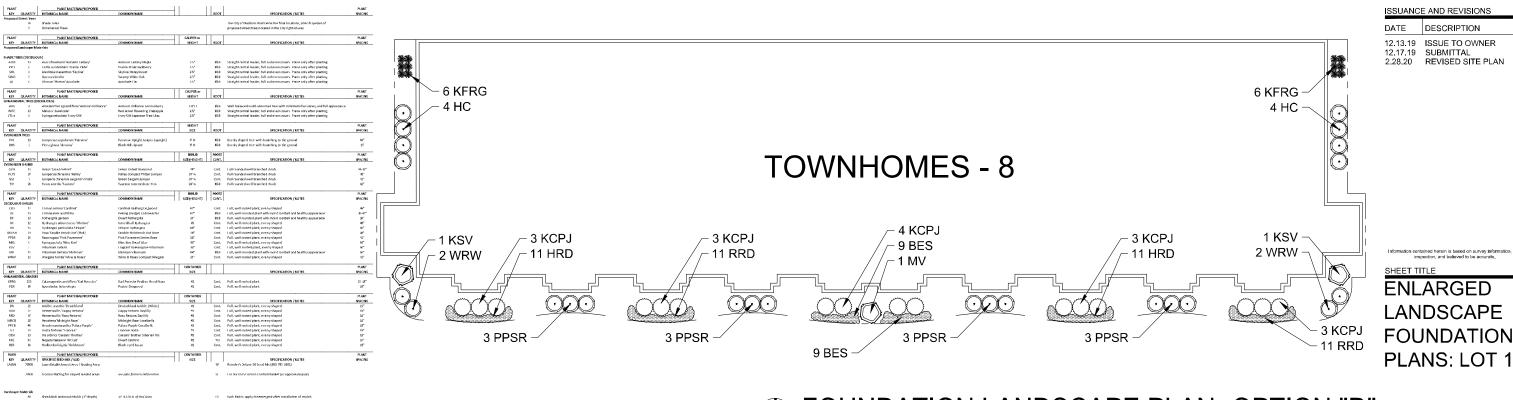


FOUNDATION LANDSCAPE PLAN -OPTION "D"


PROJE	ECT MANAGER	WDH
PROJE	ECT NUMBER	19-090
DATE		2.28.20
SHEE	T NUMBER	


L 1.4

PLANT & MATERIAL SCHEDULE: LOT 1

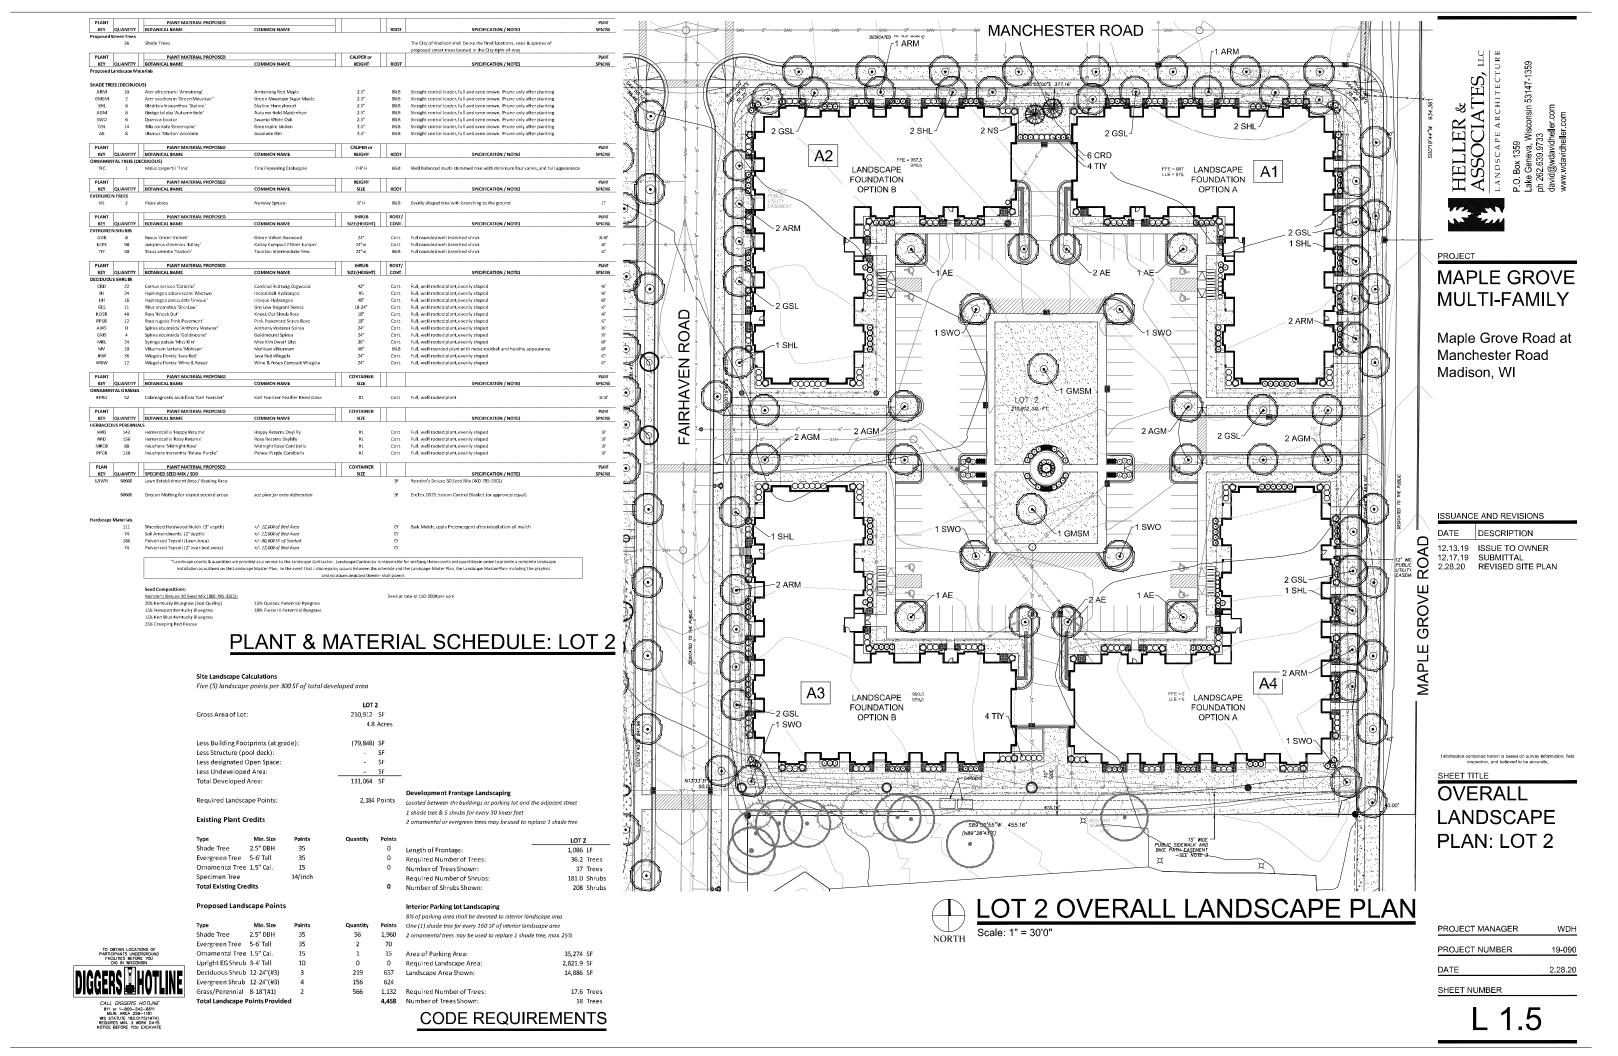




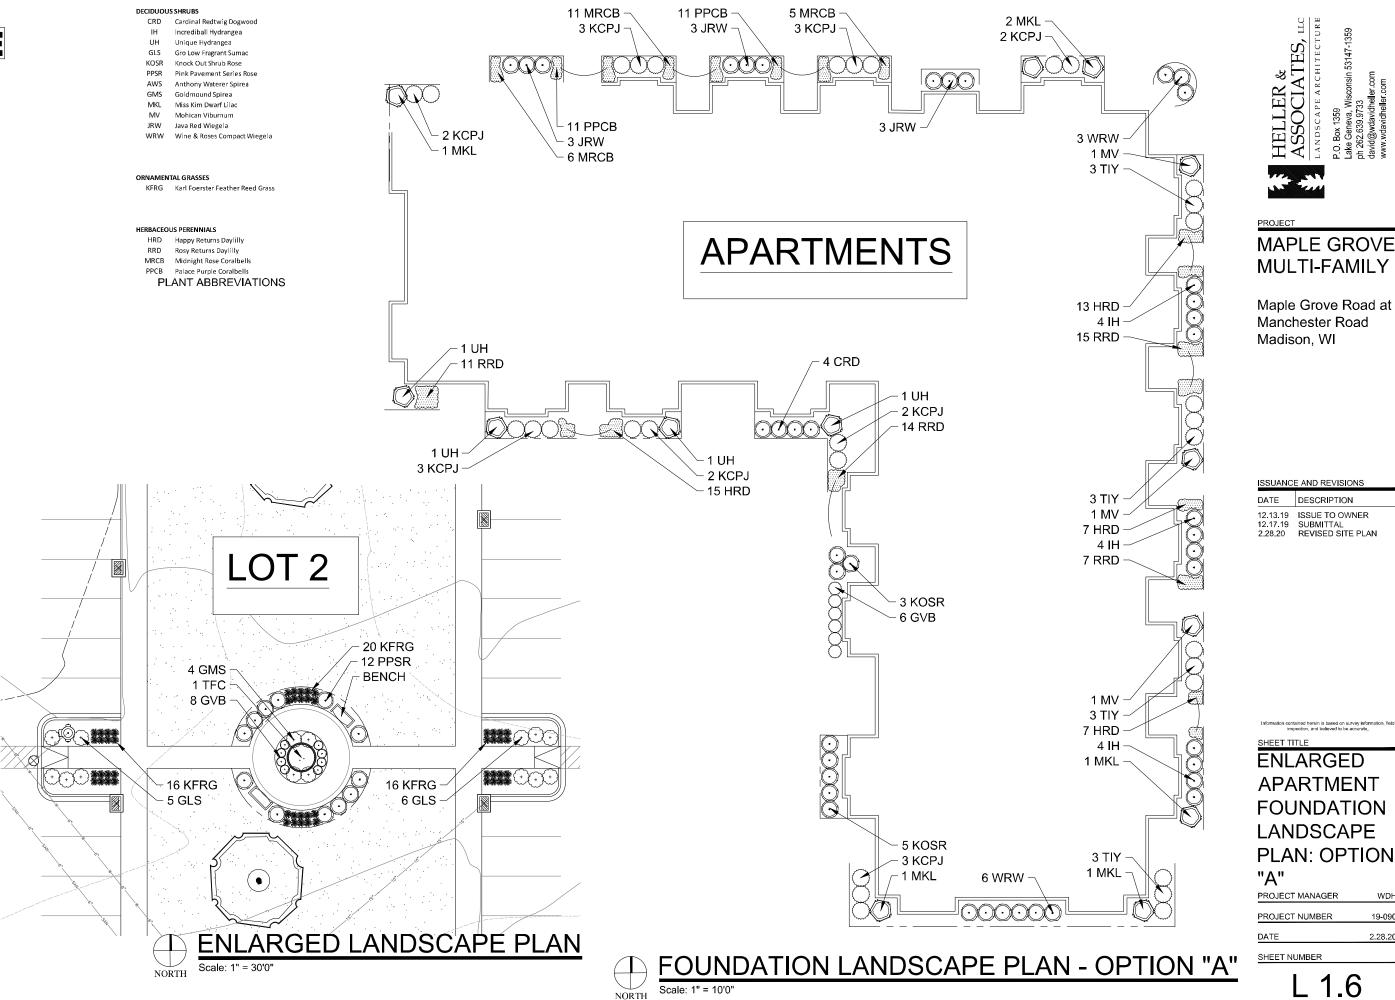

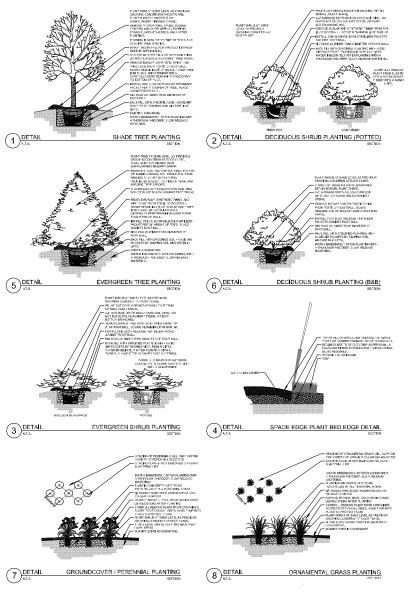


PLANTING & HARDSCAPE DETAILS

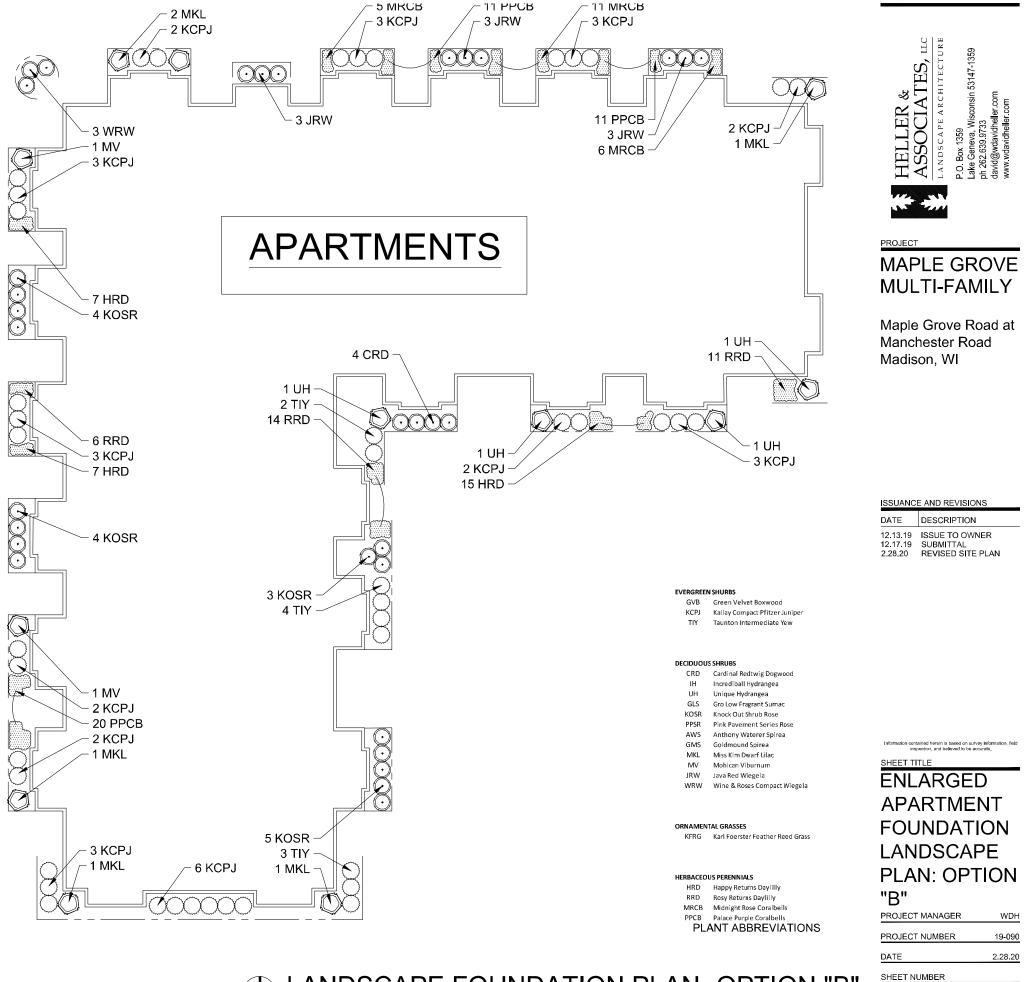

NORTH

LANDSCAPE FOUNDATION PLAN -OPTION "B"

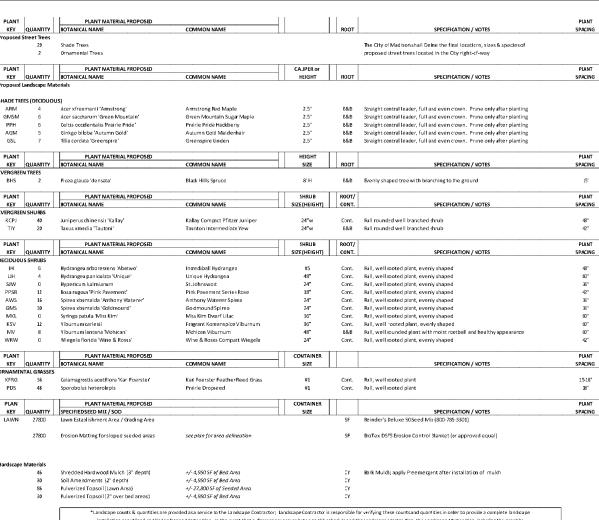

installation as outlined on this Landscape Master Plan. In the event that a discrepancy occurs between this schedule and the Landscape Master Plan, the Lardscape Master Plan including the graphic and notations depoted therein-shall govern

15% Creeping Red Fescue

Reinder's Deluxe 50 Seed Mix (800-785-3301): 20% Kentucky Bluegrass (Sod Quality) 15% Newport Kentucky Bluegrass 15% Ken Blue Kentucky Bluegrass

15% Quebec Perennial Ryegrass 10% Fiesta III Perennial Ryegrass Seed at rate of 150-200# per acie

PLANT & MATERIAL SCHEDULE: LOT 3

Site Landscape Calculations

Five (5) landscape points per 300 SF of total developed area

	LOT 3		
Gross Area of Lot:	71,092	SF	
	1.6	Acres	
Less Building Footprints (at grade):	(22,692)	SF	
Less Structure (pool deck):	-	SF	
Less designated Open Space:	-	SF	
Less Undeveloped Area:	-	SF	
Total Developed Area:	48,400	SF	
			Development Frontage Landscaping
Required Landscape Points:	807	Points	Located between the buildings or parking lo
			1 shade tree & 5 shruhs for eveny 30 linear

Located between the buildings or parking lot and the adjacent street 1 shade tree & 5 shrubs for every 30 linear feet **Existing Plant Credits** 2 ornamental or evergreen trees may be used to replace 1 shade tree


Туре	Min. Size	Points	Quantity	Points		LOT 3
Shade Tree	2.5" DBH	35		0	Length of Frontage:	785 LF
Evergreen Tree	5-6' Tall	35		0	Required Number of Trees:	26.2 Trees
Ornamental Tree	1.5" Cal.	15		0	Number of Trees Shown:	26 Trees
Specimen Tree		14/inch			Required Number of Shrubs:	130.9 Shrubs
Total Existing Cre	edits			0	Number of Shrubs Shown:	126 Shrubs

Proposed Landscape Points

Interior Parking Lot Landscaping 8% of parking area shall be devoted to interior landscape area

Туре	Min. Size	Points	Quantity	Points	One (1) shade tree for every 160 SF of interior landscape area		
Shade Tree	2.5" DBH	35	28	980	2 ornamental trees may be used to replace 1 shade tree, max. 25%		
Evergreen Tree	5-6' Tall	35	2	70			
Ornamental Tree	1.5" Cal.	15	0	0	Area of Parking Area:	5,055	SF
Upright EG Shrub	3-4' Tall	10	0	0	Required Landscape Area:	404.4	SF
Deciduous Shrub	12-24"(#3)	3	88	264	Landscape Area Shown:	408	SF
Evergreen Shrub	12-24"(#3)	4	60	240			
Grass/Perennial	8-18"(#1)	2	84	168	Required Number of Trees:	2.5	Trees
Total Landscape F	Points Provid	ed		1,722	Number of Trees Shown:	3	Trees

CODE REQUIREMENTS

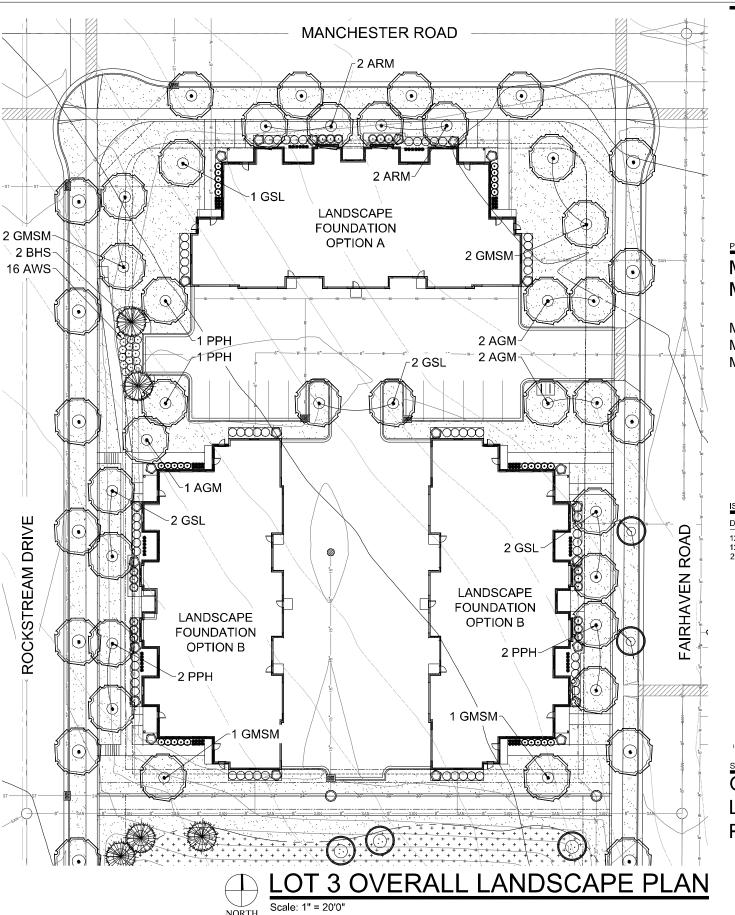

HELLER & ASSOCIATES, 1

MAPLE GROVE MULTI-FAMILY

Maple Grove Road at Manchester Road Madison, WI

ISSUANCE AND REVISIONS

DESCRIPTION 12.13.19 ISSUE TO OWNER 12.17.19 SUBMITTAL 2.28.20 REVISED SITE PLAN

SHEET TITLE

OVERALL LANDSCAPE PLAN: LOT 3

PROJECT MANAGER	WDH
PROJECT NUMBER	19-090
DATE	2.28.20
SHEET NUMBER	



EVERGREEN SHURBS

KCPJ Kallay Compact Pfitzer Juniper Taunton Intermediate Yew

Incrediball Hydrangea Unique Hydrangea PPSR Pink Pavement Series Rose AWS Anthony Waterer Spirea MKL Miss Kim Dwarf Lilad KSV Fragrant Koreanspice Viburnum WRW Wine & Roses Compact Wiegela

ORNAMENTAL GRASSES

KFRG Karl Foerster Feather Reed Grass PDS Prairie Dropseed

PLANT ABBREVIATIONS

- 1. Contractor responsible for contacting Diggers Hotline (811 or 800-242-8511) to have site marked prior to excavation or planting
- 2. Contractor to verify all plant quantities shown on Plant & Material List and landscape planting symbols and report any discrepancies to Landscape Architect of General Contractor.
- 3. All plantings shall comply with standards as described in American Standard of Nursery Stock Z60.1 ANSI (talest version). Landscape Architect reserves the right to inspect, and potentially reject any plants that are inferior, compromised, undersized, diseased, improperly transported, installed incorrectly or damaged. No sub-standard "B Grade" or "Park Grade" plant material shall be accepted. Plant material shall originate from nursery(ies) with a similar climate as
- 5. Topspol in Parking Lot Islands (if applicable): All parking lot islands to be backfilled with topsoil to a minimum depth of 18" to insure long-term plant health. Topsoil should be placed within 3" of finish grade by General Contractor / Excavation Contractor during rough grading operations/activity. The landscape contractor shall be responsible for the fine grading of all disturbed areas, planting bed areas, and lawn areas. Crown all parking lot islands a minimum of 6" to provide proper drainage, unless otherwise specified.
- 6. Tree Planting: Plant all trees slightly higher than finished grade at the root flare. Remove excess soil from the top of the root ball, if needed. Remove and discard non-biodegradable ball wrapping and support wire. Removed biodegradable burlap and wire cage (if present) from the top \(\frac{1}{3}\) of the rootball and carefully bend remaining wire down to the bottom of the hole. Once the tree has been placed into the hole and will no longer be moved, score the remaining $\frac{2}{3}$ of the burdap and remove the twine. Provide three slow release fertilizer for each tree planted.
- 7. Tree Planting: Backfill tree planting holes 80% existing soils removed from excavation and 20% plant starter mix. Avoid air pockets and do not tamp soil down. Discard any gravel, rocks, heavy clay, or concrete pieces. When hole is § full, trees shall be watered thoroughly, and water left to soak in before proceeding to fill the remainder of the hole. Water again to full soak in the new planting. Each tree shall receive a 3" deep, 4-5" diameter (see planting details or planting plan) shredded hardwood bark mulch ring around all trees planted in Jawan areas. Do not build up any mulch onto the trunk of any tree. Trees that are installed incorrectly will be replaced at the time and expense of the Landscape Contractor.
- 8. Shrub Planting: All shrubs to be planted in groupings as indicated on the Landscape Plan. Install with the planting of shrubs a ¹⁰/₅₀ mix of plant starter with topsoil. Install lopsoil into all plant beds as needed to achieve proper grade and displace undesirable soil (see planting detail). Remove all excessive graved, clay and stones from plant beds prior to planting. When hole(s) are ½ full, shrubs shall be watered thoroughly, and water left to soak in before proceeding. Provide slow-release fertilizer packets at the rater of 1 per 24* height/diamter of shrub at planting.
- 9. Mulching. All free and shrub planting beds to receive a 3" deep layer of high qualify shredded hardwood bark mulch (not pigment dyed or enviro-mulch). All perennial planting areas (groupings) shall receive a 2" layer of shredded hardwood bark mulch, and groundcover areas a 1-2" layer of the same mulch. Do not mulch annual flower bods (if applicable). Do not allow mulch to contact plant stems and tree trunks.
- 10. Edging: All planting beds shall be edged with a 4" deep spade edge using a flat landscape spade or a mechanical edger. Bedlines are to be cut crisp, smooth as per plan. A clean definition between landscape beds and lawn is required. Pack mulch against lawn edge to hald in place.
- 11. Plant bed preparation/Soil Amendment composition: All perennial, groundcover and annual areas (if applicable) are required to receive a blend of organic soil (Soil Amendments) amendments prior to installation. Roto-till the following materials at the following ratio, into existing soil beds or installed topsoil beds to a depth of approximately 8"-10". Containerized and balled & burlapped plant material should be back-filled with amended soil:

Per 100 SF of bed area (Soil Amendment composition): % CV Peat Moss or Mushroom Compost % CV Peat Moss or Mushroom Compost % CV blended/pulverized Topsoil % CV composted manure

In roto-tilled beds only, also include in above mixture: 2 lbs Starter Fertilizer

- 12. Lawn Installation for all sodded turfgrass areas: Contractor to furnish and prepare blended topsoli (2" minimum) and sod bed, removing all debris and stones ½" and larger. Apply a 10-10-10 starter lawn fertilizer uniformly throughout areas prior to laying sod. Use only premium sod blend according to TPI (revised 1995) and ASPA Standards. Install sod uniformly with staggered joints, laid tightly end to end and side to side. Roll sod with a walk behind roller and water immediately upon installation to a 3" depth. Stake any sod installed on slopes steeper than 13, and in late applications. Contractor is responsible to provide a smooth, uniform, healthy turf, and is responsible for the first two mowings of the newly installed turf, and is also responsible for watering during this
- 13. Installation preparation for all seeded areas: remove/kill off any existing unwanted vegetation prior to seeding. Prepare the topsoil (if adequate or provide as in item #6 above) and seed bed by removing all surface stones 1* or larger. Apply a starter fertilizer and specified seed uniformly at the specified rate, and provide much covering suitable to germinate and establish turf. Provide seed and fertilizer specifications to Landscape Architect and Owner prior to installation. Erosion control measures are to be used in swales and on shopes in excess of 1:3 and where applicable (see Civil Engineering Drawings). Methods of installation may var are the discretion of the Landscape Contractor on his/her responsibility to establish and guarantee a smooth, uniform, quality turf. A minimum of 2* days are the discretion of the Landscape Contractor on his/her responsibility to establish and guarantee a smooth, uniform, quality turf. A minimum of 2* of blended, prepared and non-compacted toposid is required for all lavar areas. If straw mulch used as a mulch covering, a tacklifier may be necessary to avoid wind dispersal of mulch covering. Marsh hay containing reed canary grass is NOT acceptable as a mulch covering.

An acceptable quality seed installation is defined as having:


No bare spots larger than one (1) square foot

No more than 10% of the total area with bare areas larger than one (1) square foot

- 14. No-Mow seed areas: "No-Mow" fine fescue seed mix with annual rye nurse crop (available at Cedar Creek Seed Farm 888-313-6807; or Prairie Nursery 608-286-3879) or approved equivalent mix from a reputable seed mix provider. Apply at 220 lbs per acre or at rate recommended by supplier. Prepare seed bed and soil as specified in time #13 above.
- 15. Native Prairie Seed Mix / Stormwater Seed Mix: Native seed mixes as listed on the Plant and Material List or other seeding schedules outlined on the landscape plan set. Seed mixes available from Prairie Nursery 808-296-3379 or JF New 8008-348-1783 or approved equivalent mix from a reputable seed mix provider. Apply at rates specified herein, or per supplier recommendation. Prepare soil and seed bed as in lam #13 above.
- 16. Warranty and Replacements: All plantings are to be watered thoroughly at the time of planting, through construction and upon completion of project as required. Trees, Evergreens, and Shrubs (deciduous and evergreen) shall be guaranteed (100% replacement) for a minimum of one (1) year from the date of project completion. Perennials, groundovers, and ornamental grasses shall be guaranteed for a minimum of one (1) growing season. Perennials, groundovers, and ornamental grasses planted after September 15th shall be guaranteed through May 31st the following year. Only one replacement per plant will be required during the warranty period, except for bases or replacements due to fallure to comply with grain strength of the project.

 Watering and general ongoing maintenance instructions are to be supplied by the Landscape Contractor to the Owner upon completion of the project.
- 17. The Landscape Contractor is responsible for the watering and maintenance of all landscape areas for a period of 45 days after the substantial completion of the landscape installation. This shall include all trees, shrubs, evergreens, perennials, omamental grasses, turf grass, no-mow grass, and native prairie seed mix / stormwater seed mix. Work also includes weeding, edging, mulching (only if required), fertilizing, trimming, sweeping up grass dippings, pruning and dependentions.
- 18. Project Completion: Landscape Contractor is responsible to conduct a final review of the project, upon completion, with the Landscape Architect, Client o Owner / Clent Representative, and the General Contractor to answer questions, provide written care instructions for new plantings and turf, and insure that all specifications have been mel.

LANDSCAPE GENERAL NOTES

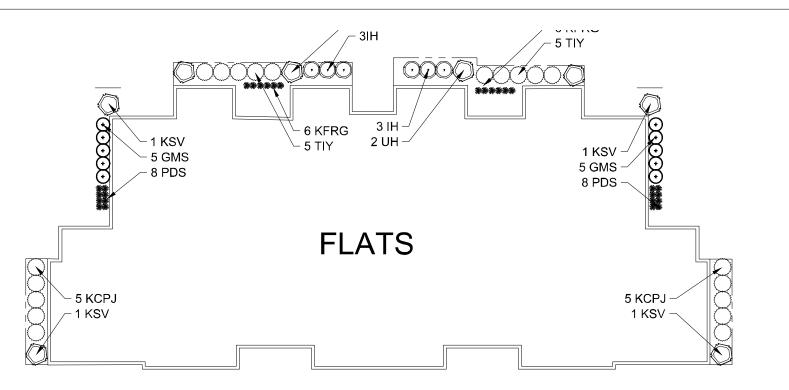




MAPLE GROVE MULTI-FAMILY

Maple Grove Road at Manchester Road Madison, WI



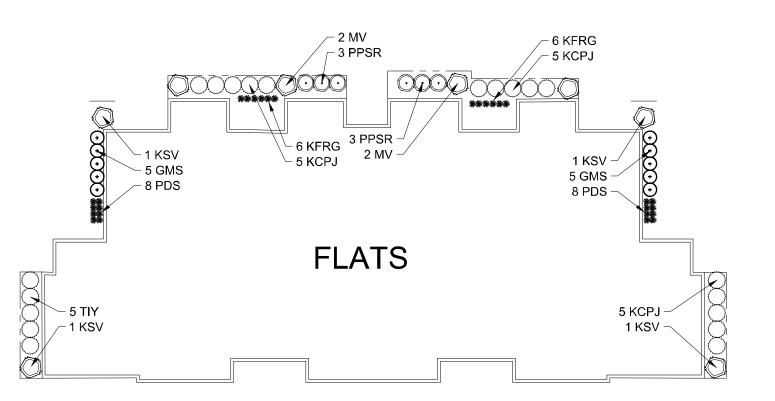

ISSUANCE AND REVISIONS


DESCRIPTION DATE 12.13.19 ISSUE TO OWNER 12.17.19 SUBMITTAL 2.28.20 REVISED SITE PLAN


SHEET TITLE

OVERALL LANDSCAPE PLAN: LOT 3

PROJECT MANAGER	WDI
PROJECT NUMBER	19-09
DATE	2.28.2
SHEET NUMBER	

LANDSCAPE FOUNDTION - OPTION "B"

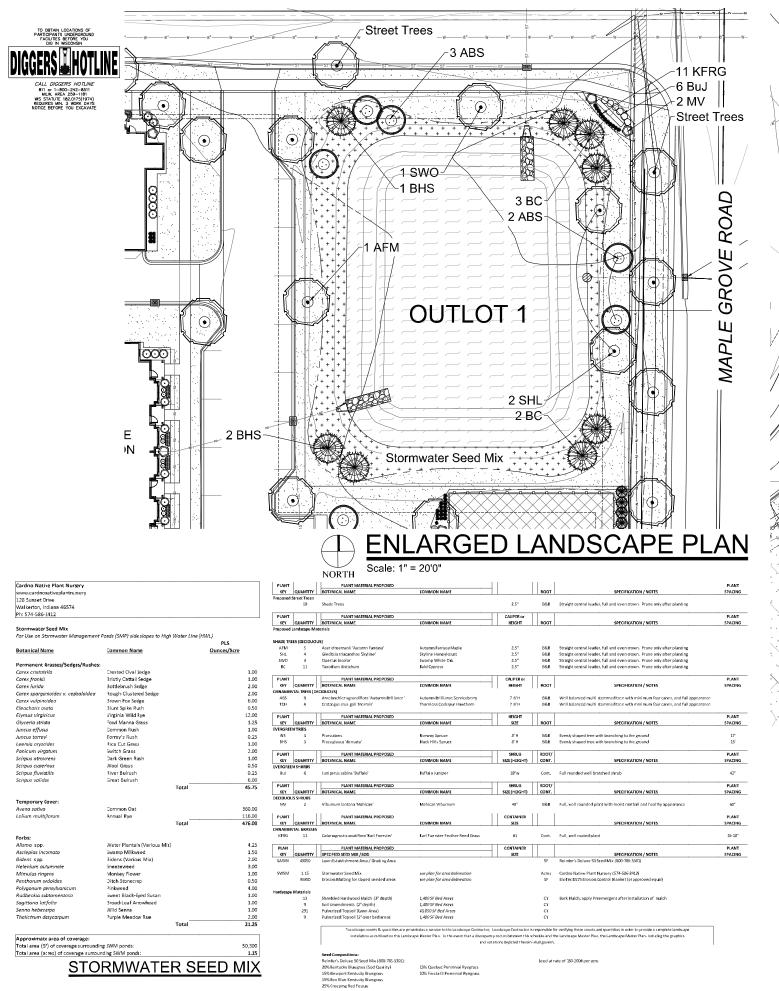

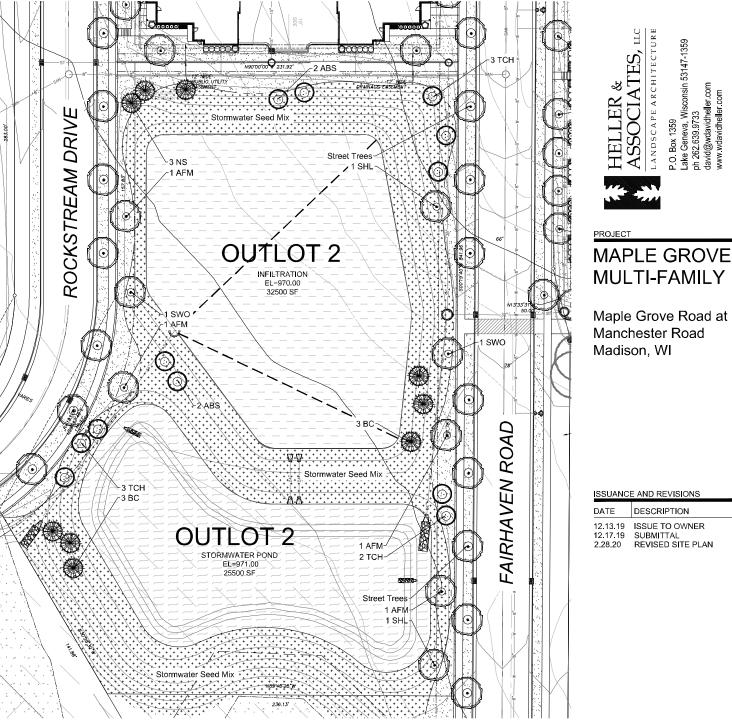

ENLARGED LANDSCAPE PLAN


OVERALL LANDSCAPE PLAN: OUTLOTS 1 & 2


ISSUANCE AND REVISIONS DESCRIPTION

PROJECT MANAGER	WDH
PROJECT NUMBER	19-090
DATE	2.28.20

L 1.10

PLANT & MATERIAL SCHEDULE: OUTLOTS 1 & 2

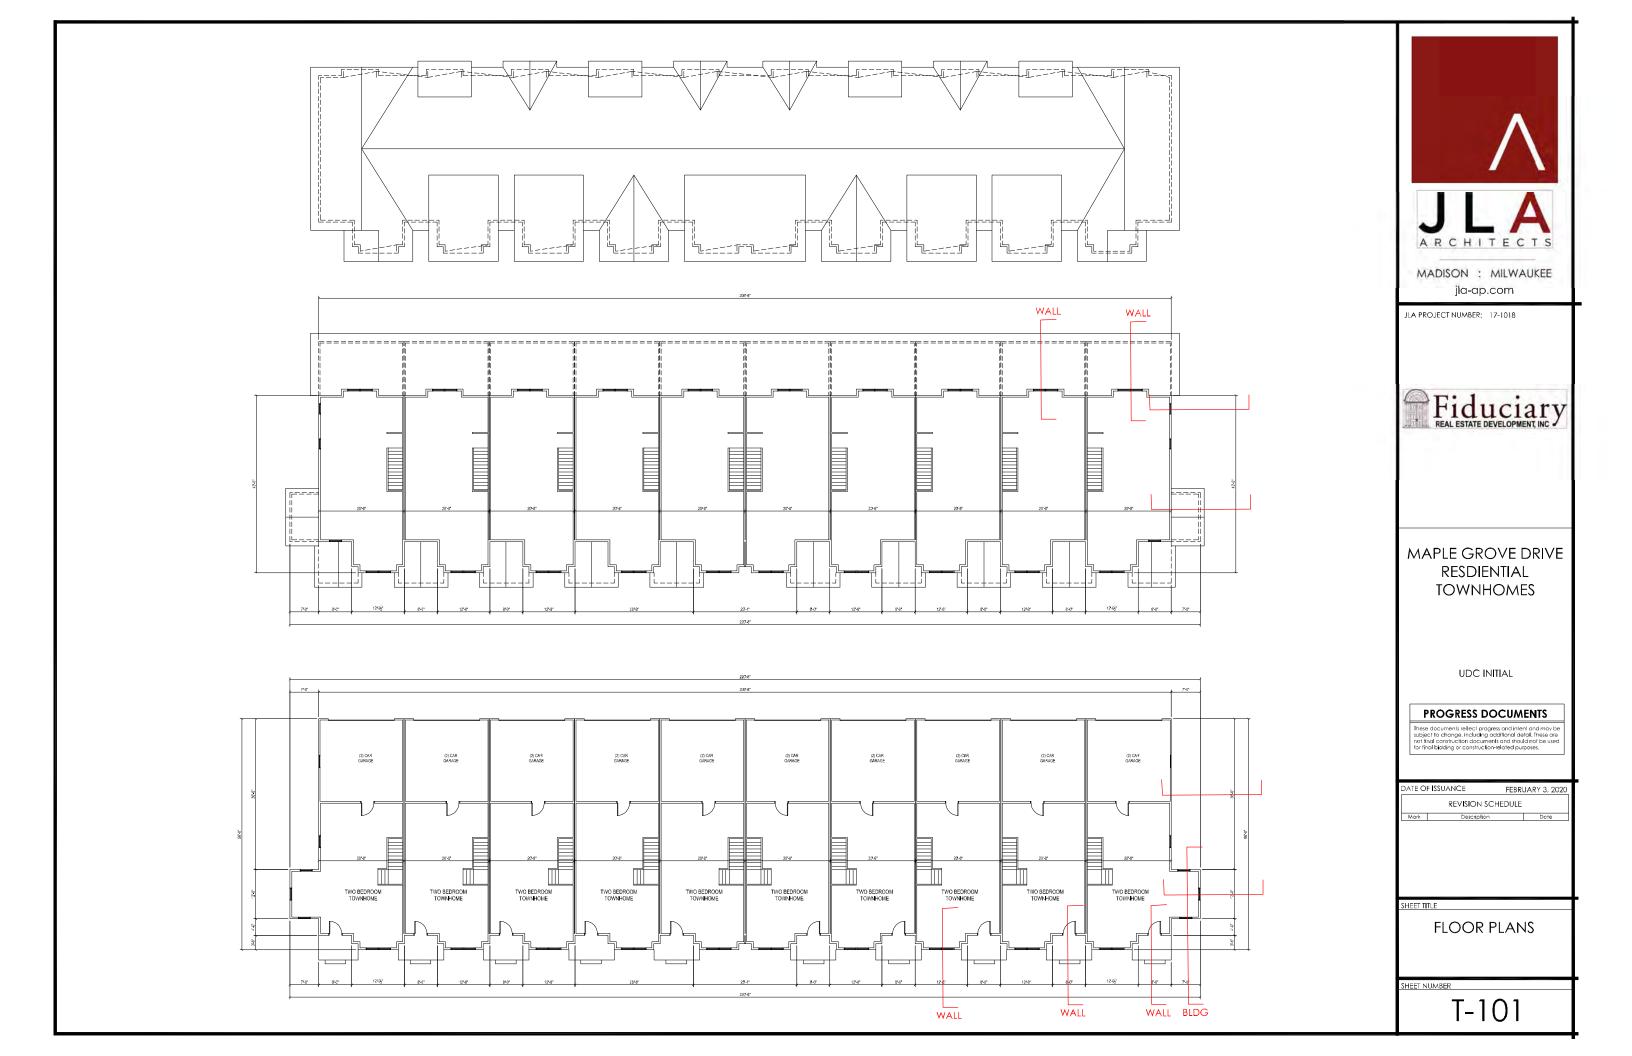

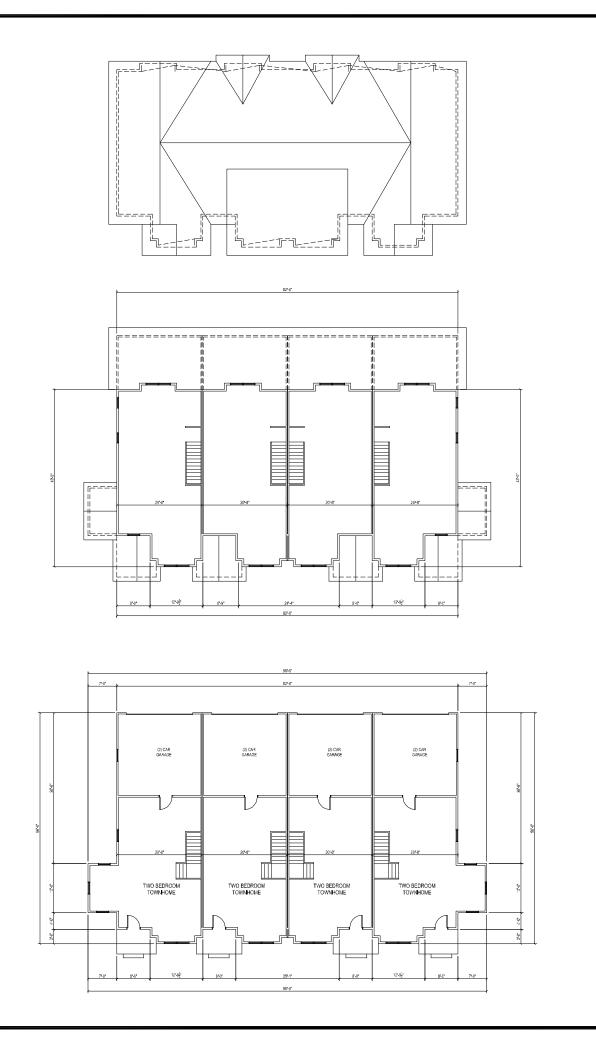



JLA PROJECT NUMBER: 17-1018



MAPLE GROVE DRIVE RESDIENTIAL TOWNHOMES

UDC INITIAL

PROGRESS DOCUMENTS

These documents reflect progress and intentional may be subject to change, including additional detail. These are not final construction documents and should not be used for final bidding or construction-related purposes.

	REVISION SCHEDU	LE
Mark	Description	Dote

SHEET TITLE

FLOOR PLANS

SHEET NUMBE

T-102









MADISON : MILWAUKEE jla-ap.com

JLA PROJECT NUMBER: XX-XXXX-XX

MAPLE GROVE DRIVE RESDIENTIAL TOWNHOMES

UDC INITIAL

PROGRESS DOCUMENTS

These documents reflect progress and intent and may b subject to change, including additional detail. These are not final construction documents and should not be use for final bidding or construction-related purposes.

DATE O	F ISSUANCE	FEBRUARY 3, 20	20
	REVIS ION SCHI	EDULE	
Mark	Description	Date	

SHEET TITLE

SKETCHUP ELEVATIONS

SHEET NUMBER

T-A200



16 10 Unit South Elevation







8 4 Unit East Elevation 1/8" = 1'-0"



16 10 Unit North Elevation

J L A ARCHITECTS

MADISON : MILWAUKEE jla-ap.com

JLA PROJECT NUMBER: XX-XXXX-XX

MAPLE GROVE DRIVE RESDIENTIAL TOWNHOMES

UDC INITIAL

PROGRESS DOCUMENTS

These documents reflect progress and intent and may be subject to change, including additional detail. These are not final construction documents and should not be used for final bidding or construction related purposes.

DATE OF ISSUANCE FEBRUARY 3, 2020

REVISION SCHEDULE

Mark Description Date

SHEET TITLE_

SKETCHUP ELEVATIONS

SHEET NUMBER

T-A201



6 PERSPECTIVE





MADISON : MILWAUKEE jla-ap.com

JLA PROJECT NUMBER: XX-XXXX-XX

MAPLE GROVE DRIVE RESDIENTIAL TOWNHOMES

UDC INITIAL

PROGRESS DOCUMENTS

These documents reflect progress and intent and may be subject to change, including additional detail. These are not final construction documents and should not be used for final bidding or construction-related purposes.

FEBRUARY 3, 2020	
REVISION SCHEDULE	
Date	

SHEET TITL

SKETCHUP PERSPECTIVES

SHEET NUMBE

T-A202



6 PERSPECTIVE





MADISON : MILWAUKEE jla-ap.com

JLA PROJECT NUMBER: XX-XXXX-XX

MAPLE GROVE DRIVE RESDIENTIAL TOWNHOMES

UDC INITIAL

PROGRESS DOCUMENTS

These documents reflect progress and intent and may b subject to change, including additional detail. These are not final construction documents and should not be use for final bidding or construction-related purposes.


3, 2020	
revision schedule	
Date	


SHEET TITL


SKETCHUP PERSPECTIVES


SHEET NUMBE


T-A202

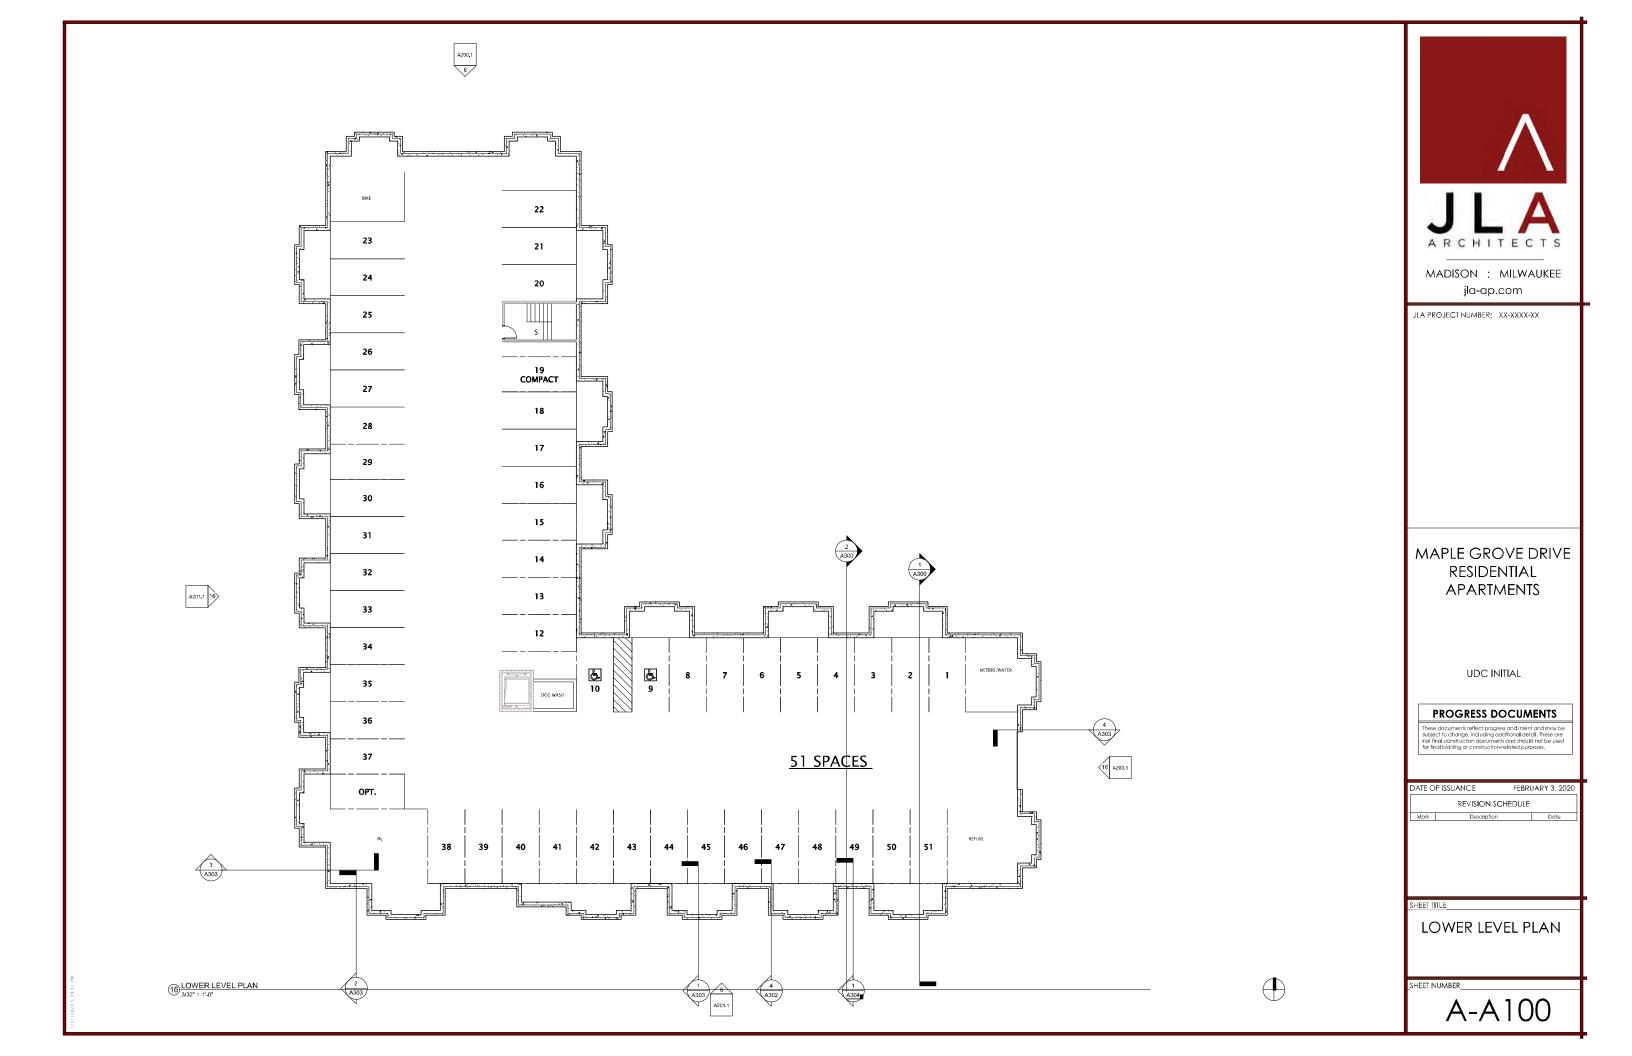

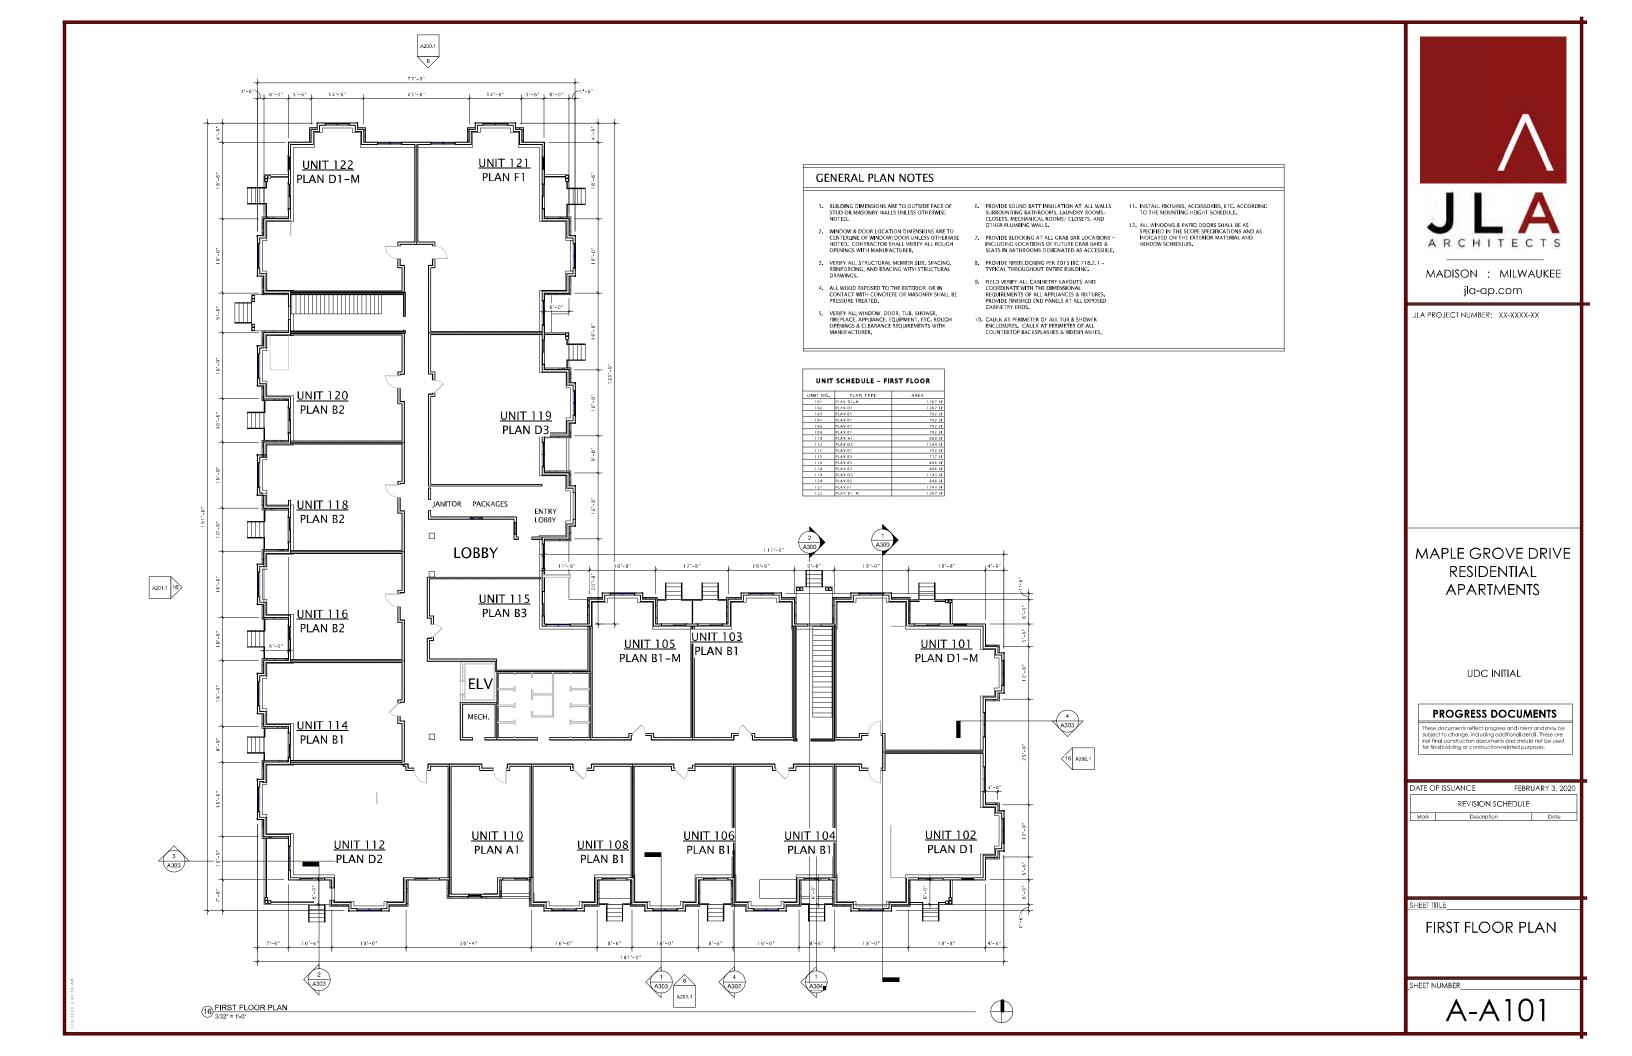

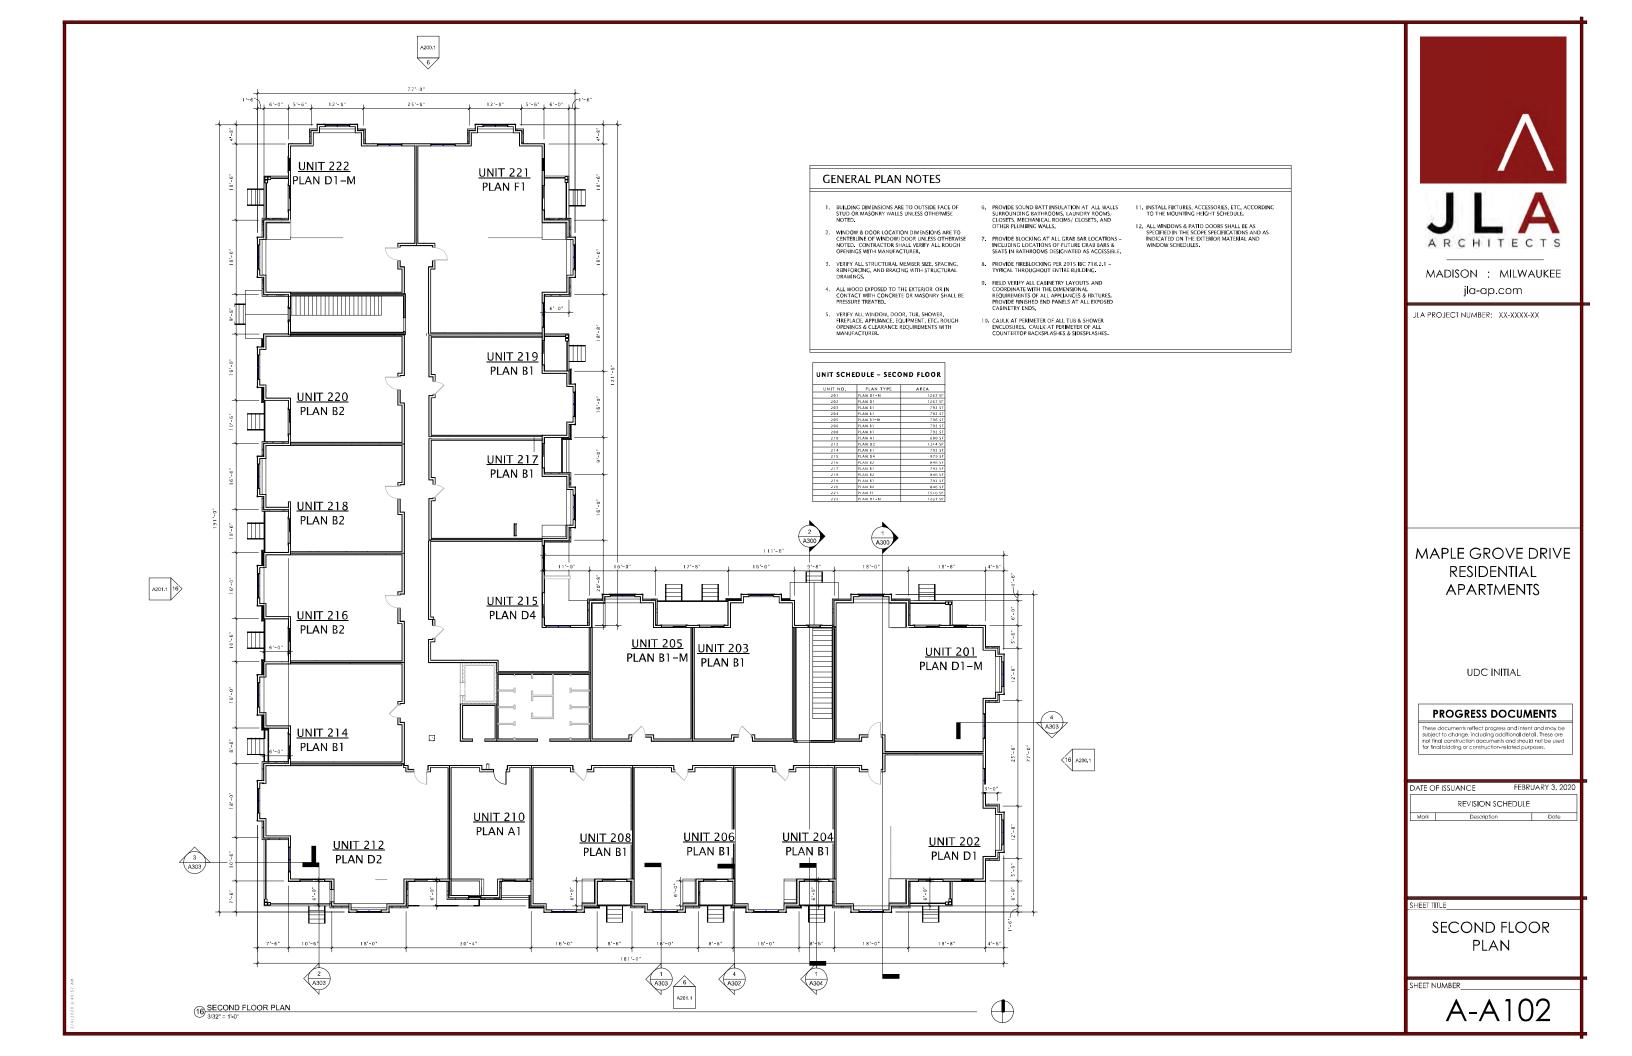

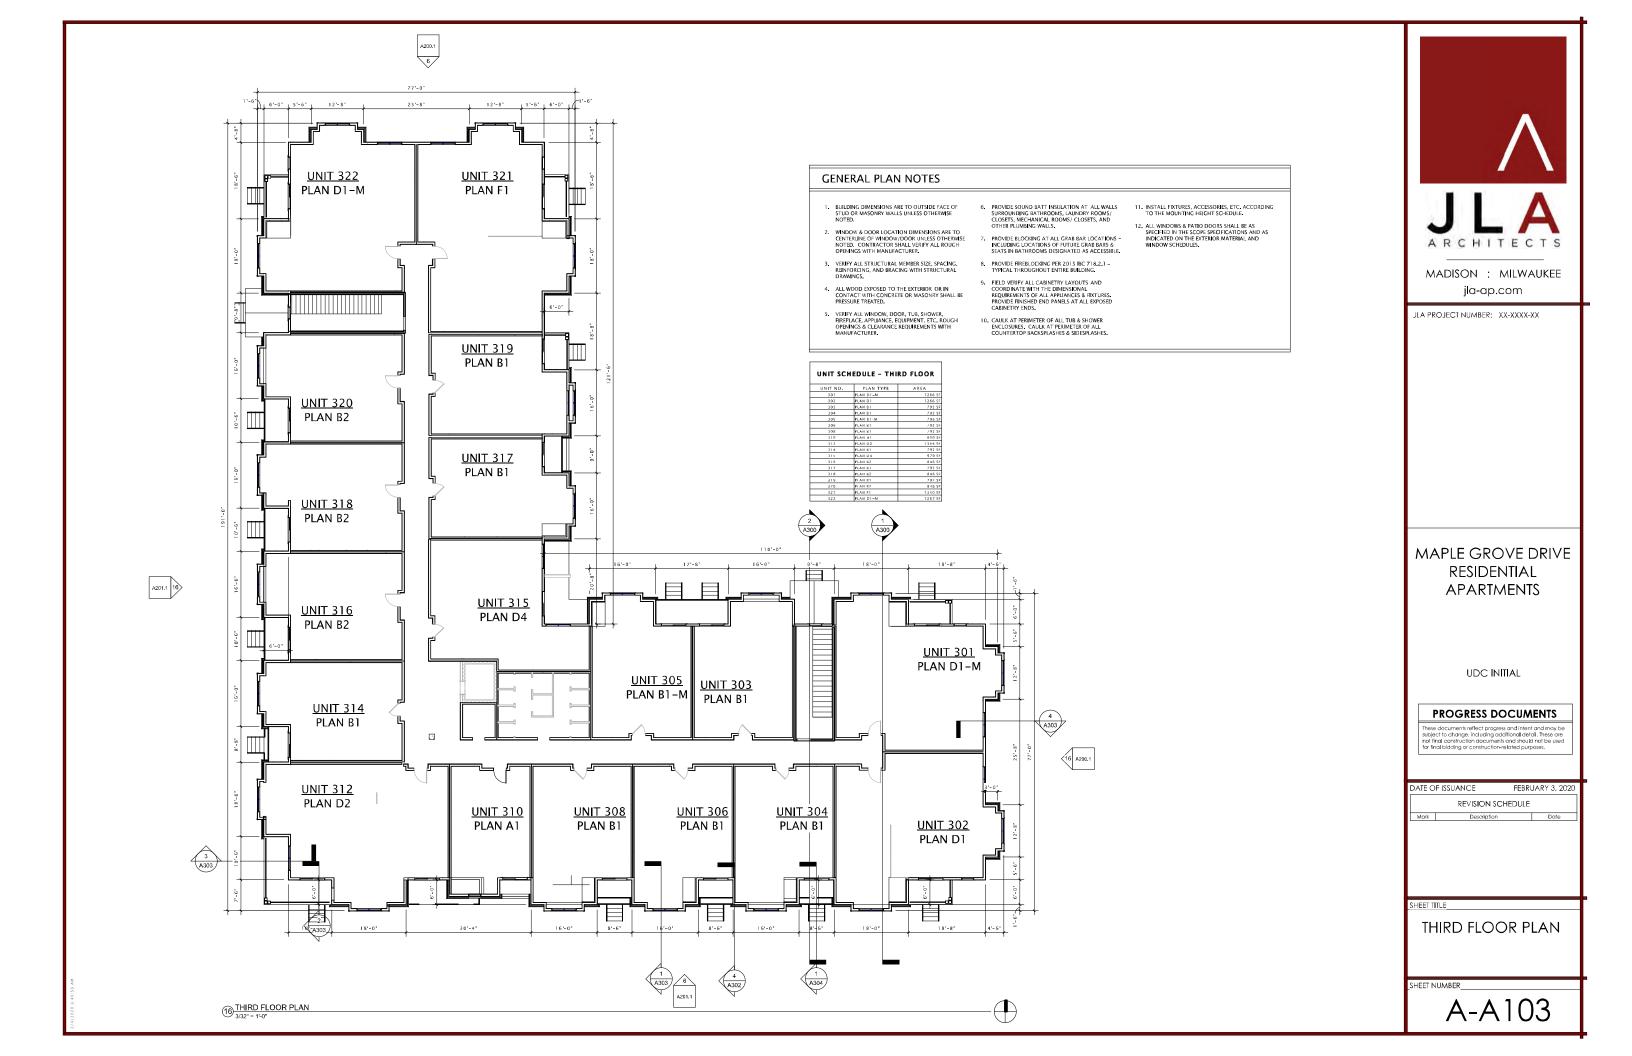

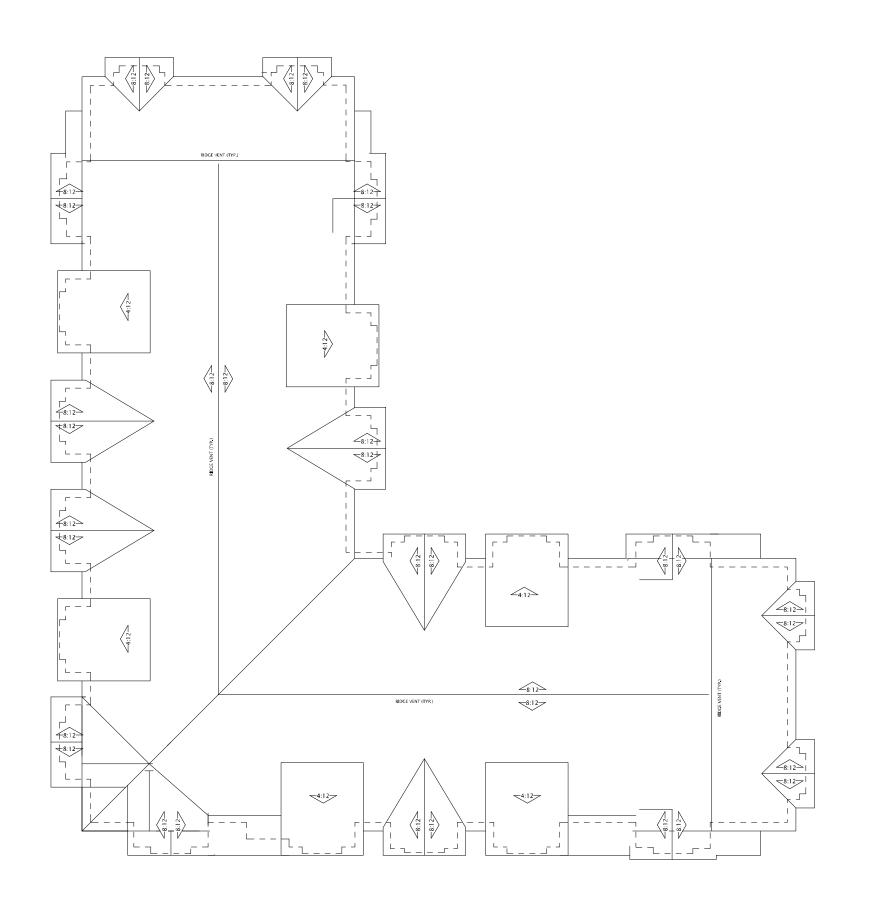



MADISON: MILWAUKEE jla-ap.com

JLA PROJECT NUMBER: XX-XXXX-XX

MAPLE GROVE DRIVE RESIDENTIAL APARTMENTS

UDC INITIAL

PROGRESS DOCUMENTS

These documents reflect progress and intent and may b subject to change, including additional detail. These are not final construction documents and should not be use for final bidding or construction-related purposes.

DATE OF ISSUANCE FEBR			
revision schedule			
Mark Description Date			
	revision s		

SHEET TI

ROOF PLAN

SHEET NUMBER

A-A104

1) ROOF PLAN Copy 1





16 A - Elevation West



MADISON : MILWAUKEE jla-ap.com

JLA PROJECT NUMBER: XX-XXXX-XX

MAPLE GROVE DRIVE RESIDENTIAL APARTMENTS

UDC INITIAL

PROGRESS DOCUMENTS

These documents reflect progress and intent and may b subject to change, including additional detail. These are not final construction documents and should not be use for final bidding or construction-related purposes.

Г	DATE O	FEBRUARY 3, 2020		
	revision schedule			
	Mark Description Date			

SHEET TITL

SKETCHUP ELEVATIONS

SHEET NUMBER

A-A200



6 A - Elevation North



16 A - Elevation East



MADISON: MILWAUKEE jla-ap.com

JLA PROJECT NUMBER: XX-XXXX-XX

MAPLE GROVE DRIVE RESIDENTIAL APARTMENTS

UDC INITIAL

PROGRESS DOCUMENTS

These documents reflect progress and intent and may b subject to change, including additional detail. These are not final construction documents and should not be use for final bidding or construction-related purposes.

DATE O	F ISSUANCE	FEBRU	JARY 3, 2020	
	REVISION SCHEDULE			
Mark	Mark Description			

SHEET TITL

SKETCHUP ELEVATIONS

SHEET NUMBER

A-A201



6 PERSPECTIVE 1/8" = 1'-0"





MADISON : MILWAUKEE jla-ap.com

JLA PROJECT NUMBER: XX-XXXX-XX

MAPLE GROVE DRIVE RESIDENTIAL APARTMENTS

UDC INITIAL

PROGRESS DOCUMENTS

These documents reflect progress and intent and may b subject to change, including additional detail. These are not final construction documents and should not be use for final bidding or construction-related purposes.


DATE O	f ISSUANCE	FEBRUARY 3, 2020
revision sched		CHEDULE
Mark	Description	n Date

SHEET TITL

SKETCHUP PERSPECTIVES

SHEET NUMBER

A-A202

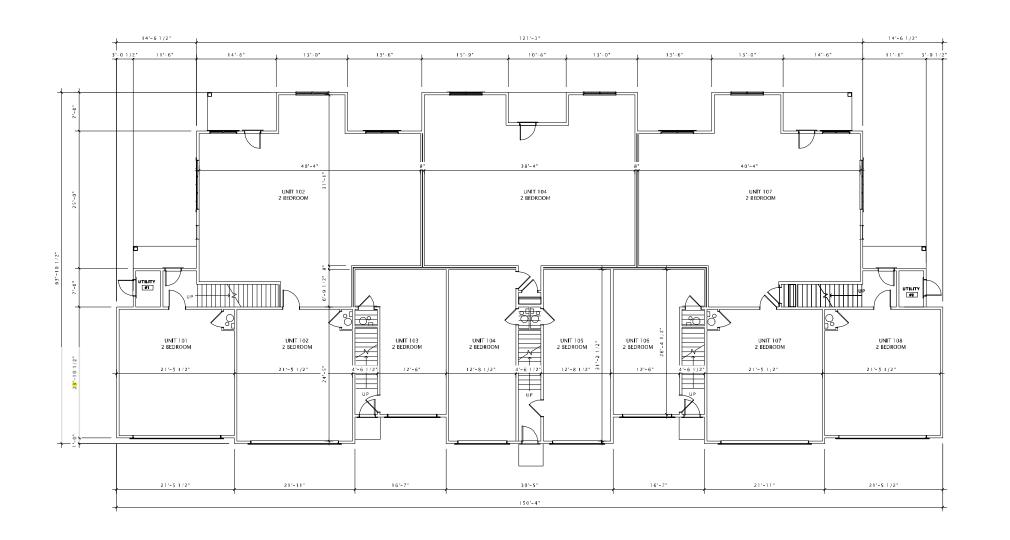



JLA PROJECT NUMBER: XX-XXXX-XX

MAPLE GROVE ROAD STACKED FLATS

UDC INITIAL

PROGRESS DOCUMENTS

These documents reflect progress and intent and may subject to change, including additional detail. These a not final construction documents and should not be us for final bidding or construction-related purposes.

DATE OF ISSUANCE FEBRUARY 3, 2020

REVISION SCHEDULE

Mark Description Date

SHEET TITLE


FIRST FLOOR PLAN

HEET NUMBER

 \bigoplus

S-A101

1) FIRST FLOOR PLAN 1/8" = 1'-0"

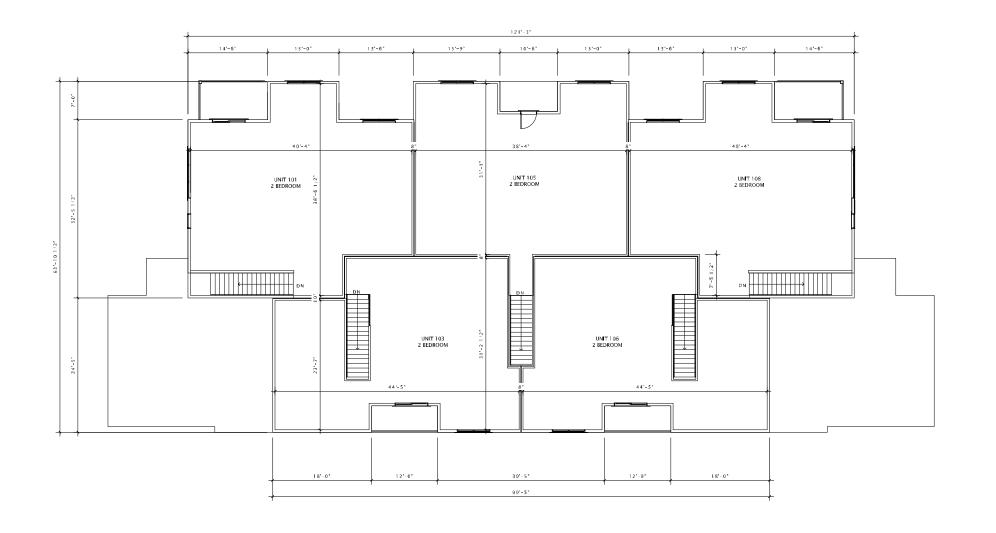



MADISON : MILWAUKEE jla-ap.com

JLA PROJECT NUMBER: XX-XXXX-XX

MAPLE GROVE ROAD STACKED FLATS

UDC INITIAL

PROGRESS DOCUMENTS

These documents reflect progress and intent and may subject to change, including additional detail. These a not final construction documents and should not be us for final bidding or construction-related purposes.

DATE OF ISSUANCE FEBRUARY 3, 2020

REVISION SCHEDULE

Mark Description Date

SHEET TITLE

SECOND FLOOR PLAN

HEET NUMBER


 \bigoplus

S-A102

SECOND FLOOR PLAN

1/8" = 1'-0"

2019 10:55:29 Pt

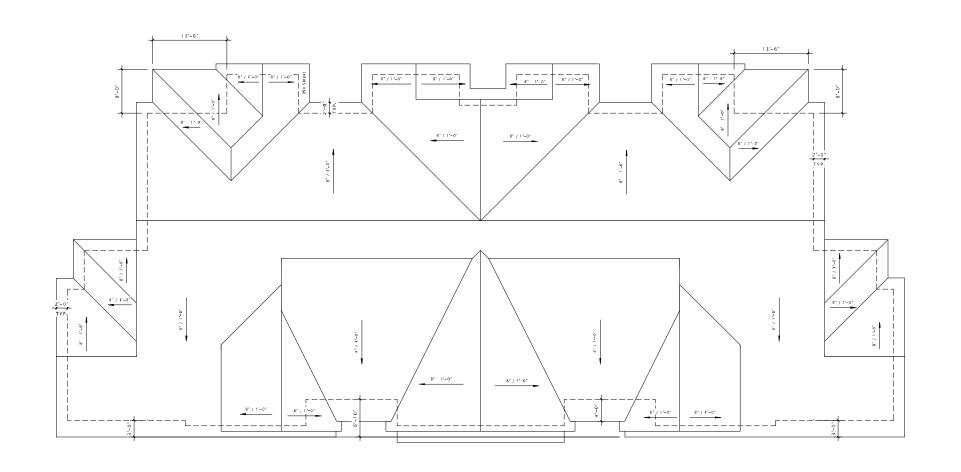



MADISON : MILWAUKEE jla-ap.com

JLA PROJECT NUMBER: XX-XXXX-XX

MAPLE GROVE ROAD STACKED FLATS

UDC INITIAL

PROGRESS DOCUMENTS

These documents reflect progress and intent and may b subject to change, including additional detail. These are not final construction documents and should not be use for final bidding or construction-related purposes.

DATE OF ISSUANCE FEBRUARY 3, 2020				
	REVISION SCHEDULE			
Mark	Mark Description			

SHEET TITLE

ROOF PLAN

SHEET NUMBER

S-A103

1) ROOF PLAN 1/8" = 1'-0"

2019 10:55:30 1





West Elevation



JLA PROJECT NUMBER: 17-1018

MAPLE GROVE ROAD STACKED FLATS

UDC INITIAL

PROGRESS DOCUMENTS

These documents reflect progress and intent and may be subject to change, including additional detail. These are not final construction documents and should not be used for final bidding or construction-related purposes.

	DATE O	FEBRUARY 3, 2020			
	revision schedule				
ı	Mark Description Date				

SHEET TITL

SKETCHUP ELEVATIONS

SHEET NUMBER

S-A200



JLA PROJECT NUMBER: 17-1018

MADISON : MILWAUKEE jla-ap.com

MAPLE GROVE ROAD STACKED FLATS

UDC INITIAL

PROGRESS DOCUMENTS

DATE O	F ISSUANCE	FEBRUARY 3, 2020
revision scheduli		DULE
Mark	Description	Date

SKETCHUP **ELEVATIONS**

S-A201

6 South Elevation
3/16" = 1'-0"



16 East Elevation
3/16" = 1'-0"



6 PERSPECTIVE 1/8" = 1'-0"





MADISON : MILWAUKEE jla-ap.com

JLA PROJECT NUMBER: XX-XXXX-XX

MAPLE GROVE DRIVE RESIDENTIAL STACKED FLATS

UDC INITIAL

PROGRESS DOCUMENTS

These documents reflect progress and intent and may be subject to change, including additional detail. These are not final construction documents and should not be used for final bidding or construction related purposes.


DATE O	f ISSUANCE	FEBRUARY 3, 2020
REVISION SCHEDULE		EDULE
Mark	Description	Date

SHEET TITL

SKETCHUP PERSPECTIVE

SHEET NUMBE

SF-A202

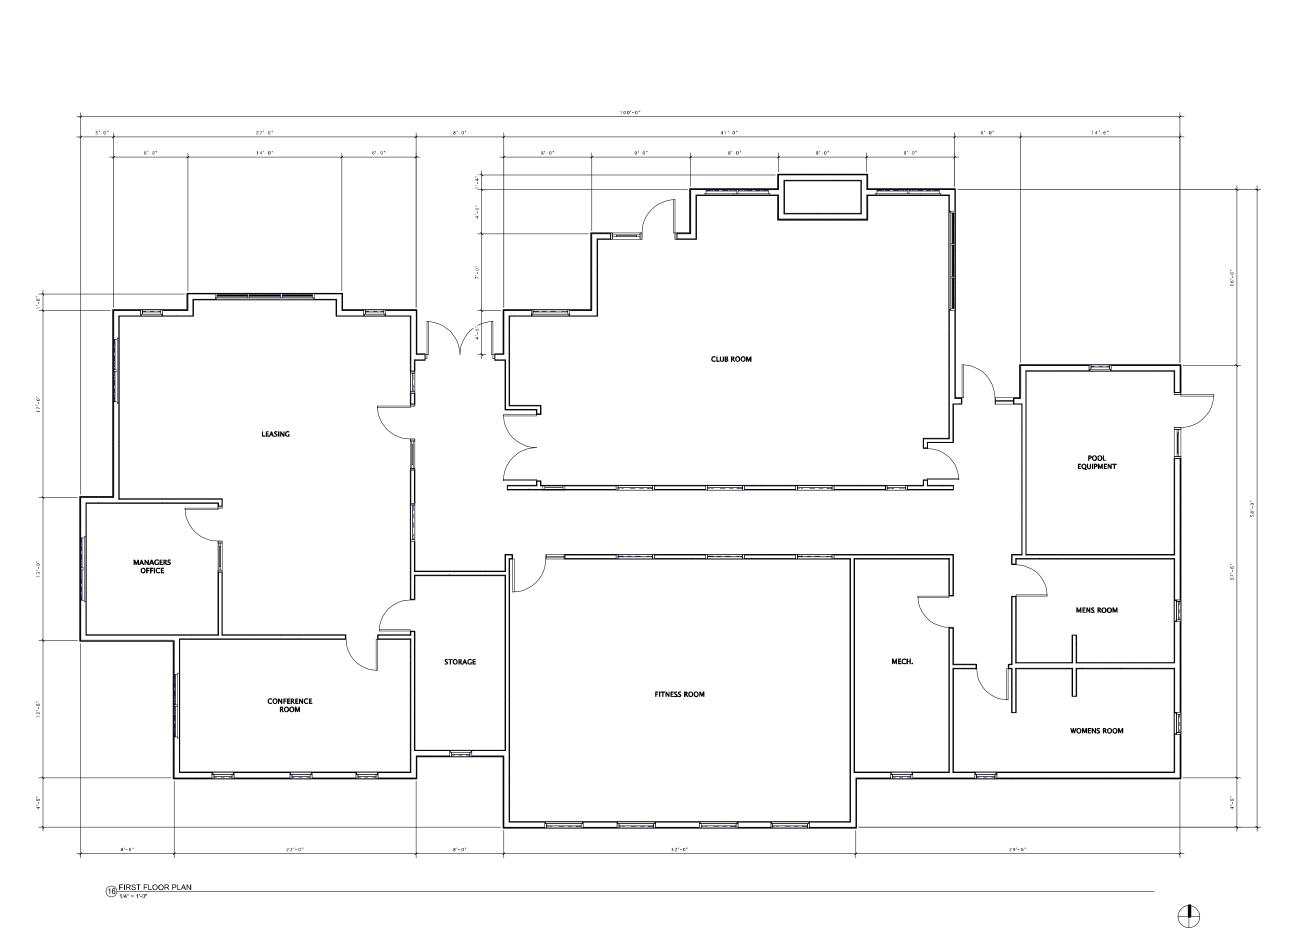



JLA PROJECT NUMBER: XX-XXXX-XX

MAPLE GROVE DRIVE CLUBHOUSE

UDC INITIAL

PROGRESS DOCUMENTS

These documents reflect progress and intent and may is subject to change, including additional detail. These are not final construction documents and should not be use for final bidding or construction-related purposes.

DATE OF ISSUANCE			FEBRUARY 3, 2020	
REVISION SCHEDULE Mark Description Date				

SHEET TITLE

FIRST FLOOR PLAN

SHEET NUMBER



6 C - Elevation North
3/16" = 1'-0"



16 C - Elevation West

J L A
A R C H I T E C T S

MADISON : MILWAUKEE

JLA PROJECT NUMBER: XX-XXXX-XX

jla-ap.com

MAPLE GROVE DRIVE CLUBHOUSE

UDC INITIAL

PROGRESS DOCUMENTS

These documents reflect progress and intent and may be subject to change, including additional detail. These are not final construction documents and should not be used for final bidding or construction-related purposes.

DATE O	F ISSUANCE	FEBRU	JARY 3, 2020	
	REVISION SCHEDULE			
Mark	Mark Description Date			

SHEET TITLE

SKETCHUP ELEVATIONS

SHEET NUMBER



6 C - Elevation South
3/16" = 1'-0"



16 C - Elevation East 3/16" = 1'-0"



MADISON : MILWAUKEE jla-ap.com

JLA PROJECT NUMBER: XX-XXXX-XX

MAPLE GROVE DRIVE CLUBHOUSE

UDC INITIAL

PROGRESS DOCUMENTS

These documents reflect progress and intent and may be subject to change, including additional detail. These are not final construction documents and should not be used for final bidding or construction related purposes.

DATE O	F ISSUANCE	FEBRU	JARY 3, 2020
revision schedule			
Mark Description Date			

SHEET TITL

SKETCHUP ELEVATIONS

SHEET NUMBER



6 PERSPECTIVE Club House





MADISON : MILWAUKEE jla-ap.com

JLA PROJECT NUMBER: XX-XXXX-XX

MAPLE GROVE DRIVE CLUBHOUSE

UDC INITIAL

PROGRESS DOCUMENTS

These documents reflect progress and intent and may b subject to change, including additional detail. These are not final construction documents and should not be use for final bidding or construction-related purposes.

2020

SHEET TITLE

SKETCHUP PERSPECTIVES

SHEET NUMBER