

**APPLICATION FOR  
URBAN DESIGN COMMISSION  
REVIEW AND APPROVAL**

**AGENDA ITEM # \_\_\_\_\_**

**Project # \_\_\_\_\_**

DATE SUBMITTED: September 17, 2008

**Action Requested**

Informational Presentation

Initial Approval and/or Recommendation

Final Approval and/or Recommendation

UDC MEETING DATE: September 24, 2008

PROJECT ADDRESS: 610 John Nolen Drive

ALDERMANIC DISTRICT: 14

OWNER/DEVELOPER (Partners and/or Principals)

Beechwood Development, LLC

ARCHITECT/DESIGNER/OR AGENT:

ICON Architectural Group, PLLC

1025 Thoroughbred Lane

4200 James Ray Drive

DePere, WI 54115

Grand Forks, ND 58203

CONTACT PERSON: Bert Slinde - Representative

Address: 4705 Monona Drive  
Monona, WI 53716

Phone: (608) 221-1900


Fax: (608) 221-1910

E-mail address: bert@slinderealty.com

**TYPE OF PROJECT:**

(See Section A for:)

- Planned Unit Development (PUD)
- General Development Plan (GDP)
- Specific Implementation Plan (SIP)
- Planned Community Development (PCD)
- General Development Plan (GDP)
- Specific Implementation Plan (SIP)
- Planned Residential Development (PRD)
- New Construction or Exterior Remodeling in an Urban Design District \* (A public hearing is required as well as a fee)
- School, Public Building or Space (Fee may be required)
- New Construction or Addition to or Remodeling of a Retail, Hotel or Motel Building Exceeding 40,000 Sq. Ft.
- Planned Commercial Site

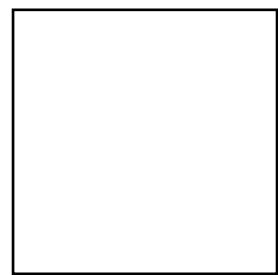

(See Section B for:)

- New Construction or Exterior Remodeling in C4 District (Fee required)

(See Section C for:)

- R.P.S.M. Parking Variance (Fee required)

(See Section D for:)


- Comprehensive Design Review\* (Fee required)
- Street Graphics Variance\* (Fee required)
- Other \_\_\_\_\_

\*Public Hearing Required (Submission Deadline 3 Weeks in Advance of Meeting Date)

Where fees are required (as noted above) they apply with the first submittal for either initial or final approval of a project.



 **Hilton Garden Inn**  
Proposed Site Location

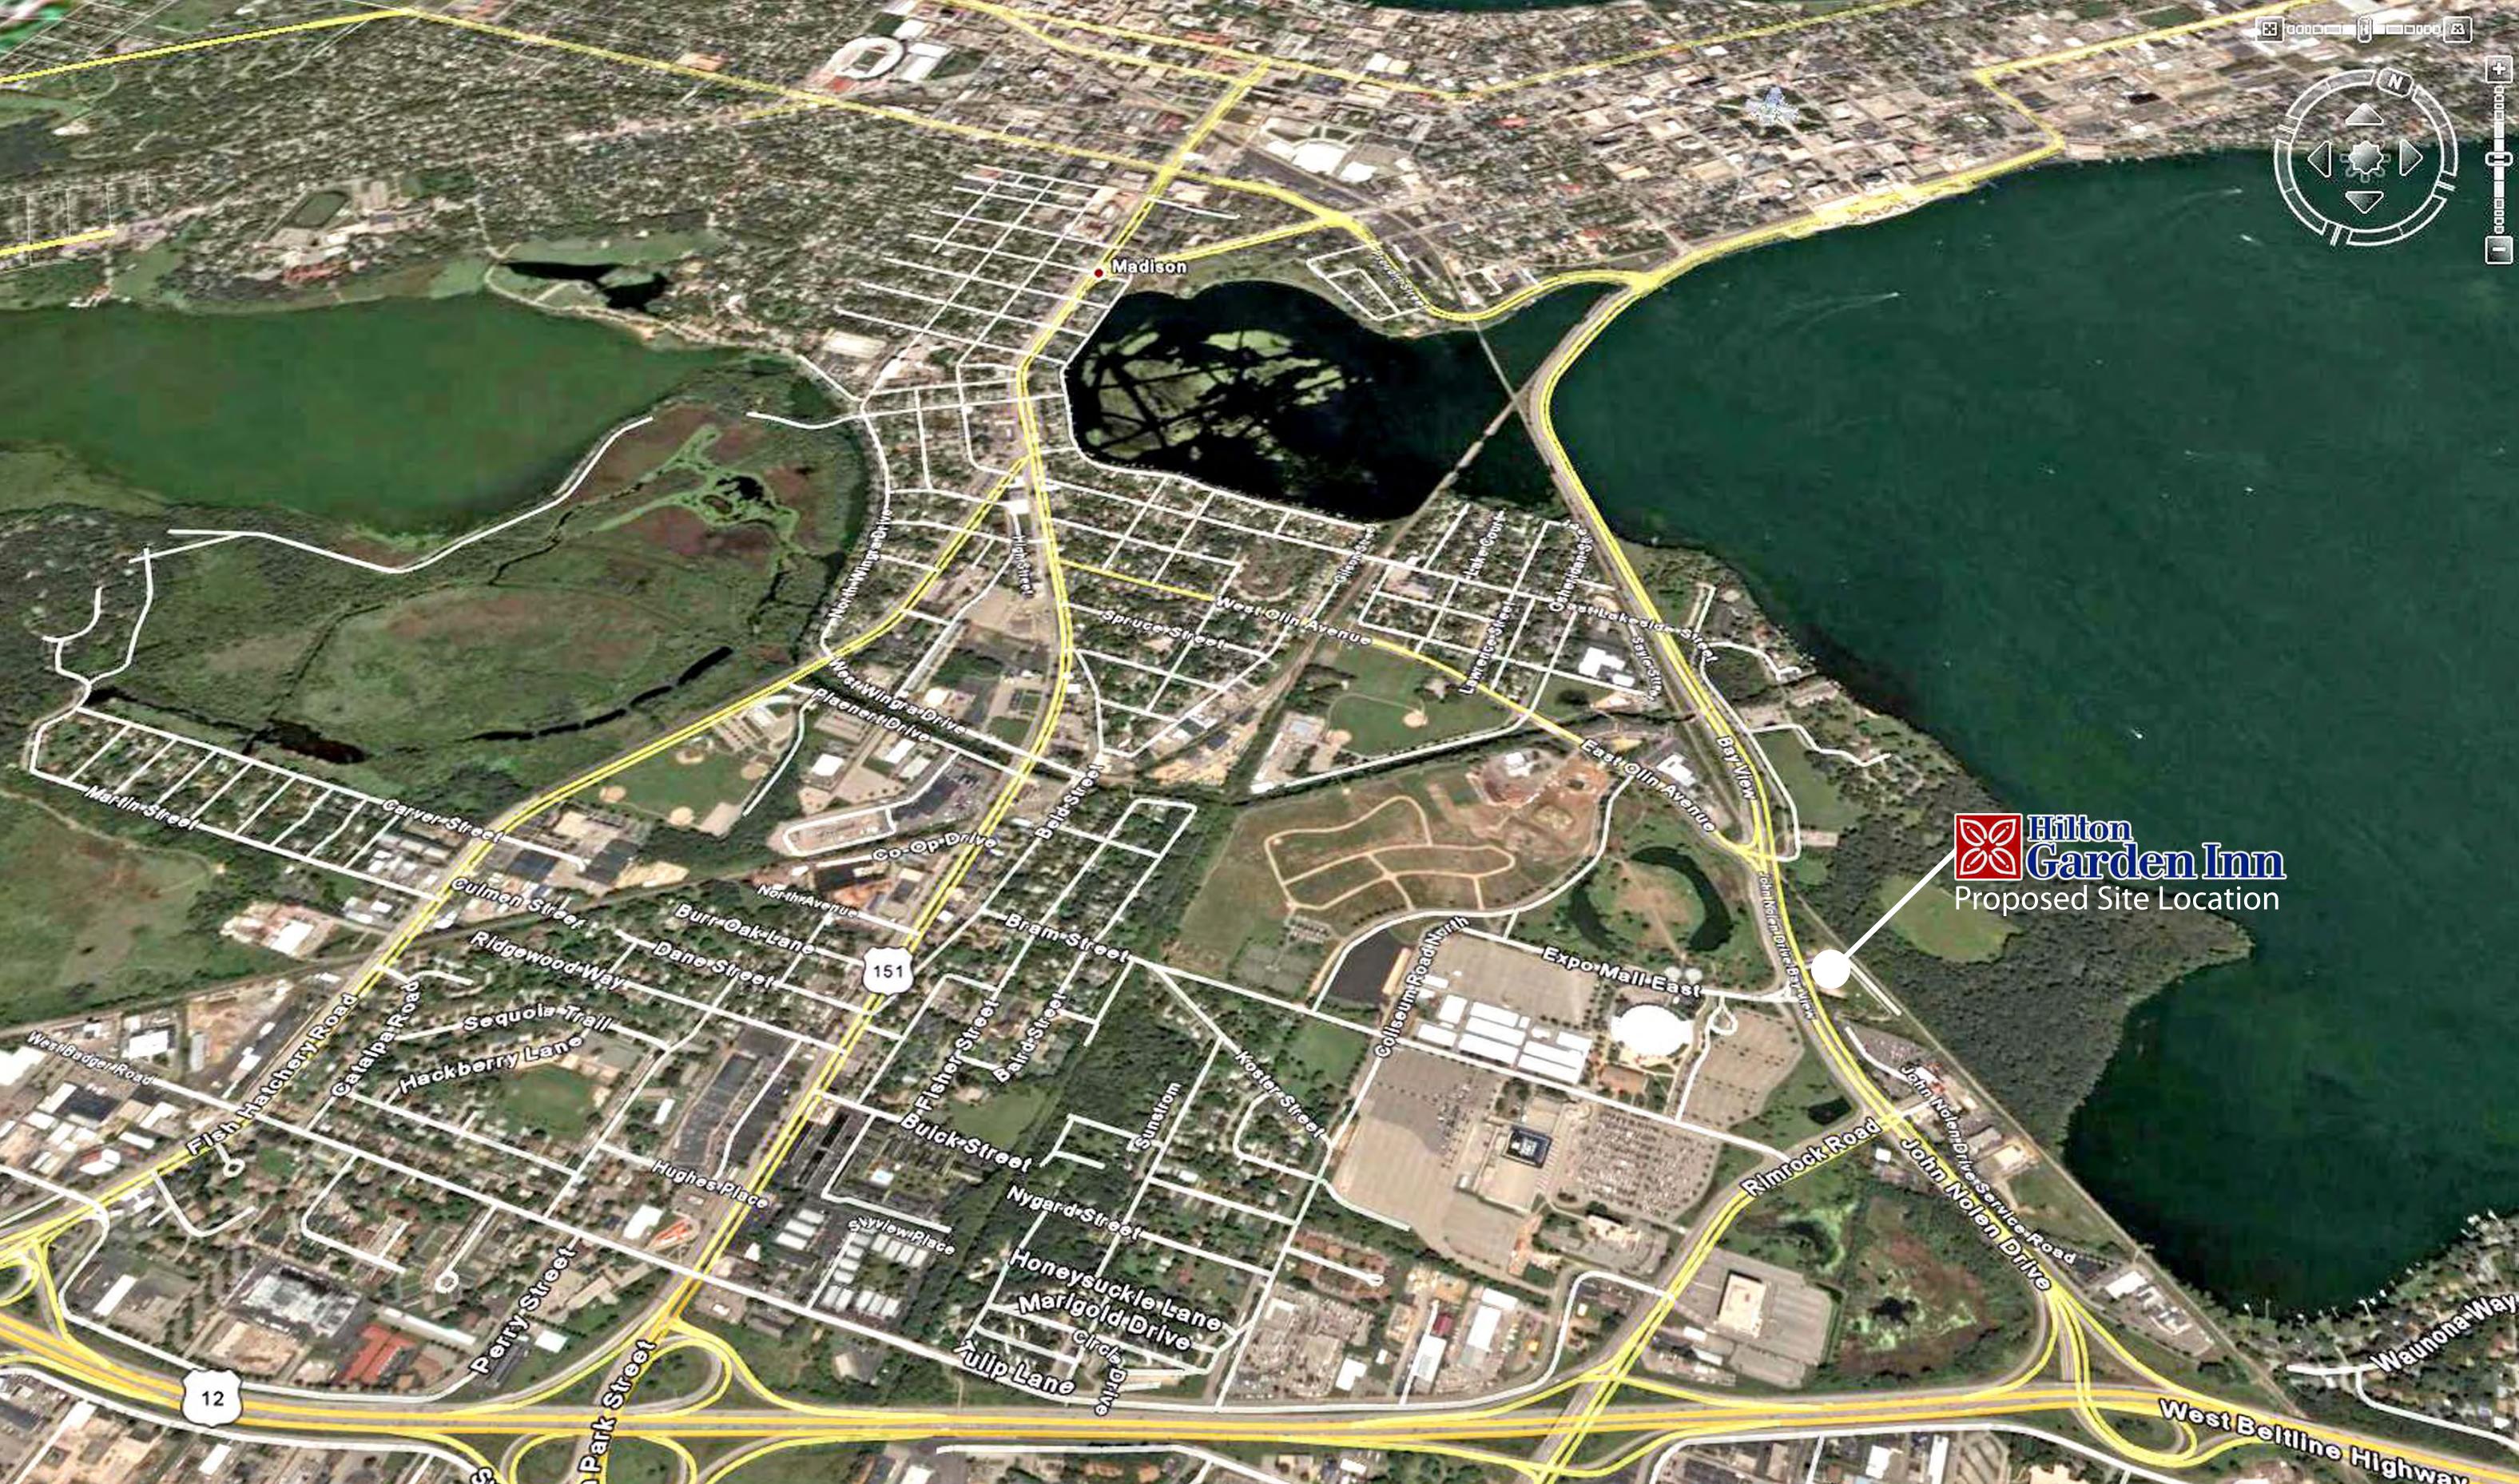

 **Hilton Garden Inn**  
Madison, Wisconsin



Beechwood  
Development, L.L.C.

**ICON**  
ARCHITECTURAL GROUP  
v. 701.772.ICON f. 701.772.4275  
[www.iconarchitects.com](http://www.iconarchitects.com)



 **Hilton  
Garden Inn**  
Madison, Wisconsin

  
**Beechwood  
Development, L.L.C.**

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## MATERIAL LEGEND

- 1 Architectural Concrete Base
- 2 Brick
- 3 Composite Metal Panel
- 4 Standing Seam Metal Roof
- 5 Precast Concrete Band
- 6 Fabric Awnings



 **Hilton  
Garden Inn**  
Madison, Wisconsin

  
Beechwood  
Development, L.L.C.

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 **Hilton  
Garden Inn**  
Madison, Wisconsin

  
**Beechwood  
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STRUCTURAL

ICON Architectural Group  
4200 James Ray Drive  
Grand Forks, North Dakota  
(701) 772 4266 Office  
(701) 772 4275 Fax

MECHANICAL

ELECTRICAL

CIVIL

# HILTON GARDEN INN

610 JOHN NOLAN DRIVE  
MADISON, WISCONSIN



REVISION RECORD

Revision	Date
-	-
-	-
-	-
-	-

SCALE: 1" = 80'

DRAWN BY: MK/KD JN: #06-022



NOT FOR  
CONSTRUCTION

OVERALL  
SITE PLAN

DATE  
09/15/08

SHEET

A001



Beechwood  
Development, L.L.C.



# HILTON GARDEN INN

610 JOHN NOLEN DRIVE  
MADISON, WISCONSIN



Revision	Date
-	-

SCALE: 1" = 30'  
DRAWN BY: MK/KD JN: #06-022




NOT FOR  
CONSTRUCTION

ENLARGED  
SITE PLAN

DATE  
09/15/08

SHEET  
**A002**

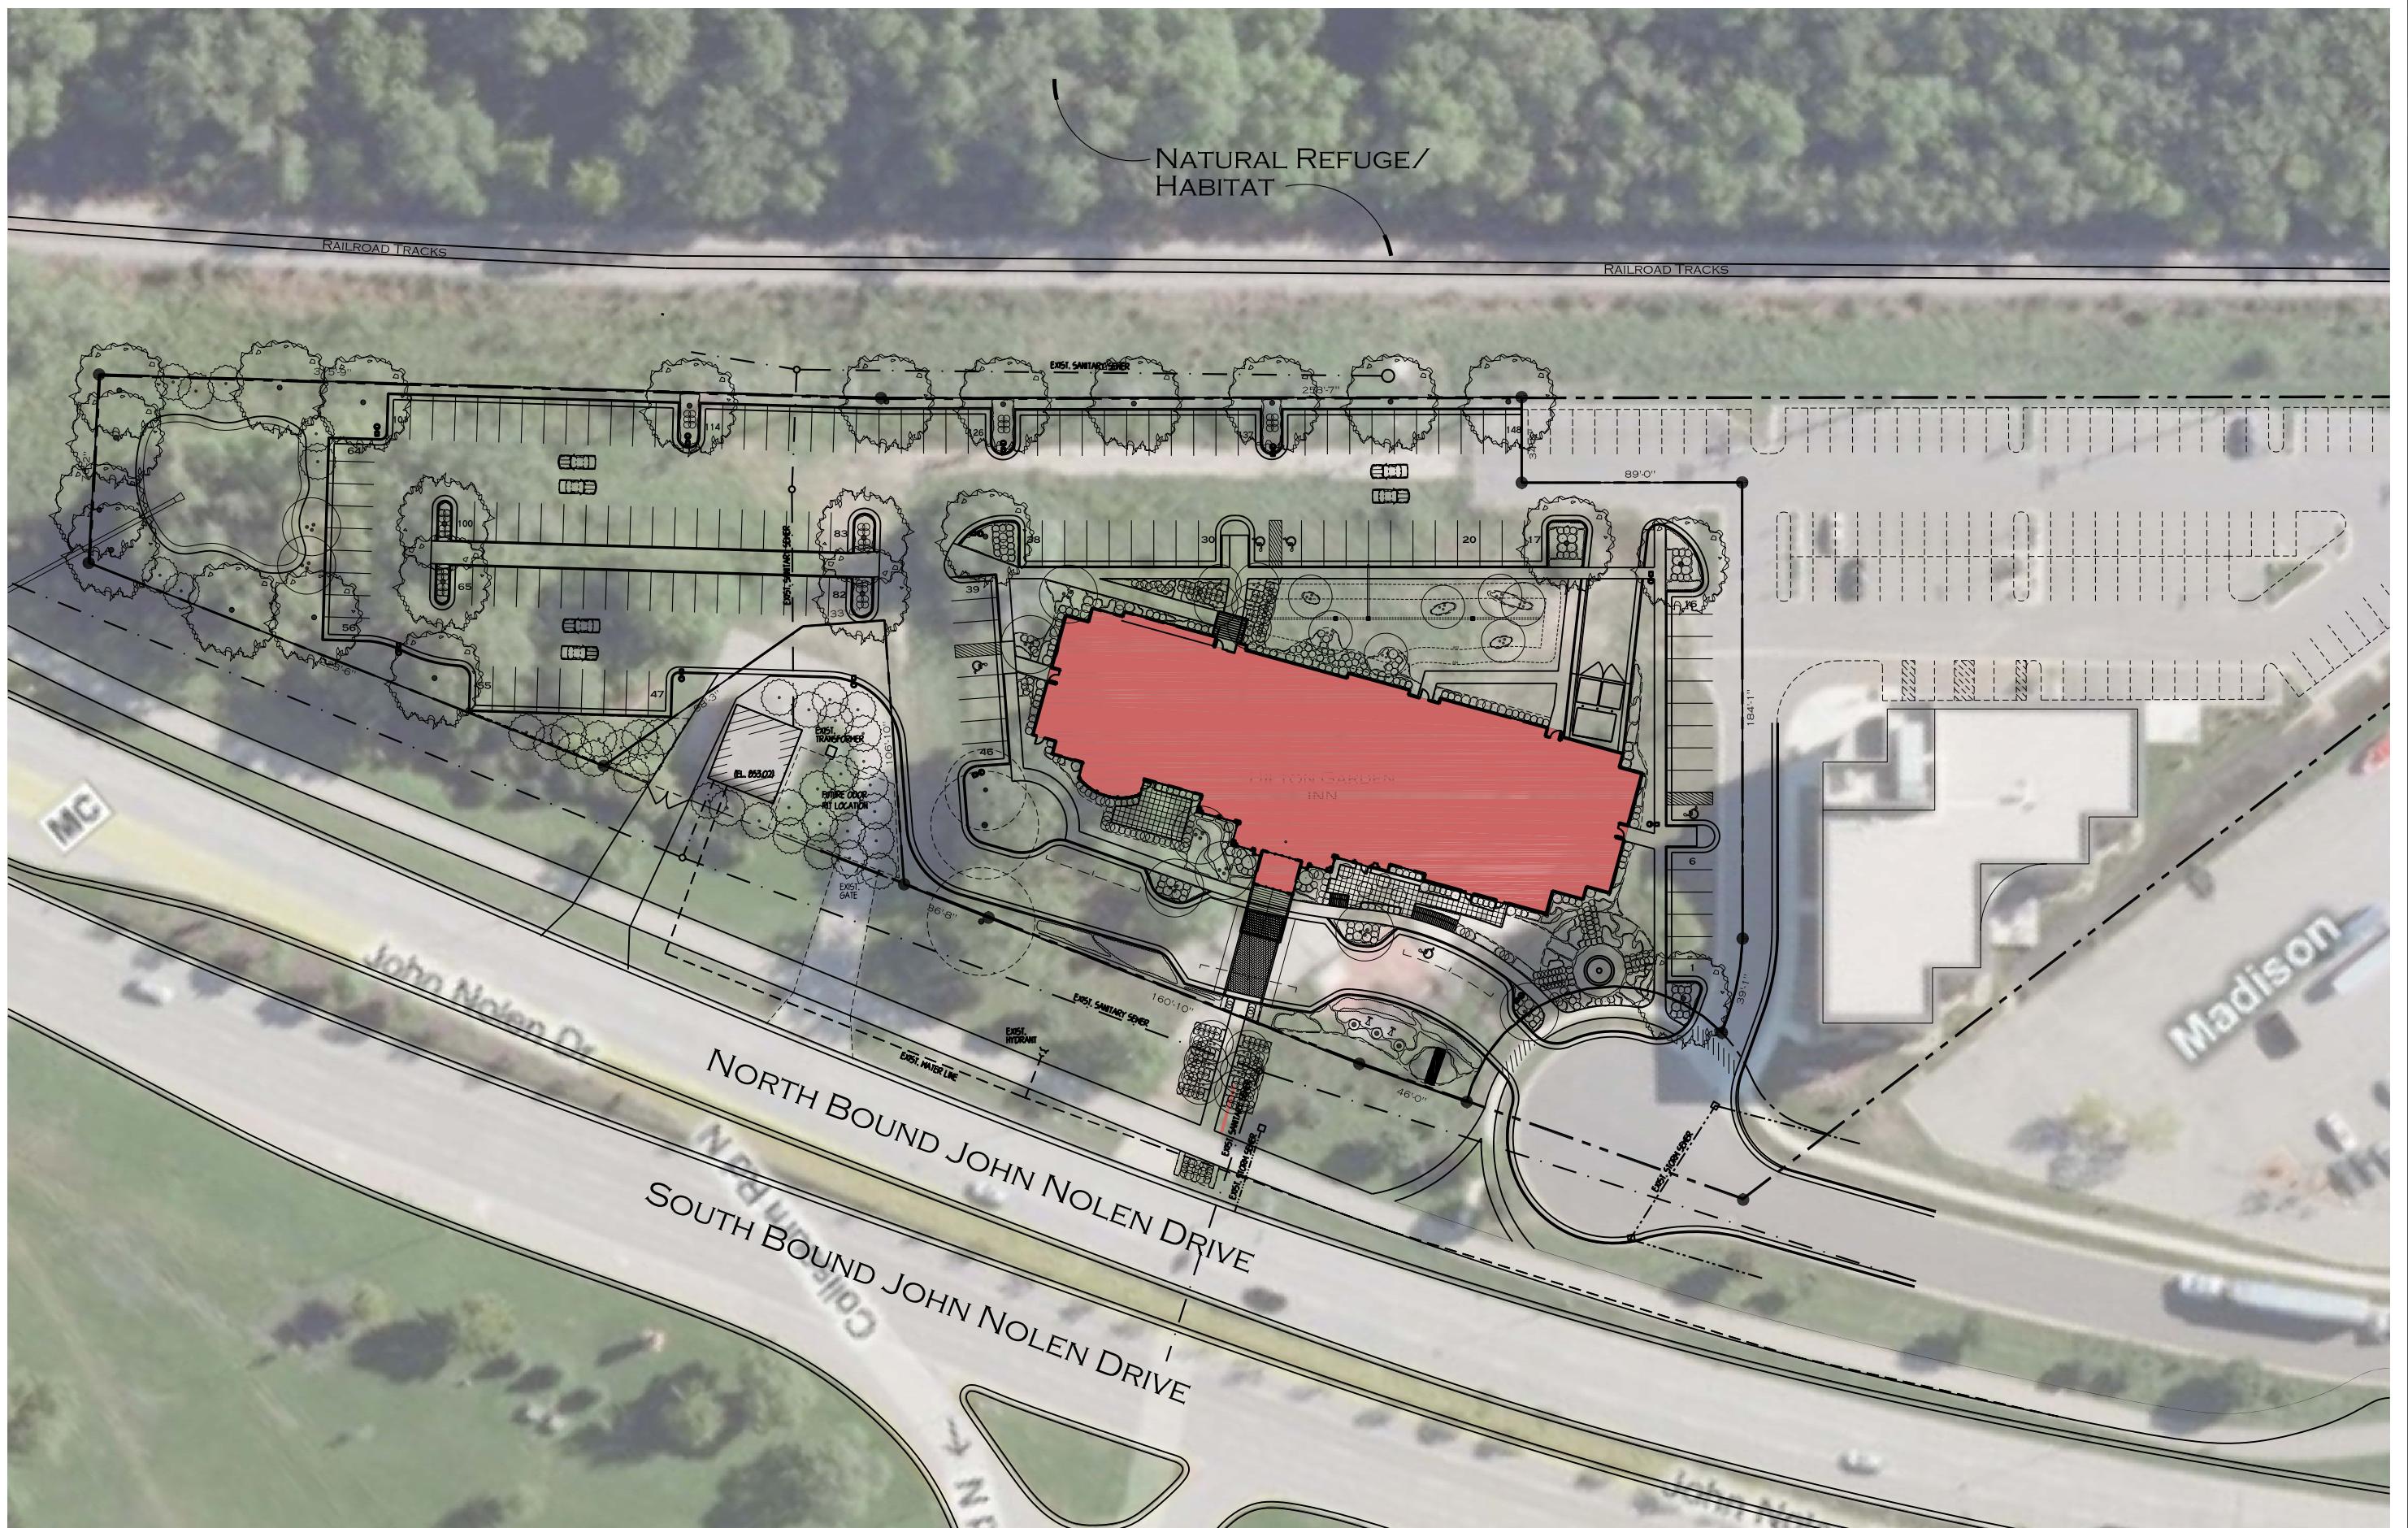

STRUCTURAL

ICON Architectural Group  
4200 James Ray Drive  
Grand Forks, North Dakota  
(701) 772 4266 Office  
(701) 772 4275 Fax

MECHANICAL

ELECTRICAL

CIVIL

# HILTON GARDEN INN

610 JOHN NOLEN DRIVE  
MADISON, WISCONSIN



REVISION RECORD

Revision \_\_\_\_\_ Date \_\_\_\_\_

SCALE: 1/8" = 1'-0"  
DRAWN BY: MK/KD JN: #06-022

NOT FOR CONSTRUCTION


FIRST FLOOR PLAN

DATE  
09/15/08

SHEET  
**A101**



Beechwood  
Development, L.L.C.

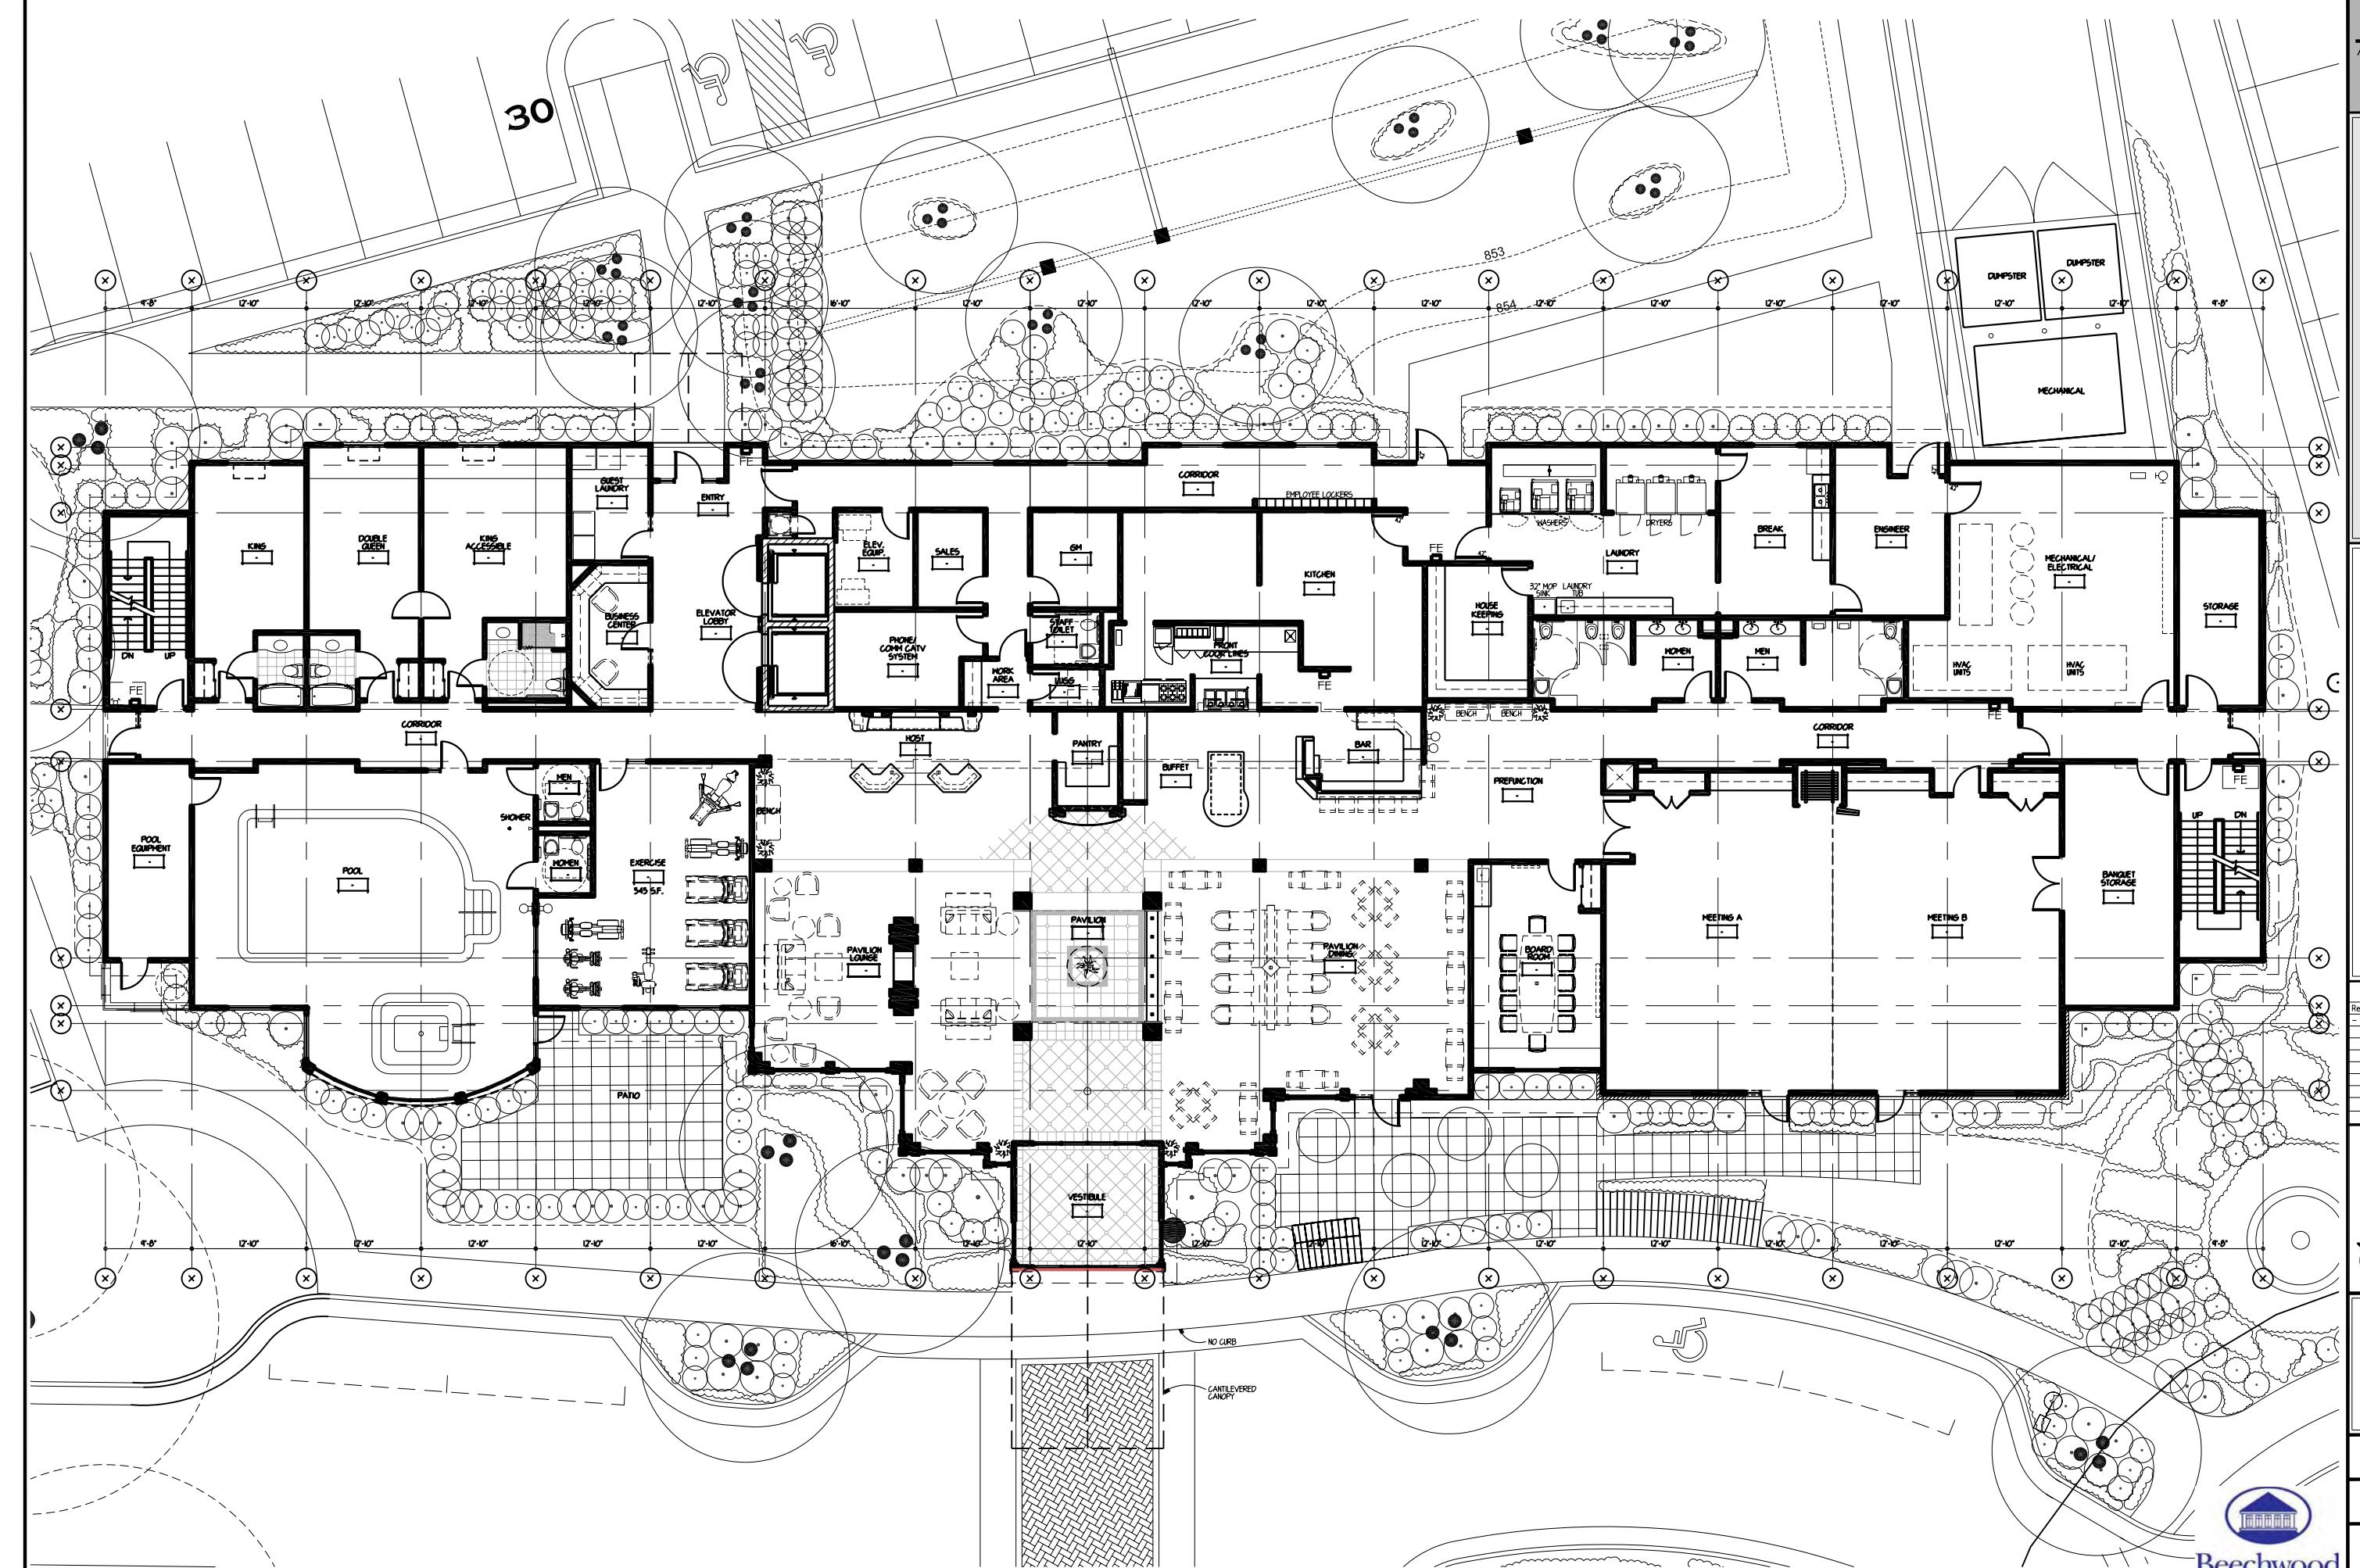

# HILTON GARDEN INN

610 JOHN NOLEN DRIVE  
MADISON, WISCONSIN



REVISION RECORD	
Revision	Date
	-


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DRAWN BY: MK/KD JN: #06-022




NOT FOR CONSTRUCTION

BUILDING ELEVATIONS  
DATE  
09/15/08

SHEET  
**A300**

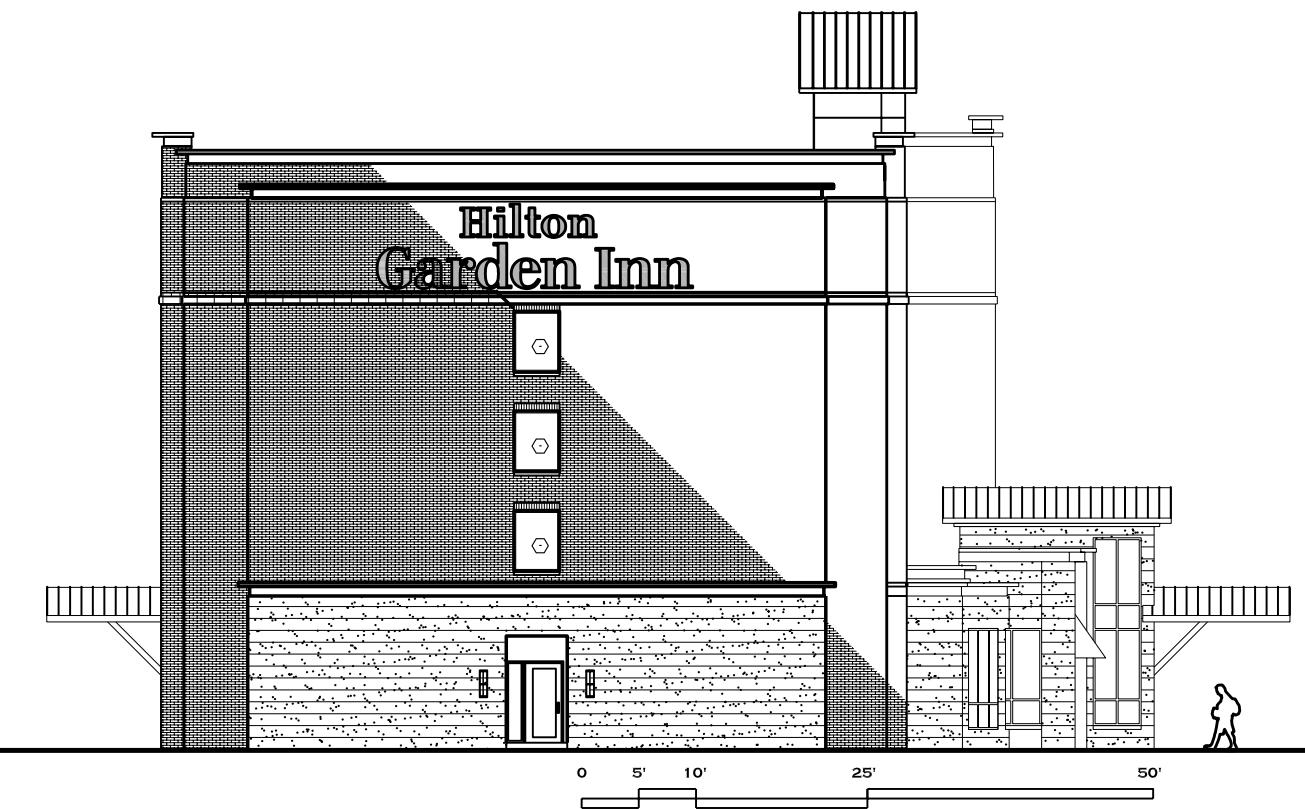

WEST BUILDING ELEVATION

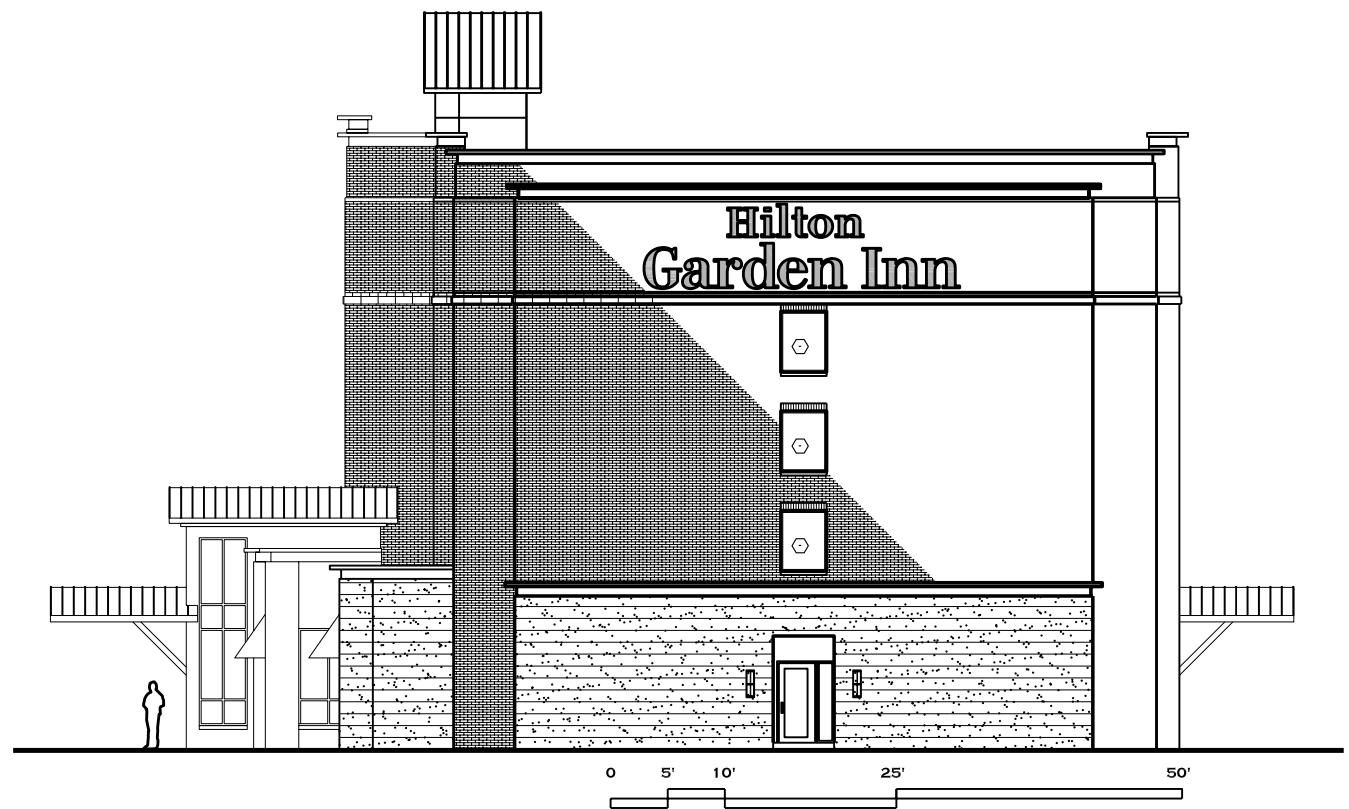

EAST BUILDING ELEVATION



SOUTH BUILDING ELEVATION



Beechwood  
Development, L.L.C.

HILTON  
GARDEN INN


610 JOHN NOLEN DRIVE  
MADISON, WISCONSIN

REVISION RECORD	
Date	
visions	9/09/08

BY : KJP

FN: IA-02-08

**NOT FOR  
CONSTRUCTION**

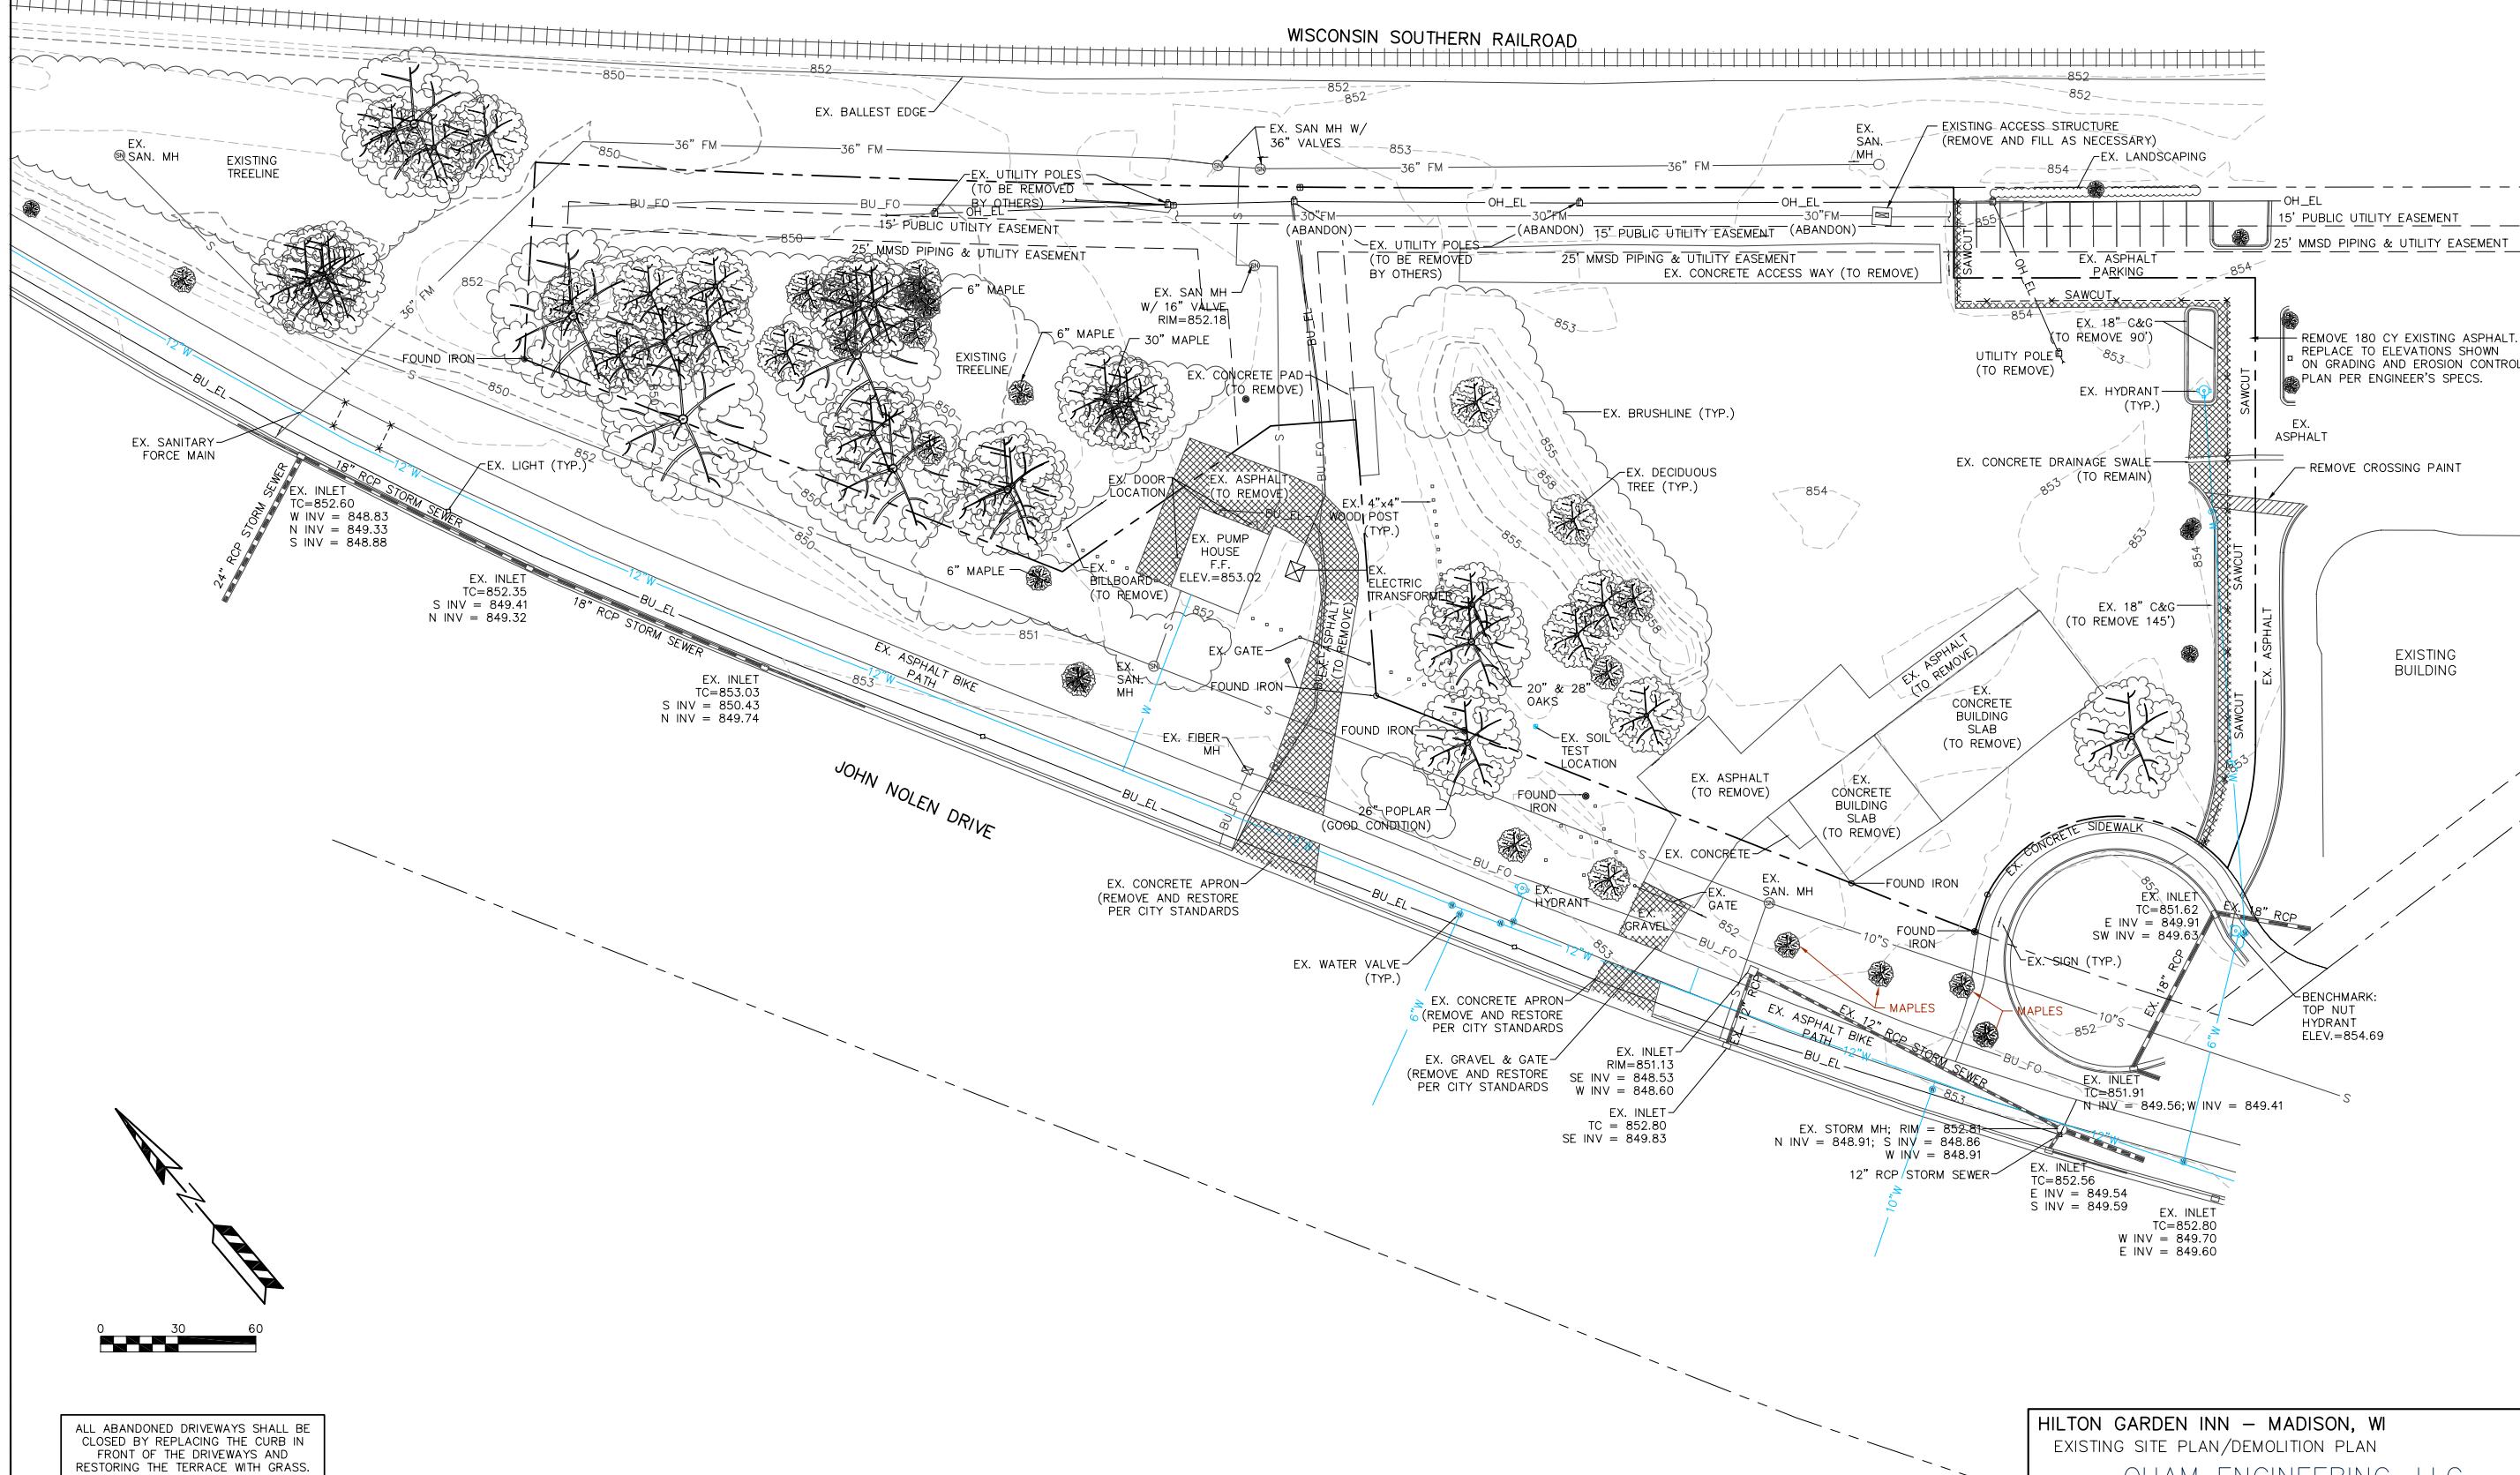

ALL ABANDONED DRIVEWAYS SHALL BE  
CLOSED BY REPLACING THE CURB IN  
FRONT OF THE DRIVEWAYS AND  
RESTORING THE TERRACE WITH GRASS.

ALL WORK IN THE PUBLIC RIGHT-OF-WAY  
SHALL BE PERFORMED BY A CITY  
LICENSED CONTRACTOR

**HILTON GARDEN INN – MADISON, WI**  
**EXISTING SITE PLAN/DEMOLITION PLAN**

QUAM ENGINEERING, LLC



4893 Larson Beach Road; McFarland, Wisconsin 53558  
Phone (608) 838-7750; Fax (608) 838-7752

DATE  
09/09/08


SHEET

C-101


DATE  
09/15/08

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SHEET  
C-102

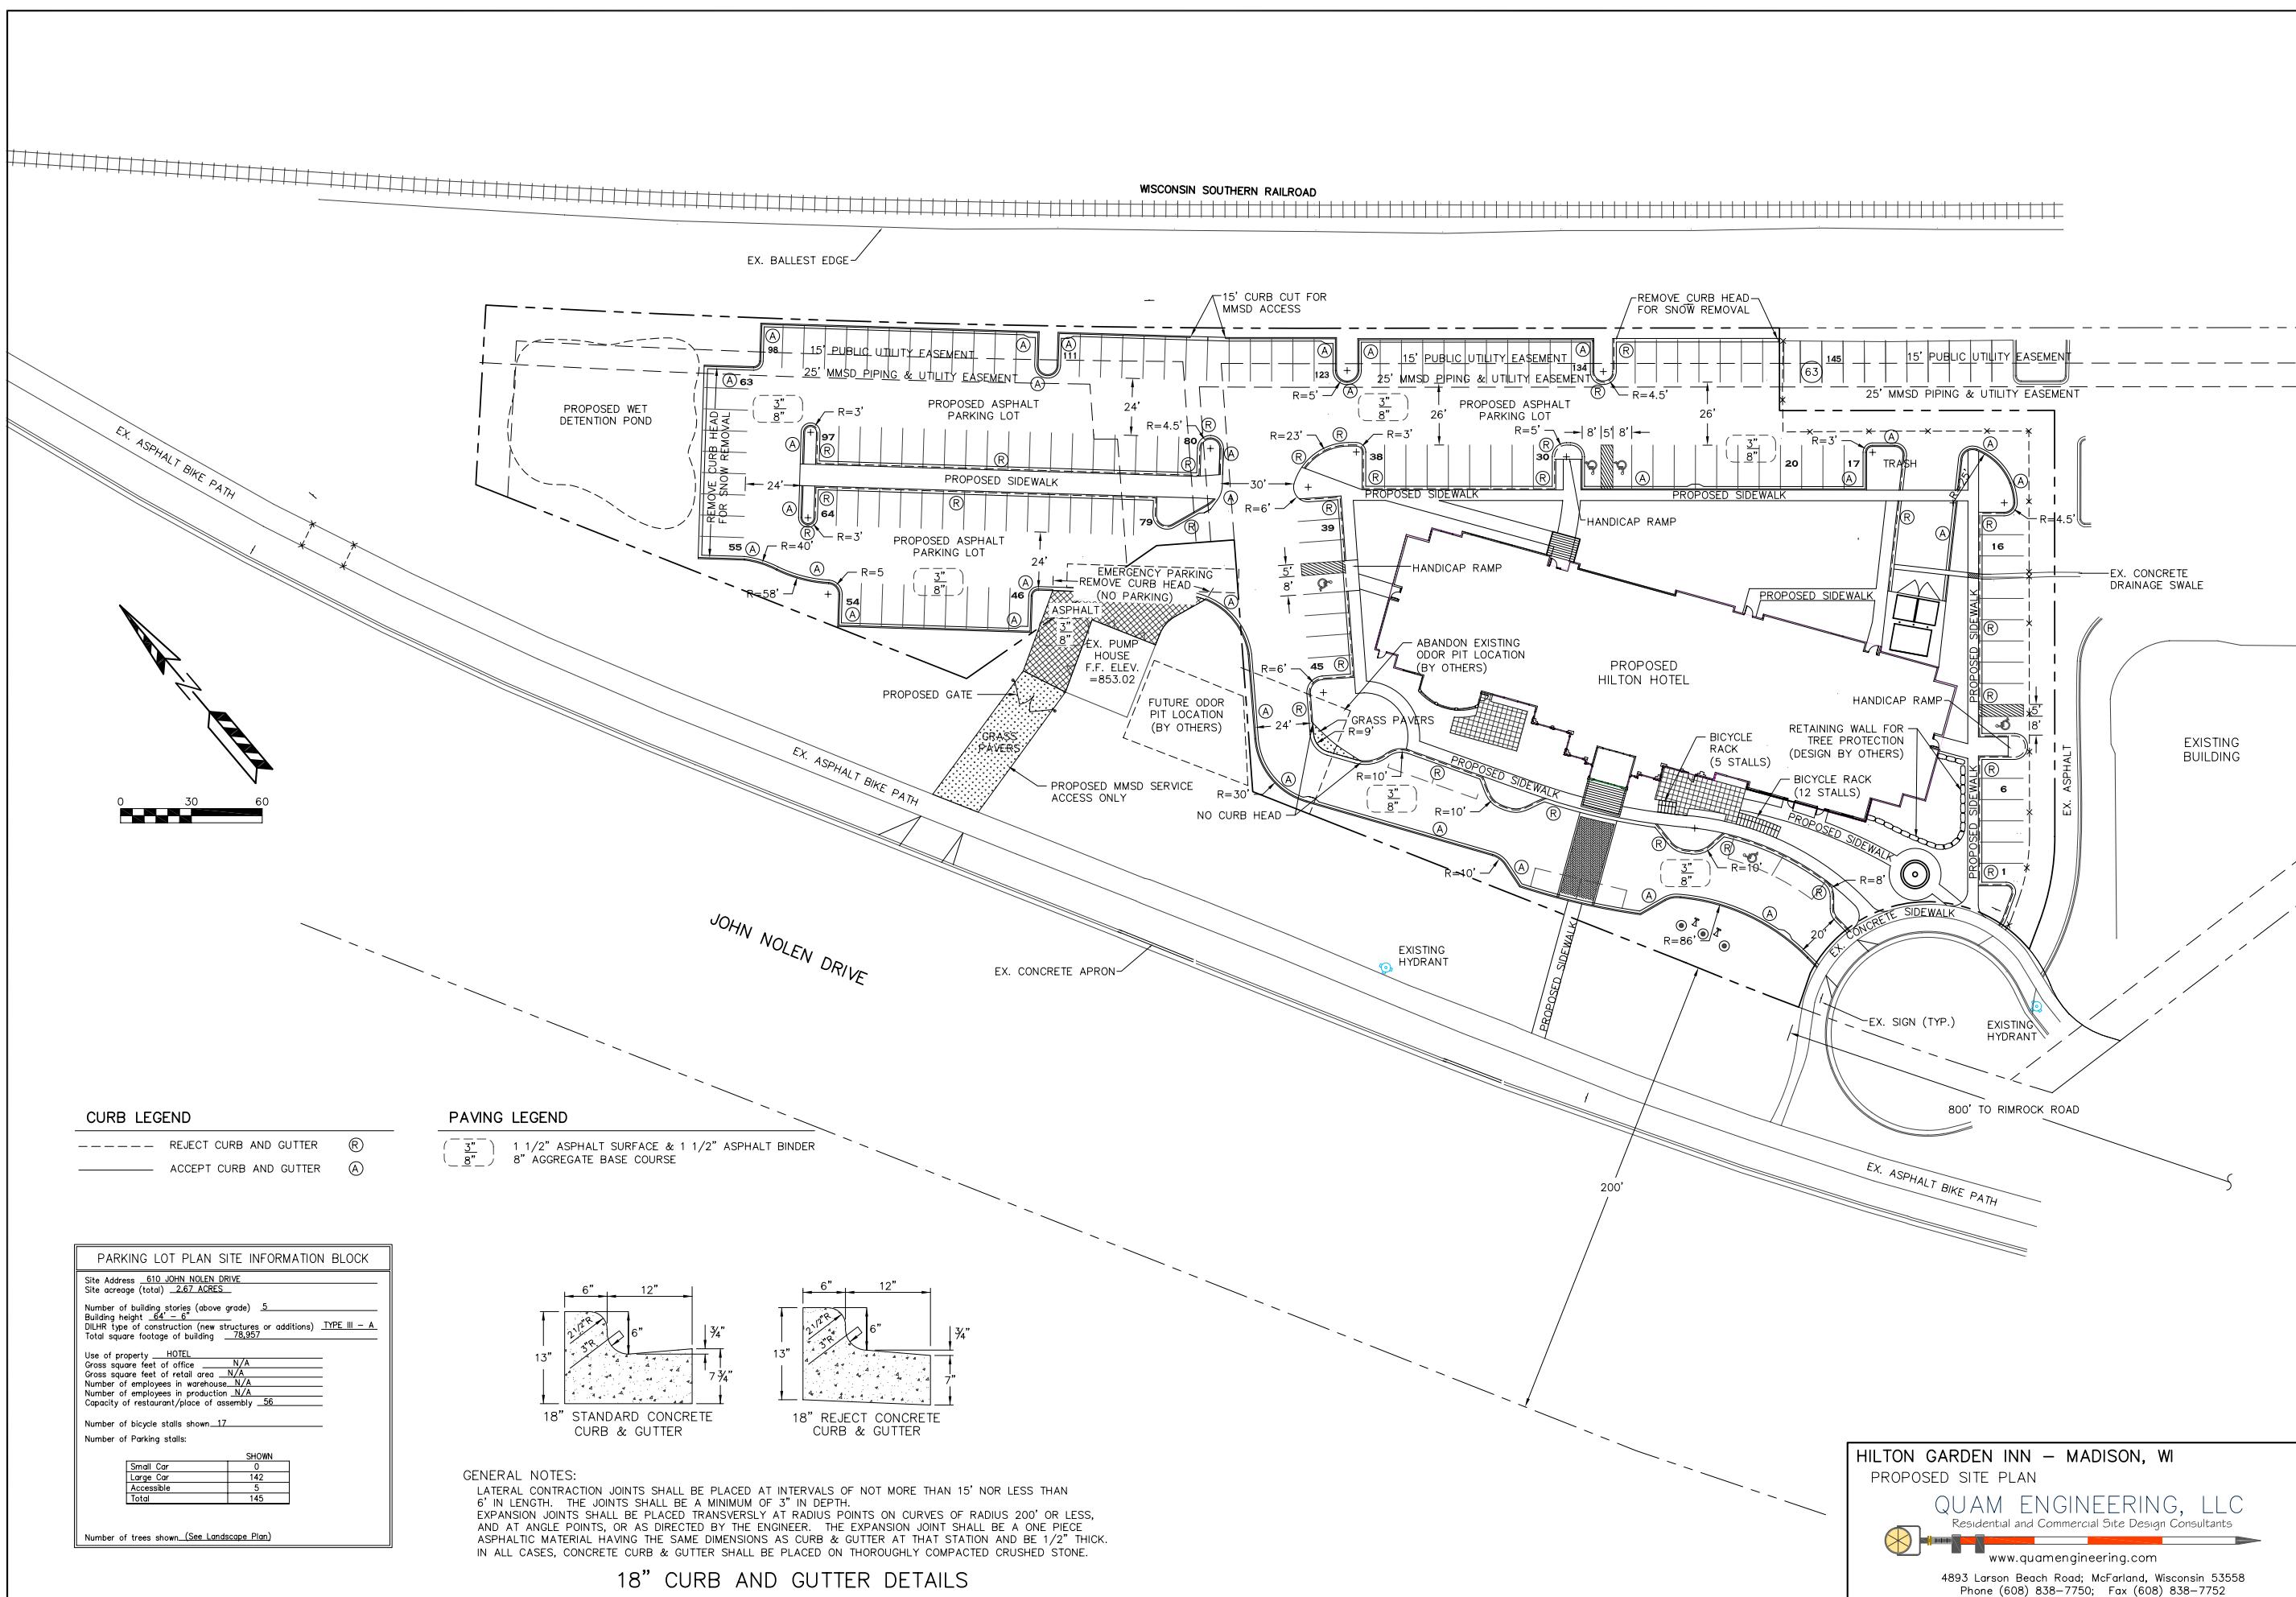

REVISION RECORD	
Revision	Date
New Site Layout	8/29/08
MMSD Revisions	9/09/08
SCALE:	
DRAWN BY: KJP	FN: IA-02-08

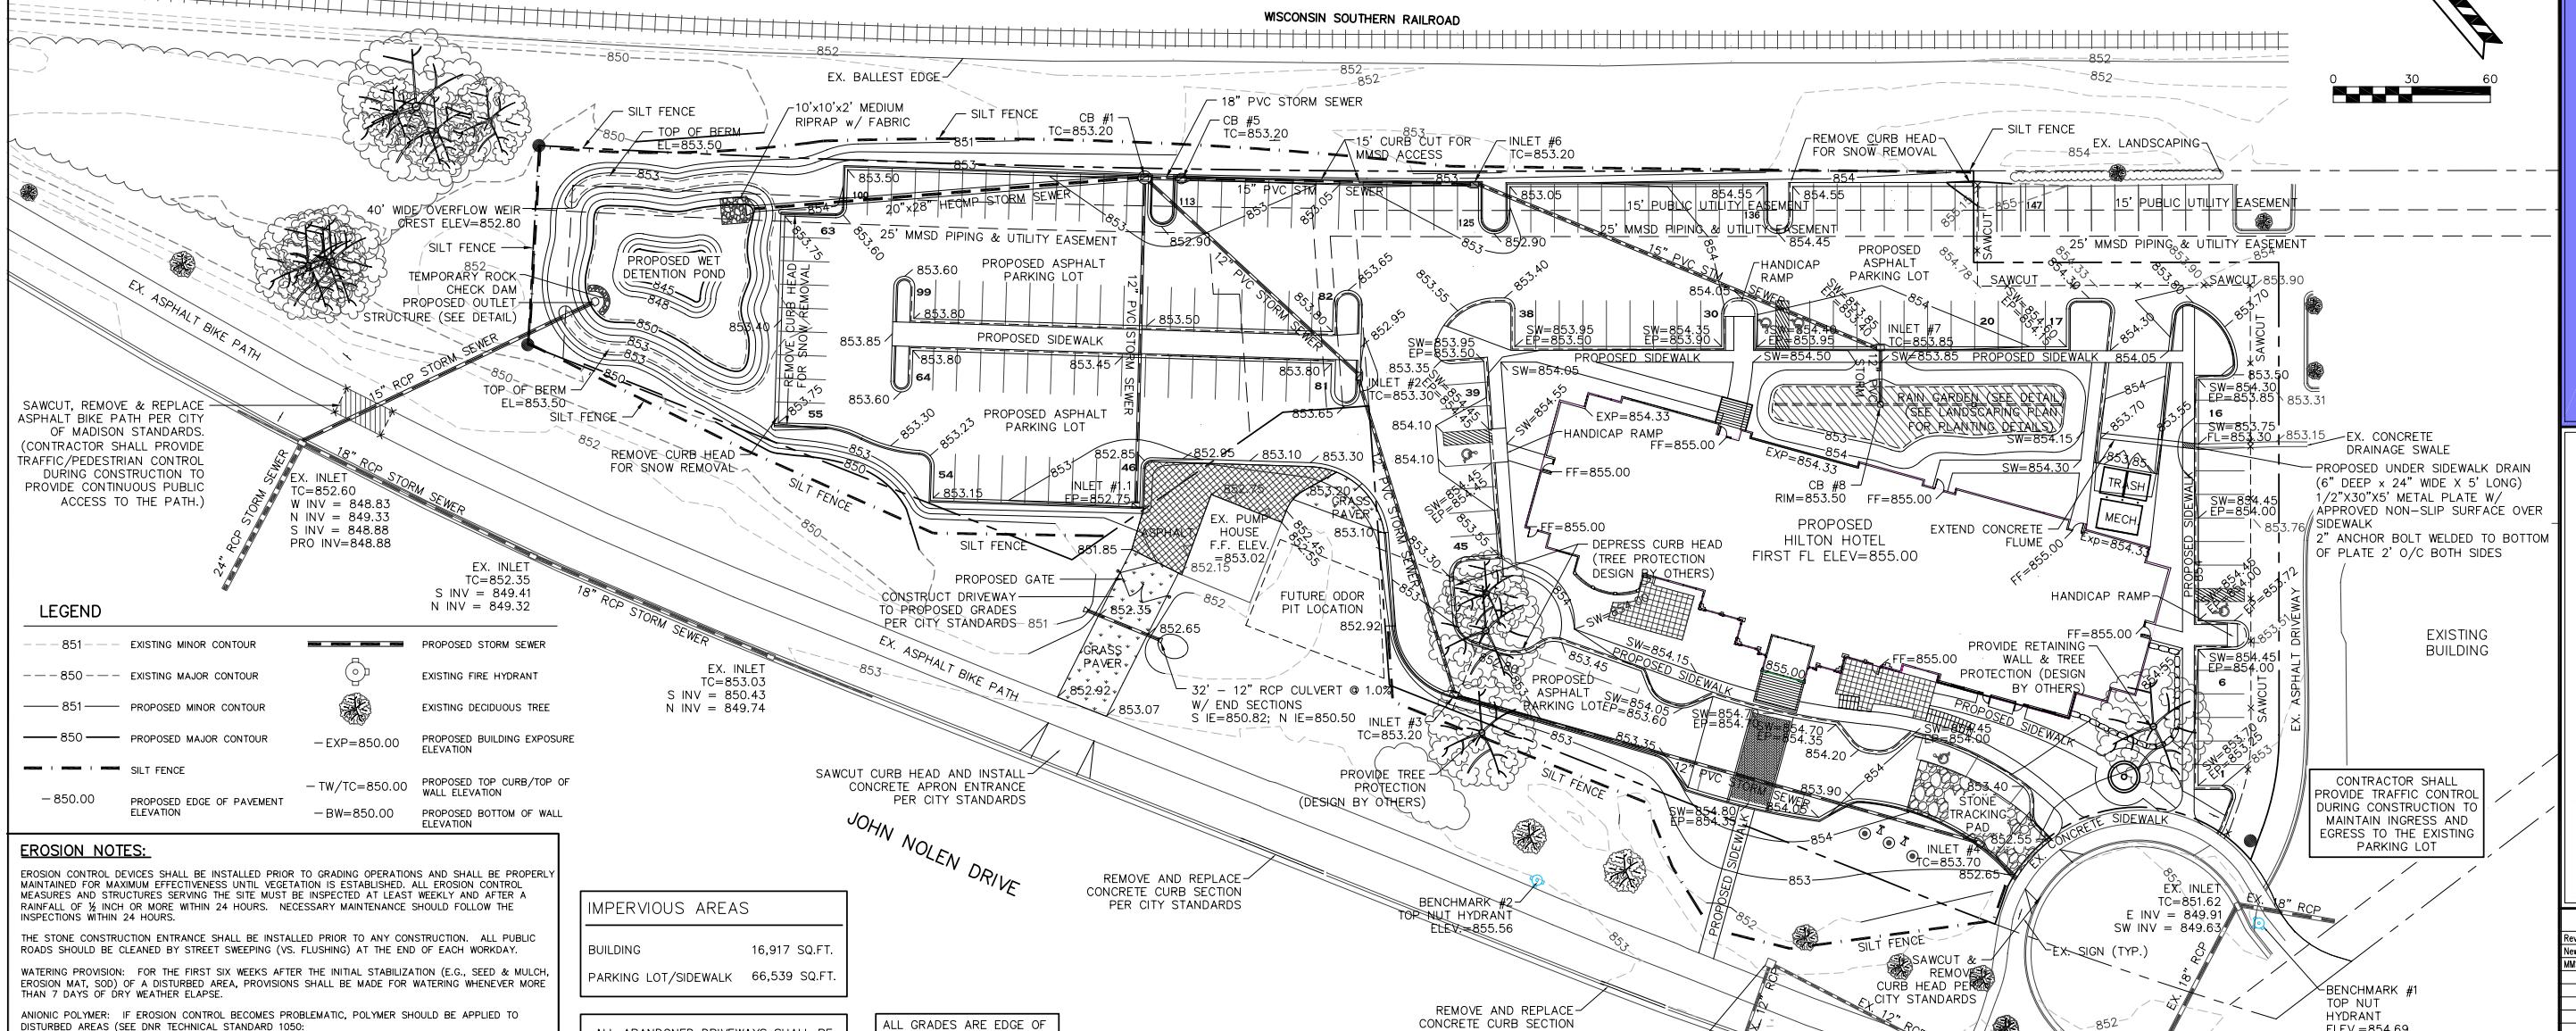

#### EROSION NOTES:

EROSION CONTROL DEVICES SHALL BE INSTALLED PRIOR TO GRADING OPERATIONS AND SHALL BE PROPERLY MAINTAINED FOR MAXIMUM EFFECTIVENESS UNTIL VEGETATION IS ESTABLISHED. ALL EROSION CONTROL MEASURES AND STRUCTURES SERVING THE SITE MUST BE INSPECTED AT LEAST WEEKLY AND AFTER A RAINFALL OF  $\frac{1}{2}$  INCH OR MORE WITHIN 24 HOURS. NECESSARY MAINTENANCE SHOULD FOLLOW THE INSPECTIONS WITHIN 24 HOURS.

THE STONE CONSTRUCTION ENTRANCE SHALL BE INSTALLED PRIOR TO ANY CONSTRUCTION. ALL PUBLIC ROADS SHOULD BE CLEANED BY STREET SWEEPING (VS. FLUSHING) AT THE END OF EACH WORKDAY.

WATERING PROVISION: FOR THE FIRST SIX WEEKS AFTER THE INITIAL STABILIZATION (E.G., SEED & MULCH, EROSION MAT, SOD) OF A DISTURBED AREA, PROVISIONS SHALL BE MADE FOR WATERING WHENEVER MORE THAN 7 DAYS OF DRY WEATHER ELAPSE.

ANIONIC POLYMER: IF EROSION CONTROL BECOMES PROBLEMATIC, POLYMER SHOULD BE APPLIED TO DISTURBED AREAS (SEE DNR TECHNICAL STANDARD 1050: [HTTP://DNR.WI.GOV/WATER/WM/NPS/PDF/STORMWATER/TECHSTD/EROSION/DNR1050-POLYACRYLIC.PDF](http://DNR.WI.GOV/WATER/WM/NPS/PDF/STORMWATER/TECHSTD/EROSION/DNR1050-POLYACRYLIC.PDF))

SOIL STOCKPILES: A ROW OF SILT FENCE PLACED DOWNSLOPE AND AT LEAST 10 FEET AWAY FROM THE STOCKPILE SHALL PROTECT ALL STOCKPILES. SOIL STOCKPILES THAT ARE INACTIVE FOR MORE THAN 14 CONSECUTIVE DAYS SHALL BE STABILIZED WITH SEED & MULCH, EROSION MAT, POLYMER, OR COVERED WITH TARPS OR SIMILAR MATERIAL. NO STOCKPILE SHALL BE PLACED WITHIN 20 FEET OF A DRAINAGE WAY.

SILT FENCE AND STOCKPILES SHALL BE FIELD LOCATED BY THE ENGINEER.

CUT AND FILL SLOPES SHALL BE NO GREATER THAN 2:1. ALL SLOPES 3:1 OR GREATER SHALL BE STABILIZED BY CLASS I, TYPE A EROSION MATTING.

ADDITIONAL EROSION CONTROL MEASURES WILL BE INSTALLED AS NEEDED.

#### TIME SCHEDULE:

OCTOBER 2 – 16, 2008 INSTALL INITIAL EROSION CONTROL DEVICES AND DETENTION POND WITH OUTLET STRUCTURE AND RESTORE POND SIDE SLOPES.

OCTOBER 16, 2008 – SEPT. 7, 2009 CONSTRUCT BUILDING, UTILITIES AND PARKING LOT.

SEPTEMBER 8 – 15, 2009 RESTORE ALL PERVIOUS DISTURBED AREAS AND FINAL LANDSCAPING.

#### RESTORATION NOTES:

ALL DISTURBED AREAS SHALL RECEIVE A MINIMUM OF FOUR (4) INCHES OF TOPSOIL. FERTILIZER, SEED AND MULCH RESTORATION WILL OCCUR AS SOON AFTER THE DISTURBANCE AS PRACTICAL. SEED MIXTURE #40 SHALL BE USED AND MIXTURES SHALL BE IN ACCORDANCE WITH SECTION 630 OF D.O.T. SPECIFICATIONS. AN EQUAL AMOUNT OF ANNUAL RYEGRASS SHALL BE ADDED TO THE MIX.

SEED MIXTURES FOR LAWN AREAS SHALL BE APPLIED AT THE RATE OF FOUR (4) POUNDS PER 1,000 SQUARE FEET. FERTILIZER SHALL BE APPLIED AT THE RATE OF FOUR (4) POUNDS PER 1,000 SQUARE FEET. FERTILIZER FOR LAWN AREAS SHALL MEET THE MINIMUM REQUIREMENTS THAT FOLLOW: NITROGEN, NOT LESS THAN 16%; PHOSPHORIC ACID, NOT LESS THAN 8%; POTASH, NOT LESS THAN 8%.



THE CONTRACTOR SHALL BE RESPONSIBLE FOR A SATISFACTORY STAND OF GRASS ON ALL SEADED AREAS FOR ONE YEAR AFTER THE PROJECT'S FINAL ACCEPTANCE.

#### OWNER:

DEPPERWOOD DEVELOPMENT, LLC  
ATTN: THOMAS ARNOT  
1025 THOROUGHBRED LANE  
DEPERE, WI 54115  
QUAM ENGINEERING, LLC  
ATTN: KEVIN PARISH  
4893 LARSON BEACH ROAD  
MCFARLAND, WI 53558

#### ENGINEER:

QUAM ENGINEERING, LLC  
ATTN: KEVIN PARISH  
4893 LARSON BEACH ROAD  
MCFARLAND, WI 53558

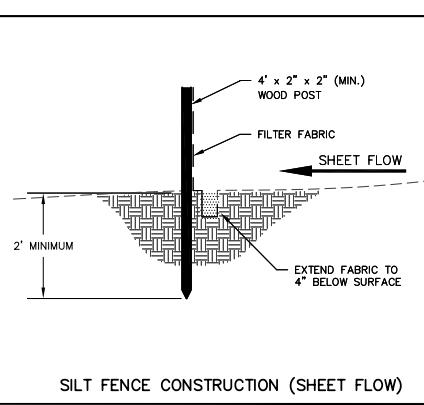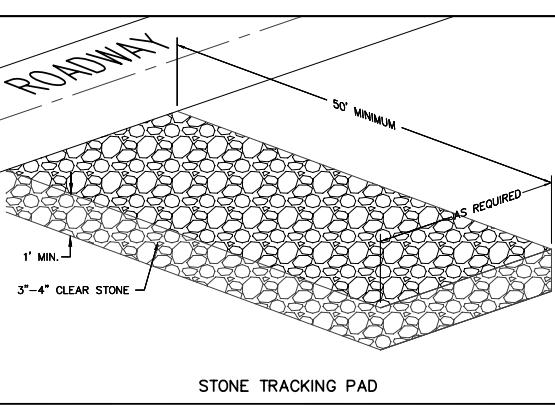

**HILTON GARDEN INN – MADISON, WI**  
GRADING AND EROSION CONTROL PLAN  
**QUAM ENGINEERING, LLC**  
Residential and Commercial Site Design Consultants  
www.quamengineering.com  
4893 Larson Beach Road; McFarland, Wisconsin 53558  
Phone (608) 838-7750; Fax (608) 838-7752


NOT FOR CONSTRUCTION

DATE  
09/09/08  
SHEET  
C-103

REVISION RECORD	
Revision	Date
New Site Layout	8/29/08
MMSD Revisions	9/09/08

SCALE:  
DRAWN BY: KJP FN: IA-02-08

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#### UTILITY LEGEND

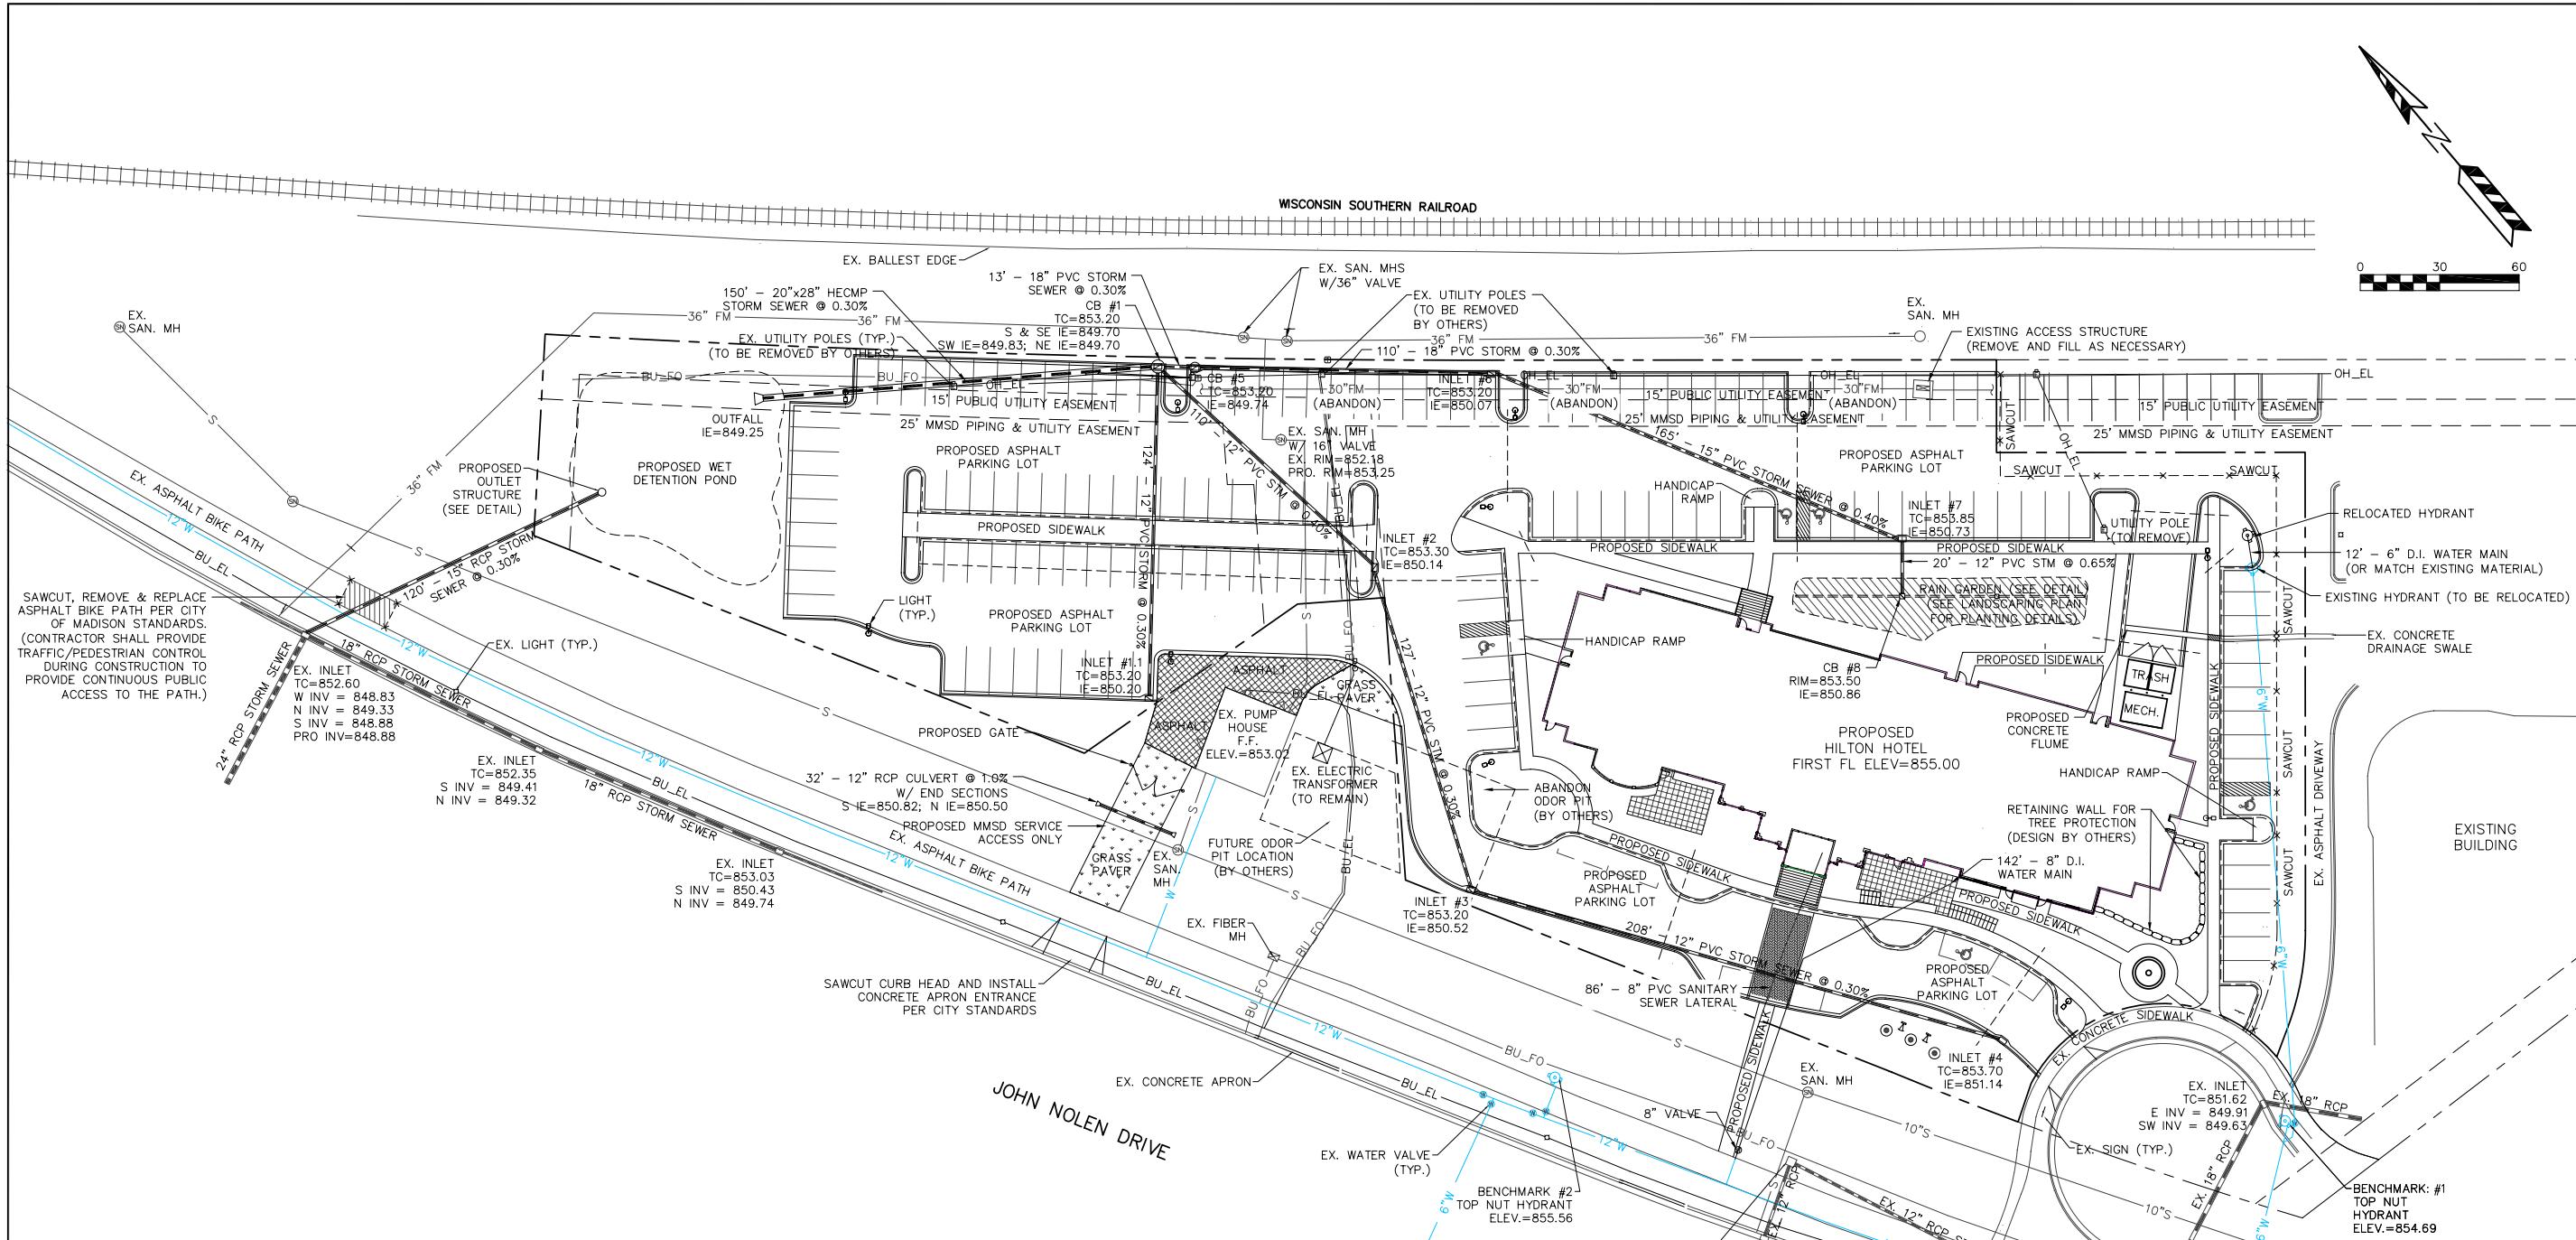- PROPOSED SANITARY SEWER
- PROPOSED WATER MAIN
- PROPOSED STORM SEWER
- PROPOSED WATER HYDRANT
- PROPOSED WATER VALVE
- PROPOSED STORM CATCH BASIN
- PROPOSED STORM INLET
- PROPOSED IRRIGATION CONDUIT SLEEVE

#### GENERAL NOTES:

ALL WORK IN THE PUBLIC RIGHT-OF-WAY SHALL BE PERFORMED BY A CITY LICENSED CONTRACTOR.

THE APPLICANT SHALL OBTAIN A STREET EXCAVATION PERMIT FOR THE INSTALLATION OF UTILITIES REQUIRED TO SERVE THIS PROJECT. THE APPLICANT SHALL PAY THE PERMIT FEE, INSPECTION FEE AND STREET DEGRADATION FEE AS APPLICABLE AND SHALL COMPLY WITH ALL THE CONDITIONS OF THE PERMIT.

THE APPLICANT SHALL OBTAIN ALL NECESSARY SEWER CONNECTION PERMITS AND SEWER PLUGGING PERMITS PRIOR TO ANY UTILITY WORK.

PRIOR TO APPROVAL OF THE CONDITIONAL USE APPLICATION, THE OWNER SHALL OBTAIN A PERMIT TO PLUG EACH EXISTING SANITARY SEWER LATERAL THAT SERVES A BUILDING THAT IS PROPOSED FOR DEMOLITION. FOR EACH LATERAL TO BE PLUGGED THE OWNER SHALL DEPOSIT \$1,000 WITH THE CITY ENGINEER IN TWO SEPARATE CHECKS IN THE FOLLOWING AMOUNTS: (1) \$100 NON-REFUNDABLE DEPOSIT FOR THE COST OF INSPECTION OF THE PLUGGING BY CITY STAFF; AND (2) \$900 FOR THE COST OF CITY CREWS TO PERFORM THE PLUGGING. IF THE OWNER ELECTS TO COMPLETE THE PLUGGING OF A LATERAL BY PRIVATE CONTRACTOR AND THE PLUGGING IS INSPECTED AND APPROVED BY THE CITY ENGINEER, THE \$900 FEE SHALL BE REFUNDED TO THE OWNER.


STORM STRUCTURE INFORMATION						
#	DESC.	NEENAH CASTING	SIZE (FT.)	TC/RIM (FT.)	INVERT (FT.)	DEPTH (FT.)
1	CB	R-3067	5' Dia.	853.20	849.70	3.50
1.1	Inlet	R-3067	2' x 3'	853.20	850.20	3.00
2	Inlet	R-3067	2' x 3'	853.30	850.14	3.16
3	Inlet	R-3067	2' x 3'	853.20	850.52	2.68
4	Inlet	R-3067	2' x 3'	853.70	851.14	2.56
5	CB	R-3067	4' Dia.	853.20	849.74	3.46
6	Inlet	R-3067	2' x 3'	853.20	850.07	3.13
7	Inlet	R-3067	2' x 3'	853.85	850.73	3.17
8	CB	Open Grate	2' x 2'	853.50	850.86	2.64



**HILTON GARDEN INN - MADISON, WI**  
UTILITY PLAN  
**QUAM ENGINEERING, LLC**  
Residential and Commercial Site Design Consultants  
4893 Larson Beach Road; McFarland, Wisconsin 53558  
Phone (608) 838-7750; Fax (608) 838-7752

DATE  
09/09/08

SHEET  
C-104

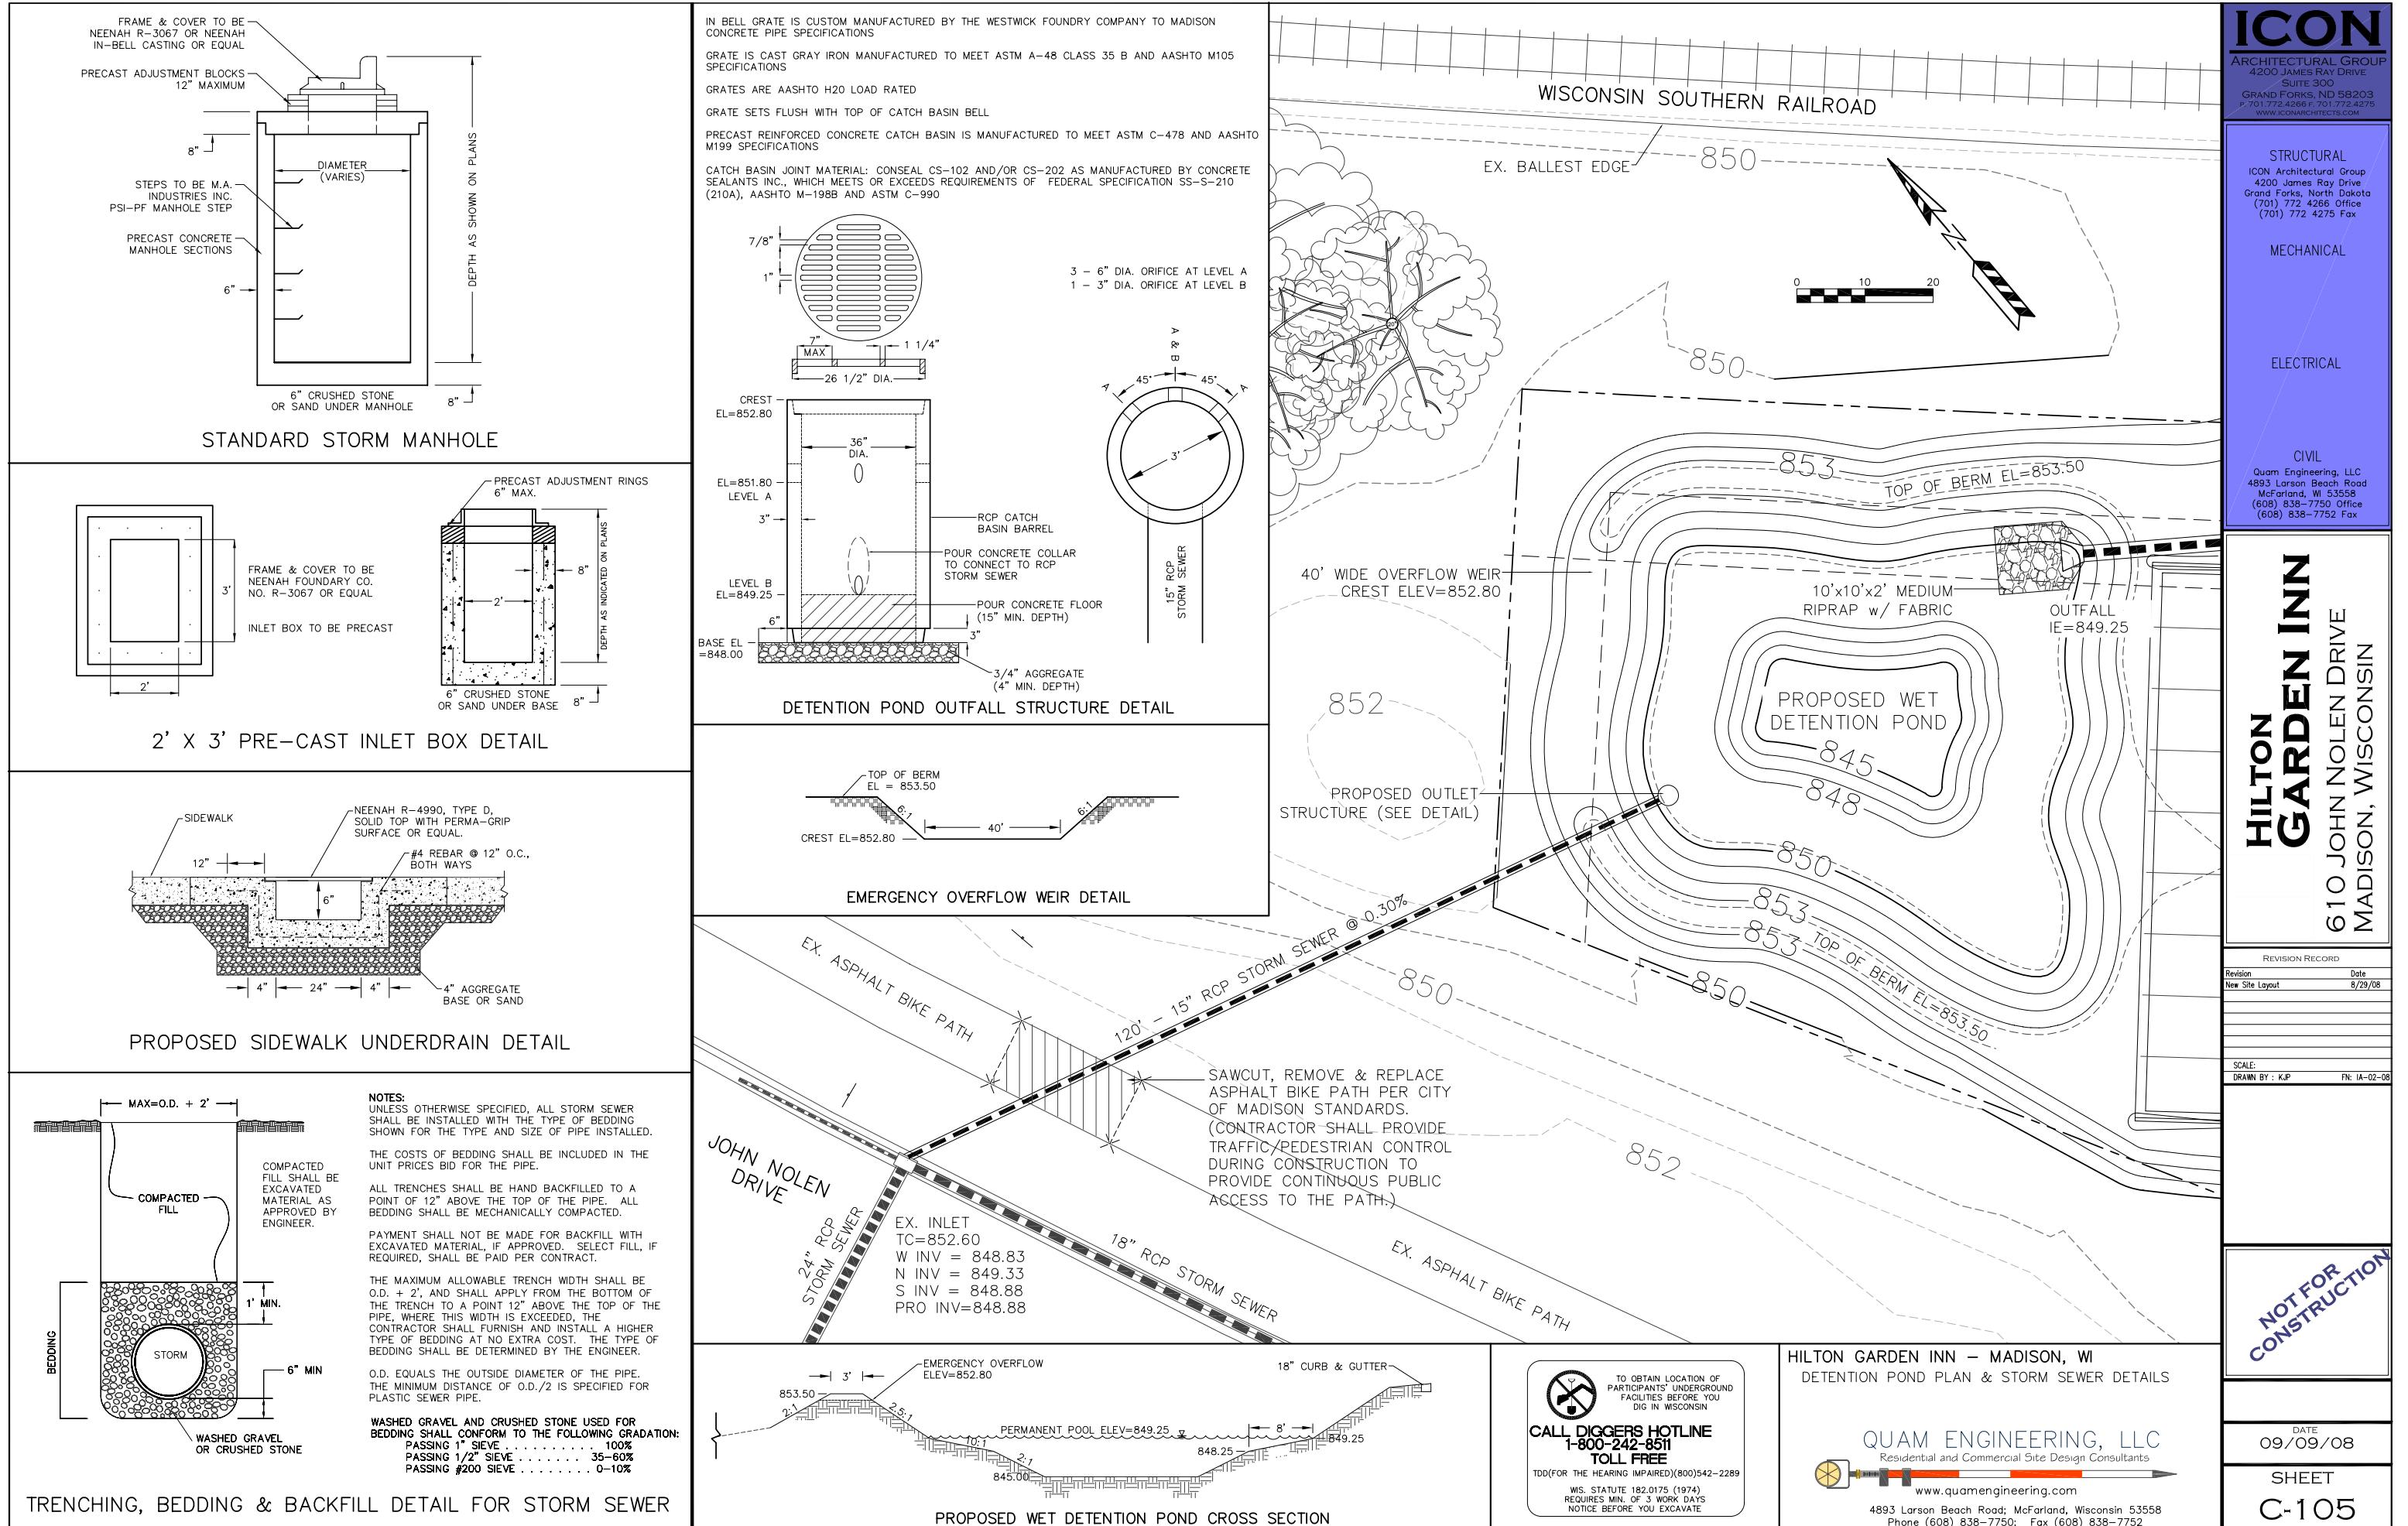

WISCONSIN SOUTHERN RAILROAD  
RIGHT-OF-WAY

**ICON**

ARCHITECTURAL GROUP  
4200 JAMES RAY DRIVE  
SUITE 300  
GRAND FORKS, ND 58203  
P. 701.772.4266 F. 701.772.4275  
WWW.ICONARCHITECTS.COM

STRUCTURAL  
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4200 James Ray Drive  
Grand Forks, North Dakota  
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(701) 772 4275 Fax

MECHANICAL

ELECTRICAL

CIVIL

Quam Engineering, LLC  
4893 Larson Beach Road  
McFarland, WI 53558  
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(608) 838-7752 Fax

**HILTON GARDEN INN**  
610 JOHN NOLEN DRIVE  
MADISON, WISCONSIN

REVISION RECORD

Revision	Date
New Site Layout	8/29/08
New MMSD Access	9/15/08

SCALE:  
DRAWN BY: KJP FN: IA-02-08

NOT FOR CONSTRUCTION

DRIVING PATH SHOWN IS FOR  
A WHEEL BASE 62 SEMI  
TRUCK IN CONFORMANCE WITH  
AASHTO 2004 (US)  
STANDARD VEHICLE LIBRARY.

HILTON GARDEN INN - MADISON, WI  
TURNING MOVEMENT ANALYSIS PLAN

QUAM ENGINEERING, LLC

Residential and Commercial Site Design Consultants


 www.quamengineering.com


4893 Larson Beach Road; McFarland, Wisconsin 53558  
Phone (608) 838-7750; Fax (608) 838-7752

DATE  
09/15/08

SHEET


C-106

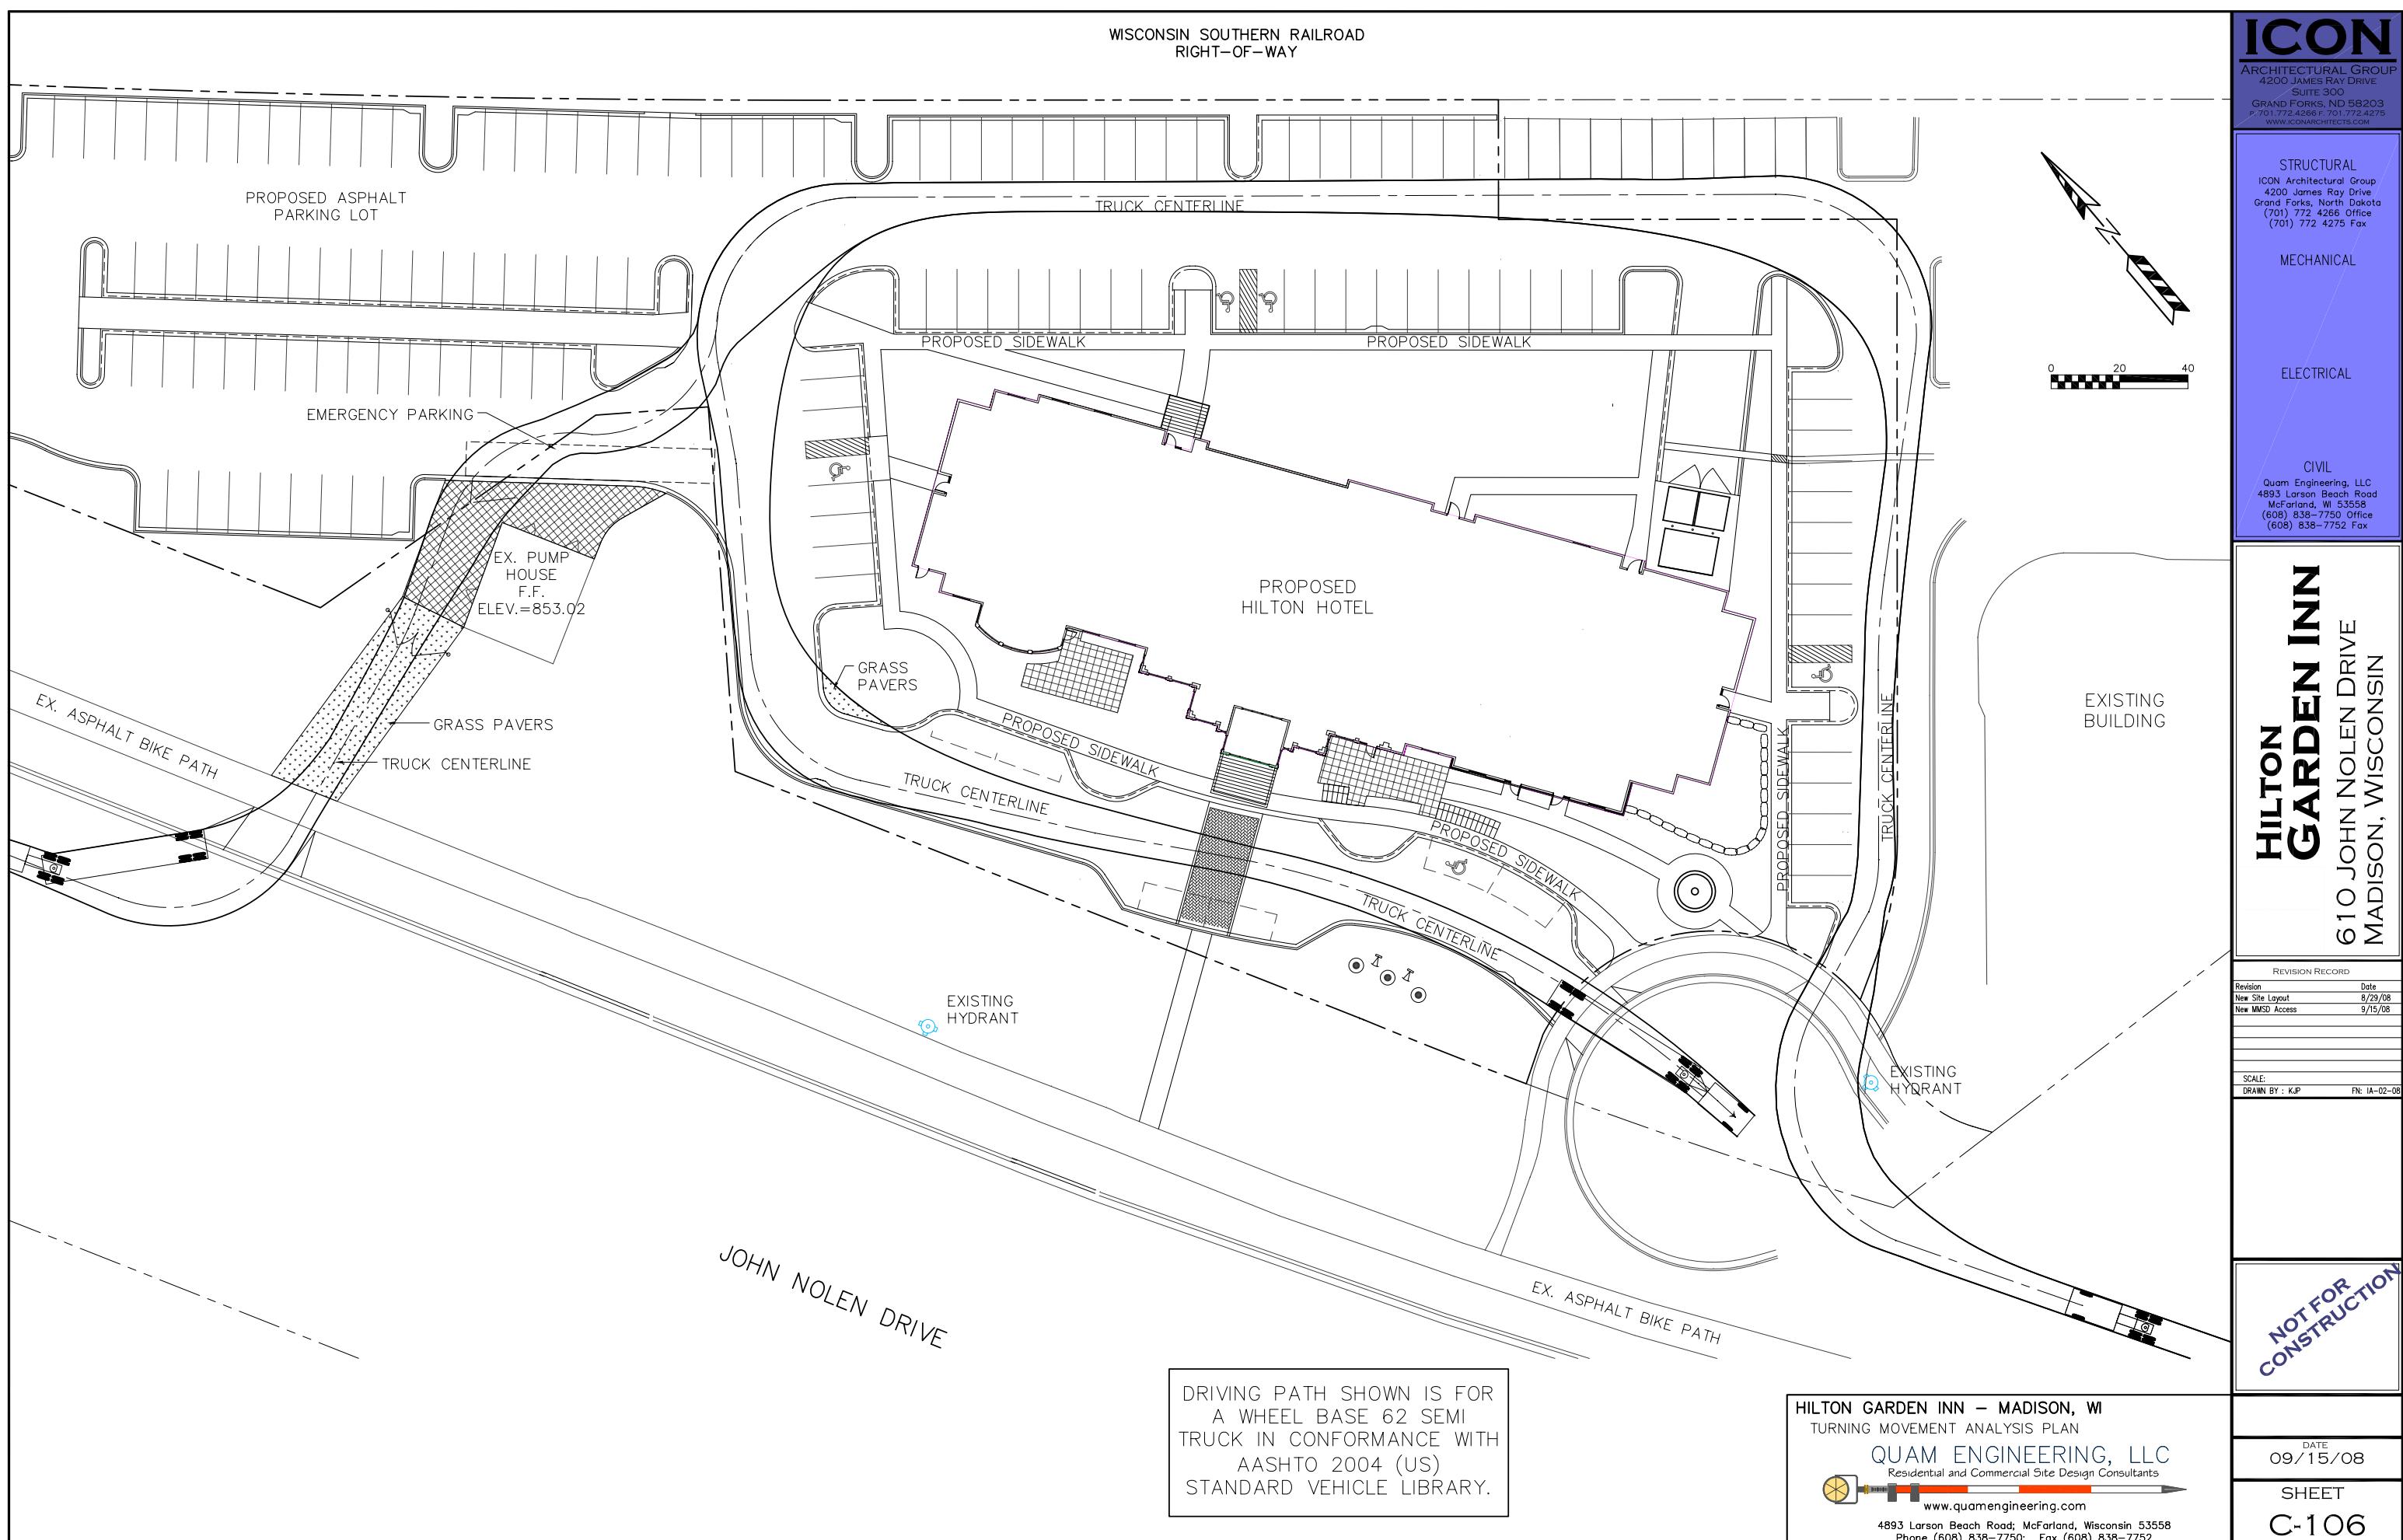

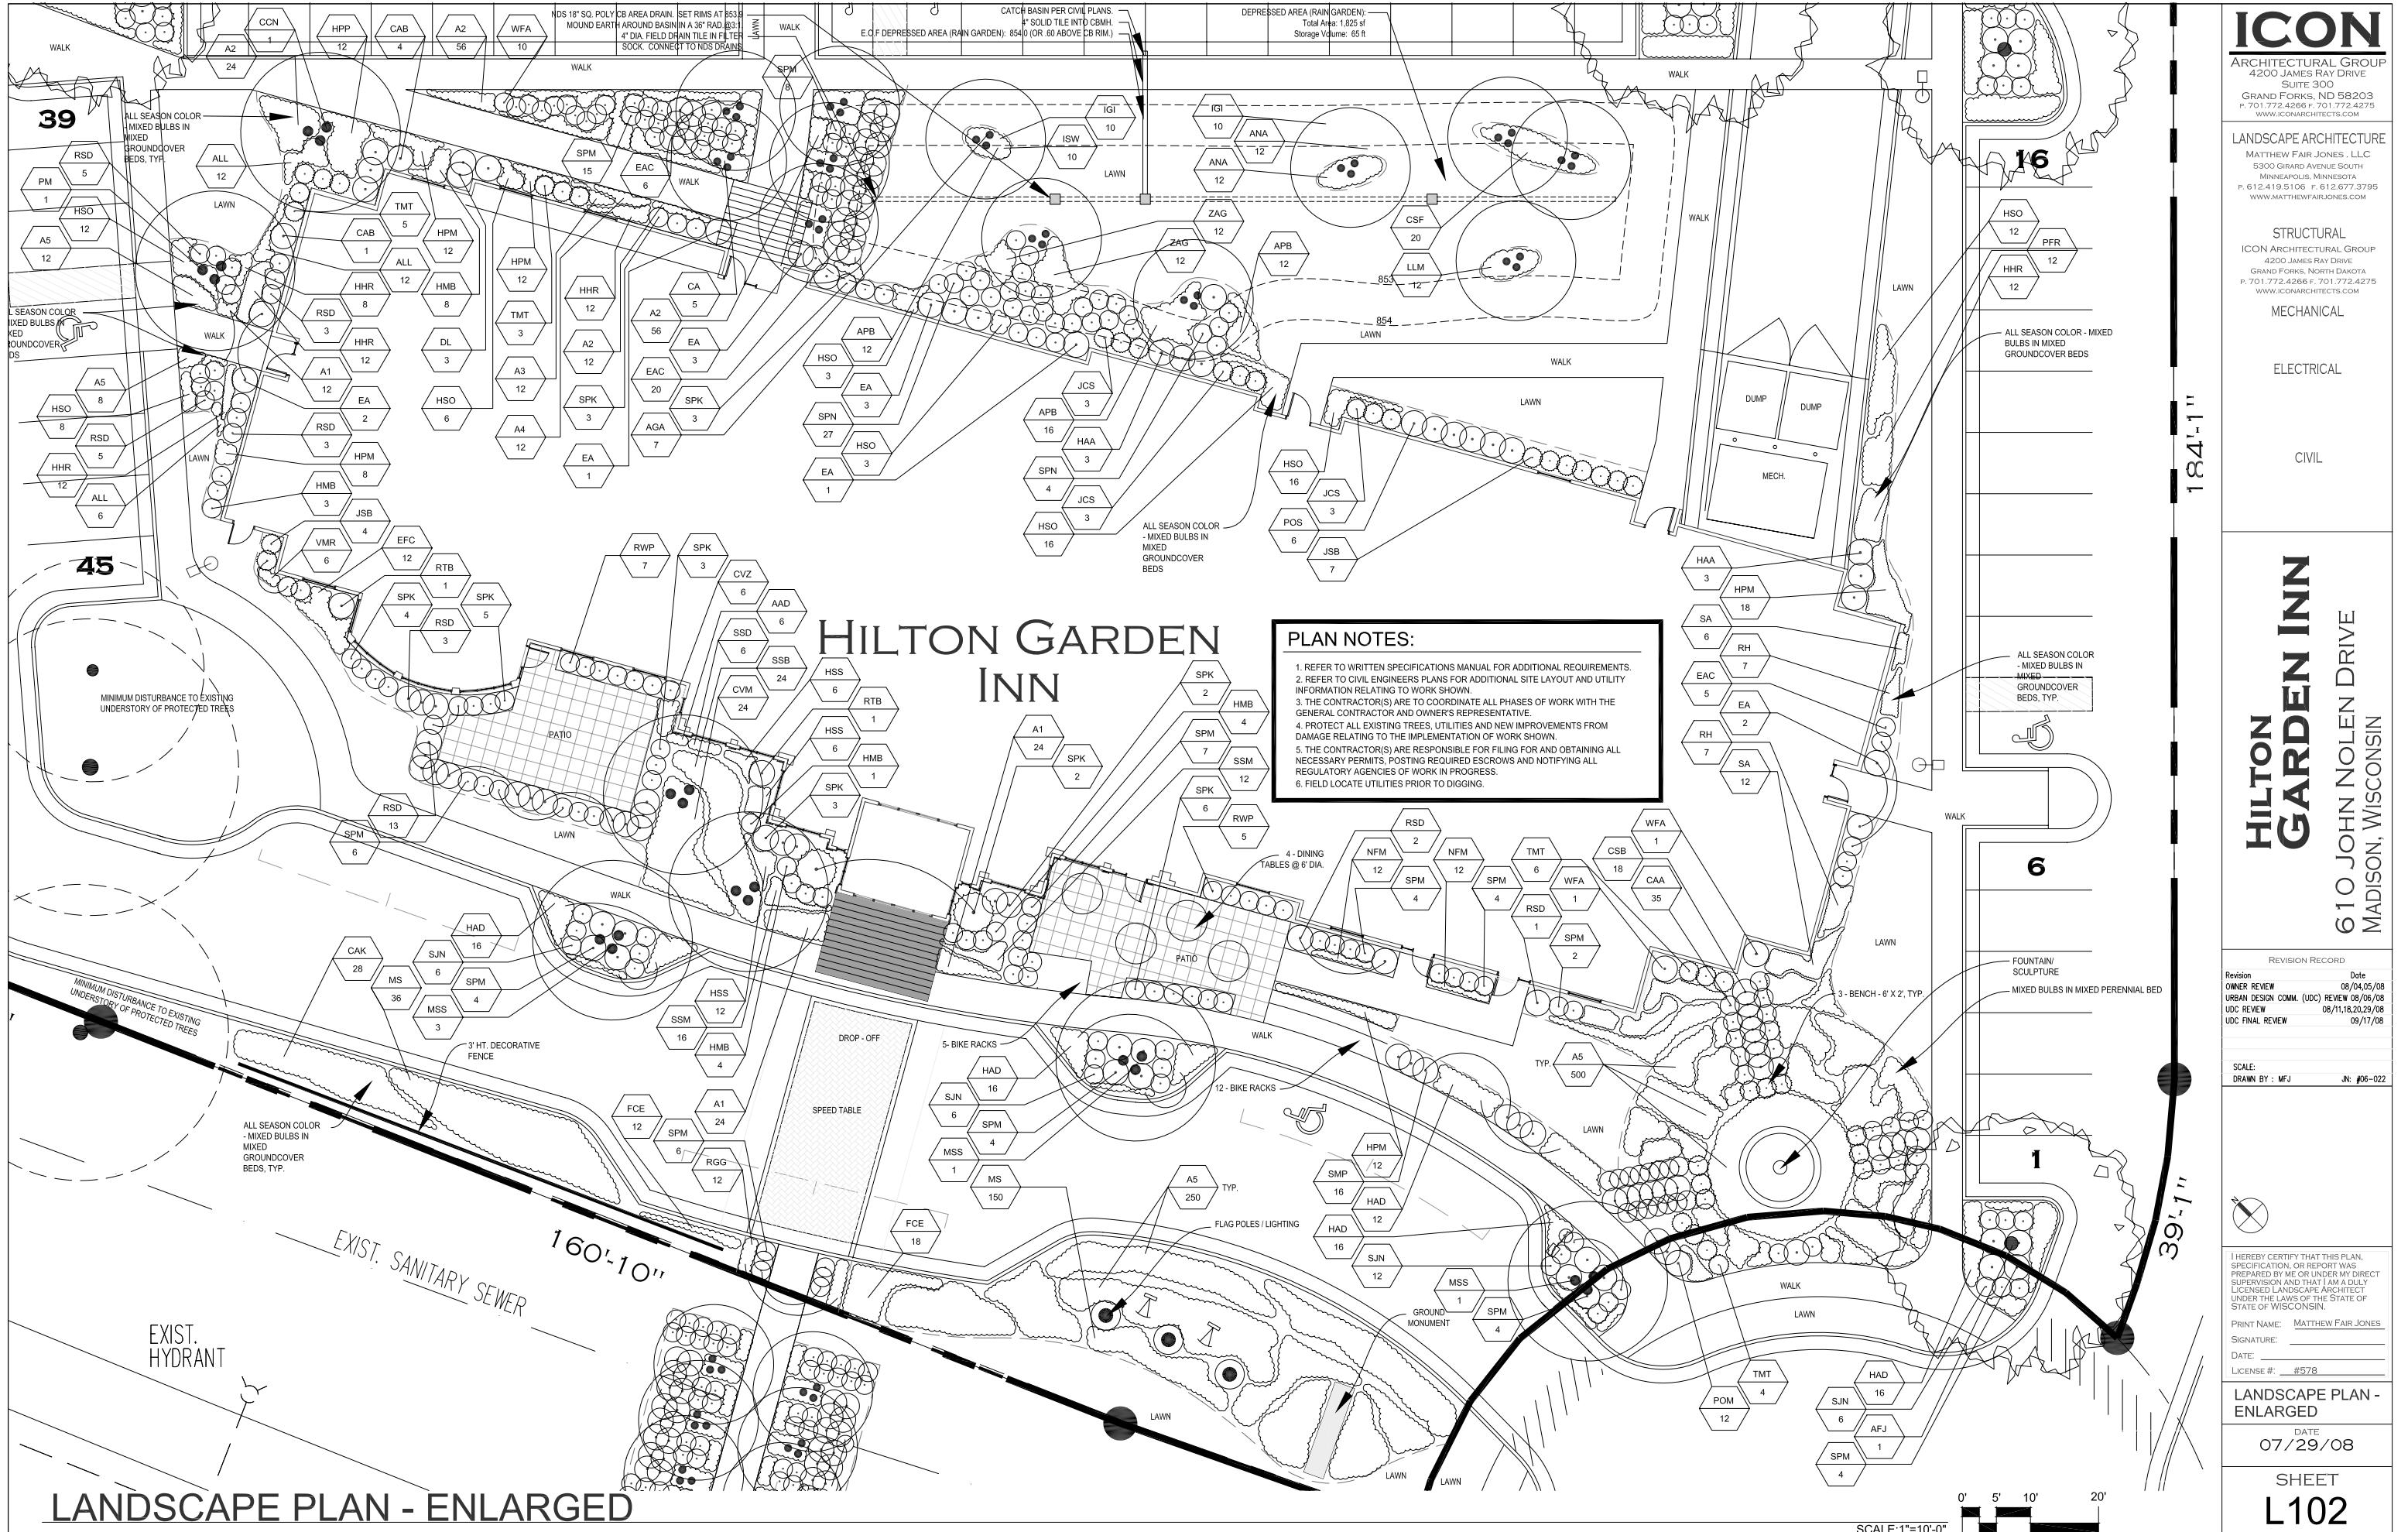

# HILTON GARDEN INN

610 JOHN NOLAN DRIVE  
MADISON, WISCONSIN

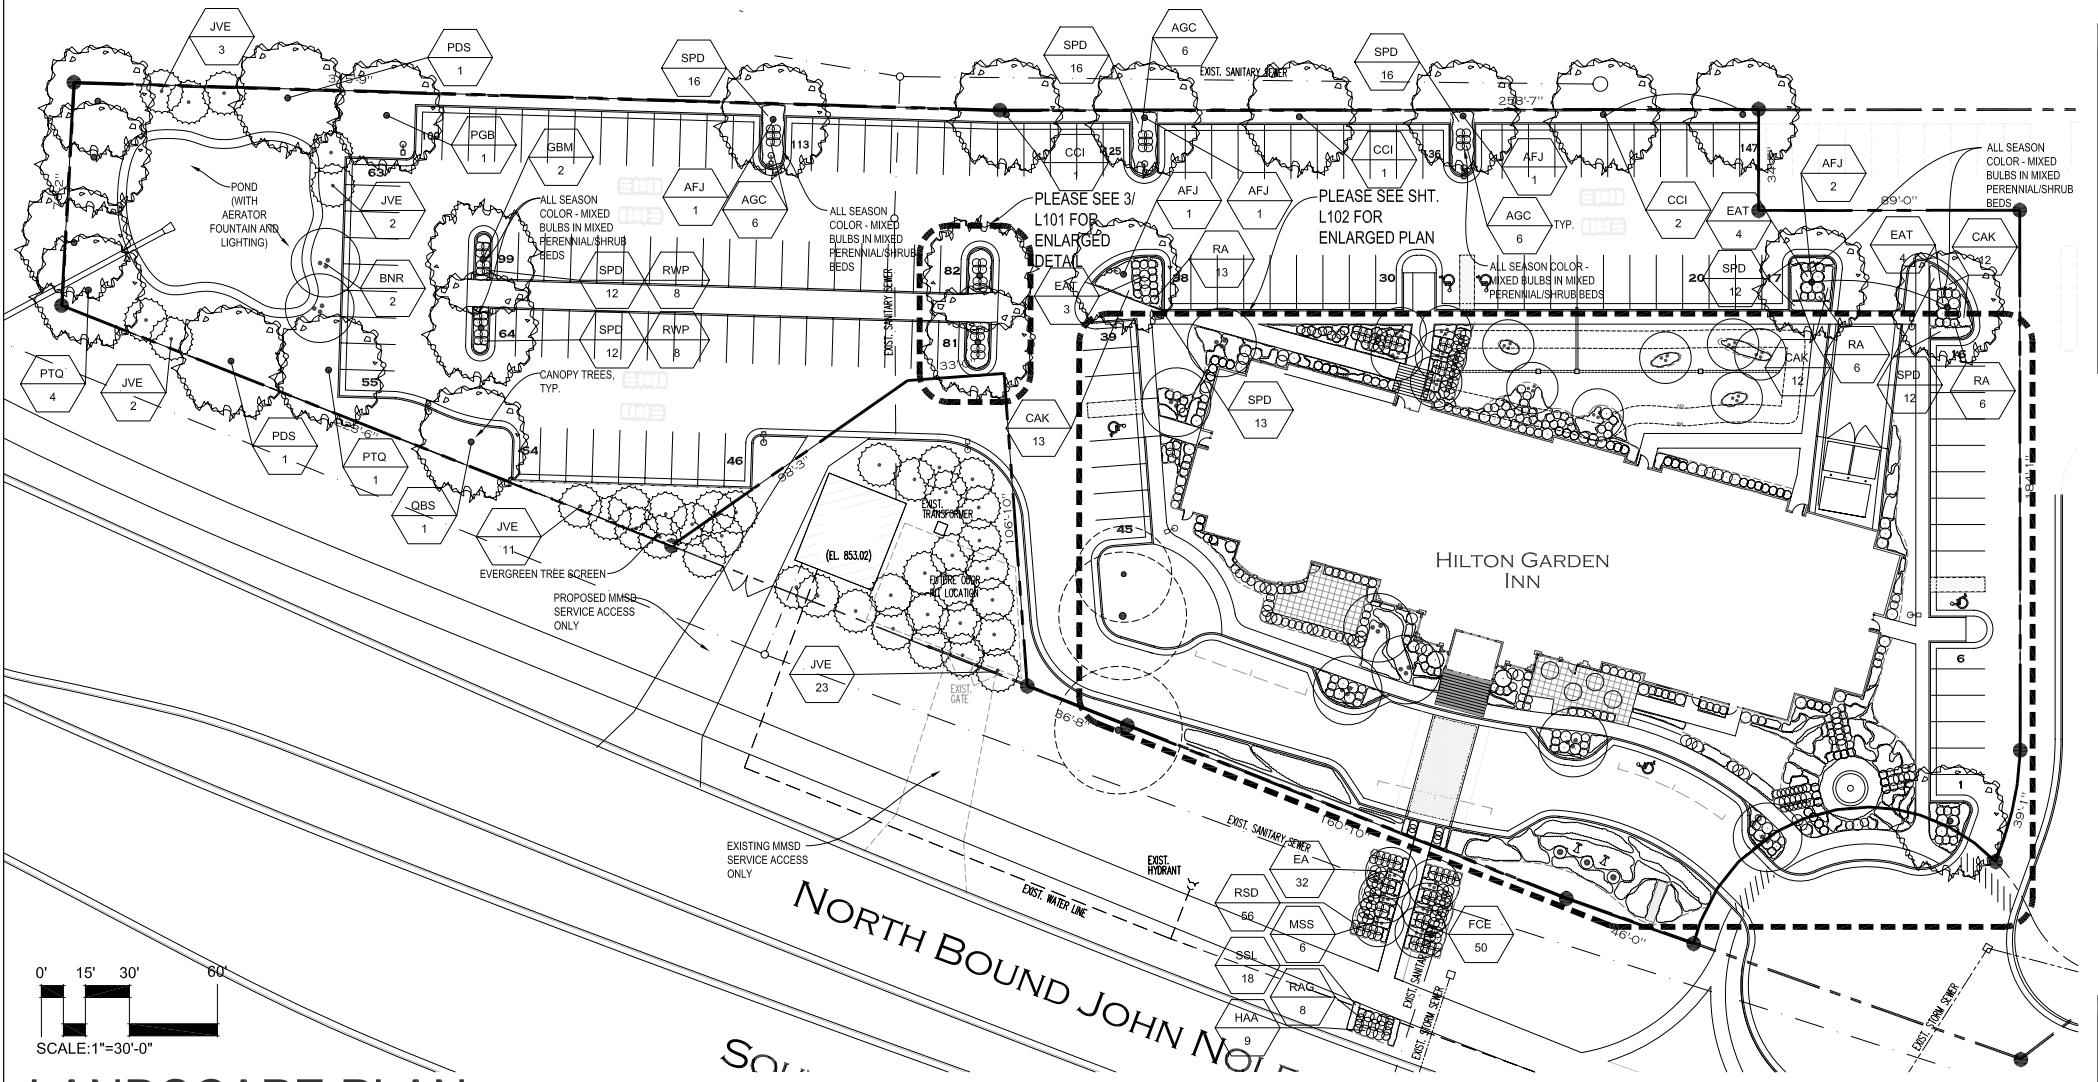

## PLAN NOTES:

- REFER TO WRITTEN SPECIFICATIONS MANUAL FOR ADDITIONAL REQUIREMENTS.
- REFER TO CIVIL ENGINEERS PLANS FOR ADDITIONAL SITE LAYOUT AND UTILITY INFORMATION RELATING TO WORK SHOWN.
- THE CONTRACTOR(S) ARE TO COORDINATE ALL PHASES OF WORK WITH THE GENERAL CONTRACTOR AND OWNER'S REPRESENTATIVE.
- PROTECT ALL EXISTING TREES, UTILITIES AND NEW IMPROVEMENTS FROM DAMAGE RELATING TO THE IMPLEMENTATION OF WORK SHOWN.
- THE CONTRACTOR(S) ARE RESPONSIBLE FOR FILING FOR AND OBTAINING ALL NECESSARY PERMITS, POSTING REQUIRED ESCROWS AND NOTIFYING ALL REGULATORY AGENCIES OF WORK IN PROGRESS.
- FIELD LOCATE UTILITIES PRIOR TO DIGGING.

## LANDSCAPE WORKSHEET

### I. NUMBER OF TREES REQUIRED

ELEMENT	QUANTITY	REQUIRED	MIN.	MAX.
NUMBER OF PARKING STALLS (CURRENTLY 148)	161	N/A	N/A	N/A
TOTAL SF OF THE STORAGE AREA (DIV. BY 300 SF)	0	N/A	N/A	N/A
NUMBER OF CANOPY SHADE TREES REQ. (2'-2 1/2' CAL.)	N/A	12	30	36

### II. NUMBER OF LANDSCAPE POINTS REQUIRED

ELEMENT	QUANTITY	REQUIRED	MIN.	MAX.
NUMBER OF PARKING STALLS	693	1,732	2,079	
TOTAL SF OF THE STORAGE AREA (DIV. BY 300 SF)	75	75	75	
NUMBER OF LANDSCAPE POINTS REQUIRED (2'-2 1/2' CAL.)	768	1,807	2,154	

### TABULATION OF POINTS AND CREDITS


ELEMENT	POINT VALUE	QUANTITY	CREDITS		
			POINTS ACHIEVED	QUANTITY	POINTS
CANOPY TREE: 2'-2 1/2' CAL. (TREES REQ. ABOVE N/A)	35	24	840	3	65
DECIDUOUS SHRUB	2	550	1,100	0	0
EVERGREEN SHRUB	3	43	129	0	0
DECORATIVE WALL OR FENCE (PER 10LF)	5	76	38	0	0
EARTH BERM (PER 10LF) AVG. HT. 30"	5	0	0	0	0
EARTH BERM (PER 10LF) AVG. HT. 15"	3	0	0	0	0
EVERGREEN TREES (3' HT. MINIMUM)	15	41	615	0	0
CANOPY TREE OR SMALL TREE: 1 1/2'-2' CAL.	15	27	405	0	0
SUB TOTALS		3,127	3	65	TOTAL 3,192

## RAIN GARDEN DESIGN:

PROPOSED HOTEL BUILDING ROOF AREA ONLY:  
 RUNOFF (GROSS): (A) 16,916SF X (E) 1' HR. = (V) 1,410CF  
 (A)=AREA  
 (E)=EVENT  
 (V)=VOLUME IN CUBIC FEET  
 (D)=DEPTH (AVERAGE)  
 ASSUMED TAPERED HOTEL ROOF, EXTERNAL STORM PIPING: (V)=1,410CF X .5 = 704.8CF

PROPOSED RAIN GARDEN:  
 HOLDING CAPACITY: (A) 9,268SF X (D) 36" = (V) 3,202CF (32% OF ANTICIPATED IMPERVIOUS ROOF AREA)  
 (WISCONSIN DOT SUGGESTS A RAIN GARDEN TARGET CAPACITY OF 15%-30% OF INTENDED IMPERVIOUS AREA)

REVISION RECORD	Dates
OWNER REVIEW	08/04/08
URBAN DESIGN COMM. (UDC) REVIEW	08/06/08
UDC REVIEW	08/11/08, 20, 29/08
UDC FINAL REVIEW	09/17/08
SCALE:	
DRAWN BY : MFJ	JN #06-022

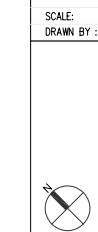


I HEREBY CERTIFY THAT THIS PLAN, SPECIFICATION, OR REPORT WAS PREPARED BY ME OR UNDER MY DIRECT SUPERVISION AND THAT I AM A DULY LICENSED ARCHITECT IN THE STATE OF WISCONSIN.  
 PRINT NAME: MATTHEW FAIR JONES  
 SIGNATURE: \_\_\_\_\_



DATE: \_\_\_\_\_  
 LICENSE #: #578

LANDSCAPE PLAN  
 DATE 07/29/08





SHEET  
 L101

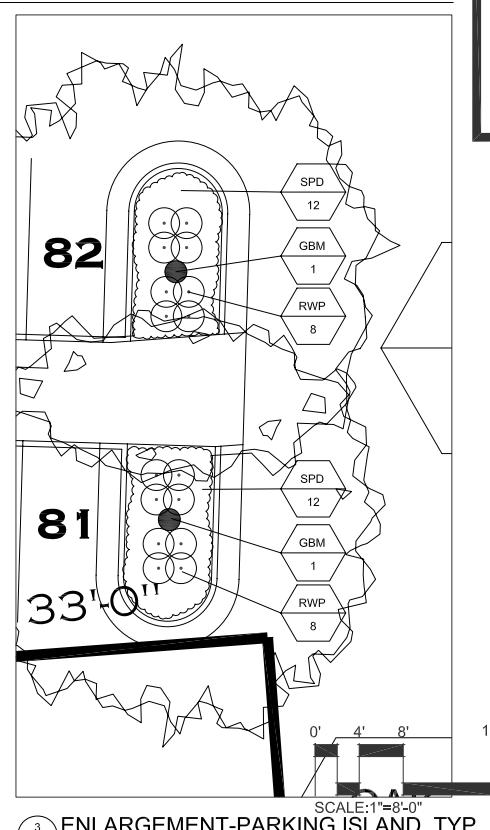

L101

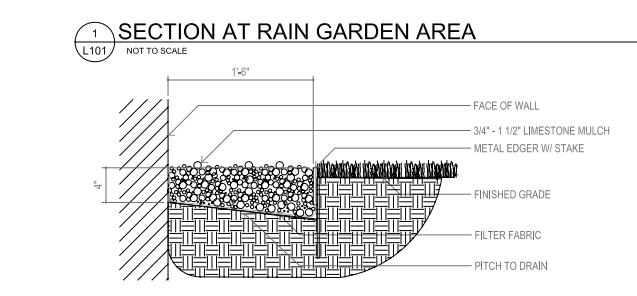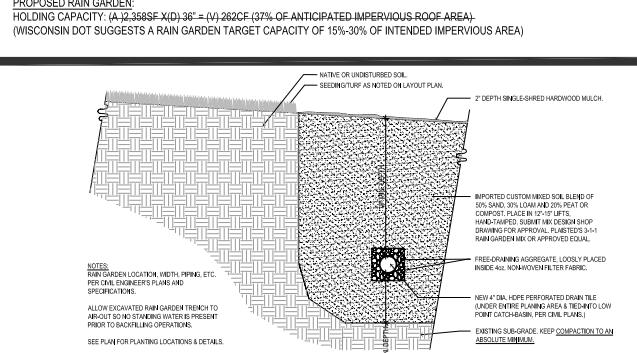

L101

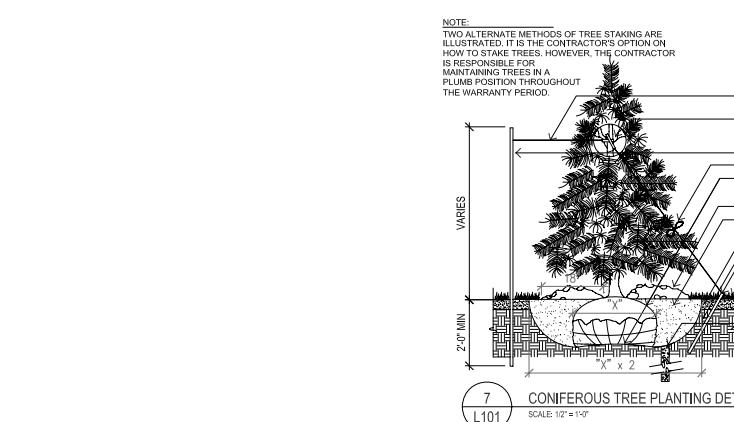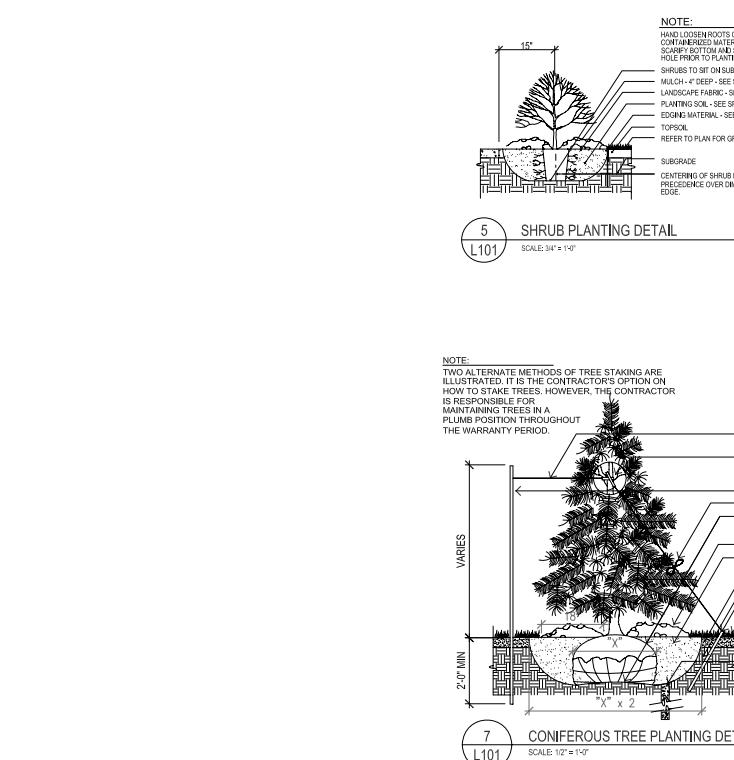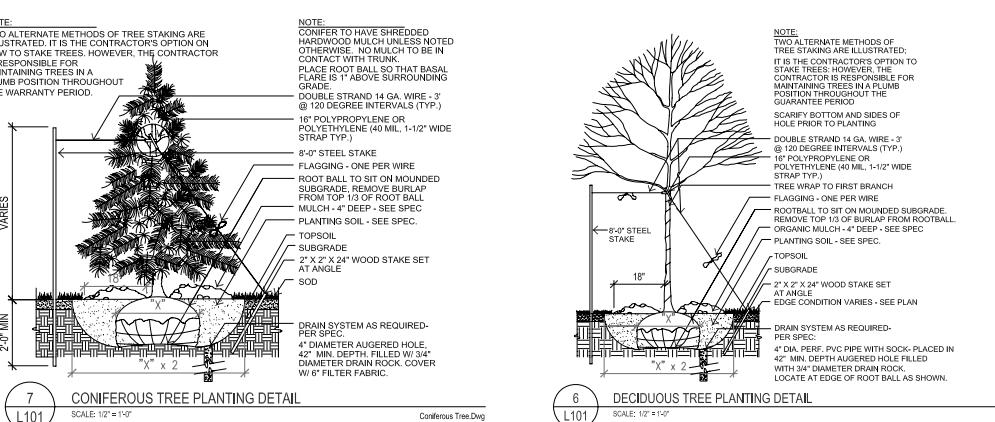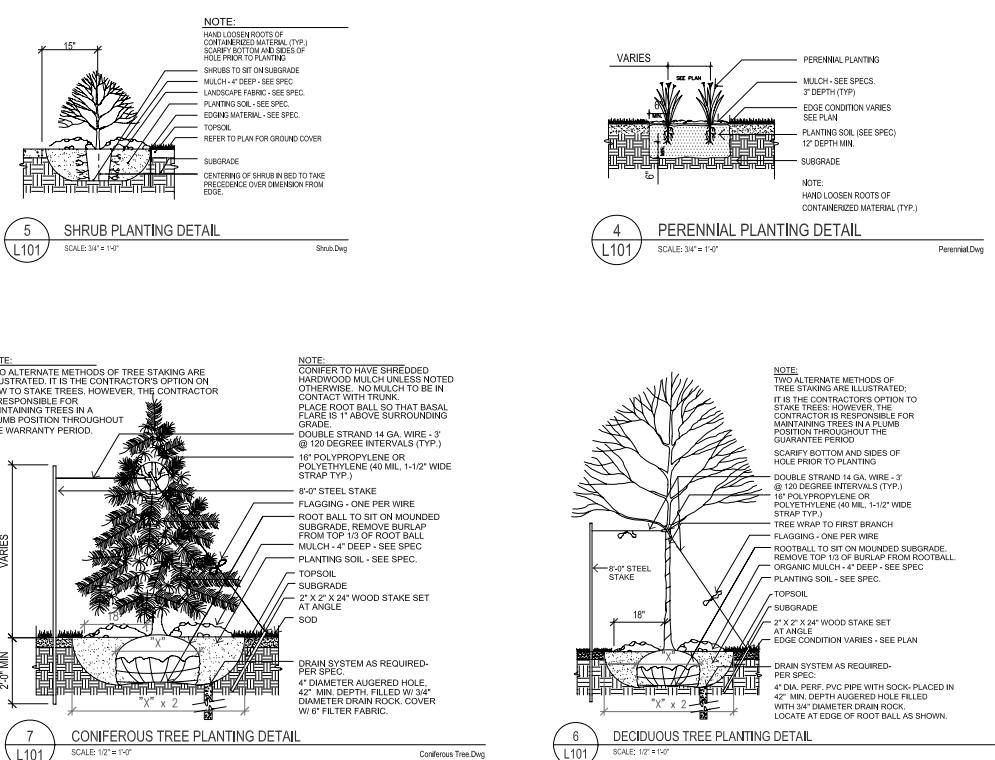

## PLANTING PALETTE:

GENERAL LANDSCAPE AREAS					
KEY	QTY / BOTANICAL NAME / COMMON NAME	HT. x WID.	CONT.	BASE BID	ADD ALT.
				SIZE / SPACING	SIZE / SPACING
<b>TREES: DECIDUOUS, CANOPY</b>					
AFA	0 Acer x freemanii 'Armstrong' / ARMSTRONG MAPLE	45'x15'	BB	2" CAL.	4" CAL.
AFJ	7 Acer x freemanii 'Jefferson' / AUTUMN BLAZE MAPLE	50'x40'	BB	2" CAL.	4" CAL.
AFS	0 Acer X freemanii 'Sienna' / SIENNA GLEN MAPLE	40'x30'	BB	2" CAL.	4" CAL.
ASA	0 Aesculus x syriaca 'Autumn Splendor' / AUTUMN SPLENDOR OHIO BUCKEYE	15'x30'	BB	2" CAL.	4" CAL.
BNR	0 Betula nigra / RIVER BIRCH	40'-60'x30'-40'	BB	2" CAL.	4" CAL.
COC	0 Celtis occidentalis / COMMON HACKBERRY	60'x50'	BB	2" CAL.	4" CAL.
GMB	4 Ginkgo biloba 'Mugay' / MUGAY GINKGO	-	BB	2" CAL.	4" CAL.
GII	0 Ligustrum lucidum var. Inermis / THORNLESS HONEYLOCUST	35'x30'	BB	2" CAL.	4" CAL.
GTS	0 Gleditsia triacanthos var. Inermis 'Sunburst' / SUNBURST THORNLESS HONEYLOCUST	35'x30'	BB	2" CAL.	4" CAL.
GDK	0 Gymnocladus dioica / KENTUCKY COFFEE TREE	50'x40'	BB	2" CAL.	4" CAL.
PDS	2 Populus tremuloides 'Quakingland' / QUIKINGLAND ASPIRE	70'x90'-40'	BB	2" CAL.	4" CAL.
PGB	1 Populus grandidentata 'Bigtooth' / BIGTOOTH ASPEN	50'x20'-30'	BB	2" CAL.	4" CAL.
PTO	5 Populus tremuloides / QUAKE ASPIRE	40'-60'x20'-30	BB	2" CAL.	4" CAL.
PSB	0 Prunus serrulata / CHERRY	_x50'-60'	BB	2" CAL.	4" CAL.
OPP	0 Quercus rubra / WHITE OAK	60'-80'x60'-80'	BB	2" CAL.	4" CAL.
QBS	1 Quercus bicolor / SWAMP WHITE OAK	50'-60'x40'-50'	BB	2" CAL.	4" CAL.
QMT	0 Quercus macrocarpa / BUR OAK	80'x60'	BB	2" CAL.	4" CAL.
OPP	0 Quercus coccinea / RED OAK	25'-40'x60'-70'	BB	2" CAL.	4" CAL.
QD	0 Quercus rubra / RED OAK	40'-60'x20'-25'	BB	2" CAL.	4" CAL.
TAB	0 Tilia americana 'Boulevard' / BOULEVARD LINDEN	50'x30'	BB	2" CAL.	4" CAL.
TAG	0 Tilia americana 'Greenspire' / GREENSPIRE LINDEN	40'x30'	BB	2" CAL.	4" CAL.
TCG	0 Tilia americana 'Greenspire' / GREENSPIRE LINDEN	40'-50'x30'-35'	BB	2" CAL.	4" CAL.
TMH	0 Tilia mongolica 'Harvest Gold' / HARVEST GOLD LINDEN	40'x30'	BB	2" CAL.	4" CAL.
UNH	0 Ulmus Hybrid Elms 'New Horizon' / NEW HORIZON ELM	50'x30'	BB	2" CAL.	4" CAL.

<b>TREES: DECIDUOUS, ORNAMENTAL</b>					
ACG	0 Amelanchier canadensis 'Glenhaven' / RIVERBERRY	20'x8'-10'	BB	6'HT.	8'HT.
AGA	7 Amelanchier x grandiflora 'Autumn Brilliance' / AUTUMN BRILLIANCE SERVICEBERRY	20'-25'x15'	BB	2" CAL.	4" CAL.
CCN	0 Cercis canadensis / NORTHERN TREE REDBUD	20'-30'x20'-25'	BB	2" CAL.	4" CAL.
CCI	4 Crataegus crus-galli var. Inermis / THORNLESS HAWTHORN	15'-20'x15'-20'	BB	2" CAL.	4" CAL.
CA	5 Cornus amomum / SMOKEWOOD	20'x15'	BB	2" CAL.	4" CAL.
MSS	11 Malus 'Spartacus' / SPRING SNOW CRAB	30'x20'	BB	2" CAL.	4" CAL.
PM	0 Prunus maackii / AMUR CHERRY	20'x15'	BB	2" CAL.	4" CAL.
PNP	0 Prunus nigra 'Princess Kay' / PRINCESS KAY CHERRY	15'x15'	BB	2" CAL.	4" CAL.
PUM	0 Pyrus ussuriensis 'MarDak' / PRAIRIE GEM FLORING PEAR	20'x15'	BB	2" CAL.	4" CAL.
SR	0 Syringa reticulata / JAPANESE TREE LILAC	20'x15'	BB	2" CAL.	4" CAL.

<b>TREES: CONIFEROUS</b>					
JVE	43 Juniperus virginiana / EASTERN REDCEDAR	8'-20'x40'-50'	BB	6'HT.	10'HT.
PG	0 Picea glauca densata / BLACK HILLS SPRUCE	35'x15'	BB	6'HT.	8'HT.
PP	0 Picea pungens / COLORADO SPRUCE	40'-60'x15'-30'	BB	6'HT.	10'HT.

<b>RAIN GARDEN PLANTS</b>					
APB	40 Andromeda polifolia 'Blue Ice' / BLUE ICE ANDROMEDA	24'x30'	CONT	#1	#2
ANA	24 Aster novae-angliae / NEW ENGLAND ASTER	18'x24'	CONT	#1	#2
CSF	20 Cornus alba 'Flaviramea' / ARCTIC FIRE REDWOOD	30'x36'	CONT	#1	#2
IGI	20 Iris germanica 'Imagette' / DWARF BEARDED IRIS	18'x18'	CONT	#1	#2
ISW	10 Iris sibirica 'White Swirls' / SIBERIAN IRIS	18'x24'	CONT	#1	#2
LLM	12 Leptandra texana / TEXAS LEAVES	12'x24'	CONT	#1	#2
SPN	31 Salix purpurea 'Nana' / DWARF RED BLOODED WILLOW	30'x24'	CONT	#1	#2
ZAG	24 Zizia aurea / GOLDEN ALEXANDER	12'x24'	CONT	#1	#2

<b>PLANTING PALETTE (CONTINUED):</b>					
GENERAL LANDSCAPE AREAS	KEY	QTY / BOTANICAL NAME / COMMON NAME	HT. x WID.	CONT.	BASE BID
<b>SHRUBS: DECIDUOUS</b>					
ACC	18 Acer glinoides 'Compactum' / COMPACT AMUR MAPLE	6'-10'x6'-10'	BB	#2	#5
CAA	35 Cornus alba 'Alleman's Compact' / ALLEMAN'S COMPACT DOGWOOD	5'x5'	CONT	#2	#5
CAB	5 Cornus alba 'Ballard' / IVORY HALO DOGWOOD	5'-6'x5'-6"	CONT	#2	#5
CRG	0 Cornus sanguinea 'Flaviramea' / GRAY DOGWOOD	10'-15'x10'-15'	CONT	#2	#5
CSB	18 Cornus sanguinea 'Bailey' / RED TWIGGED DOGWOOD	8'-10'x8'-10"	CONT	#2	#10
CSC	0 Cornus sanguinea 'Cardinal' / CARDINAL DOGWOOD	8'-10'x8'-10"	CONT	#2	#10
DL	3 Dierama litorale / DWARF LILY HONEYSUCKLE	3'-4'x3'	CONT	#2	#10
EA	43 Euonymus alatus 'Sulphuratum' / WINGED EUONYMUS	12'-15'x8'-12'	CONT	#2	#5
EAC	31 Euonymus alatus 'Compactus' / DWARF WINGED EUONYMUS	8'-10'x6'-8"	CONT	#2	#5
EAT	11 Euonymus alatus 'Timber Creek' / CHICAGO FIRE BURNING BUSH	8'-10'x6'-8"	CONT	#2	#5
HAA	15 Hydrangea paniculata 'Grandiflora' / ANNUAL HYDRANGEA	4'-5'x3'-5"	CONT	#2	#5
HMB	20 Hydrangea macrophylla 'Ballerina' / ENDLESS SUMMER HYDRANGEA	3'-5'x3'-5"	CONT	#2	#5
POS	6 Physocarpus opulifolius 'Seward' / SUMMER WINE NINEBARK	4'-5'x4'-6"	CONT	#2	#5
POM	12 Physocarpus opulifolius 'Monrovia' / MONROVIA NINEBARK	6'-10'x6"-8"	CONT	#2	#5
RSD	91 Rhododendron 'Slim Dunk' / SLIM DUNK RHODODENDRON	4'-5'x3'-5"	CONT	#2	#5
RAG	8 Rhus aromatica 'Gro-Low' / GRO-LAWN FRAGRANT SUMAC	2'-6'x8"	CONT	#2	#5
RTB	2 Rhus typhina 'Bailey' / CUTLEAF TIGER EYES SUMAC	6'x6"	CONT	#2	#5
RA	25 Ribes cereum / CEDAR Currant	3'-5'x4'-6"	CONT	#2	#5
RWP	44 Rosa 'Wimble Park' / WINNipeg PARKS SHRUB ROSE	2'-10'	BB	#2	#5
SJN	30 Spiraea japonica 'Neon Flash' / NEON FLASH SPIREA	3'-3.5'x3'-5"	CONT	#2	#5
SMP	22 Syringa meyeri 'Palibin' / PALIBIN LILAC	4'-6'x5'-7"	BB	#2	#5
SPM	62 Syringa prestolea 'Minuet' / MINUET LILAC	6'-8'x4'-6"	BB	#2	#5
SPK	31 Syringa parviflora 'Miss Kim' / MISS KIM LILAC	6'-8'x5'-6"	BB	#2	#5
VDS	0 Viburnum dentatum 'Synthetic' / CHICAGO LUSTER ARROWWOOD VIBURNUM	10'x10'	BB	#2	#5
WFA	12 Weigela florida 'Alexandra' / WINE AND ROSES WEIGELA	4'-6'x4'	BB	#2	#5

<b>SHRUBS: CONIFEROUS</b>		
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PROJECT: Hilton Hotel/SB82608 GROUP: Site AREA: Parking Site GRID: Grade  
PREPARED BY: Dave - Visual Impact Lighting  
VALUES ARE FC, SCALE: 1 IN= 20.0FT, HORIZ GRID (U), HORIZ CALC, Z= 0.0

#### LitePro 2.025 Point-By-Point Results

Computed in accordance with IES recommendations

Statistics					
GROUP	MIN	MAX	AVE	AVE/MIN	MAX/MIN
(+)	0.00	26.77	3.77	N/A	N/A

### Luminaires Used

Equipment List		
TYPE	QTY	TEST#
B0	19	----- Bollard, , Conc. Pour (1) BL <FN2-P10-DO>, LLF= 0.80;
F	3	AFL15-17 KIM LIGHTING, AFL15/175MHxxx/xx, ARCHITECTURAL FLOODLIGHT LUMIN, DIE-CAST ALUM. HOUSING & LENS LAMPS ( 1 ) 14400 LUMENS BLST: LLF = 1.00 @ 2.00
OA	12	----- Single Warp 9, 25' RTS, Conc. Pour (1) W <WP9L3/400PMH-ED28>, LLF= 1.00;
OB	2	----- Double Warp 9, 25' RTS, Conc. Pour (2) W <WP9L3/400PMH-ED28>, LLF= 1.00;
OW	10	----- Laradeo, , Wall (1) W1 <LMC-175H-CS>, LLF= 0.72;

