# URBAN DESIGN COMMISSION APPLICATION



City of Madison Planning Division 126 S. Hamilton St.



Paid	Receipt#
Date received	
Received by	
Aldermanic District	
Zoning District	
Urban Design District	
Submittal reviewed by	

Madison, WI 53701-298 (608) 266-4635		I 53701-2985	2985		received ived by rmanic District
	the desired n  If you need an I formats or othe	sections of this app neeting date and th interpreter, translator, i er accommodations to o ohone number above in	e action requested. materials in alternate access these forms.	Urban	ng District  n Design District  nittal reviewed by
Address.		917 EAST MIFFLI	N STREET Field Phase 3 Facility Impro	vemen	nts
2.	UDC meeting	Type (check all that date requested elopment 图	apply) and Requested Da 12/05/2018		viously-approved development
	□ Informat	•	Initial approval	JY DIEVI	• • • • • • • • • • • • • • • • • • • •
3.	Project in Mixed-Usi Project in Campus I District (E Planned I Gene	the Suburban Emplonstitutional District (EC) Development (PD) Peral Development Placific Implementation	District (DC), Urban xed-Use Center District (MXC) yment Center District (SEC), CI), or Employment Campus an (GDP)		
4.	Applicant, Ag Applicant nan Street address Telephone Project contact Street address Telephone	me Mike Sturn 210 MLK Ji 608-267- ct person Peter R	Owner Information  BLVD, Rm 104  4921  ott  son St. Suite 203	Email Compa City/Si Email	State/Zip Madison, WI 53701  sturm@cityofmadison.com  pany Isthmus Architecture  State/Zip Madison, WI 53703  rott@is-arch.com
	Street address Telephone	210 MIN I	BLVD, Rm 104	City/St _Email	State/Zip Madison, WI 53701 EKnepp@cityofmadison.com

5. Re	equired Submittal Materials				
$\mathbf{X}$	Application Form	)			
×	Letter of Intent	1	Each submittal must include fourteen (14)		
	<ul> <li>If the project is within an Urban Design Distric development proposal addresses the district criteria</li> </ul>		11" x 17" collated paper copies. Landscape and		
	<ul> <li>For signage applications, a summary of how the pro with the applicable CDR or Signage Variance review</li> </ul>	oposed signage is consistent criteria is required.	Lighting plans (if required) must be full-sized. Please		
X	Development plans (Refer to checklist provided below	for plan details)	refrain from using plastic		
DK .	Filing fee		covers or spiral binding.		
	Electronic Submittal*				
be	th the paper copies and electronic copies <u>must</u> be submitt scheduled for a UDC meeting. Late materials will not be ac pearance.	ted prior to the application dead cepted. A completed application	lline before an application will form is required for each UDC		
Cor	For projects also requiring Plan Commission approval, applicants must also have submitted an accepted application for Plan Commission consideration prior to obtaining any formal action (initial or final approval) from the UDC. All plans must be legible when reduced.				
con pro not	Electronic copies of all items submitted in hard copy are required. Individual PDF files of each item submitted should be compiled on a CD or flash drive, or submitted via email to <a href="mailto:udcapplications@cityofmadison.com">udcapplications@cityofmadison.com</a> . The email must include the project address, project name, and applicant name. Electronic submittals via file hosting services (such as Dropbox.com) are not allowed. Applicants who are unable to provide the materials electronically should contact the Planning Division at (608) 266-4635 for assistance.				
6. Ap	plicant Declarations				
1.	Prior to submitting this application, the applicant is required to discuss the proposed project with Urban Design Commission staff. This application was discussed with Kevin Furchow, Bill Fruhling, Janine Glaeser on 6/14/2018				
2. The applicant attests that all required materials are included in this submittal and understands that if any required information is not provided by the application deadline, the application will not be placed on an Urban Design Commission agenda for consideration.					
Δnr	olicant name Mike Sturm	Nelationship to property	ladison Parks Dept. Staff		
			Date 10/31/2018		
Aut	thorized signature of Property Owner		Date10/31/2018		
Fee part and fees	s are required to be paid with the firstapplicationforeith tof the combined applicationprocessinvolvingthe Urban De Jor Common Council consideration. Makecheckspayable to sof less than \$1,000.  "PLEASE CHARGE FEES as consult the schedule below for the appropriate fee for	signCommissioninconjunc to CityTreasurer Credit cards of the Communication of the Communicati	ionwithPlanCommission		
1100	Urban Design Districts: \$350 (per §35.24(6) MGO).	r your request.	<del>-</del>		
	Minor Alteration in the Downtown Core District (DC) or Urban Mixed-Use District (UMX): \$150 (per §33.24(6)(b) MGO)	A filing fee is not required for applications if part of the con involving both Urban Design (Commission:	nbined application process		
	Comprehensive Design Review: \$500 (per §31.041(3)(d)(1)(a) MGO)	Project in the Downtown C	Core District (DC), Urban r Mixed-Use Center District (MXC)		
	Minor Alteration to a Comprehensive Sign Plan: \$100 (per §31.041(3)(d)(1)(c) MGO)	Project in the Suburban Er (SEC), Campus Institutional			
	All other sign requests to the Urban Design Commission, including, but not limited to: appeals from the decisions of the Zoning Administrator,		D): General Development		

requests for signage variances (i.e. modifications of

signage height, area, and setback), and additional sign code approvals: \$300 (per §31.041(3)(d)(2) MGO)

Plan (GDP) and/or Specific Implementation Plan (SIP)

Planned Multi-Use Site or Residential Building Complex

#### **LETTER OF INTENT**

#### Breese Stevens Field - HOSPITALITY AND FIELD IMPROVEMENTS

917 East Mifflin Street

To: City of Madison Urban Design Commission

From: Eric Knepp, Parks Superintendent

> Madison Parks Division 210 Martin Luther King Jr. Blvd., Rm. 104

Madison, WI 53701

Peter Rött, AIA, NCARB

Isthmus Architecture

613 Williamson St. Suite 203

Madison, WI 53703

#### **Project Context**

Breese Stevens Field, originally Breese Stevens Municipal Athletic Field, was constructed in 1925. Additions occurred in 1934 and 1939. Local architects, Claude and Starck, designed the brick and terra cotta structure in the Mediterranean Revival Style. The stone wall enclosing the field was built (1934) by the Civil Works Administration (CWA) with native stone guarried at Hoyt Park.

Breese Stevens Field was designated a City Landmark in 1995 and subsequently listed on the State and National Registers of Historic Places in 2015. Upon securing the historic designations, Madison Parks Division set out to prioritize restoration and revitalization of the stadium. For the past several years, as part of a focused planning process, Parks staff's efforts have been successful in completing significant code improvements and infrastructure upgrades to ensure the on-going viability of this cultural asset. The City entered into a partnership with Big Top Events to further leverage the site's great potential and this has been very productive. Breese Stevens Field is returning as destination venue for seasonal sports events and now community festivals and open-air concerts.

#### **Project Description**

Continuing to implement "preservation through purpose" at Breese Stevens Field, the Madison Parks Division is proposing the next phase of facility improvements. This project phase consists of hospitality and field improvements. Hospitality improvements will upgrade the bleacher area beneath the 1925 canopy and include public access atop the concession addition, previously approved and set to begin construction. Field improvements include additional bleachers, hardscape / flex space for concerts and vendors and technology upgrades required for professional soccer. The scope of this project is consistent with the 2007 Breese Stevens Field Rehabilitation Design Report and as further articulated in the comprehensive 2017 Breese Stevens Field Facility Plan. These documents and the proposed addition were prepared for the City by Isthmus Architecture.

All proposed improvements will only be visible upon admission to the facility. The 1934 stone wall that secures the perimeter otherwise prevents public view except from the adjacent high-rise buildings now constructed immediately to the east and to the west.

#### Compatibility

The proposed project is in keeping with overall goals, character, and pattern of development in the following:

- Tenney Lapham Neighborhood Plan
- City of Madison Downtown Plan

Respectfully submitted,

Peter R Rött, Principal Architect

Isthmus Architecture

#### **ATTACHMENTS**

Project Drawings with Conditions Image and Perspective View of Proposed Improvements

-1 of 1 -October 31,2018


# BREESE STEVENS FIELD PHASE 3 FACILITY IMPROVEMENTS







Phase 3 Improvements
BREESE STEVENS FIELD
917 East Mifflin Street

Proj. No.:	1617.03
Scale:	
Drawn By:	pr
Date:	10/31/2018
Rev. Date:	

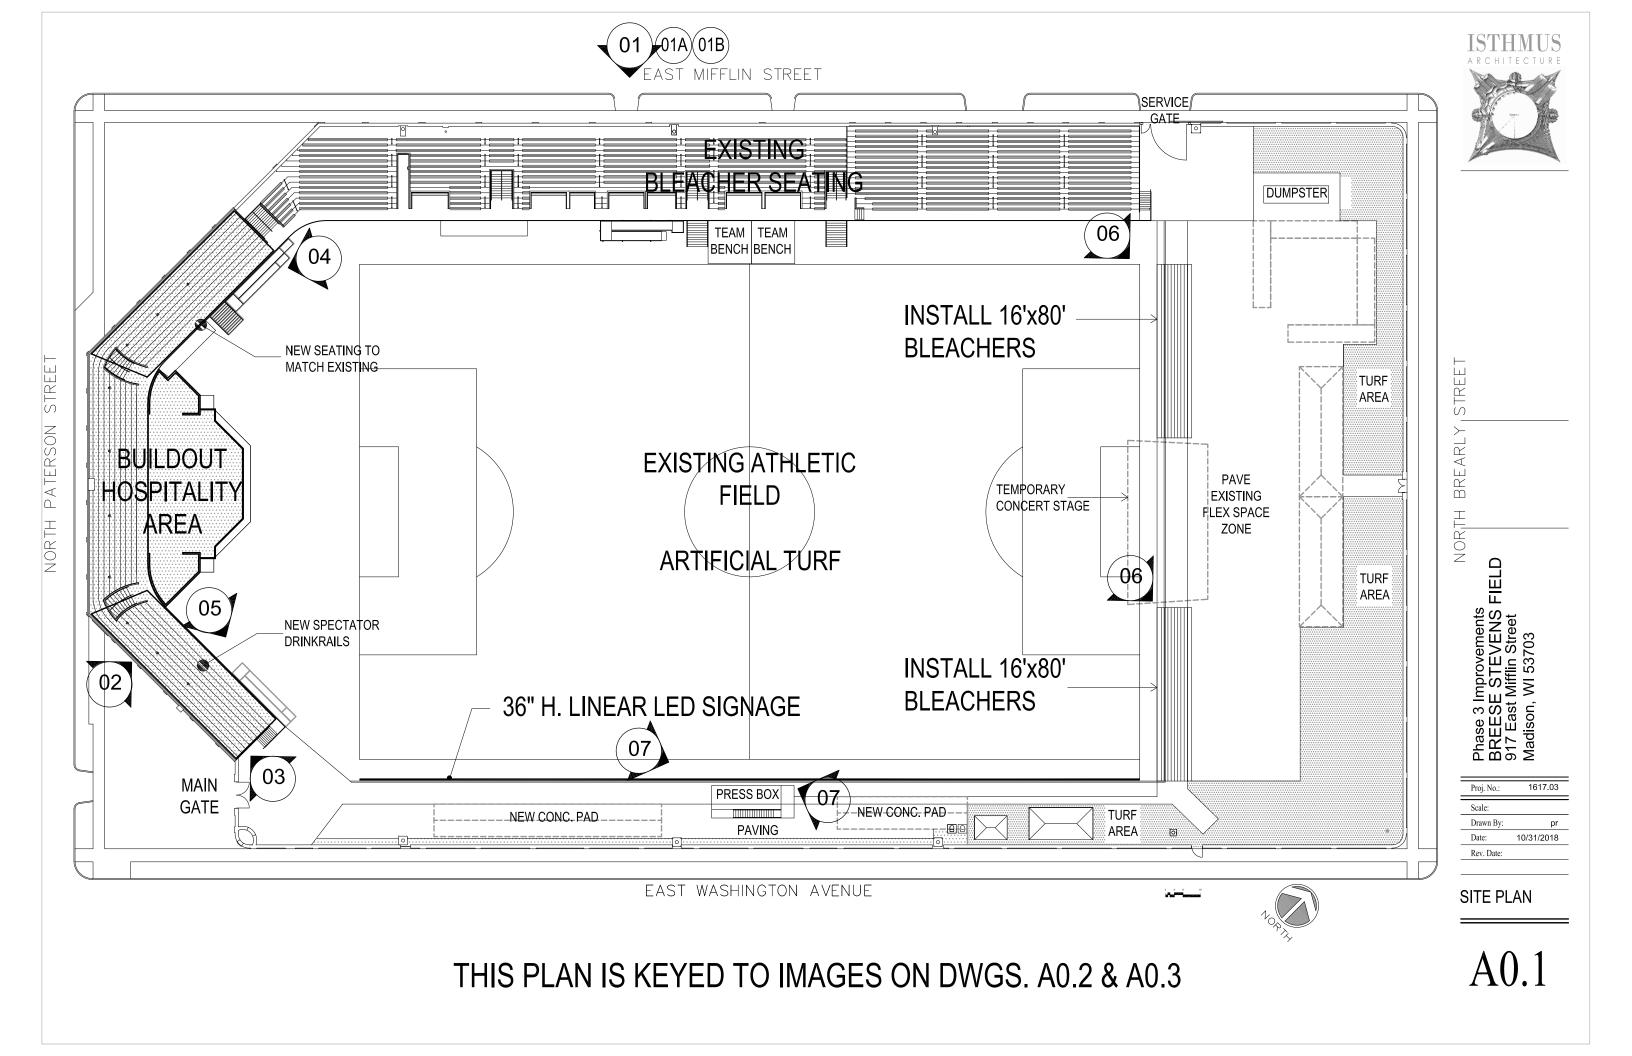

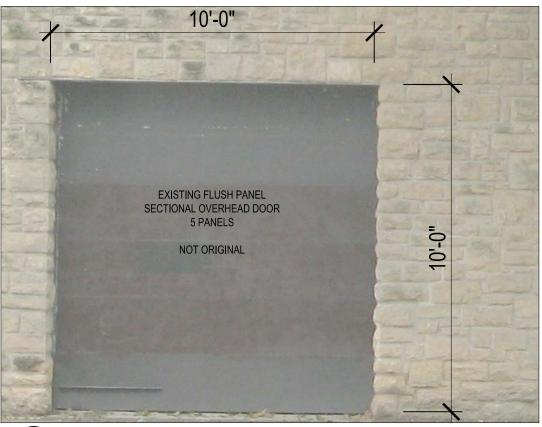

# (01) EXISTING OVERHEAD DOOR @ MIFFLIN

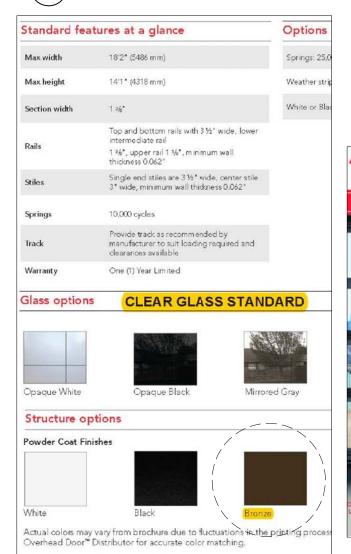



**DOOR SPECS** 












PROPOSED DOOR to LOWER LEVEL

(02) EXISTING DOOR to LOWER LEVEL



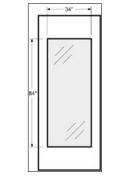

PROPOSED SERVICE DOOR to LOWER LEVEL (NO SIDELIGHTS)

Phase 3 Improvements BREESE STEVENS FIELD 917 East Mifflin Street Madison, WI 53703

1617.03
pr
10/31/2018

03 EXISTING SERVICE DOOR to LOWER LEVEL

**EXTERIOR ENVELOPE MODIFICATIONS** 


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04) INSTALL ADDITIONAL BLEACHERS TO MATCH




ig(  ${f 05}\,ig)$  INSTALL DRINK RAILS TO MATCH BLEACHERS



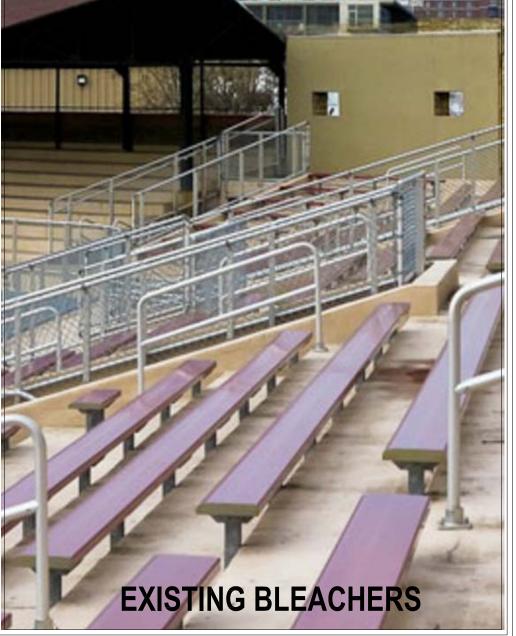

(06) INSTALL TWO SPECTATOR BLEACHERS @ EAST END ZONE

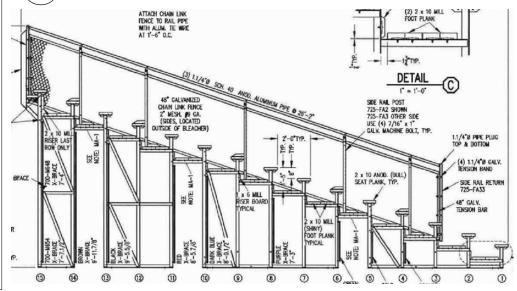

Phase 3 Improvements
BREESE STEVENS FIELD
917 East Mifflin Street









**GRANDSTAND & FIELD MODIFICATIONS** 

**ISTHMUS** 

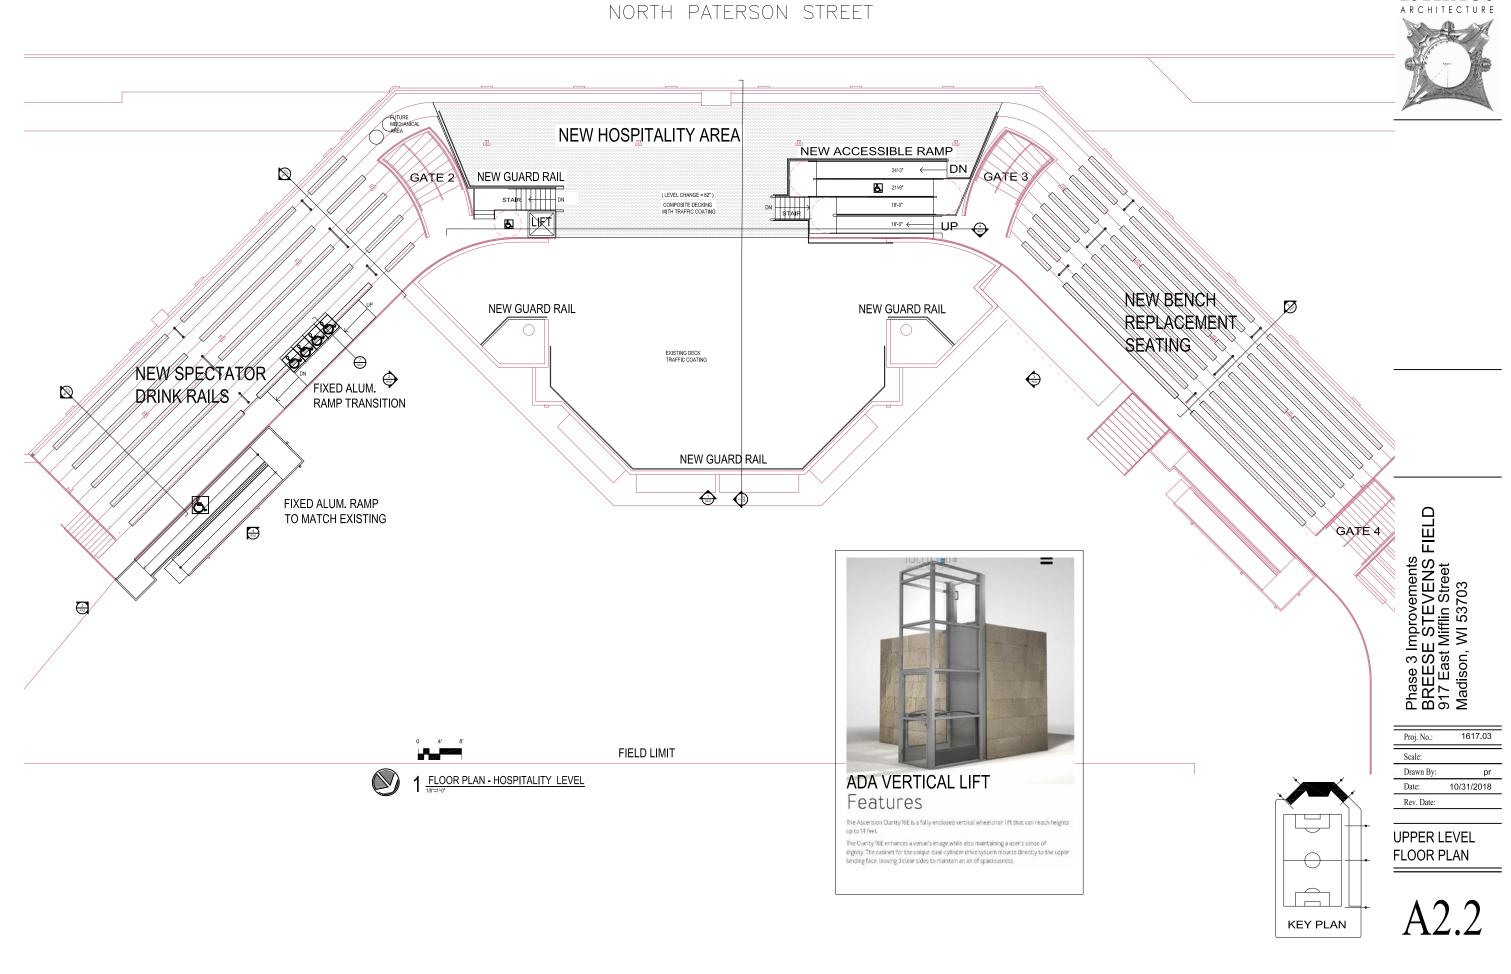

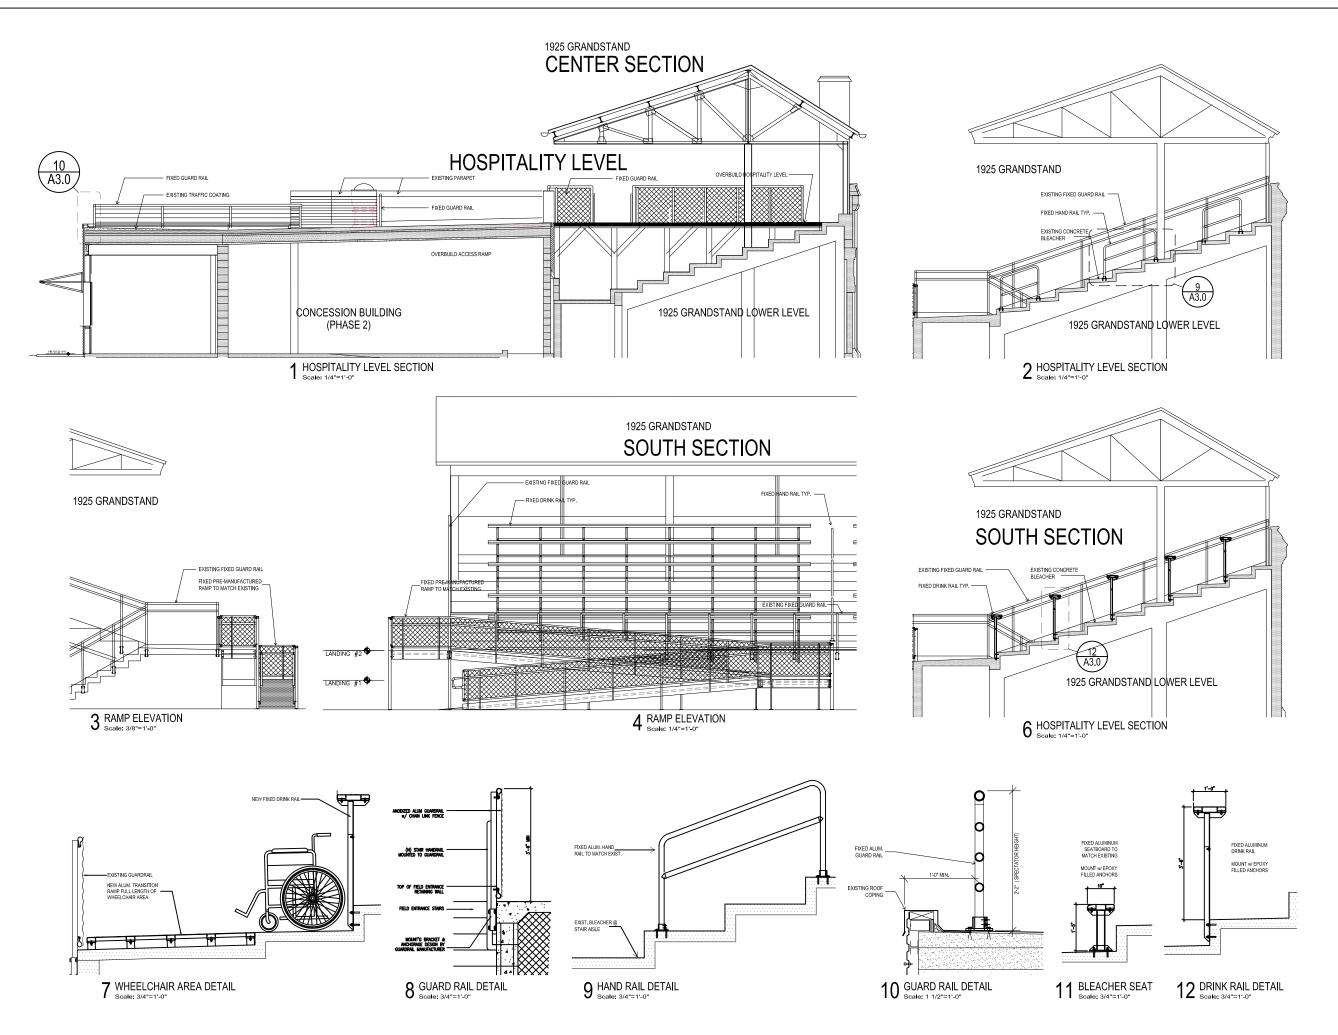


ISTHMUS ARCHITECTURE


> Phase 3 Improvements BREESE STEVENS FIELD 917 East Mifflin Street Madison, WI 53703


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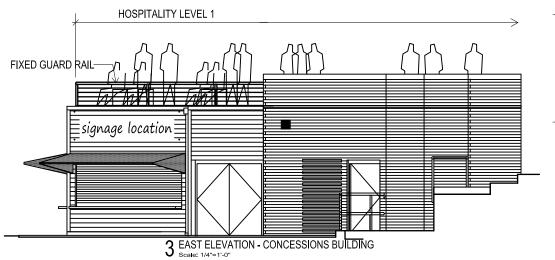
SECTION & ELEVATIONS


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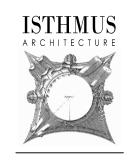


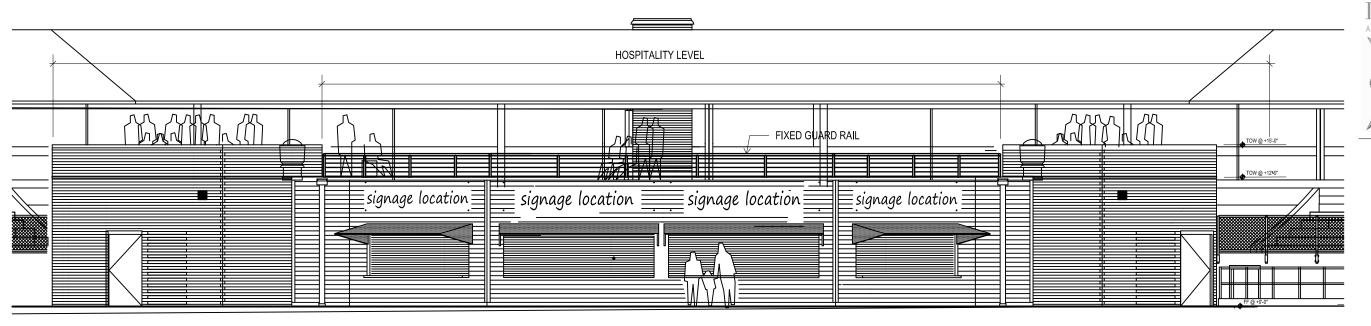



Phase 3 Improvements BREESE STEVENS FIELD 917 East Mifflin Street Madison, WI 53703
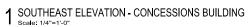
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**ELEVATIONS** 

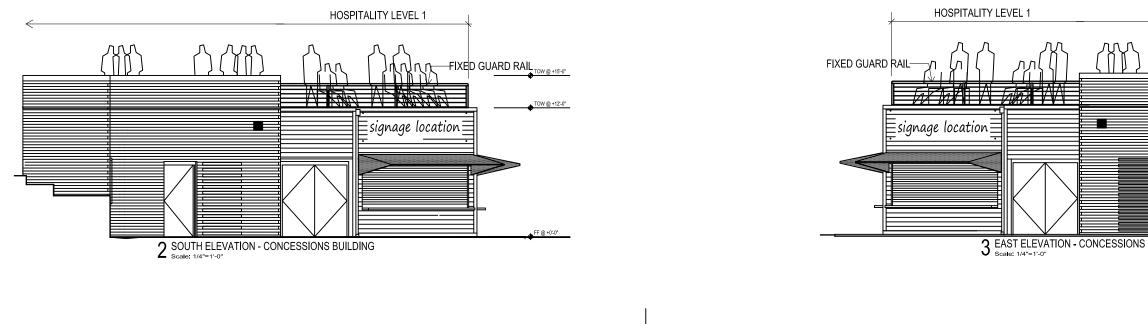

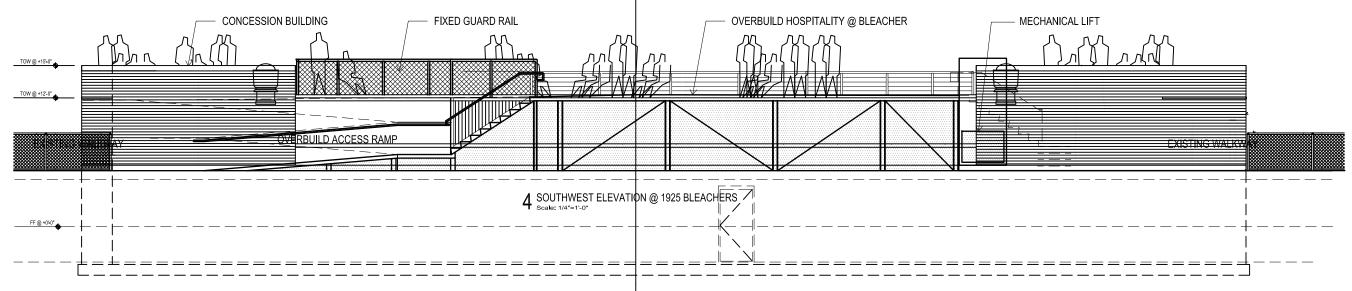

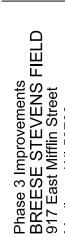

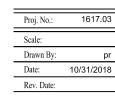

**GUARD RAIL** 

PERSPECTIVE VIEW OF HOSPITALITY LEVEL looking SW


# <u>GENERAL</u>

- 1. THE CONTRACTOR SHALL NOTIFY THE OWNER AND THE MUNICIPALITY FORTY— EIGHT (48) HOURS PRIOR TO THE START OF CONSTRUCTION.
- 2. THE CONTRACTOR SHALL INDEMNIFY THE OWNER, THE ENGINEER, AND THE MUNICIPALITY, THEIR AGENTS, ETC, FROM ALL LIABILITY INVOLVED WITH THE CONSTRUCTION, INSTALLATION, AND TESTING OF THE WORK ON THIS PROJECT.
- 3. SITE SAFETY SHALL BE THE SOLE RESPONSIBILITY OF THE CONTRACTOR.
- 4. THE BIDDER WILL BE SOLELY RESPONSIBLE FOR DETERMINING QUANTITIES AND SHALL STATE SUCH QUANTITIES IN HIS PROPOSAL. HE SHALL BASE HIS BID ON HIS OWN ESTIMATE OF THE WORK REQUIRED AND SHALL NOT RELY ON ANY ESTIMATE PROVIDED BY ENGINEER.
- 5. THE CONTRACTOR IS RESPONSIBLE FOR VERIFYING SOIL CONDITIONS PRIOR TO COMMENCEMENT OF CONSTRUCTION. A GEOTECHNICAL REPORT MAY BE AVAILABLE FROM THE OWNER. THE CONTRACTOR SHALL ABIDE BY THE RECOMMENDATIONS OF THE TESTING AGENCY.
- 6. THE CONTRACTOR IS RESPONSIBLE FOR EXAMINING ALL SITE CONDITIONS PRIOR TO COMMENCEMENT OF CONSTRUCTION AND SHALL COMPARE FIELD CONDITIONS WITH DRAWINGS.

- 7. THE CONTRACTOR SHALL NOTIFY ENGINEER OF ANY DISCREPANCIES FOR POSSIBLE REDESIGN.
- 8. THE CONTRACTOR SHALL OBTAIN AND PAY FOR ALL PERMITS REQUIRED FOR EXECUTION OF THE WORK. THE CONTRACTOR SHALL CONDUCT HIS WORK ACCORDING TO THE REQUIREMENTS OF THE PERMITS.
- 9. THE CONTRACTOR IS RESPONSIBLE FOR FIELD VERIFYING ALL UTILITY INFORMATION SHOWN ON THE PLANS PRIOR TO THE START OF CONSTRUCTION. THE CONTRACTOR SHALL CALL DIGGER'S HOTLINE AT 1-800-242-8511 TO NOTIFY THE UTILITIES OF HIS INTENTIONS, AND TO REQUEST FIELD STAKING OF EXISTING UTILITIES.
- 10. CONTRACTOR IS ADVISED THAT ALL MUD AND DEBRIS MUST NOT BE DEPOSITED ONTO THE ADJACENT ROADWAYS PER THE REQUIREMENT OF THE MUNICIPALITY OR OTHER APPROPRIATE GOVERNMENT AGENCIES.
- 11. ANY ADJACENT PROPERTIES OR ROAD RIGHT-OF-WAYS WHICH ARE DAMAGED DURING CONSTRUCTION MUST BE RESTORED BY THE CONTRACTOR. THE COST OF THE RESTORATION IS CONSIDERED INCIDENTAL, AND SHOULD BE INCLUDED IN THE BID PRICES.
- 12. CONTRACTOR SHALL REFER TO ARCHITECTURAL PLANS FOR EXACT LOCATION AND DIMENSION OF ENTRANCES, VESTIBULES, STAIRS, RETAINING WALLS, RAMPS, PRECISE BUILDING DIMENSIONS AND EXACT BUILDING UTILITY ENTRANCE LOCATIONS

# ADDITIONAL NOTES:

1. BEFORE PROCEEDING WITH ANY UTILITY CONSTRUCTION, THE CONTRACTOR SHALL EXCAVATE EACH EXISTING LATERAL OR POINT OF CONNECTION AND VERIFY THE LOCATION, ELEVATION, AND CONDITION OF ALL UTILITIES. THIS MAY REQUIRE TELEVISING AND/OR DYE TESTING EXISTING LINES TO VERIFY THE INTEGRITY AND CONNECTIVITY OF ANY LINE (CONDITION TO BE DETERMINED BY CITY OF MADISON). IF ANY EXISTING UTILITIES ARE NOT AS SHOWN ON THE DRAWINGS, THE CONTRACTOR SHALL NOTIFY THE ENGINEER IMMEDIATELY FOR POSSIBLE REDESIGN. COST FOR THE VERIFICATION OF EXISTING UTILITY CONNECTIONS IS CONSIDERED INCIDENTAL AND SHALL BE INCLUDED IN THE BID PRICES.

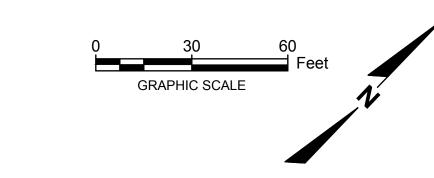

LEGEND

LIMITS OF WORK (36,793 SF / 0.84 AC)

GRAVEL REMOVAL



ASPHALT REMOVAL




STORM SEWER INLET PROTECTION

Parks Utility Inventory may not be complete, current or accurate. The City makes no representation about the accuracy of these records and shall not be liable for any damages. Call Diggers Hotline (811) & Parks Div. (266-4711) before digging, driving stakes,

#### DEMOLITION PLAN NOTES

- 1. PRIOR TO DEMOLITION OCCURRING, ALL EROSION CONTROL DEVICES ARE TO BE INSTALLED.
- 2. THE CONTRACTOR IS RESPONSIBLE FOR THE DEMOLITION, REMOVAL, AND DISPOSING IN A LOCATION APPROVED BY ALL GOVERNING AUTHORITIES, OF ALL STRUCTURES, PADS, WALLS, FOUNDATIONS, PARKING, DRIVES, UTILITIES, ETC., SUCH THAT THE IMPROVEMENTS SHOWN ON THE REMAINING PLANS CAN BE CONSTRUCTED. ALL FACILITIES TO BE REMOVED SHALL BE UNDERCUT TO SUITABLE MATERIAL AND BROUGHT TO GRADE WITH SUITABLE COMPACTED FILL MATERIAL PER RECOMMENDATIONS OF THE TESTING AGENCY.
- 3. THE CONTRACTOR IS RESPONSIBLE FOR REMOVING ALL DEBRIS FROM THE SITE AND DISPOSING THE DEBRIS IN A LAWFUL MANNER. THE CONTRACTOR IS RESPONSIBLE FOR OBTAINING ALL PERMITS REQUIRED FOR DEMOLITION AND DISPOSAL.
- 4. THE CONTRACTOR SHALL COORDINATE WITH RESPECTIVE UTILITY COMPANIES PRIOR TO THE REMOVAL AND/OR RELOCATION OF UTILITIES, IF REQUIRED. THE CONTRACTOR SHALL COORDINATE WITH THE UTILITY COMPANY CONCERNING PORTIONS OF WORK WHICH MAY BE PERFORMED BY THE UTILITY COMPANY'S FORCES AND ANY FEES WHICH ARE TO BE PAID TO THE UTILITY COMPANY FOR THEIR SERVICES. THE CONTRACTOR IS RESPONSIBLE FOR PAYING ALL FEES AND CHARGES.
- 5. THE LOCATIONS OF ALL EXISTING UTILITIES SHOWN ON THIS PLAN HAVE BEEN DETERMINED FROM THE BEST INFORMATION AVAILABLE AND ARE GIVEN FOR THE CONVENIENCE OF THE CONTRACTOR. THE ENGINEER ASSUMES NO RESPONSIBILITY FOR THEIR ACCURACY. PRIOR TO THE START OF ANY DEMOLITION ACTIVITY, THE CONTRACTOR SHALL NOTIFY THE UTILITY COMPANIES FOR ONSITE LOCATIONS OF EXISTING UTILITIES.
- 6. ALL EXISTING SEWERS, PIPING AND UTILITIES SHOWN ARE NOT TO BE INTERPRETED AS THE EXACT LOCATION, OR AS THE ONLY OBSTACLES THAT MAY OCCUR ON THE SITE. VERIFY EXISTING CONDITIONS AND PROCEED WITH CAUTION AROUND ANY ANTICIPATED FEATURES. GIVE NOTICE TO ALL UTILITY COMPANIES REGARDING DESTRUCTION AND REMOVAL OF ALL SERVICE LINES AND CAP ALL LINES (IF ALLOWED—CHECK WITH LOCAL UTILITY) BEFORE PROCEEDING WITH THE WORK AS APPLICABLE. UTILITIES DETERMINED TO BE ABANDONED AND LEFT IN PLACE SHALL BE GROUTED IF UNDER BUILDING (COORDINATE WITH TESTING AGENCY).
- 7. ELECTRICAL, TELEPHONE, CABLE, WATER, FIBER OPTIC CABLE AND/OR GAS LINES NEEDING TO BE REMOVED OR RELOCATED, IF REQUIRED, SHALL BE COORDINATED WITH THE AFFECTED UTILITY COMPANY. ADEQUATE TIME SHALL BE PROVIDED FOR RELOCATION AND CLOSE COORDINATION WITH THE UTILITY COMPANY IS NECESSARY TO PROVIDE A SMOOTH TRANSITION IN UTILITY SERVICE.
- 8. CONTRACTOR MUST PROTECT THE PUBLIC AT ALL TIMES WITH FENCING, BARRICADES, ENCLOSURES, ETC. CONTINUOUS ACCESS SHALL BE MAINTAINED AT ALL TIMES DURING DEMOLITION OF THE EXISTING FACILITIES. CONTRACTOR SHALL MAINTAIN ALL EXISTING PARKING, SIDEWALKS, DRIVES, ETC. CLEAR AND FREE FROM ANY CONSTRUCTION ACTIVITY AND/OR MATERIAL TO ENSURE EASY AND SAFE PEDESTRIAN AND VEHICULAR TRAFFIC.
- 9. DAMAGE TO ALL EXISTING CONDITIONS TO REMAIN WILL BE REPLACED AT CONTRACTOR'S EXPENSE.
- 10. CONTRACTOR MAY LIMIT SAW—CUT & PAVEMENT REMOVAL OR ARTIFICIAL TURF REMOVAL TO ONLY THOSE AREAS WHERE IT IS REQUIRED AS SHOWN ON THESE CONSTRUCTION PLANS BUT IF ANY DAMAGE IS INCURRED ON ANY OF THE SURROUNDING PAVEMENT, TURF, ETC. THE CONTRACTOR SHALL BE RESPONSIBLE FOR ITS REMOVAL AND REPAIR. CONTRACTOR SHOULD ALSO NOTE THAT IT MAY BE NECESSARY THAT ADDITIONAL PAVEMENT OR TURF REMOVAL IS REQUIRED TO FACILITATE INSTALLATION OF PROPOSED IMPROVEMENTS, TO PROMOTE PROPER DRAINAGE, AND/OR TO PROVIDE A SMOOTH TRANSITION BETWEEN EXISTING AND PROPOSED CONDITIONS, TO MEET ADA COMPLIANCE (SEE GRADING PLAN) OR TO PROVIDE A MORE UNIFORM LOOK TO THE AFFECTED AREA. THE COST OF THIS ADDITIONAL PAVEMENT OR TURF REMOVAL IS CONSIDERED INCIDENTAL, AND SHALL BE INCLUDED IN THE BID PRICES.

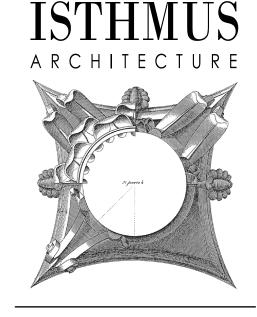

rasmith

CREATIVITY BEYOND ENGINEERING

5250 E. Terrace Dr., Ste. 108

Madison, WI 53718-8345

(608) 467-3034

rasmith.com

Project Number:1160426

EVEN FOR TON CONSTRUCTION

DEMOLITION PLAN

Phase 3 Improvements
BREESE STEVENS FIEL
917 East Mifflin Street
Madison, WI 53703

Proj. No.: 1617.03

Scale: 1"=30'

Drawn By: RJH


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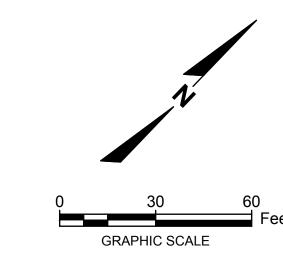
Rev. Date:



R.A.SMITH, INC. ASSUMES NO RESPONSIBILITY FOR DAMAGES, LIABILITY OR COSTS RESULTING FROM CHANGES OR ALTERATIONS MADE TO THIS PLAN WITHOUT THE EXPRESSED WRITTEN CONSENT OF R.A.SMITH, INC.

C100



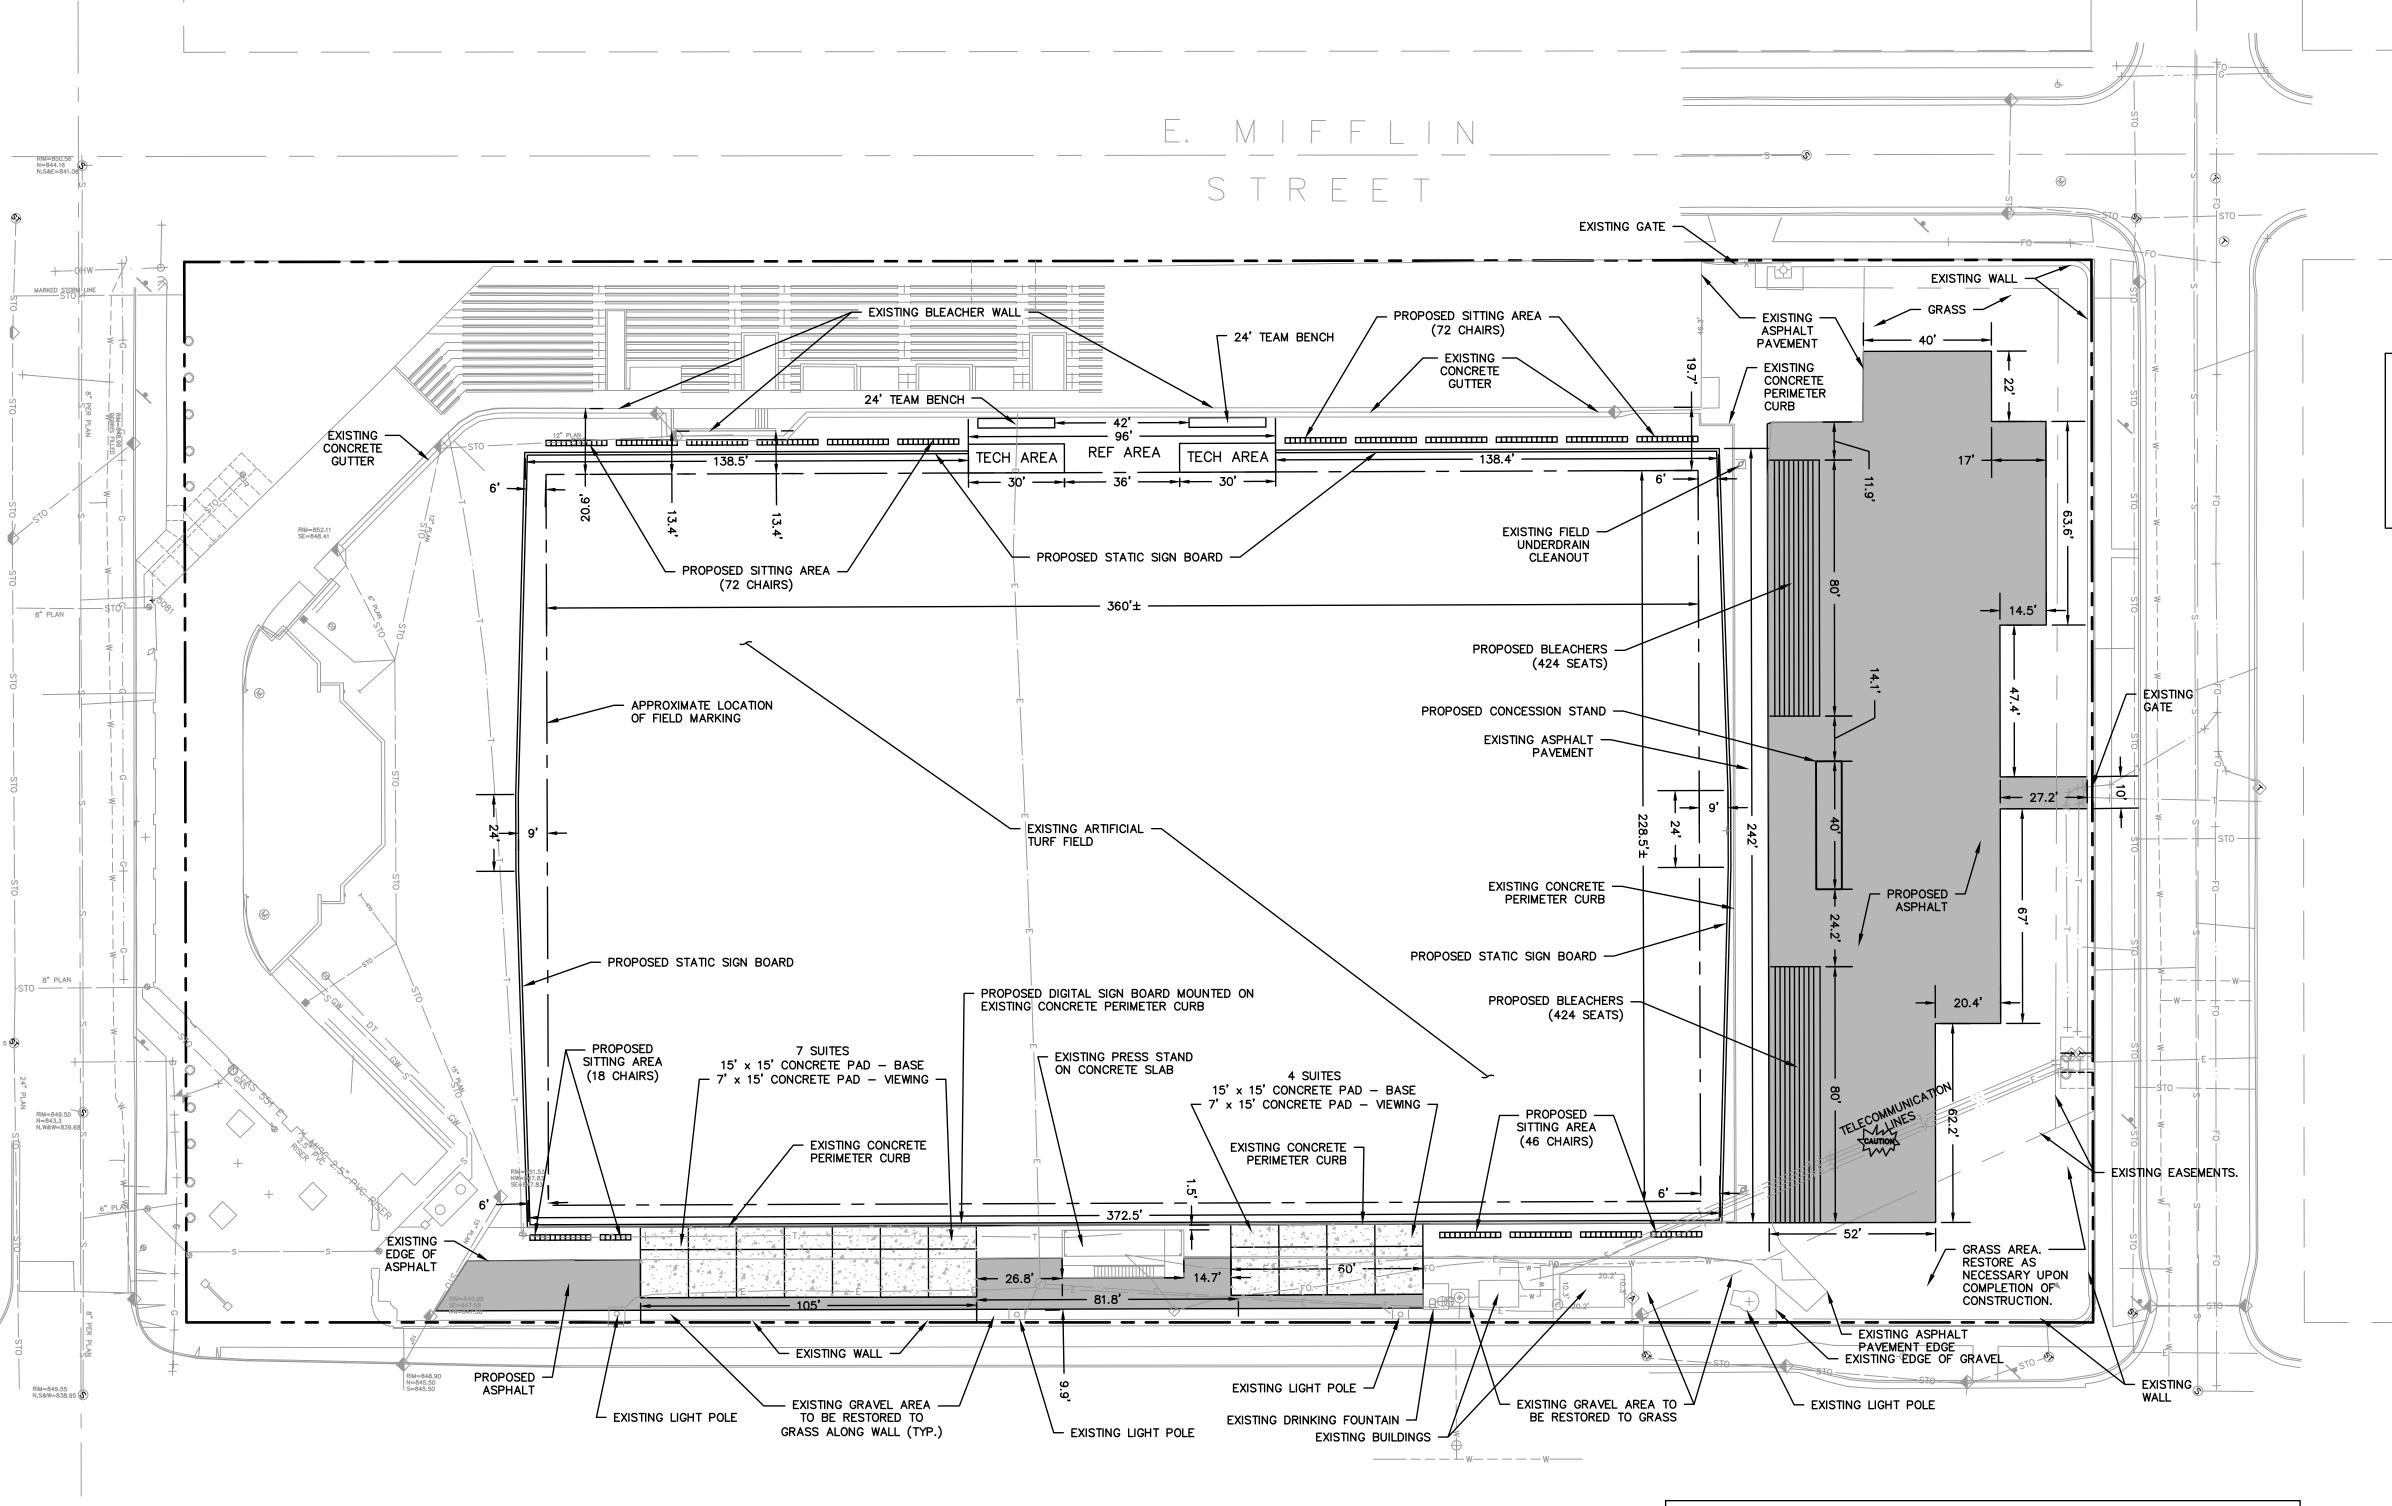


## LEGEND

PROPERTY LINE PROPOSED ASPHALT PAVEMENT

PROPOSED CONCRETE PAVEMENT

NOTE: REFER TO ARCHITECTURAL PLANS (AND OTHER APPLICABLE PLANS) FOR ALL FIXTURING AND SITE AMENITIES INCLUDING BUT NOT LIMITED TO:

- SEATS IN DESIGNATED SITTING AREAS AND TEAM BENCHES
- TECH AND REF AREAS
- SUITE FINISHES
- STATIC SIGN BOARDS AND MOUNTING DETAILS
   DIGITAL SIGN BOARD AND MOUNTING DETAILS
- BLEACHERS
- CONCESSION STAND (EAST END)

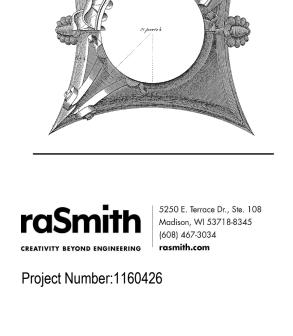



SITE PLAN

Proj. No.:	1617.03
Scale:	1"=30'
Drawn By:	RJH
Date:	10/30/2018
Rev. Date:	

ASPHALTIC MATERIALS SHALL BE PERFORMANCE GRADED (PG) BINDERS IN ACCORDANCE WITH SECTION 455 OF THE STANDARD SPECIFICATIONS AND PER RECOMMENDATIONS OF THE TESTING AGENCY OR PER CITY OF MADISON REQUIREMENTS THE MORE STRINGENT OF THE TWO SHALL APPLY.

- AGGREGATES USED IN THE HMA SHALL BE IN ACCORDANCE WITH SUBSECTION 460.2.2.3 OF THE STANDARD SPECIFICATIONS. THE NOMINAL AGGREGATE SIZE FOR THE PAVEMENT SHALL BE PER RECOMMENDATIONS OF THE TESTING AGENCY OR PER CITY OF MADISON REQUIREMENTS THE MORE STRINGENT OF THE TWO SHALL APPLY.
- 7. TACK COAT SHALL BE IN ACCORDANCE WITH SUBSECTION 455.2.5 OF THE STANDARD SPECIFICATIONS.
- 8. CONCRETE CONSTRUCTION FOR WALKS AND NON-FLOOR SLABS SHALL BE IN ACCORDANCE WITH THE FOLLOWING SECTIONS OF THE STANDARD SPECIFICATIONS: SECTION 415 FOR CONCRETE PAVEMENT AND SECTION 602 FOR CONCRETE SIDEWALKS, RECOMMENDATIONS OF THE TESTING AGENCY, OR PER CITY OF MADISON REQUIREMENTS THE MORE STRINGENT OF THE TWO SHALL APPLY. AT A MINIMUM ALL CONCRETE PAVEMENT SHALL BE REPLACED IN KIND. IF ADDITIONAL MATERIAL IS REQUIRED BY MUNICIPALITY OR AS DETERMINED BY GEOTECHNICAL ENGINEER, THESE COSTS SHALL BE CONSIDERED INCIDENTAL TO BID AND SHALL BE INCLUDED IN BID PRICE.
- 9. ALL FINISHED CONCRETE SHALL BE COVERED WITH A LIQUID CURING COMPOUND CONFORMING TO AASHTO M 148, TYPE 2, IN ACCORDANCE WITH SECTION 415 OF THE STANDARD SPECIFICATIONS.
- 10. CONTRACTOR SHALL DETERMINE LOCATION OF ALL CONSTRUCTION AND EXPANSION JOINTS AS APPLICABLE.
- 11. PAVEMENT MARKINGS SHALL BE IN ACCORDANCE WITH SECTION 646 OF THE STANDARD SPECIFICATIONS OR PER CITY OF MADISON REQUIREMENTS THE MORE STRINGENT OF THE TWO SHALL APPLY.

R.A.SMITH, INC. ASSUMES NO RESPONSIBILITY FOR DAMAGES, LIABILITY OR COSTS RESULTING FROM CHANGES OR ALTERATIONS MADE TO THIS PLAN WITHOUT THE EXPRESSED WRITTEN CONSENT OF R.A.SMITH, INC.

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- 8. THE CONTRACTOR SHALL OBTAIN AND PAY FOR ALL PERMITS REQUIRED FOR EXECUTION OF THE WORK. THE CONTRACTOR SHALL CONDUCT HIS WORK ACCORDING TO THE REQUIREMENTS OF THE PERMITS.
- 9. THE CONTRACTOR IS RESPONSIBLE FOR FIELD VERIFYING ALL UTILITY INFORMATION SHOWN ON THE PLANS PRIOR TO THE START OF CONSTRUCTION. THE CONTRACTOR SHALL CALL DIGGER'S HOTLINE AT 1-800-242-8511 TO NOTIFY THE UTILITIES OF HIS INTENTIONS, AND TO REQUEST FIELD STAKING OF EXISTING UTILITIES.
- 10. CONTRACTOR IS ADVISED THAT ALL MUD AND DEBRIS MUST NOT BE DEPOSITED ONTO THE ADJACENT ROADWAYS PER THE REQUIREMENT OF THE MUNICIPALITY OR OTHER APPROPRIATE GOVERNMENT AGENCIES.
- 11. ANY ADJACENT PROPERTIES OR ROAD RIGHT-OF-WAYS WHICH ARE DAMAGED DURING CONSTRUCTION MUST BE RESTORED BY THE CONTRACTOR. THE COST OF THE RESTORATION IS CONSIDERED INCIDENTAL, AND SHOULD BE INCLUDED IN THE BID PRICES.
- 12. CONTRACTOR SHALL REFER TO ARCHITECTURAL PLANS FOR EXACT LOCATION AND DIMENSION OF ENTRANCES, VESTIBULES, STAIRS, RETAINING WALLS, RAMPS, PRECISE BUILDING DIMENSIONS AND EXACT BUILDING UTILITY ENTRANCE

PROVIDED BY THE CONTRACTOR.


NOTE: DEFER ALL PAVING QUESTIONS OR SUBMITTALS TO THE TESTING AGENCY THE PROPOSED IMPROVEMENTS SHALL BE CONSTRUCTED ACCORDING TO THE WISCONSIN D.O.T. STANDARD

ORDINANCES AND SPECIFICATIONS THE MORE STRINGENT OF THE TWO SHALL APPLY. 2. PAVING SHALL CONSIST OF FINE GRADING PAVEMENT AREAS, INSTALLATION OF CRUSHED STONE BASE, CONCRETE AND/OR BITUMINOUS PAVEMENT, PAVEMENT MARKING, AND CLEANUP. ALL MATERIALS SHALL BE

SPECIFICATIONS FOR HIGHWAY AND STRUCTURE CONSTRUCTION, LATEST EDITION, AND CITY OF MADISON

- AGGREGATES USED IN THE CRUSHED AGGREGATE BASE SHALL BE PER RECOMMENDATIONS OF GEOTECHNICAL ENGINEER OR PER CITY OF MADISON REQUIREMENTS THE MORE STRINGENT OF THE TWO SHALL APPLY. AT A MINIMUM ALL AGGREGATE BASE SHALL BE REPLACED IN KIND. IF ADDITIONAL MATERIAL IS REQUIRED BY MUNICIPALITY OR AS DETERMINED BY GEOTECHNICAL ENGINEER, THESE COSTS SHALL BE CONSIDERED INCIDENTAL TO BID AND SHALL BE INCLUDED IN BID PRICE.
- HOT MIX ASPHALT PAVEMENT (HMA) SHALL BE PER RECOMMENDATIONS OF GEOTECHNICAL ENGINEER OR PER CITY OF MADISON REQUIREMENTS THE MORE STRINGENT OF THE TWO SHALL APPLY. AT A MINIMUM ALL ASPHALT PAVEMENT SHALL BE REPLACED IN KIND. IF ADDITIONAL MATERIAL IS REQUIRED BY MUNICIPALITY OR AS DETERMINED BY GEOTECHNICAL ENGINEER, THESE COSTS SHALL BE CONSIDERED INCIDENTAL TO BID AND SHALL BE INCLUDED IN BID PRICE.

Milwaukee Area (414) 259-118 Hearing Impaired TDD (800) 542-2289 www.Diggeral-lottine.com

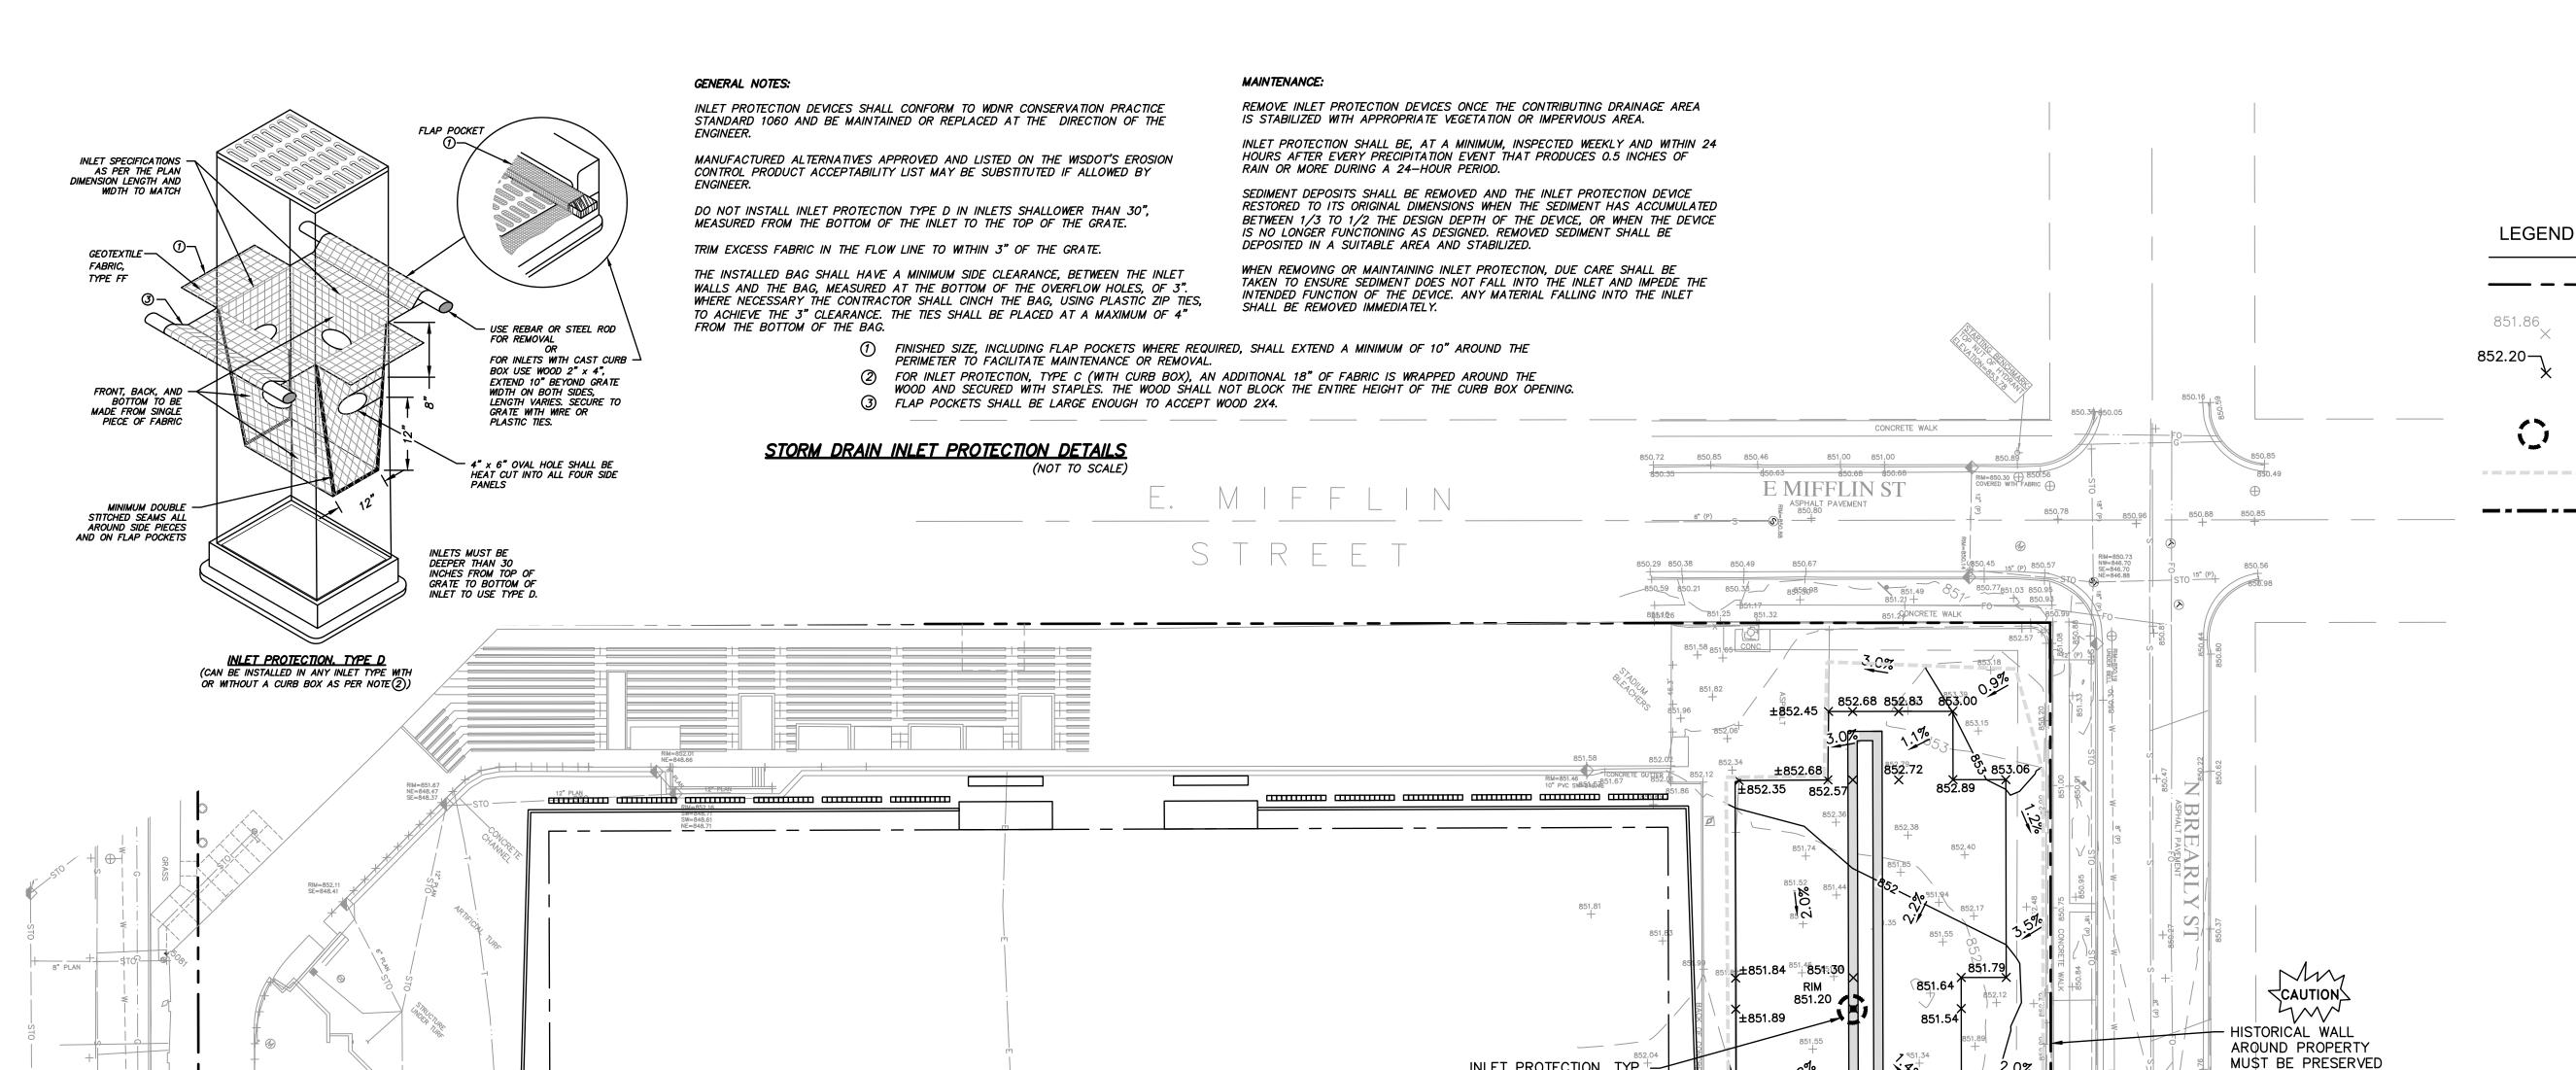

**GRAPHIC SCALE** 

LEGEND

----- PROPERTY LINE EXISTING SPOT GRADE 851.86

> PROPOSED SPOT GRADE MATCH = TIE INTO EXISTING GRADE CONTRACTOR TO VERIFY

PROPOSED INLET PROTECTION

PROPOSED LIMITS OF DISTURBANCE

PROPOSED TEMPORARY EROSION CONTROL EELS

5250 E. Terrace Dr., Ste. 108 rasmith Madison, WI 53718-8345 (608) 467-3034 CREATIVITY BEYOND ENGINEERING rasmith.com

Project Number: 1160426

**GRADING AND EROSION CONTROL PLAN** 

FIEL

36,793± SF

ESTIMATED TOTAL LIMITS OF DISTURBANCE

ADDITIONAL IMPERVIOUS AREA AFTER IMPROVEMENTS 16,369± SF

1617.03 Scale: 1"=30' Drawn By: 10/30/2018 Date:

Rev. Date:

Hearing Impaired TDD (800) 542-2289

R.A.SMITH, INC. ASSUMES NO RESPONSIBILITY FOR DAMAGES, LIABILITY OR COSTS RESULTING FROM CHANGES OR ALTERATIONS MADE TO THIS PLAN WITHOUT THE EXPRESSED WRITTEN CONSENT OF R.A.SMITH, INC.

# GRADING AND EROSION CONTROL

acksim INLET PROTECTION, TYP.

E WASHINGTON AVE

(A.K.A. STH "151")

1. THE PROPOSED IMPROVEMENTS SHALL BE CONSTRUCTED ACCORDING TO THE WISCONSIN D.O.T. STANDARD SPECIFICATIONS FOR HIGHWAY AND STRUCTURE CONSTRUCTION, LATEST EDITION, LOCAL ORDINANCES AND SPECIFICATIONS, AND RECOMMENDATIONS OF THE TESTING AGENCY - REFER TO SECTION 014000 OF THE PROJECT SPECIFICATIONS.

- PROPOSED TEMPORARY EROSION "EELS", REQUIRED DURING REMOVAL OF ASPHALT AREAS AND CONCRETE INSTALLATION; DO NOT STAKE IN THE

CAUTION

ARTIFICIAL TURF FIELD

- 2. THE CONTRACTOR SHALL MAINTAIN SITE DRAINAGE THROUGHOUT CONSTRUCTION. THIS MAY INCLUDE THE EXCAVATION OF TEMPORARY DITCHES OR PUMPING TO ALLEVIATE WATER PONDING.
- 3. THE CONTRACTOR IS RESPONSIBLE FOR OBTAINING ALL PERMITS, INCLUDING BUT NOT LIMITED TO R/W PERMIT AND EROSION CONTROL PERMITS. CONTRACTOR IS RESPONSIBLE FOR ABIDING BY ALL PERMIT REQUIREMENTS AND RESTRICTIONS.
- 4. ANY SEDIMENT TRACKED ONTO A PUBLIC OR PRIVATE ROAD SHOULD BE REMOVED BY STREET CLEANING, NOT FLUSHING, BEFORE THE END OF EACH WORKING DAY.
- 5. DUST CONTROL SHALL BE PROVIDED AS NECESSARY IN ACCORDANCE WITH WDNR TECHNICAL STANDARD 1068.
- 6. THE CONTRACTOR IS RESPONSIBLE FOR INSTALLATION OF ANY ADDITIONAL EROSION CONTROL MEASURES NECESSARY TO PREVENT EROSION AND SEDIMENTATION. ALL DISTURBED AREAS ARE TO DRAIN TO APPROVED SEDIMENT CONTROL MEASURES AT ALL TIMES DURING SITE DEVELOPMENT UNTIL FINAL STABILIZATION IS ACHIEVED. DEPENDING ON HOW THE CONTRACTOR GRADES THE SITE. IT MAY BE NECESSARY TO INSTALL TEMPORARY SEDIMENT TRAPS IN VARIOUS LOCATIONS THROUGHOUT THE PROJECT. TEMPORARY SEDIMENT TRAPS SHALL BE DESIGNED, INSTALLED, AND MAINTAINED IN ACCORDANCE WITH WDNR TECHNICAL STANDARD 1063.
- 7. SILT FENCE AND OTHER EROSION CONTROL FACILITIES MUST BE INSTALLED PRIOR TO CONSTRUCTION OR ANY OTHER LAND DISTURBING ACTIVITY. THE CONTRACTOR SHALL BE RESPONSIBLE FOR REMOVING ALL EROSION CONTROL FACILITIES ONCE THE

THREAT OF EROSION HAS PASSED WITH THE APPROVAL OF THE GOVERNING AGENCY. <u>PLACE SILT FENCE AT PERIMETER OF</u> CONSTRUCTION IN ALL DOWNSTREAM AREAS. THE PROJECT IS PRIMARILY LOCATED IN PAVEMENT — THE USE OF EROSION EELS™ AND/OR GUTTER EELS™ (OR EQUIVALENT) IN LIEU OF SILT FENCE IS ALLOWED IF ACCEPTABLE TO CITY OF MADISON.

INLET PROTECTION, TYP.

852.18

851.90 +

TELECOMMUNICATION -

CAUTION LINES TO REMAIN

INLET PROTECTION, TYP.

INSTALL PER MANUFACTURER'S RECOMMENDATIONS.

INLET PROTECTION, TYP.

851,87

851.35

E WASHINGTON AVE

(A.K.A. STH "151"


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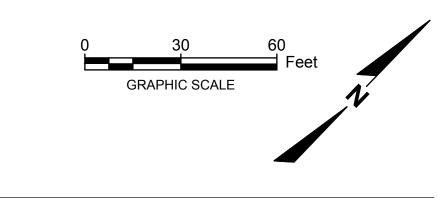
- 8. ALL INSTALLATION AND MAINTENANCE OF EROSION CONTROL PRACTICES SHALL BE IN ACCORDANCE WITH APPLICABLE WDNR TECHINCAL STANDARDS AND CITY OF MADISON REQUIREMENTS.
- 9. ALL EROSION AND SEDIMENTATION CONTROL PRACTICES SHALL BE INSPECTED WEEKLY AND WITHIN 24 HOURS AFTER EVERY PRECIPITATION EVENT THAT PRODUCES 0.5 INCHES OF RAIN OR MORE DURING A 24 HOUR PERIOD. NEEDED REPAIRS WILL BE MADE IMMEDIATELY.
- 10. ALL WATER FROM CONSTRUCTION DEWATERING SHALL BE TREATED IN ACCORDANCE WITH WDNR TECHNICAL STANDARD 1061 PRIOR TO DISCHARGE TO WATERS OF THE STATE, WETLANDS, OR OFFSITE. CONTRACTOR SHALL PREPARE AND SUBMIT DEWATERING PLAN TO MUNICIPALITY AND WONR AS REQUIRED.
- 11. CONTRACTOR OR ITS SUBCONTRACTORS WILL BE RESPONSIBLE FOR REMOVING SEDIMENT IN THE STORM SEWER DRAINAGE SYSTEMS DEPOSITED PRIOR TO STABILIZATION OF THE SITE.
- 12. SOIL STOCKPILE (AND BORROW AREAS IF APPLICABLE) SHALL BE PROTECTED FROM EROSION AND SEDIMENTATION THROUGH IMPLEMENTATION OF BEST MANAGEMENT PRACTICES.
- 13. THE CONTRACTOR SHALL ASSUME SOLE RESPONSIBILITY FOR THE COMPUTATIONS OF ALL GRADING AND FOR ACTUAL LAND BALANCE, INCLUDING UTILITY TRENCH SPOIL. THE CONTRACTOR SHALL IMPORT OR EXPORT MATERIAL AS NECESSARY TO COMPLETE THE PROJECT.

- 14. GRADING SHALL CONSIST OF REMOVAL OF EXISTING PAVEMENT, FOUNDATIONS, OR UNSUITABLE FILL (AS DETERMINED BY TESTING AGENCY), IMPORTING OR EXPORTING MATERIAL TO ACHIEVE AND ON-SITE EARTHWORK BALANCE, GRADING THE PROPOSED PAVEMENT AREAS, SCARIFYING AND FINAL COMPACTION OF THE PAVEMENT SUBGRADE.
- 15. NO FILL SHALL BE PLACED ON A WET OR SOFT SUBGRADE. THE SUBGRADE SHALL BE PROOF—ROLLED AND INSPECTED BY THE TESTING AGENCY BEFORE ANY MATERIAL IS PLACED.
- 16. ALL FILL SHALL BE CONSIDERED STRUCTURAL FILL (AS DETERMINED BY THE TESTING AGENCY) AND SHALL BE PLACED IN ACCORDANCE WITH THE RECOMMENDATIONS OF THE TESTING AGENCY.

17. CONTRACTOR MAY LIMIT SAW-CUT & PAVEMENT REMOVAL TO ONLY THOSE AREAS WHERE IT IS REQUIRED AS SHOWN ON

THESE CONSTRUCTION PLANS BUT IF ANY DAMAGE IS INCURRED ON ANY OF THE SURROUNDING PAVEMENT, ETC. THE CONTRACTOR SHALL BE RESPONSIBLE FOR IT'S REMOVAL AND REPAIR. CONTRACTOR SHOULD ALSO NOTE THAT IT MAY BE NECESSARY THAT ADDITIONAL PAVEMENT IS REQUIRED TO FACILITATE INSTALLATION OF PROPOSED IMPROVEMENTS, TO PROMOTE PROPER DRAINAGE, TO MEET EROSION CONTROL REQUIREMENTS, AND/OR TO PROVIDE A SMOOTH TRANSITION BETWEEN EXISTING AND PROPOSED CONDITIONS. THE COST OF THIS ADDITIONAL PAVEMENT REMOVAL IS CONSIDERED INCIDENTAL, AND SHALL BE INCLUDED IN THE BID PRICES.



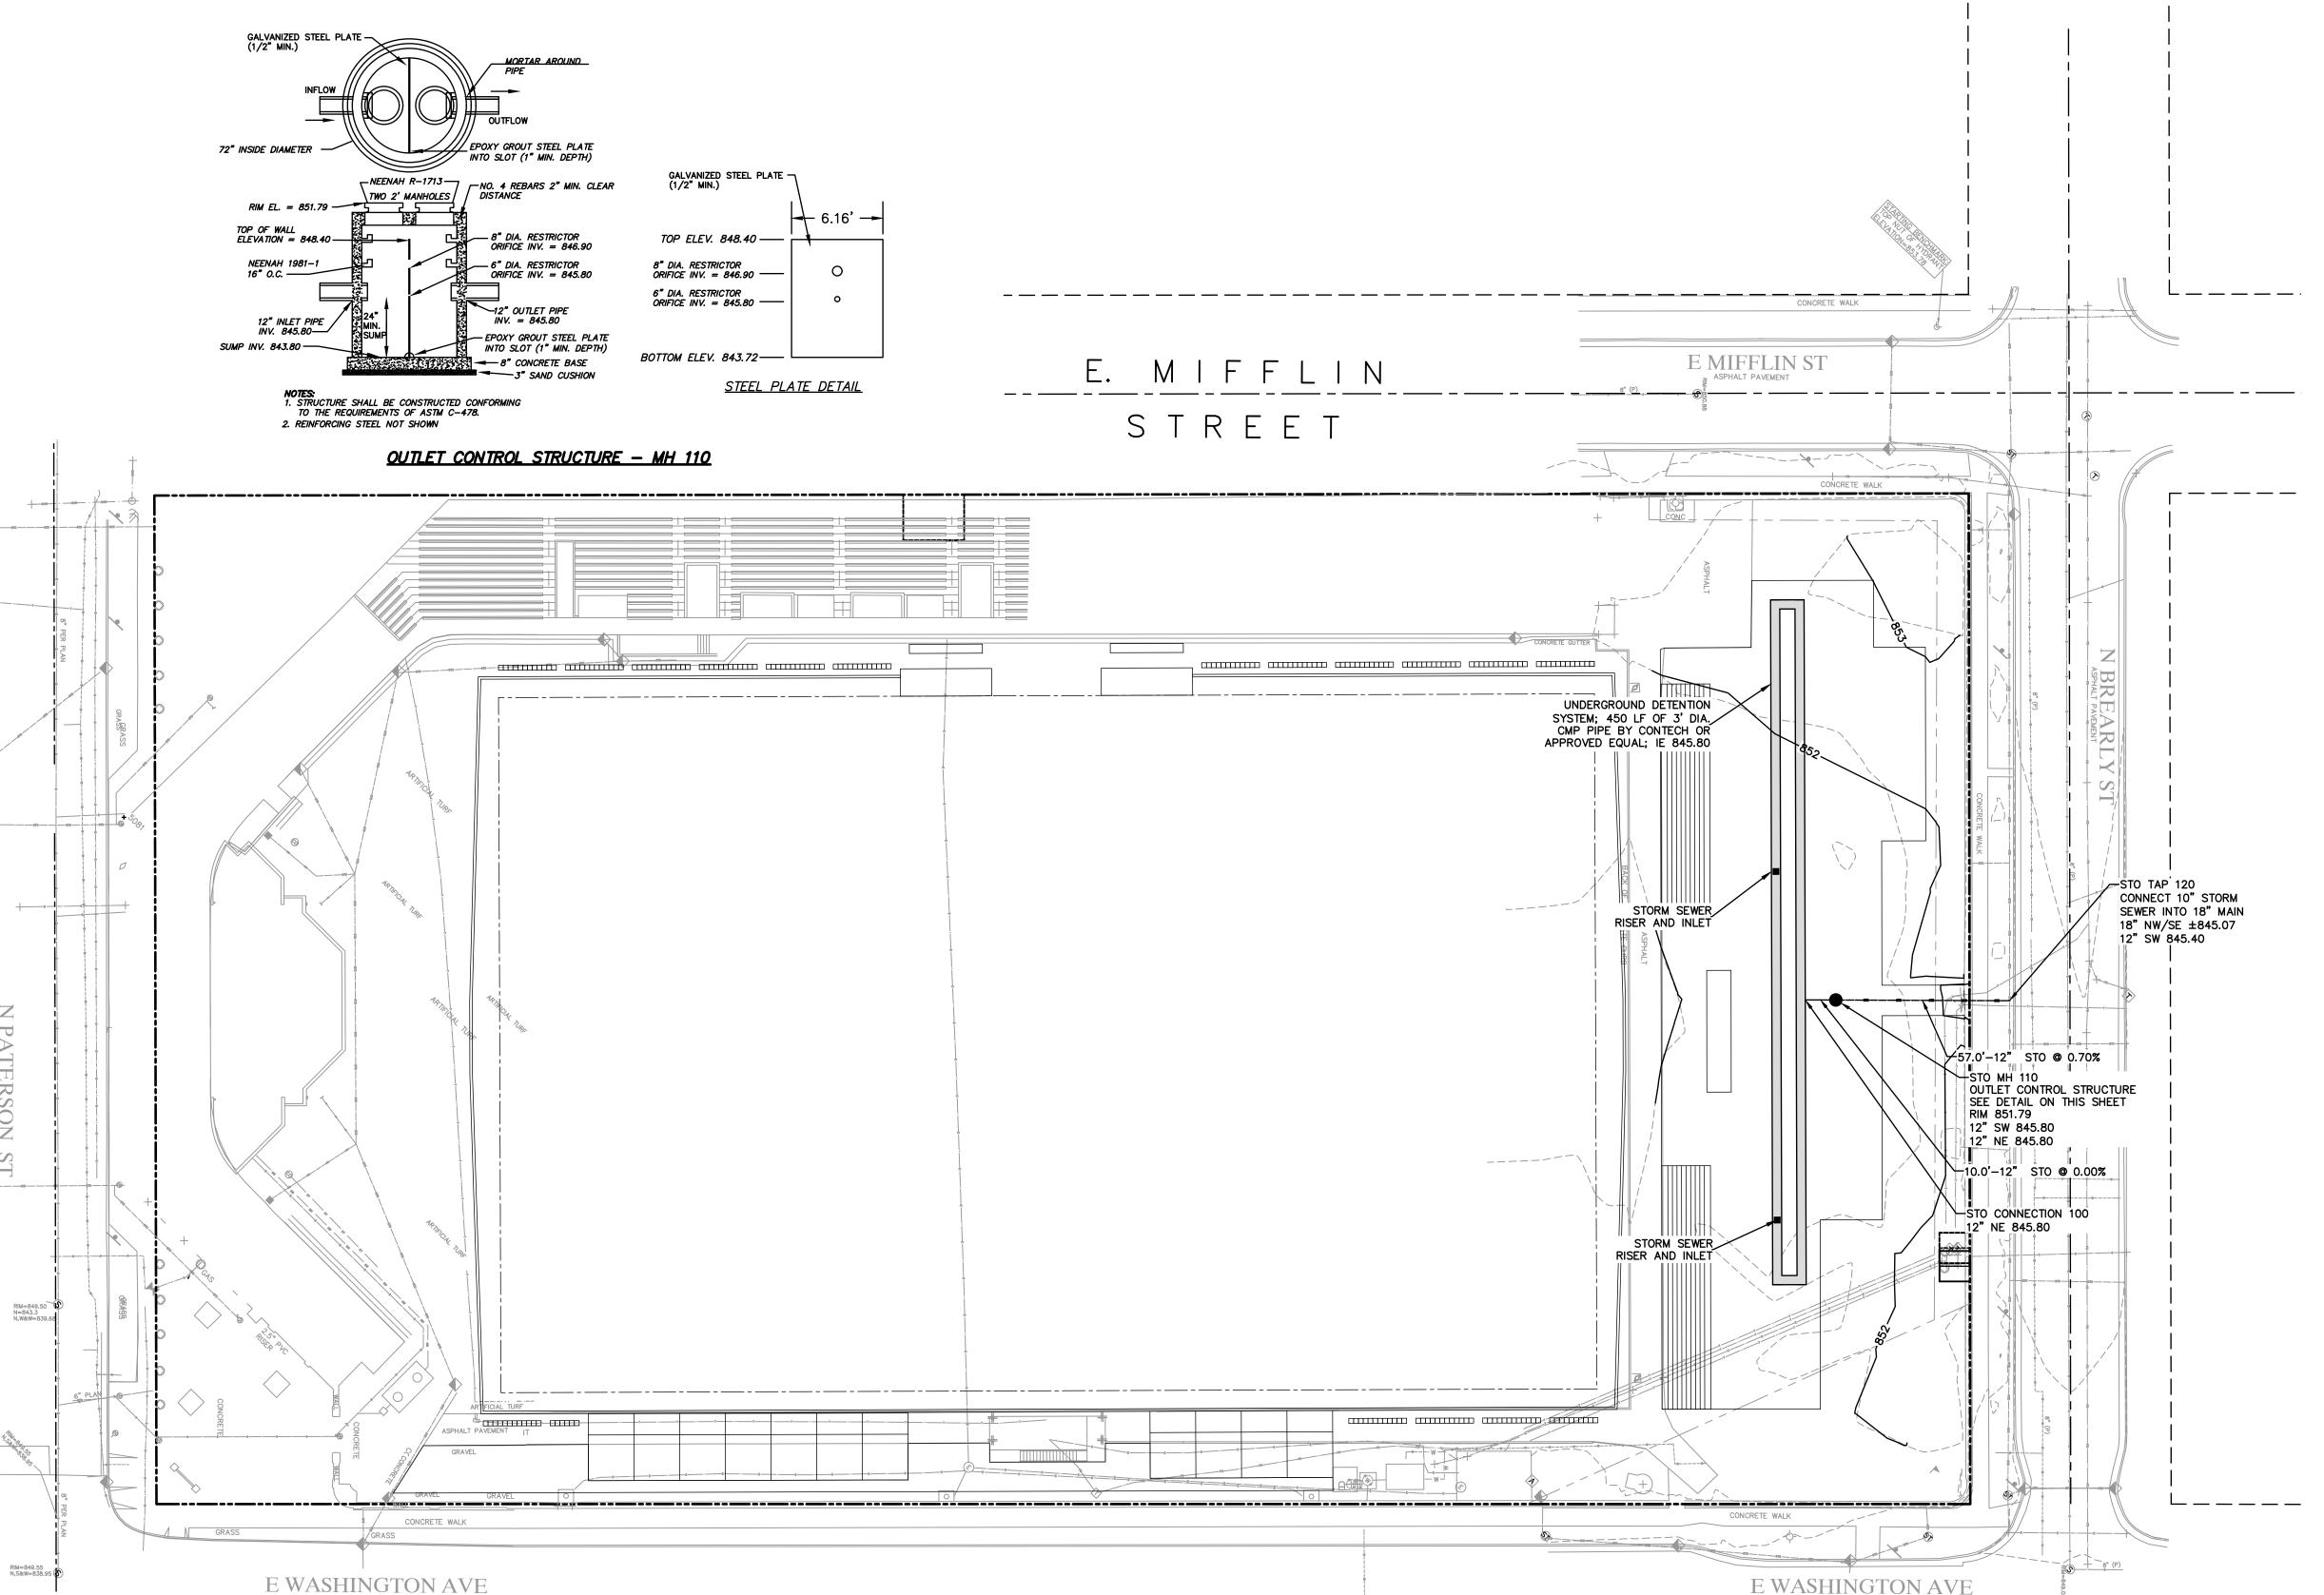

**LEGEND** 

————— PROPERTY LINE

## PRIVATE UTILITIES

- 1. THE PROPOSED IMPROVEMENTS SHALL BE CONSTRUCTED ACCORDING TO CITY OF MADISON PLUMBING CODE, WISCONSIN ADMINISTRATIVE CODE, SECTION SPS 382 AND SPS 384, LATEST EDITION, THE STANDARD SPECIFICATIONS FOR SEWER AND WATER CONSTRUCTION IN WISCONSIN, LATEST EDITION, AND THE CITY OF MADISON SPECIFICATIONS, THE MORE STRINGENT Project Number:1160426 SHALL APPLY.
- BEFORE PROCEEDING WITH ANY UTILITY CONSTRUCTION, THE CONTRACTOR SHALL EXCAVATE EACH EXISTING LATERAL OR POINT OF CONNECTION AND VERIFY THE LOCATION AND ELEVATION OF ALL UTILITIES (SEE DEMOLITION PLAN FOR ADDITIONAL FIELD VERIFICATION REQUIREMENTS). IF ANY EXISTING UTILITIES ARE NOT AS SHOWN ON THE DRAWINGS, THE CONTRACTOR SHALL NOTIFY THE ENGINEER IMMEDIATELY FOR POSSIBLE REDESIGN. SEE DEMOLITION SHEET FOR ADDITIONAL INFORMATION ON EXISTING UTILITY VERIFICATION.
- ALL CONNECTIONS TO EXISTING PIPES AND MANHOLES SHALL BE CORED CONNECTIONS, UNLESS OTHERWISE SPECIFIED BY PLUMBING CODE REQUIERMENTS. CONTRACTOR SHALL BE RESPONSIBLE FOR MEANS AND METHODS TO DETERMINE APPROPRIATE, APPROVABLE CONNECTION BETWEEN DISSIMILAR MATERIAL TYPES.
- 4. MATERIALS FOR STORM SEWER SHALL BE AS FOLLOWS:


UNLESS OTHERWISE REQUIRED BY CITY OF MADISON, STORM SEWER PIPE 24" OR LESS SHALL

- A) HIGH DENSITY POLYETHYLENE (HDPE) CORRUGATED PIPE WITH AN INTEGRALLY FORMED SMOOTH WATERWAY SUCH AS ADS N-12 (WITHIN THE FIELD).
- B) POLYVINYL CHLORIDE (PVC) PIPE, ASTM D-3034, SDR 35, WITH ELASTOMERIC PUSH-ON JOINTS CONFORMING TO ASTM D-3212 (CONNECTIONS TO PUBLIC MAIN OR LATERALS).

TRENCH SECTION SHALL BE CLASS C FOR CONCRETE AND CLASS "B" FOR ALL OTHER MATERIALS. FOR WORK WITHIN THE R/W, SLURRY BACKFILL IS REQUIRED.

INLETS/MANHOLES AND ASSOCIATED CASTINGS SHALL BE BE REPLACED IN KIND.

- 5. EXTREME CAUTION MUST BE FOLLOWED REGARDING THE COMPACTION OF ALL UTILITY TRENCHES. MECHANICALLY COMPACTED GRANULAR BACKFILL IS REQUIRED UNDER & WITHIN 5 FEET OF ALL PAVEMENT INCLUDING SIDEWALKS. FLOODING OF BACKFILL MATERIAL IS NOT ALLOWED. THE COST OF THIS GRANULAR MATERIAL AND ITS COMPACTION IS CONSIDERED INCIDENTAL AND SHALL BE INCLUDED IN THE COST OF THE PROPOSED UTILITY.
- 6. UPON COMPLETION OF FINAL PAVING OPERATIONS, THE UTILITY CONTRACTOR SHALL ADJUST ALL MANHOLE AND INLET RIMS AND VALVE BOXES TO FINISHED GRADE.
- 7. THE CONTRACTOR IS RESPONSIBLE FOR PROVIDING THE OWNER WITH A SET OF MARKED-UP PRINTS SHOWING ALL CHANGE MADE DURING THE CONSTRUCTION PROCESS. ANY CHANGES TO THE DRAWINGS OR ADDITIONAL ITEMS MUST BE REPORTED TO THE OWNER.
- 8. PIPE LENGTH DISTANCES & ELEVATIONS ARE GIVEN TO THE CENTER OF MANHOLES & INLETS.
- 9. WHEN APPLICABLE, CONTRACTOR TO MAINTAIN MINIMUM 18" CLEARANCE WHEN PRIVATE WATER SERVICE CROSSES UNDER SANITARY SEWER, AND 6" MINIMUM UNDER STORM SEWER. PROVIDE 2" INSULATION BETWEEN WATER MAIN AND SEWER CROSSINGS WHERE THE VERTICAL SEPARATION IS LESS THAN 2.0'.

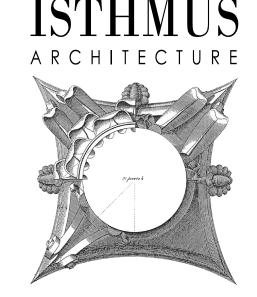

rasmith (A08) 467 3034 (608) 467-3034

UTILITY PLAN

Pha BRE 917

1617.03 Proj. No.: Scale: 1"=30' Drawn By: 10/30/2018 Date: Rev. Date:

**GENERAL** 

(A.K.A. STH "151")

Milwaukee Area (414) 259-118

Hearing Impaired TDD (800) 542-2289

www.Diggeral-lotline.com

R.A.SMITH, INC.

R.A.SMITH, INC. ASSUMES NO RESPONSIBILITY FOR

DAMAGES, LIABILITY OR COSTS RESULTING FROM CHANGES OR ALTERATIONS MADE TO THIS PLAN

WITHOUT THE EXPRESSED WRITTEN CONSENT OF

1. THE CONTRACTOR SHALL NOTIFY THE OWNER AND THE MUNICIPALITY FORTY-EIGHT (48) HOURS PRIOR TO THE START OF CONSTRUCTION.

2. THE CONTRACTOR SHALL INDEMNIFY THE OWNER, THE ENGINEER, AND THE MUNICIPALITY, THEIR AGENTS, ETC, FROM ALL LIABILITY INVOLVED WITH THE CONSTRUCTION, INSTALLATION, AND TESTING OF THE WORK ON THIS PROJECT.

- 3. SITE SAFETY SHALL BE THE SOLE RESPONSIBILITY OF THE CONTRACTOR.
- 4. THE BIDDER WILL BE SOLELY RESPONSIBLE FOR DETERMINING QUANTITIES AND SHALL STATE SUCH QUANTITIES IN HIS PROPOSAL. HE SHALL BASE HIS BID ON HIS OWN ESTIMATE OF THE WORK REQUIRED AND SHALL NOT RELY ON ANY ESTIMATE PROVIDED BY ENGINEER.
- THE CONTRACTOR IS RESPONSIBLE FOR VERIFYING SOIL CONDITIONS PRIOR TO COMMENCEMENT OF CONSTRUCTION. A GEOTECHNICAL REPORT MAY BE AVAILABLE FROM THE OWNER. THE CONTRACTOR SHALL ABIDE BY THE RECOMMENDATIONS OF THE TESTING AGENCY.
- THE CONTRACTOR IS RESPONSIBLE FOR EXAMINING ALL SITE CONDITIONS PRIOR TO COMMENCEMENT OF CONSTRUCTION AND SHALL COMPARE FIELD CONDITIONS WITH DRAWINGS.


- 7. THE CONTRACTOR SHALL NOTIFY ENGINEER OF ANY DISCREPANCIES FOR POSSIBLE REDESIGN.
- 8. THE CONTRACTOR SHALL OBTAIN AND PAY FOR ALL PERMITS REQUIRED FOR EXECUTION OF THE WORK. THE CONTRACTOR SHALL CONDUCT HIS WORK ACCORDING TO THE REQUIREMENTS OF THE PERMITS.
- 9. THE CONTRACTOR IS RESPONSIBLE FOR FIELD VERIFYING ALL UTILITY INFORMATION SHOWN ON THE PLANS PRIOR TO THE START OF CONSTRUCTION. THE CONTRACTOR SHALL CALL DIGGER'S HOTLINE AT 1-800-242-8511 TO NOTIFY THE UTILITIES OF HIS INTENTIONS, AND TO REQUEST FIELD STAKING OF EXISTING UTILITIES.
- 10. CONTRACTOR IS ADVISED THAT ALL MUD AND DEBRIS MUST NOT BE DEPOSITED ONTO THE ADJACENT ROADWAYS PER THE REQUIREMENT OF THE MUNICIPALITY OR OTHER APPROPRIATE GOVERNMENT AGENCIES.
- 11. ANY ADJACENT PROPERTIES OR ROAD RIGHT-OF-WAYS WHICH ARE DAMAGED DURING CONSTRUCTION MUST BE RESTORED BY THE CONTRACTOR. THE COST OF THE RESTORATION IS CONSIDERED INCIDENTAL, AND SHOULD BE INCLUDED IN THE BID PRICES.
- 12. CONTRACTOR SHALL REFER TO ARCHITECTURAL PLANS FOR EXACT LOCATION AND DIMENSION OF ENTRANCES, VESTIBULES, STAIRS, RETAINING WALLS, RAMPS, PRECISE BUILDING DIMENSIONS AND EXACT BUILDING UTILITY ENTRANCE LOCATIONS.

Parks Utility Inventory— may not be complete, current or accurate. The City makes no representation about the accuracy of these records and shall not be liable for any damages. Call Diggers Hotline (811) & Parks Div. (266—4711) before digging, driving stakes,

(A.K.A. STH "151")

SUBMITTALS ARE NOT REQUIRED. IT IS THE CONTRACTOR'S RESPONSIBILITY TO PROVIDE MATERIALS IN ACCORDANCE WITH ALL APPLICABLE CODE REQUIREMENTS AND ASSOCIATED SPECIFICATIONS.


# **TEAM BENCH + SHELTER (2)**

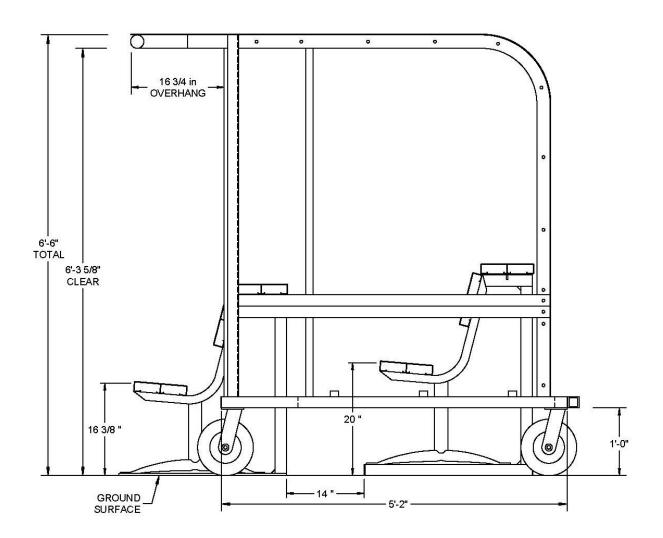

#### SIDE VIEW OF SHELTER

- Placed on field for soccer events ONLY
- NOT visible outside facility

#### **SOCCER FIELD FENCE**

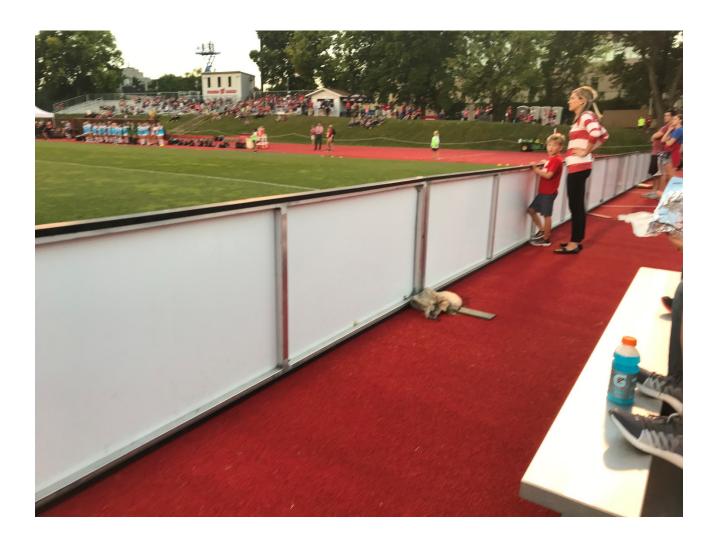

Temporary safety fencing for three (3) sides of field required to separate players from spectators.

- Placed on field for soccer events ONLY
- NOT visible outside facility

#### LED LINEAR DIGITAL SIGNAGE

Located on East Washington sideline of field. Completes the enclosure required to separate players from spectators.




• Installed onto existing concrete curb at edge of artificial turf

Weight: 45 kg

Led: 3 in 1 SMD, 6200 cd max power consumption 750W Refresh rate > 2000Hz

• NOT visible outside facility

## **EVENT TENTS (4)**

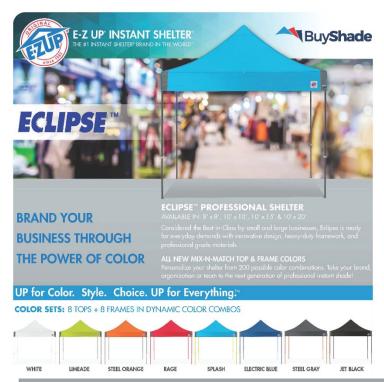



- PARTIALLY VISIBLE outside facility. Approximately 4 feet higher than stone enclosure wall.
- Requires paved surface and site anchors