

CITY OF MADISON ZONING BOARD OF APPEALS

VARIANCE APPLICATION

\$300 Filing Fee

Ensure all information is typed or legibly printed using blue or black ink.

Code Section(s): 28.141 (9) (c)

Address of Subj	ect Property: 5006 Lake Me	endota Drive	
Name of Owner:	Chris Carpenter		
Address of Owne	er (if different than above): _		
Daytime Phone:	608-695-1526	Evening Phone:	
Email Address:	ccarpenter@royle.com		
Name of Applica	int (Owner's Representative):	Amy Hasselman, AIA	
Address of Appli	icant: 116 E Dayton St Madison, WI 53703		
Daytime Phone:	608-251-7515 x33	Evening Phone:	608-698-0715
	amy_hasselman@architect	ture-network.net	
	equested Variance: O 28.141(9), to allow two driv	veways to two separate	single-car garages (See reverse side for more instructions)
n en		R OFFICE USE ONLY	(
Amount Paid:		Hearing Date:	
Receipt: Filing Date:		Published Date: Appeal Number:	
9	_11 - > / /		700 / White W 160

Parcel Number: 0 70
Zoning District: 18

Standards for Variance

The Zoning Board of Appeals shall not grant a variance unless it finds that the applicant has shown the following standards are met:

1. There are conditions unique to the property of the applicant that do not apply generally to other properties in the district.

Existing condition is a driveway to an existing single-car garage, paved frontage, and a paved single-car parking space on the opposite side of the street frontage from the garage. The landscaping and walks are set up for two separated parking locations. Topography drops off steeply from the street, preventing a circular drive, and expanding the existing garage would kill a large mature tree.

2. The variance is not contrary to the spirit, purpose, and intent of the regulations in the zoning district and is not contrary to the public interest.

The proposed project would reduce the front yard paved area from 61% to 36%, and eliminate an non-conforming parking space in the front yard setback. It would also create a much more attractive street frontage.

3. For an area (setbacks, etc) variance, compliance with the strict letter of the ordinance would unreasonably prevent use of the property for a permitted purpose or would render compliance with the ordinance unnecessarily burdensome.

Two garage spaces with a compliant driveway could be made by expanding the existing garage, but doing so would kill a large mature tree.

4. The alleged difficulty or hardship is created by the terms of the ordinance rather than by a person who has a present interest in the property.

The present owner just bought the property. All conditions are existing.

5. The proposed variance shall not create substantial detriment to adjacent property.

The proposed solution improves the existing situation by bringing it into compliance with impervious area and parking standards, and makes a more attractive streetscape.

6. The proposed variance shall be compatible with the character of the immediate neighborhood.

Typical houses along the street have 2-3 garage stalls. The garages close to the street are more commonly single-car.

Application Requirements

Please provide the following Information (Please note any boxes left uncheck below could result in a processing delay or the Board's denial of your application):

	Pre-application meeting with staff : Prior to submittal of this application, the applicant is strongly encouraged to discuss the proposed project and submittal material with Zoning staff. Incomplete applications could result in referral or denial by the Zoning Board of Appeals.
	Site plan, drawn to scale. A registered survey is recommended, but not required. Show the following on the site plan (Maximum size for all drawings is 11" x 17"): Lot lines Existing and proposed structures, with dimensions and setback distances to all property lines Approximate location of structures on neighboring properties adjacent to variance Major landscape elements, fencing, retaining walls or other relevant site features Scale (1" = 20' or 1' = 30' preferred) North arrow
	Elevations from all relevant directions showing existing and proposed views, with notation showing the existing structure and proposed addition(s). (Maximum size for all drawings is $11'' \times 17''$)
	Interior floor plan of existing and proposed structure, when relevant to the variance request and required by Zoning Staff (Most additions and expansions will require floor plans). (Maximum size for all drawings is $11'' \times 17''$)
	Front yard variance requests only. Show the building location (front setback) of adjacent properties on each side of the subject property to determine front setback average.
	Lakefront setback variance requests only. Provide a survey prepared by a registered land surveyor showing existing setbacks of buildings on adjacent lots, per MGO 28.138.
	Variance requests specifically involving slope, grade, or trees. Approximate location and amount of slope, direction of drainage, location, species and size of trees.
	CHECK HERE. I acknowledge any statements implied as fact require supporting evidence.
	CHECK HERE. I have been given a copy of and have reviewed the standards that the Zoning Board of Appeals will use when reviewing applications for variances.
Owne	Date: 1-22-14 (Do not write below this line/For Office Use Only)
***************************************	DECISION pard, in accordance with its findings of fact, hereby determines that the requested variance for (is) (is not) in compliance with all of the standards for a variance. It findings of fact are stated in the minutes of this public hearing.
The 7	oning Board of Appeals: Approved Denied Conditionally Approved
ine Z	oming board of AppendixApproved

Zonin	g Board of Appeals Chair:
Date:	



1830 Sugar River Road • Verona, Wisconsin 53593 • (608) 271-4126 • (608) 271-4125 Fax

November 13, 2013

Amy Hasselman, AIA Architecture Network, Inc. 116 E. Dayton Street Madison, WI 53703

Dear Ms. Hasselman,

At your request I have visited your client's residence at 5006 Lake Mendota Drive to examine a 33" trunk diameter bur oak (*Quercus macrocarpa*) behind the existing garage. You have asked that I provide an opinion regarding the impact on the tree resulting from two alternative proposed garage construction plans. You have provided me with those two alternative plans with dimensions showing foundation distance from the oak trunk.

The first plan with the new garage attached to the existing garage and a shared driveway places the new foundation within 3.5 feet of the trunk. Foundation footing excavation would severely cut into the root plate creating an unacceptable loss of tree stability and introducing inevitable root decay. The second plan with a detached driveway places the garage foundation much further to the west outside of the root plate. There would be some fibrous and smaller arterial root zone loss with a resultant decrease of water and nutrient uptake but not above the threshold of tolerance for this tree to adapt. This assumes that the foundation wall would be left exposed and no terracing, grading or other soil disturbance would occur in an area beyond the minimal excavation required for foundation forms. It is also important to avoid any soil disturbance or compaction in the remaining root zone during construction and also to paint with tree paint wounds to the oak limbs or roots if construction occurs during the oak wilt season of April 1-September 31.

I observe that the oak trunk enters the soil without normal taper suggesting that many years ago soil filling occurred. This can lead to root decay. Looking for signs of heartwood decay I conducted a microdrill resistance test with a, IML PD400 Resistograph with a west entry at grade. The enclosed results indicate solid wood in the area tested. Furthermore there is no sign of canopy dieback.

Respectfully submitted for Aflison Tree Care, Inc.,

R Bruce Allison


ASCA Registered Consulting Arborist ISA Board Certified Master Arborist

Measuring / object data

Measurement no. :	9 :		5000 r/min	Diameter:	
ID number		Needle state :	1	: Fevel	
Drilling depth	: 37,95 cm		-	Direction:	
Date	: 13.11.2013	Offset : 1	145/243	Species	
Time	: 13:32:40	Avg. curve : 0	iff the second	Location:	
Feed speed	: 100 cm/min			Name :	

Cavity detector

Start / Stop level	0/1/0/6:
Maximum start depth	
Mode	
Level / width	: 10% / 1,00 cm
Start / stop	: 0,39 cm / 37,95 cm
Resulting length	: 37,56 cm
Cavity	: 1,37 cm / 4%

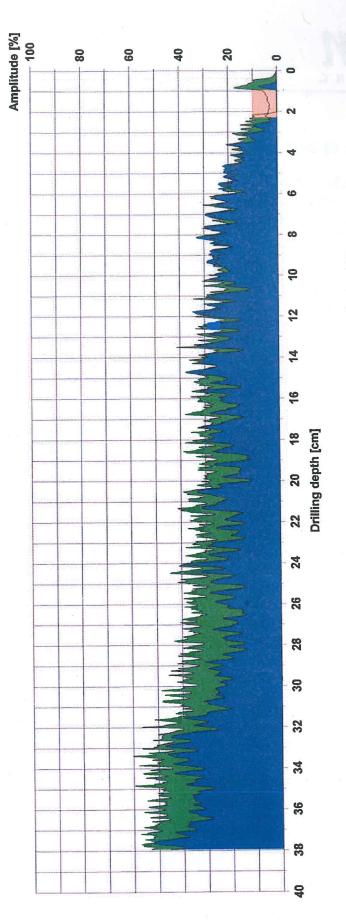

Assessment

From	0,0 cm	\$	0,0 cm	
rom	0,0 cm	9	0,0 cm	
rom	0,0 cm	\$	0'0 cm	D B
From	0,0 cm	\$	0,0 cm	
From	0,0 cm	Ç	0,0 cm	
From	0,0 cm	Ç	0,0 cm	

Comment

Bur oak 5006 Lake Mendota Drive west entry at ground level



IMG_0340.JPG




IMG_0341.JPG



IMG_0342.JPG



IMG_0343.JPG

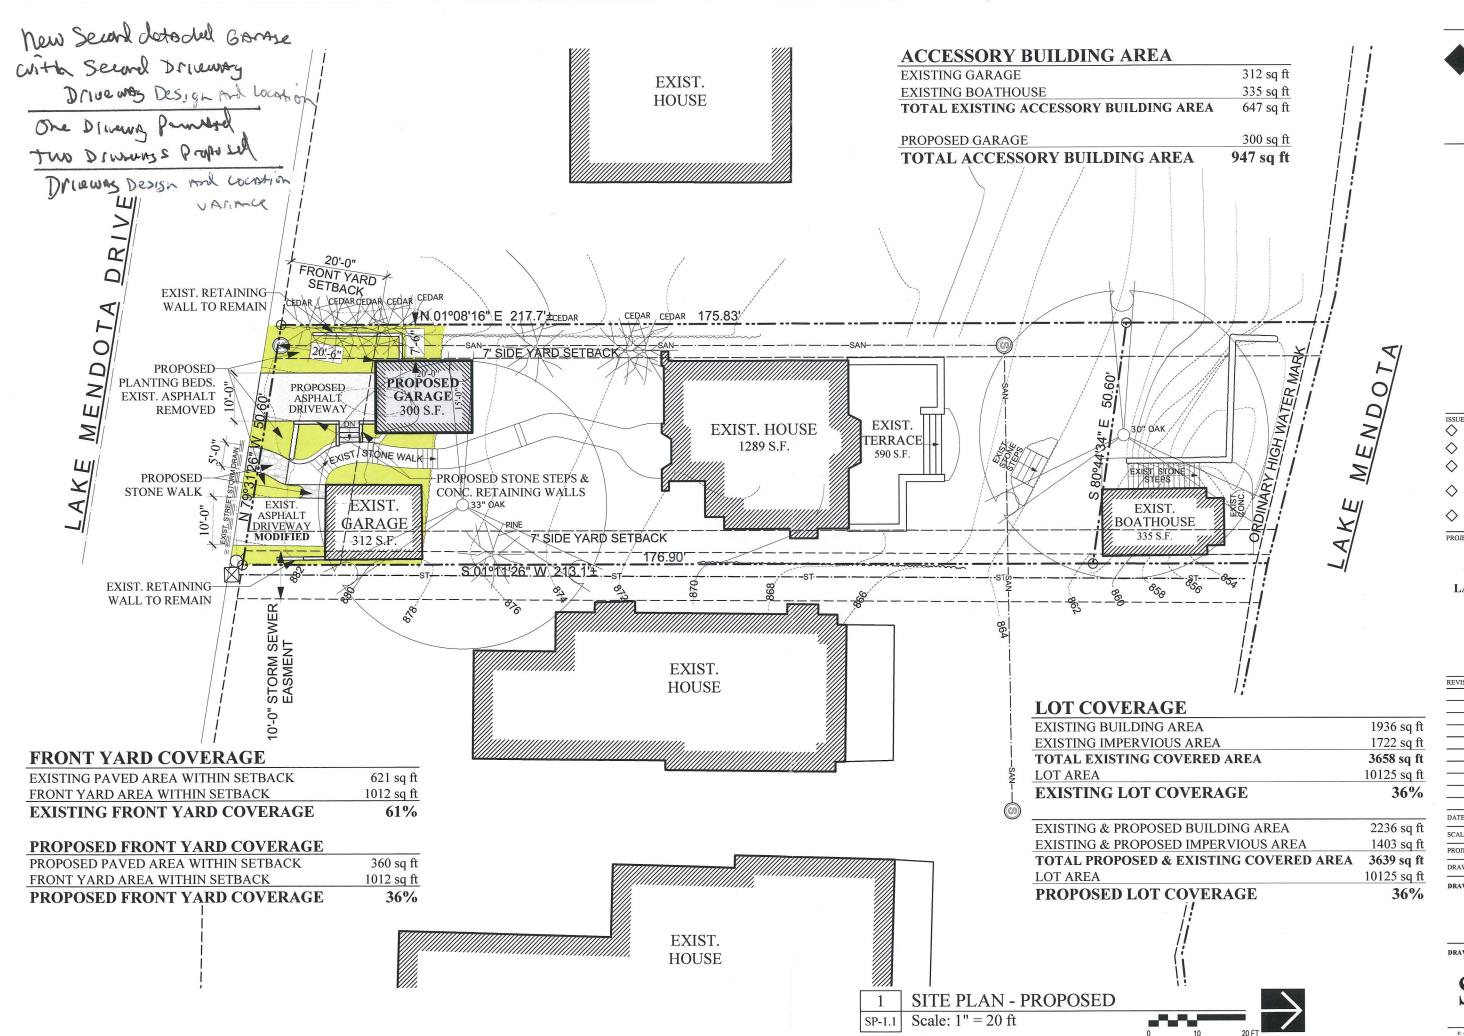



116 East Dayton Street Madison, WI 53703 608-251-7515 Phone 608-251-7566 Fax www.architecture-network.net

ISSU	E:
\Diamond	CONSTRUCTION SET
\Diamond	PLAN REVIEW SET

SID SET
NOT FOR CONSTRUCTION

PRELIMINARY NOT FOR CONSTRUCTION

PROGRESS SET
NOT FOR CONSTRUCTION

GARAGE ADDITION

for 5006 LAKE MENDOTA DR

5006 Lake Mendete Dr

REVISIONS:

 DATE:
 23 JAN 2014

 SCALE:
 AS SHOWN

 PROJECT:
 K1301.21

 DRAWN BY:
 DTZ


DRAWING NAME:

SITE PLAN PROPOSED


DRAWING NUMBER:

SP-1.1

COPYRIGHT BY: ARCHITECTURE NETWORK INC.

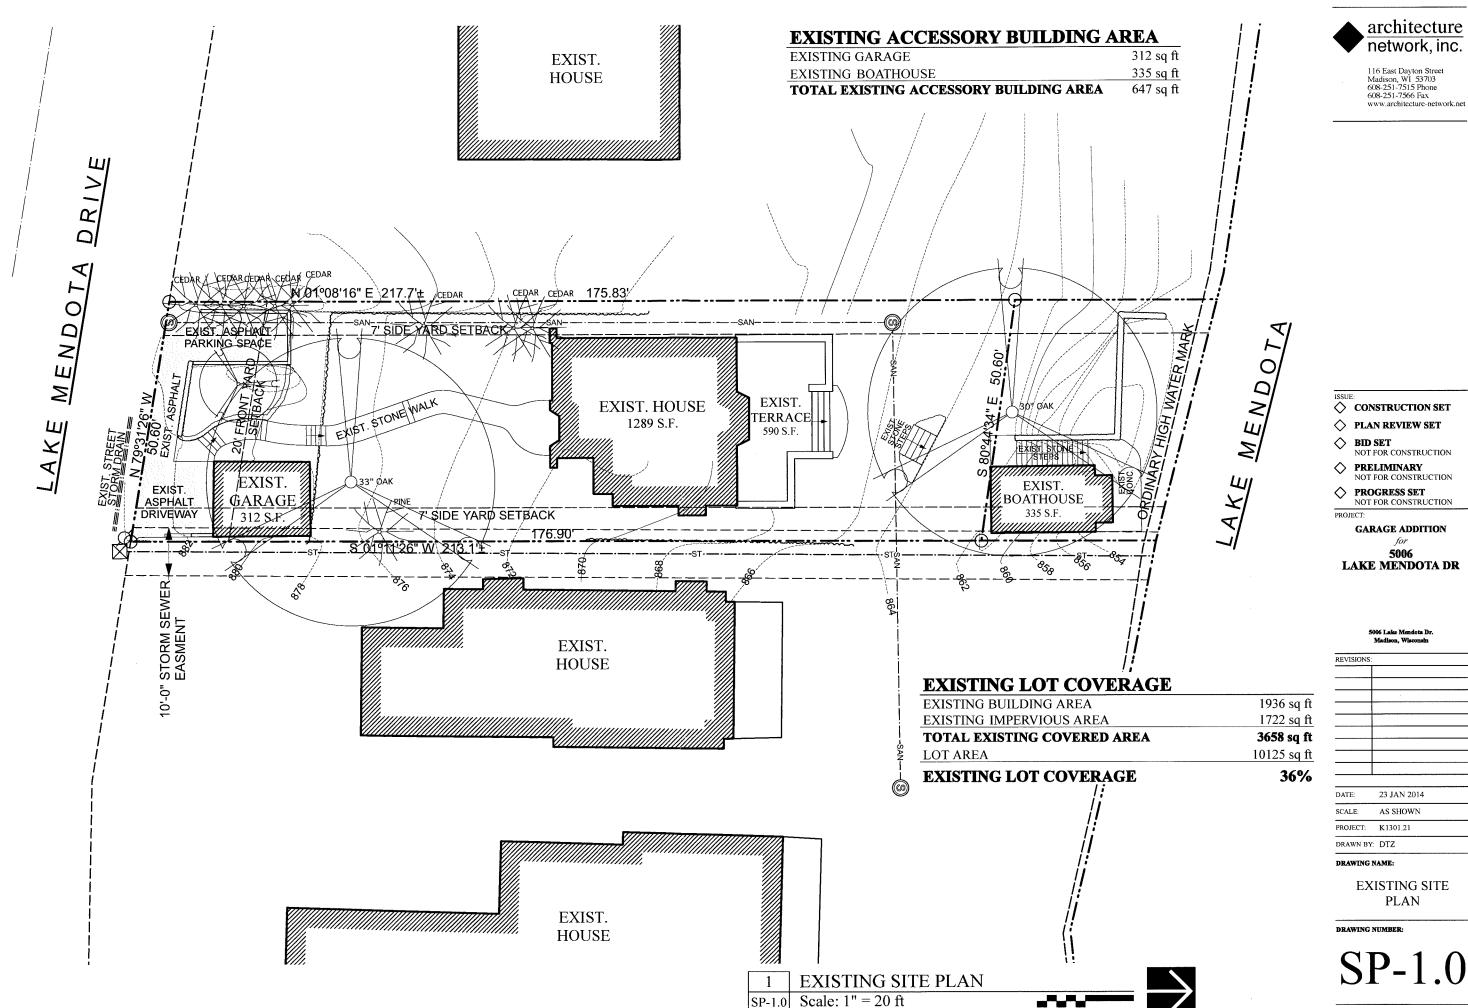

116 East Dayton Street Madison, W1 53703 608-251-7515 Phone 608-251-7566 Fax www.architecture-network.net

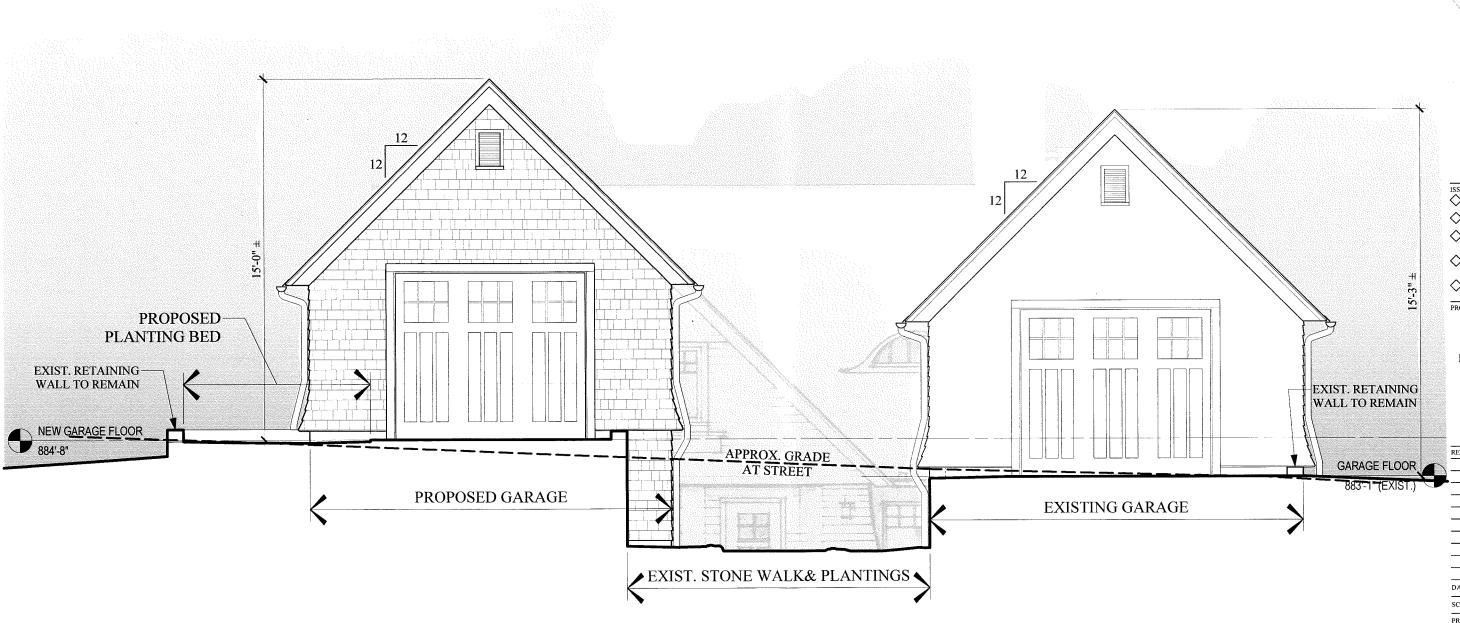

1 SOUTH ELEVATION

Scale: 1/4" = 1'-0"

ISSUE:

CONSTRUCTION SET

PLAN REVIEW SET

BID SET

NOT FOR CONSTRUCTION

PRELIMINARY

NOT FOR CONSTRUCTION

PROGRESS SET

NOT FOR CONSTRUCTION

FOR SOURCE

GARAGE ADDITION

for

5006

LAKE MENDOTA DR

REVISIONS:

REVISIONS:

DATE:

O7 Nov 2013

SCALE:

AS SHOWN

PROJECT:

K1301.21

DRAWN BY: DTZ

SOUTH ELEVATION 🛔

DRAWING NUMBER:


DRAWING NAME:

A-2.0

€ COPYRIGHT BY : ARCHITECTURE NETWORK INC.



116 East Dayton Street Madison, WI 53703 608-251-7515 Phone 608-251-7566 Fax www.architecture-network.net

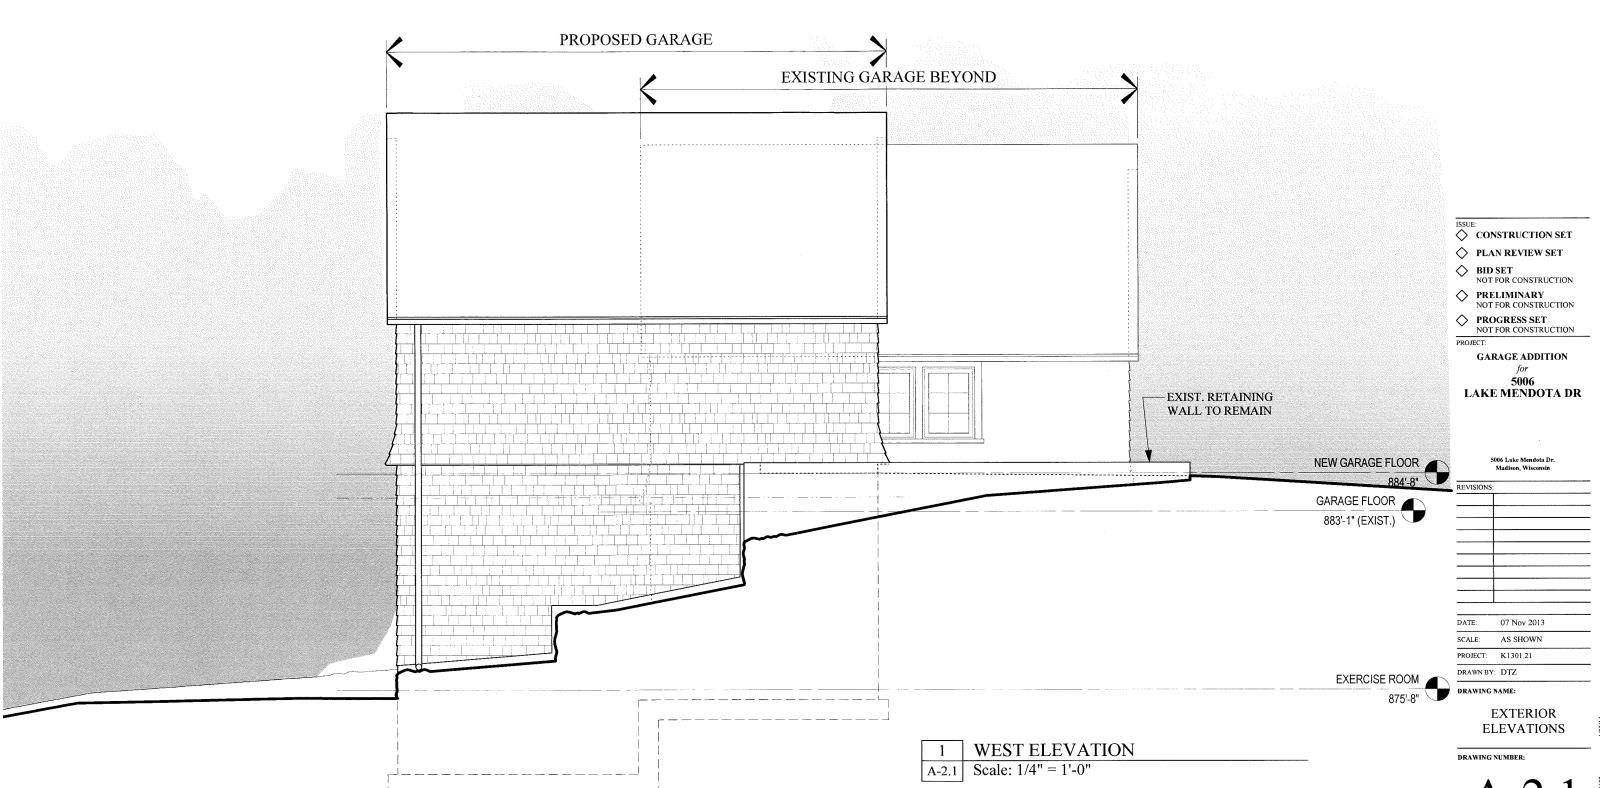

A-2.1

© COPYRIGHT BY: ARCHITECTURE NETWORK INC.