



 $\blacksquare$  Project Info. — 24025 — LIGHTHOUSE CHRISTIAN SCHOOL ADDITION

-Sheet Title ----


6402 SCHROEDER ROAD MADISON, WI 53711


PREFINISHED METAL WALL COPING


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NJH	JMS


lo. Date Description 03.19.24 Budget Set 04.08.24 UDC Submittal 04.29.24 UDC Submittal


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ROOF HATCH/LADDER DETAIL SCALE: 1/2"=1'-0" (30x42)

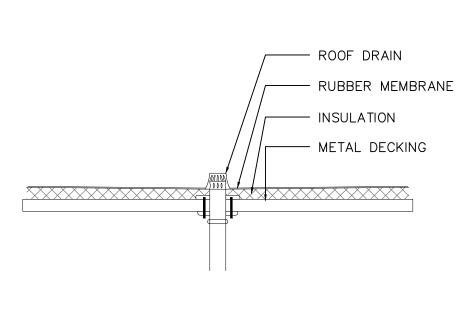PARTIAL ROOF PLAN

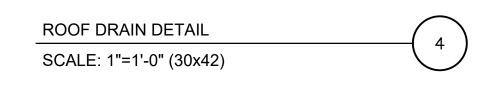45'-0"ADDITION

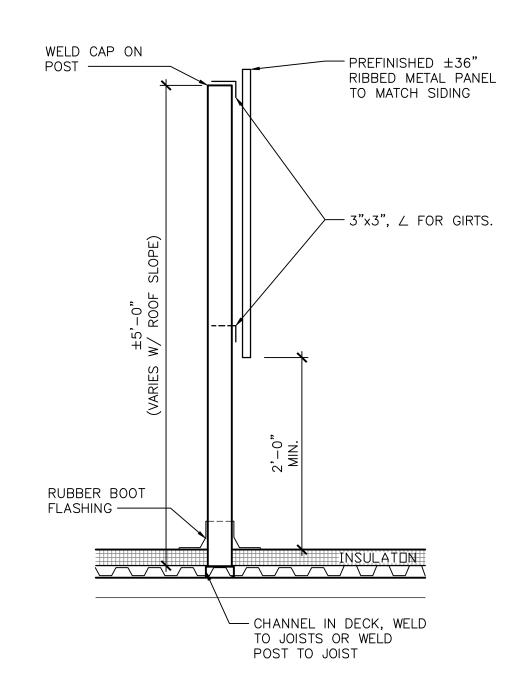SLOPE JOISTS 1/4" PER FOOT

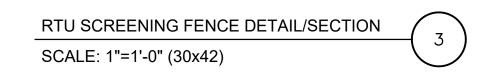HIGH POINT, SLOPE JOISTS 1/4" PER FOOT TO ROOF DRAINS

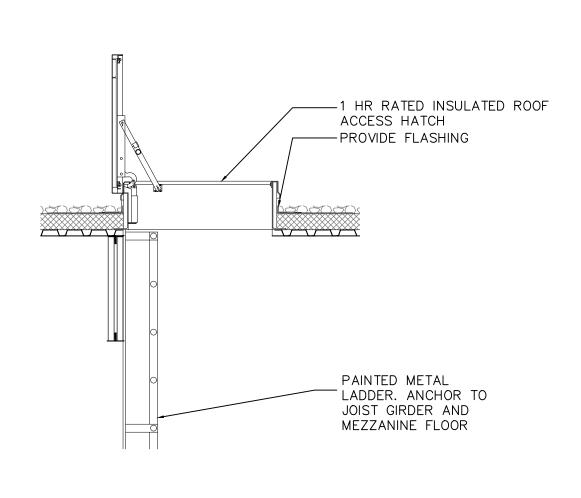TAPERED INSULATION ROOF SADDLE

--- NEW RTU

- NEW RTU

HIGH POINT, SLOPE JOISTS 1/4" PER FOOT TO ROOF DRAINS

TAPERED INSULATION ROOF SADDLE

SLOPE JOISTS 1/4" PER FOOT

POOF DRAIN

— MECH. EQUIPMENT SCREENING FENCE. SEE DETAIL 3/A1.2

SLOPE JOISTS 1/4" PER FOOT


ROOF DRAIN


POOF DRAIN

\_\_\_\_\_

ROOF HATCH, SEE DETAIL 2/A1.2

EXISTING ROOF

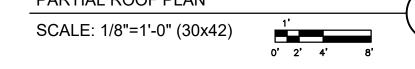

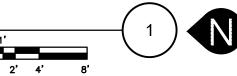



THR VE ARCH TECTS

Architect

259 South Street, Suite A
WAUKESHA, WI 53186
p: 833-380-6180

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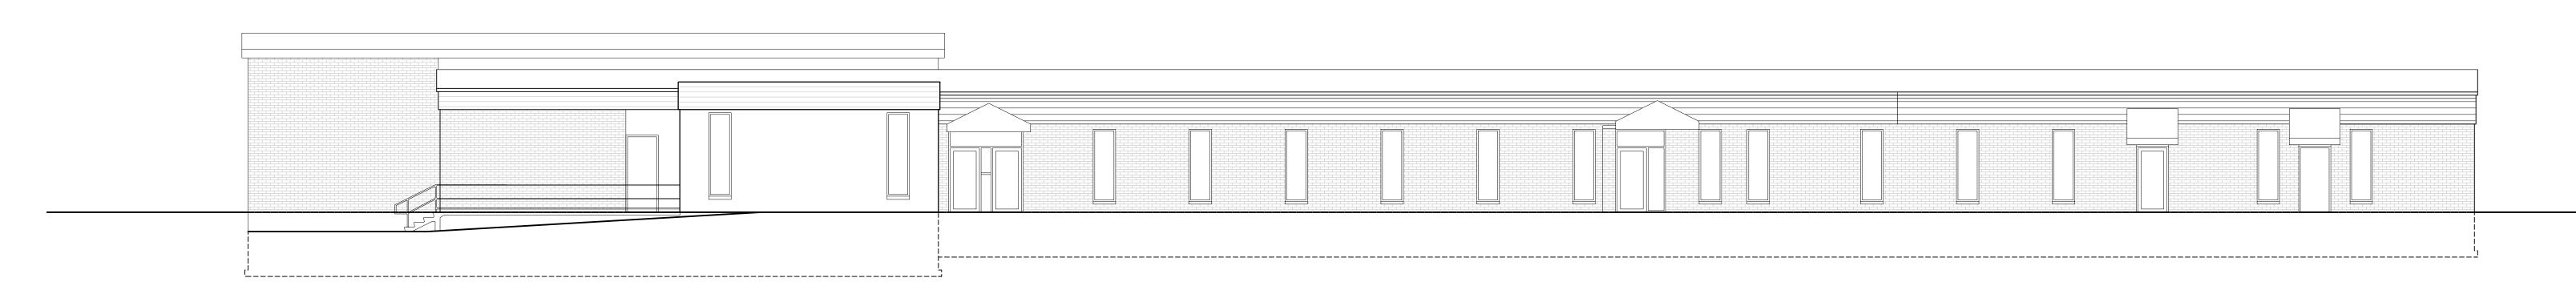
LIGHTHOUSE CHRISTIAN SCHOOL
ADDITION

6402 SCHROEDER ROAD MADISON, WI 53711

Sheet Title ————


EXISTING GOOGLE STREET VIEW - OCT. 2023
SCALE: NTS

23 4



EXISTING WEST ELEVATION - SEE SHEET A2.1 FOR PROPOSED ELEVATIONS

SCALE: 1/8"=1'-0" (30x42)

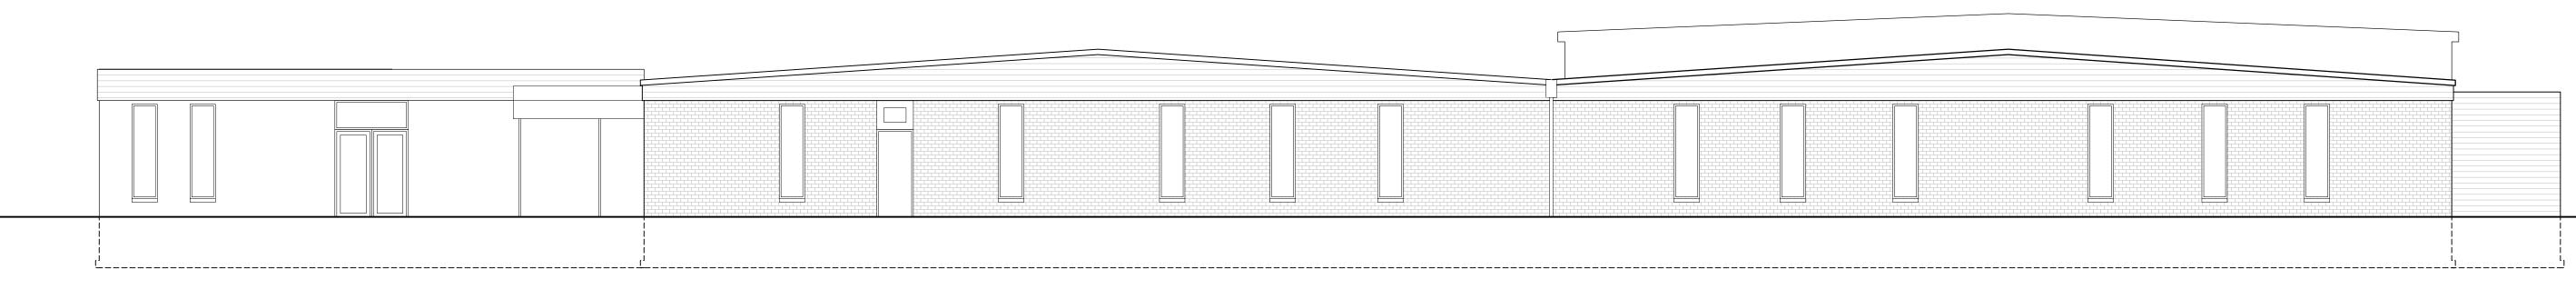

EXISTING SOUTH ELEVATION - SEE SHEET A2.1 FOR PROPOSED ELEVATIONS

SCALE: 1/8"=1'-0" (30x42)



Revisions
No. Date

O3.19.24

Budget Set

O4.08.24


UDC Submittal

O4.29.24

UDC Submittal

Sheet No. ——

A2.0

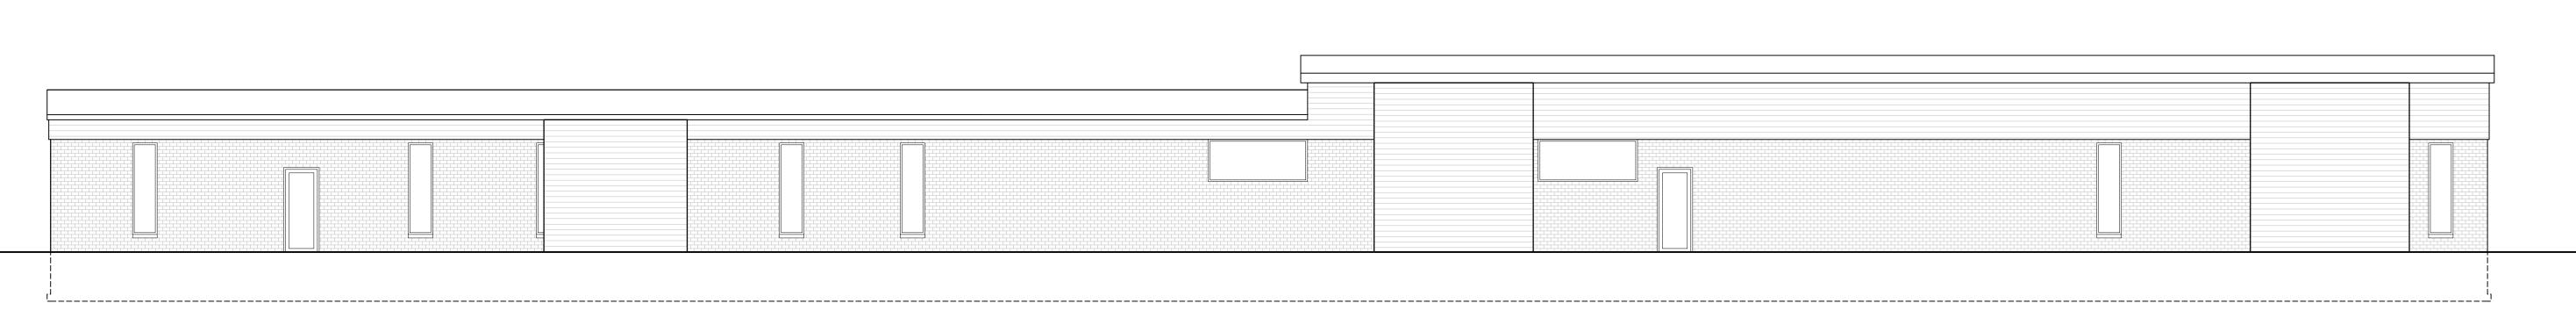

EXISTING EAST ELEVATION - SEE SHEET A2.1 FOR PROPOSED ELEVATIONS

SCALE: 1/8"=1'-0" (30x42)

#### BIRD SAFE GLASS ORDINANCE

- PER 28.129(4)(a)2.
  FOR BUILDING FAÇADES WHERE THE FIRST SIXTY (60) FEET FROM GRADE ARE COMPRISED OF LESS
- THAN FIFTY PERCENT (50%) GLASS: a. AT LEAST EIGHTY-FIVE PERCENT (85%) OF THE GLASS ON GLASS AREAS FIFTY (50) SQUARE FEET OR OVER MUST BE TREATED; AND
- O. OF ALL GLASS AREAS OVER FIFTY (50) SQUARE FEET, ANY GLASS WITHIN FIFTEEN (15) FEET OF A BUILDING CORNER MUST BE TREATÉD.

#### BIRD SAFE GLASS CALCULATIONS

SOUTH ELEVATION AREA = 2,265 S.F. SOUTH ELEVATION WINDOW AREA = 327.5 S.F.

EAST ELEVATION AREA = 590 S.F. EAST ELEVATION WINDOW AREA = 51 S.F.

WEST ELEVATION AREA = 669 S.F.

WEST ELEVATION WINDOW AREA = 135 S.F.

WINDOW AREA LESS THAN 50% OF FACADE TYP. WINDOW AREA (SINGLE) = 13 S.F.TYP. WINDOW AREA (PAIR OF WINDOWS) = 25.5 S.F.

PROVIDING BIRD SAFE GLAZING AT SWC CLUSTER OF WINDOWS ON SOUTH AND WEST FACADE PER ORDINANCE

TYP. WINDOW AREA (3 SETS OF WINDOWS) = 38.2 S.F.

ELEVATION KEYNOTES

- $\langle 1 \rangle$  METAL PANEL SIDING = PAC-CLAD HIGHLINE B2, COLOR- STONE WHITE
- 2 METAL PANEL SIDING = PAC-CLAD HIGHLINE S2, COLOR PACIFIC BLUE
- COMPOSITE SIDING = AZEK TIMBERTECH CLOSED JOINT SIDING, COLOR ENGLISH WALNUT.
- 4 ALUMINUM STOREFRONT, COLOR DARK BRONZE.
- 5 1" INSULATED, CLEAR, LOW-E GLAZING
- 6 1" INSULATED, CLEAR, LOW-E GLAZING W/ BIRD SAFE FILM/PATTERN
- 1" INSULATED ALUMINUM PANEL. VARIOUS COLORS TO MATCH PAC-CLAD // INTERSTATE BLUE, BONE WHITE, AND BERKSHIRE BLUE.
- $\langle 8 \rangle$  PRE-FINISHED METAL COPING. COLOR TO MATCH WALL (BELOW) COLOR.
- 9 INSULATED METAL EXIT DOOR. PAINT TO MATCH ADJACENT WALL COLOR.
- (10) EXISTING BUILDING NO CHANGE TO MATERIALS
- METAL PANEL RTU SCREENING = PAC-CLAD HIGHLINE MI, COLOR STONE WHITE






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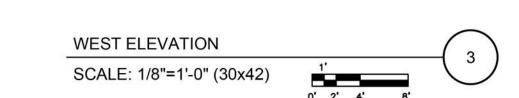
LIGHTHOUSE CHRISTIAN SCHOOL **ADDITION** 


6402 SCHROEDER ROAD MADISON, WI 53711


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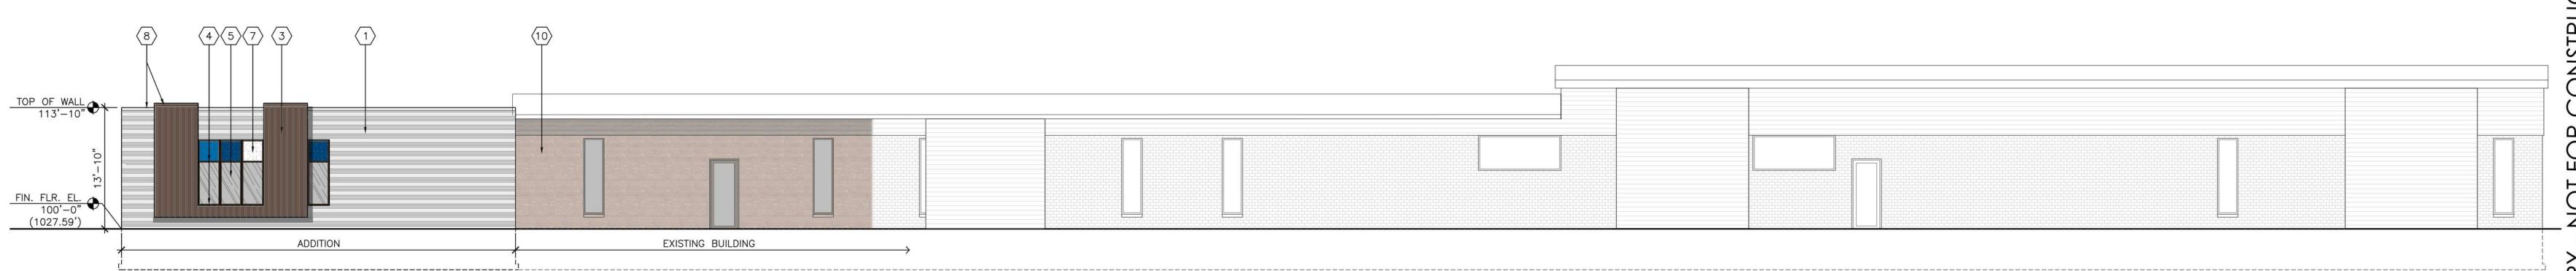






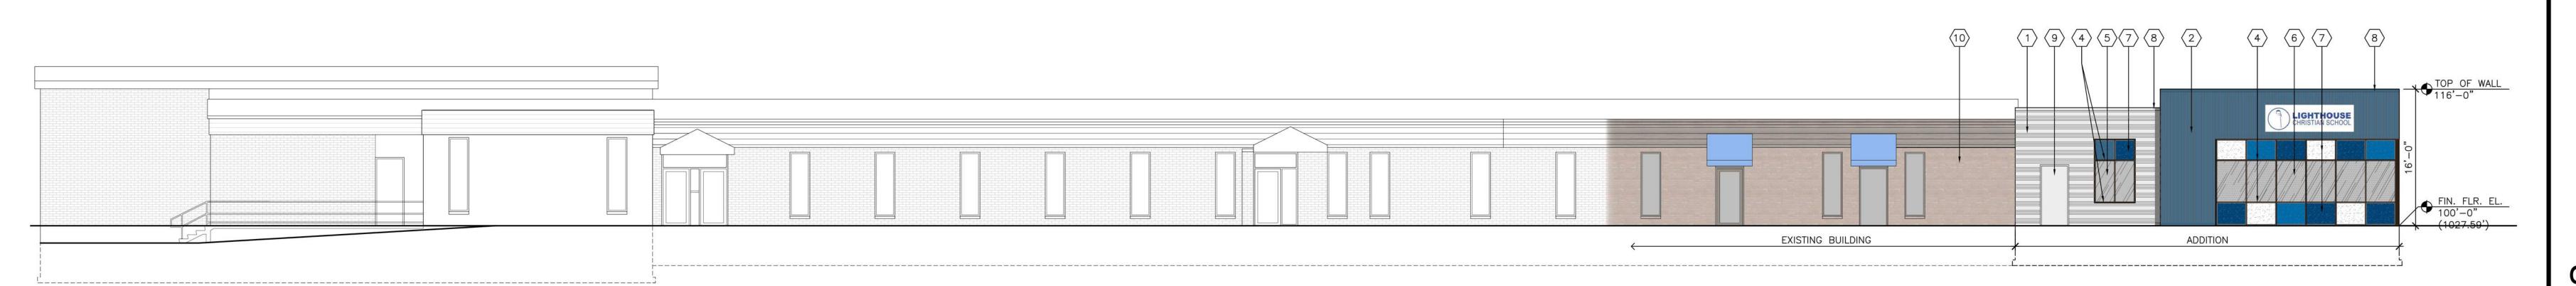

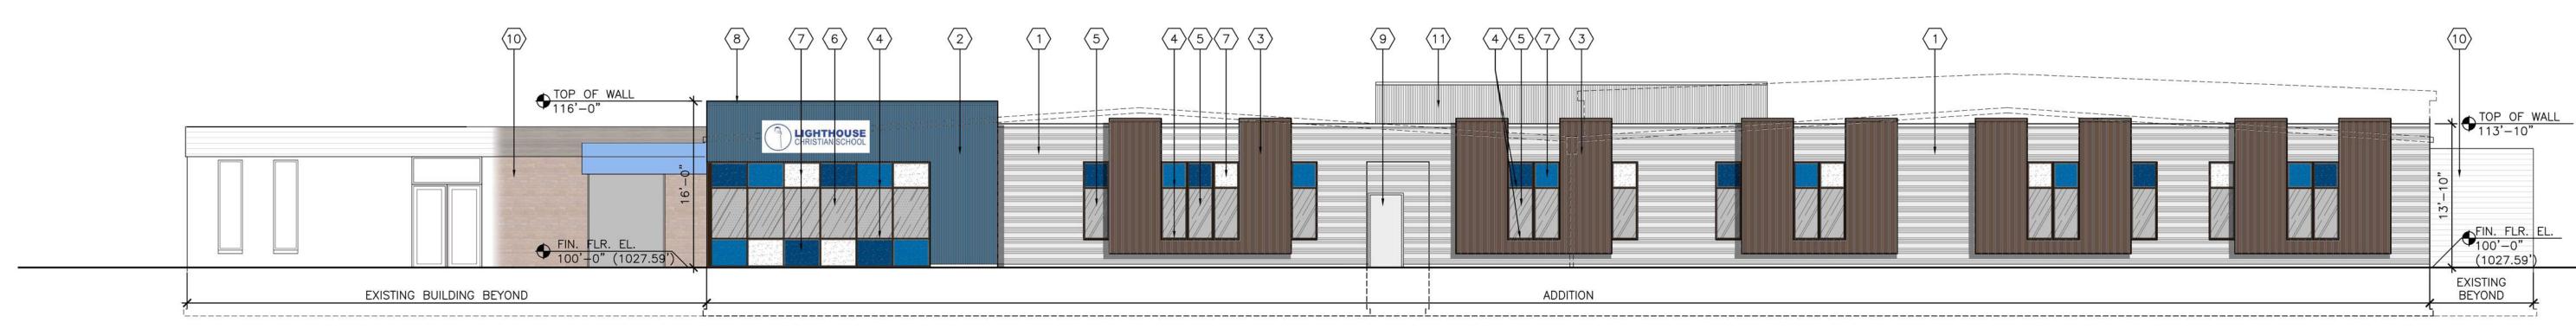

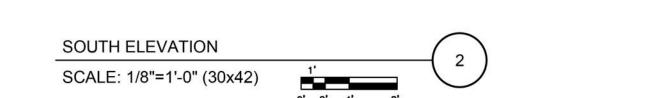

**EAST ELEVATION** SCALE: 1/8"=1'-0" (30x42)

Checked by Drawn by

Revisions —— Description 03.19.24 Budget Set 04.08.24 UDC Submittal 04.29.24 UDC Submittal

Sheet No. —





ADDITION

6402 SCHROEDER ROAD MADISON, WI 53711


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PERSPECTIVE RENDERING VIEW FROM SW N.T.S.



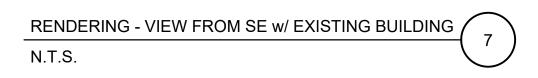

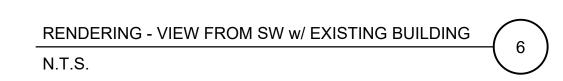

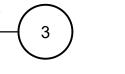

PERSPECTIVE RENDERING VIEW FROM SE







PERSPECTIVE RENDERING VIEW FROM SW - SCHROEDER AND LAURIE

N.T.S.

Drawn by Check

NJH JMS

Revisions
No. Date Description

03.19.24 Budget Set

04.08.24 UDC Submittal

04.29.24 UDC Submittal


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A9.0

**BONE WHITE** 

INTERSTATE BLU BERKSHIRE BLUE

STONE WHITE



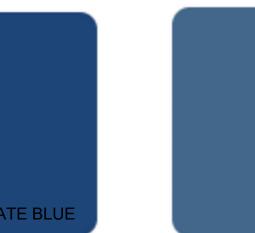

INSULATED ALUMINUM WINDOW INFILL PANELS ELEVATION KEYNOTE 7

# Vitro Architectural Glass

## Product Data Sheet



### Aesthetic Description

Solarban® 70 glass (formerly Solarban® 70XL glass) is a solar control, low-e glass that brilliantly combines the clear appearance of transparent, color-neutral glass with an exceptional combination of solar control and visible light transmittance (VLT), The world's first triple-silver, magnetron sputter vacuum


deposition (MSVD) coating, Solarban® 70 glass expands the design possibilities for buildings in two important ways. First, Solarban\* 70 glass enables architects to incorporate vast areas of vision glass into their designs without a corresponding increase in cooling equipment capacity.

Second, architects can specify a clear aesthetic while achieving solar control performance that was once attainable only through the use of tinted glass and a solar control, low-e coating in an insulated glass unit (IGU).

### Performance Options

When coupled with conventional clear glass in a one-inch IGU, Solarban\* 70 glass achieves a Visible Light Transmittance (VLT of 64 percent and a Solar Heat Gain Coefficient (SHGC) of 0.27 to produce a Light to Solar Gain (LSG) ratio of 2.37, making it one of the industry's highest-performing glasses.


The clear aesthetic of Solarban® 70 glass also makes the product exceptionally versatile, offering architects an extensive array of performance and appearance options. For instance, for projects that require advanced solar control performance, Solarban" 70 glass can be coated on the second (#2) surface of nearly all of

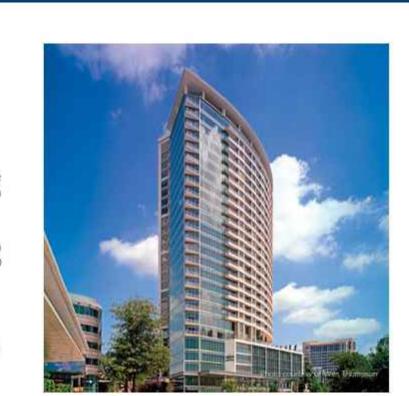


Location: Dallas, TX | Product: Solarbon® 70XL Glass | Architect of Record: PageSoutherlandPage | Design Architect: Gromatzky Dupree & Associates | Glass Fabricator: Trulite Glass and Aluminum Solutions | Glazing Contractor: Haley-Green

Vitro Architectural Glass' (formerly PPG glass) wide range of tinted glasses to produce SHGCs as low as 0.19 and LSG ratios ranging from 1.68 to 2.15.

For more color and reflectivity choices, Solarban® 70 glass may be specified on the third (#3) surface of an IGU behind a tinted lite or in combination with Solarcool® reflective or Vistacool® subtly reflective color-enhanced glasses.

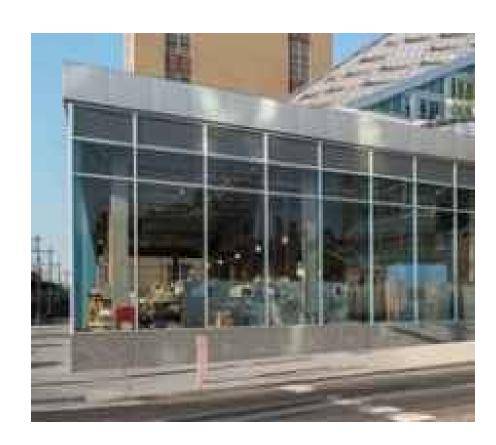

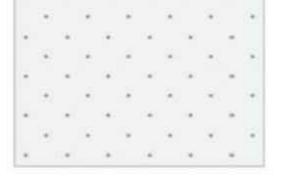


1" - INSULATED, LOW-E GLAZING & BIRD GLAZING ELEVATION KEYNOTES 5 & 6



METAL PANEL SIDING = PAC-CLAD HIGHLINE S2, COLOR - PACIFIC BLUE **ELEVATION KEYNOTE 2** 

15.356" NOMINAL

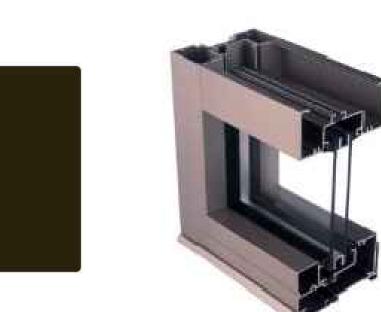





STOREFRONT GLAZING SYSTEM TUBELITE - T14000 SERIES - DARK BRONZE **ELEVATION KEYNOTE 4** 






AZEK TIMBERTECH CLOSED JOINT SIDING COLOR - ENGLISH WALNUT **ELEVATION KEYNOTE 3** 

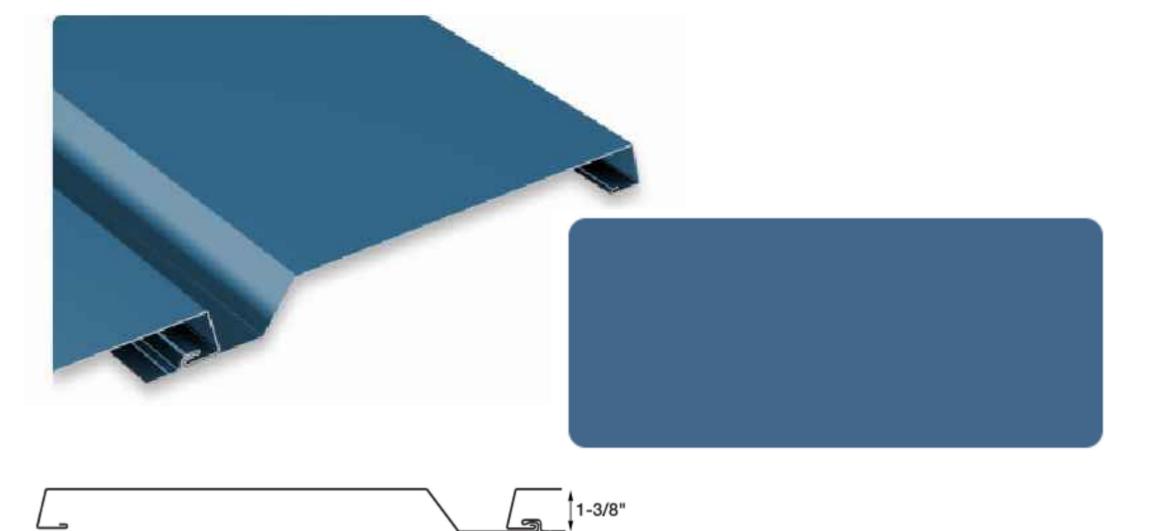

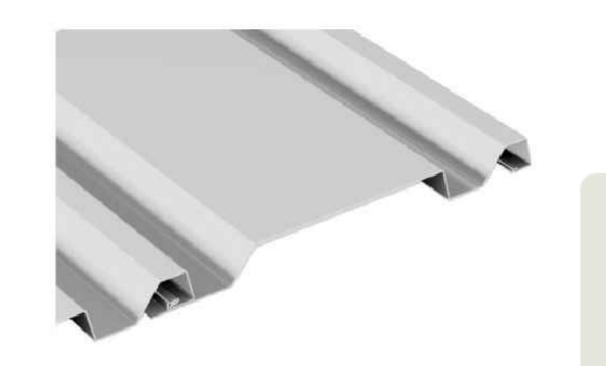

TIMBERTECH® CLADDING

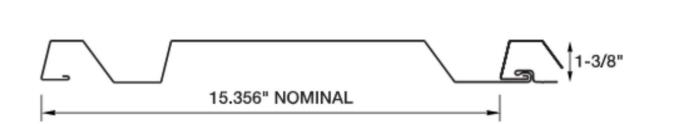

METAL PANEL SIDING = PAC-CLAD HIGHLINE B2, COLOR- STONE WHITE **ELEVATION KEYNOTE 1** 



ADDITION

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**\_**Sheet No. \_\_\_\_