

AP 02 - Site Plan Review - Revision 1 06/13/2025




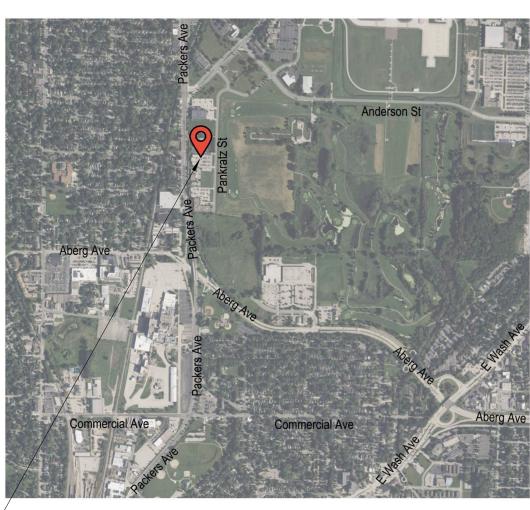

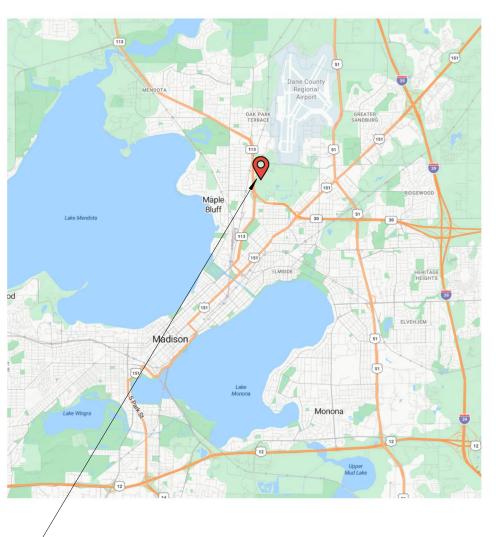


PROJECT LOCATION



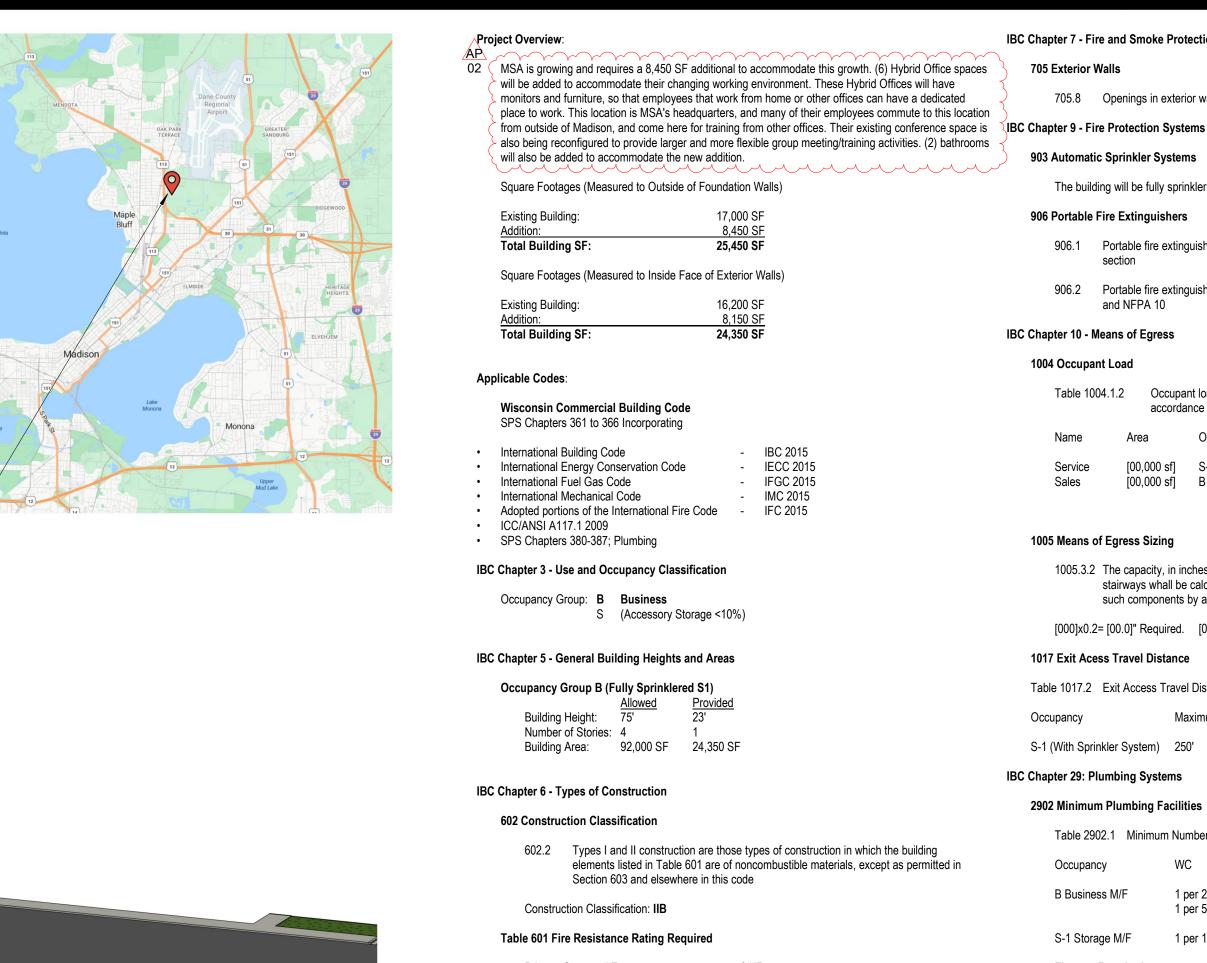


Bearing Walls

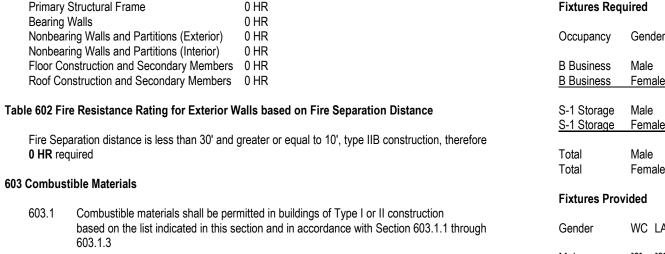

IPC 419.2 Substitution for water closets

Urinals shall not be substituded for more than 50% of the required water closets

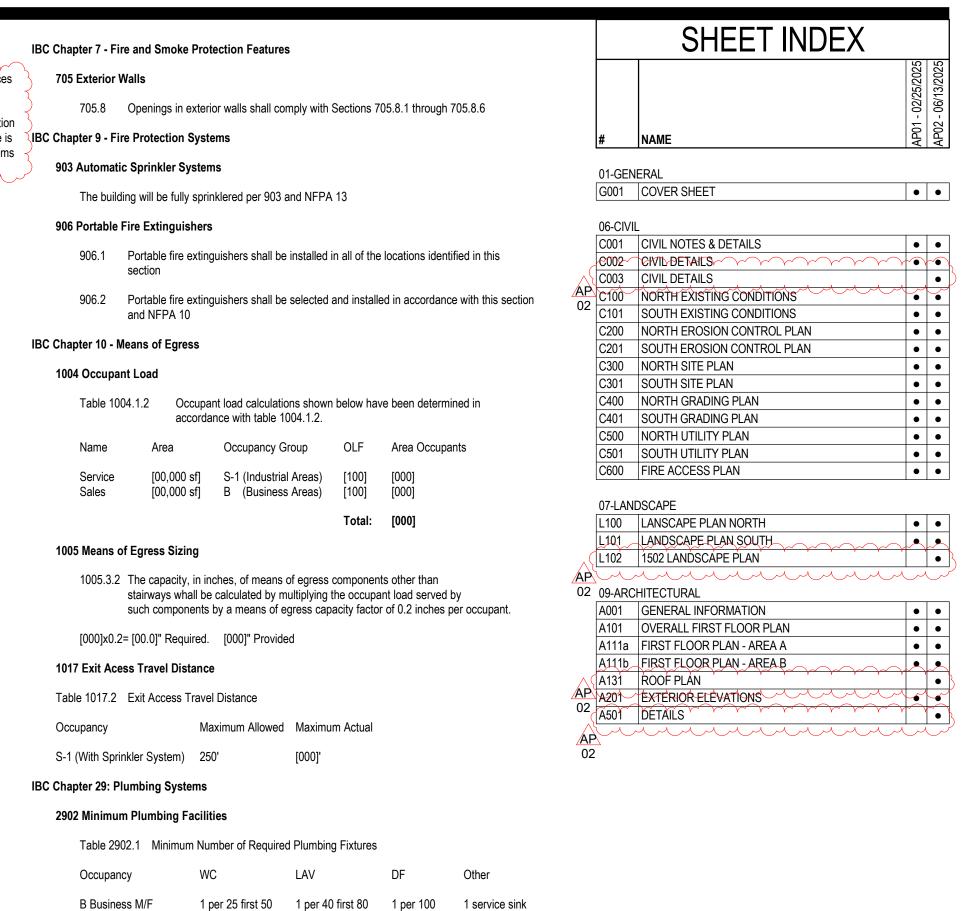

1 per 1000 1 Service Sink

Stamps and Approvals



EROSION CONTROL NOTES/SPECIFICATIONS:

1. EROSION CONTROL DEVICES AND/OR STRUCTURES SHALL BE INSTALLED PRIOR TO CLEARING AND GRUBBING OPERATIONS. THESE SHALL BE PROPERLY MAINTAINED FOR MAXIMUM EFFECTIVENESS UNTIL VEGETATION IS RE-ESTABLISHED.

- 2. EROSION CONTROL IS THE RESPONSIBILITY OF THE CONTRACTOR UNTIL ACCEPTANCE OF THIS PROJECT. EROSION CONTROL MEASURES AS SHOWN SHALL BE THE MINIMUM PRECAUTIONS THAT WILL BE ALLOWED. THE CONTRACTOR SHALL BE RESPONSIBLE FOR RECOGNIZING AND CORRECTING ALL EROSION CONTROL PROBLEMS THAT ARE THE RESULT OF CONSTRUCTION ACTIVITIES. ADDITIONAL EROSION CONTROL MEASURES, AS REQUESTED IN WRITING BY THE STATE OR LOCAL INSPECTORS, OR THE DEVELOPER'S ENGINEER, SHALL BE INSTALLED WITHIN 24 HOURS.
- 3. ALL EROSION CONTROL MEASURES AND STRUCTURES SERVING THE SITE MUST BE INSPECTED AT LEAST WEEKLY OR WITHIN 24 HOURS OF THE TIME 0.5 INCHES OF RAIN IS PRODUCED. ALL MAINTENANCE WILL FOLLOW AN INSPECTION WITHIN 24 HOURS. INSPECTION SCHEDULE AND RECORD KEEPING SHALL COMPLY WITH NR 216.46(9), WIS. ADM. CODE.
- 4. CONSTRUCTION ENTRANCES PROVIDE A STONE TRACKING PAD AT EACH POINT OF ACCESS. INSTALL ACCORDING TO WDNR STANDARD 1057. REFER TO WDNR'S STORMWATER WEB PAGE OF TECHNICAL STANDARDS AT: HTTP://DNR.WI.GOV/TOPIC/STORMWATER/STANDARDS/CONST_STANDARDS.HTML. THE TRACKING PAD MUST BE MAINTAINED IN A CONDITION THAT PREVENTS THE TRACKING OF MATERIAL ONTO THE PUBLIC STREET.
- 5. SOIL STOCKPILES A ROW OF SILT FENCE PLACED DOWNSLOPE AND AT LEAST 10 FEET AWAY FROM THE STOCKPILE SHALL PROTECT ALL STOCKPILES. SOIL STOCKPILES THAT ARE INACTIVE FOR MORE THAN 14 CONSECUTIVE DAYS SHALL BE STABILIZED WITH SEMENTAL WOLCH, EROSION MATH POLYMAR, OR COVERED WITH TARPS OR SIMILAR MATERIAL. NO STOCKPILE SHALL BE PLACED WITHIN 20 FEET OF A DRAINAGE WAY.
- 6. DEWATERING WATER PUMPED FROM THE SITE SHALL BE TREATED BY USING A TEMPORARY SEDIMENTATION BASIN, PORTABLE DEWATERING BASIN, GEOTEXTILE BAG, OR AN EQUIVALENT DEVICE. SHOW ON THE PLAN THE ANTICIPATED LOCATIONS OF DEWATERING ACTIVITY, AND PROVIDE AN ENGINEERING DETAIL OF THE DEWATERING SYSTEM. DEVISES SHALL COMPLY WITH WDNR TECHNICAL STANDARD 1061 FOUND AT: HTTP://DNR.WI.GOV/TOPIC/STORMWATER/STANDARDS/CONST_STANDARDS.HTML THIS WATER SHALL BE DISCHARGED IN A MANNER THAT DOES NOT INDUCE EROSION OF THE SITE OR ADJACENT PROPERTY.

- 7. STORM SEWER INLETS PROVIDE WDOT TYPE D "CATCHALL" INLET PROTECTION OR EQUIVALENT. REFER TO WDOT PRODUCT ACCEPTABILITY LIST AT: HTTP://www.dot.wisconsin.gov/business/engrserv/pal.htm. inlet protection shall be installed prior to the storm sewer system receiving site runoff. Other than for performing maintenance, THESE DEVICES SHALL NOT BE REMOVED UNTIL PLAT-LEVEL STABILIZATION IS COMPLETE.
- 8. BUILDING AND WASTE MATERIALS SHALL BE PREVENTED FROM RUNNING—OFF THE SITE AND ENTERING WATERS OF THE STATE IN CONFORMANCE WITH NR151.12(6M).
- 9. NO SOLID MATERIAL SHALL BE DISCHARGED OR DEPOSITED INTO WATERS OF THE STATE IN VIOLATION OF CH. 30 OR 31 OF THE WISCONSIN STATE STATUTES OR 33 USC 1344 PERMITS.
- 10. EROSION CONTROL DEVICES SHALL ADHERE TO THE TECHNICAL STANDARDS FOUND AT: HTTP://DNR.WI.GOV/RUNOFF/STORMWATER/TECHSTDS.HTM AND COMPLY WITH ALL CITY OF MADISON ORDINANCES.
- 11. ALL DEBRIS TRACKED ONTO PUBLIC STREETS SHALL BE BE SWEPT OR SCRAPED CLEAN BY THE END OF EACH WORKDAY.
- 12. ALL BUILDING AND WASTE MATERIAL SHALL BE HANDLED PROPERLY TO PREVENT RUNOFF OF THESE MATERIALS OFF OF THE
- 13. ALL DISTURBED AREAS SHALL BE SEEDED IMMEDIATELY AFTER GRADING ACTIVITIES HAVE BEEN COMPLETED.
- 14. ALL DISTURBED AREAS, EXCEPT PAVED AREAS, SHALL RECEIVE A MINIMUM OF FOUR (4) INCHES OF TOPSOIL, FERTILIZER, SEED, AND MULCH. SEED MIXTURES SHALL BE SELECTED APPROPRIATE TO THE INTENDED FUNCTION. A QUALIFIED LANDSCAPING CONTRACTOR, LANDSCAPE ARCHITECT OR NURSERY CAN BE CONSULTED FOR RECOMMENDATIONS. SEEDING RATES SHALL BE BASED ON POUNDS OR OUNCES OF PURE LIVE SEED PER ACRE AND SHALL BE PROVIDED BY THE SEED SUPPLIER. FERTILIZER CAN BE APPLIED TO HELP PROMOTE GROWTH, BUT A SOIL TEST IS RECOMMENDED TO DETERMINE THE TYPE AND AMOUNT OF FERTILIZER TO BE APPLIED. ALL SEEDING AND RESTORATION SHALL BE IN CONFORMANCE TO WDNR TECHNICAL STANDARD 1059 FOUND AT HTTP://DNR.WI.GOV/TOPIC/STORMWATER/STANDARDS/CONST_STANDARDS.HTML. SEEDING AND SODDING MAY ONLY BE USED FROM MAY 1ST TO SEPTEMBER 15TH OF ANY YEAR. TEMPORARY SEED SHALL BE USED AFTER SEPTEMBER 15. IF TEMPORARY SEEDING IS USED, A PERMANENT COVER SHALL ALSO BE REQUIRED AS PART OF THE FINAL SITE STABILIZATION.
- 15. FOR THE FIRST SIX (6) WEEKS AFTER THE INITIAL STABILIZATION OF A DISTURBED AREA, WATERING SHALL BE PERFORMED WHENEVER MORE THAN SEVEN (7) DAYS OF DRY WEATHER ELAPSE.

EMERGENCY CONTACT JEREMY VASKE 1314 EMIL STREET MADISON, WI 53713

PHONE: 608-257-2289 CELL: 608-438-4450

FAX: 608-257-2906 EMAIL: jeremy@sullivandesignbuild.com

SCHEDULE:

JULY 7,2025 BEGIN DISTURBANCE OF SITE GROUND COVER.

AUGUST 15, 2025 BASE COURSE INSTALLED IN SOUTHERN AND NORTHERN PARKING LOTS. RESTORE DISTURBED AREAS.

RESTORE DISTURBED AREAS AROUND BUILDING. BEGIN RETROFIT SEPTEMBER 15, 2025 OF EXISTING BIORETENTION BASIN

NOVEMBER 15, 2025 ALL DISTURBED AREAS STABILIZED

GENERAL NOTES:

- 1. ALL PRIVATE UTILITIES (GAS, ELECTRIC, AND TELECOMMUNICATIONS) SERVING EXISTING BUILDINGS SCHEDULED FOR DEMOLITION TO BE ABANDONED OR REMOVED BY CORRESPONDING UTILITY COMPANY.
- 2. IT IS THE CONTRACTOR'S RESPONSIBILITY TO VERIFY THE LOCATION OF UNDERGROUND UTILITIES. UTILITIES WERE LOCATED BY OBSERVED EVIDENCE, MARKINGS PROVIDED BY DIGGER'S HOTLINE, AND RECORD DRAWINGS FROM THE CITY OF MADISON.
- 3. CONTRACTOR SHALL VERIFY THE SIZE, TYPE, SLOPE, AND INVERTS OF ALL EXISTING STORM AND SANITARY LATERALS CALLED OUT TO BE CONNECTED TO. CONTRACTOR SHALL SUBMIT THE INFORMATION ON THE PIPES TO THE CITY INSPECTOR AND PROJECT CIVIL ENGINEER.
- 4. ANY SIDEWALK, CURB, OR OTHER PUBLIC PROPERTY DAMAGED AS PART OF THE CONSTRUCTION OF THE UTILITIES AND BUILDING SHALL BE REPLACED IN-KIND PER THE CITY OF MADISON STANDARD SPECIFICATIONS.
- 5. THE RIGHT-OF-WAY IS THE SOLE JURISDICTION OF THE CITY OF MADISON AND IS SUBJECT TO CHANGE AT ANY TIME PER THE RECOMMENDATION/PLAN OF THE
- 6. CONTRACTOR SHALL INSTALL TREE PROTECTION FENCING IN THE AREA BETWEEN THE CURB AND SIDEWALK AND EXTEND IT AT LEAST 5 FEET FROM BOTH SIDES OF THE TREE ALONG THE LENGTH OF THE TERRACE. NO EXCAVATION IS PERMITTED WITHIN 5 FEET OF THE OUTSIDE EDGE OF A TREE TRUNK. IF EXCAVATION WITHIN 5 FEET OF ANY TREE IS NECESSARY, CONTRACTOR SHALL CONTACT CITY FORESTRY (266-4816) PRIOR TO EXCAVATION TO ASSESS THE IMPACT TO THE TREE AND ROOT SYSTEM. TREE PRUNING SHALL BE COORDINATED WITH CITY FORESTRY PRIOR TO THE START OF CONSTRUCTION. TREE PROTECTION SPECIFICATIONS CAN BE FOUND IN SECTION 107.13 OF CITY OF MADISON STANDARD SPECIFICATIONS FOR PUBLIC WORKS CONSTRUCTION http://www.cityofmadison.com/business/pw/documents/stdspecs/2018/part1.pdf. ANY TREE REMOVALS THAT ARE REQUIRED FOR CONSTRUCTION AFTER THE DEVELOPMENT PLAN IS APPROVED WILL REQUIRE AT LEAST À 72 HOUR WAIT PERIOD BEFORE A TREE REMOVAL PERMIT CAN BE ISSUED BY FORESTRY, TO NOTIFY THE ALDER OF THE CHANGE IN THE TREE PLAN.
- 7. CONTRACTOR SHALL BE RESPONSIBLE FOR SITE SAFETY DURING THE CONSTRUCTION OF IMPROVEMENTS.

DEMOLITION NOTES:

- 1. THE CONTRACTOR IS RESPONSIBLE FOR THE DEMOLITION, REMOVAL, AND DISPOSING IN A LOCATION APPROVED BY ALL GOVERNING AUTHORITIES, OF ALL STRUCTURES, PADS, WALLS, FLUMES, FOUNDATIONS, PARKING DRIVES, DRAINAGE, STRUCTURES, UTILITIES, ETC., SUCH THAT THE IMPROVEMENTS SHOWN ON THE REMAINING PLANS CAN BE CONSTRUCTED. ALL FACILITIES TO BE REMOVED SHALL BE UNDERCUT TO SUITABLE MATERIAL AND BROUGHT TO GRADE WITH SUITABLE COMPACTED FILL MATERIAL PER THE SPECIFICATIONS.
- 2. THE CONTRACTOR IS RESPONSIBLE FOR OBTAINING ALL PERMITS REQUIRED FOR DEMOLITION AND DISPOSAL.
- 3. THE CONTRACTOR SHALL COORDINATE WITH THE RESPECTIVE UTILITY COMPANIES PRIOR TO THE REMOVAL AND/OR RELOCATION OF UTILITIES. THE CONTRACTOR SHALL COORDINATE WITH THE UTILITY COMPANY CONCERNING PORTIONS OF WORK WHICH MAY BE PERFORMED BY THE UTILITY COMPANY FORCING ANY FEES WHICH ARE TO BE PAID TO THE UTILITY COMPANY FOR THEIR SERVICES. THE DEVELOPER IS RESPONSIBLE FOR PAYING ALL FEES AND CHARGES.
- 4. THE LOCATIONS OF ALL EXISTING UTILITIES SHOWN ON THIS PLAN HAVE BEEN DETERMINED FROM THE BEST INFORMATION AVAILABLE AND ARE GIVEN FOR THE CONVENIENCE OF THE CONTRACTOR. THE ENGINEER ASSUMES NO RESPONSIBILITY FOR THEIR ACCURACY. PRIOR TO THE START OF ANY DEMOLITION ACTIVITY, THE CONTRACTOR SHALL NOTIFY THE UTILITY COMPANIES FOR ONSITE LOCATIONS OF EXISTING UTILITIES. NOTIFY THE ENGINEER OF ANY DISCREPANCIES.
- 5. ALL EXISTING SEWERS, PIPING, AND UTILITIES SHOWN ARE NOT TO BE INTERPRETED AS THE EXACT LOCATION, OR AS THE ONLY OBSTACLES THAT MAY OCCUR ON THE SITE. VERIFY EXISTING CONDITIONS AND PROCEED WITH CAUTION AROUND ANY ANTICIPATED FEATURES. GIVE NOTICE TO ALL UTILITY COMPANIES REGARDING DESTRUCTION AND REMOVAL OF ALL SERVICE LINES BEFORE PROCEEDING WITH THE WORK. UTILITIES DETERMINED TO BE ABANDONED AND LEFT IN PLACE SHALL BE GROUTED IF UNDER BUILDINGS.
- 6. ELECTRICAL, TELEPHONE, CABLE, WATER, FIBER OPTIC CABLE, AND/OR GAS LINES NEEDING TO BE REMOVED OR RELOCATED SHALL BE COORDINATED WITH THE AFFECTED UTILITY COMPANY. ADEQUATE TIME SHALL BE PROVIDED FOR RELOCATION AND CLOSE COORDINATION WITH THE UTILITY COMPANY IS NECESSARY TO PROVIDE A SMOOTH TRANSITION IN UTILITY SERVICE.
- 7. CONTRACTOR SHALL PROTECT THE PUBLIC AT ALL TIMES WITH FENCING, BARRICADES, ENCLOSURES, COVERED WALKWAYS, ETC. CONTRACTOR SHALL SUBMIT THEIR STREET OCCUPANCY PLAN TO TRAFFIC ENGINEERING FOR APPROVAL.
- 8. PRIOR TO DEMOLITION OCCURRING, ALL APPLICABLE EROSION CONTROL DEVICES ARE TO BE INSTALLED.
- 9. THE CONTRACTOR MAY LIMIT SAWCUT AND PAVEMENT REMOVAL TO ONLY THOSE AREAS WHERE IT IS REQUIRED AS SHOWN ON THESE CONSTRUCTION PLANS, BUT IF ANY DAMAGE IS INCURRED ON ANY OF THE SURROUNDING PAVEMENT, ETC. THE CONTRACTOR SHALL BE RESPONSIBLE FOR ITS REMOVAL AND REPAIR IN KIND.
- 10. DAMAGE TO ALL EXISTING CONDITIONS TO REMAIN WILL BE REPLACED AT THE CONTRACTOR'S EXPENSE.
- 11. CONTINUOUS ACCESS SHALL BE MAINTAINED FOR THE SURROUNDING PROPERTIES AT ALL TIMES DURING DEMOLITION OF THE EXISTING FACILITIES.

SITE PLAN NOTES:

- 1. PAVEMENT DESIGN SHALL BE PER THE RECOMMENDATION OF THE SOILS CONSULTANT.
- 2. THE RIGHT-OF-WAY IS THE SOLE JURISDICTION OF THE CITY OF MADISON AND IS SUBJECT TO CHANGE AT ANY TIME PER THE RECOMMENDATION/PLAN OF TRAFFIC ENGINEERING AND CITY ENGINEERING DEPARTMENTS.
- 3. TRAFFIC CONTROL SIGNAGE SHALL BE IN ACCORDANCE WITH FEDERAL, STATE, COUNTY, CITY, AND LOCAL CODE, WHICHEVER HAS JURISDICTION.
- 4. CITY SIDEWALK AND CURB DAMAGED IN THE COURSE OF CONSTRUCTION TO BE REPLACED PER GRADING PLAN AND PER CITY OF MADISON STANDARD SPECIFICATIONS.
- 5. NEW APRONS SHALL BE CONSTRUCTED AND PLACED IN CONFORMANCE WITH THE CITY OF MADISON STANDARD DETAIL 3.02 FOR COMMERCIAL OPENINGS.

GRADING PLAN NOTES:

1. ALL GRADES ARE FINISH ELEVATION UNLESS NOTED OTHERWISE.

UTILITY PLAN NOTES:

- 1. ALL WORK WITHIN THE CITY RIGHT OF WAY AND EASEMENTS SHALL BE COMPLIANT WITH THE CITY OF MADISON STANDARD SPECIFICATIONS CURRENT AT THE TIME
- 2. UTILITY INSTALLATION SHALL BE COORDINATED WITH ENGINEER AT LEAST 4 WEEKS PRIOR TO INSTALLATION TO ENSURE BUILDING INSPECTION APPROVAL IS
- 3. UTILITY INSTALLATION SHALL BE PER STANDARD SPECIFICATIONS FOR SEWER AND WATER CONSTRUCTION IN WISCONSIN, LATEST EDITION.

LEGEND/ ABBREVIATIONS

ACCESSIBLE ROUTE EXISTING EASEMENT PROPERTY BOUNDARY PARKING STALL COUNT LANDSCAPED AREA BITUMINOUS PAVEMENT CONC. CONCRETE PAVEMENT -1041.02 SPOT GRADE FINISH GRADE EXISTING GRADE SIDEWALK EDGE OF PAVEMENT FLOW LINE LOW POINT HIGH POINT TOP OF CURB TOP OF WALL BOTTOM OF WALL BOW BACK OF WALK FOW FRONT OF WALK EXPOSURE PROPOSED SANITARY SEWER —— ST —— PROPOSED STORM SEWER -____ UTILITY LINE DEMOLITION TREE REMOVAL EXISTING MINOR CONTOUR

— ·1041· — — - - 1040 - - EXISTING MAJOR CONTOUR ___ · · -__

PROPOSED MINOR CONTOUR PROPOSED MAJOR CONTOUR PROPOSED RIDGE LINE PROPOSED SWALE/DITCH

ACCESSIBLE PARKING SIGN (NO VISUAL OBSTRUCTIONS BETWEEN HEIGHTS OF 30" AND 10')

CONSTRUCTION ENTRANCE ---- DISTURBANCE LIMITS — — — — SILT FENCE

SILT SOCK CHECK DAM DIVERSION BERM

INLET PROTECTION


USLE FLOW PATH

2801 International Lane, Suite 10 Madison, WI 53704 Phone: 608-250-9263 Fax: 608-250-9266 e-mail: Mburse@BSE-INC.net www.bursesurveyengr.com MLE DBY:
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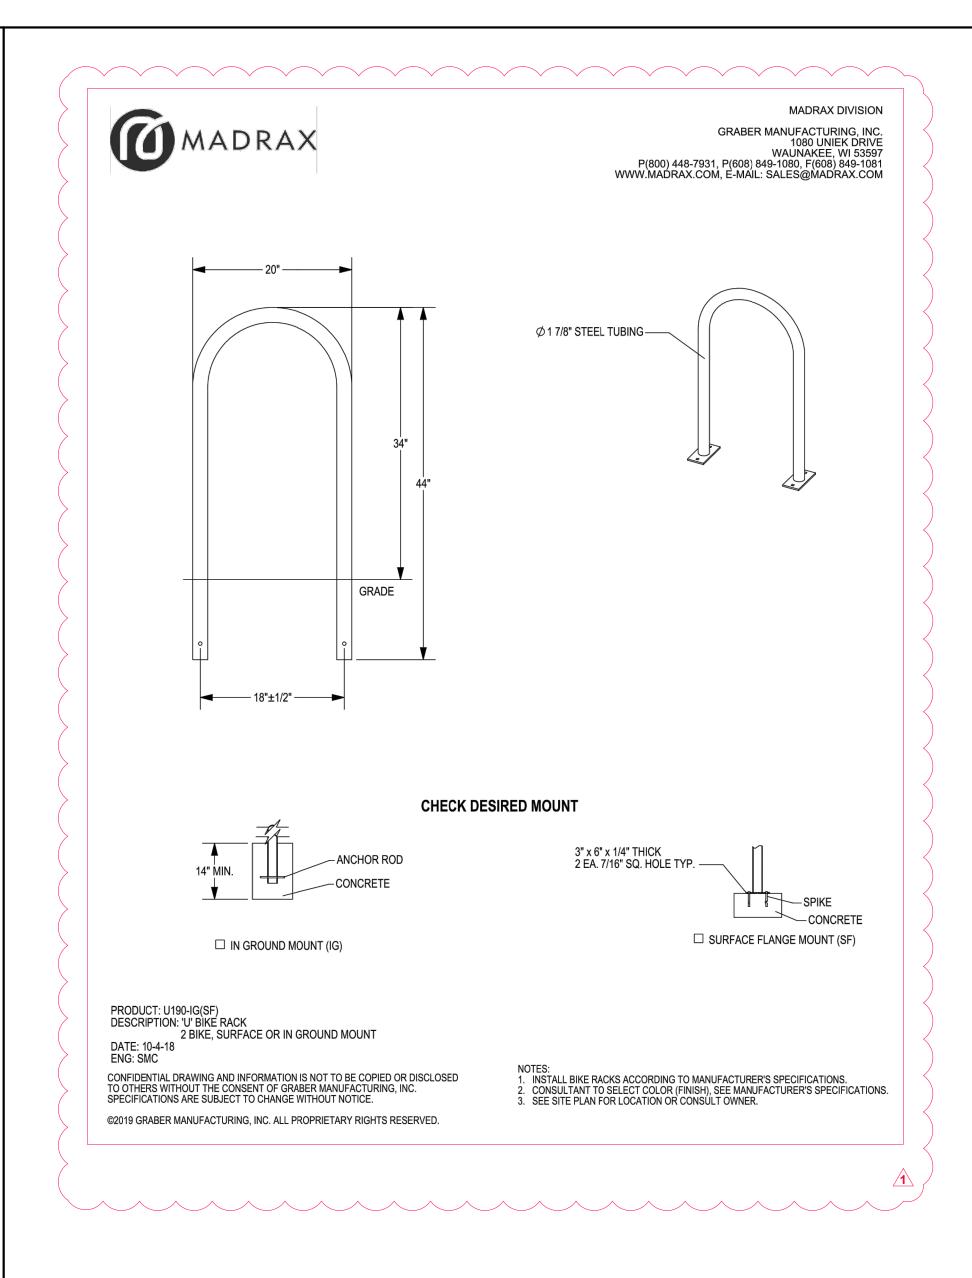
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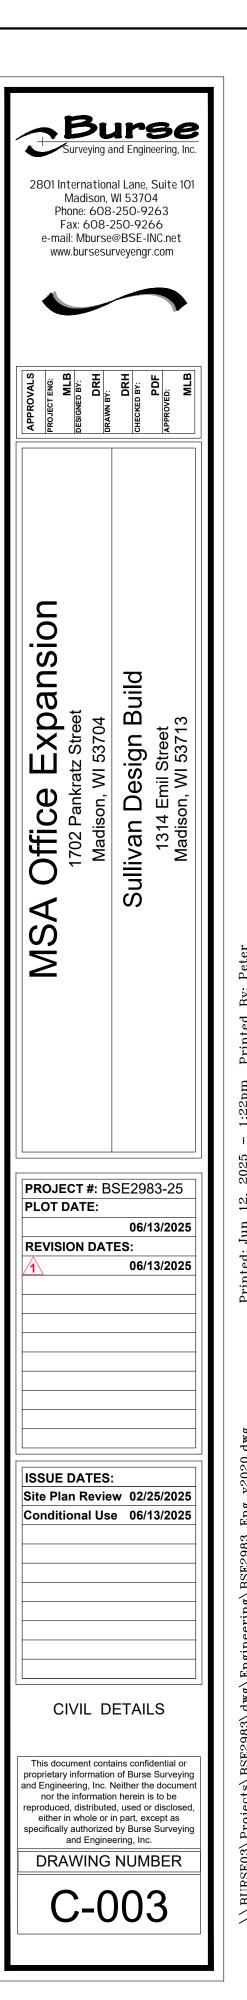
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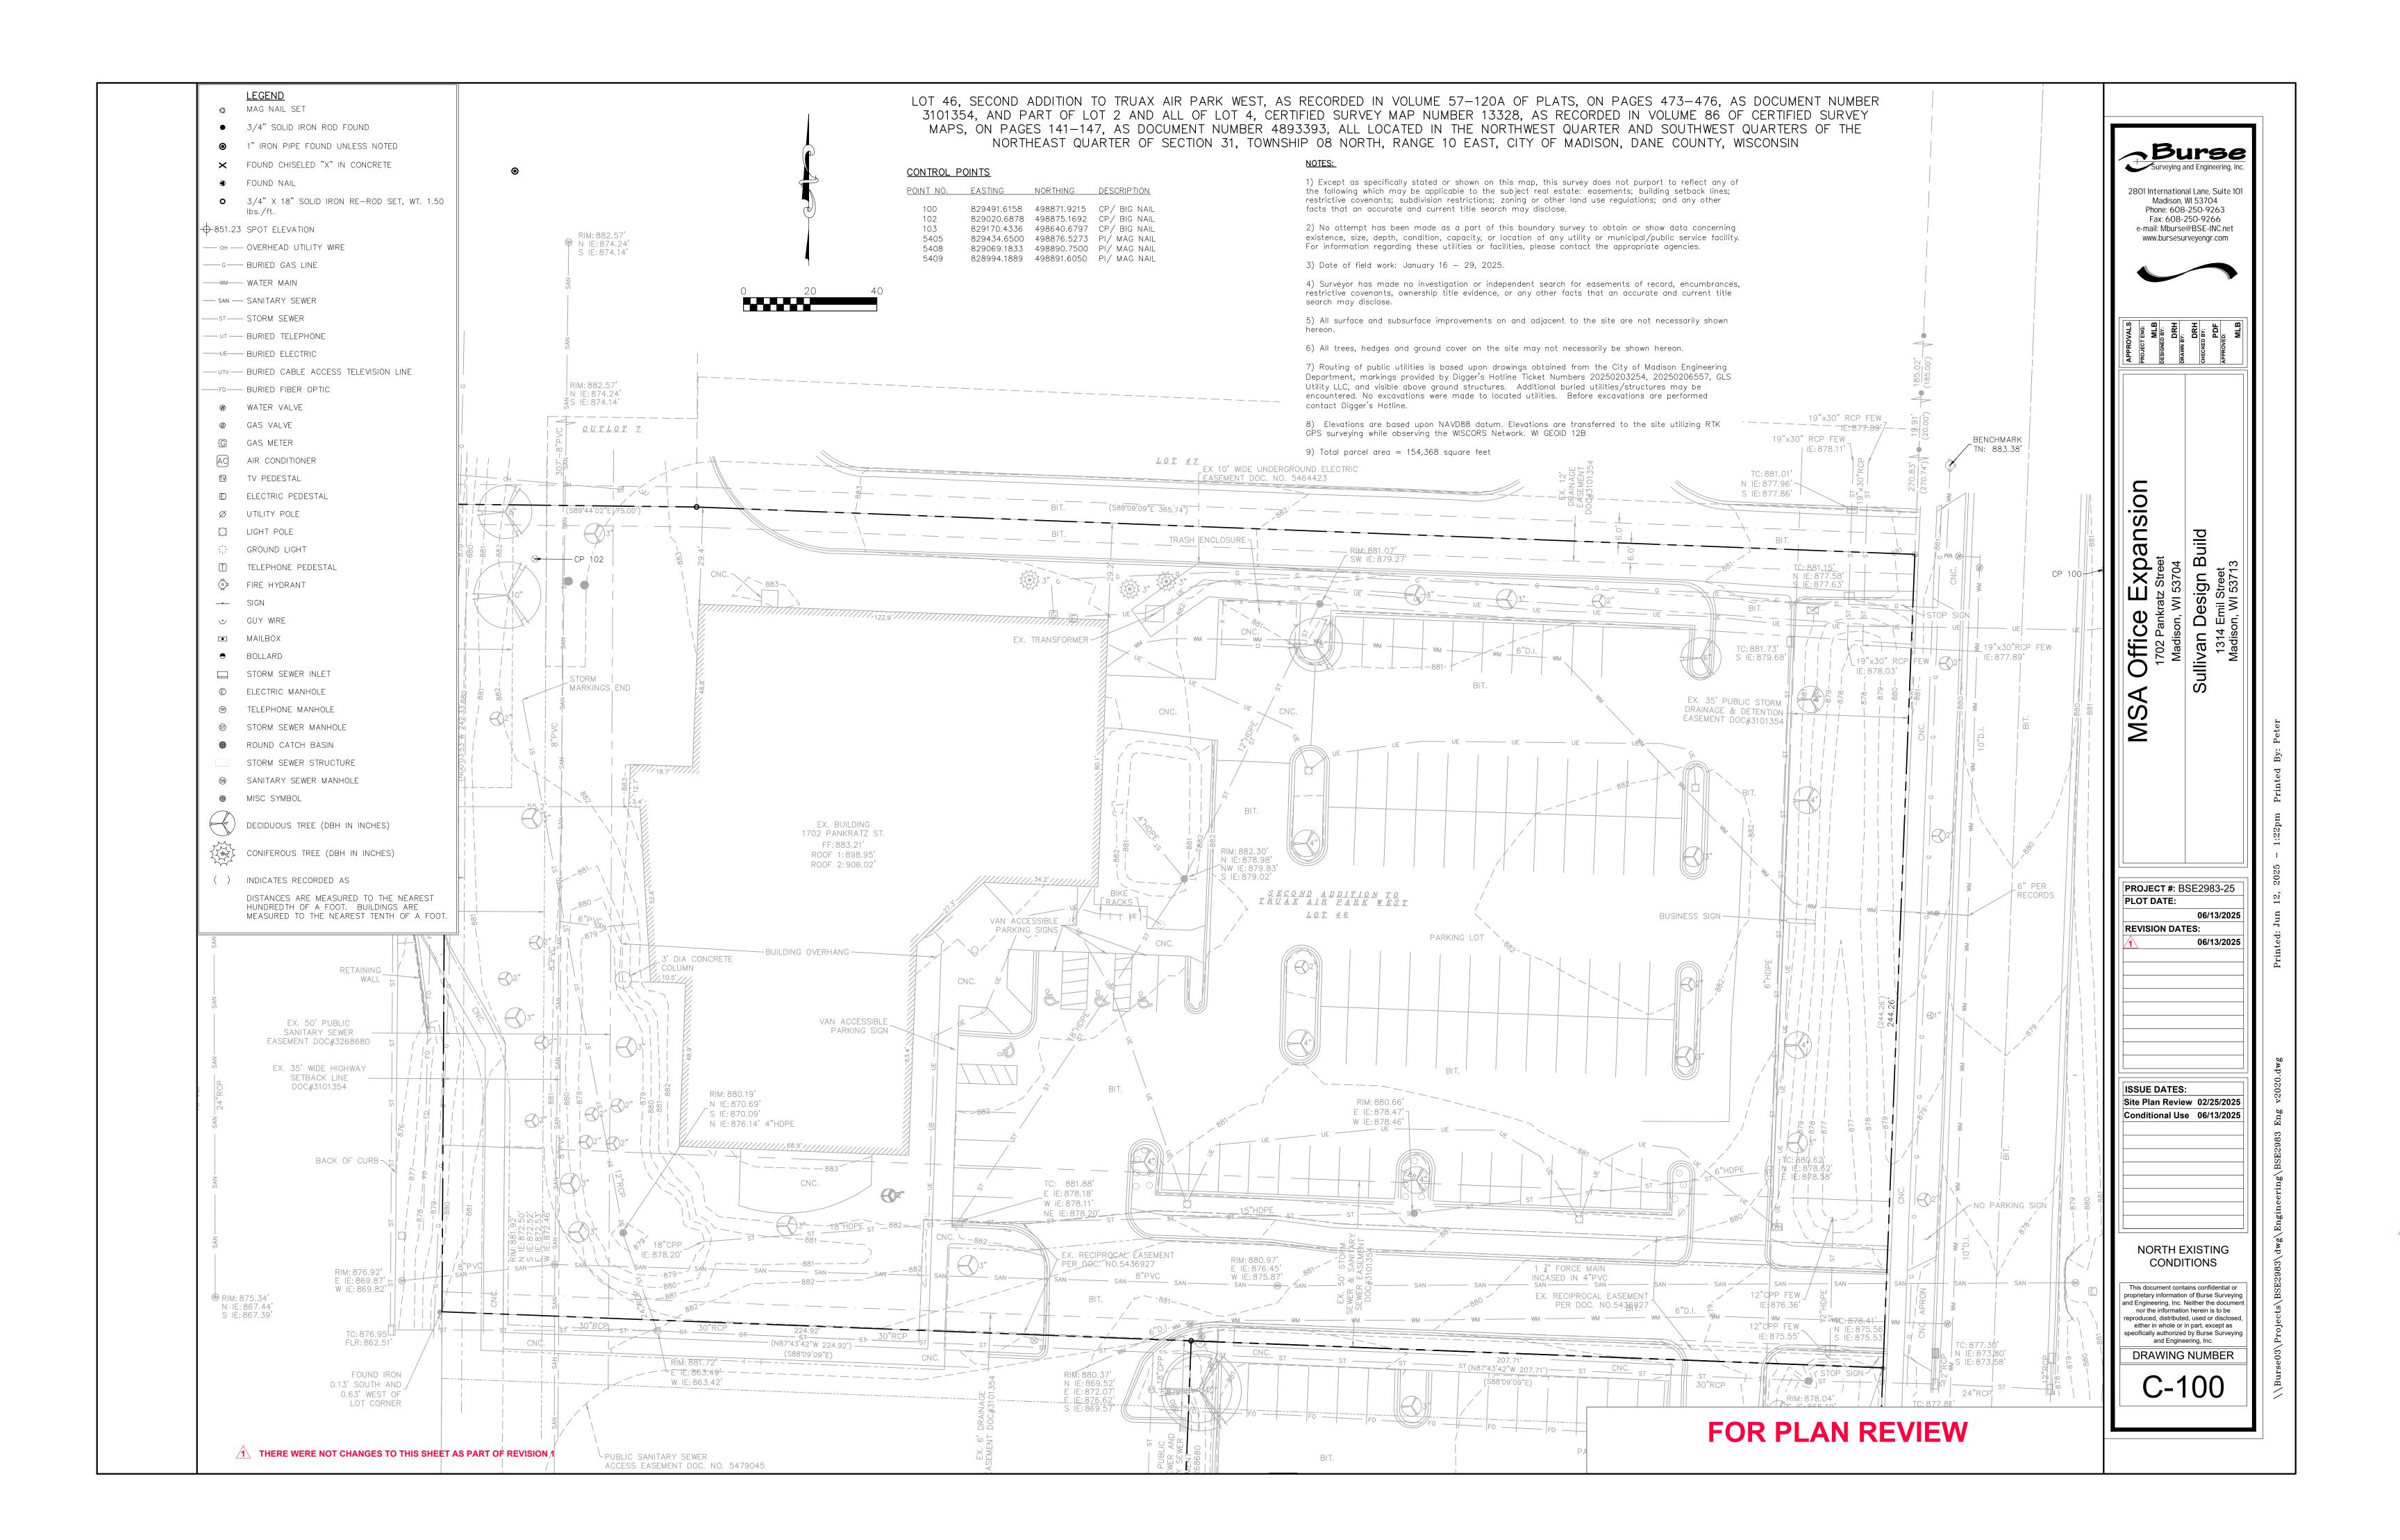
06/13/2025 06/13/2025 **ISSUE DATES:** Site Plan Review 02/25/2025 Conditional Use 06/13/2025 **CIVIL NOTES &** DETAILS This document contains confidential or proprietary information of Burse Surveying and Engineering, Inc. Neither the docume nor the information herein is to be reproduced, distributed, used or disclosed either in whole or in part, except as specifically authorized by Burse Surveying and Engineering, Inc. DRAWING NUMBER





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D Sullivan Des 1314 Emil Madison, W **PROJECT #**: BSE2983-25 PLOT DATE: 06/13/2025 **REVISION DATES:** 06/13/2025 ISSUE DATES: Site Plan Review 02/25/2025 Conditional Use 06/13/2025 CIVIL DETAILS This document contains confidential or proprietary information of Burse Surveying and Engineering, Inc. Neither the documen nor the information herein is to be reproduced, distributed, used or disclosed either in whole or in part, except as specifically authorized by Burse Surveying and Engineering, Inc. DRAWING NUMBER C-002




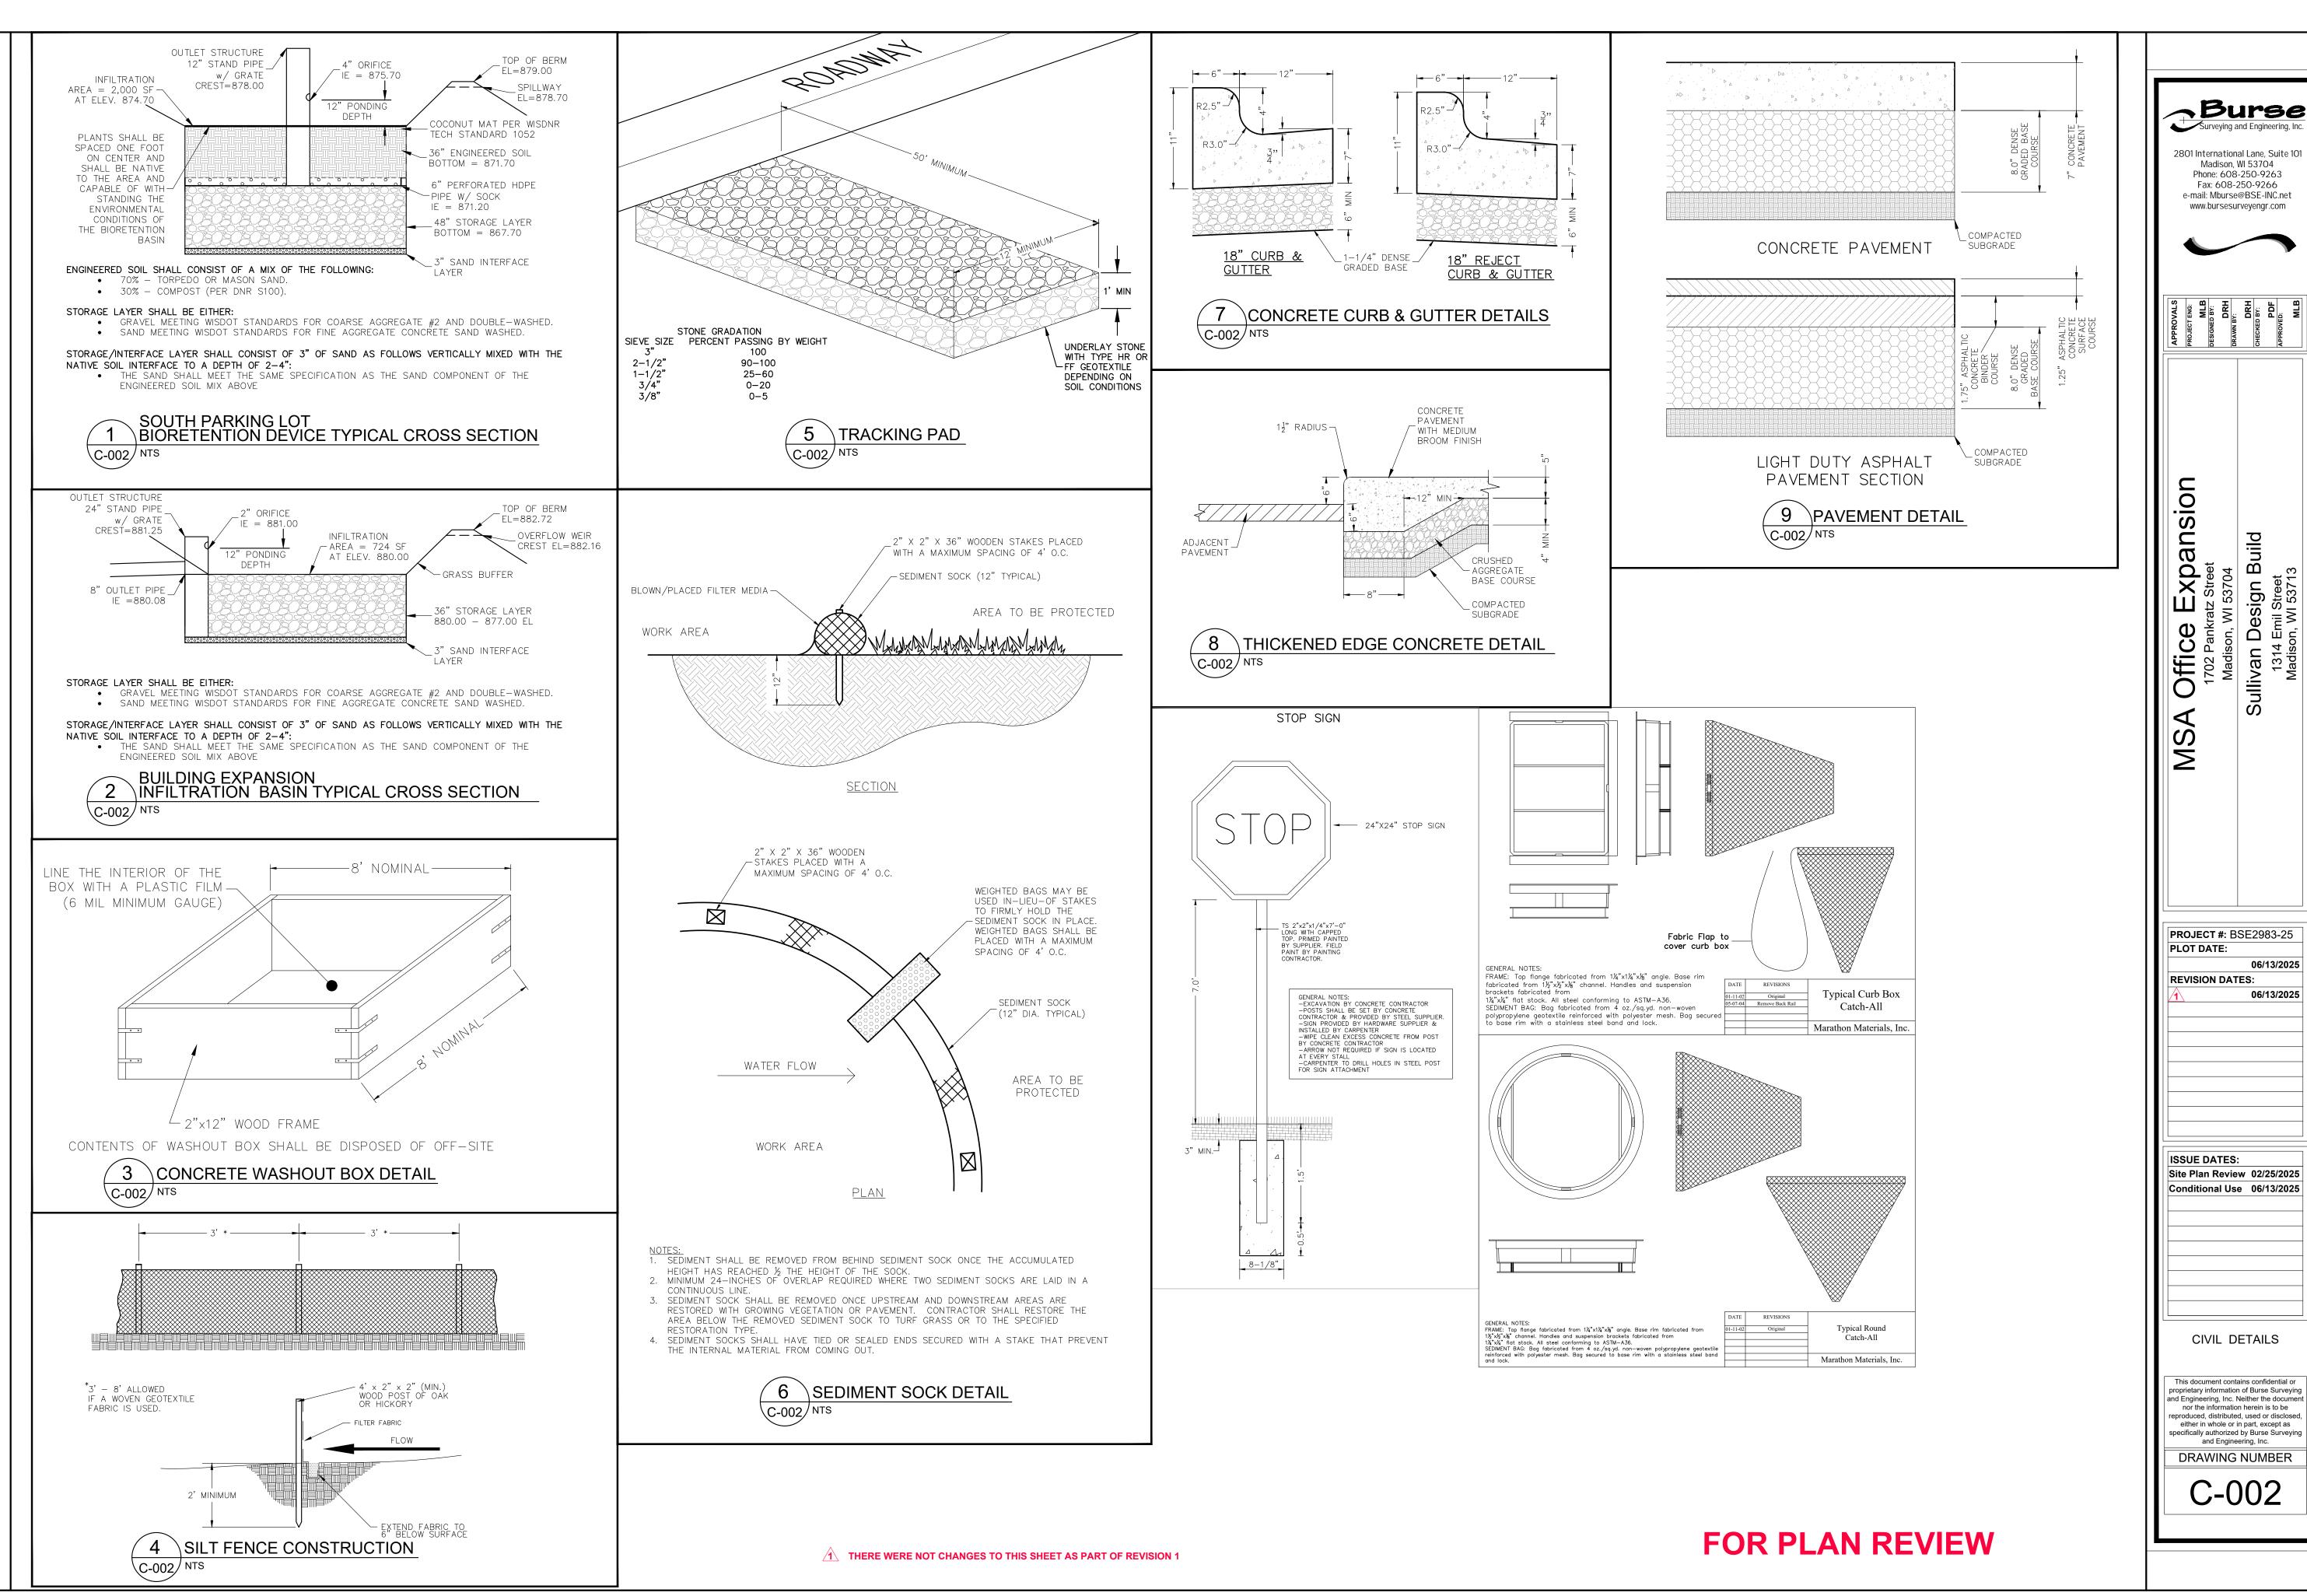





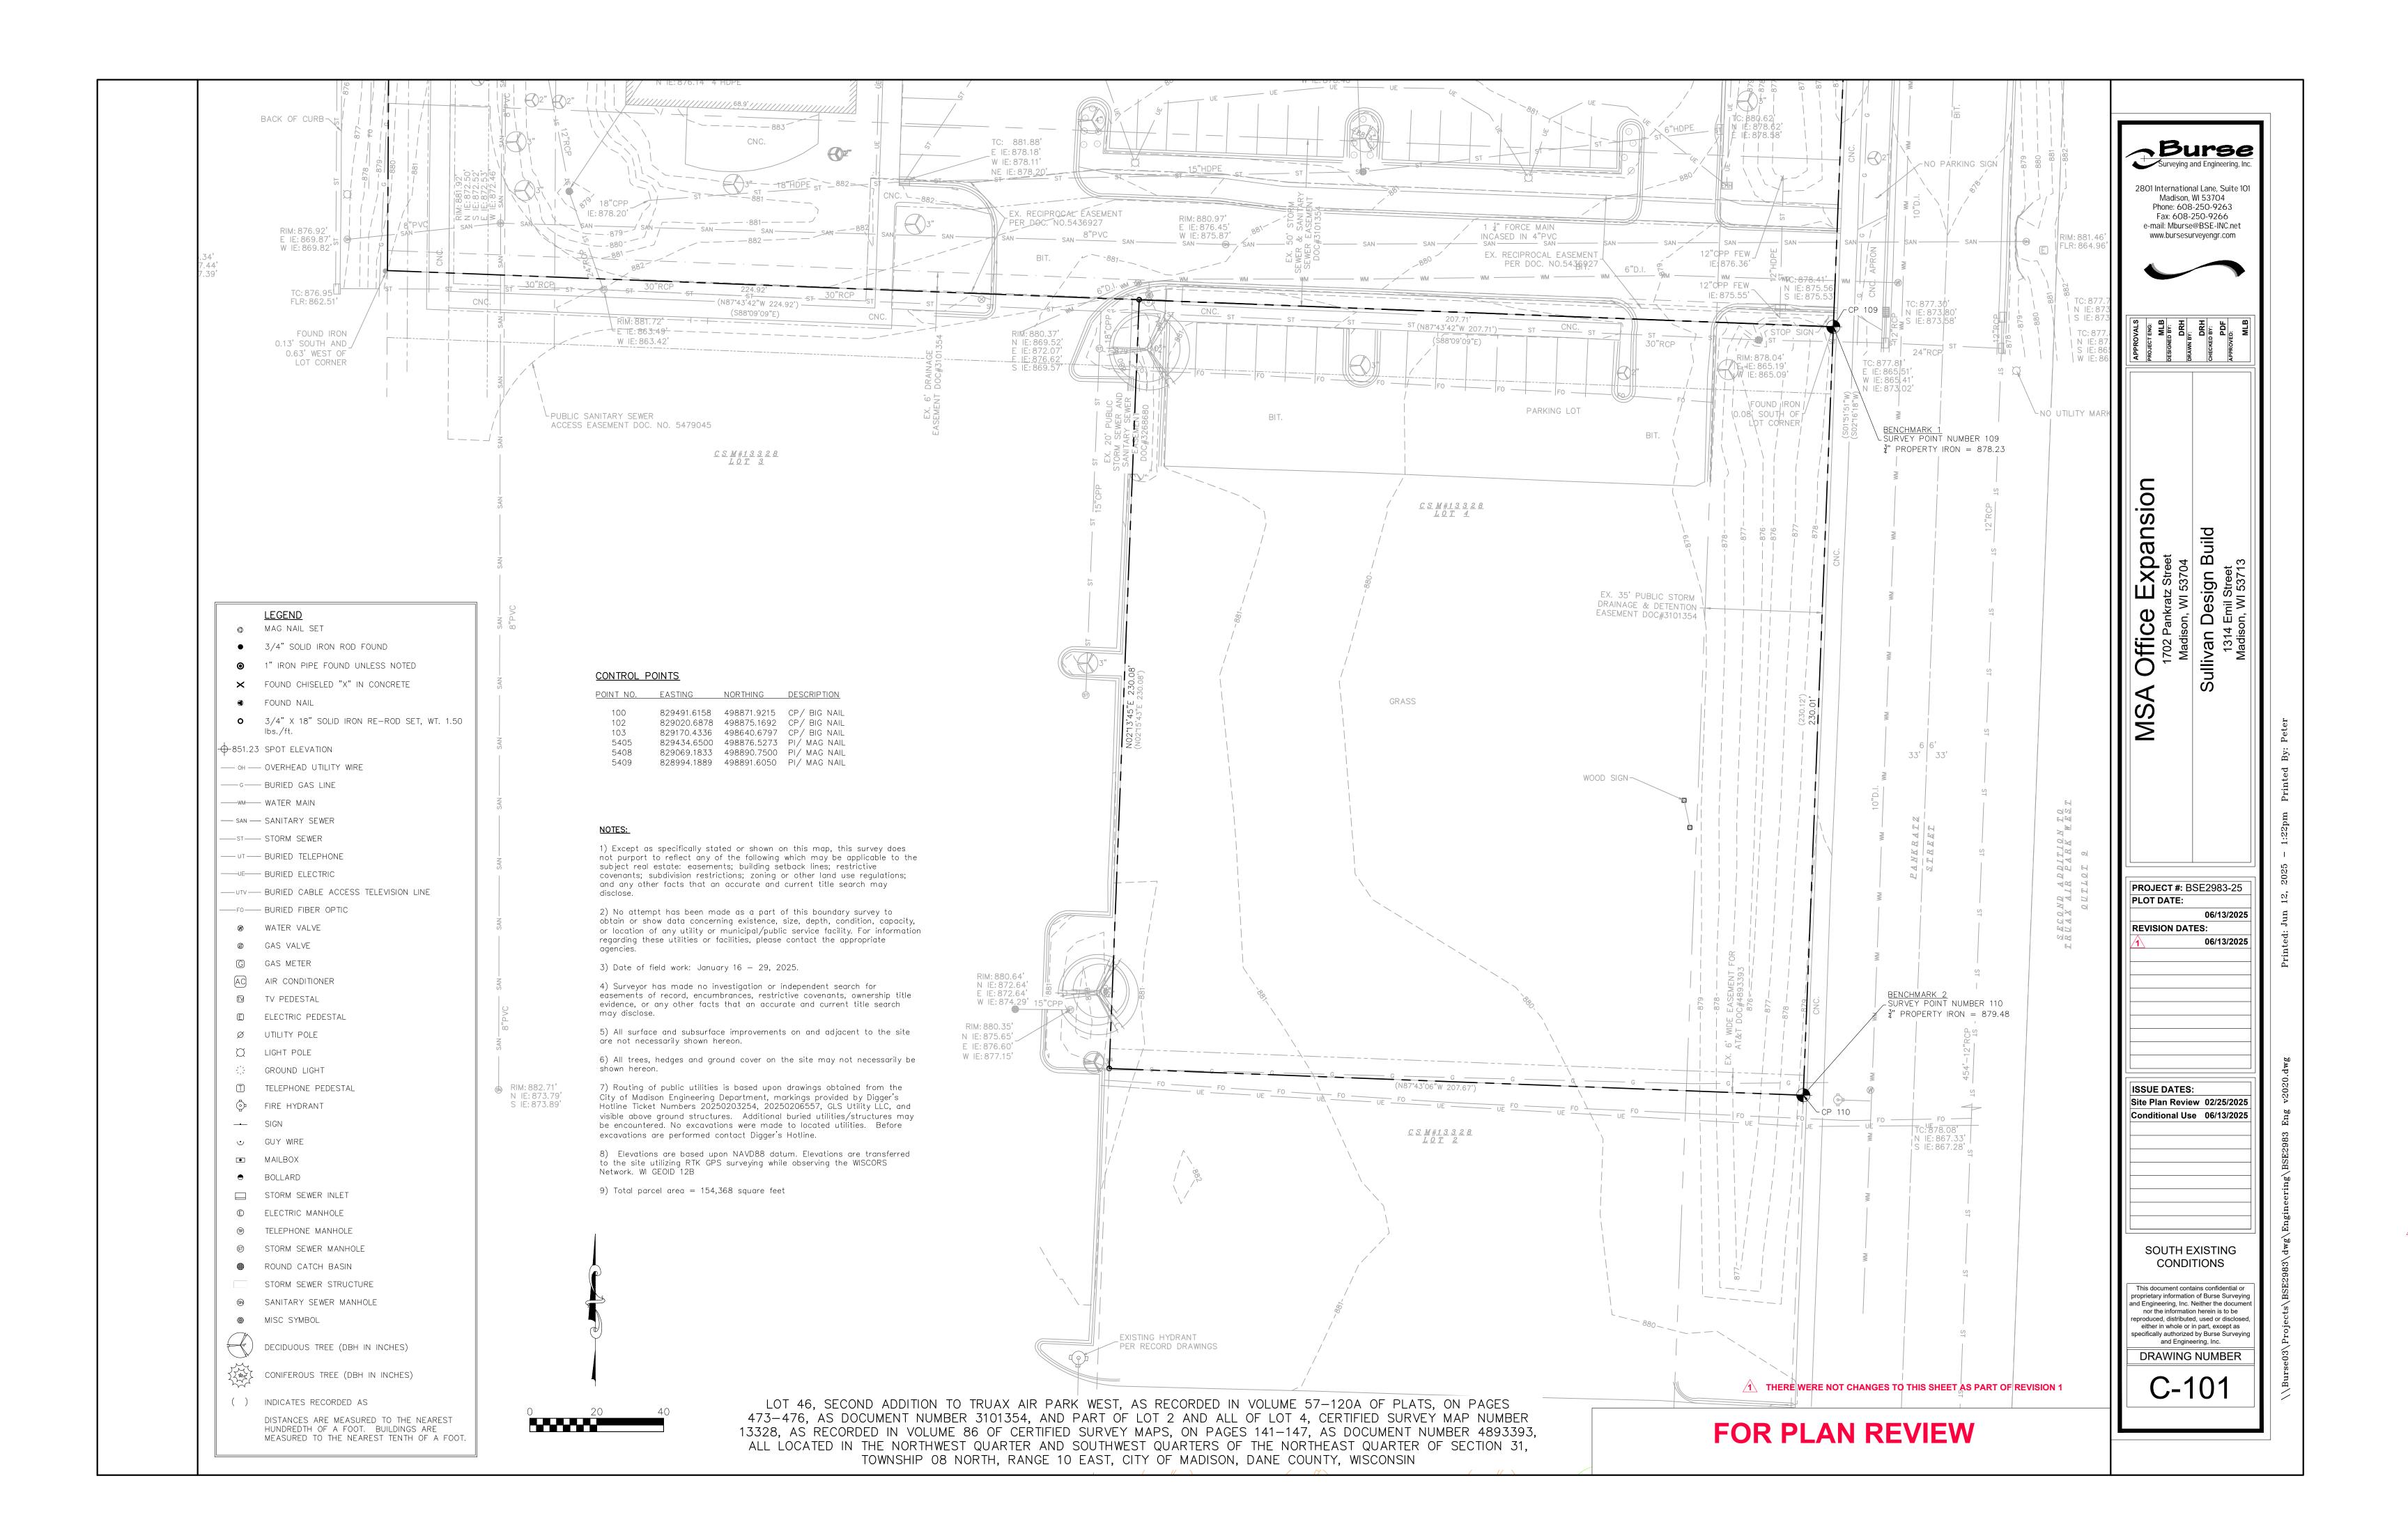


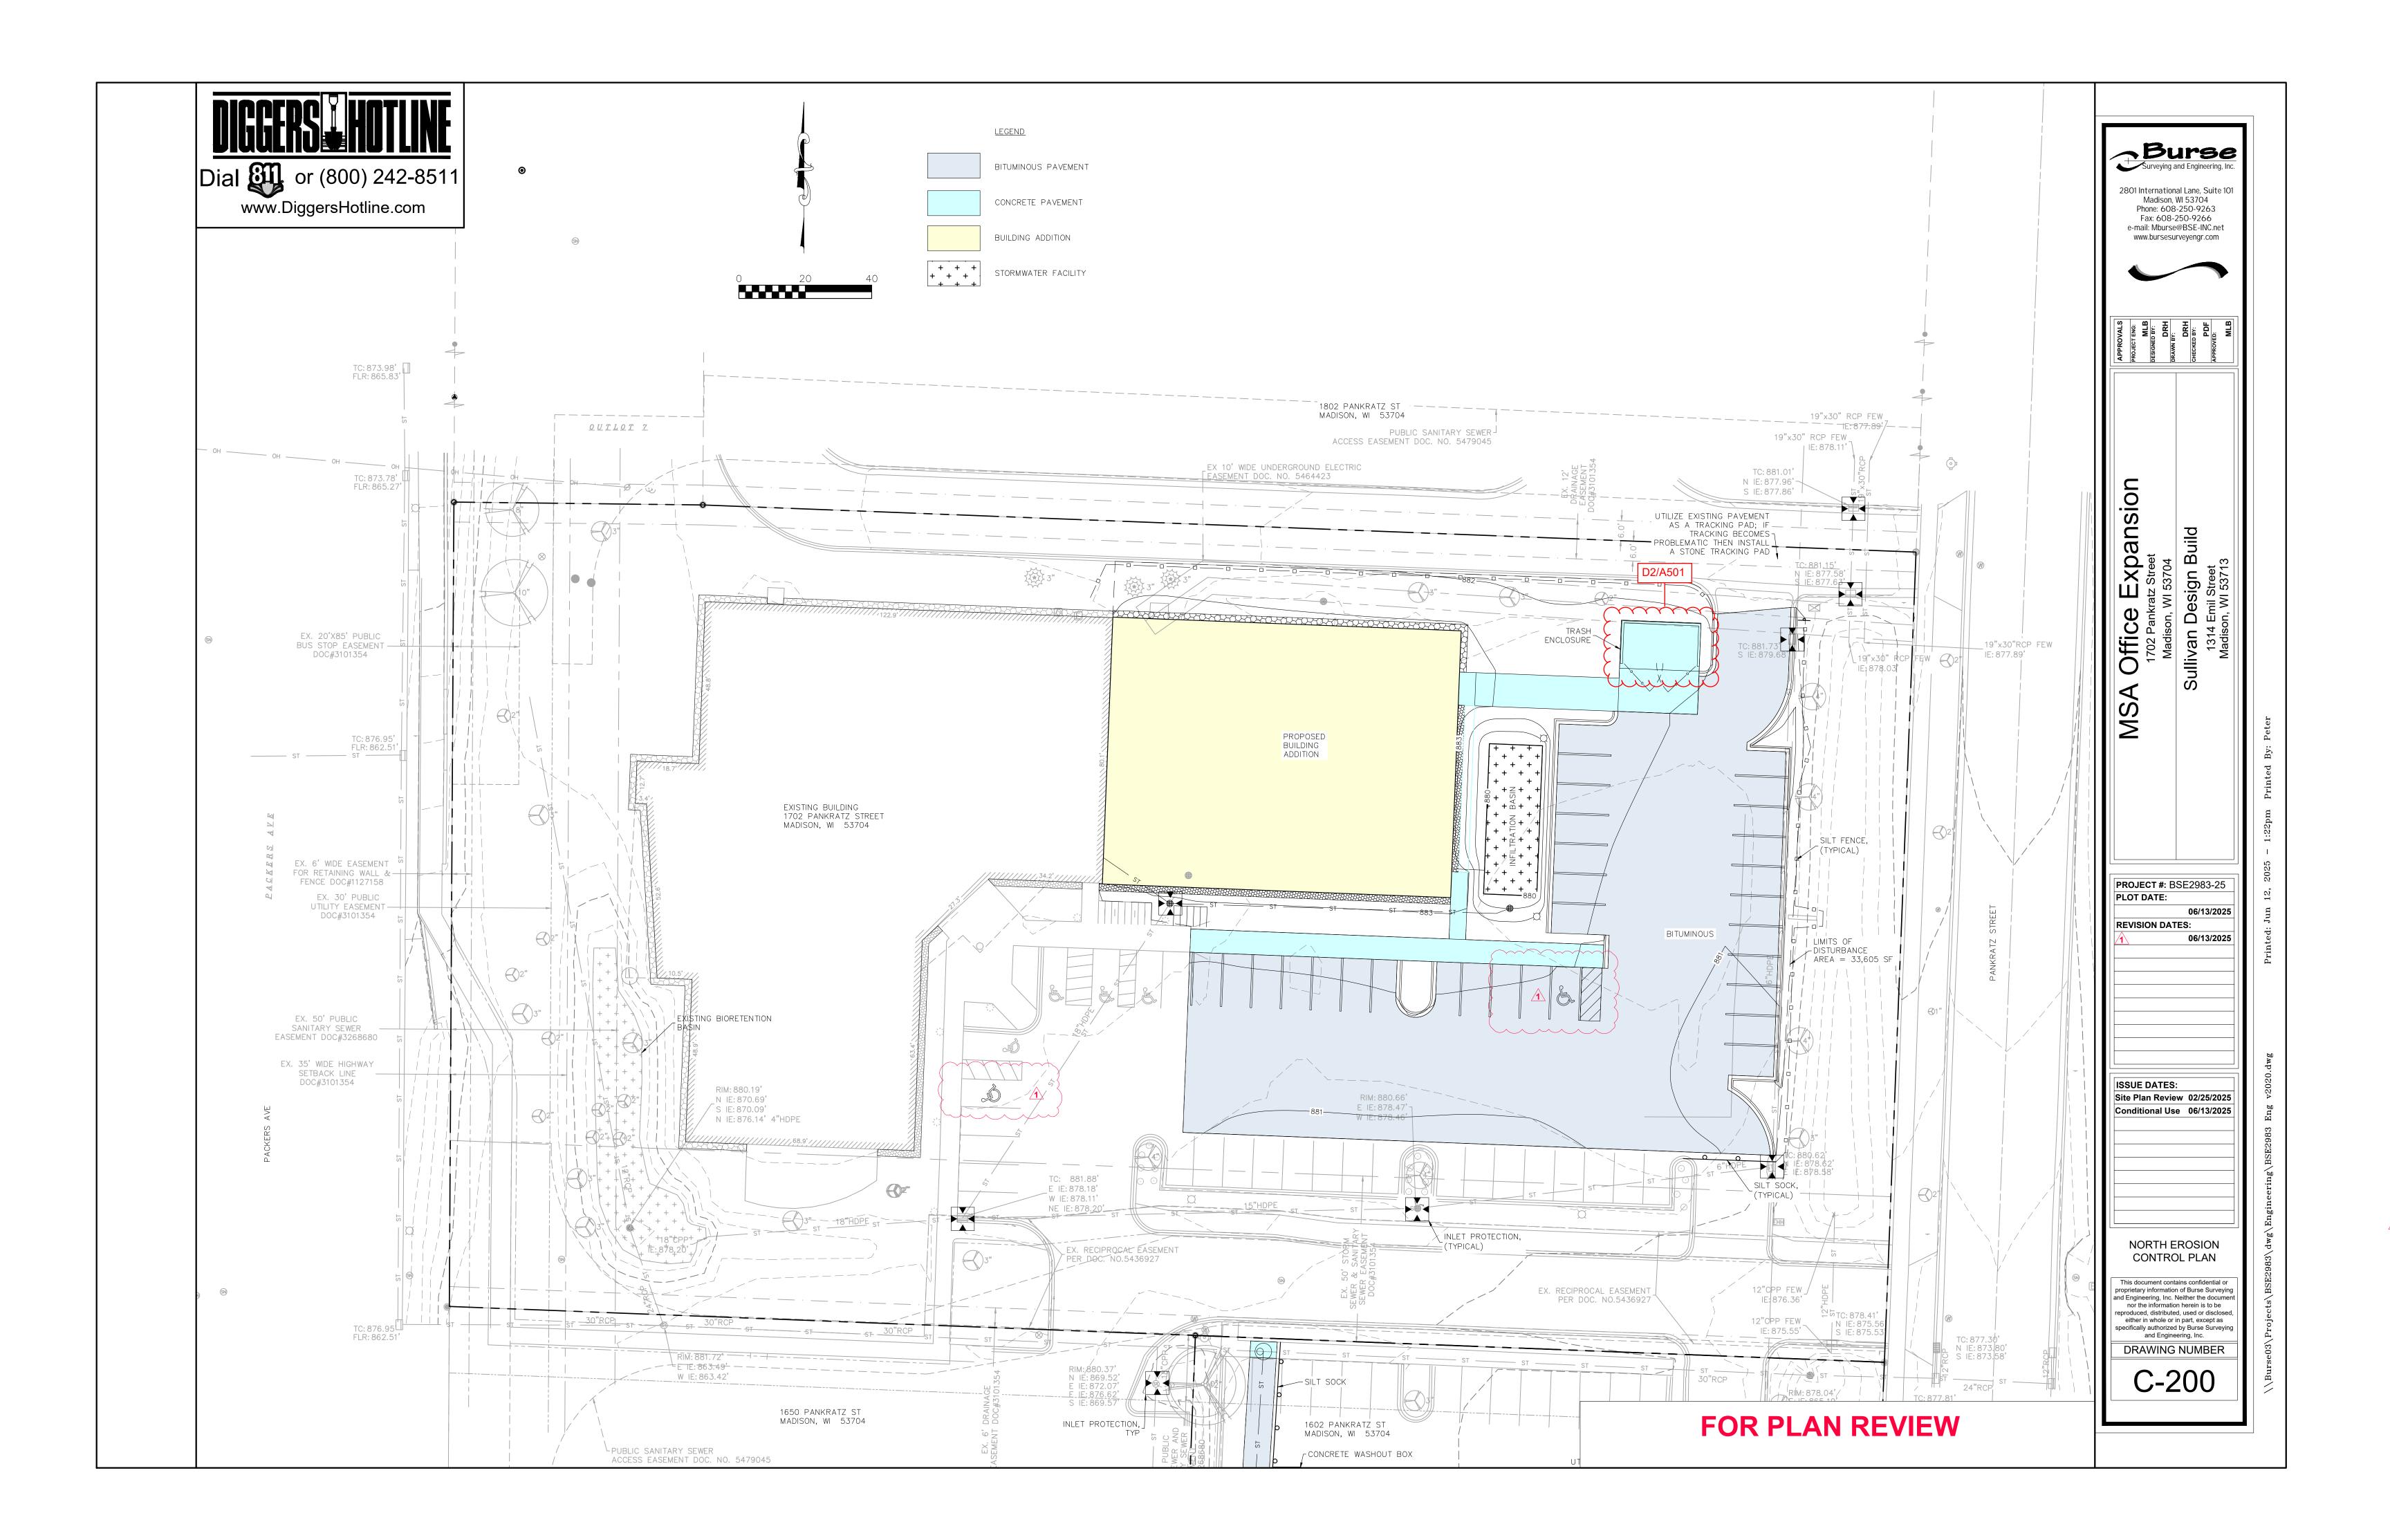


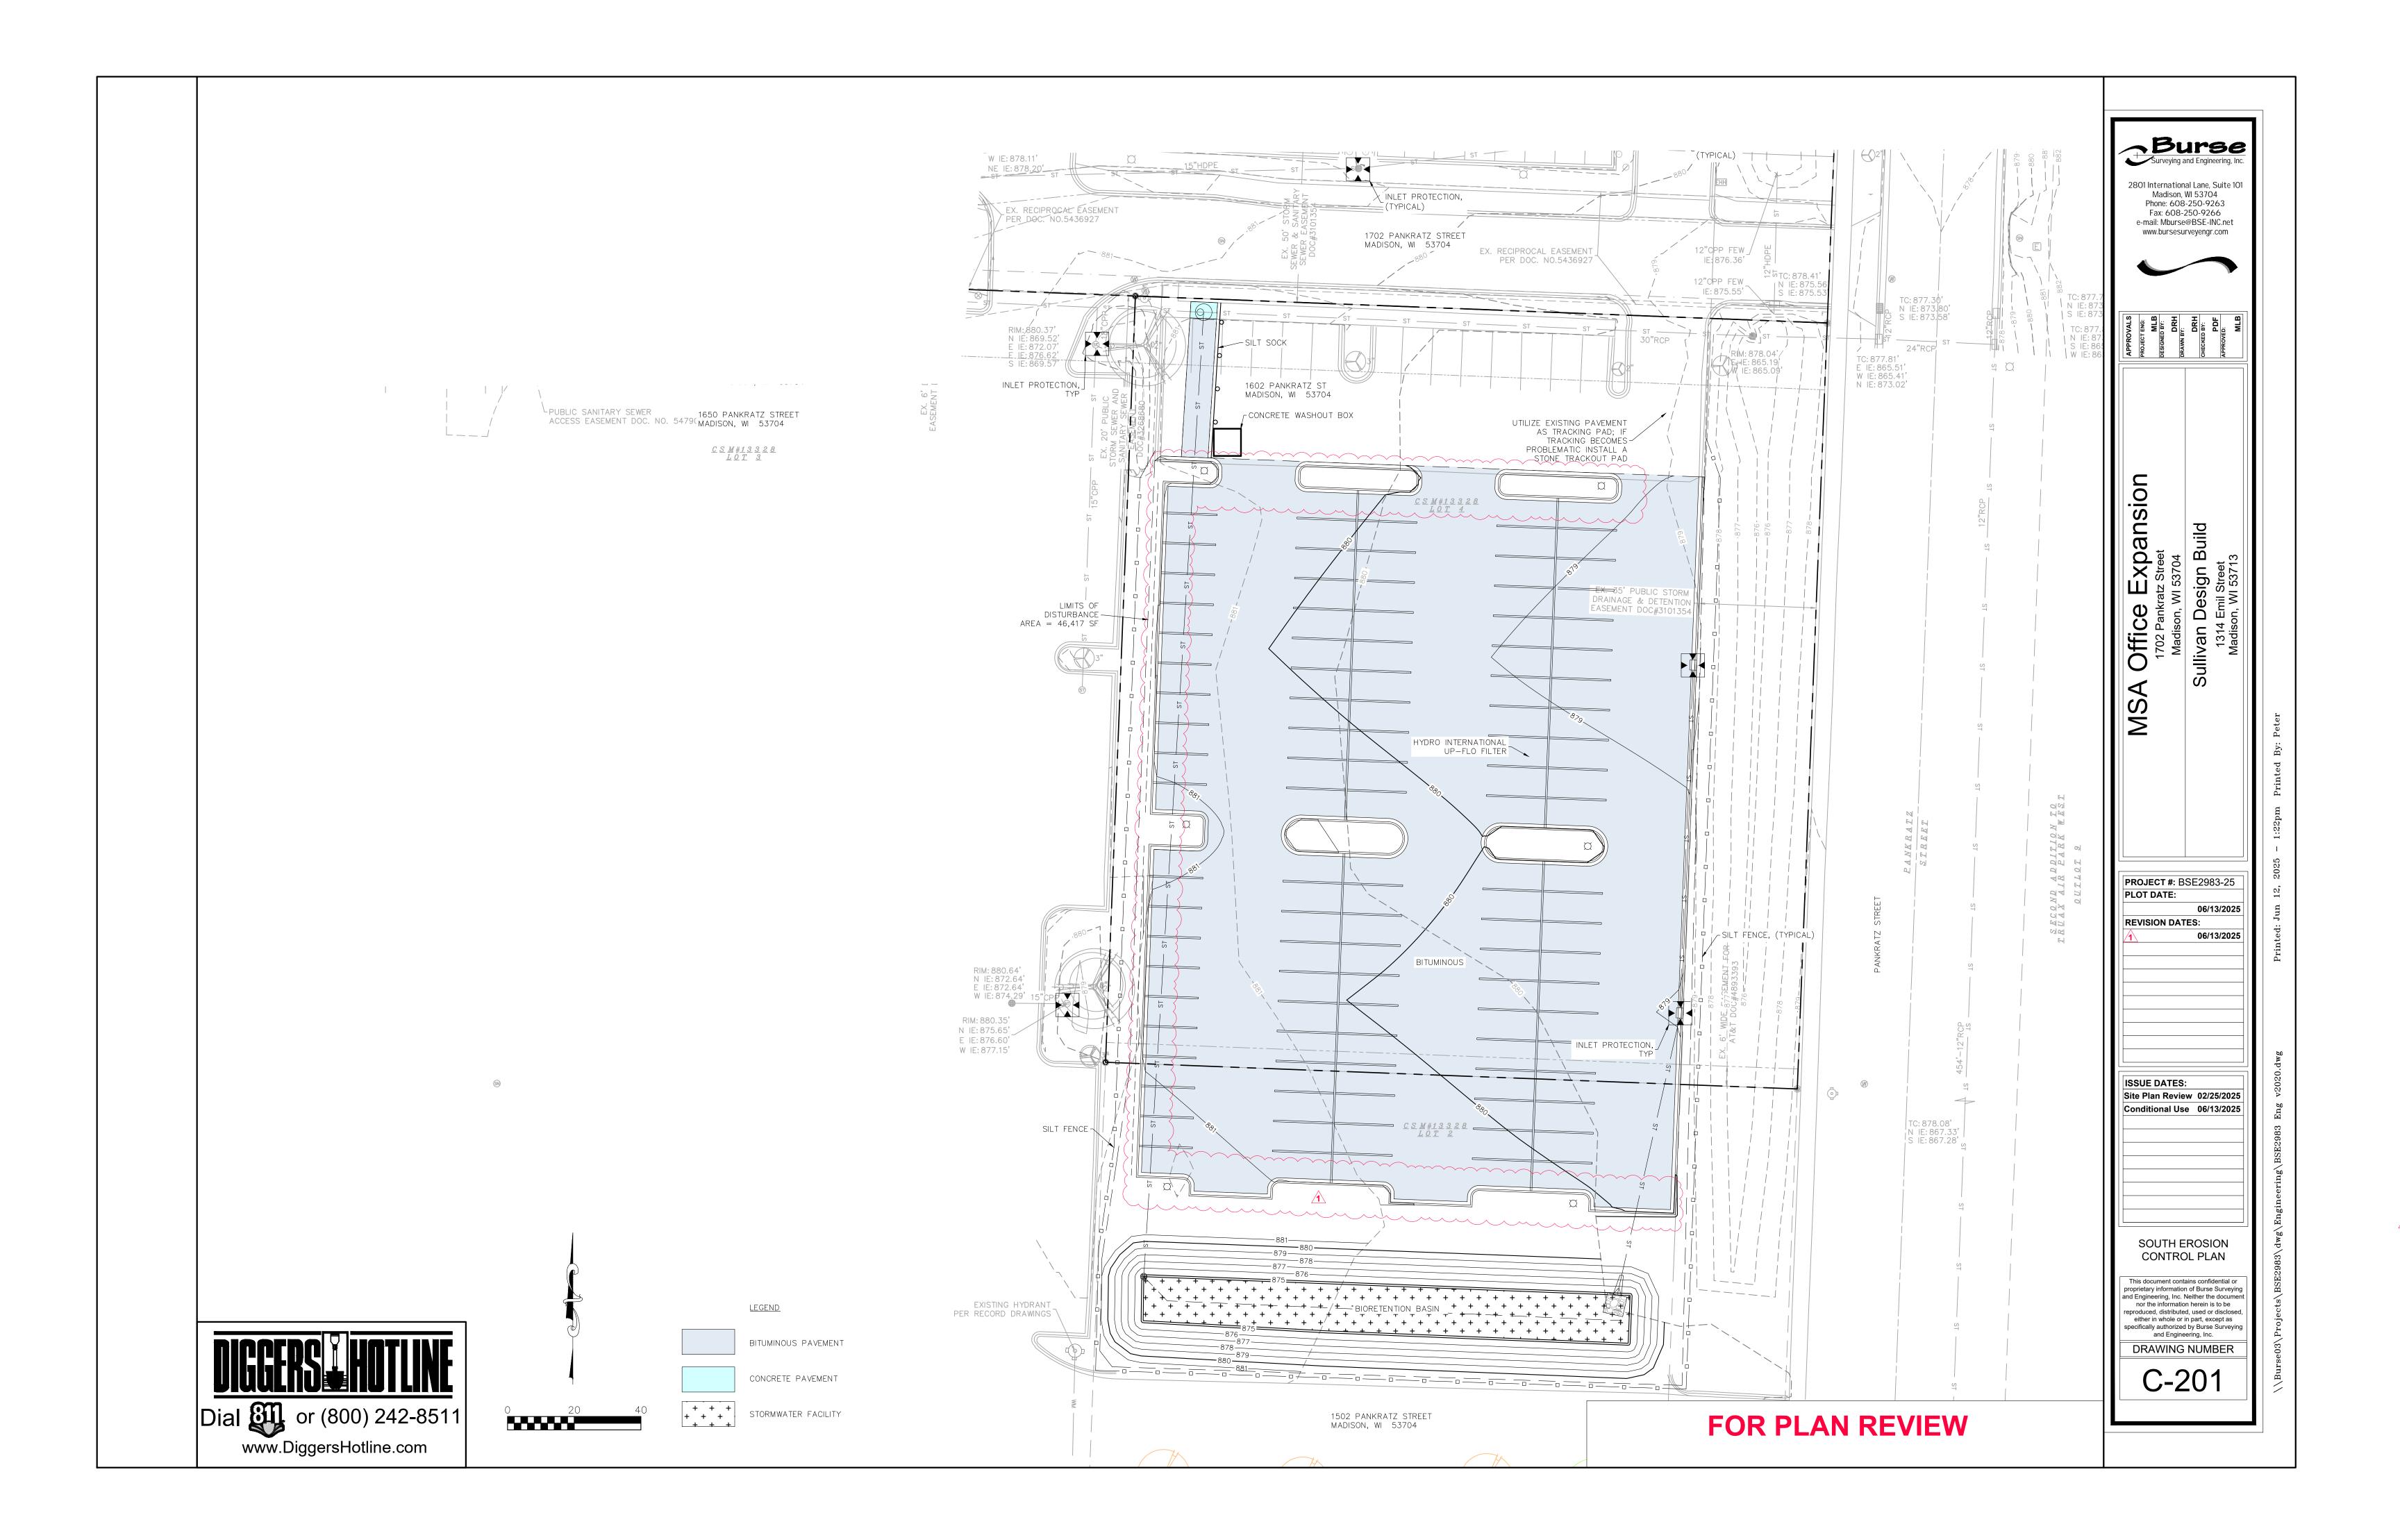


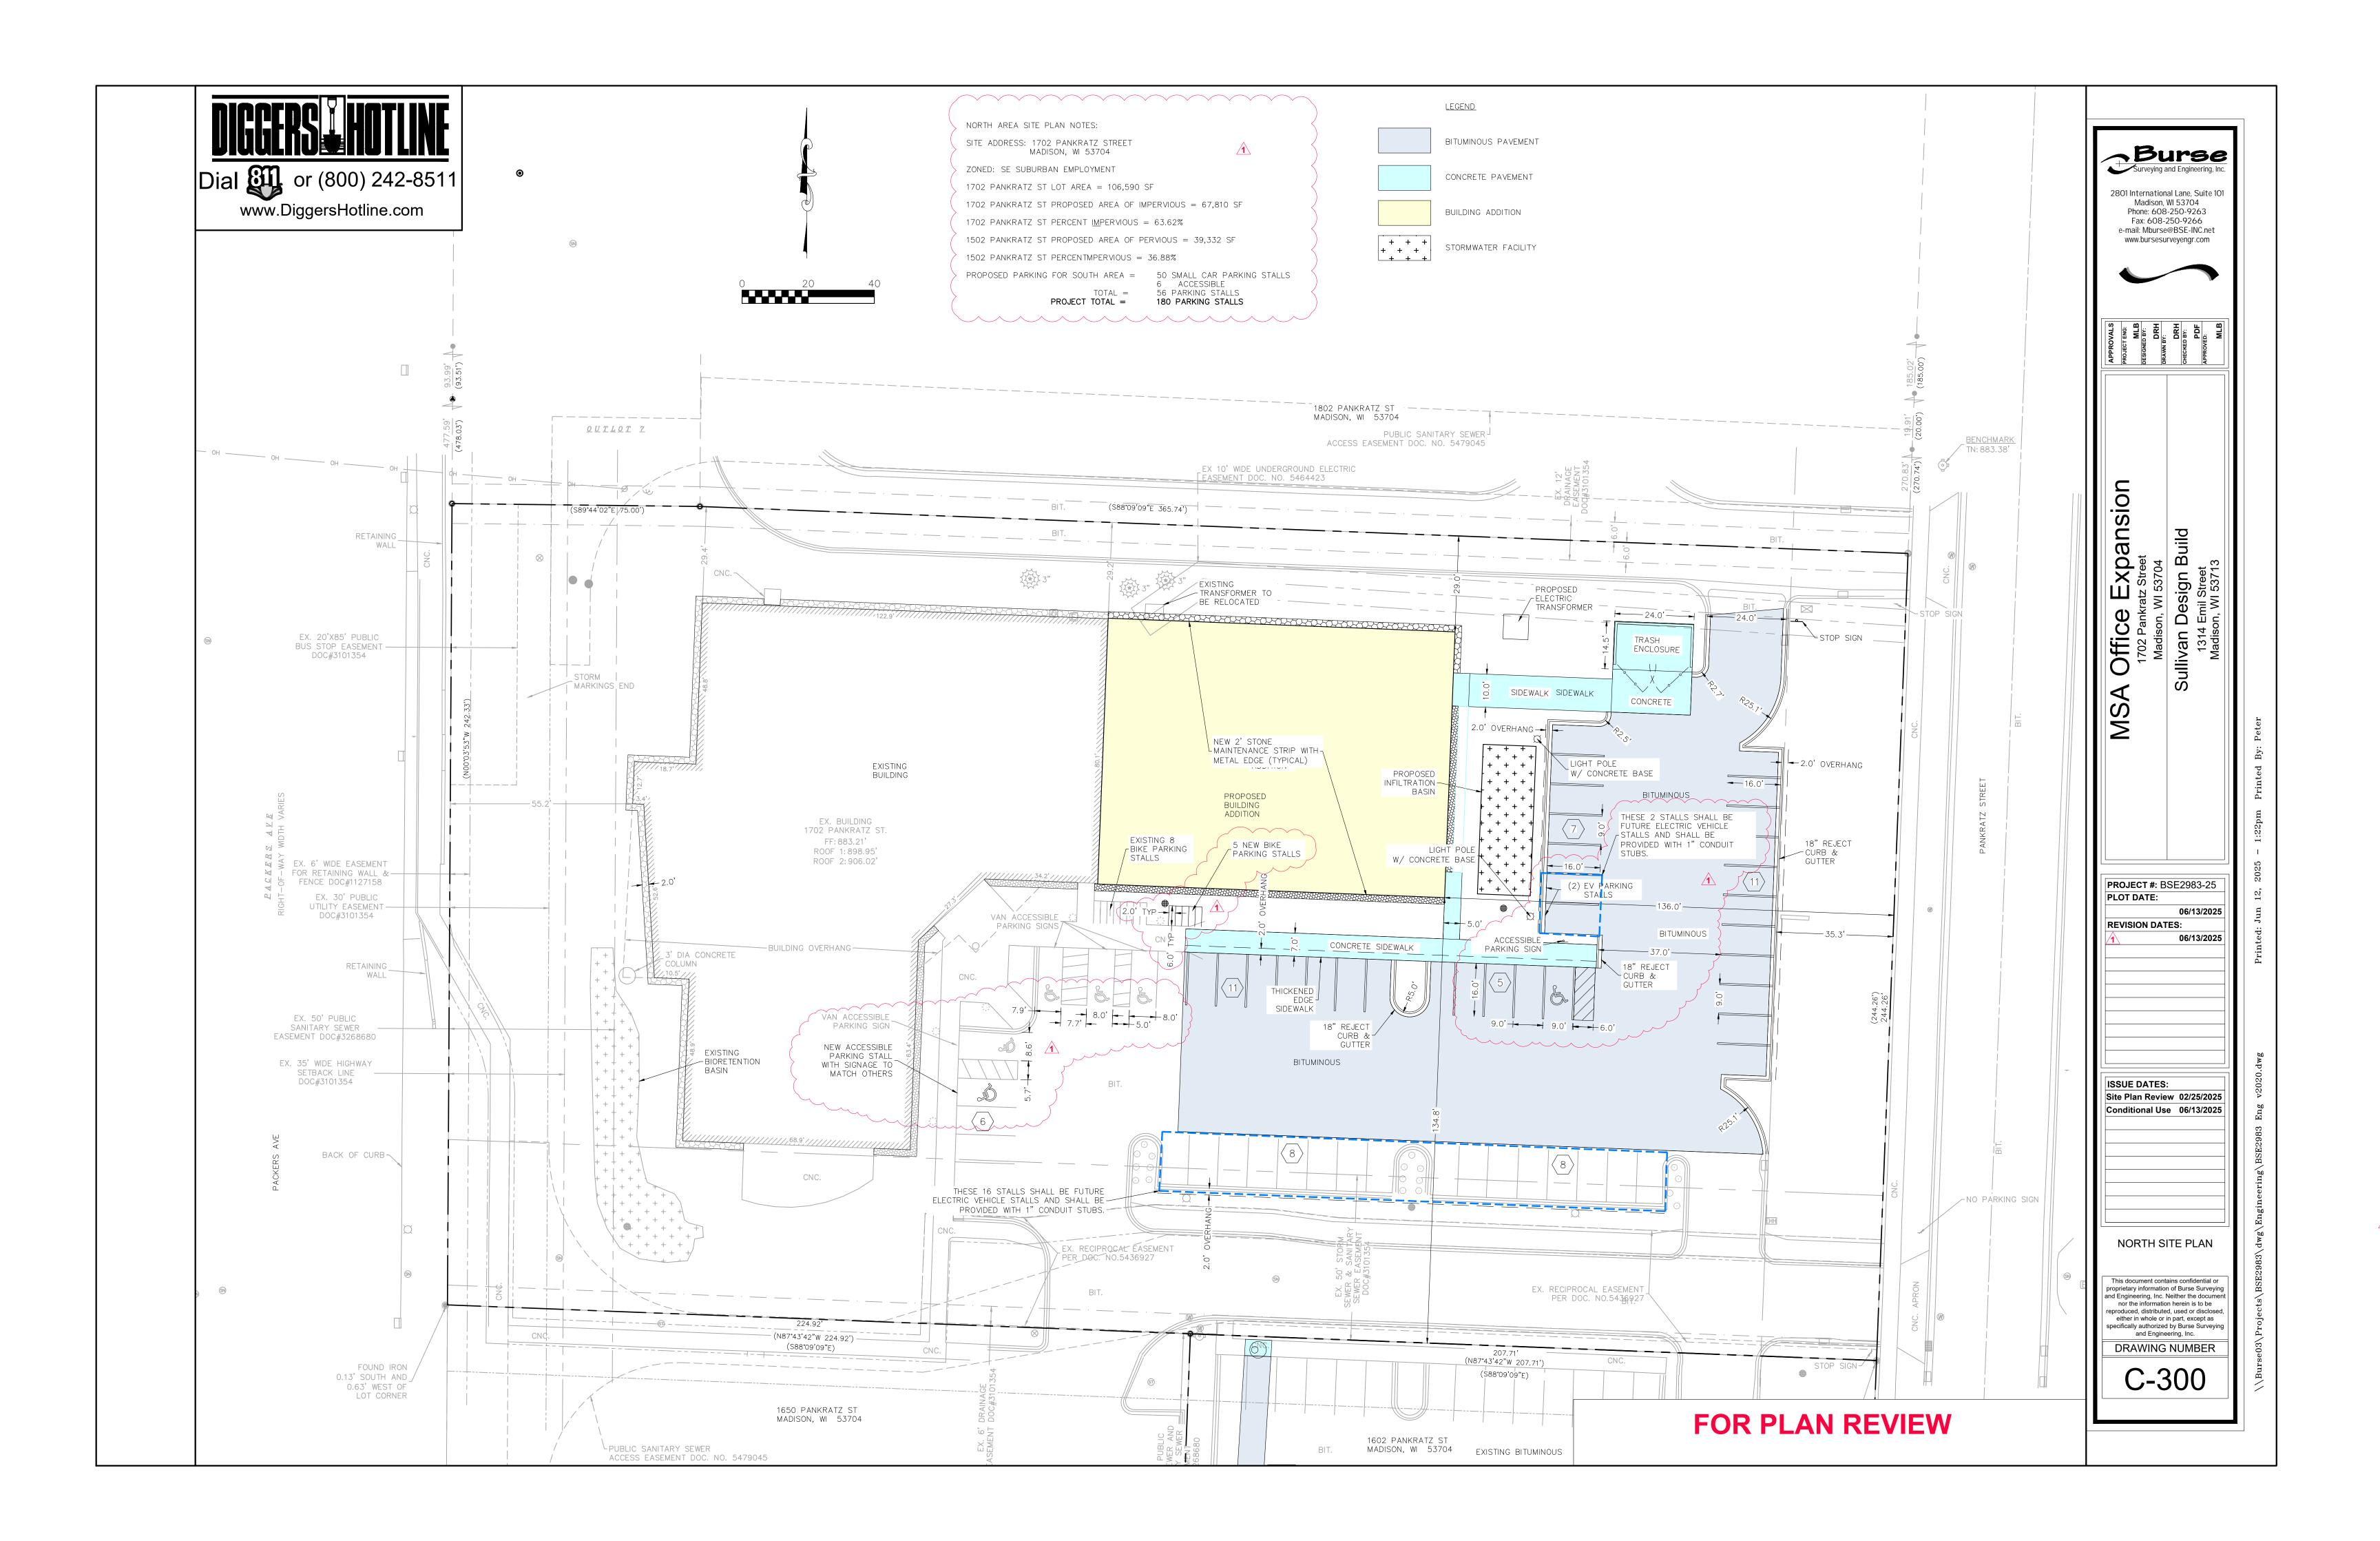


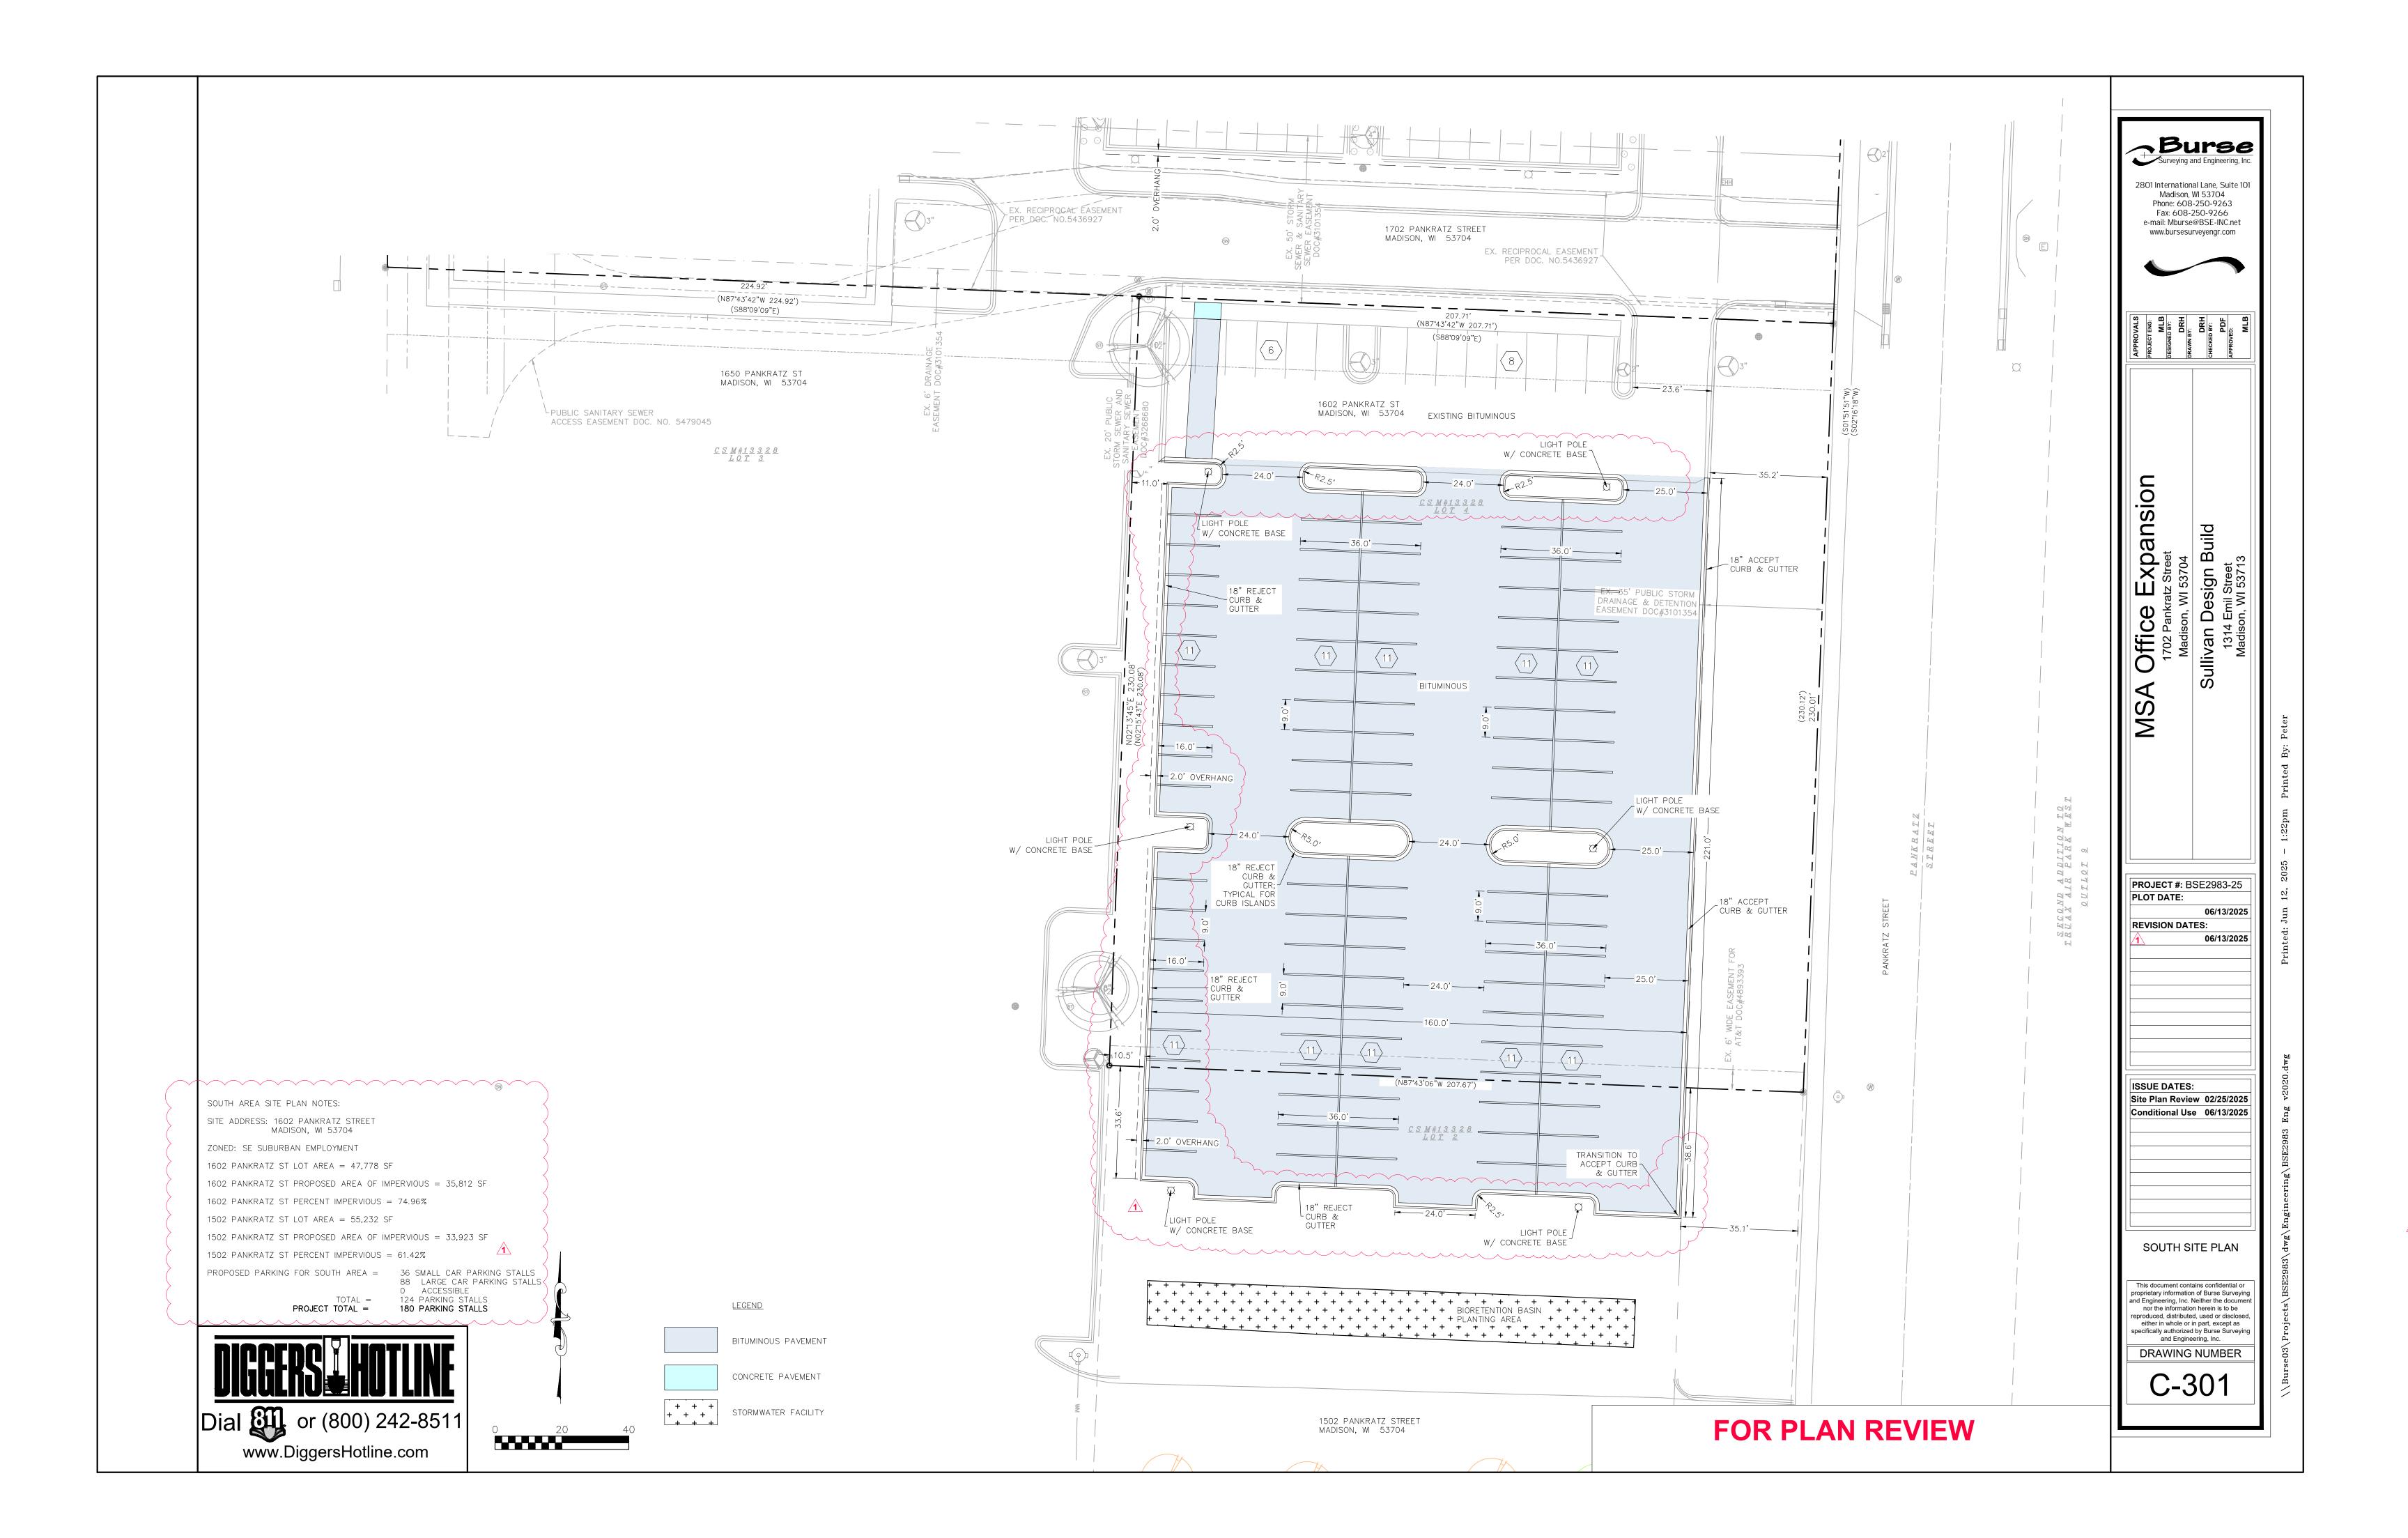


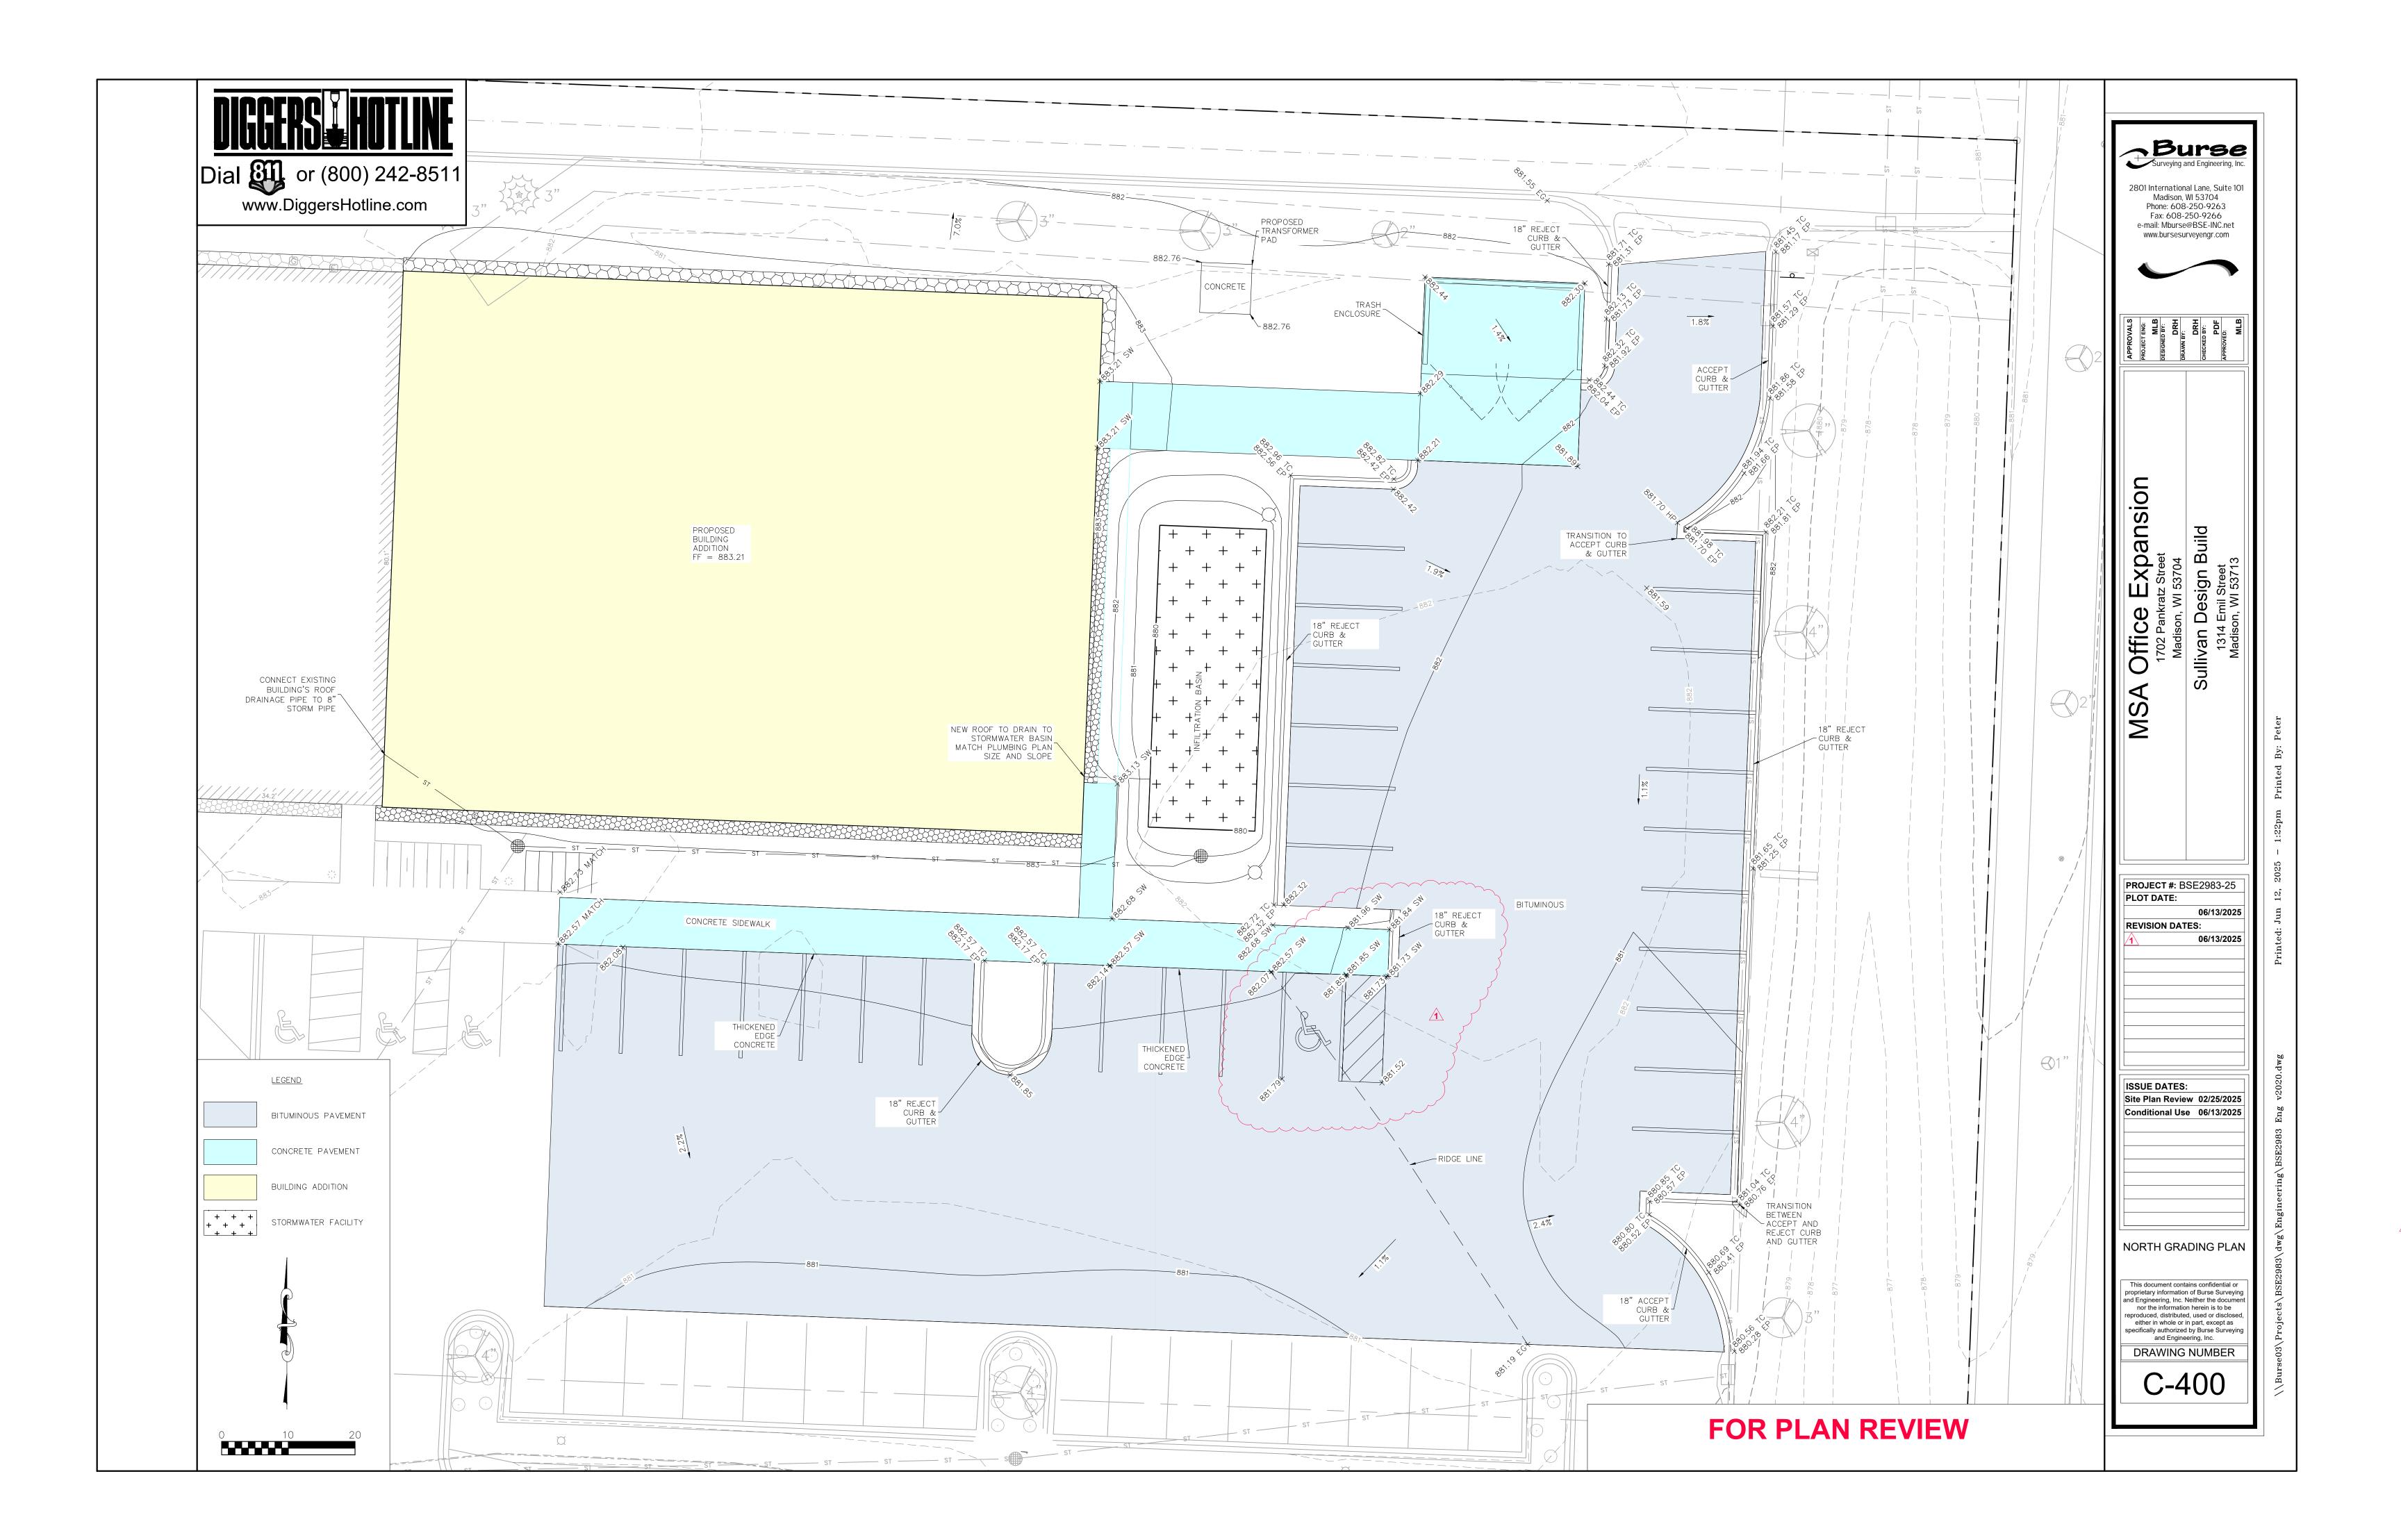


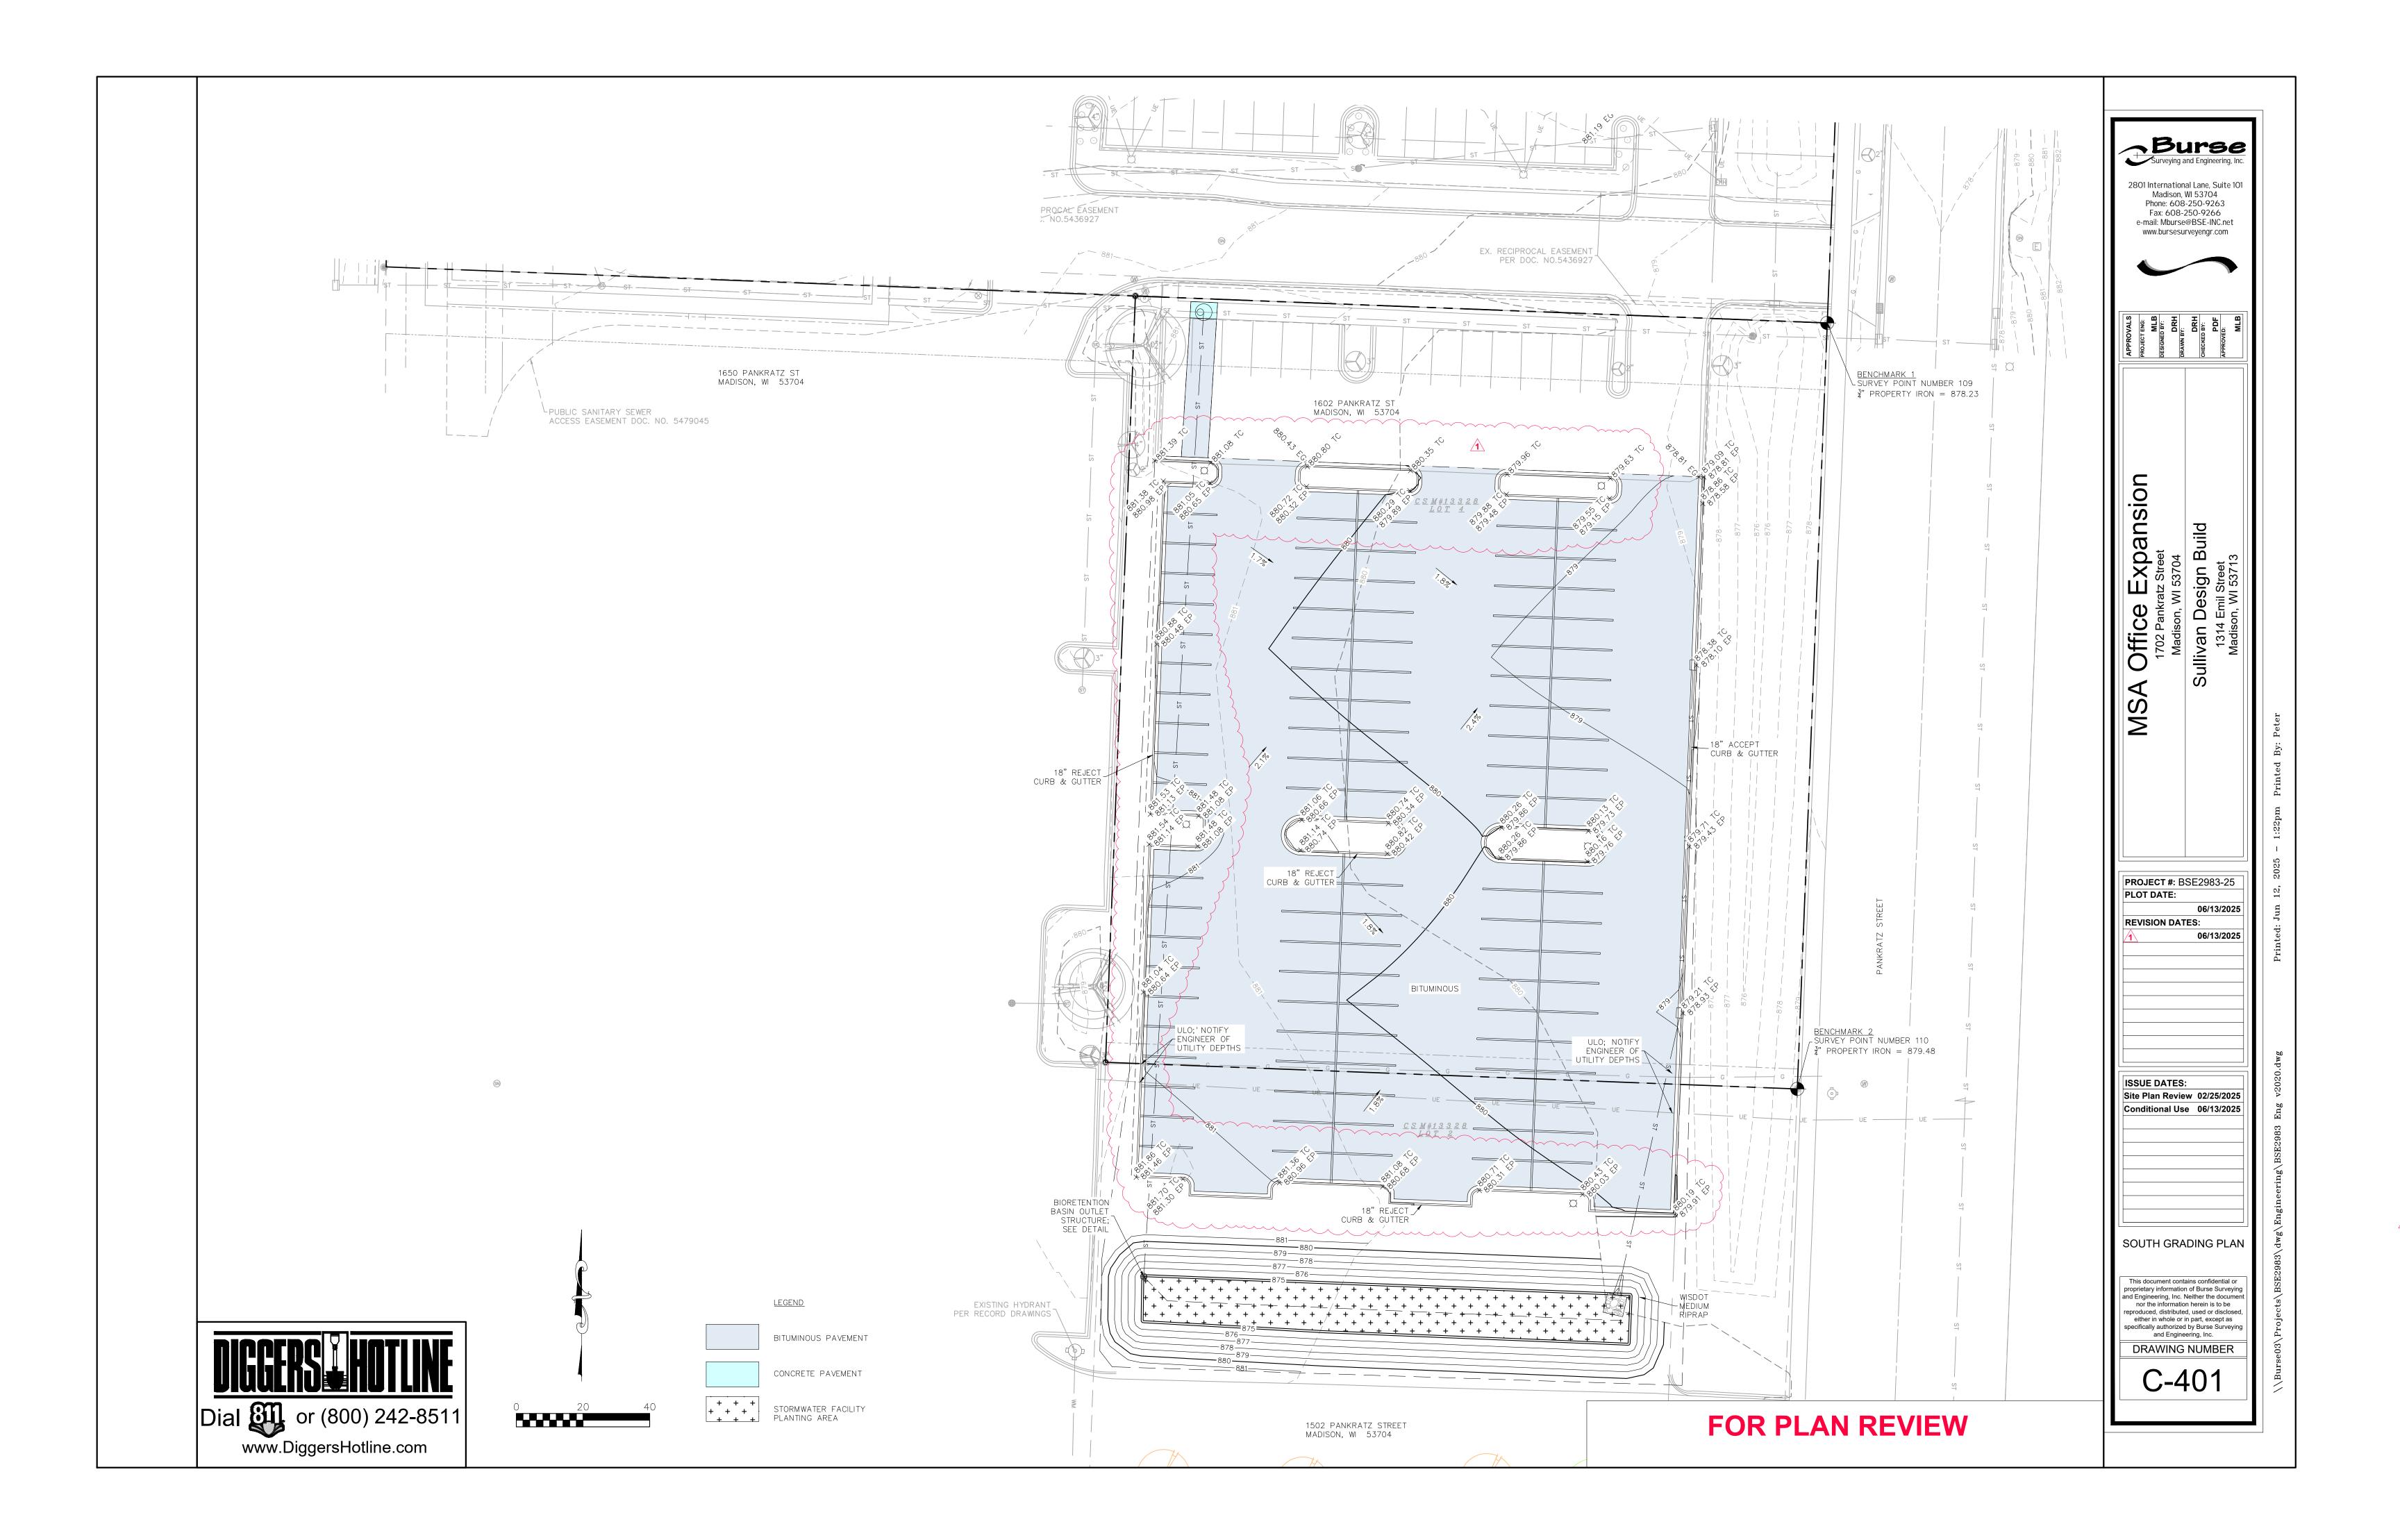


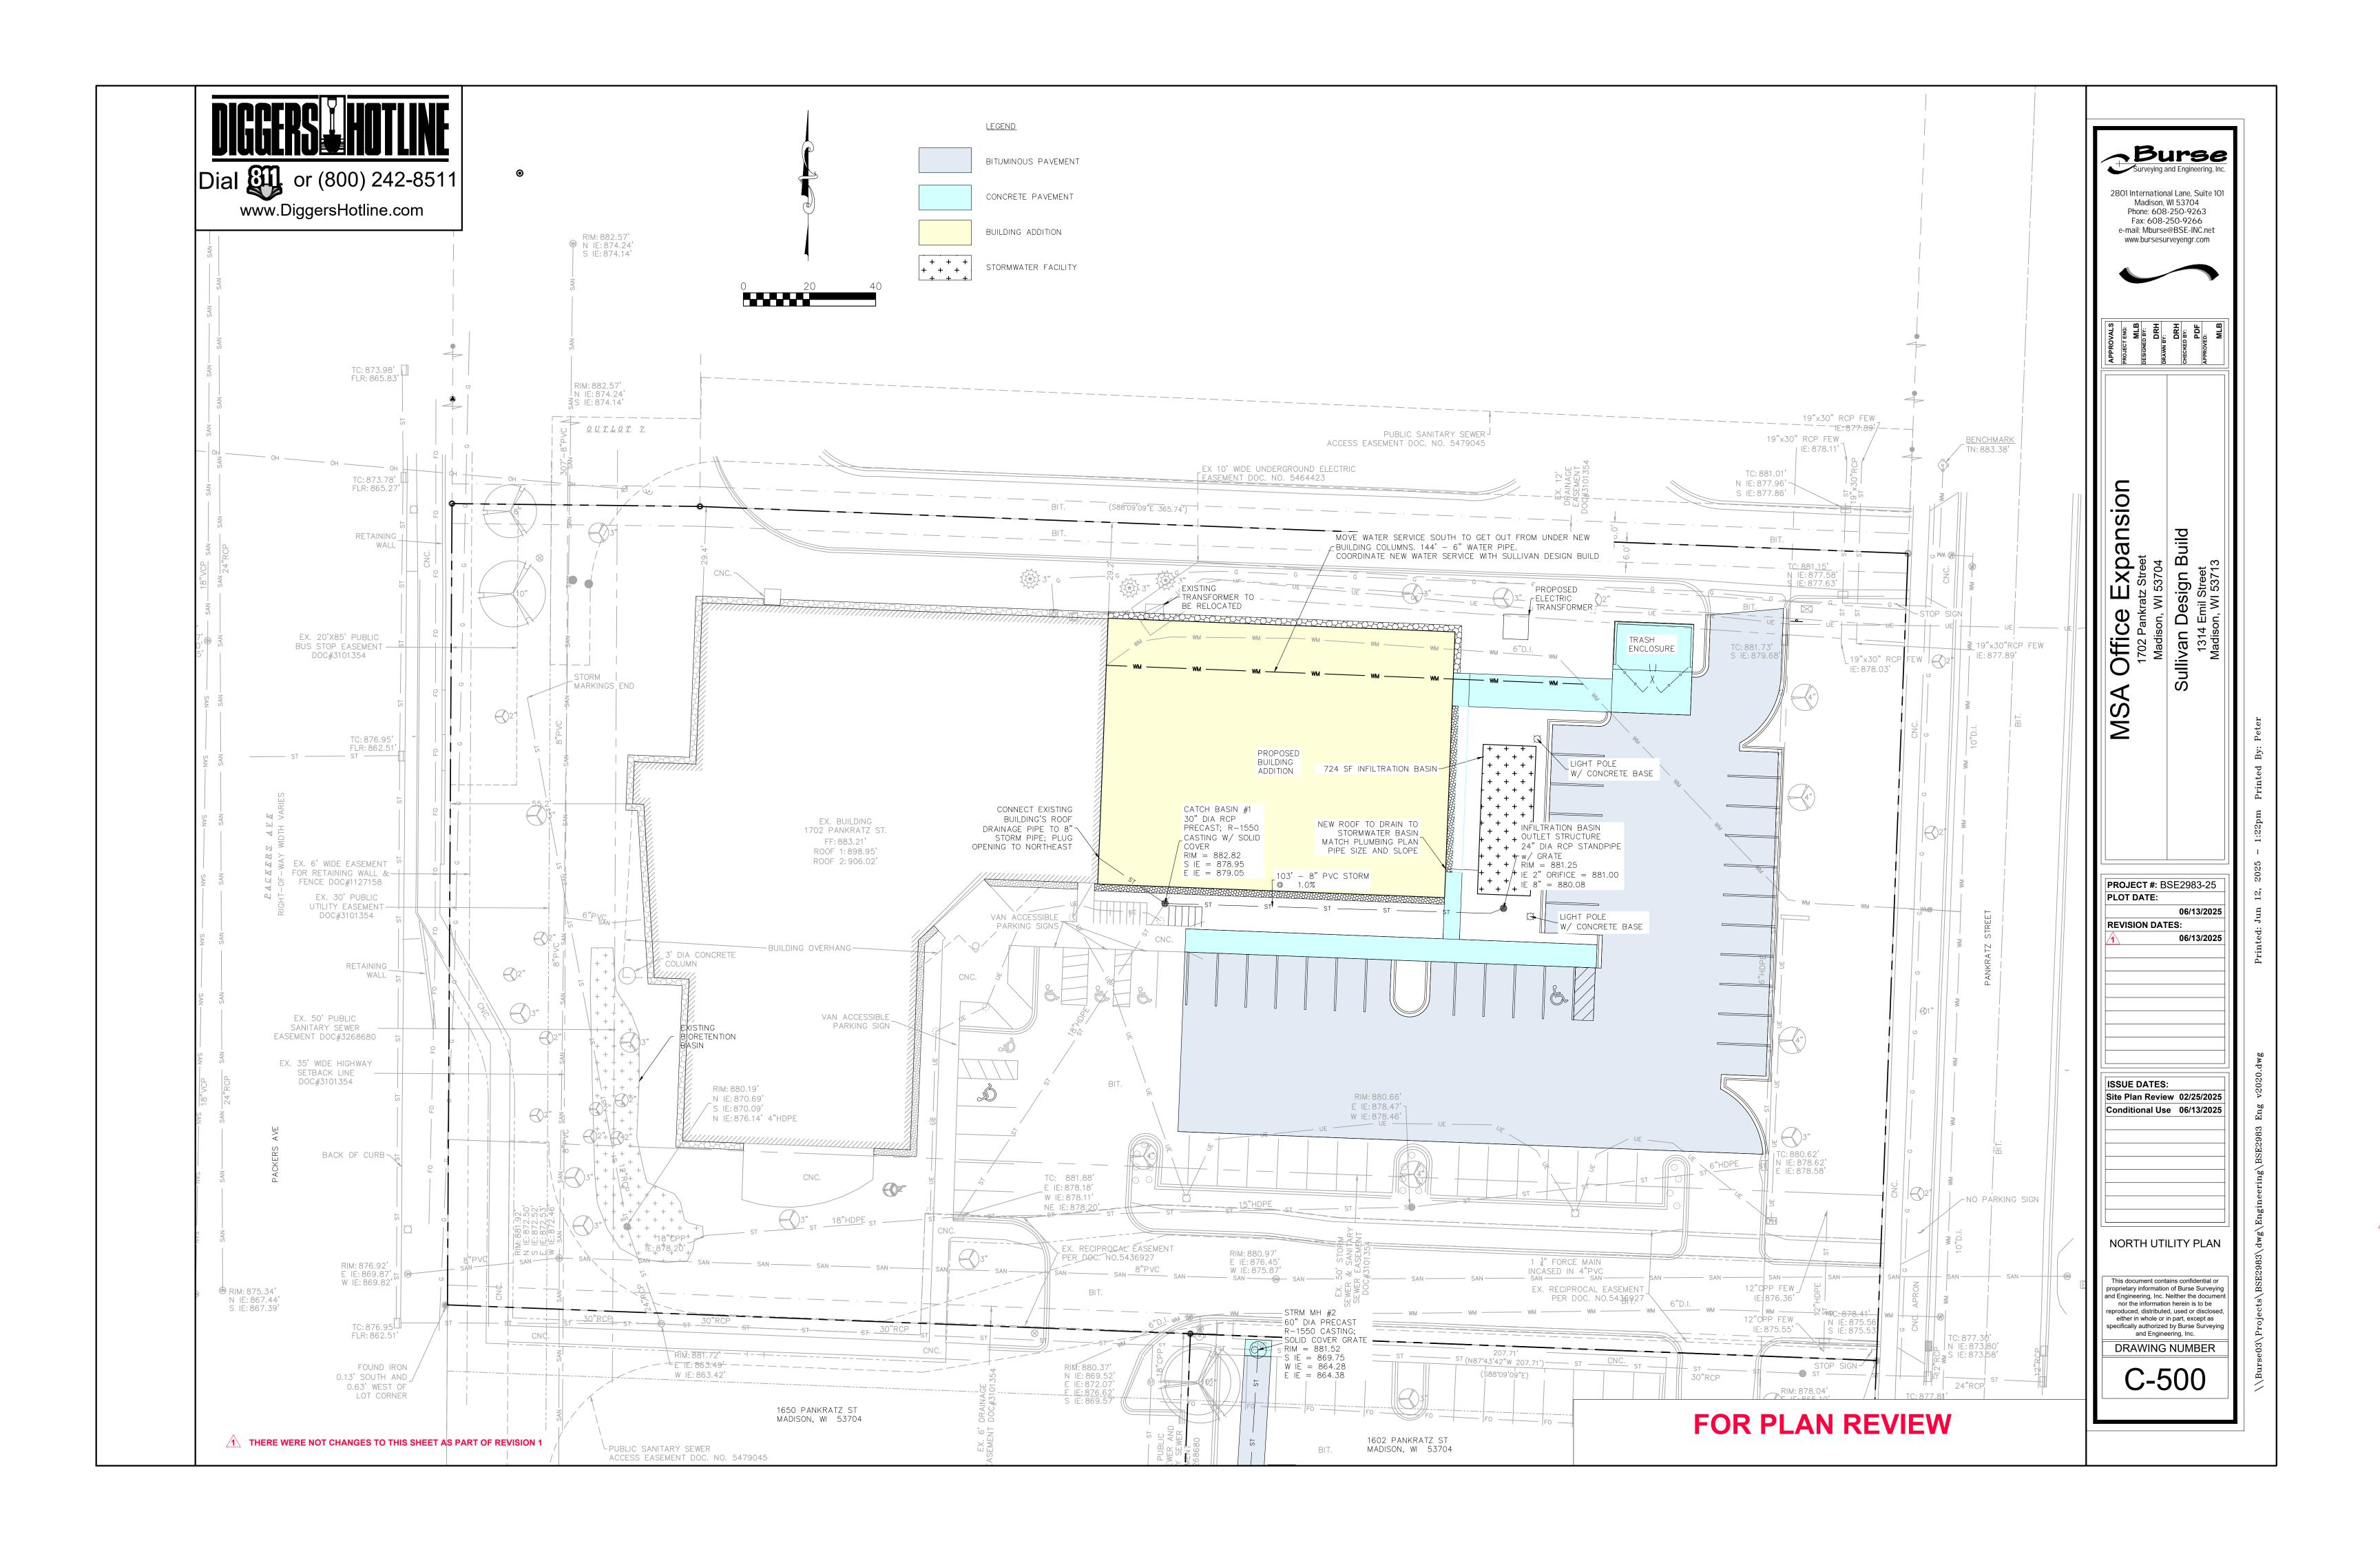


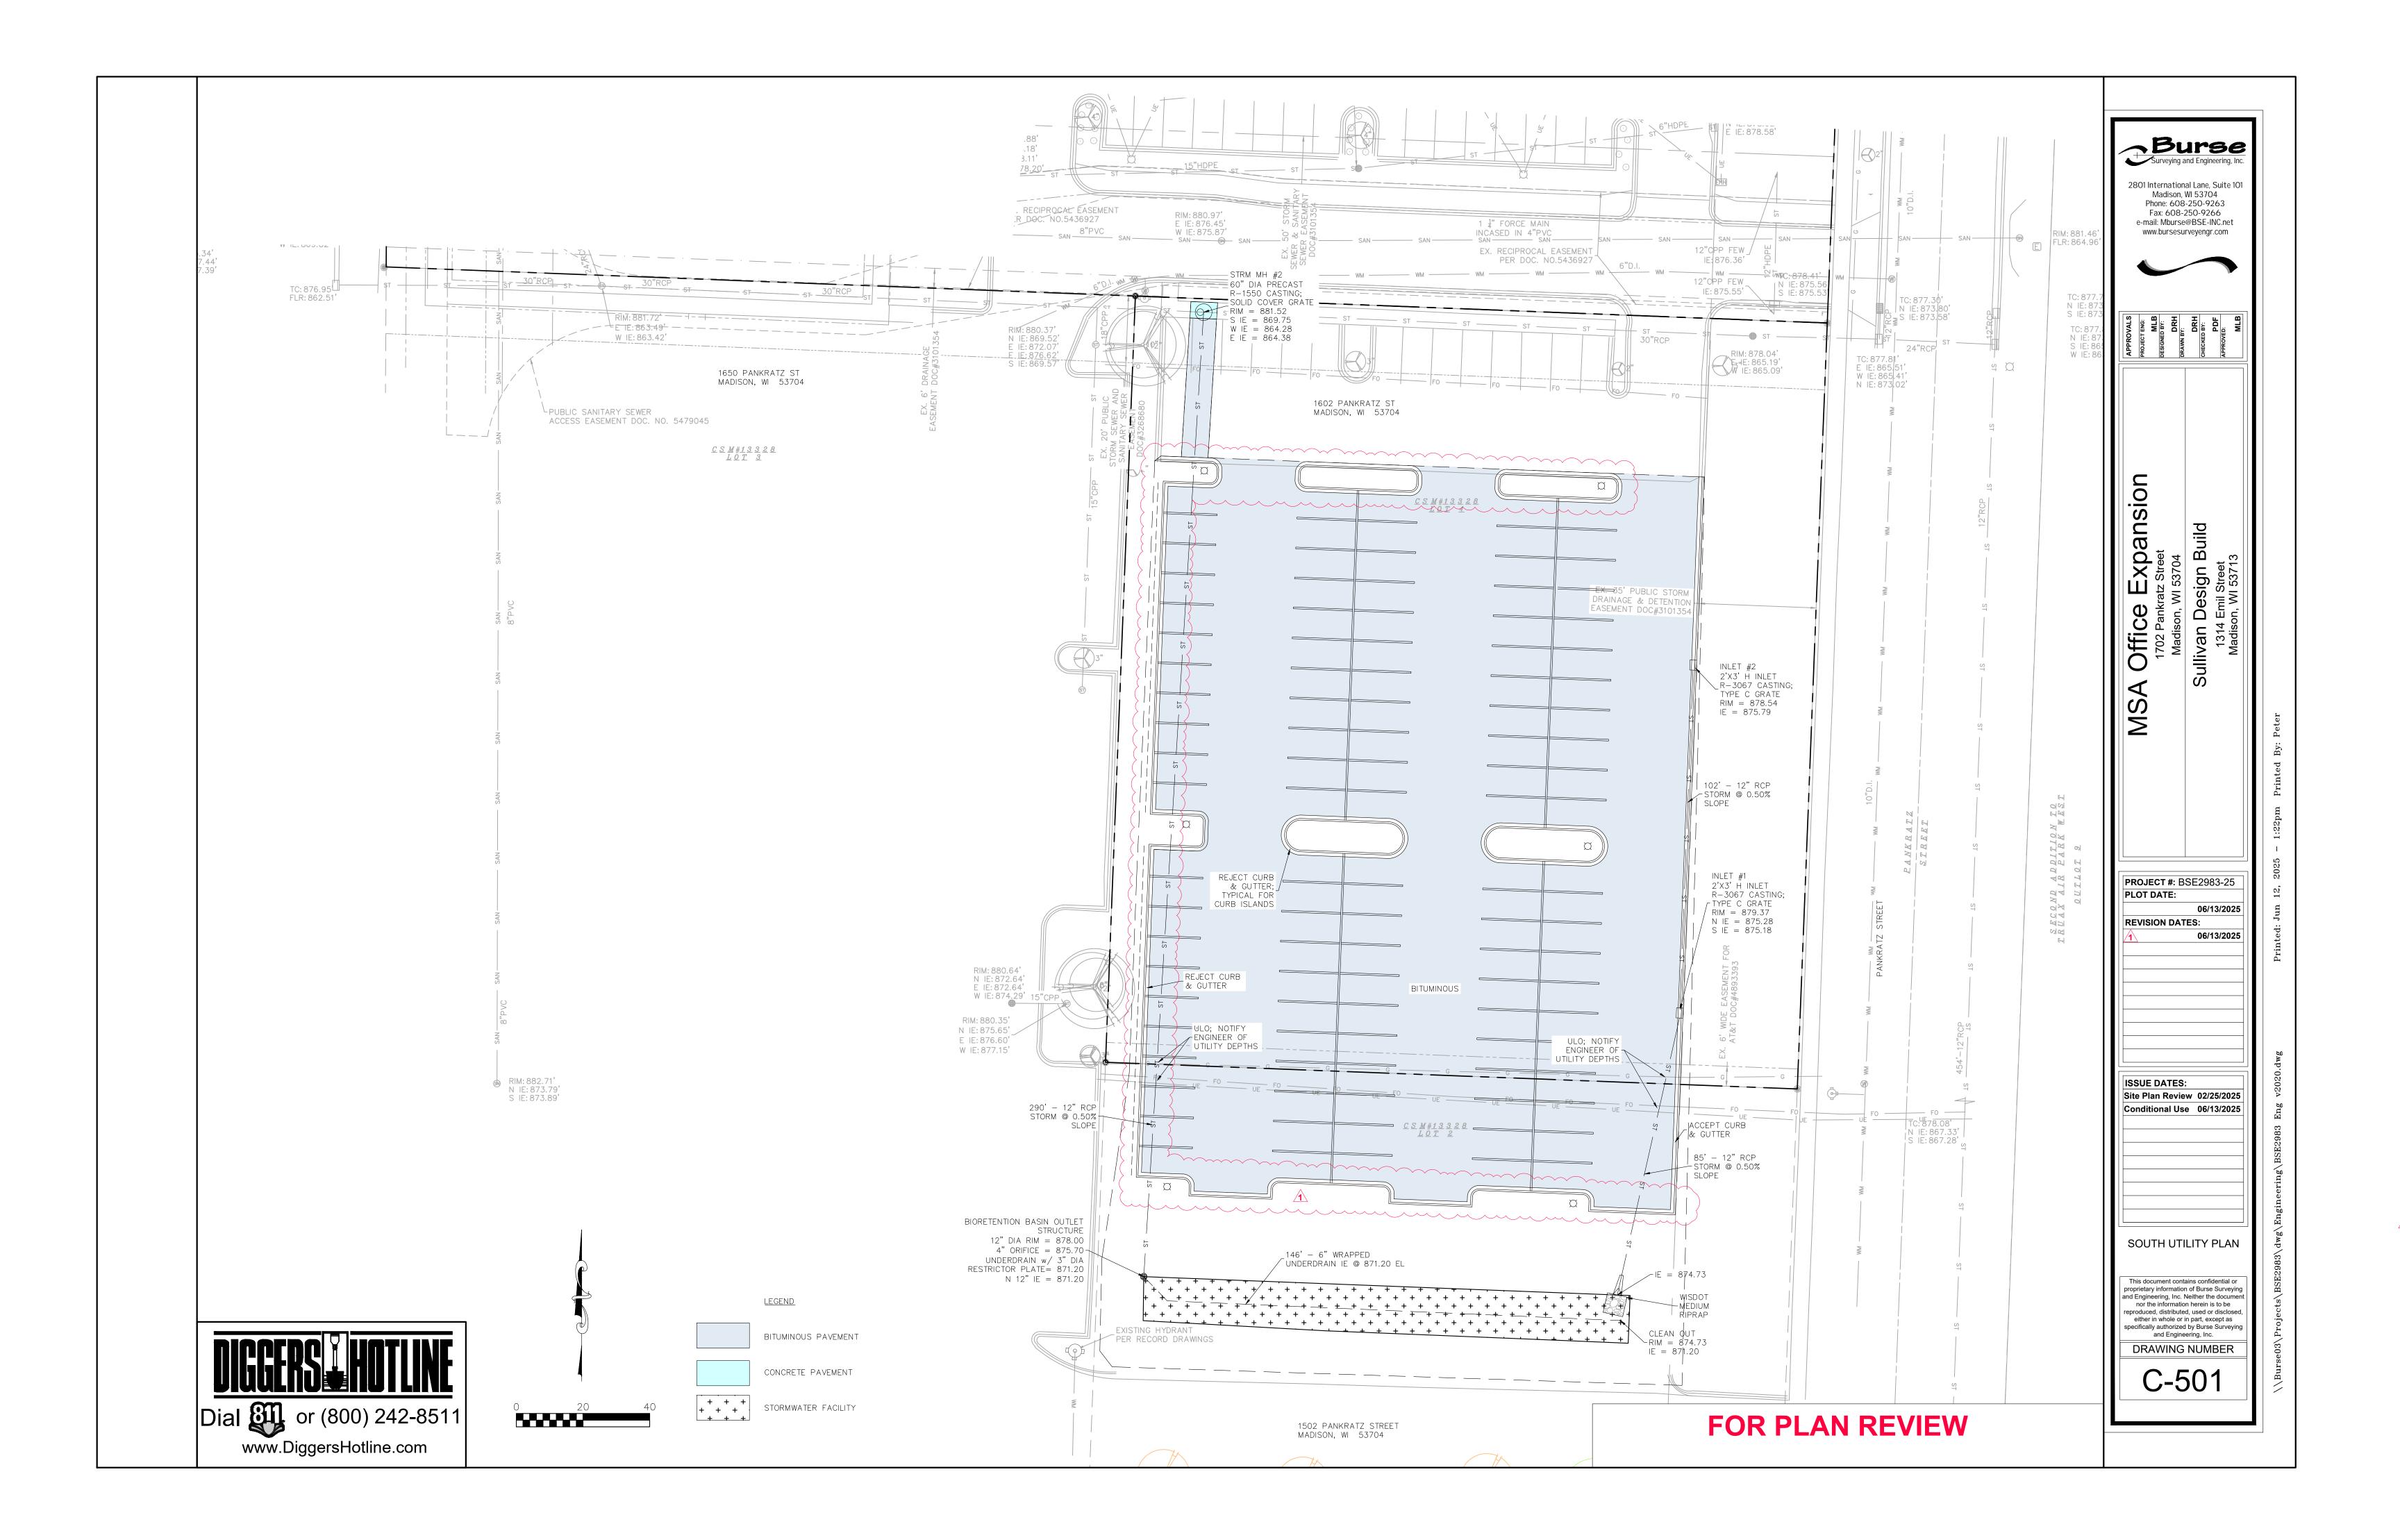

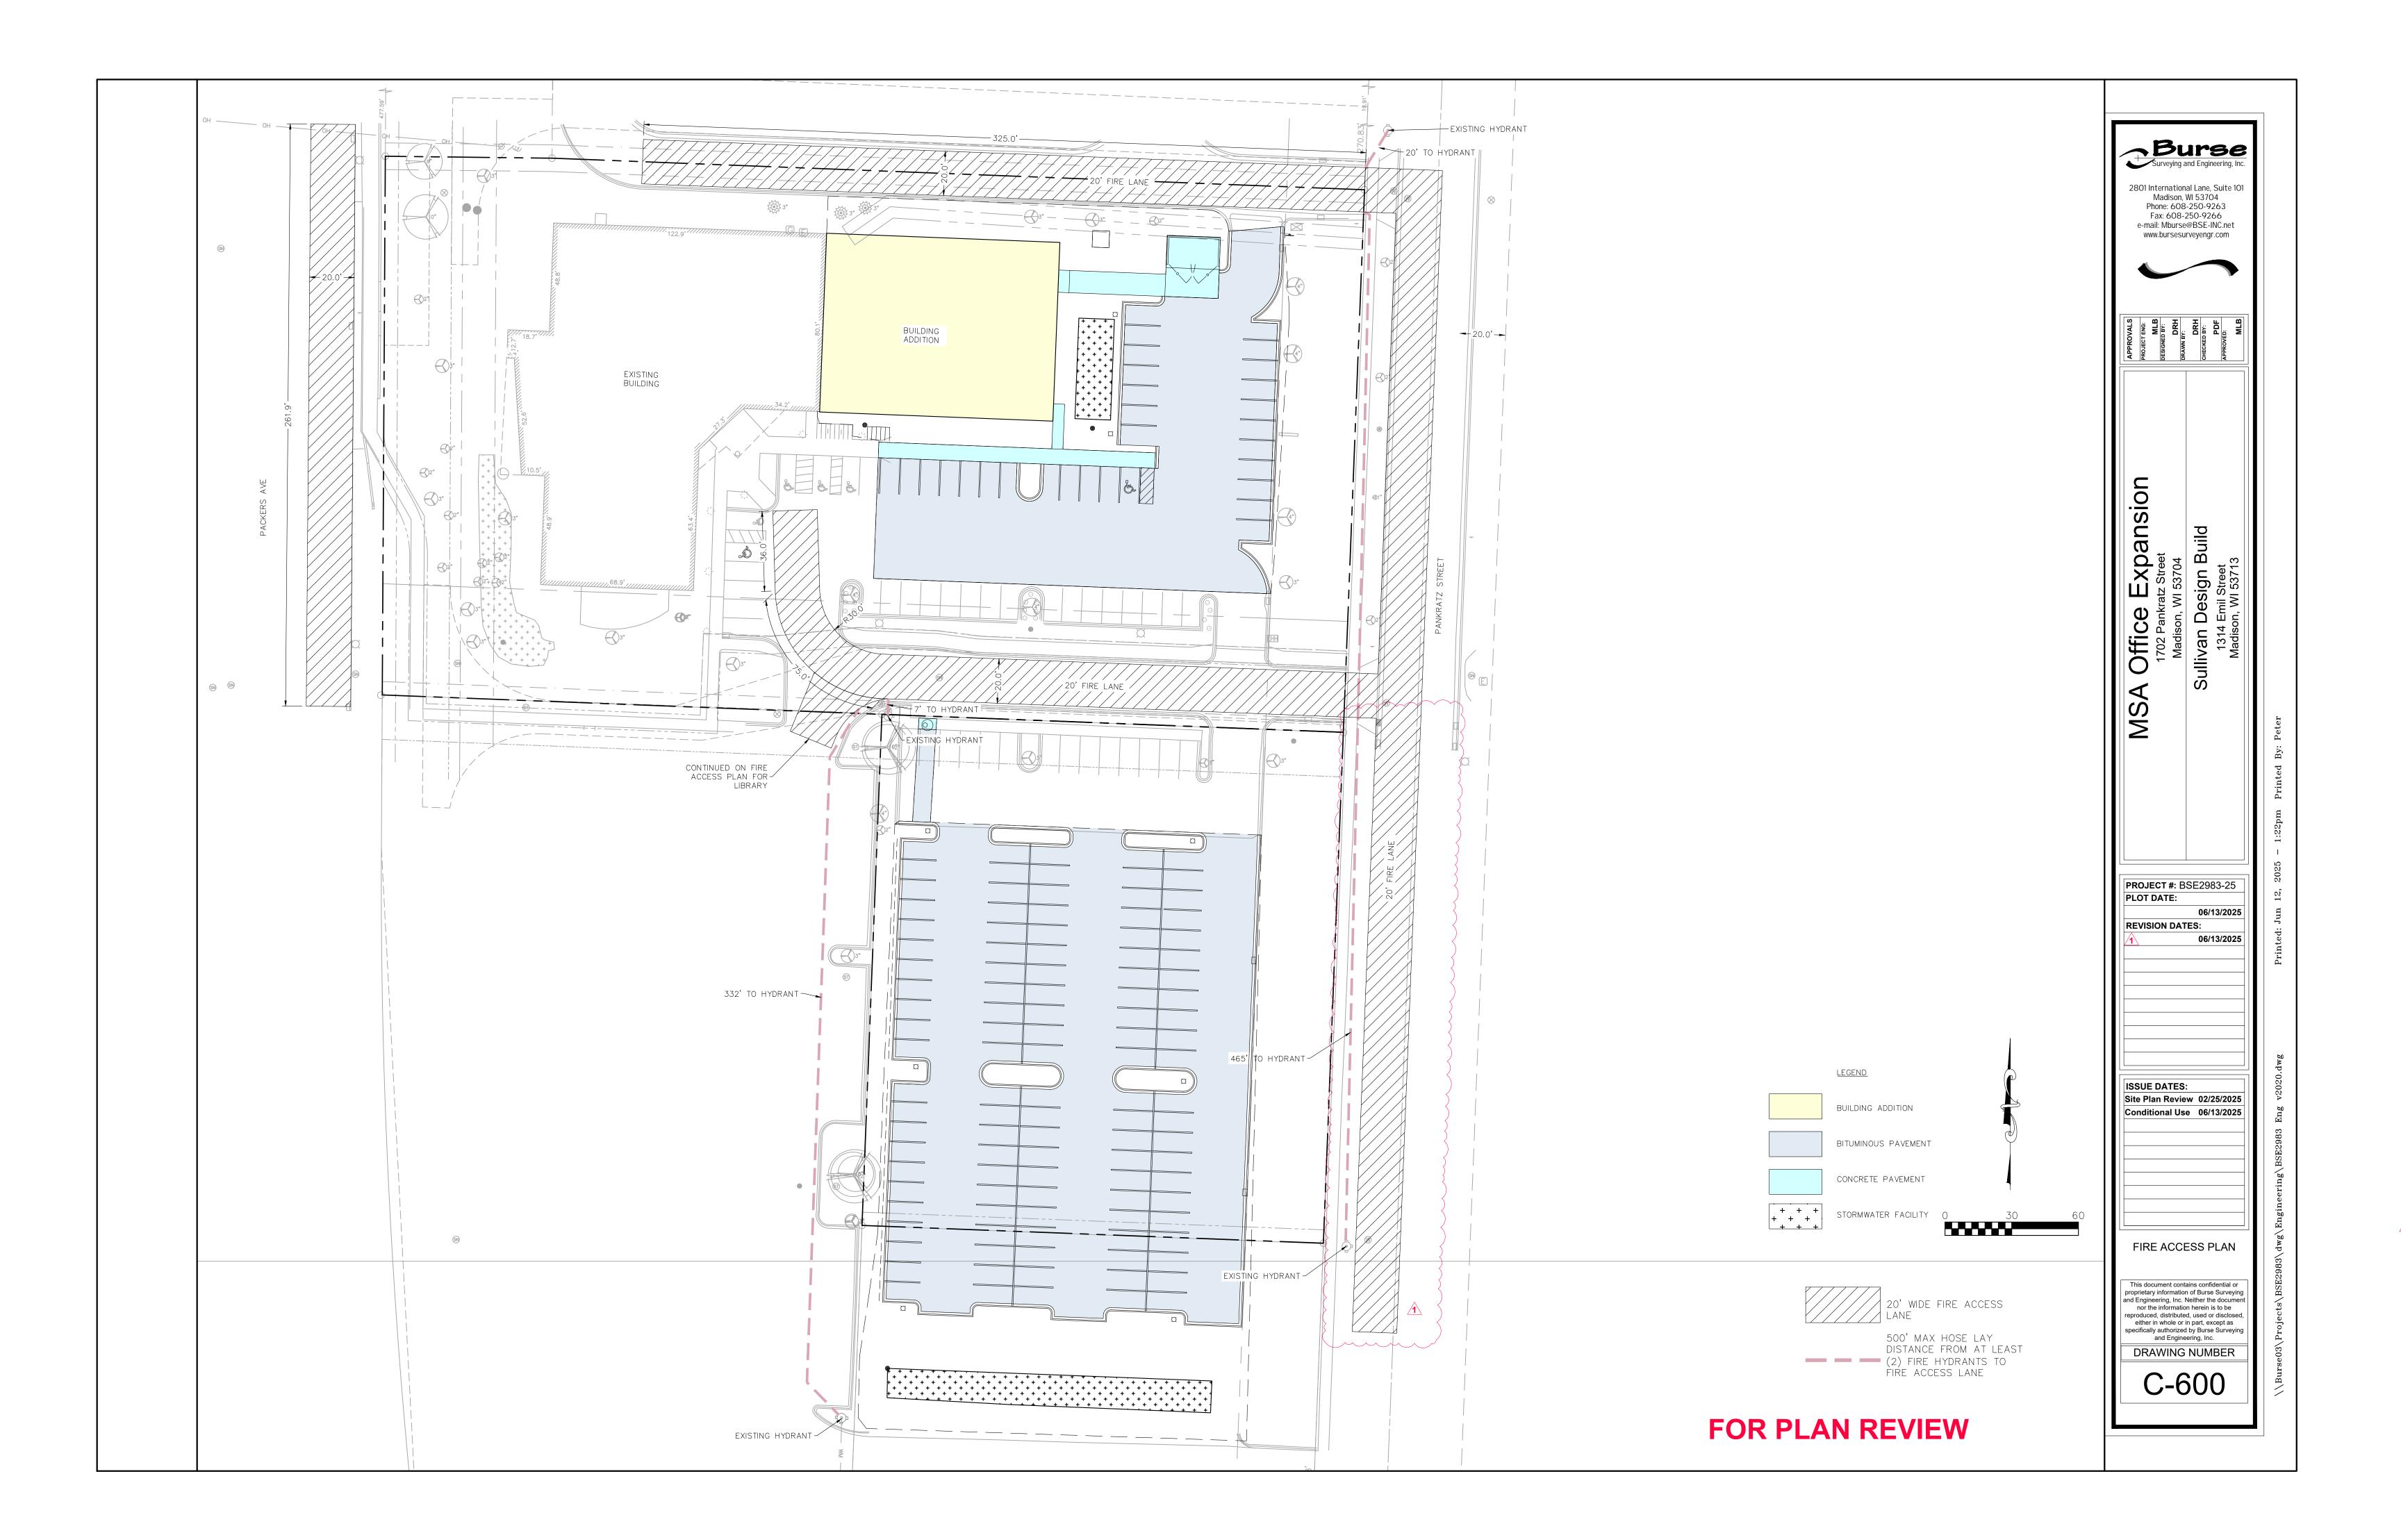


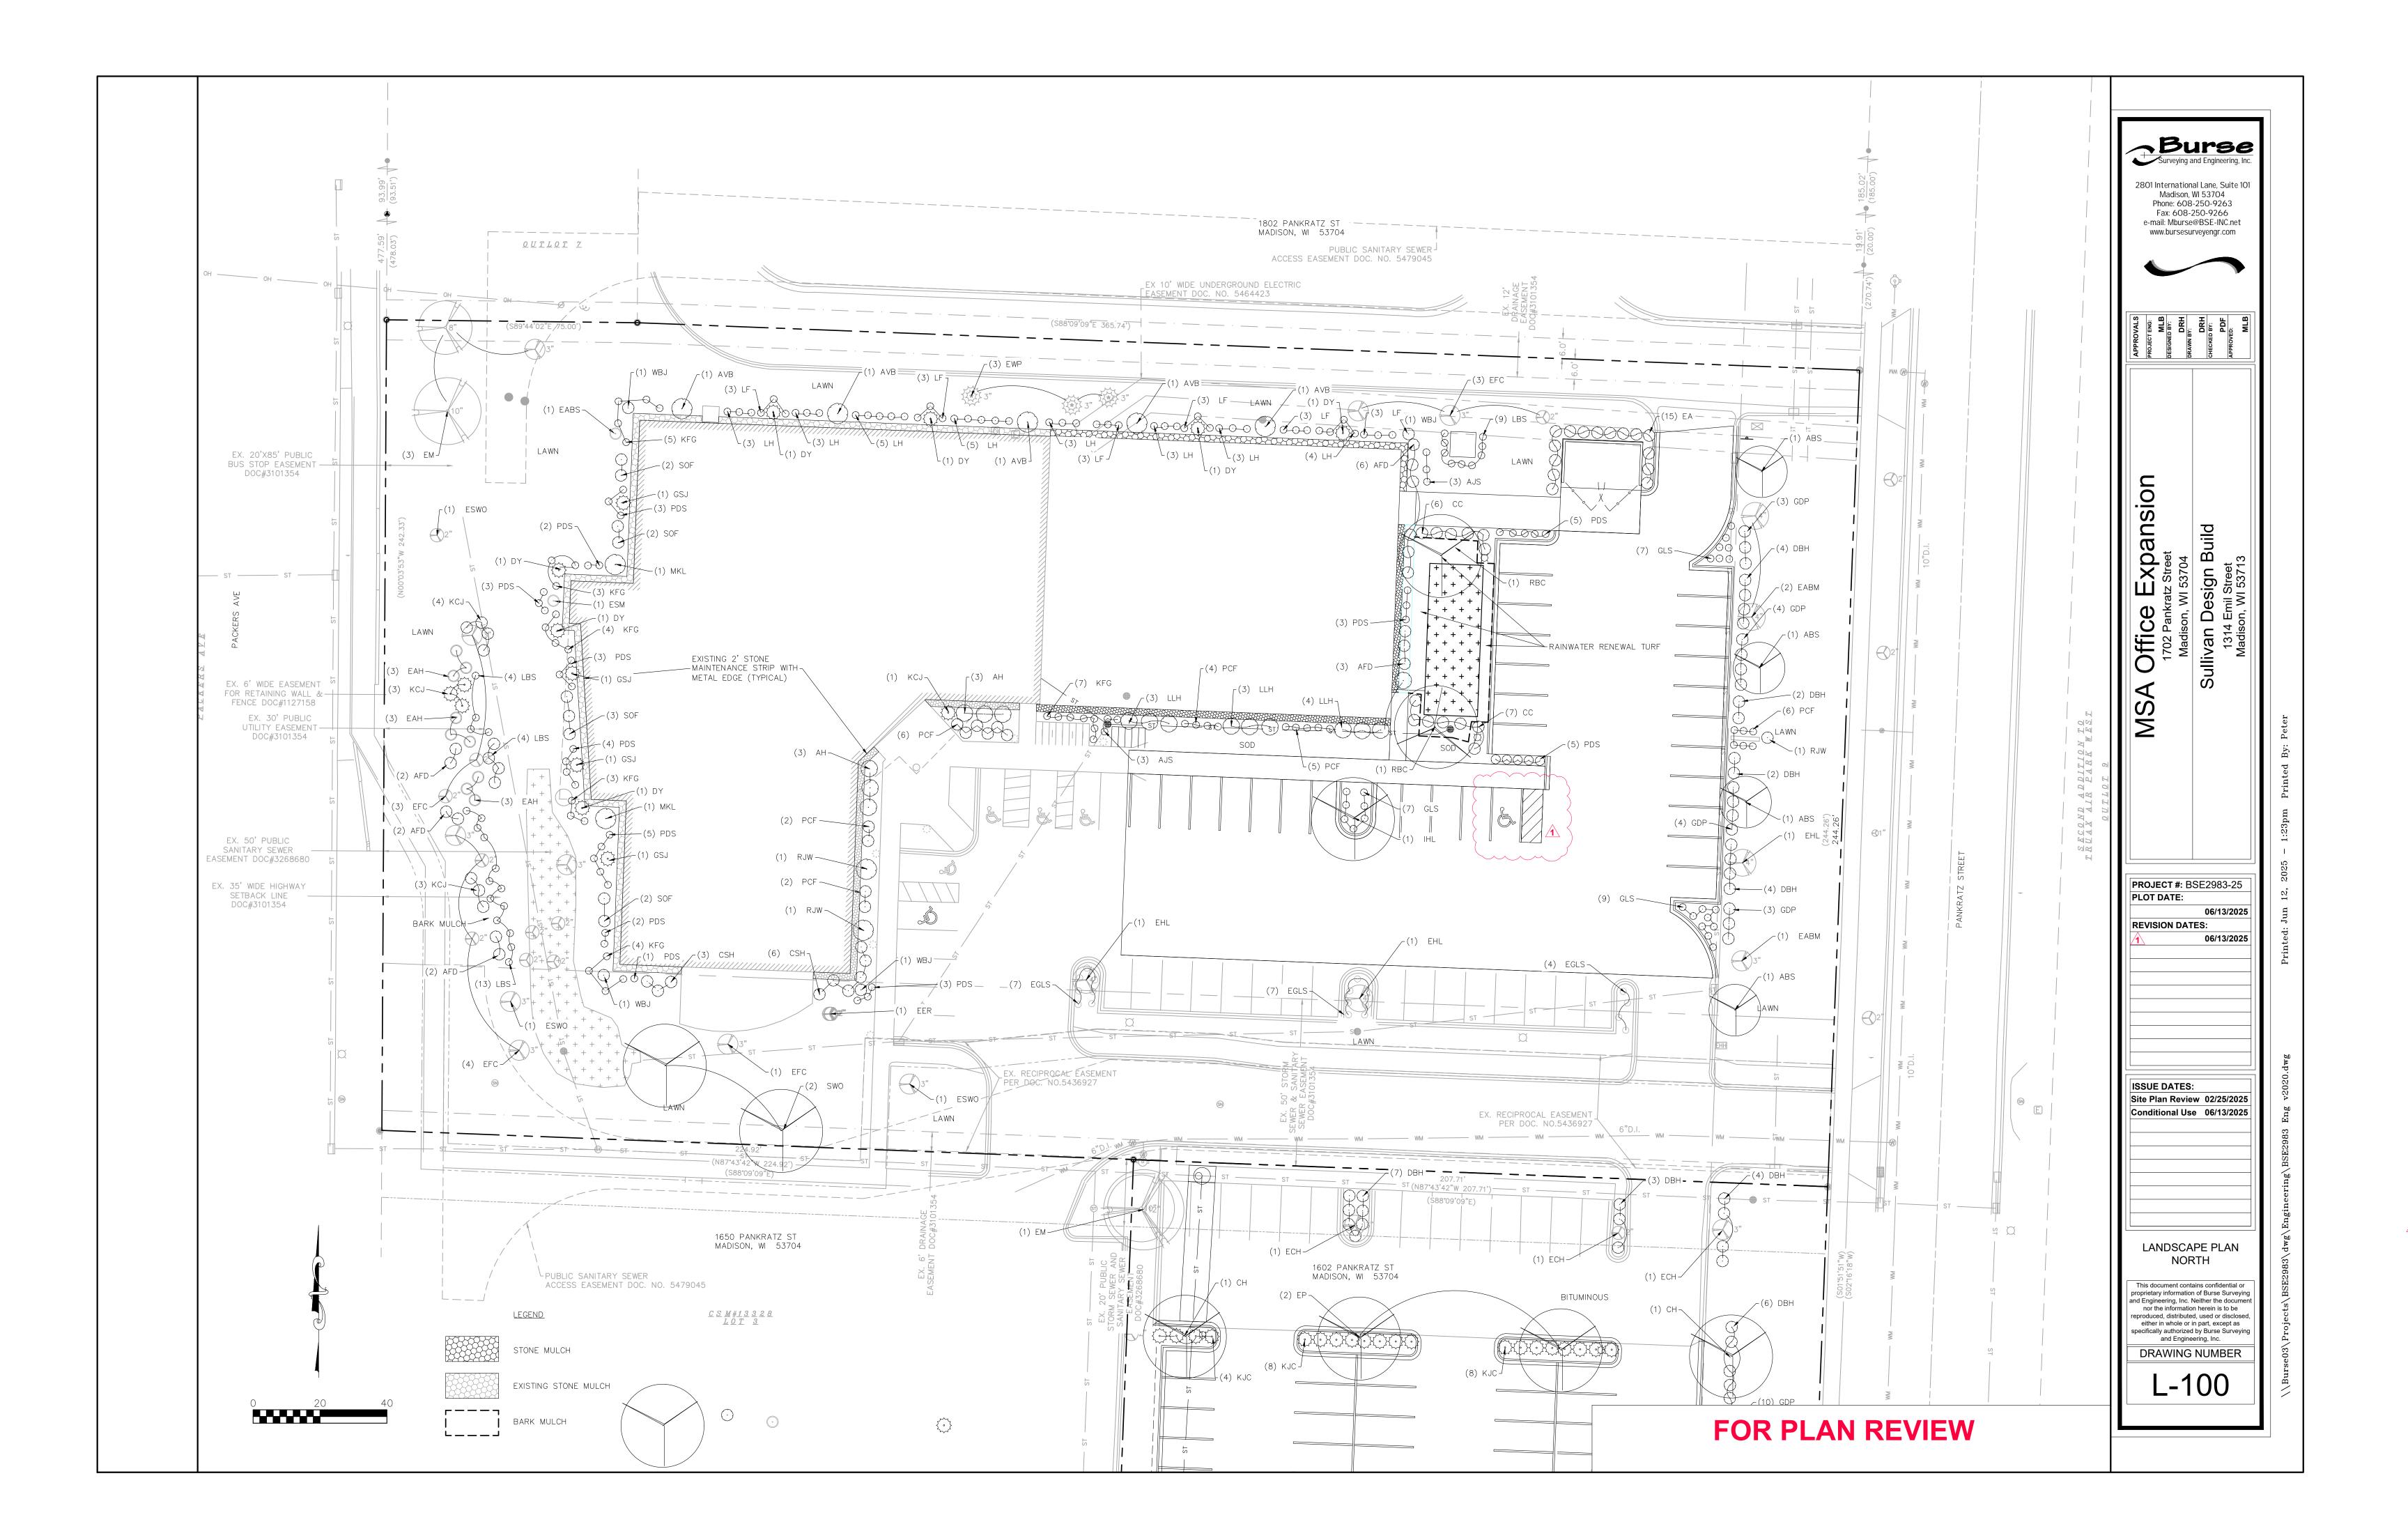

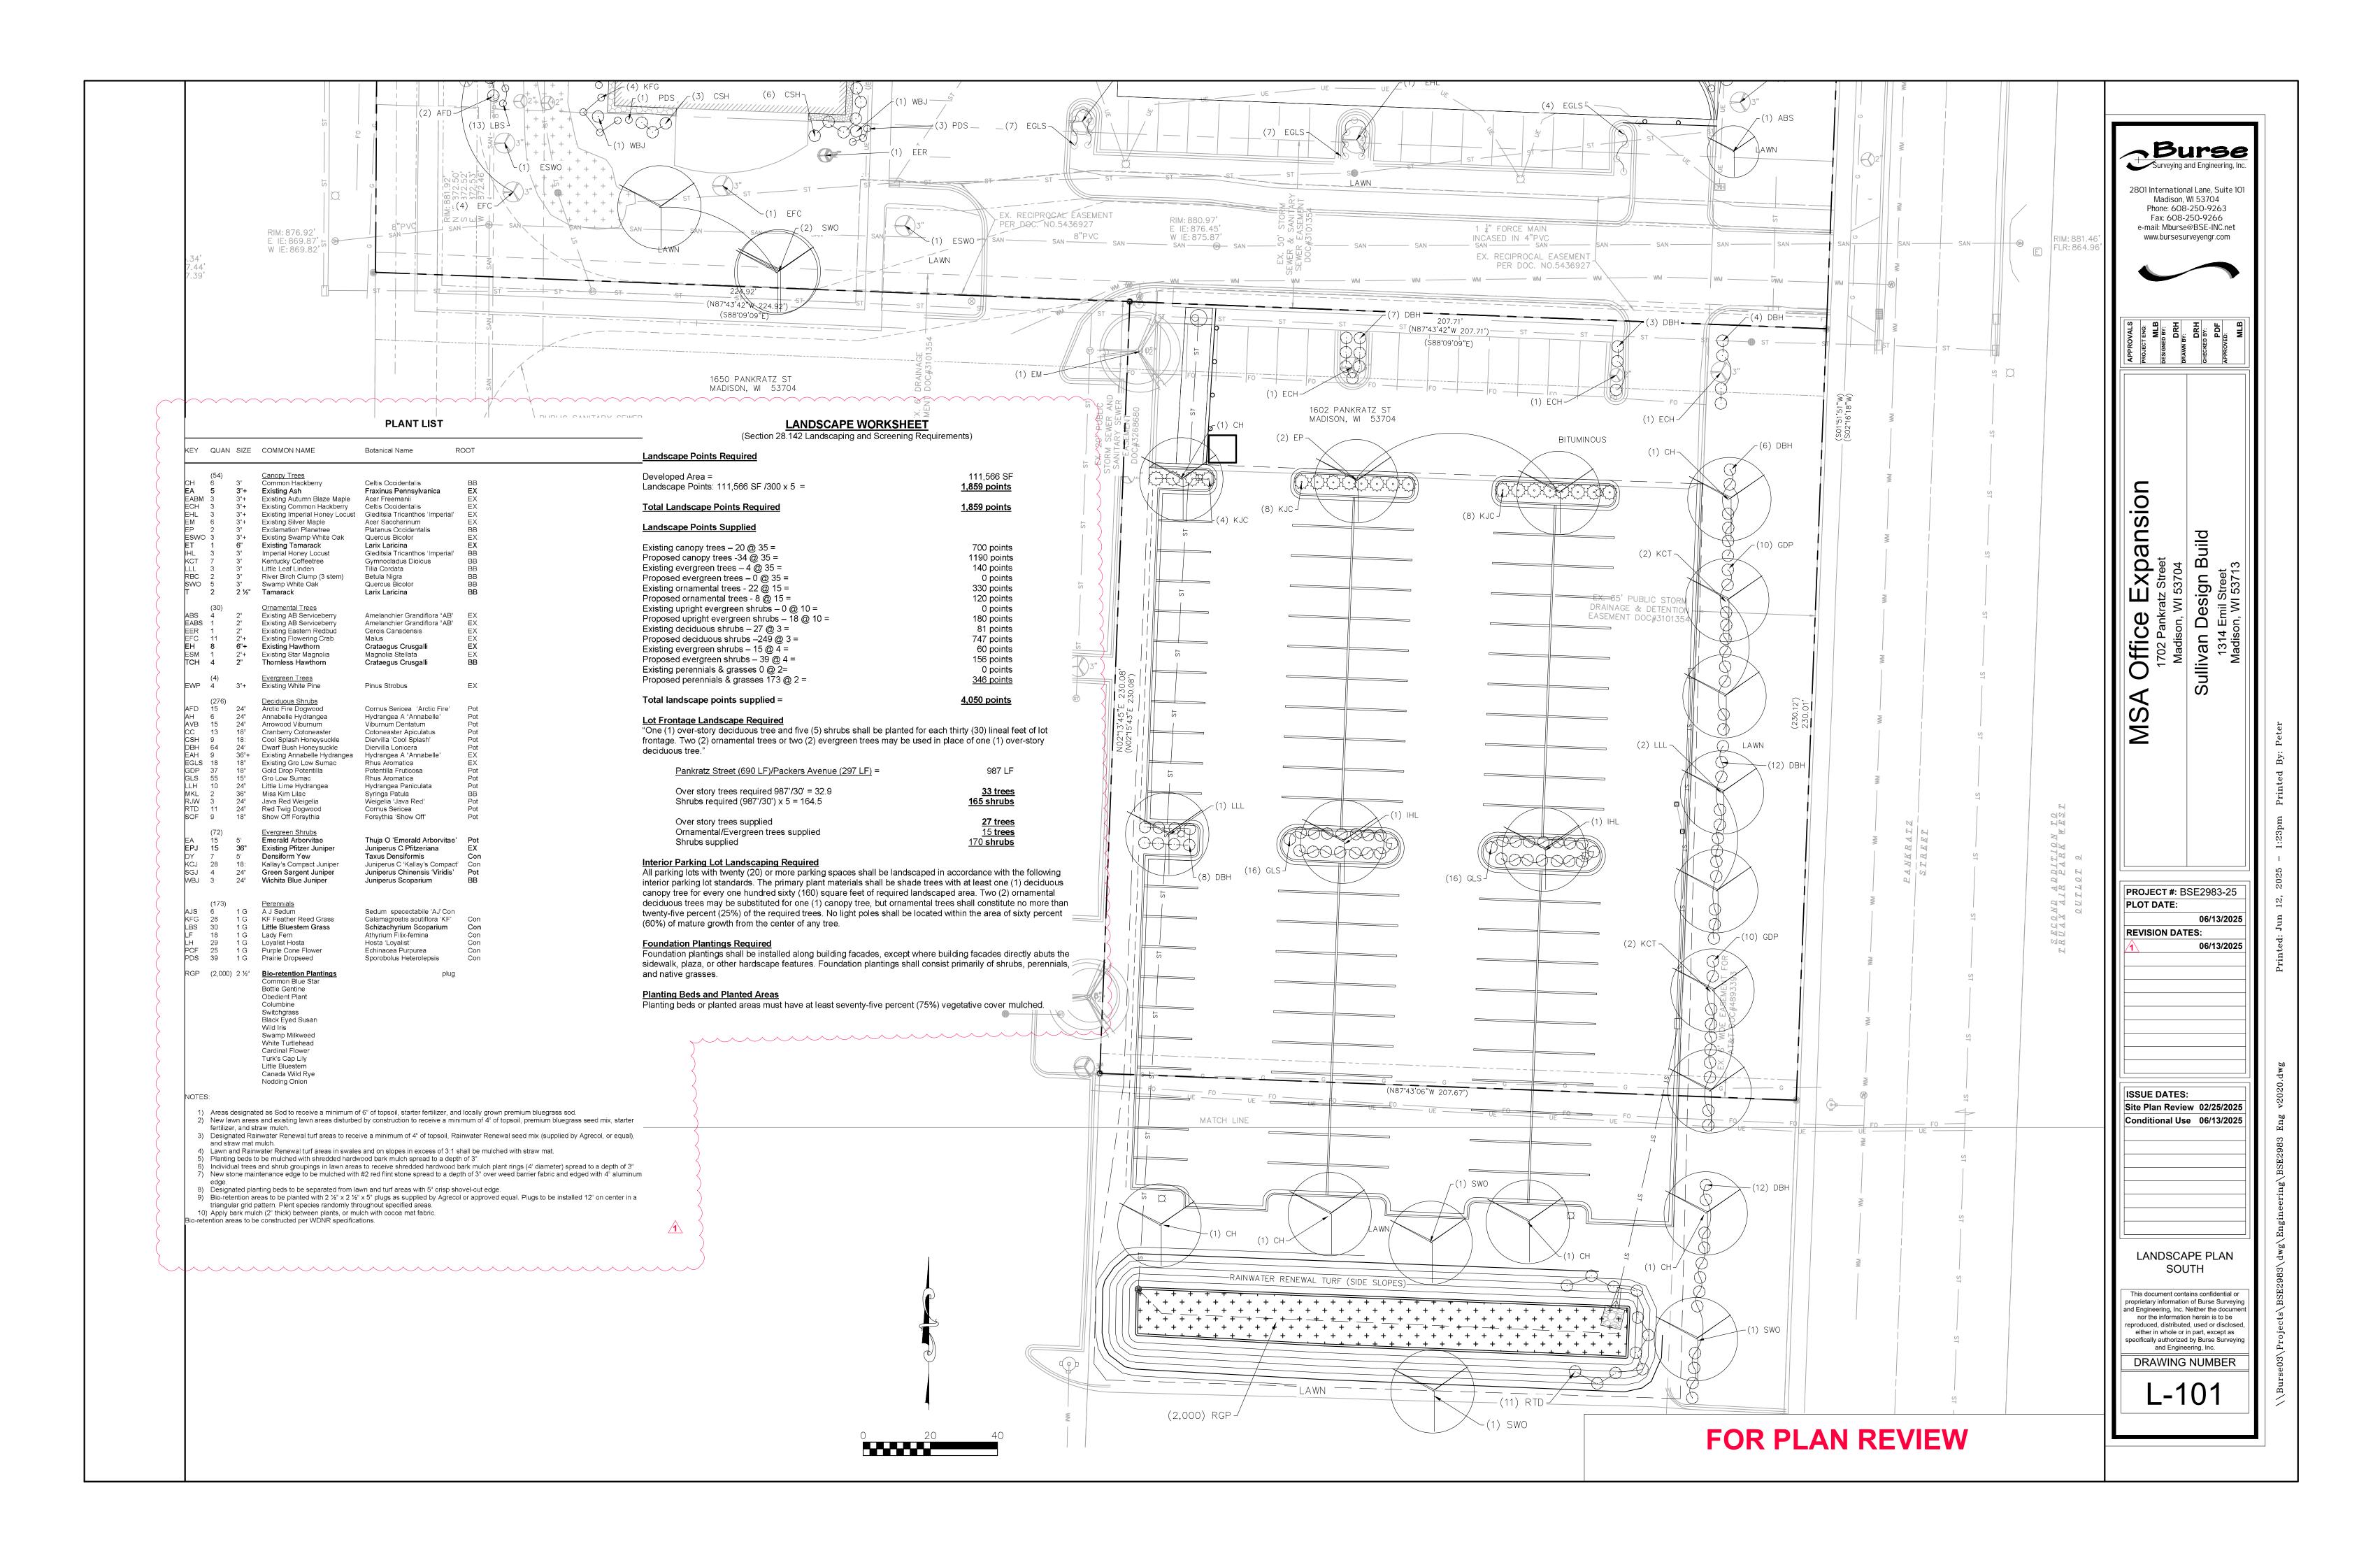


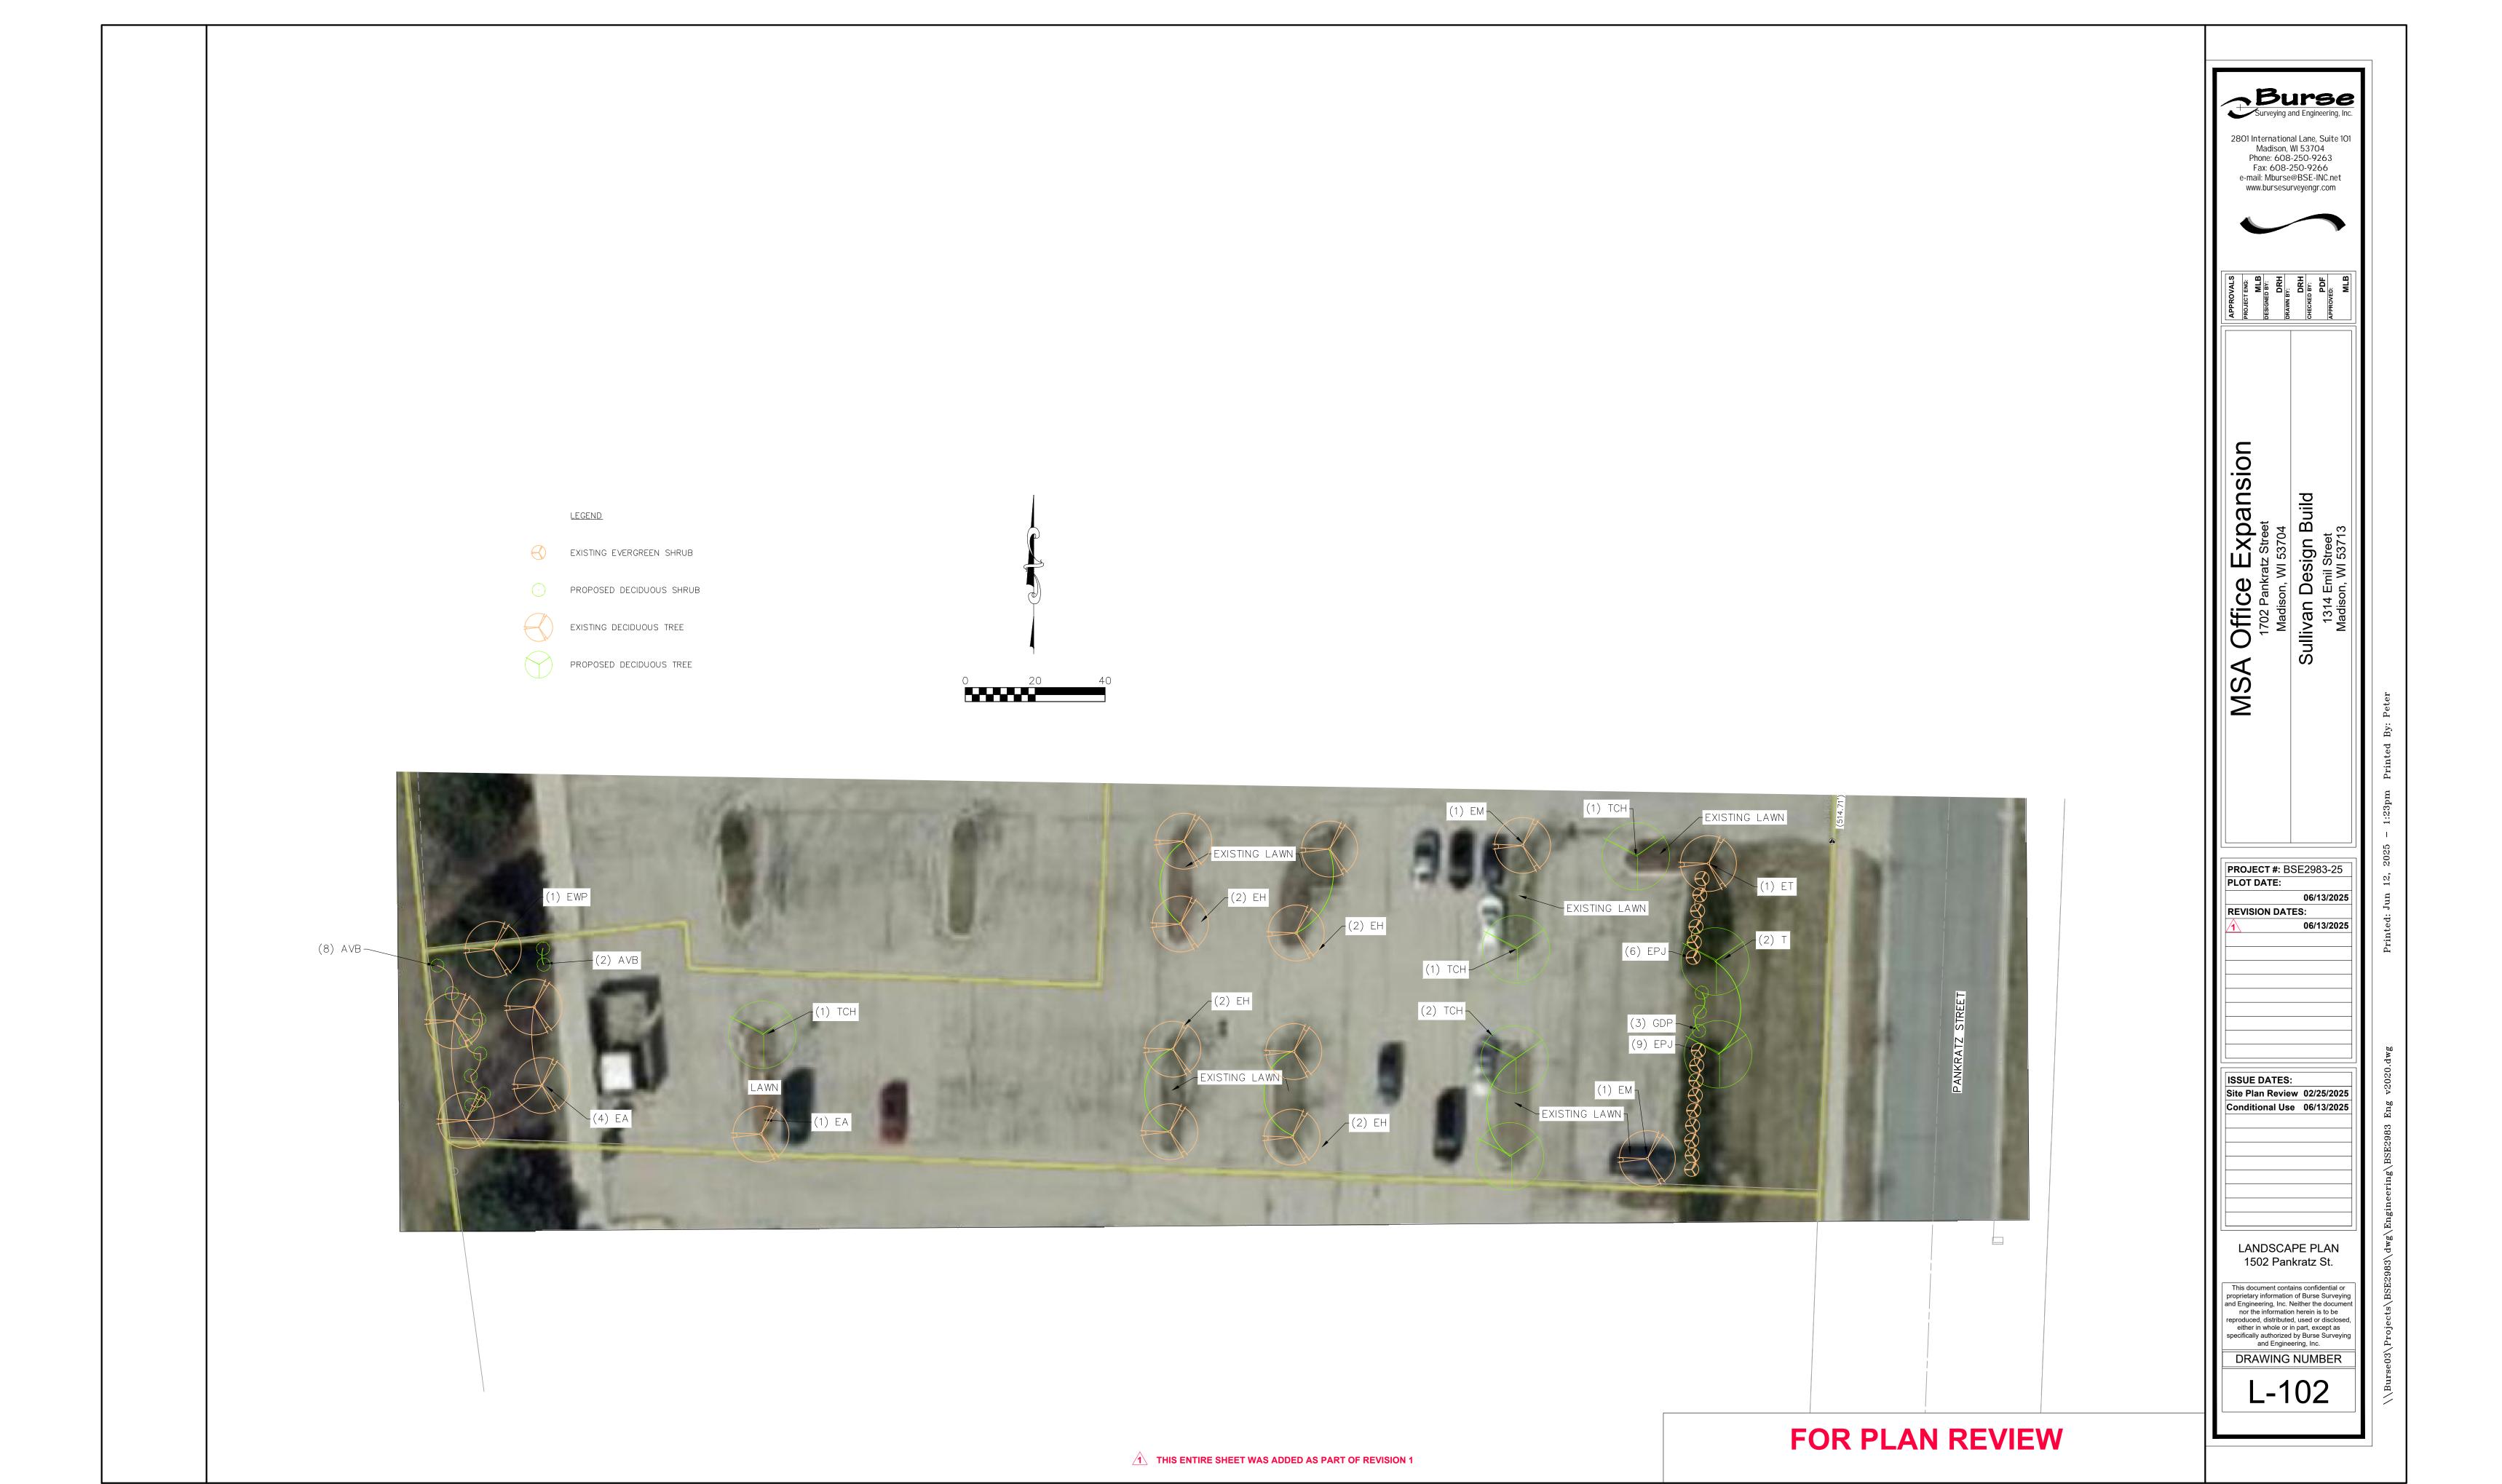


VIEW LOCATION LEGEND

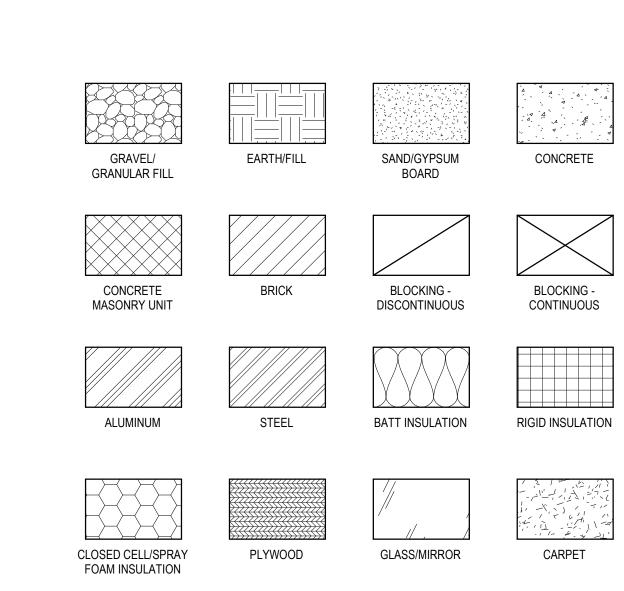

MATERIAL LEGEND

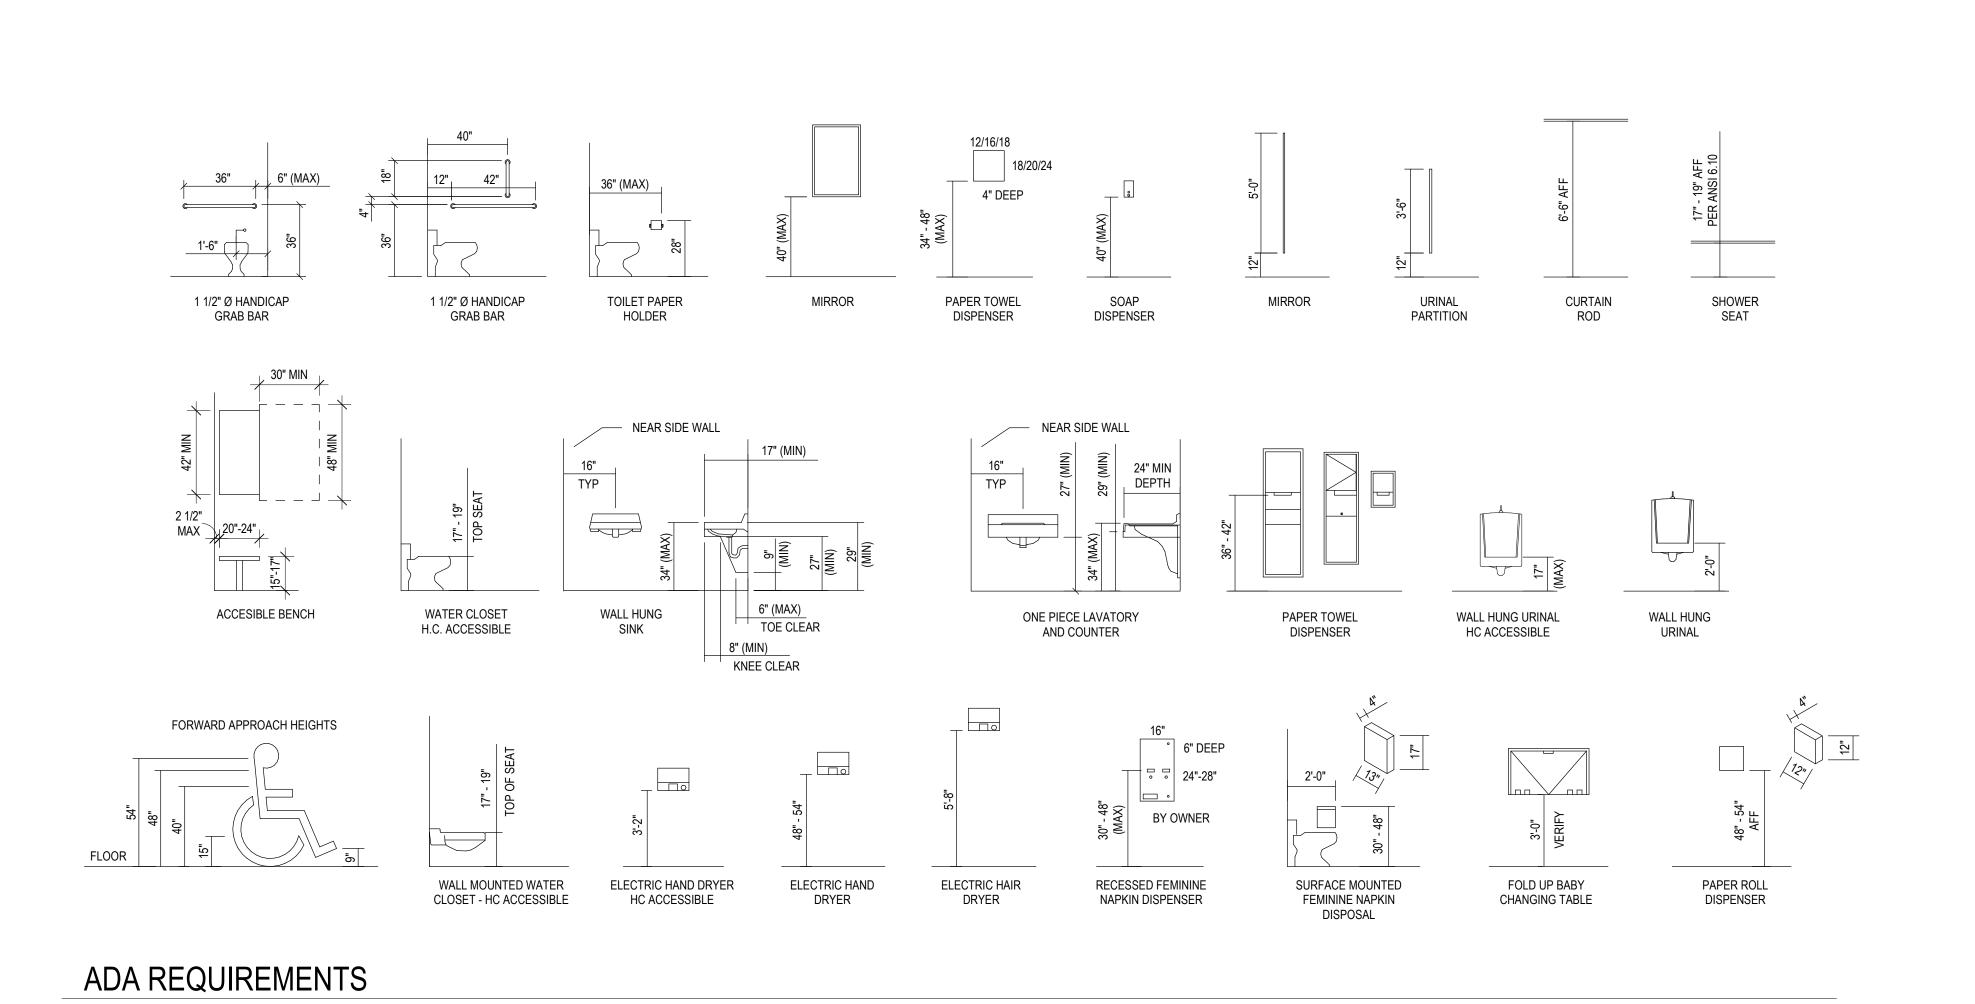

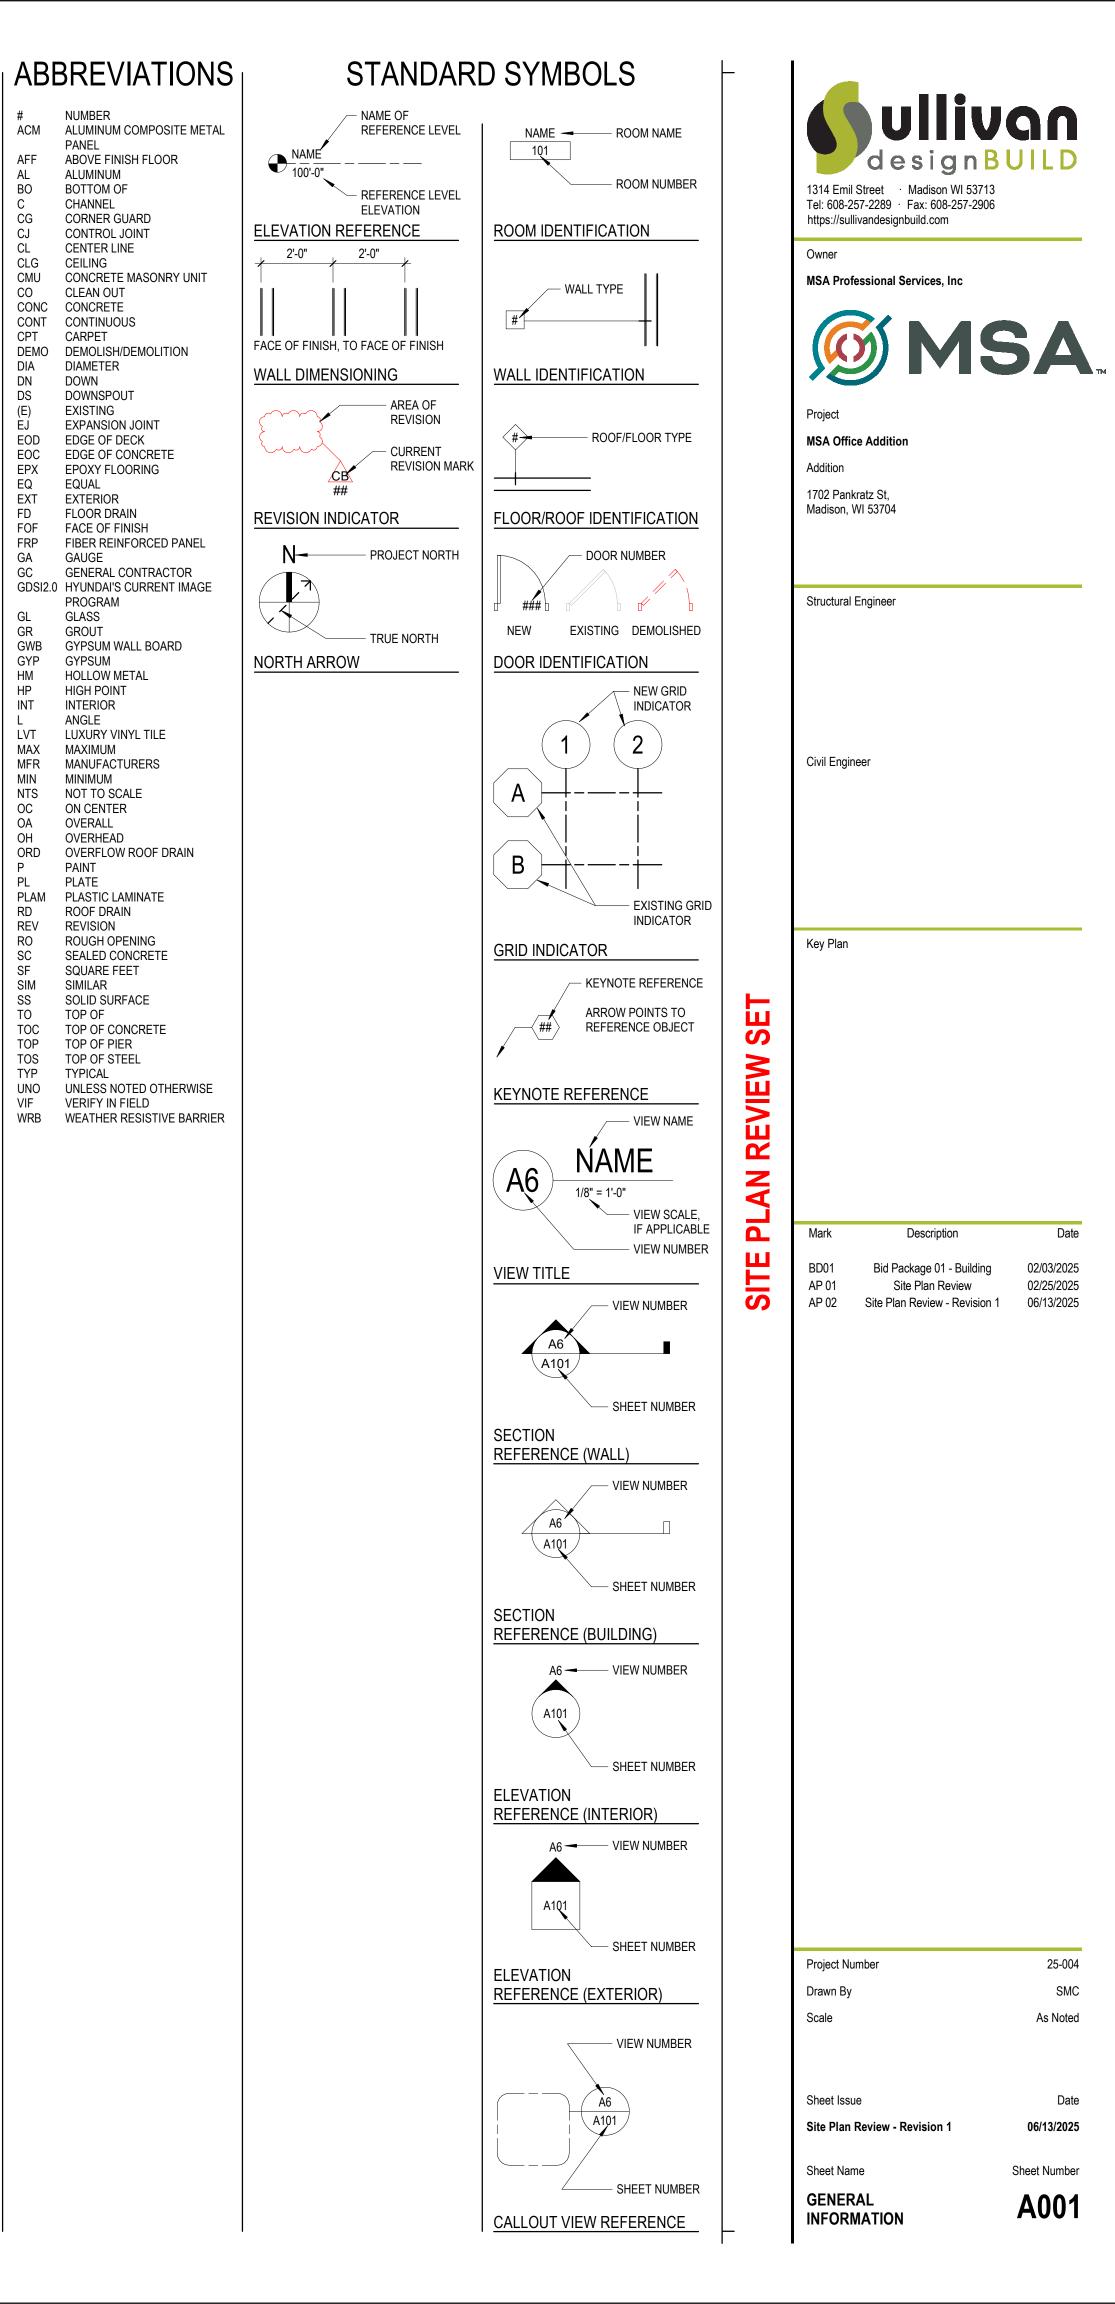


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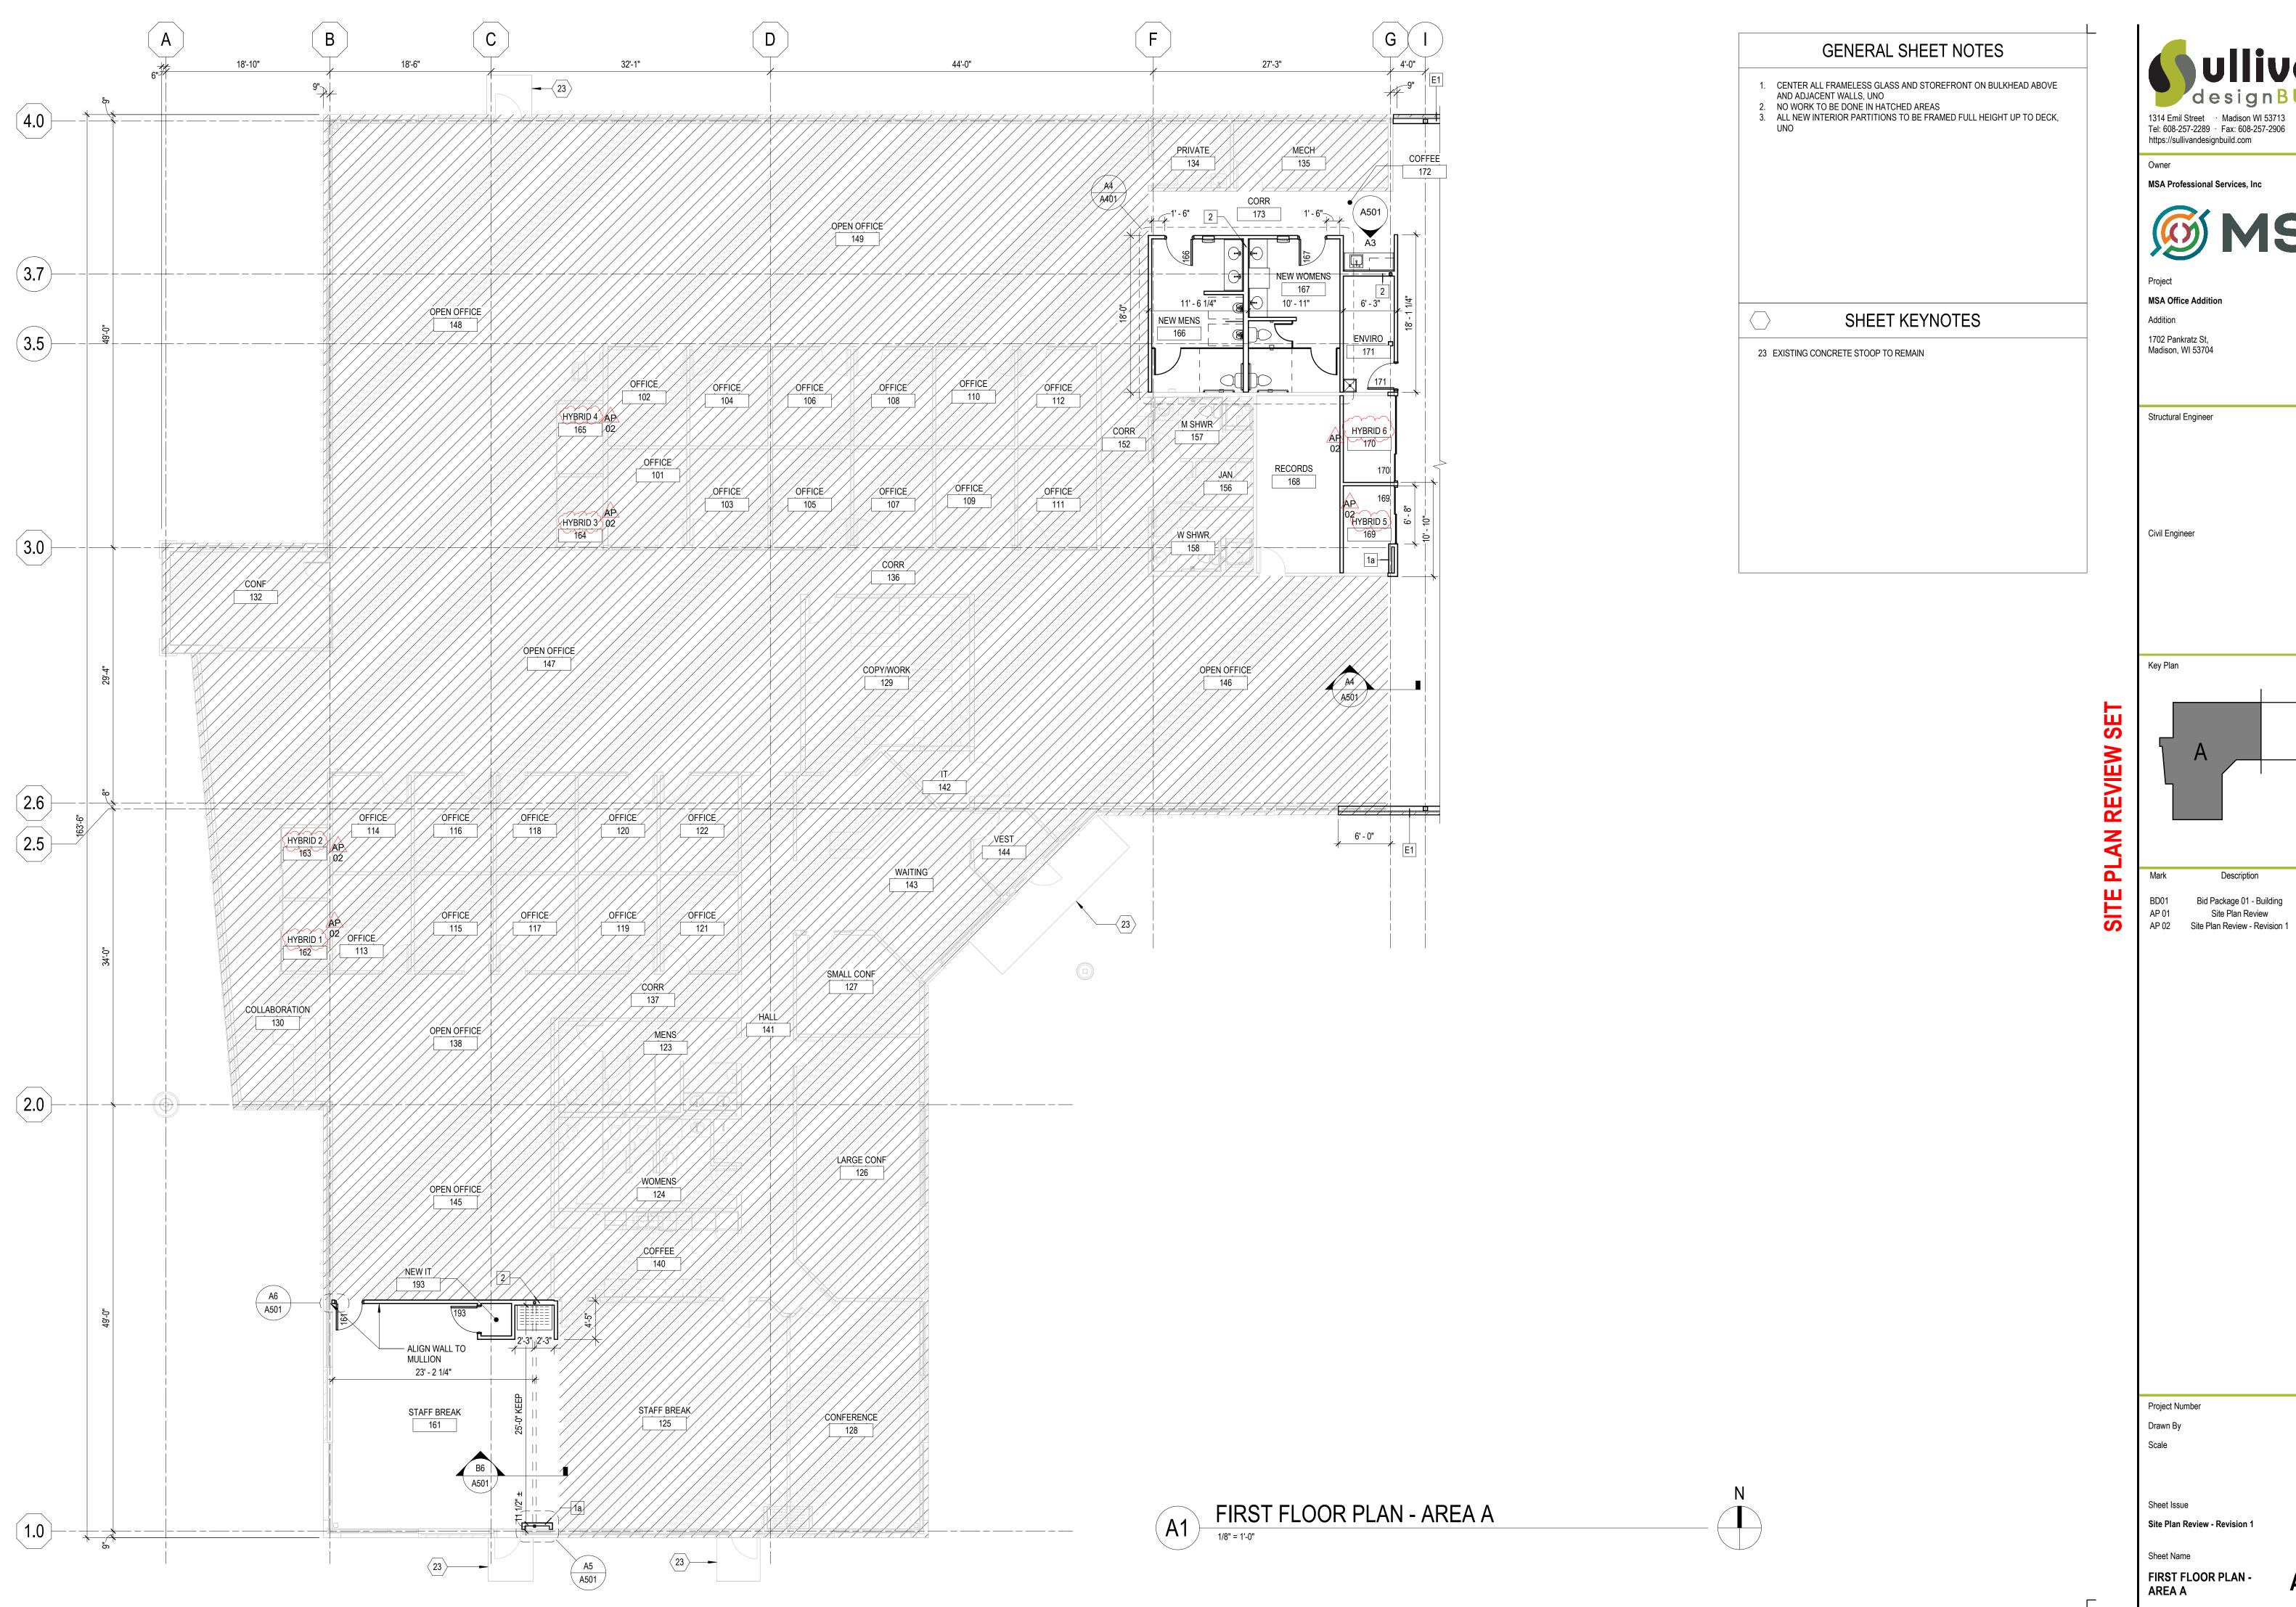
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1314 Emil Street · Madison WI 53713 Tel: 608-257-2289 · Fax: 608-257-2906 https://sullivandesignbuild.com Bid Package 01 - Addendum 01 02/14/2025

Sheet Number A101

OVERALL FIRST FLOOR PLAN



Sheet Name Sheet Number A111a

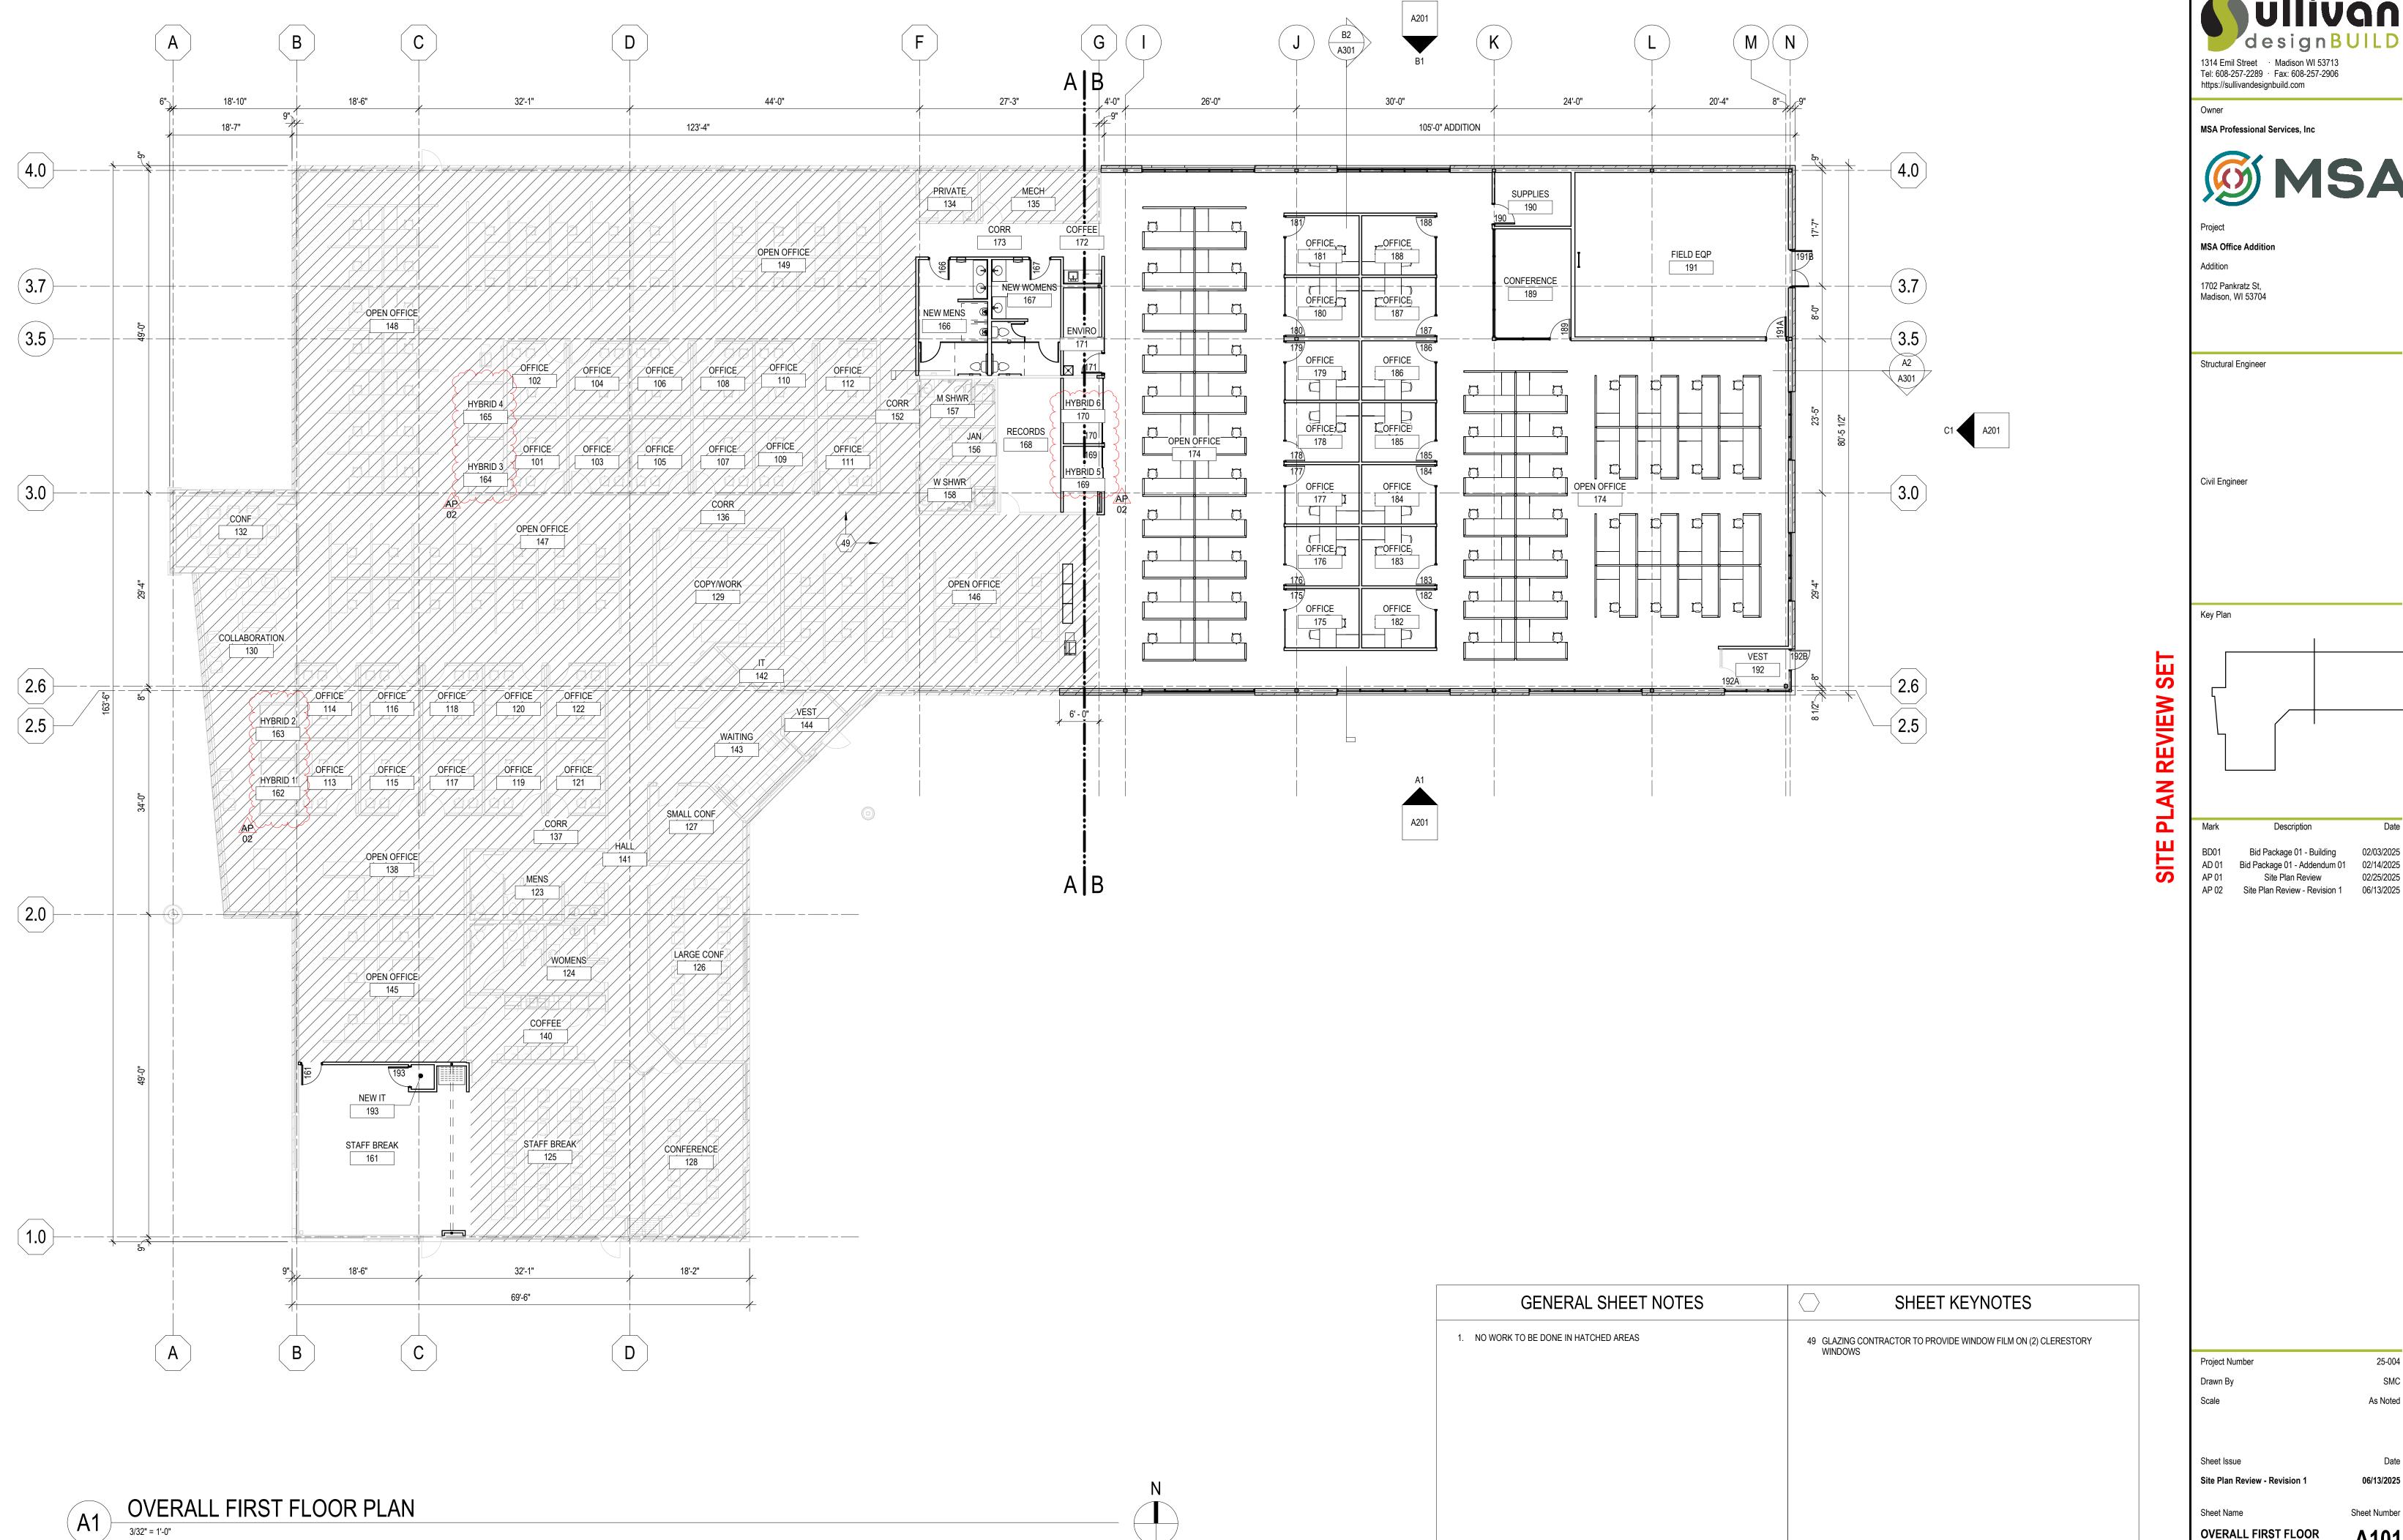FIRST FLOOR PLAN -AREA A

GENERAL SHEET NOTES

1. CENTER ALL FRAMELESS GLASS AND STOREFRONT ON BULKHEAD ABOVE

AND ADJACENT WALLS, UNO

NO WORK TO BE DONE IN HATCHED AREAS
 ALL NEW INTERIOR PARTITIONS TO BE FRAMED FULL HEIGHT UP TO DECK,

4. ELECTRICIAN TO PROVIDE QUAD OUTLETS ABOVE SHELF TOPS IN FIELD EQUIP 191, COORDINATE FINAL LOCATIONS WITH OWNER

SHEET KEYNOTES

22 CONCRETE STOOP, SEE STRUCTURAL 29 GLAZING CONTRACTOR TO REMOVE, SALVAGE AND REPURPOSE EXISTING VESTIBULE FRAMING AND GLAZING AT NEW LOCATION.

38 PROVIDE 5/8" FIRE TREATED PLYWOOD IN LEAU OF DRYWALL UP TO 8' AFF 43 UTILITY SINK

46 ADD ALT SOUND BOARD FULL HEIGHT

1314 Emil Street · Madison WI 53713
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https://sullivandesignbuild.com

MSA Professional Services, Inc

MSA Office Addition

Addition

1702 Pankratz St, Madison, WI 53704

Structural Engineer

Civil Engineer

SET

Key Plan

Bid Package 01 - Addendum 01 02/14/2025

AN REVIEW
 AP 01
 Site Plan Review
 02/25/2025

 AP 02
 Site Plan Review - Revision 1
 06/13/2025

Project Number

Sheet Issue Site Plan Review - Revision 1

Sheet Name Sheet Number FIRST FLOOR PLAN -AREA B A111b

G 4.0 3.5 ORD O RDO ____ 2.5

GENERAL SHEET NOTES

- NOT ALL ROOF PENETRATIONS ARE SHOWN. ROOFING CONTRACTOR TO PROVIDE BOOTS, FLASHING AND OTHER ACCESSORIES REQUIRED TO PROVIDE A COMPLETE, WATERTIGHT WARRANTED SEAL AT ALL NEW ROOF DENETRATIONS.
- PENETRATIONS.

 2. ROOF DRAIN LOCATIONS ARE SHOWN FOR INTENT ONLY. PLUMBING CONTRACTOR TO CONFIRM FINAL ROOF DRAIN SIZES AND LOCATIONS.

 3. HVAC CONTRACTOR TO PROVIDE INSULATED ROOF CURBS FOR ALL HVAC EQUIPMENT

SHEET KEYNOTES

 ROOFING CONTRACTOR TO PROVIDE CONCRETE PAVERS
 ASSUMED RTU LOCATION
 RTU SCREENING. 4' HIGH CORRUGATED METAL PANEL AND METAL STUDS ATTACHED TO TUBE STEEL AT 5' OC MAX 1314 Emil Street · Madison WI 53713
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'roject

MSA Office Addition
Addition

1702 Pankratz St, Madison, WI 53704

Structural Engineer

Civil Engineer

Key Plan

AN REVIEW SET

 Mark
 Description
 Date

 BD01
 Bid Package 01 - Building
 02/03/2025

 AD 01
 Bid Package 01 - Addendum 01
 02/14/2025

 AP 02
 Site Plan Review - Revision 1
 06/13/2025

AP 02 Site Plan Review - Revision 1 06/13/2

Number

Sheet Issue
Site Plan Review - Revision 1

et Name Sh

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BIRD SAFE MARKINGS

1/4" ø TYP 2" OC

GENERAL SHEET NOTES	SHEET KEYNOTES
1. ALL NEW GLAZING TO BE BIRD SAFE	30 CLEAR ANNODIZED ALUMINUM AND BIRD SAFE GLASS STOREFRONT. SEE EXTERIOR FRAME ELEVATIONS. 32 HOLLOW METAL DOOR

TO PARAPET	A3 A312 MT-1 MP-1 A5 A312	A1 A312	A1 A311 MT-1 MP-1
TO PARAPET			
TO WINDOW			
FIRST FLOOR	30 ST-1 ST-1	30 ST-2 ST-1	32

MADIC	EXTERIOR FINISH SCHEDULE									
MARK	MATERIAL	MANUFACTURER	MODEL	COLOR	FINISH	DIMENSIONS	APPLICATION	COMMENTS		
MP-1	METAL PANEL	CMG	ULTRA-LOC	SILVER		14"x38" NOMINAL	}	INSTALL RUNNING BOND. TO MATCH EXISTING IN COLOR, FINISH, SIZE AND INSTALL PATTERN VIF BEFORE MANUFACTURE.		
MP-2	METAL PANEL	CMG	ULTRA FLUSH SOFFIT PANEL	BURNISHED SLATE			EXTERIOR	COLOR TO MATCH EXISTING.		
MT-1	METAL FLASHING	CMG		BURNISHED SLATE			EXTERIOR	COLOR TO MATCH EXISTING.		
ST-1	MANUFACTURED STONE	ARRISCRAFT	URBAN LEDGERSTONE	DUSK	SPLIT FACE	3 5/8"xRANDOM	\	INSTALL RANDOM PATTERN. TO MATCH EXISTING IN COLOR, FINISH, SIZE AND INSTALL PATTERN. VIF BEFORE MANUFACTURE.		
ST-2	MANUFACTURED STONE		THIN-CLAD ARRIS-TILE RENAISSANCE	GRAPHITE	SMOOTH	8"x24"	\	INSTALL RUNNING BOND. TO MATCH EXISTING IN COLOR, FINISH, SIZE AND INSTALL PATTERN VIF BEFORE MANUFACTURE.		

Key Plan

AN REVIEW SET AP 01 Site Plan Review
AP 02 Site Plan Review - Revision 1

1314 Emil Street · Madison WI 53713 Tel: 608-257-2289 · Fax: 608-257-2906 https://sullivandesignbuild.com

MSA Professional Services, Inc

MSA Office Addition

1702 Pankratz St, Madison, WI 53704

Structural Engineer


Civil Engineer

Addition

EAST ELEVATION

3/16" = 1'-0" ST-2 30 ST-1

NORTH ELEVATION

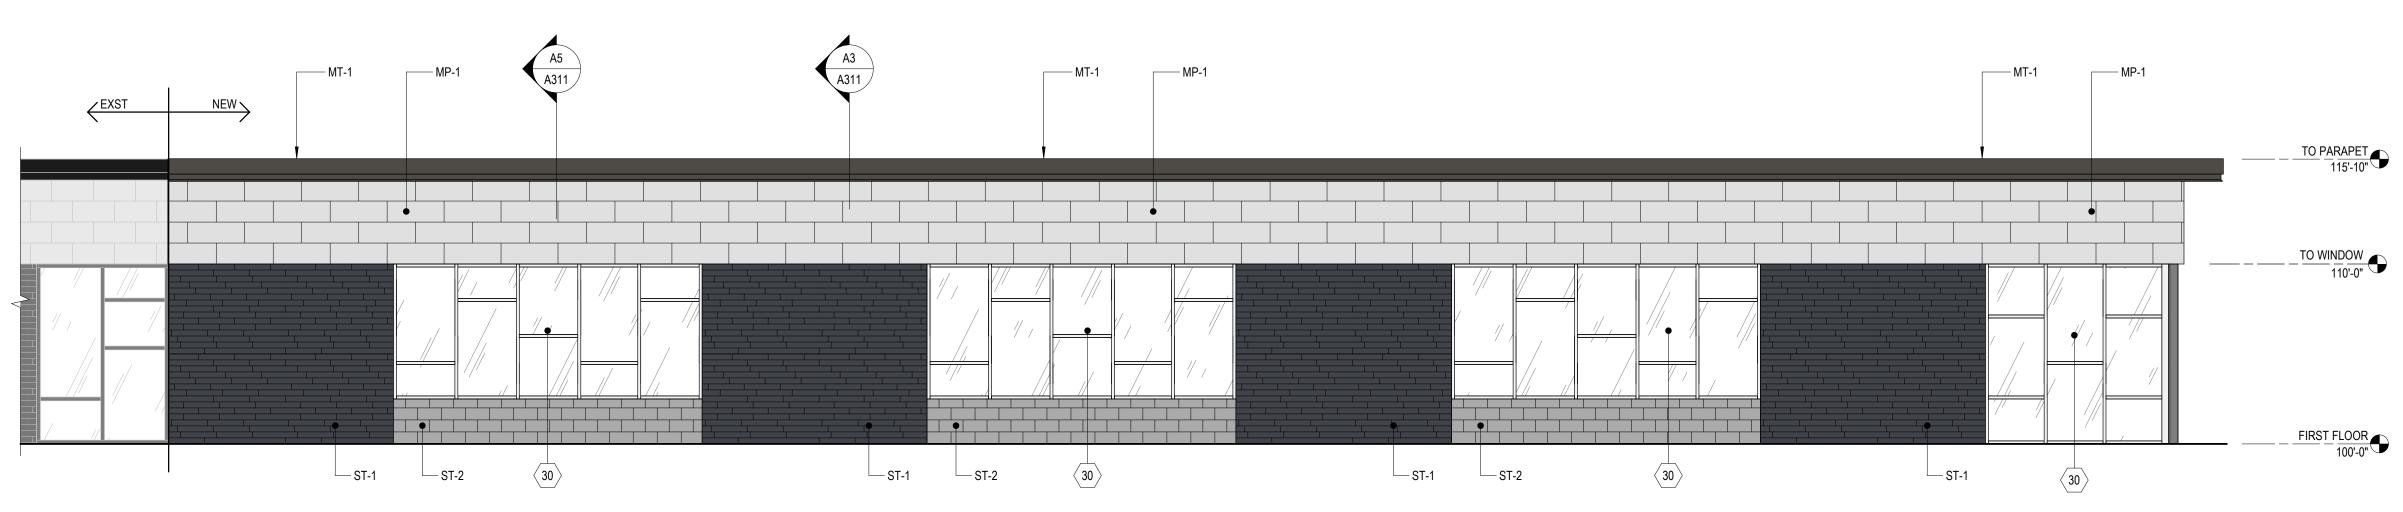

SOUTH ELEVATION

3/16" = 1'-0"

EXTERIOR ELEVATIONS

Sheet Issue


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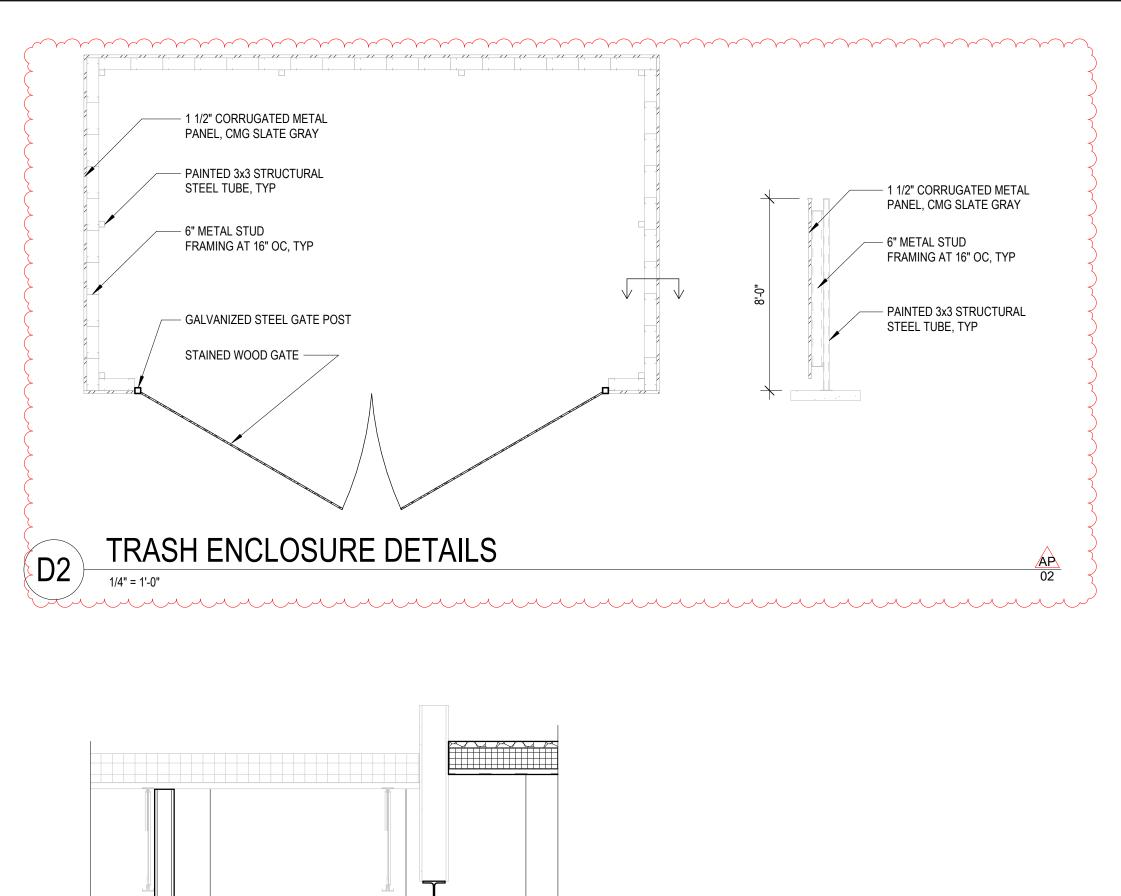
Site Plan Review - Revision


A201


BILCO TYPE S ROOF HATCH -

INSULATED ROOF CURB -



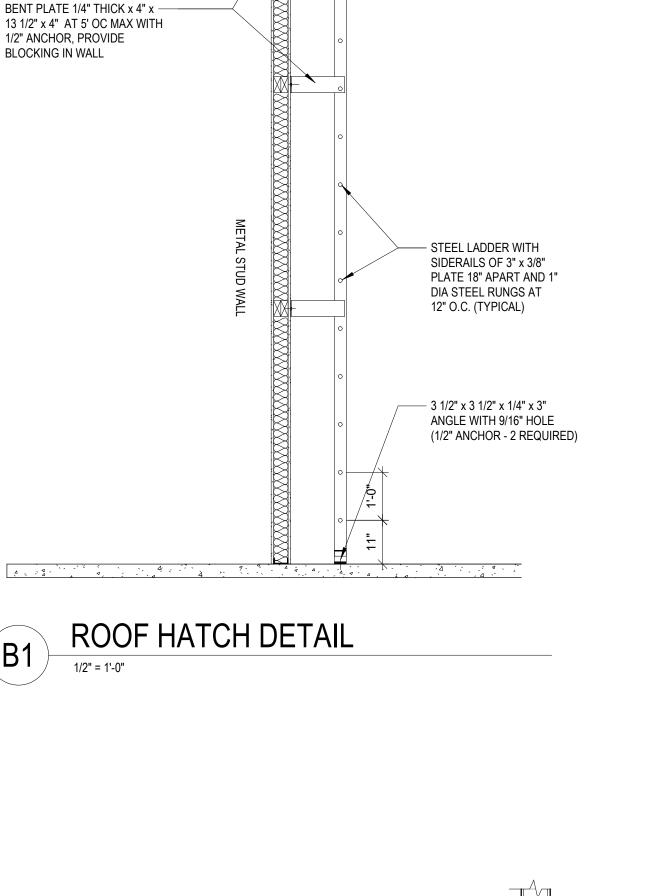

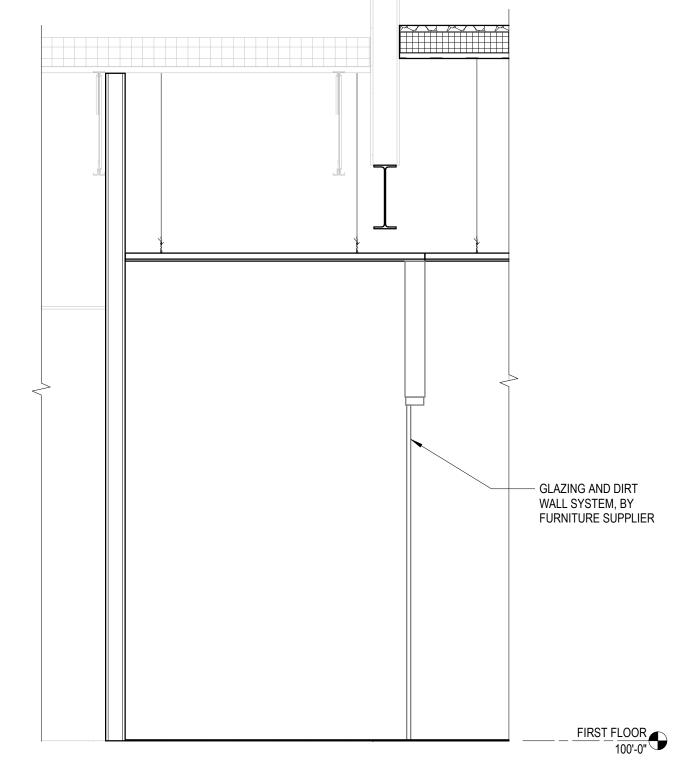

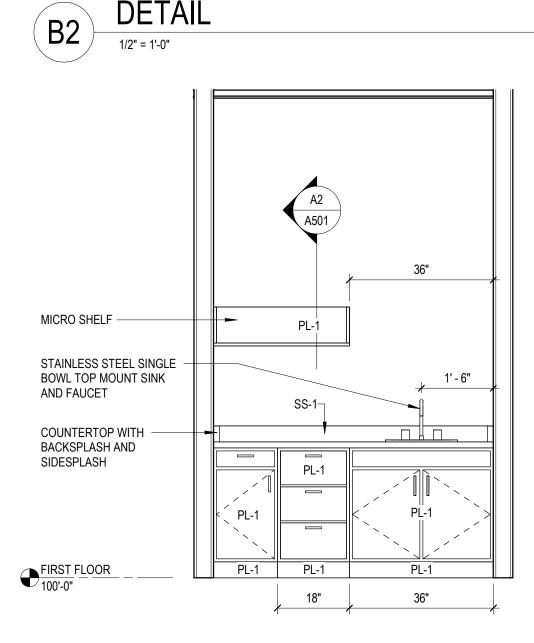

DETAIL

- MICRO SHELF

- (1) MOVEABLE SHELF

- WHITE MELAMINE


INTERIOR, TYP

18"


24"


SECTION



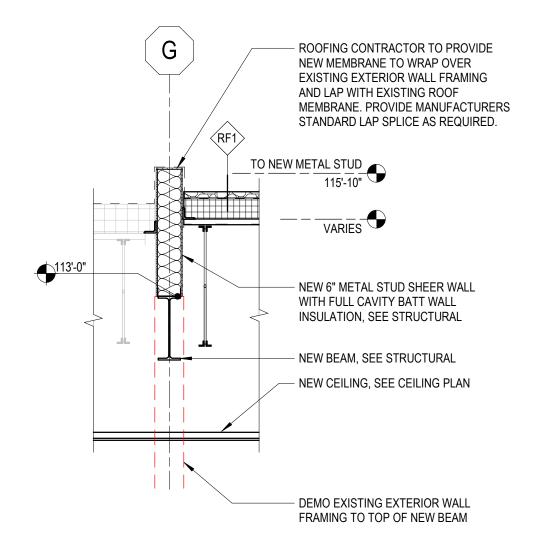




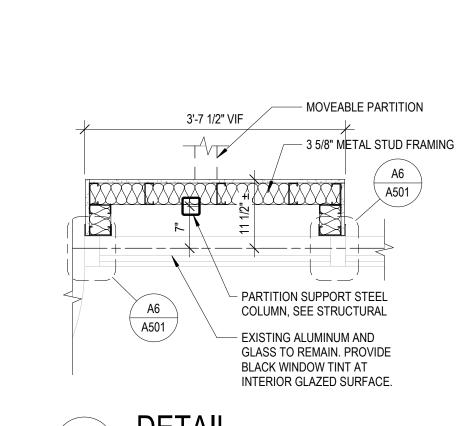

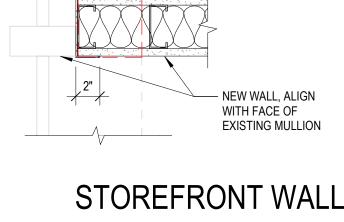

STOREFRONT WALL TRANSITION DETAIL



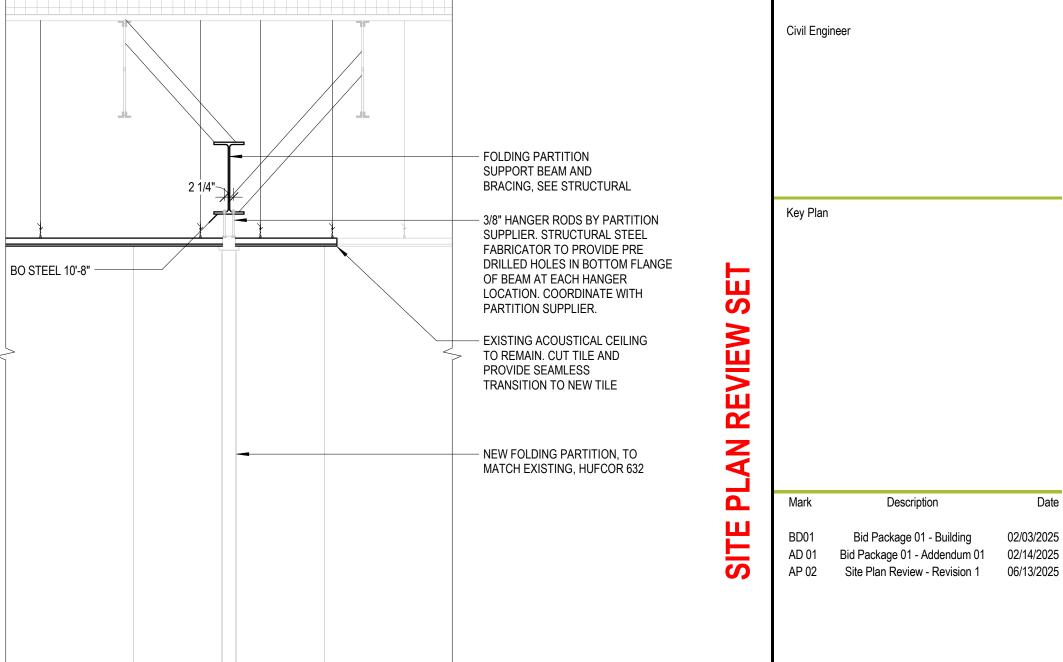

- PROVIDE ALUMINUM TRIM TO

MATCH STOREFRONT. WRAP AROUND WALL AS SHOWN.

- EXISTING SILL AND KNEE

WALL BELOW TO REMAIN

- DEMO EXISTING LAMINATED SILL AND KNEE WALL BELOW

Project Number Drawn By Scale As Noted Sheet Issue

Site Plan Review - Revision 1 06/13/2025 Sheet Name Sheet Number **DETAILS** A501

RTU SCREEN SUPPORT

FULL DEPTH FLASHING AT TOP —

4" METAL STUD WALL AT 16" OC -

CMG CORRUGATED METAL PANEL -

4" PIPE RTU SCREEN -SUPPORT, SEE STRUCTURAL

ROOFING CONTRACTOR TO —

SCREEN SUPPORT LOCATION

PROVIDE PRE-MOLDED SQUARE PIPE SEAL AT EACH

DETAIL

DETAIL AT OPERABLE PARTITION

1/2" = 1'-0"