# BAKERS PLACE T.I. CM100

# Neutral Studio

## **SHEET LIST:**

C000 - SITE SURVEY BY OTHERS C001 - SITE SURVEY BY OTHERS

C401 - SITE UTILITY PLAN

C601 - 1ST LEVEL LANDSCAPE PLAN

F101 - FIRE ACCESS PLAN


CV002.B - SCOPE SUMMARY


A101 - 1ST LEVEL FLOOR PLAN - CONSTRUCTION BULLETIN 10


A401 - NORTH ELEVATION - BUILDING PERMIT
A401.1 - NORTH ELEVATION - PROPOSED CHANGES

A403 - EAST AND WEST ELEVATIONS - BUILDING PERMIT A403.1 - EAST AND WEST ELEVATIONS - PROPOSED CHANGES

CV102 - PROPOSED FLOOR PLAN - DELIVERIES AND WASTE MANAGEMENT

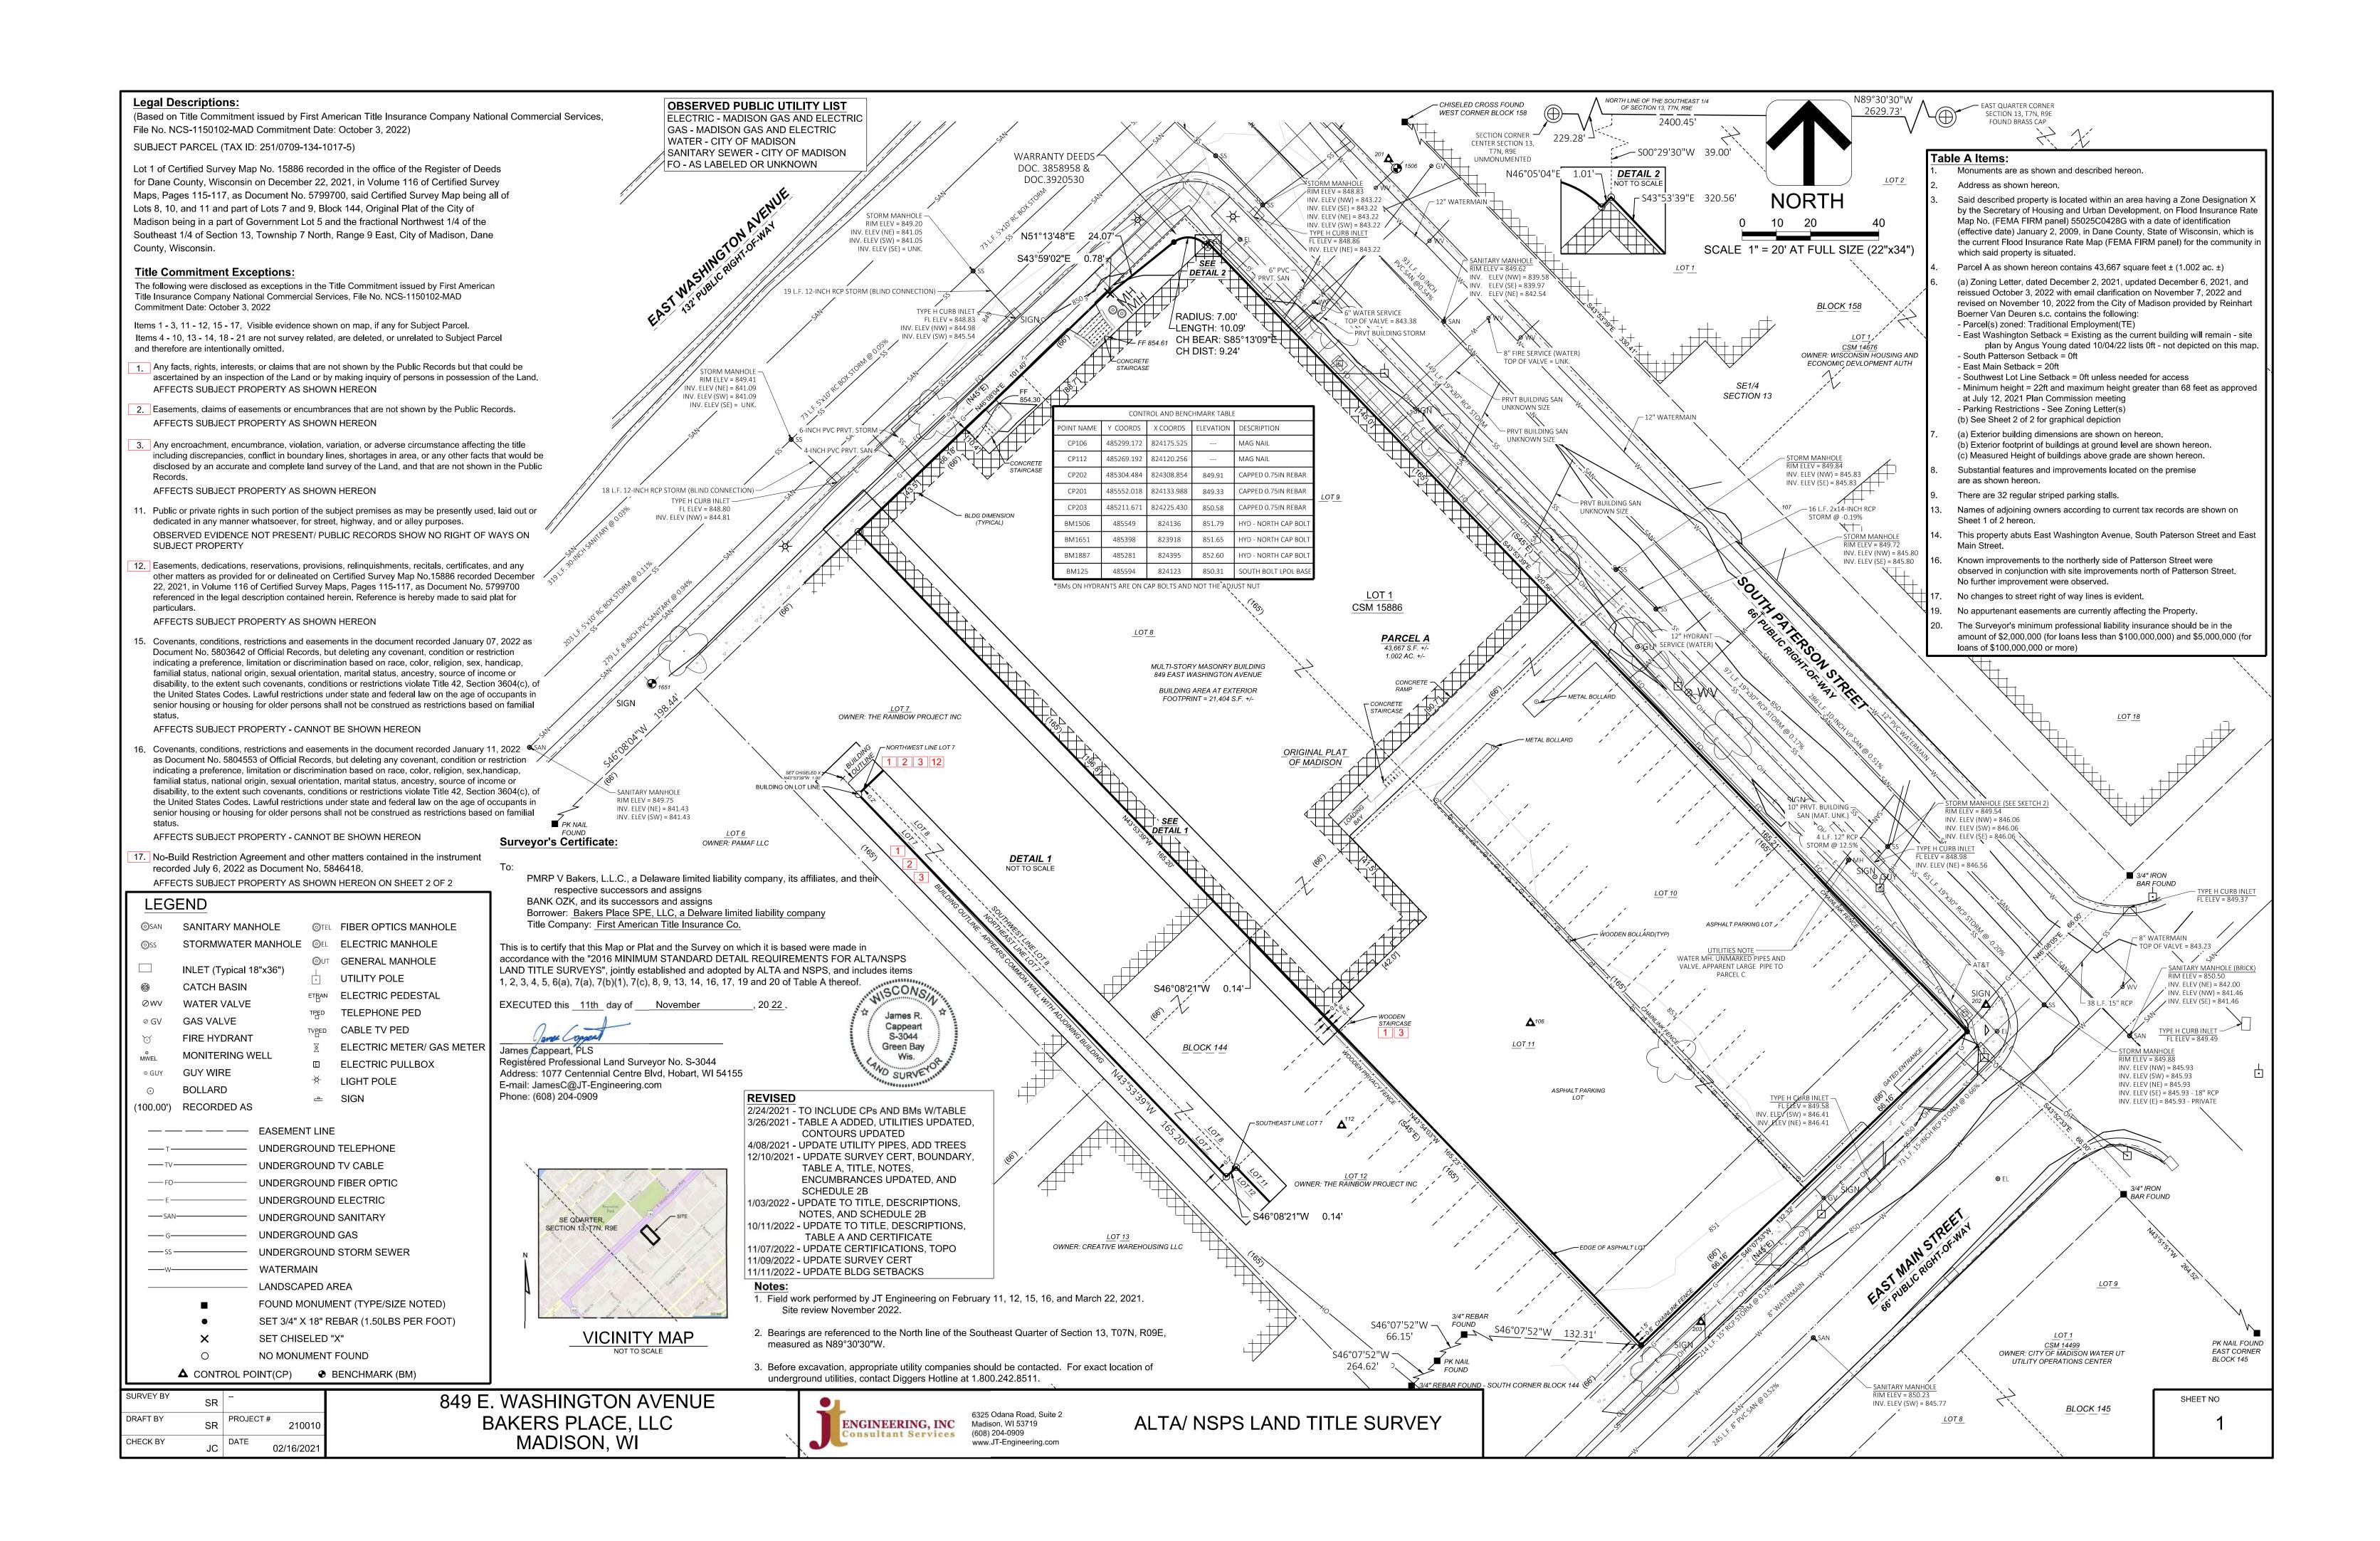

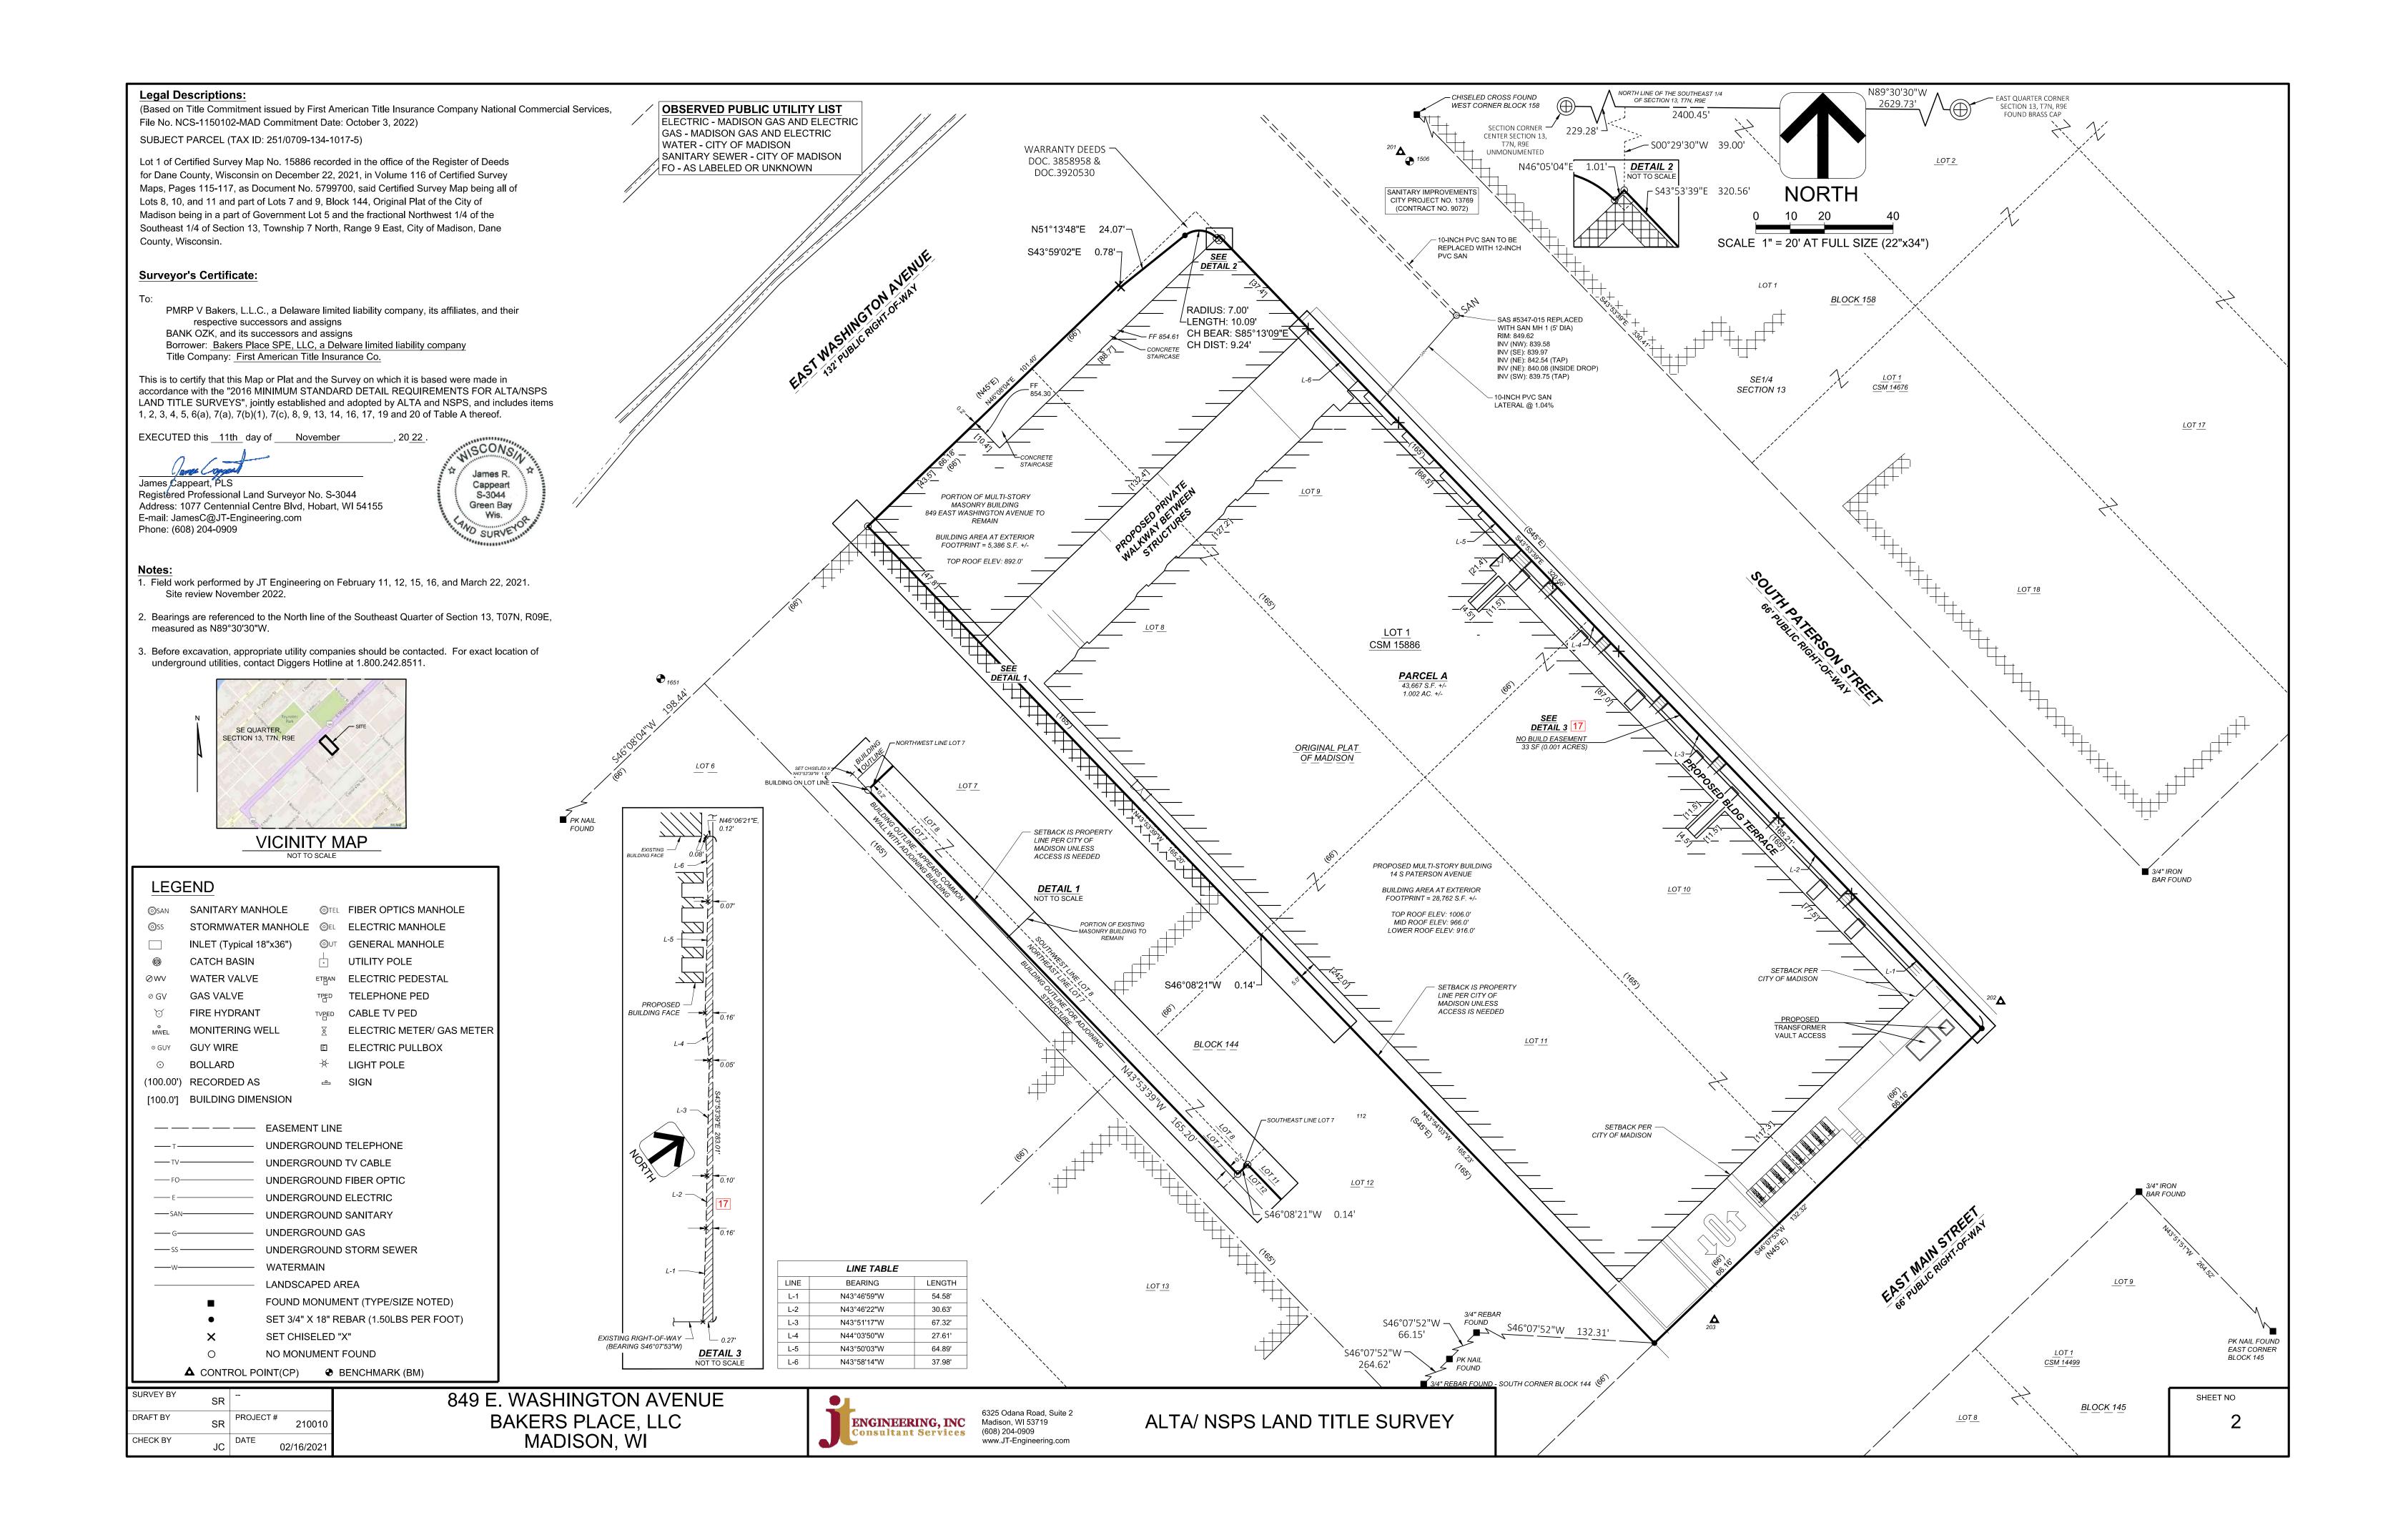

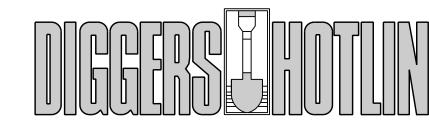

CALL TOLL FREE 1-800-242-851 MILWAUKEE AREA 414-259-1181 FAX A LOCATE 1-800-338-3860 TDD (HEARING IMPAIRED) 1-800-542-2289 ONLINE: www.DiggersHotline.com WISCONSIN STATUE 182.0175 (1974) REQUIRES A MINIMUM OF THREE (3) WORKING DAYS NOTICE PRIOR TO EXCAVATION.

	SITE SYMBOL LEGEND				
<del>+</del>	SIGN				
(0)	BOLLARD				
A	FIRE HYDRANT				
0	MANHOLE/CATCH BASIN/INLET				
	CURB INLET				
	NEW FLARED END SECTION WITH RIPRAP AND GUARD				
XXX,XX	NEW SPOT ELEVATION (FEET)				
TC XXX.XX BC XXX.XX	NEW TOP OF CURB ELEVATION (FEET) NEW BOTTOM OF CURB ELEVATION (FEET)				
TS XXX.XX BS XXX.XX	NEW TOP OF STEP (FEET) NEW BOTTOM OF STEP (FEET)				
RE / IE XXX.XX	RIM OR INVERT ELEVATION (FEET)				
8	WATER VALVE OR GAS VALVE				
XO 8	LIGHT POLE				
<del></del>	UTILITY POLE				
	NEW STRUCTURE OR ADDITION				
	EXISTING STRUCTURE				

NEW 10" PVC SANITARY LATERAL, PROVIDE 2" THICK INSULATION FROST PROTECTION, SEE DETAIL 13/C801. CONNECT TO CITY SANITARY MANHOLE, FIELD VERIFY INVERTS OF PIPE CROSSINGS.

02 NEW GAS LATERAL, COORDINATE WITH MG&E

03 NEW UNDERGROUND POWER TO VAULT IN LOWER LEVEL, COORDINATE WITH MG&E

04 NEW COMBINED DOMESTIC AND FIRE PROTECTION WATER SERVICE AND VALVE, PROVIDE THRUST BLOCKING AT BEND, SEE DETAIL 01/C401. PROVIDE TWO LATERALS FROM MAIN, AND PROVIDE VALVE AT MAIN BETWEEN TWO LATERAL CONNECTIONS.

NEW WATER SERVICE AND VALVE TO EXISTING BULDING, FIELD VERIFY ENTRANCE

NEW BURIED UNDERGROUND POWER BY MG&E, FIELD VERIFY

08 NEW CARD READER

NEW STORM SEWER CONNECTION TO EXISTING STORM STRUCTURE, FIELD VERIFY

11 NEW STORM INLET, SEE PLUMBING FOR CONTINUATION

PROVIDE NEW 4" PVC SANITARY EXIT BUILDING, FIELD VERIFY INVERT, CONNECT TO EXISTING 4" SANITARY LATERAL.

13 INTERCEPT EXISTING ANTICIPATED 4" STORM LATERAL TO AVOID INTERIOR EXISTING CHIMNEY, COORDINATE FINAL LOCATION WITH PLUMBING CONTRACTOR. PROVIDE CLEANOUT INSIDE BUILDING

CAMERA EXISTING SANITARY SEWER TO DETERMINE DAMAGE AND VERIFY SIZE. IF DAMAGED, REPLACE WITH NEW 6" PVC SANITARY.

SITE UTILITY PLAN GENERAL NOTES 1. TRUE NORTH MAY VARY FROM PROJECT NORTH.


. CONSTRUCTION PRACTICES, MEANS AND METHODS, AND JOB SITE SAFETY, SHALL REMAIN THE SOLE RESPONSIBILITY OF THE CONTRACTOR. 3. ALL WORK SHALL BE PERFORMED IN COMPLIANCE WITH THE FEDERAL OCCUPATIONAL HEALTH AND SAFETY ADMINISTRATION (OSHA), AND ALL FEDERAL, STATE AND LOCAL CODES AND ORDINANCES AS THEY PERTAIN TO THE PROJECT.

1. THE PROJECT. 4. FIELD VERIFY ALL EXISTING AND PROPOSED UTILITIES, ELEVATIONS AND DIMENSIONS. 5. COORDINATE RELOCATION OF ANY UTILITIES WITH THE UTILITY COMPANIES. NOTIFY THE ELECTRICAL UTILITY OF ANY EXCAVATION ADJACENT TO HIGH VOLTAGE LINES. PROTECT ALL UTILITIES TO REMAIN. 6. DIGGERS HOTLINE SHALL BE CALLED TO MARK UTILITIES PRIOR TO LAND DISTURBANCE.


7. COORDINATE WITH THE AUTHORITY HAVING JURISDICTION AND UTILITY COMPANIES AS NECESSARY.
8. PROVIDE THRUST BLOCKING AND PIPE JOINT RESTRAINT FOR DUCTILE IRON WATER LATERALS. PROVIDE WATER CONNECTIONS AND CONTROL VALVES IN ACCORDANCE WITH STATE AND LOCAL REQUIREMENTS. 9. CONTRACTOR SHALL RESTORE CURB AND GUTTER AND PAVEMENT WORK TO MEET AUTHORITY HAVING JURISDICTION REQUIREMENTS. SAWCUT PAVEMENT TO PROVIDE CLEAN EDGE. 10. TRACER WIRE SHALL BE INSTALLED ABOVE ALL SANITARY, STORM AND WATER LATERALS THAT CONNECT TO A PUBLIC UTILITY. TRACER WIRE SHALL BE A MINIMUM OF 12 GAUGE, PLASTIC-COATED COPPER WIRE BURIED WITHIN 6" AND DIRECTLY ABOVE THE TOP OF THE PIPE. THE TRACER WIRE SHALL BE BROUGHT TO THE SURFACE AT LEAST EVERY 400'. PROTECT THE WIRE AT THE ACCESS POINTS. THE COLOR OF THE TRACER WIRE SHALL BE AS FOLLOWS:
- GREEN FOR SANITARY SEWER

- BROWN FOR STORM SEWER - BLUE FOR POTABLE WATER 11. PROVIDE TRENCH BEDDING. UTILITY TRENCHES UNDER CONCRETE PAVEMENT SHALL UTILIZE FLOWABLE FILL IN AREAS DIFFICULT TO COMPACT TO PREVENT CONCRETE CRACKING. 12. PROVIDE MIN. 7'-0" COVER OVER WATER LATERAL. SEE GRADING PLAN SHEET FOR EXISTING AND PROPOSED GRADES. COORDINATE AS NECESSARY, PARTICULARLY AROUND STORMWATER FACILITIES. PROVIDE MIN. 18" CLEARANCE UNDER OR 12" CLEARANCE OVER SANITARY AND STORM SEWER PIPES.
13. ALL SANITARY, STORM, AND WATER UTILITY WORK WITHIN PUBLIC RIGHT OF WAY SHALL CONFORM TO

AUTHORITY HAVING JURISDICTION REQUIREMENTS AND STANDARD SPECIFICATIONS. 14. RESTORE ALL AREAS TO SEEDED LAWN UNLESS NOTED OTHERWISE. 15. SEE ARCHITECTURAL AND PLUMBING DRAWINGS FOR ROOF DRAIN LOCATIONS. 16. THE RIGHT-OF-WAY IS THE SOLE JURISDICTION OF THE CITY OF MADISON AND IS SUBJECT TO CHANGE AT ANY TIME PER THE RECOMMENDATION/PLAN OF TRAFFIC ENGINEERING AND CITY ENGINEERING DEPARTMENTS. 17. ALL WORK WITHIN THE CITY RIGHT-OF-WAY AND ALL PUBLIC IMPROVEMENTS TO SERVE THE PROJECT, INCLUDING LATERAL CONNECTIONS, SHALL BE COMPLETED PER THE CITY OF MADISON ISSUED PLANS

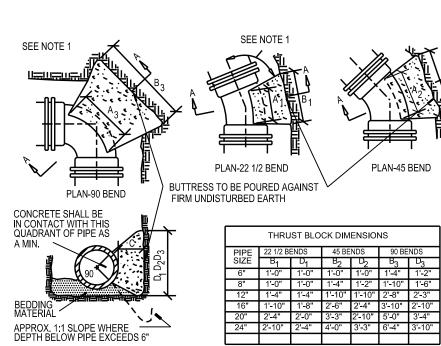

SECTION A-A NOTES: 1. DIMENSION C SHOULD BE LARGE ENOUGH TO MAKE ANGLE EQUAL TO OR LARGER THAN 45. 2. DIMENSION A1, A2, A3 SHOULD BE AS LARGE AS POSSIBLE WITHOUT INTERFERING WITH M.J. BOLTS. 3. SHAPE OF BLOCK MAY VARY AS LONG AS POUR IS AGAINST FIRM UNDISTURBED EARTH. 4. ALL IRON PIPE AND FITTINGS SHALL BE WRAPPED IN POLYETHYLENE PRIOR TO POURING THRUST BLOCKS.

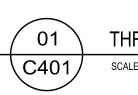

THRUST BLOCKING FOR BENDS SCALE: NOT TO SCALE

ARCHITECTS/ENGINEERS Janesville | Madison

> THE NEUTRAL PROJECT

**BAKERS PLACE** DEVELOPMENT

849 E. WASHINGTON AVE. 10 S. PATERSON MADISON, WI 53703

BAKERS PLACE



**EQUILIBRIUM** Equilibrium Consulting Inc Structural Engineers

ISSUANCES / REVISIONS NO: DESCRIPTION: 8 DD BID PACKAGE #1 1 BID PACKAGE #2 3 50% CD SET 11/08/2022 14 | 100% CD SET 12/08/2022 6 ADDENDUM 01 7 PLAN REVIEW/ FOR CONSTRUCTION 03/15/202

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PROJECT NUMBER 71420 APPROVED BY JAD

> REVIEWED BY JAD DRAWN BY

SITE UTILITY PLAN

KAU

Total SF Developed Area (Paved Areas

and Greenspace, Excluding Building)

Site Zoned TE, Provide 5 landscape point

Plant Type / Element

Shrub, Deciduous, #3 Gallon, 12-24" H 3 72

per 300 sf Developed Area

Landscape

Proposed Landscaping

Quantity Achieved

152 Required

**Points** 

Total Number of Points Provided:

REMOVE ANY AIR POCKETS

NOTE: REMOVE DAMAGED

BRANCHES AND WATER

IMMEDIATELY AFTER

4

CONTAINER PLANTING IN LANDSCAPE BED

TWICE THE WIDTH OF CONTAINER

SCALE: 1"=1'-0"

CREATE SAUCER WITH EXCAVATED

COMPACTED

\C601/

FXCAVATION SHALL BE 6"

ALLOW WATER TO DRAIN

HIGHER IN CENTER TO

UNDISTURBED EARTH

2 DIAMETERS OF ROOT BALL PLACE BALL ON INDICATION OF THE PROPERTY OF THE PROPE

NOTES: 1. DETERMINE THE PROPER SIZE TREE STAPLE DEVICE BY MEASURING THE DEPTH OF THE ROOT BALL AND ADDING 12" TO 18". THIS SHOULD EQUAL THE LONG PRONG SIZE OF THE

2. IN EXTREME WIND AND/OR LOOSE SOIL CONDITIONS, USE THREE TREE STAPLE DEVICES

B.B. SHRUB AND TREE PLANTING DETAIL

DEVICE. IF NECESSARY, ROUND UP TO THE NEXT SIZE.

PER TREE AND/OR ROUND UP TO THE NEXT SIZE.

SCALE: NONE


TOPSOIL, FIRMLY

PART COMPOST MIX

PLACE SLOW-RELEASE

BOTTOM OF EXCAVATION

∖C601*/* 

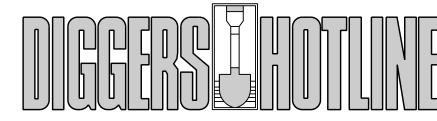

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LANDSCAPE SYMBOL LEGEND						
+	SHADE TREE					
+	ORNAMENTAL TREE					
	EVERGREEN SHRUB OR TREE					
$\odot$	DECIDUOUS SHRUB					
$\circ$	ORNAMENTAL GRASS					
⊙ ⊚	PERENNIAL					
	EXISTING VEGETATION					
	EXISTING EVERGREEN					

### NOTE: ALL SYMBOLS MAY NOT BE USED IN THIS SET.

### LANDSCAPE GENERAL NOTES

1. TRUE NORTH MAY VARY FROM PROJECT NORTH.
2. CONSTRUCTION PRACTICES, MEANS AND METHODS, AND JOB SITE SAFETY, SHALL REMAIN THE SOLE RESPONSIBILITY OF THE CONTRACTOR. 3. FIELD VERIFY ALL EXISTING AND PROPOSED UTILITIES, ELEVATIONS AND DIMENSIONS. DIGGERS HOTLINE SHALL BE CALLED TO MARK UTILITIES PRIOR TO LAND DISTURBANCE. RESTORE ALL AREAS TO SOD UNLESS NOTED OTHERWISE 6. ALL PLANTING BEDS SHALL RECEIVE 3" THICK SHREDDED BARK MULCH AND BLACK ANODIZED ALUMINUM EDGING.

7. ALL INDIVIDUAL TREES SHALL RECEIVE 4'-0" DIAMETER, 3" THICK SHREDDED BARK MULCH TREE RING WITH SPADE CUT EDGE. MULCH SHALL BE PULLED AWAY FROM TRUNK OF TREE TO PREVENT ROT.

8. ALL LAWN TO BE RESTORED WITH SEED AND EROSION MAT OR HYDROMULCH UNLESS NOTED OTHERWISE.

- WISDOT URBAN TYPE B EROSION MAT SHALL BE PROVIDED ON SLOPES 4:1 OR GREATER. 9. SEE DETAILS 26/C601 AND 31/C601 FOR PLANTING DETAILS. 10. IN THE EVENT THAT QUANTITY DISCREPANCIES OR MATERIAL OMISSIONS OCCUR IN THE PLANT MATERIALS LIST, THE PLANTING PLANS SHALL GOVERN. 11. ALL PROPOSED STREET TREE REMOVALS WITHIN THE RIGHT OF WAY SHALL BE REVIEWED BY CITY FORESTRY BEFORE THE PLAN COMMISSION MEETING. STREET TREE REMOVALS REQUIRE APPROVAL AND A TREE REMOVAL PERMIT ISSUED BY CITY FORESTRY. ANY STREET TREE REMOVALS REQUESTED AFTER THE DEVELOPMENT PLAN IS APPROVED BY THE PLAN COMMISSION OR THE BOARD OF PUBLIC WORKS AND CITY FORESTRY WILL REQUIRE A MINIMUM OF A 72-HOUR REVIEW PERIOD WHICH SHALL INCLUDE THE NOTIFICATION OF THE ALDERPERSON WITHIN WHO'S DISTRICT IS AFFECTED BY THE STREET TREE REMOVAL(S) PRIOR TO A TREE REMOVAL PERMIT BEING ISSUED.
- 12. AS DEFINED BY THE SECTION 107.13 OF CITY OF MADISON STANDARD SPECIFICATIONS FOR PUBLIC WORKS CONSTRUCTION: NO EXCAVATION IS PERMITTED WITHIN 5 FEET OF THE TRUNK OF THE STREET TREE OR WHEN CUTTING ROOTS OVER 3 INCHES IN DIAMETER. IF EXCAVATION IS NECESSARY, THE CONTRACTOR SHALL CONTACT MADISON CITY FORESTRY (266-4816) PRIOR TO EXCAVATION. CITY OF MADISON FORESTRY PERSONNEL SHALL ASSESS THE IMPACT TO THE TREE AND TO ITS ROOT SYSTEM PRIOR TO WORK COMMENCING. THIS CAN BE FOUND HERE: https://www.citvofmadison.com/business/pw/documents/StdSpecs/2021/Part1.pdf 13. CONTRACTOR SHALL TAKE PRECAUTIONS DURING CONSTRUCTION TO NOT DISFIGURE, SCAR, OR IMPAIR THE HEALTH OF ANY STREET TREE. CONTRACTOR SHALL OPERATE EQUIPMENT IN A MANNER AS TO NOT DAMAGE THE BRANCHES OF THE STREET TREE(S). THIS MAY REQUIRE USING SMALLER EQUIPMENT AND LOADING AND UNLOADING MATERIALS IN A DESIGNATED SPACE AWAY FROM TREES ON THE CONSTRUCTION SITE. ANY DAMAGE OR INJURY TO EXISTING STREET TREES
- (EITHER ABOVE OR BELOW GROUND) SHALL BE REPORTED IMMEDIATELY TO CITY FORESTRY AT 266-4816. PENALTIES AND REMEDIATION SHALL BE REQUIRED. 14. SECTION 107.13(G) OF CITY OF MADISON STANDARD SPECIFICATIONS FOR PUBLIC WORKS CONSTRUCTION ADDRESSES SOIL COMPACTION NEAR STREET TREES AND SHALL BE FOLLOWED BY CONTRACTOR. THE STORAGE OF PARKED VEHICLES, CONSTRUCTION EQUIPMENT, BUILDING MATERIALS, REFUSE, EXCAVATED SPOILS OR DUMPING OF POISONOUS MATERIALS ON OR AROUND TREES AND ROOTS WITHIN FIVE (5) FEET OF THE TREE OR WITHIN THE PROTECTION ZONE IS PROHIBITED.
- 15. SECTION 107.13(G) OF CITY OF MADISON STANDARD SPECIFICATIONS FOR PUBLIC WORKS CONSTRUCTION ADDRESSES SOIL COMPACTION NEAR STREET TREES AND SHALL BE FOLLOWED BY CONTRACTOR. THE STORAGE OF PARKED VEHICLES, CONSTRUCTION EQUIPMENT, BUILDING MATERIALS, REFUSE, EXCAVATED SPOILS OR DUMPING OF POISONOUS MATERIALS ON OR AROUND TREES AND ROOTS WITHIN FIVE (5) FEET OF THE TREE OR WITHIN THE PROTECTION ZONE IS PROHIBITED.
- 16. STREET TREE PRUNING SHALL BE COORDINATED WITH MADISON FORESTRY AT A MINIMUM OF TWO WEEKS PRIOR TO THE START OF CONSTRUCTION FOR THIS PROJECT. ALL PRUNING SHALL FOLLOW THE AMERICAN NATIONAL STANDARDS INSTITUTE (ANSI) A300 - PART 1 STANDARDS FOR
- 17. STREET TREE PLANTING SHALL ADHERE TO CITY OF MADISON STANDARD SPECIFICATIONS SECTION 209 FOR PUBLIC WORKS CONSTRUCTION. AT LEAST ONE WEEK PRIOR TO STREET TREE PLANTING, CONTRACTOR SHALL CONTACT CITY FORESTRY AT (608) 266-4816 TO SCHEDULE INSPECTION AND APPROVAL OF NURSERY TREE STOCK AND REVIEW PLANTING SPECIFICATIONS WITH THE LANDSCAPER. 18. ALL WORK WITHIN THE CITY RIGHT-OF-WAY AND ALL PUBLIC IMPROVEMENTS TO SERVE THE PROJECT, INCLUDING LATERAL CONNECTIONS, SHALL BE COMPLETED PER THE CITY OF MADISON ISSUED PLANS (CONTRACT 9072, PROJECT 13769).

O1 CONTRACTOR SHALL CONTACT CITY OF MADISON FORESTRY DEPARTMENT AT 608-266-4816 TO ISSUE A STREET TREE REMOVAL PERMIT FOR TWO (2) ASH TREES, 23-24" DBH DUE CONSTRUCTION ACCESS ON PATERSON STREET, AND ONE (1) CRABAPPLE (7" DBH) ON EAST MAIN DUE TO NEW DRIVEWAY OPENING. ON THIS PROJECT, STREET TREE PROTECTION ZONE FENCING IS REQUIRED. THE FENCING SHALL BE ERECTED BEFORE THE DEMOLITION, GRADING OR CONSTRUCTION BEGINS. THE FENCE SHALL INCLUDE THE ENTIRE WIDTH OF TERRACE AND, EXTEND AT LEAST 5 FEET ON BOTH SIDES OF THE OUTSIDE EDGE OF THE TREE TRUNK. DO NOT REMOVE THE FENCING TO ALLOW FOR DELIVERIES

OR EQUIPMENT ACCESS THROUGH THE TREE PROTECTION ZONE. 03 STREET TREE PRUNING SHALL BE COORDINATED WITH MADISON FORESTRY AT A MINIMUM OF TWO WEEKS PRIOR TO THE START OF CONSTRUCTION FOR THIS PROJECT. ALL PRUNING SHALL FOLLOW THE AMERICAN NATIONAL STANDARDS INSTITUTE (ANSI) A300 - PART 1 STANDARDS FOR

04 CLEAR AND GRUB EXISTING ELM AND BIRCH TREE AT LEAST ONE WEEK PRIOR TO STREET TREE PLANTING, CONTRACTOR SHALL CONTACT CITY FORESTER AT 608-266-416 TO SCHEDULE INSPECTION AND APPROVAL OF NURSERY TREE STOCK AND REVIEW

PLANTING SPECIFICATIONS WITH THE LANDSCAPER. O6 SOD ANY ROW DISTURBED DURING CONSTRUCTION.

## LANDSCADE DI ANTI EGEND. GDOUND I EVEL

LANDSCAPE PLANT LEGEND - GROUND LEVEL									
SYMBOL	BOTANICAL NAME	COMMON NAME	INSTALLED SIZE	ROOT	MATURE SIZE	QTY			
TREES:									
GB	Ginkgo biloba 'Princeton Sentry'	Princeton Sentry Ginkgo	2" Cal.	B.B.	60' H x 25' W	1			
GD	Gynnocladus dioica 'Espresso'	Espresso Kentucky Coffeetree	2" Cal.	B.B.	50' H x 35' W	1			
SHRUBS:									
AM	Aronia melanocarpa 'UCONNAM165' PPAF	Low Scape Mound Black Chokeberry	3 Gallon	3 Gallon	1-2' H X 2-3' W	66			
BG	Buxus 'Glencoe'	Chicagoland Green Boxwood	1 Gallon	1 Gallon	3-4' H x 5' W	10			
LS	Philadelphus illuminati 'Tower'	Tower Mockorange	1 Gallon	1 Gallon	3-4' H x 2' W	8			
MF	Microbiota 'Fuzzball'	Fuzzball Siberian Carpet Cypress	1 Gallon	1 Gallon	1-2' H x 3' W	13			
GRASSES									
CR	Carex radiata	Eastern Star Wood Sedge	Plug		10" H x 12" W	229			
HK	Hakonechloa macra 'Aureola'	Hakone Grass	Plug		18" H x 24" W	12			
HA	Hakonechloa macra 'All Gold'	Golden Hakone Grass	Plug		18" H x 24" W	24			
SH	Sporobolus heterolepsis 'Tara'	Tara Dropseed	Plug		2' H x 15" W	76			
SS	Schizachyrium scoparium 'Standing Ovation'	Standing Ovation Little Bluestem	Plug		3' H x 18" W	10			
PERENNIA									
AC	Allium cernuum	Nodding Pink Onion	Plug		18-24" H x 12" W	51			
CL	Coreopsis verticillata 'Zagreb'	Zagreb Coreopsis	Plug		15" H x 15" W	40			
DP	Dalea purpurea	Purple Prairie Clover	Plug		12" H x 12" W	123			
GM	Geranium maculatum	Wild Geranium	Plug		1-2' H x 1.5-2' W	15			
HM	Heuchera micrantha 'Purple Palace'	Purple Palace Coral Bells	Plug		18" H x 12" W	59			
NF	Nepeta faasenii 'Walker's Low'	Walker's Low Catmint	Plug		10" H x 18" W	16			
PS	Phlox subulata 'Emerald Blue'	Emerald Blue Creeping Phlox	Plug		3-6" H x 1-2' W	18			
SR	Sedum 'Rosy Glow'	Rosy Glow Sedum	Plug		8" H x 12" W	104			
VINES:									
AR	Aristolochia macrophylla	Dutchman's Pipe Vine	4.5" Pot		30' H	10			

13 50% CD SET 11/08/2022 14 | 100% CD SET 12/08/2022 16 ADDENDUM 01 7 PLAN REVIEW/ FOR CONSTRUCTION 03/15/202 CONTRACTOR TO COORDINATE WITH OWNER'S URBAN WOOD REUSE CONTRACTOR FOR REUSE AS URBAN WOOD

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ISSUANCES / REVISIONS

NO: DESCRIPTION: 8 DD BID PACKAGE #1

1 BID PACKAGE #2

ARCHITECTS/ENGINEERS

Janesville | Madison

THE NEUTRAL

PROJECT

BAKERS PLACE

DEVELOPMENT

849 E. WASHINGTON AVE.

10 S. PATERSON MADISON, WI 53703

BAKERS

PLACE

MICHAEL GREEN ARCHITECTURE

**EQUILIBRIUM** 

Equilibrium Consulting Inc

Structural Engineers

NEUTRAL

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KAU 1ST LEVEL LANDSCAPE PLAN

DRAWN BY




Janesville | Madison

THE NEUTRAL PROJECT

BAKERS PLACE DEVELOPMENT

849 E. WASHINGTON AVE. & 10 S. PATERSON MADISON, WI 53703

BAKERS PLACE

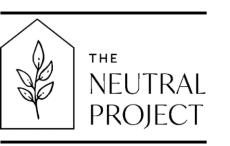

MICHAEL GREEN ARCHITECTURE

EQUILIBRIUM

Equilibrium Consulting Inc Structural Engineers

12:23:27 PM 3/14/2023

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PROJECT NUMBER
71420

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JAD

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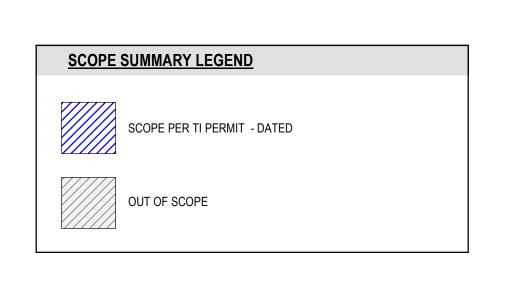
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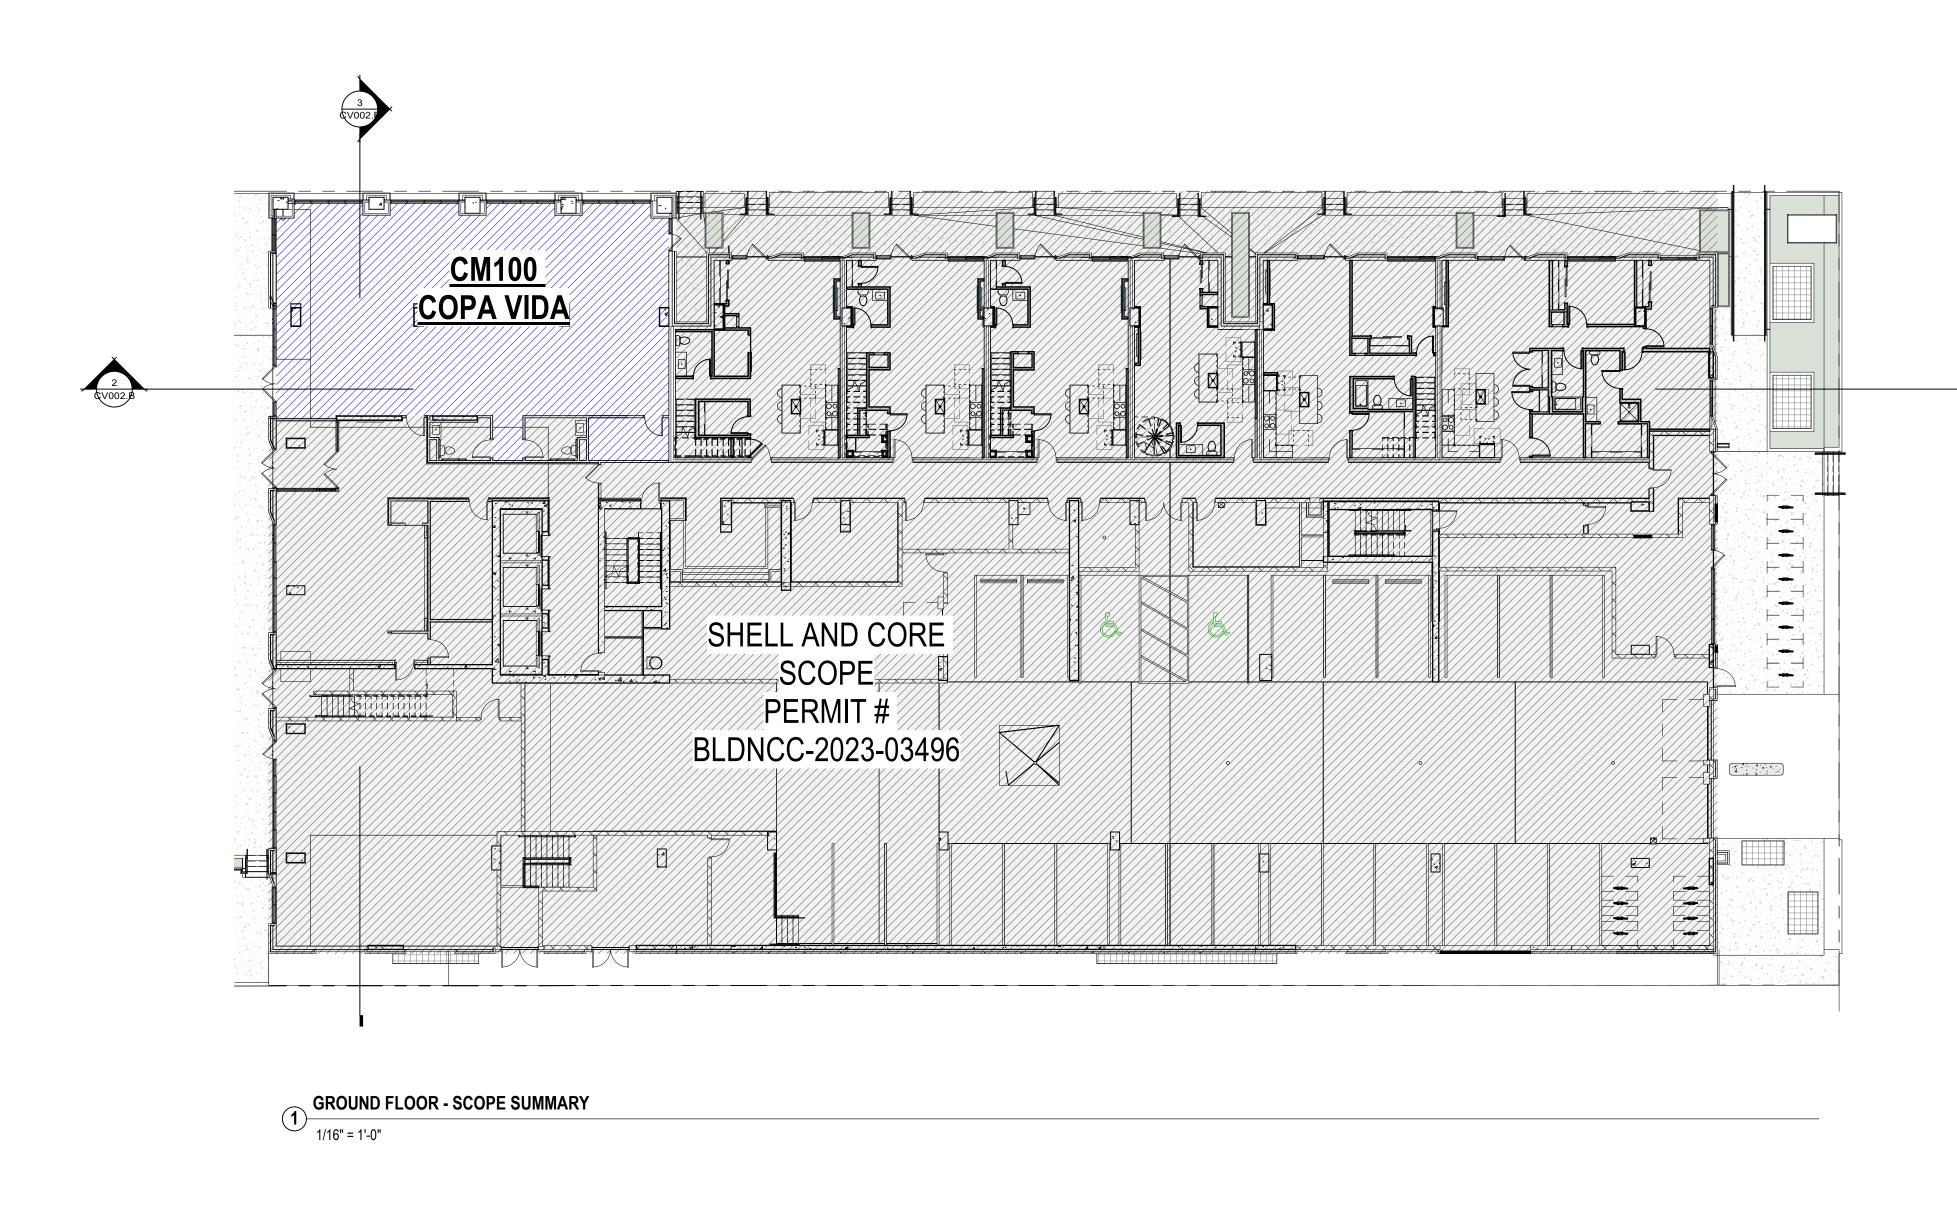
FIRE ACCESS PLAN

Revised 12/5/2014

This worksheet is based on MGO 34.503 and IFC 2012 Edition Chapter 5 and Appendix D; please see the codes for further information.

**E**101







# Neutral. Studio

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MECHANICAL TEL: 608.241.9342 mhoffman@capitolmechanical.com INTERIOR LANDSCAPE CONTACT: Deb Schufletowski ADRESS: 16948 W Victor Road, New Berlin, WI 53151 TEL: 626.255.1770 EMAIL: deb.pieper@ambius.com **AMBIUS** 

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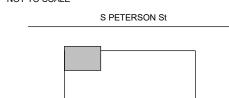
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**KEY PLAN** 


NOT TO SCALE





**PERMIT** 

ISSUANCES / REVISIONS

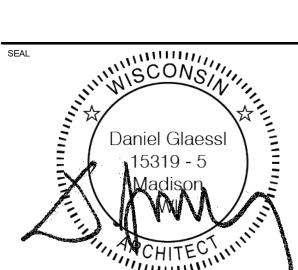

BAKERS PLACE T.I.


CM100 10 S. PATERSON STREET MADISON, WI 53703


SCOPE SUMMARY


CV002.B

REVIEWED BY AF ARCH E1 (30" X 42") As indicated REVISION NUMBER

10/02/2025

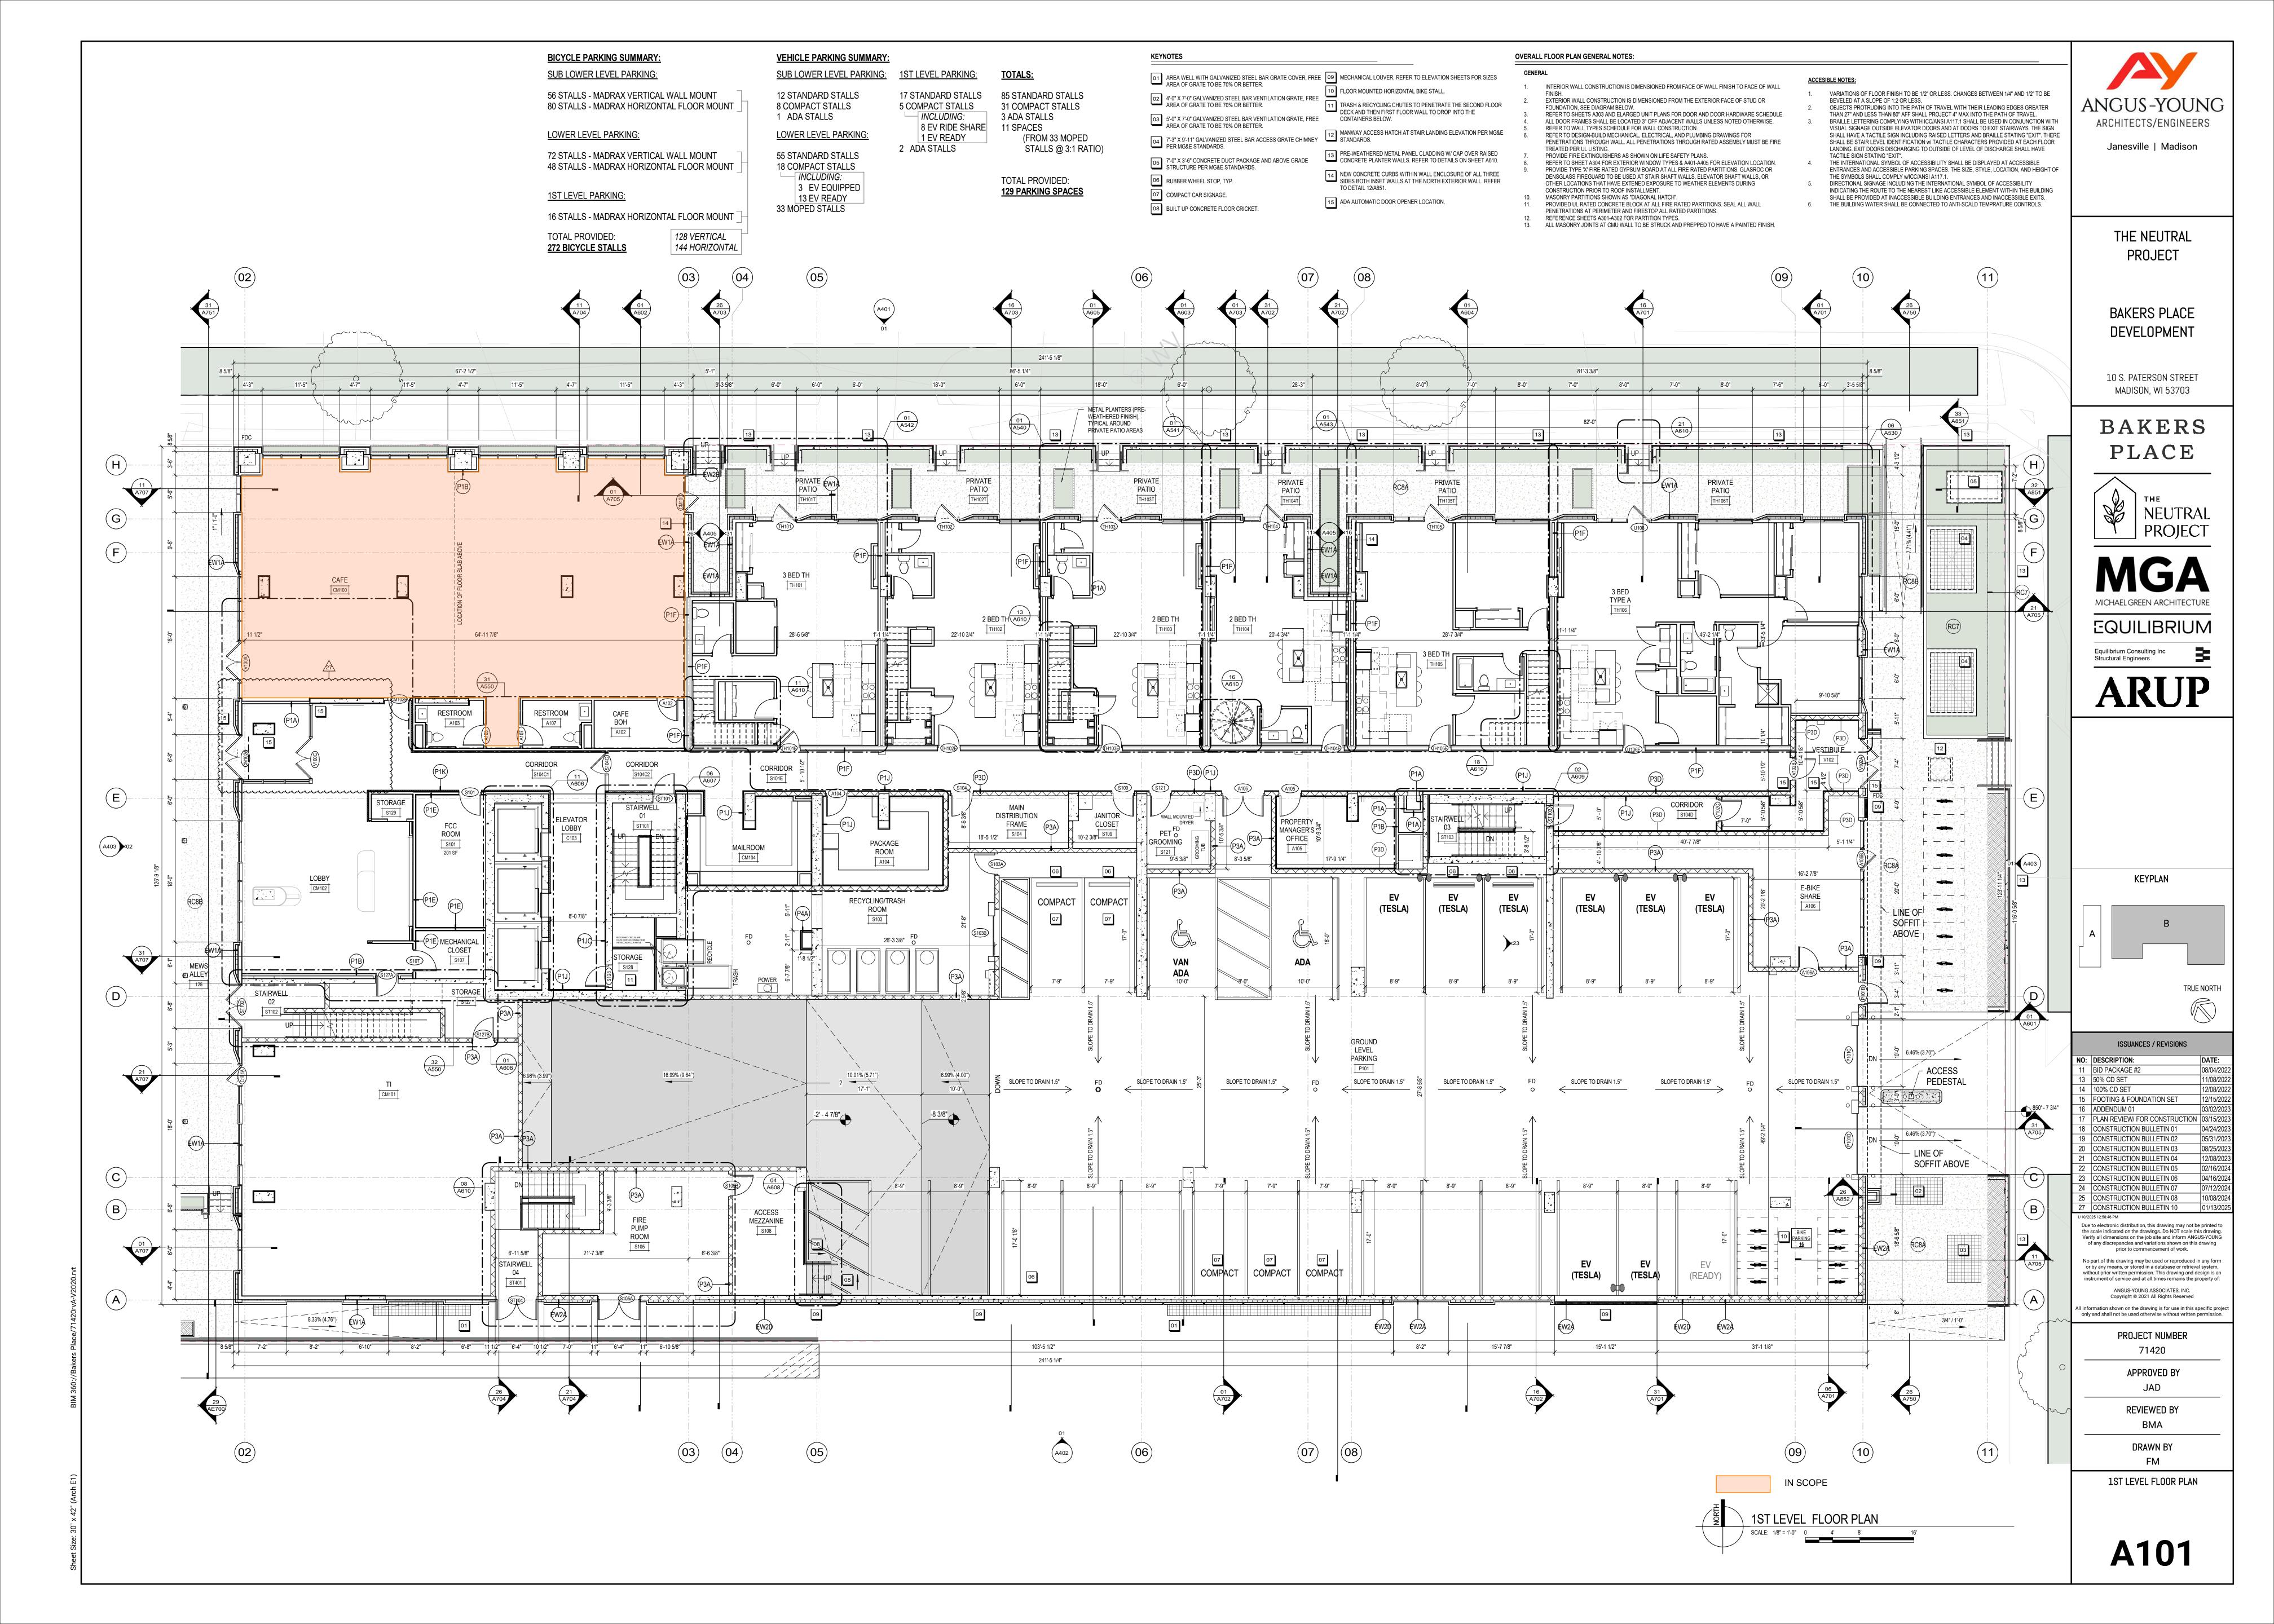


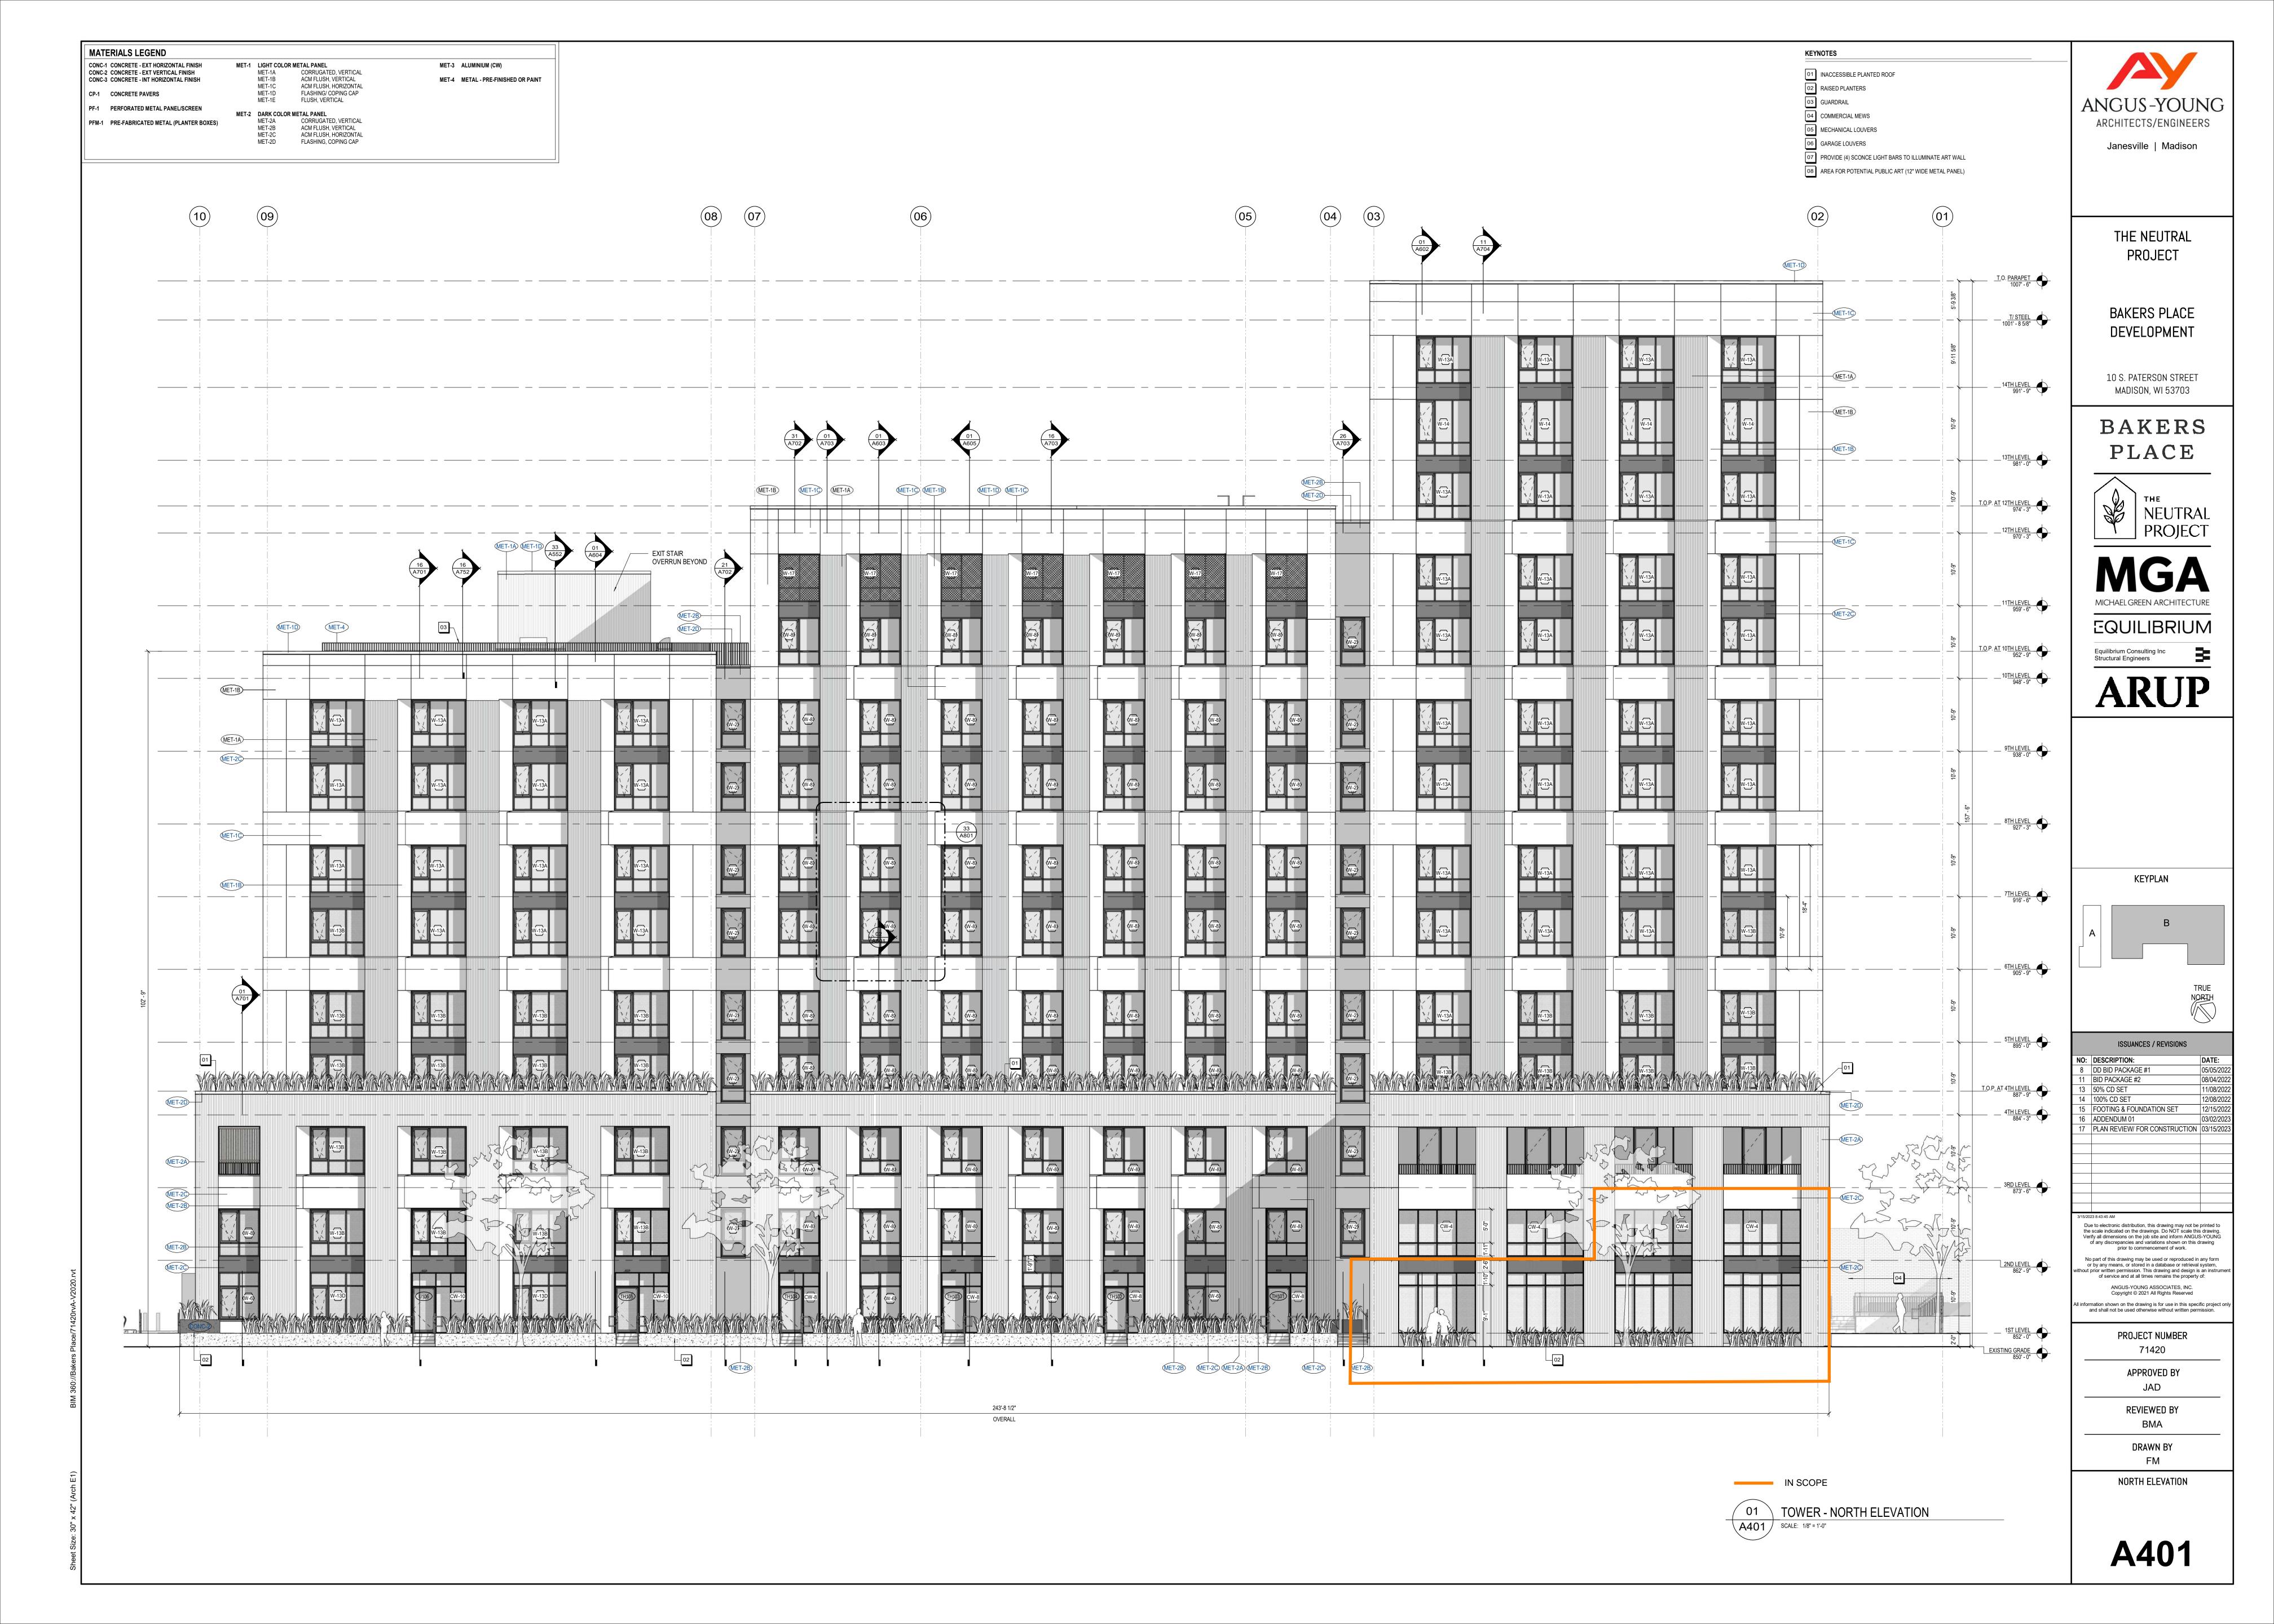


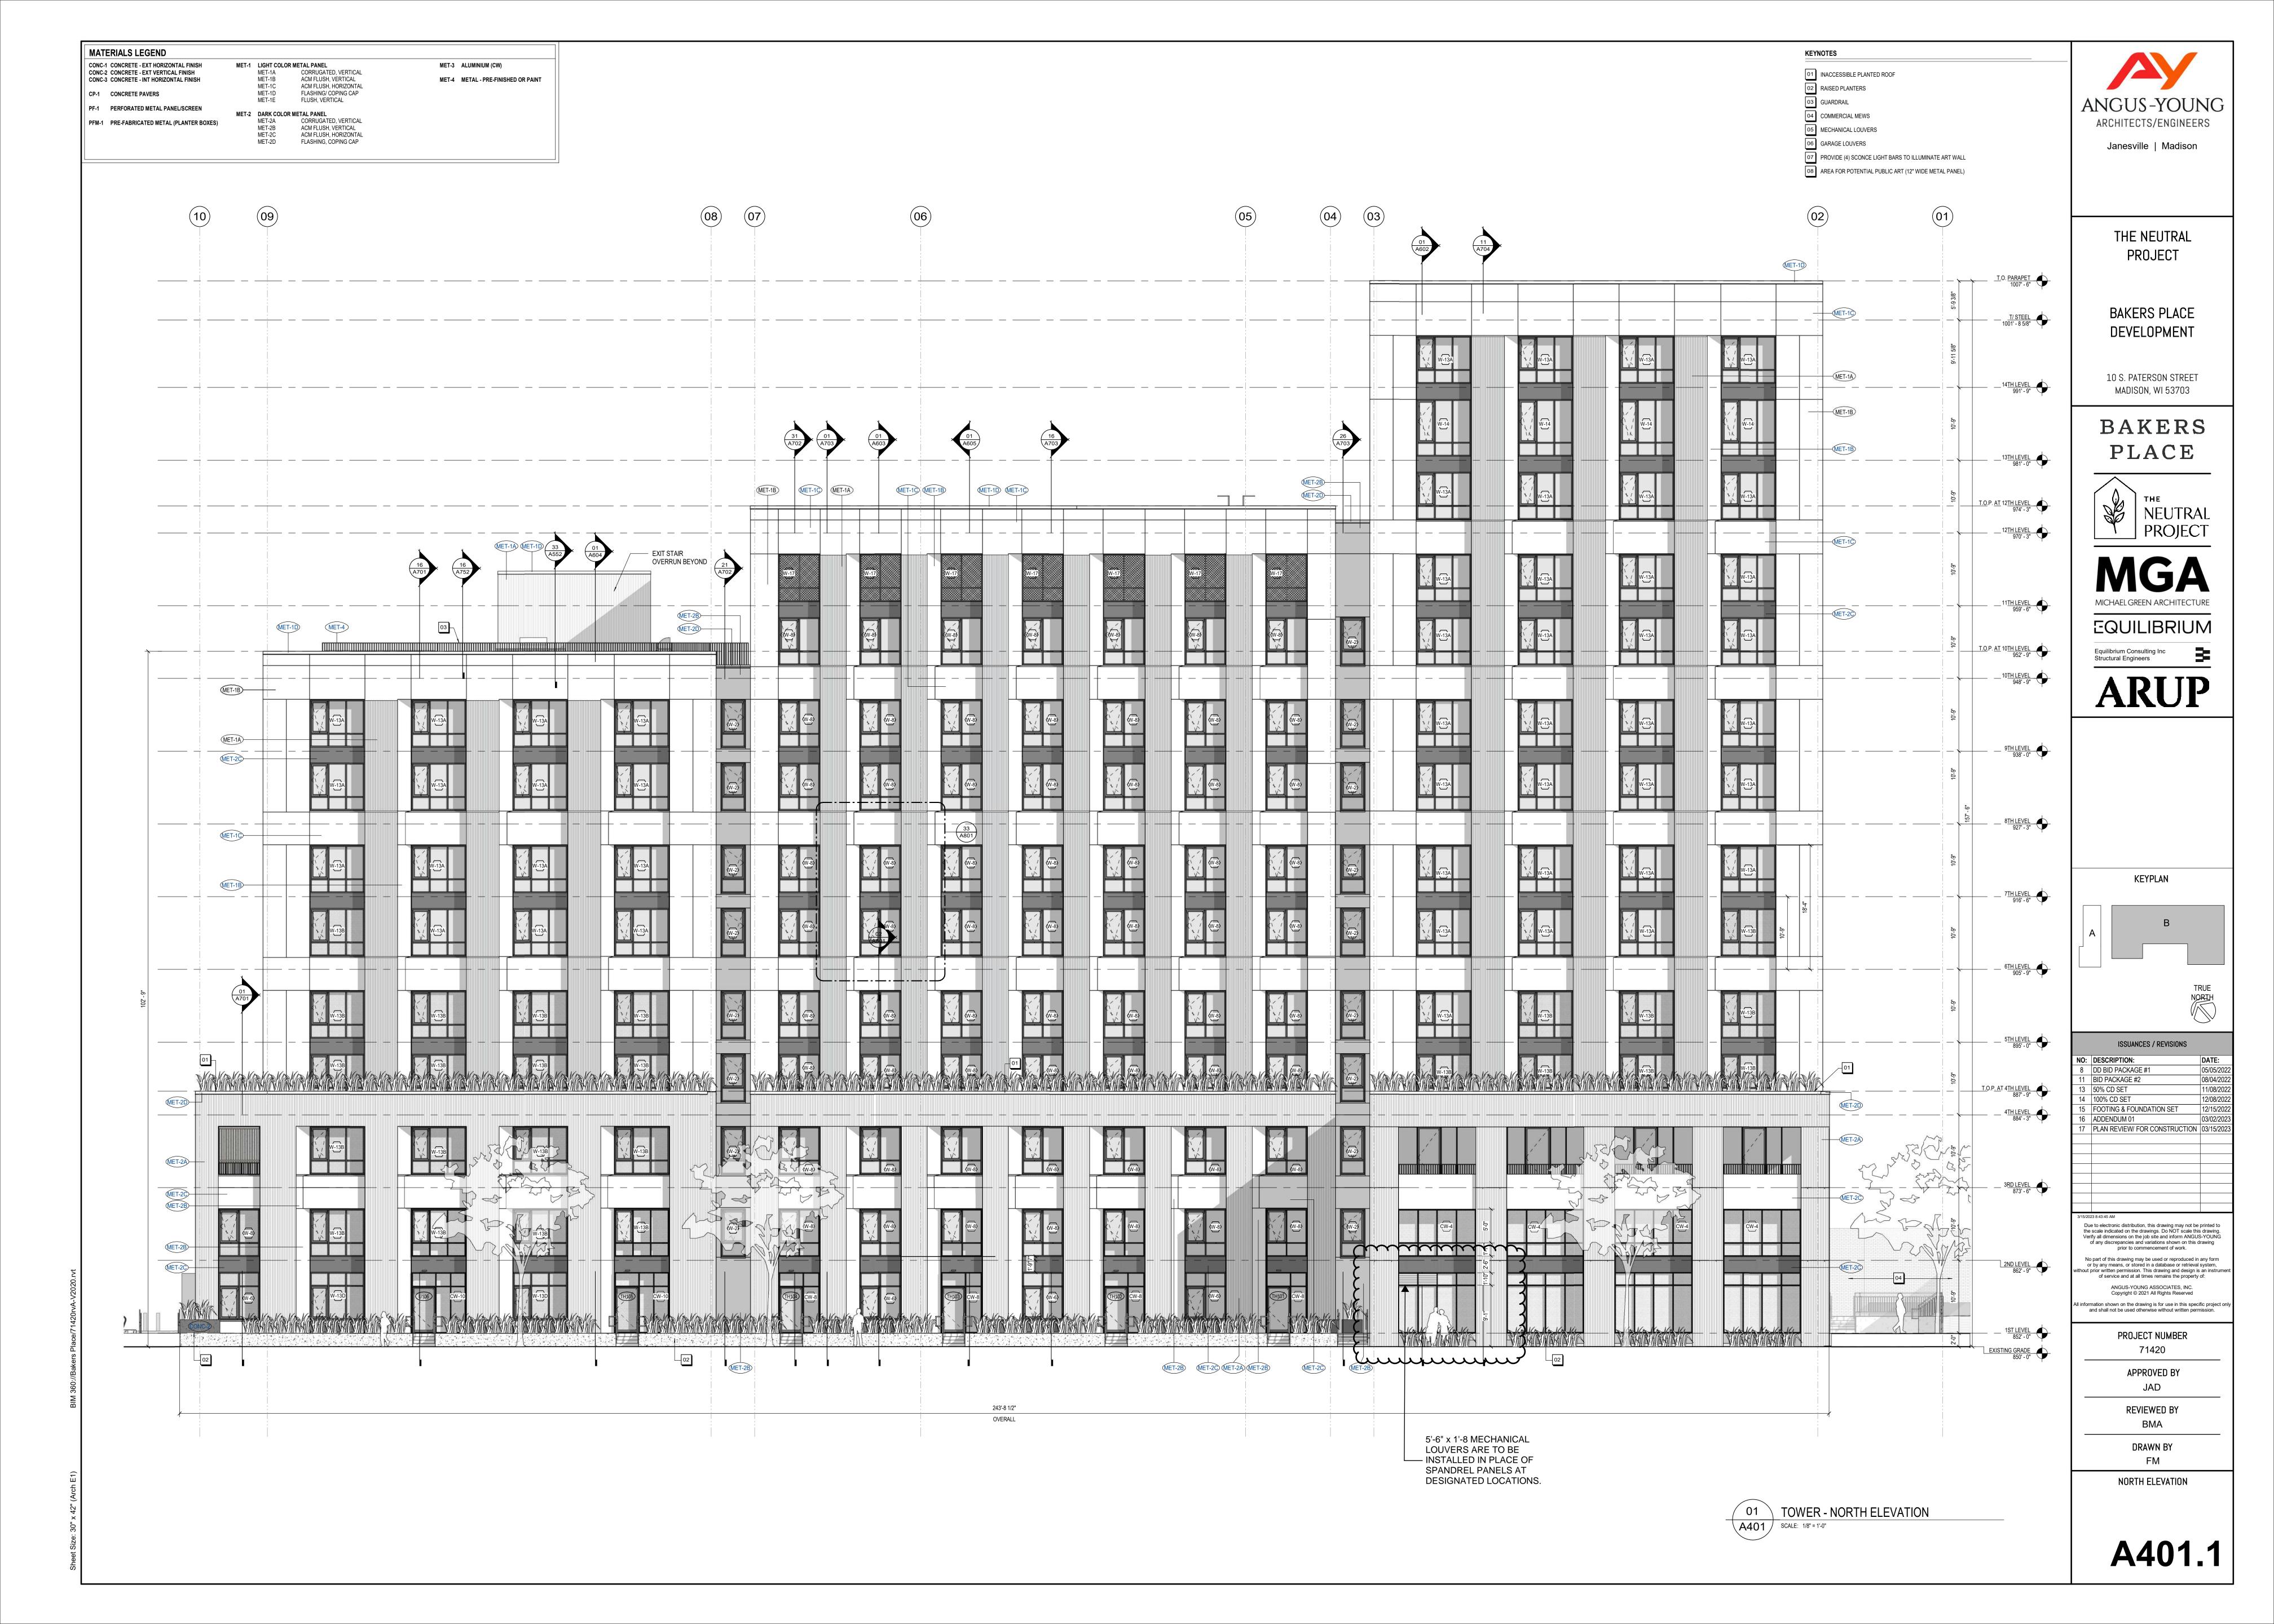





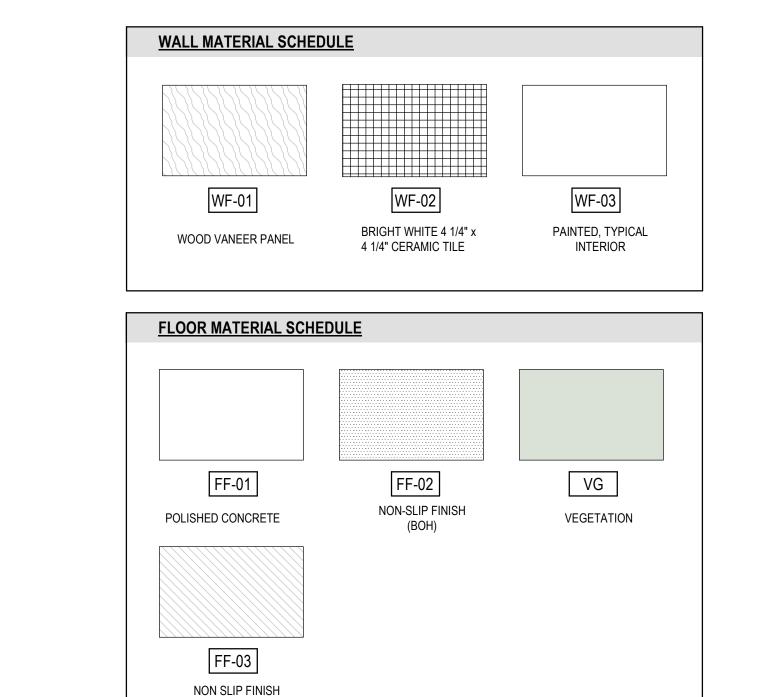

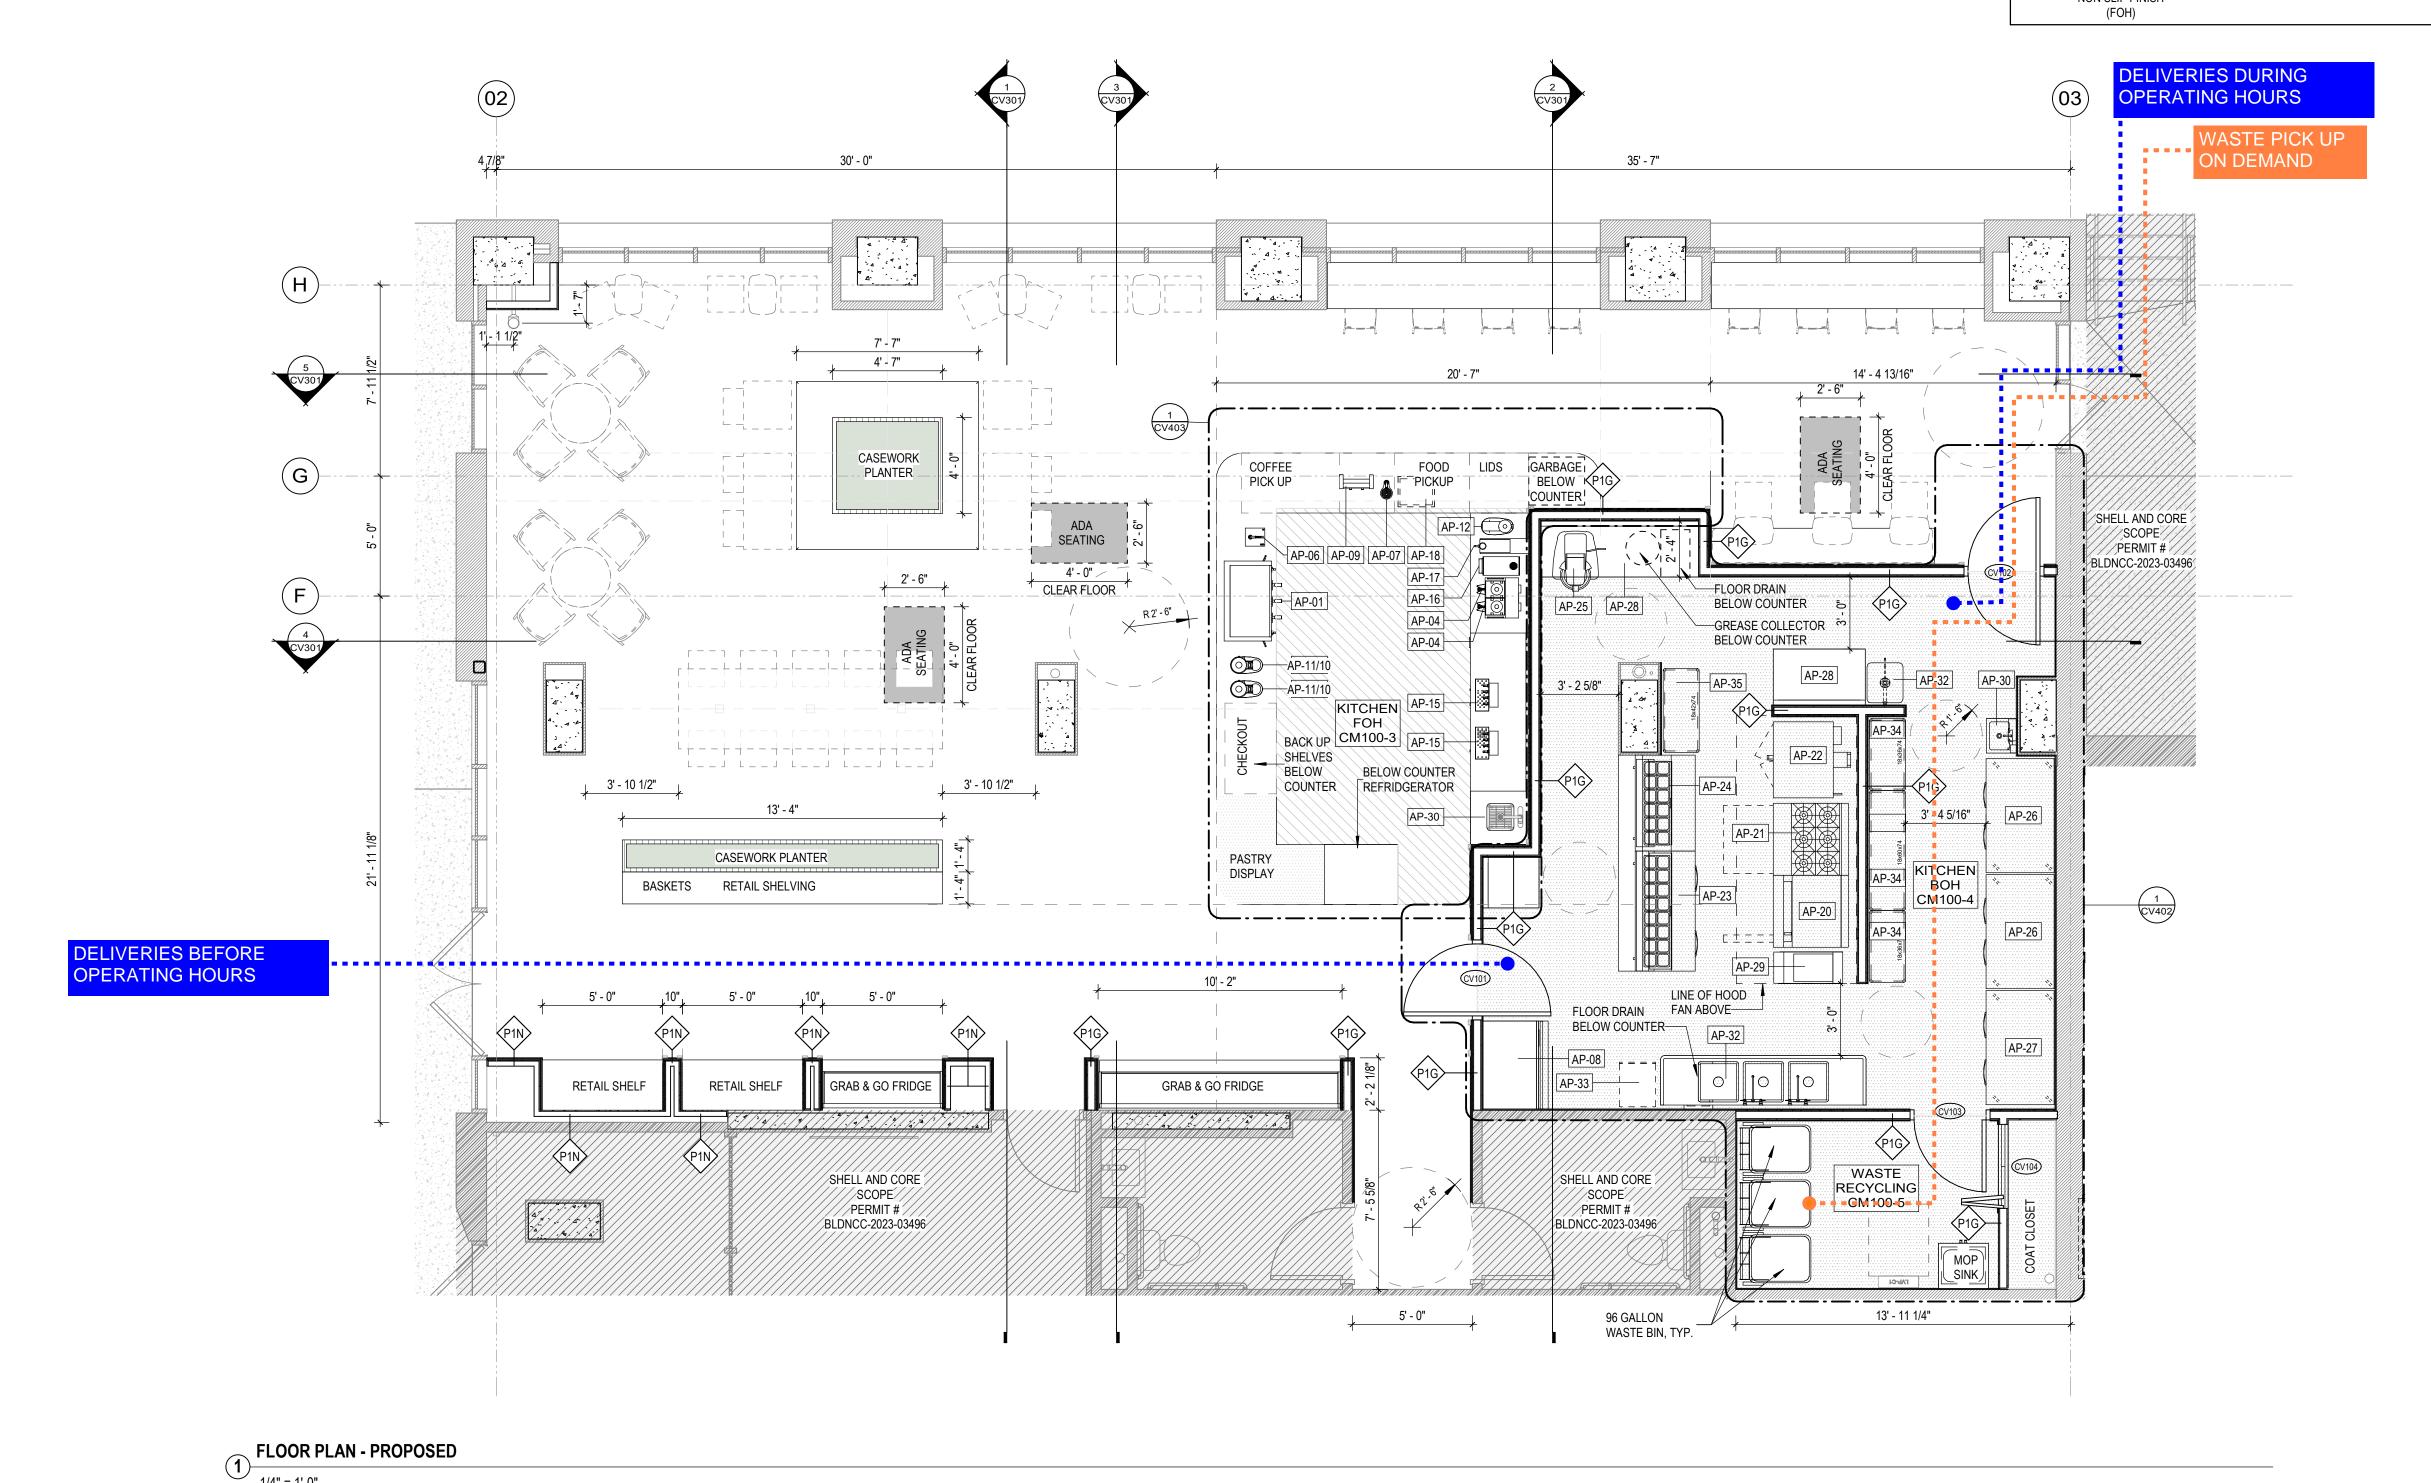

# Neutral. Studio

OWNER, DEVELOPER

THE NEUTRAL PROJECT, LLC

CONTACT: Nate Helbach

FOH EQUIPMENT SCHEDULE

MARCO UC10

3 GRP SLAYER STEAM CURTIS G4 TWIN BREWER

MARCO FRIA PLUS HCS MARCO MIX FONT

HOSHIZAKI ICE MACHINE

POURSTEADY PS-2

**KEGERATOR - 8 TAPS** 

BROOD 2 TAP SYSTEM

60 PULG REFRIGERATOR

TIER PASTRY DISPLAY CASE

REFRIGARATED GRAB AND GO

CURTIS HOT WATER TOWER FOR PREP

SINK UNDER MOUNT KITCHEN KOLHER

2ND ICE CADDY FOR KEGERATOR

PUQPRESS Q2

BOH EQUIPMENT SCHEDULE

BURNER GAS FLAT TOP

DOUBLE DECKER GAS OVEN

HOBART STANDMIXER 30 QT

2 DOOR REACH IN FRIDGE

REACH IN FREEZER

PREP TABLES

PRODUCE SINK

24" DISHWASHER

AP-30 STORAGE RACKS

MATERIAL SCHEDULE

WF-01 WOOD PANEL, CLASS B

WF-03 PAINT, TYPICAL INTERIOR

FF-01 POLISHED CONCRETE

FF-02 NON-SLIP FINISH (BOH)

FF-03 NON-SLIP FINISH (FOH)

SLAT CEILING

CONCRETE CEILING SLAB

LAMINATE CABINET FRONT

3 COMPARTIMENT SINK

DEEP FRYER HAND SINK

6-BURNER IMPERIAL STOVE RANGE

4 DRAWER DELI PREP FRIDGE LOW BOY

WF-02 BRIGHT WHITE 4" x 4" CERAMIC TILE WITH GROUT TO MATCH

GB-01 SOFFITED CEILING 1X5/8" GWB OVER SOFFIT FRAMING

QUARTZ SLAB, KITCHEN COUNTERTOP & VANITY COUNTERTOP

3-DOOR DELI LOW BOY FRIDGE W\_SANDWICH PREP TABLE

E65S GBW EK43

AP-01 AP-04

AP-05

AP-06 AP-07

AP-08

AP-09 AP-10

AP-11 AP-12 AP-15

AP-16

AP-18

AP-19

AP-20

AP-30

AP-22

AP-25

AP-26 AP-27

AP-28

AP-29 AP-30

AP-31

AP-32

AP-33

WALL FINISHES

FLOOR FINISHES

**CEILING FINISHES** 

SC-01

OTHER ST-01 CB-01

AP-34

CW-01 COUNTER

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ARCHITECT

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MECHANICAL

INTERIOR LANDSCAPE

AMBIUS

CAPITOL
MECHANICAL

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3. All dimensions are in feet and inches unless noted otherwise.

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KEY PLAN


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# FOR PERMIT

ISSUANCES / REVISIONS

REV. DESCRIPTION DATE B
PERMIT SET 10/02/2025 DG



OJECT

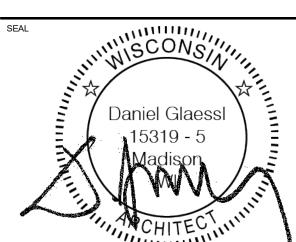BAKERS PLACE T.I.

CM100

10 S. PATERSON STREET

SHEET NAME
PROPOSED FLOOR PLAN

CV102

DRAWN BY
AF
KK
DG

DRAWING SCALE
As indicated

REVIEWED BY
KK
DG

PAGE FORMAT
ARCH E1 (30" X 42")