

### URBAN DESIGN COMMISSION APPLICATION CITY OF MADISON

This form may also be completed online at: <a href="http://www.cityofmadison.com/planning/documents/UDCapplication.pdf">http://www.cityofmadison.com/planning/documents/UDCapplication.pdf</a>

215 Martin Luther King Jr. Blvd; Room LL-100 PO Box 2985; Madison, Wisconsin 53701-2985 Phone: 608.266.4635 [Facsimile: 608.267.8739

Please complete all sections of the application, including the desired meeting date and the type of action requested.

Date Submitted:	☐ Informational Presentation				
UDC Meeting Date:	☐ Initial Approval				
Combined Schedule Plan Commission Date (if applicable):	☐ Final Approval				
1. Project Address: 4906 FEMRITE Project Title (if any): FEMRITE OFFICE					
2. This is an application for (Check all that apply to this UDC application	on):				
☐ New Development ☒ Alteration to an Existing or P					
A. Project Type: Project in an Urban Design District* (public hearing-\$300 fee) Project in the Downtown Core District (DC) or Urban Mixed-Use District (UMX) (\$250 fee, Minor Exterior Alterations) Suburban Employment Center (SEC) or Campus Institutional District (CI) or Employment Campus District (EC) Planned Development (PD) General Development Plan (GDP) Specific Implementation Plan (SIP)					
Planned Multi-Use Site or Planned Residential Comple	ex .				
B. Signage:  Comprehensive Design Review* (public hearing-\$300 fee) Signage Exception(s) in an Urban Design District (public	Street Graphics Variance* (public hearing-\$300 fee)				
C. Other:					
Please specify:	7				
3. Applicant, Agent & Property Owner Information:  Applicant Name: Seff Gill's  Street Address: 133 S. Bayler St.  Telephone: 608 273-1069 Fax: 608 273-9522	Company: Middleton Terrace 21C  City/State: Madison W/ Zip: 53703  Email: Igillis @ Fencorp. com				
Project Contact Person: 8:11 5:11 5:11 5:11 5:11 5:11 5:11 5:1	Company: Fem Composition City/State: Medison, W/ Zip: 53703 Email: Bsimpson@Fencomp.com				
Project Owner (if not applicant): Orland P. Koppes Street Address: 4825 E. Clayfon Rd.	City/State: Fitzhburge W1 Zip: 53711				
Telephone:	Email:				
4. Applicant Declarations:  A. Prior to submitting this application, the applicant is required to discuss the application was discussed with  (name of staff person)  B. The applicant attests that all required materials are included in this submit	tal and understands that if any required information is not provided by				
the application deadline, the application will not be placed on an Urban Desig	n Commission agenda for consideration.				
Name of Applicant Seff Gillis Authorized Signature Change P. Normal O.	Relationship to Property Purchasing property  Date 3/17/15				
	Date				

Ph. 608-273-1069 Fax: 608-273-9522

**Letter of Intent:** 4906 Femrite Drive

Proposed office building and storage units

Owner: Middleton Terrace, LLC

Jeff Gillis, Member

The site is 1.7 Acres with a 1,260 square foot house which has a full basement. Attached to the house is a 3,360 square foot warehouse. The attached house is currently being used by a contractor as an office and the warehouse for storing equipment, inventory and vehicles.

The proposed project is to raise the existing house, build a new 2,640 square foot office building for a Design/Build firm. The existing basement will be saved and used as office storage. The Design/Builder will use the first two storage bays, renting the third storage unit, plus adding two new storage units to the north end of the existing storage units, totaling 2,016 square feet. The office building and storage units will have a total of 9 parking spaces with bike parking for two. Also, at the north end of the proposed storage expansion we will be adding a fenced in area for any equipment parked outside.

The total impervious area is 17,300 square feet. As part of the 1.7 acre lot there is approximately 35,000 square feet of vacant area which has the potential to be developed in the future.

The assessed land value is \$259,000 and the estimated budget is \$350,000 for the building project. This construction project will create approximately 20 full time equivalent jobs. I am not requesting any public subsidy for the project.

I am estimating to commence with demolition and construction in June, completing the project in late September.


Jeff Gillis Member

### Plant Material List

Conifer Everg	reen		
Quantity	Code Name	Common Name	Scientific Name
4	WGA	Woodward Globe Arborvitae	Thuja Occidentalis 'woodwardii'
2	BSTJ	Blue Star Juniper	Juniperus Squamata 'blue Star'
4	MJF	Golden Mop Thdh Japanese False	Chamaecyparis Pisi 'golden Mop'
Perennial			
Quantity	Code Name	Common Name	Scientific Name
2	GBD	Going Bananas Daylily	Hemerocallis 'going Bananas'
3	PRD	Prairie Dropseed	Sporobolus Heterolepis
3	MG	Maiden Grass	Miscanthus Sinensis 'gracillimus'
2	KFG	Karl Foerster's Feather Reed Grass	Calamagrostis Acutiflora 'karl Foerster
3	SBA	Summer Beauty Allium	Allium 'summer Beauty'
Shrub			
Quantity	Code Name	Common Name	Scientific Name
2	PL	Palibin Lilac	Syringa Meyeri 'palibin'
7	MCS	Magic Carpet Spirea	Spiraea Japonica 'walbuma'

### **GENERAL NOTES**

- A) Areas labeled "Red B Colored Wood Mulch" to receive a mixture of recycled wood mulch, colored brown, spread to a 3" depth over pre-emergent herbicide.
- B) Individual trees (and shrub groupings) found along perimeter of property as well as those found within lawn areas to receive wood mulch rings (and wood mulch beds) consisting of a mixture of recycled wood mulch, colored brown, spread to a minimum 3" depth (3' wide beds for shrub groupings).
- C) "Vinyl Edging" to be Valley View Black Diamond Vinyl Edging or equivalent.
- D) Areas labeled "washed stone" to receive I-I/2" washed stone spread to a 3" depth over fabric weed barrier.
- E) "Seed" areas shall be finish-graded and seeded at a rate of 4 lbs. per 1,000 sq. ft.
- F) Seed shall consist of the following mixture:
  - 10% Palmer IV Perennial Ryegrass
  - 20% Dragon Kentucky Bluegrass
  - 20% Diva Kentucky Bluegrass
  - 20% Foxy II Creeping Red Fescue
  - 15% Vail II Perennial Ryegrass
  - 15% Ginney Kentucky Bluegrass
- G) Areas labeled "Seed with Straw Erosion Matting" shall be seeded with the above-noted premium lawn seed mixture and overlaid with DS75 straw erosion control netting that is then pegged into the soil with metal staples.
- H) Areas labeled "Sod" shall receive only No. I grade nursery-grown bluegrass sod.
- I) Plant beds adjacent to building foundation to be mulched with I-I/2" diameter washed stone mulch spread to a 3" depth over fabric weed barrier.
- J) Existing street trees shall be protected. Contractor shall install tree protection fencing in the area between the curb and sidewalk and extend it at least 5 feet from both sides of the tree along the length of the terrace. No excavation is permitted within 5 feet of the outside edge of the tree trunk. If Excavation within 5 feet of any tree is necessary, contractor shall contact City Forestry (608)266-4816 prior to excavation to assess the impact to the tree and root system. Tree pruning shall be coordinated with City Forestry. Tree protection specifications can be found in section 107.13 of City of Madison Standard specifications for Public Works Construction-
- http://www.cityofmadison.com/business/pw/documents/StdSpecs/2013/Part1.pdf.
- K) Contractor shall contact City Forestry (608)266-4816 at least one week prior to installing street trees to schedule inspecting the nursery stock and reviewing landscaping specifications with the landscaper.

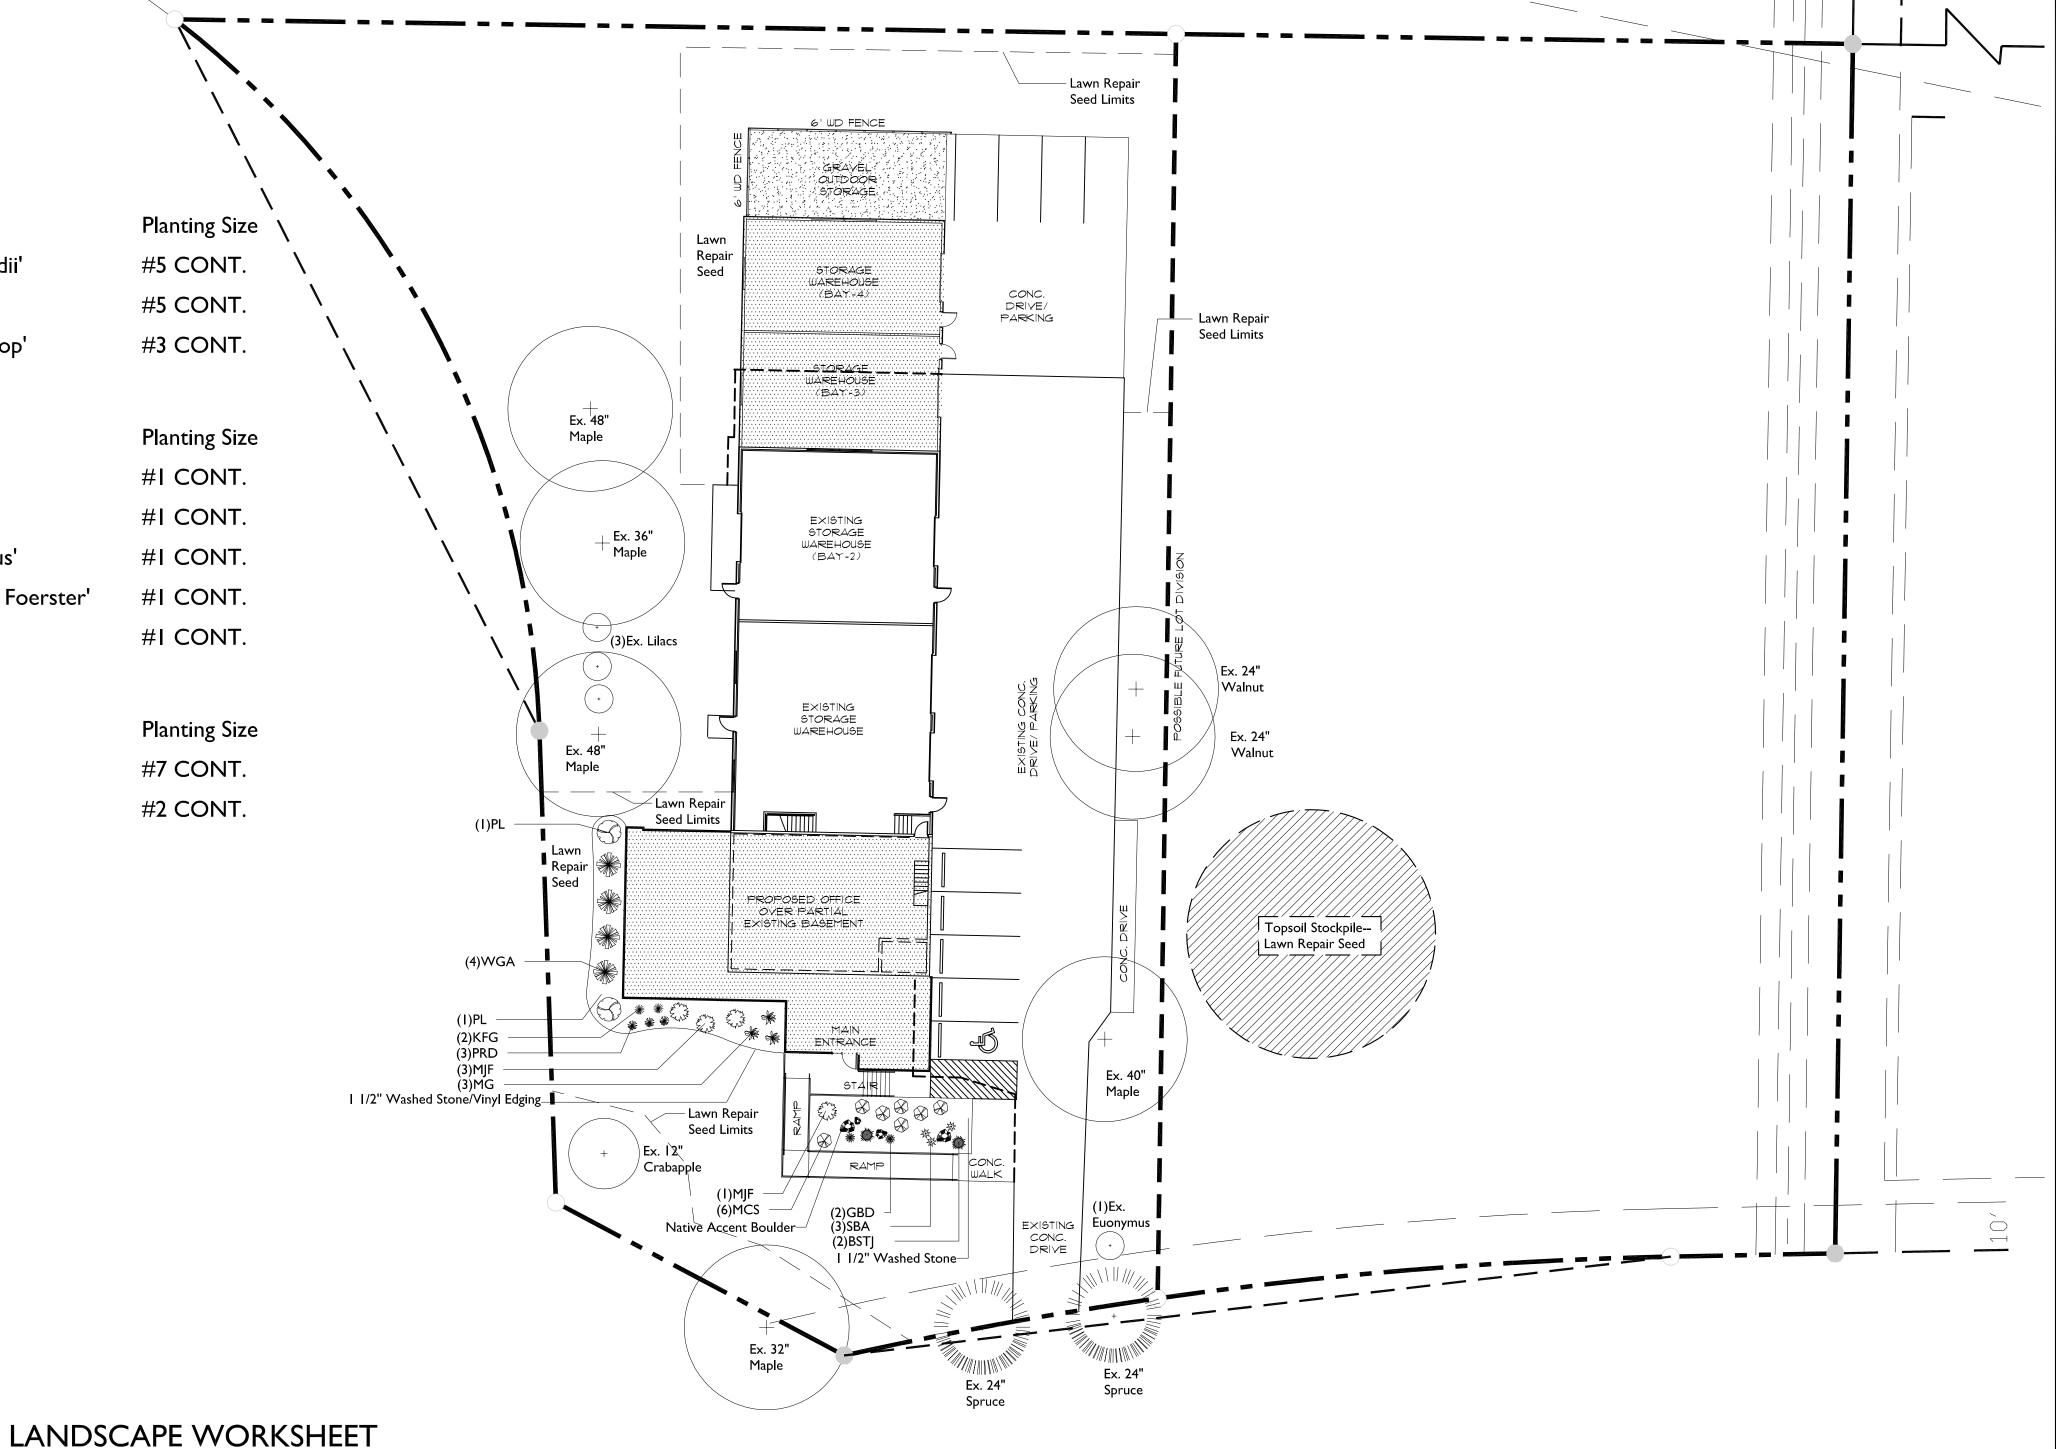


Zoning district is IL	
Total square footage of developed area	9,685
Total square footage of first 5 acres of developed area ÷ 300 square feet =	=32 Landscape Units
Total square footage of 0 additional acres of developed area ÷ 100 square	feet =0 Landscape Units

NUMBER OF LANDSCAPE POINT REQUIRED

32 Landscape Linits v. 5 landscape points for first

32 Landscape Units x 5 landscape points for first 5	acres160 points
_0 Landscpe Units x I landscape point for addition	nal 0 acres points
TOTAL LANDSCAPE POINTS REQURED	I60 points

	Point	Point NEW		EXISTING		
PLANT TYPE or ELEMENT	Value	Qty.	Points Achieved	Qty.	Points Achieved	
Overstory Deciduous Tree : 2-1/2" (dbh)	35			6	210	
Tall Evergreen Tree : 5-6 feet tall	35			2	75	
Ornamental Tree : I-1/2" Caliper (dbh)	15			I	15	
Upright Evergreen Shrub : 3-4 feet tall	10					
Shrub, deciduous : 3 gallon / 12"-24"	3	9	27	4	12	
Shrub, evergreen : 3 gallon / 12"-24"		10	40			
Ornamental grass/perennial: I gallon / 8"-18"	2	13	26			
Ornamental / Decorative fencing or wall	4 per 10 l.f.	60 l.f.	24			
Existing significant specimen tree						TOTAL
Landscape furniture for public seating and /or transit connections	5 per 'seat'					POINTS PROVIDED
	Sub	Totals	117	+	312	= 429

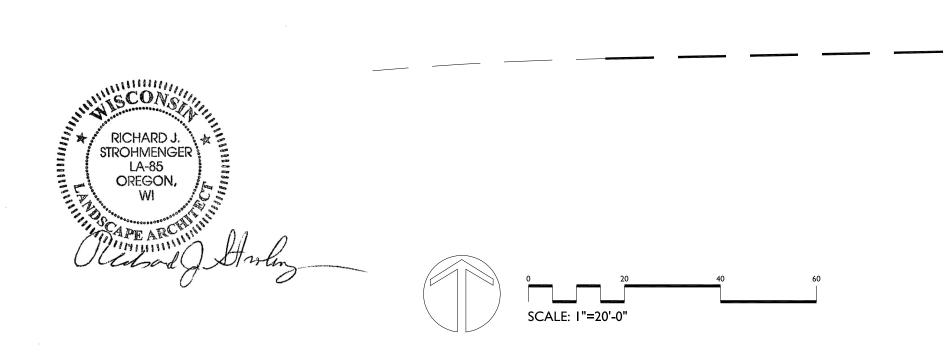

TEMRITE DRIVE

U BUIL FEMRITE DE MADISON, WISC

P.O. BOX 620330 MIDDLETON, WI 53562-0330

TEL (608) 836-7041

Checked By: SS Drawn By: 3/17/15 RS

Revised: Revised: Revised: Revised: Revised: Revised: Revised: Revised: Revised:

Revised:

This plan made exclusively for the party named in the title block. It remains the property of The Bruce
Company of Wisconsin, Inc. and may not be reproduced or implemented in whole or part by any nethod without prior written conse of The Bruce Company of



## SOUTH ELEVATION- PROPOSED

1/4" = 1' - 0" (N.T.S. @ 11"×17")



**EAST ELEVATION- PROPOSED** 

~1/8" = 1' - 0" (N.T.S. @ 11"×17")

FCM

PROPOSED RENOVATION/ ADDITION FOR:
FEMRITE OFFICE/ WAREHOUSE BUILDING

PKG/ REV NO. DATE PRELIM 3/18/15 COLOR

PROJECT NO:

CHECKED BY: SHEET:

A4.2

LIGHT FIXTURES
4906 FEMRITE

Luminai	Luminaire Schedule	lule							
Symbol	Symbol Label	QTY	QTY Catalog Number	Description	Lamp	Number Lamps	Number Lumens Lamps per Lamp	LLF	LLF Wattage
	A	7	E-WP6L03CZ	Cast black painted metal wall mounting bracket, cast black painted finned metal housing, one circuit board with one 120 led array, formed white painted metal reflector with 1.0625 x 1.8125" aperture, clear convex glass lens with rectangular prisms in formed black painted metal trim plate.	Type CXA LED, 5000 K.	H	3051.355		0
	ω	м	10LED4041	MACHINED CYLINDRICAL METAL HOUSING,ONE LED MODULE, TLM- 1 LED MODULE, CLEAR FLAT GLASS LENS R168-A3540418-A000, LED IN MACHINED CYLINDRICAL BROWN MODULE AIMED AT THE PAINTED METAL LENS FRAME WITH HORIZON.  BETWEEN LENS AND LED MODULE.	ONE LED MODULE, TLM- R16B-A354041B-A000, LED MODULE AIMED AT THE HORIZON.	н	1.	н	8.04

**Applications:** Security, pathway and perimeter lighting; ideal for entryways and other applications where control of spill light is important. **Typical Mounting Height:** 8 to 15 feet **Typical Spacing:** 1 to 2 times the mounting height







9.5"D x 8.75"W x 4.5"H Weight: 7.0 lbs.



	Catalog#	Description	Input Voltage	Initial Delivered Lumens	CCT	CRI	50K Hours Projected Lumen Maintenance Factor at 25°C¹	Comparable To:
-	E-WP6L03CZ	36W LED Cool white	120V-277V	3350	5000K	70	50,000 Hours	100W PSMH
	E-WP6LO3NZ	36W LED Neutral white	120V-277V	3350	4000K	70	50,000 Hours	100W PSMH

<sup>&</sup>lt;sup>1</sup> Calculated L<sub>70</sub> based on 6,048 hours of LM-80 testing: >36,000 hours

#### **Performance**

- Estimated 50,000 hours of maintenance-free operation to  $L_{70}\,$
- · Minimum starting temperature: -40°F
- 5-year limited warranty

#### **Construction & Materials**

- · Low copper, die-cast aluminum housing and lens frame
- Dark bronze polyester powder-coat finish
- · Fixed cutoff glare shield to reduce light pollution
- Tempered glass lens, thermal shock and impact resistant
- Patented lens design delivers true IES Type III distribution
- Mounts over recessed junction box or with conduit
- · Die-cast detachable back box for easy mounting
- · Heat dissipating fins
- · Conduit entries on all sides of the fixture
- · Two knockouts provided on back for conduit or J-box mounting
- Cree® LEDs inside

#### Electrical

- · Non-dimmable
- 75°C minimum supply wire required
- Universal voltage (120V through 277V)

#### Regulatory

- UL Listed for wet locations
- · RoHS compliant

#### Accessories



CAT.# E-ACP1 (120 volts)
CAT.# E-ACP2 (208/240/277 volts)

Photocell is field installed. For use with adjustable slip fitter only.



#### DESCRIPTION

Westwood 904 and 904-2 are small dimmable LED or MR16 low-voltage halogen luminaires. Model 904 provides downlight or uplight by way of its 180° rotational fixture head. Model 904-2 provides combination uplight and downlight. A square shroud option (-SQS) is available in both models, offering rectilinear styling instead of cylindrical. Both models mount directly to any wall surface or over a standard 4-inch J-box and require a remote 12-volt step-down transformer (not included). Various lenses, louvers, and color or dichroic filters can be combined - up to three at once to create multiple lighting effects.

Catalog #	Туре
Project	
Comments	Date
Prepared by	

#### **SPECIFICATION FEATURES**

#### A ... Material

Housing and hood are precision-machined from corrosion-resistant 6061-T6 aluminum billet, brass, bronze or stainless steel. Mounting canopy is constructed from corrosion-resistant silicone aluminum, brass, bronze or stainless steel.

#### B ... Finish Painted

Fixtures constructed from 6061-T6 aluminum are double protected by an ROHS compliant chemical film undercoating and polyester powdercoat paint finish, surpassing the rigorous demands of the outdoor environment. A variety of standard colors are available. Brass, Bronze or Stainless Steel Fixtures constructed from brass, bronze or stainless steel are left unpainted to reveal the natural beauty of the material. Brass and bronze will patina naturally over time.

#### C ... Hood

Hood is removable for easy relamping and accepts up to three internal accessories at once (lenses, louvers, filters) to achieve multiple lighting effects. Weep holes prevent water collection on the uplight position.

w3

#### D ... Gasket

Housing and hood are sealed with a high temperature silicone o-ring gasket to prevent water intrusion.

#### E ... Lens

Tempered glass lens, factory sealed with high temperature adhesive to prevent water intrusion and breakage due to thermal shock.

#### F ... Mounting

Both models mount directly to wall surface or over a standard 4" J-box and require remote 12V step-down transformer (not included). Model 904 provides downlight or uplight. Model 904-2 provides non-adjustable uplight and downlight. Lumière's exclusive Siphon Protection System (S.P.S.) prevents water from siphoning into the fixture through its own lead wires.

#### G ... Hardware

Stainless steel hardware is standard to provide maximum corrosion-resistance.

#### H ... Socket

Ceramic socket with 250° C Teflon® coated lead wires and GU5.3 bi-pin base.

#### I ... Electrical

Remote 12V transformer required (not included). NOTE: initial power draw on LED equipped fixtures is 15 watts. When sizing transformer use 15 watts per LED fixture. Nominal power draw after start up is 10 or 6 watts accordingly. Also, LEDs are more voltage sensative than standard halogen MR16 lamps. The LED module is designed to operate between 10 and 13 volts. Any less or more voltage can cause premature failures.

#### J ... Lamp

Halogen lamp not included.
Available from Lumiere as an accessory - see reverse side for details and catalog logic. LED modules are included and are available in four color temperatures (2700,3000,4000, and 5700) and three distributions (spot, narrow, and flood). Both color temperature and distribution must be specified when ordering - see reverse side for details and catalog logic.

#### K ... Labels & Approvals

UL and cUL listed, standard wet label. IP65 rated. Manufactured to ISO 9001-2000 Quality Systems Standard. IBEW union made.

#### L ... Warranty

Lumière warrants its fixtures against defects in materials & workmanship for three (3) years. Auxiliary equipment such as transformers, ballasts and lamps carry the original manufacturer's warranty.





WESTWOOD

904


904-2


10W LED 6W LED

50W (max.) MR16 Low Voltage

Wall

IP65

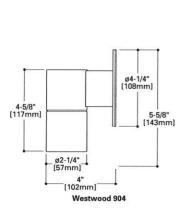

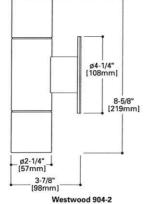



Westwood 904/904-2 Cone of Light Lamp=50MR16/NSP CBCP=11,000

Distance to Initial Nadio Ream Illuminated Plane Diameter Footcandles 15'0' 45 4'0" 10'0" 102 3'0" 8'0" 159 2'0" 6'0" 283 1'6" 4'0" 638 1'0" 2'0" 2550 0'6" Lamp Wattage Multiplier

Westwood 904/904-2 Lamp=50MR16/NFL (EXZ) CBCP=3200

Distance to Illuminated Plane	Initial Nadir Footcandles	Beam Diameter
15'0"	13	10'0"
10'0"	29	6'6"
8'0"	45	5'0"
6'0"	81	4'0"
4'0"	181	2'6"
2'0"	725 /	1'0"

Westwood 904/904-2 Cone of Light Lamp=50MR16/FL (EXN)

CBCP=2000

20W x 0.32

Initial Nadir Beam Distance to Illuminated Plane Diameter 15'0" 12'0" 10'0' 17 8'0" 8'0' 27 6'6" 6'0' 48 5'0" 4'0" 106 3'0" 2'0" 431 1'6" Lamp Wattage Multiplier 35W x 0.57 20W x 0.30

Voltage

12=12V

Finish

Painted

BK=Black

BZ=Bronze

VE=Verde

WT=White

NBR=Brass

NCP=Copper

NSS=Stainless Steel

Metal

cs=City Silver

Accessories

Optical Lenses

Optical Louver

FH203=Angled Glare Shield, MR16

F71=Peach Dichroic Filter, 2.00" Dia

F73=Green Dichroic Filter, 2.00" Dia

F75=Yellow Dichroic Filter, 2.00" Dia

F22=Red Color Filter, 2.00" Dia

F44=Green Color Filter, 2.00" Dia

F77=Dark Blue Dichroic Filter, 2.00" Dia

F66=Mercury Vapor Color Filter, 2.00" Dia

LSL=Linear Spread Lens (elongate standard beam spread), 2.00" Dia

LVR=Hex Cell Louver (reduce glare), 2.00" Dia

EZX=20W MR16 GU5.3 Bi-Pin Very Narrow Spot

BAB=20W MR16 GU5.3 Bi-Pin Flood

FRA=35W MR16 GU5.3 Bi-Pin Spot

EXN=50W MR16 GU5.3 Bi-Pin Flood

EXT=50W MR16 GU5.3 Bi-Pin Narrow Spot

DIF=Diffused Lens (provide even illumination), 2.00" Dia

F79=Neutral Density Dichroic Filter, 2.00" Dia

Glare Shield

Filters

Lamp=50MR16/WFL (FNV) CBCP=1200

Westwood 904/904-2 Cone of Light Initial Nadir Beam Distance to Illuminated Plane Diameter 15'0" 17'0" 10'0" 11 11'6" 8'0" 17 9'0" 6'0" 30 7'0" 4'0" 67 4'6" 2'0" 269 2'0"

F72=Amber Dichroic Filter, 2.00" Dia

F76=Red Dichroic Filter, 2.00" Dia

F33=Blue Color Filter, 2.00" Dia

F55=Yellow Color Filter, 2.00" Dia

F74=Medium Blue Dichroic Filter, 2.00" Dia

F78=Light Blue Dichroic Filter, 2.00" Dia

F80=Magenta Dichroic Filter, 2.00" Dia

ESX=20W MR16 GU5.3 Bi-Pin Narrow Spot

FRB=35W MR16 GU5.3 Bi-Pin Narrow Spot

EXZ=50W MR16 GU5.3 Bi-Pin Narrow Flood

FNV=50W MR16 GU5.3 Bi-Pin Very Wide Flood

FMW=35W MR16 GU5.3 Bi-Pin Flood

OSL=Overall Spread Lens (increase beam spread), 2.00"

#### ORDERING INFORMATION

Series

904=LED or MR16 Westwood Up/Down Wall Fixture Single

904-2=MR16 Westwood Up/Down Wall Fixture - Dual Head, Round

904-UD=LED or MR16 Westwood Up/Down Wall Fixture - Dual Head, Round

904-SQ=LED or MR16 Westwood Up/Down Wall Fixture-Single Head, Square

904-SQ-UD=LED or MR16 Westwood Up/Down Wall Fixture -Dual Head, Square

Source

50MR16=50W Max Halogen MR16, GU5.3 Base

6LED2712=6W 2700K, 12 Degree Spot, GU5.3 Base

6LED2721=6W 2700K, 21 Degree Narrow, GU5.3 Base

61 FD2741=6W 2700K, 41 Degree Wide, GU5.3 Base

6LED3012=6W 3000K, 12 Degree Spot, GU5.3 Base

6LED3021=6W 3000K, 21 Degree Narrow, GU5.3 Base

6LED3041=6W 3000K, 41 Degree Wide, GU5.3 Base 6LED4012=6W 4000K,12 Degree Spot, GU5.3 Base

6LED4021=6W 4000K, 21 Degree Narrow, Gu5.3 Base

6LED4041=6W 4000K, 41 Degree Wide, GU5.3 Base 6LED5712=6W 5700K, 12 Degree Spot, GU6.3 Base

6LED5721=6W 5700K, 21 Degree Narrow, GU5.3 Base

6LED5741= 6W 5700K, 41 Degree Wide, GU5.3 Base

10LED2712= 10W 2700K, 12 Degree Spot, GU5.3 Base

10LED2721= 10W 2700K, 21 Degree Narrow, GU5.3 Base

10LED2741= 10W 2700K, 41 Degree Wide, GU5.3 Base 10LED3012= 10W 3000K, 12 Degree Spot, GU5.3 Base

10LED3021= 10W 3000K, 21 Degree Narrow, GU5.3 Base

10LED3041= 10W 3000K, 41 Degree Wide, GU5.3 Base

10LED4012= 10W 4000K, 12 Degree Spot, GU5.3 Base 10LED4021 = 10W 4000K, 21 Degree Narrow, GU5.3 Base

10LED4041 = 10W 4000K, 41 Degree Wide, GU5.3 Base

10LED5712= 10W 5700K 12 Degree Spot, GU5.3 Base

10LED5721= 10W 5700K, 21 Degree Narrow, GU5.3 Base

10LED5741= 10W 5700K, 41 Degree Wide, GU5.3 Base

Lamp not included.

12V remote transformer required - not included

See ACCESSORIES & TECHNICAL DATA section of the Lumière catalog for Low Voltage Cable & Transformers.

Consult your Cooper Lighting representative for additional options and finishes.



#### LAMP INFORMATION

Lamp	Watts	Beam Spread	СВСР	°K	Life (hrs.)	Base	Volts
6LED2712	6	12°	3358	2700	50000	GU5.3 bi-pin	12
6LED2721	6	21°	937	2700	50000	GU5.3 bi-pin	12
6LED2741	6	41°	472	2700	50000	GU5.3 bi-pin	12
6LED3012	6	12°	3694	3000	50000	GU5.3 bi-pin	12
6LED3021	6	21°	1019	3000	50000	GU5.3 bi-pin	12
6LED3041	6	41°	646	3000	50000	GU5.3 bi-pin	12
6LED4012	6	12°	4280	4000	50000	GU5.3 bi-pin	12
6LED4021	6	21°	1179	4000	50000	GU5.3 bi-pin	12
6LED4041	6	41°	754	4000	50000	GU5.3 bi-pin	12
6LED5712	6	12°	4496	5700	50000	GU5.3 bi-pin	12
6LED5721	6	21°	1275	5700	50000	GU5.3 bi-pin	12
6LED5741	6	41°	792	5700	50000	GU5.3 bi-pin	12
10LED2712	10	12°	5037	2700	50000	GU5.3 bi-pin	12
10LED2721	10	21°	1406	2700	50000	GU5.3 bi-pin	12
10LED2741	10	41°	708	2700	50000	GU5.3 bi-pin	12
10LED3012	10	12°	5513	3000	50000	GU5.3 bi-pin	12
10LED3021	10	21°	1521	3000	50000	GU5.3 bi-pin	12
10LED3041	10	41°	964	3000	50000	GU5.3 bi-pin	12
10LED4012	10	12°	6389	4000	50000	GU5.3 bi-pin	12
10LED4021	10	21°	1759	4000	50000	GU5.3 bi-pin	12
10LED4041	10	41°	1125	4000	50000	GU5.3 bi-pin	12
10LED5712	10	12°	6711	5700	50000	GU5.3 bi-pin	12
10LED5721	10	21°	1903	5700	50000	GU5.3 bi-pin	12
10LED5741	10	41°	1182	5700	50000	GU5.3 bi-pin	12
50MR16/NSP	50	12°	11,000	3050	4000	GU5.3 bi-pin	12
50MR16/NSL	50	25°	3200	3050	4000	GU5.3 bi-pin	12
50MR16/FL	50	40°	2000	3050	4000	GU5.3 bi-pin	12
50MR16/WFL	50	60°	1200	3050	4000	GU5.3 bi-pin	12

#### NOTES AND FORMULAS

- Beam diameter is to 50% of maximum footcandles, rounded to the nearest half-foot.
- Footcandle values are initial. Apply appropriate light loss factors where necessary.



608 574 8185

4906 FEMRITE DR MADISON, WI

Designer
Kyle McGraw
Date
3/16/2015
Scale
Not to Scale
Drawing No. - 1

Summary

1 of 2

Number Lumens

Lamps per Lamp

3051.355

-1

Lamp

Type CXA LED, 5000 K.

MODULE AIMED AT THE

HORIZON.

LLF

Wattage

0

8.04

Luminaire Schedule

Label

A

B

7

3

**Catalog Number** 

E-WP6L03CZ

10LED4041

Description

Cast black painted metal wall mounting

bracket, cast black painted finned metal

with  $1.0625 \times 1.8125$ " aperture, clear

IN MACHINED CYLINDRICAL BROWN

PAINTED METAL LENS FRAME WITH

UNFINISHED INTERIOR SURFACE

BETWEEN LENS AND LED MODULE.

housing, one circuit board with one 120 led

array, formed white painted metal reflector

convex glass lens with rectangular prisms

in formed black painted metal trim plate.

MACHINED CYLINDRICAL METAL HOUSING, ONE LED MODULE, TLM-

1 LED MODULE, CLEAR FLAT GLASS LENS R16B-A354041B-A000, LED


Symbol

FEMRITE OFFICE/WAREHOUSE BUILD

Designer Kyle McGraw

2 of 2

### 4906 Femrite Drive Building Selections and Samples

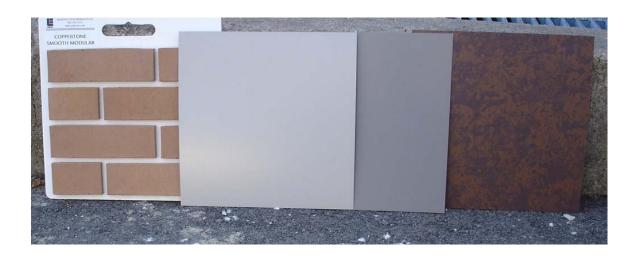

### Samples- Left to Right:

Brick- Endicott Clay Products – Coppertone Metal Corrugated Siding – Ash Gray Metal Roof Edge/ Facia – Slate Gray

Metal (SE) Ultra-Lock Accent – Western Rust



Similar – Metal Corrugated Siding



 $Similar\ Building\ Accent-Ultra-Lock\ Accent-Western\ Rust$ 



### **ULTRA-RIB PANEL**



#### **PRODUCT FEATURES**

- Asymmetric corrugated profile for horizontal application
- Clean & attractive architectural design Suitable for wall, liner or screen
- wall application
- Concealed anchor attachment
- Simple clip-less design
- Quick & easy installation
- Optional mitered corner panels available

The Ultra-Rib panel sets the industry standard for concealed anchor, horizontally-oriented corrugated wall panels. The clean architectural design provides a traditional horizontal rib application with the added security of concealed fastening. The clip-less design results in fast and easy installation while the uniform rib profile provides an exceptionally rigid panel suitable for installation over open framing. Factory mitered corner panels are available to eliminate added trim and interruption of the panel at corner transitions. Ultra-Rib panels are designed and intended for vertical wall applications and are not to be used for roofing.



ULTRA-RIB

ASTM TESTS ASTM E1592 tested

# 4906 Femrite Drive Partial Demolition of Existing Building Photos and Assessment

The following photos document the existing building and site area to be demolished. The existing building has a one story office area with basement that is approximately 1,260 square feet. The area of demolition will be the office area upper level only. The basement area shall remain. The remainder of the existing building is warehouse space at approximately 3,360 square feet, for a total existing building size of approximately 4,620 square feet. The building is constructed out of conventional wood stud framing and pitched wood roof trusses. The age of the building is estimated at 60 to 70 years old.



SW Corner of Site to Building



SE Corner of Site to Building



NE Site to the Building



NE Site to Building



NW Site to the Building



Office Area Interior of Building



Office Area Interior of Building



Bathroom Interior of Building




Kitchenette Area Interior of Building



Basement Area Interior of Building




Basement Area Interior of Building

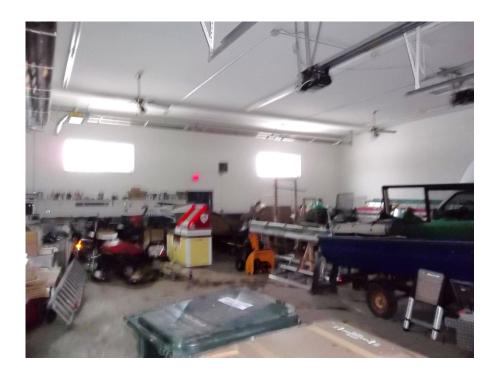

Warehouse Area Interior of Building



Warehouse Area Interior of Building

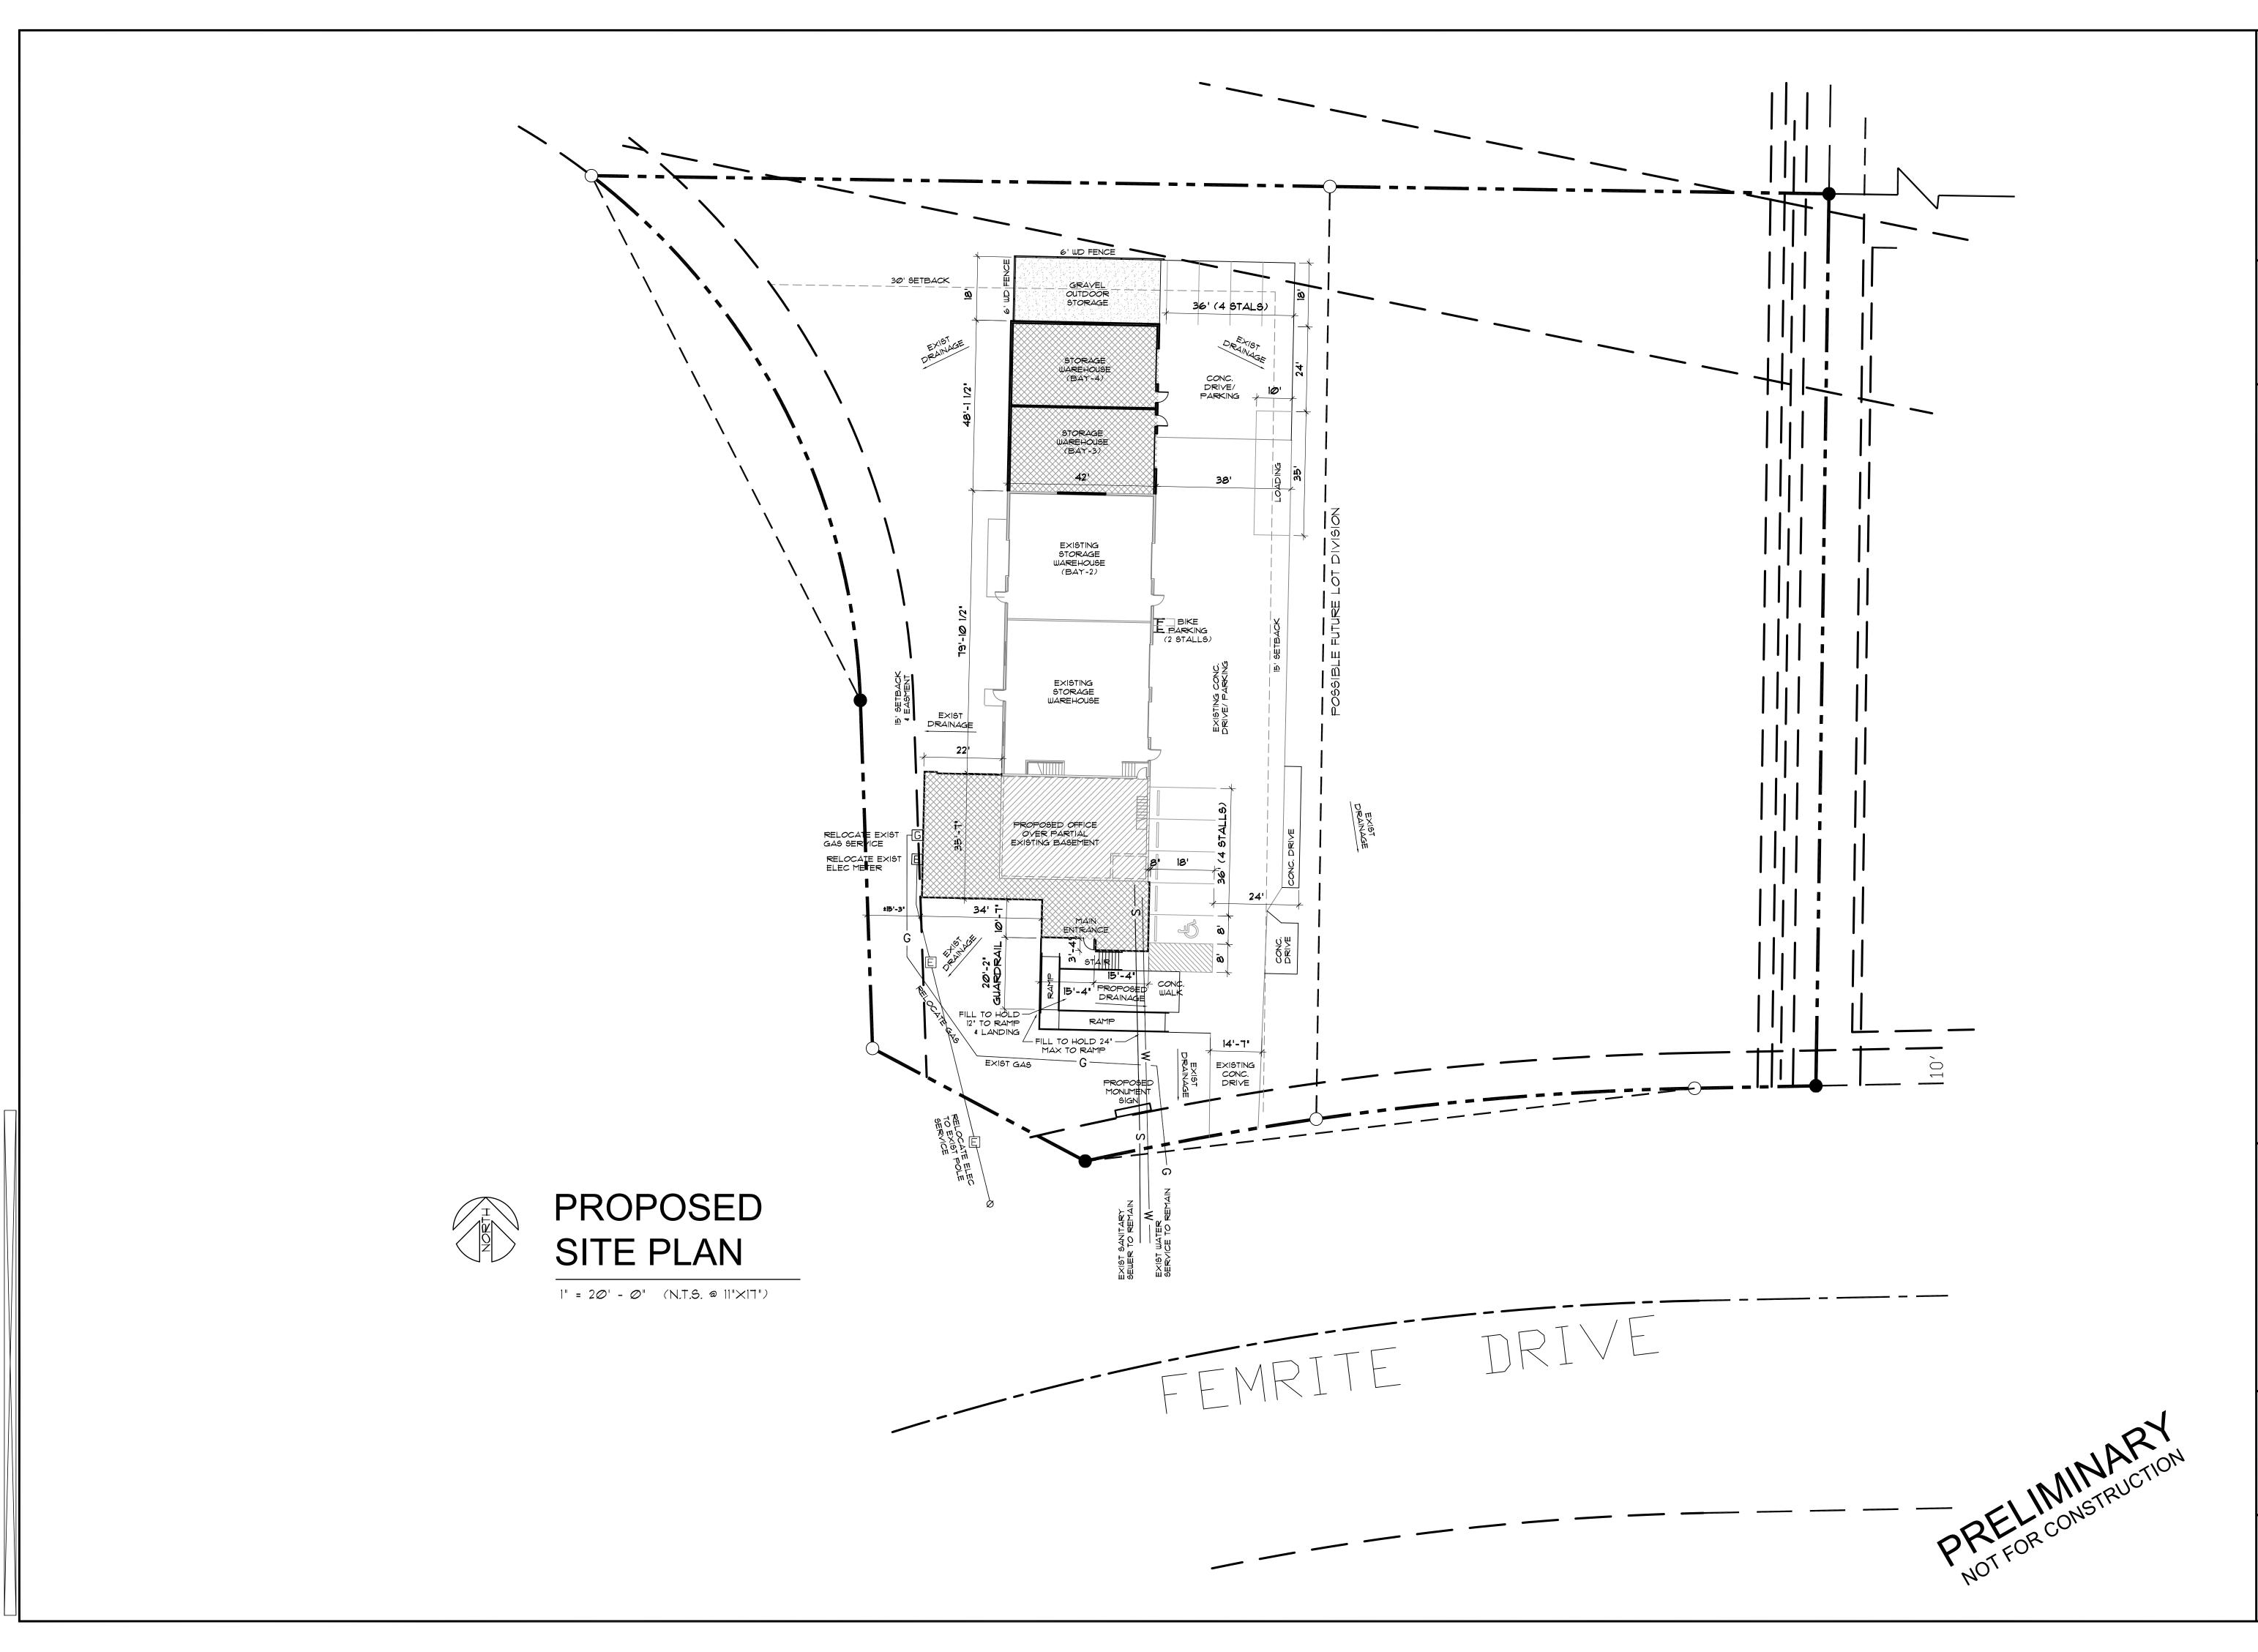


CONSTRUCTION MANAGEMENT


DRAWN BY:

CHECKED BY:

SHEET:

C2.1

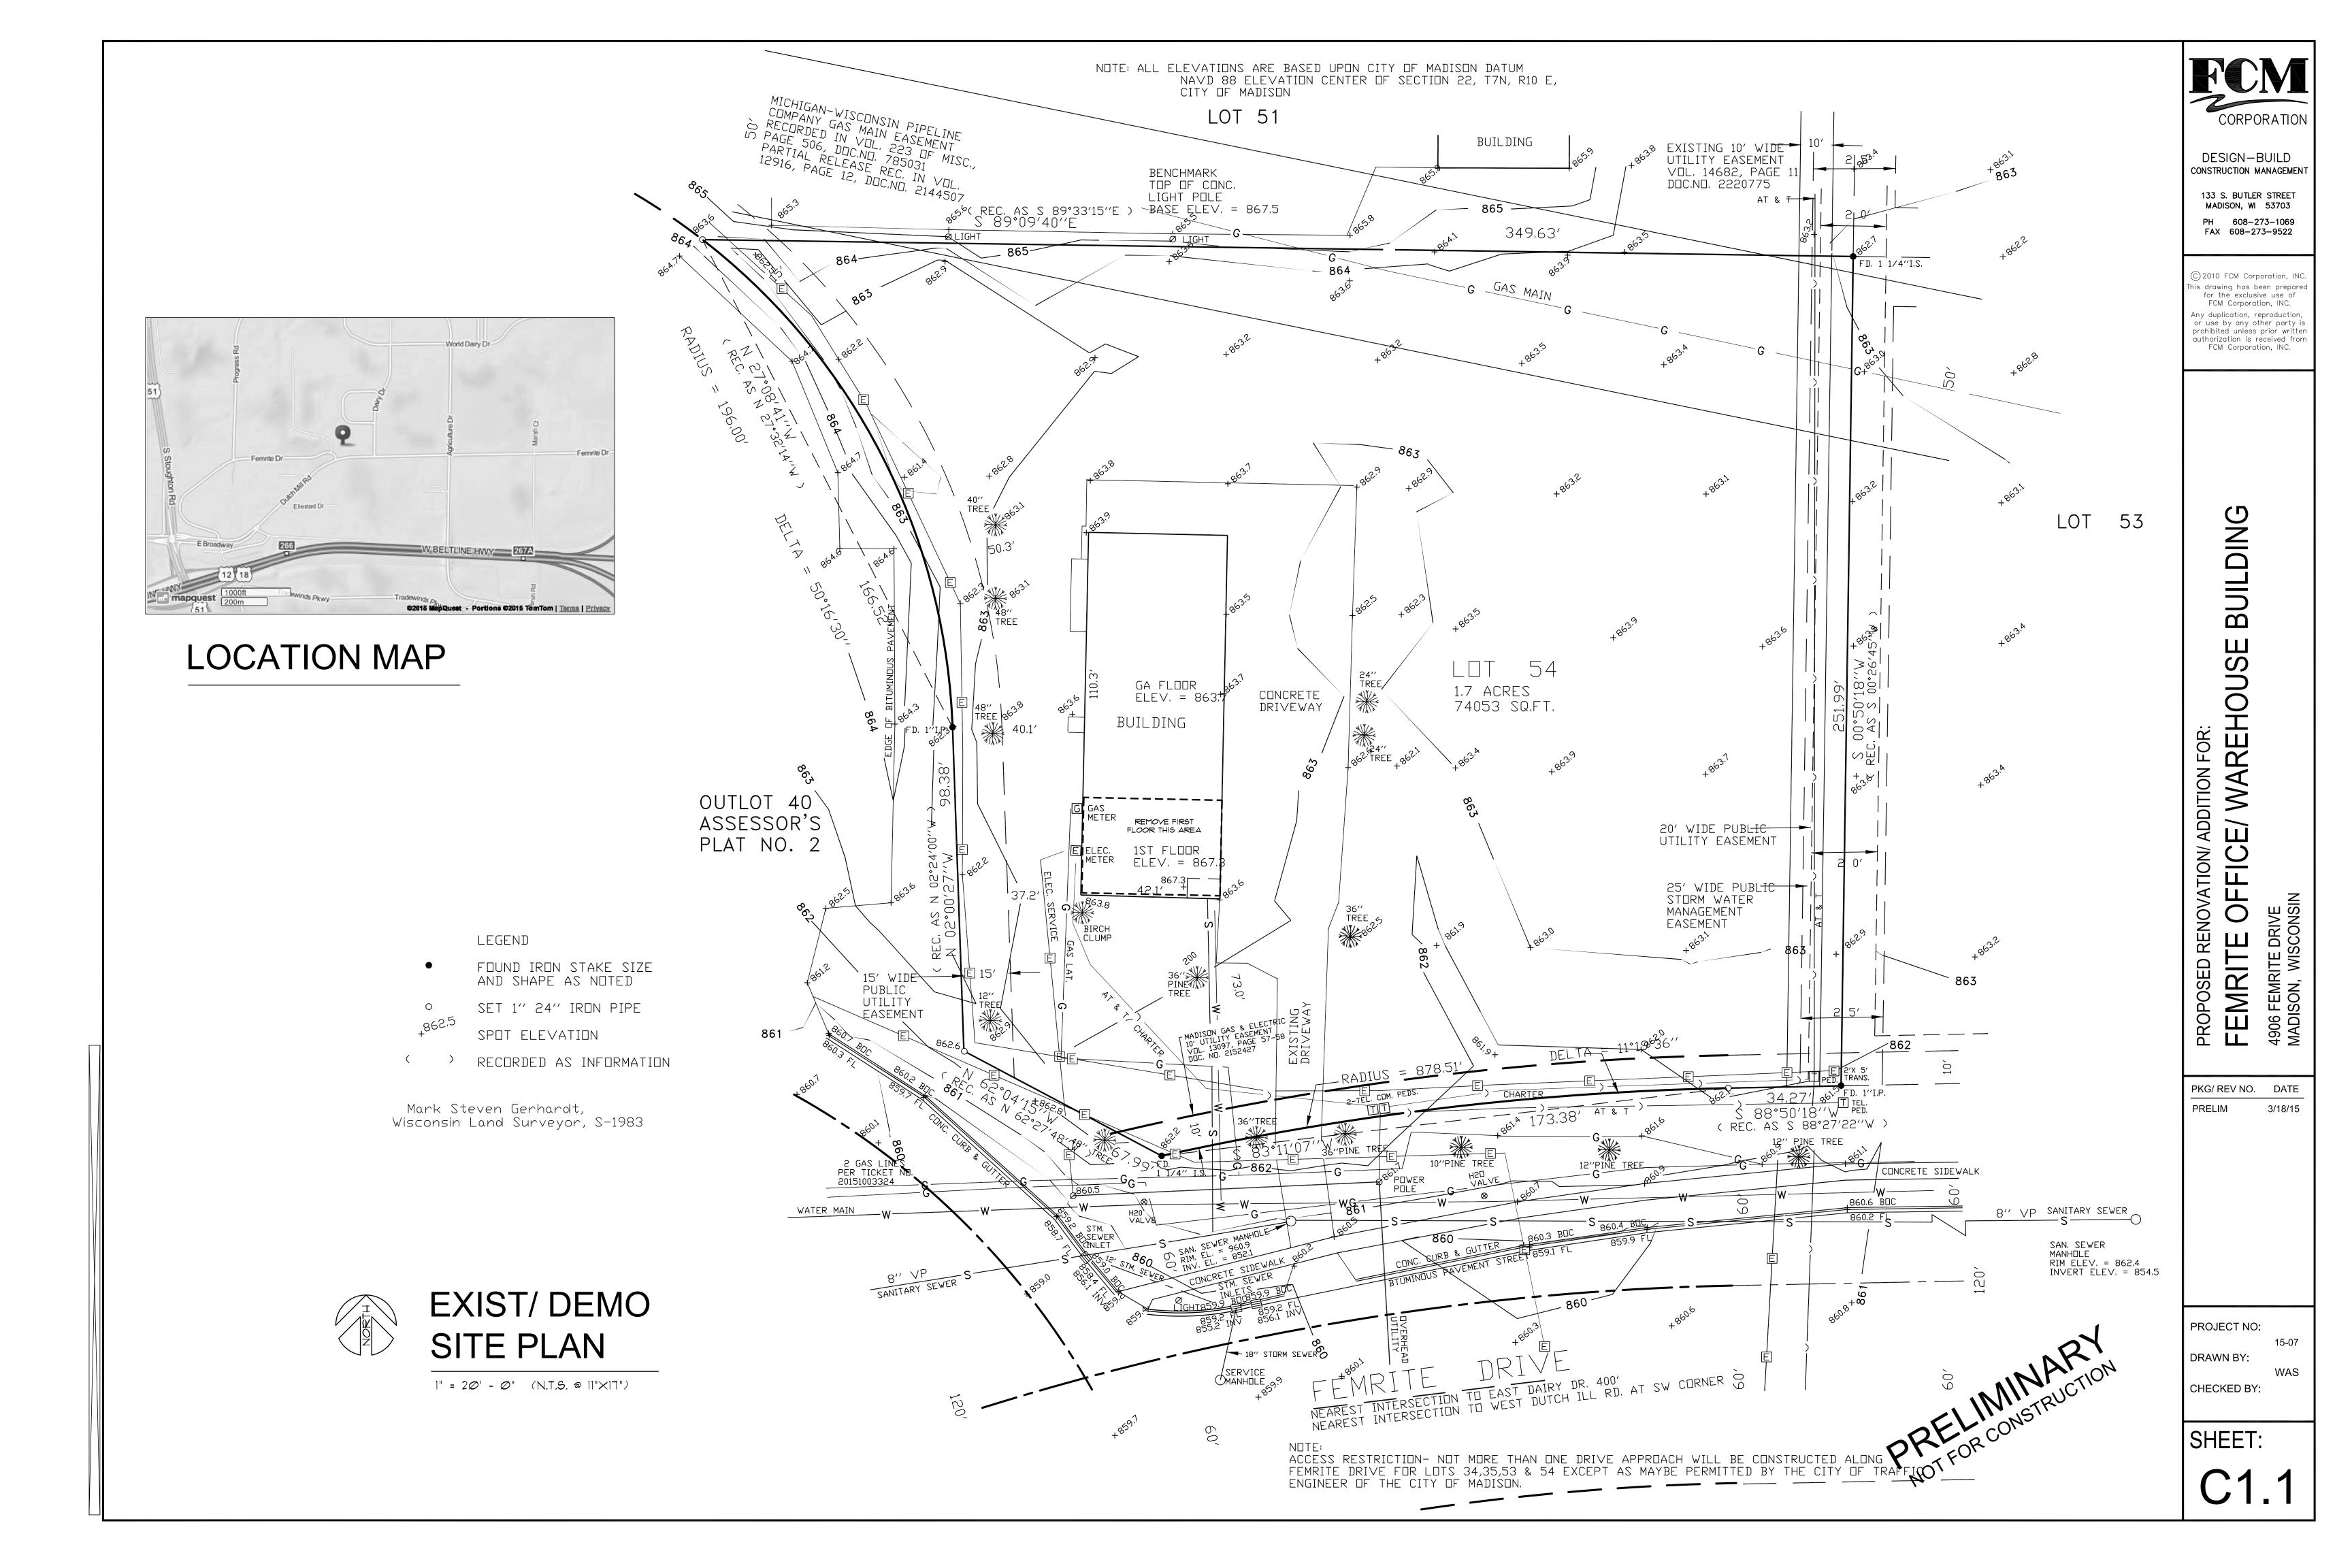

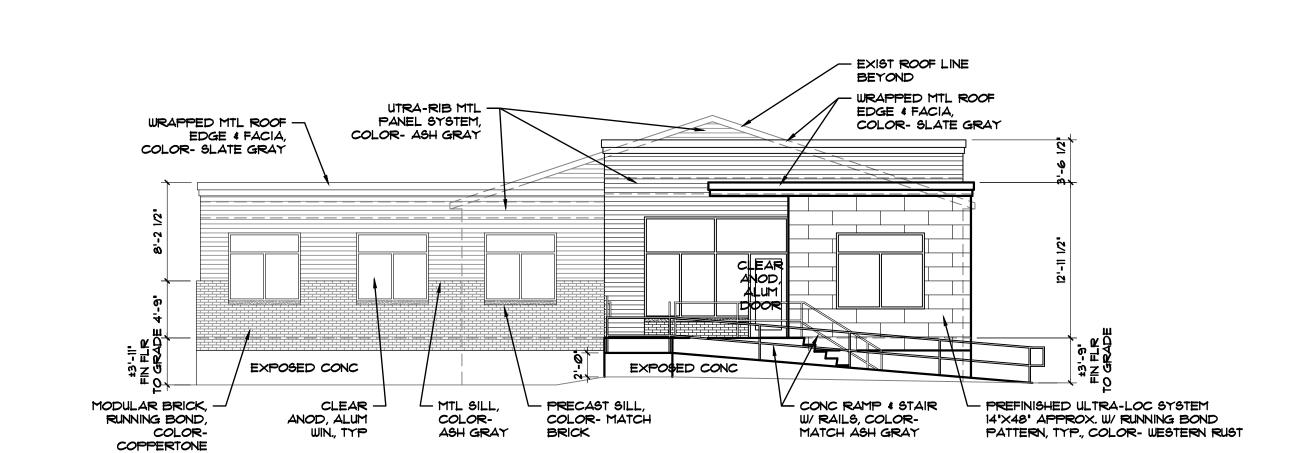

## NORTH ELEVATION- PROPOSED

UTRA-RIB MTL -

PANEL SYSTEM,

COLOR- ASH GRAY

WRAPPED MTL ROOF

COLOR- MATCH EXIST

- WRAPPED MTL ROOF

EDGE & FACIA, COLOR- SLATE GRAY

MODULAR BRICK,

RUNNING BOND,

COLOR-COPPERTONE

CLEAR

ANOD, ALUM

EDGE & FACIA,

ROOF SLOPE

 $1/8" = 1' - \emptyset" \quad (N.T.S. @ 11" \times 17")$ 

- Wrapped MTL Roof Edge & Facia,

COLOR- SLATE GRAY

SMART-SIDE SIDING TO -

MATCH EXIST PROFILE,

COLOR- ASH GRAY

RELOCATE EXIST WIN

UTRA-RIB MTL -PANEL SYSTEM,

COLOR- ASH GRAY


HARD COAT EIFS TO -

TO MATCH BRICK

MATCH EXIST, COLOR-


## SOUTH ELEVATION- PROPOSED

 $1/8" = 1' - \emptyset" \quad (N.T.S. @ 11" \times 17")$ 

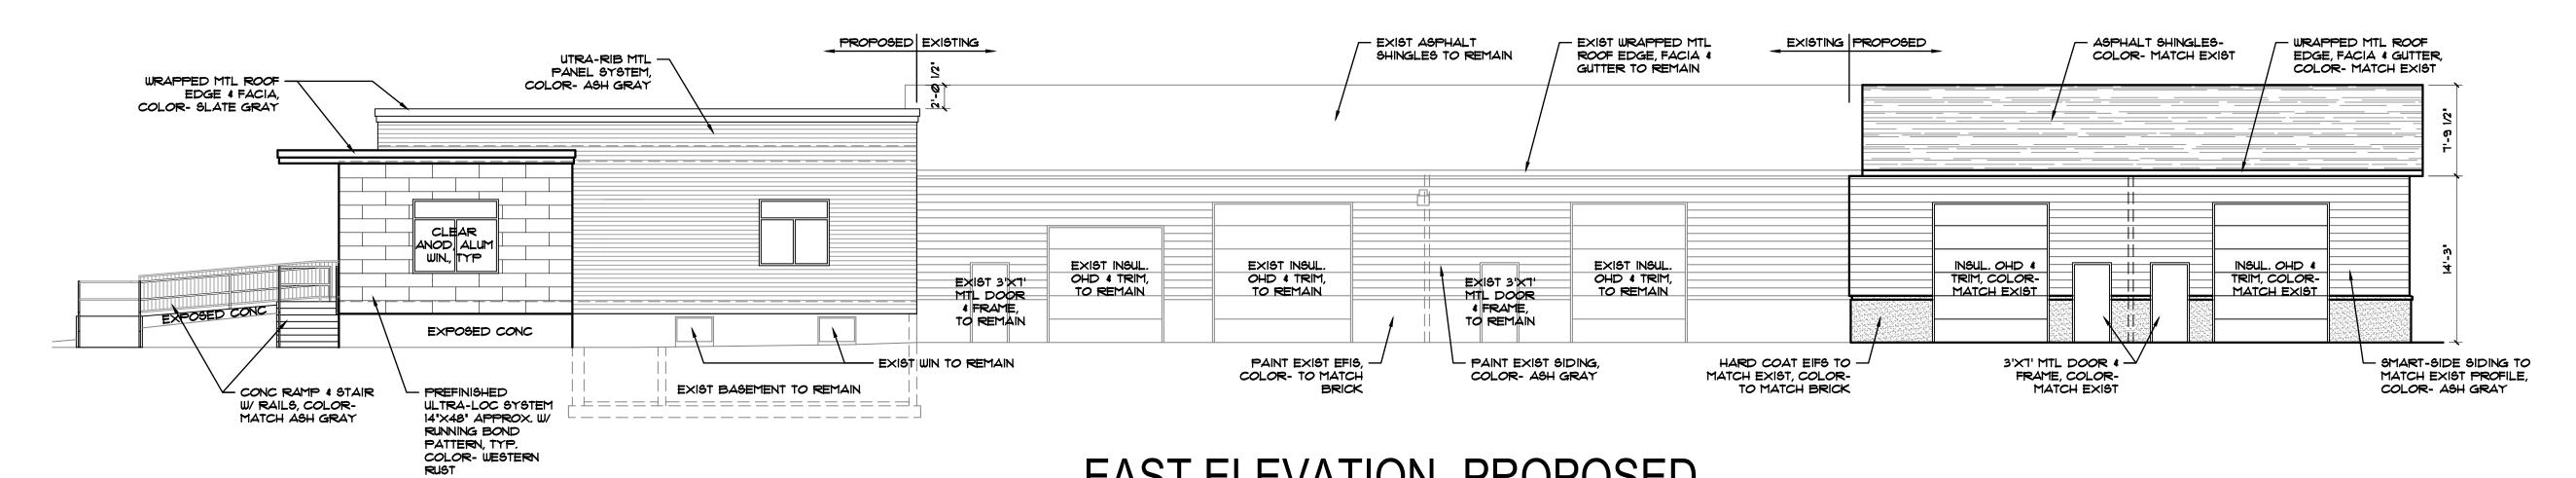

EAST ELEVATION- PROPOSED

 $1/8" = 1' - \emptyset" \quad (N.T.S. @ 11" \times 17")$ 

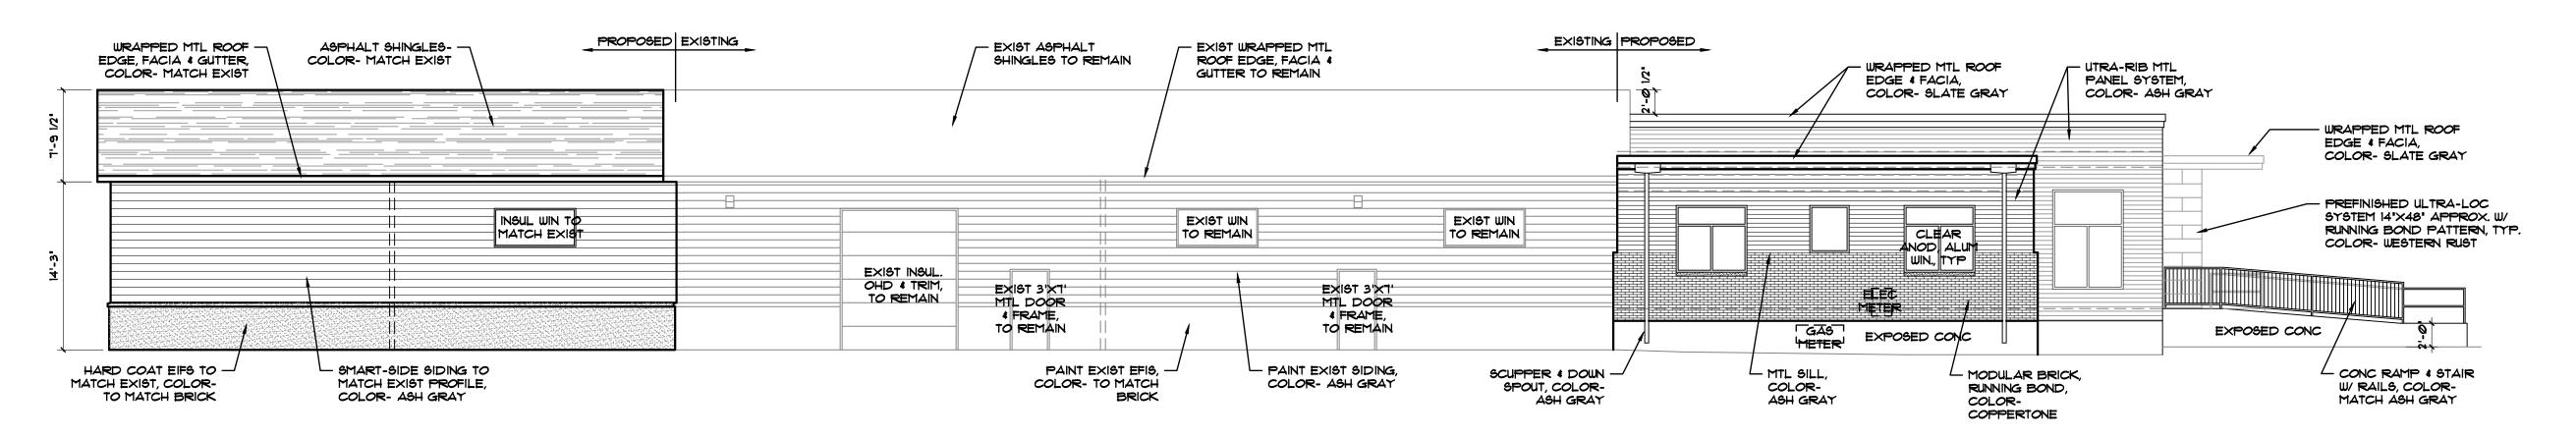

WEST ELEVATION- PROPOSED

 $1/8" = 1' - \emptyset" \quad (N.T.S. @ 11" \times 17")$ 

DESIGN-BUILD CONSTRUCTION MANAGEMENT

133 S. BUTLER STREET MADISON, WI 53703 PH 608-273-1069 FAX 608-273-9522

© 2010 FCM Corporation, INC nis drawing has been prepare for the exclusive use of FCM Corporation, INC. prohibited unless prior writte

authorization is received from FCM Corporation, INC.

Ž O


ADI PROPOSED RENOVATION/ **FEMRITE** 

4906 FEMRITE DRIVE MADISON, WISCONSIN

PKG/ REV NO. DATE


PROJECT NO: 15-07 DRAWN BY:

CHECKED BY:

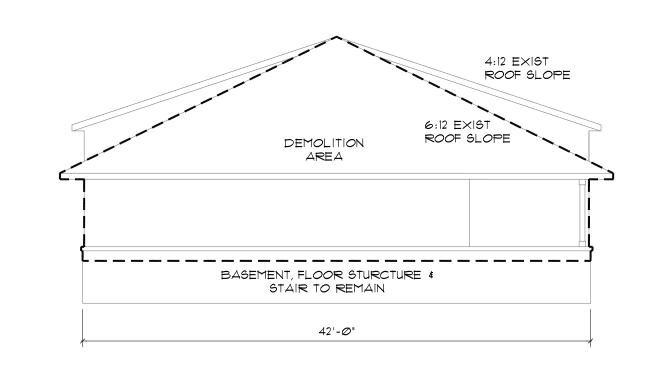


## SOUTH ELEVATION- EXIST/ DEMO

1/8" = 1' - Ø" (N.T.S. @ 11"×17"

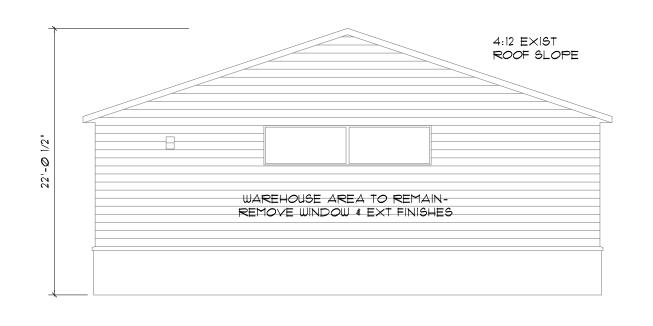


## NORTH ELEVATION- EXISTING

1/8" = 1' - Ø" (N.T.S. @ 11"×17")

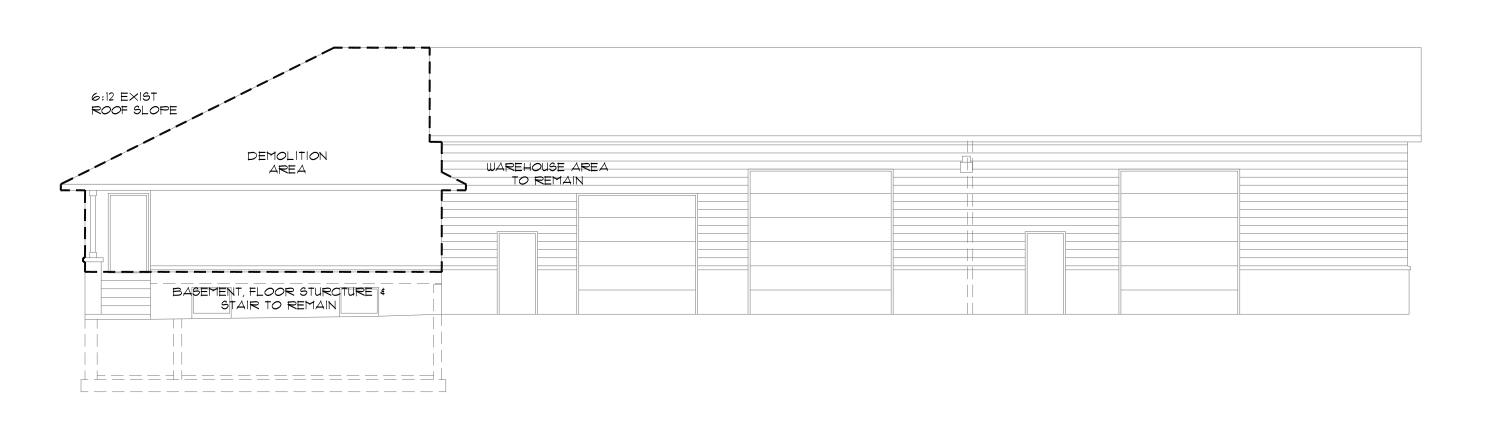

## EAST ELEVATION- EXIST/ DEMO

1/8" = 1' - Ø" (N.T.S. @ 11"×17"

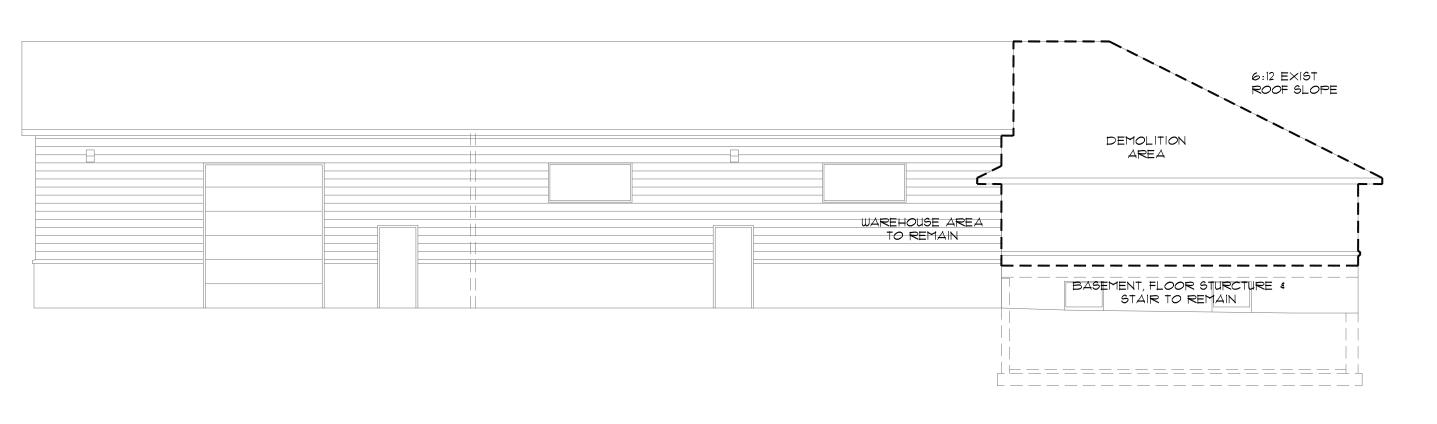

## WEST ELEVATION- EXIST/ DEMO

1/8" = 1' - Ø" (N.T.S. @ 11"×17")

PRELIMINAR ON PROPERTY OF THE PROPERTY OF THE

CORPORATION

DESIGN-BUILD CONSTRUCTION MANAGEMEN

133 S. BUTLER STREET MADISON, WI 53703 PH 608-273-1069 FAX 608-273-9522

© 2010 FCM Corporation, INC This drawing has been prepare for the exclusive use of FCM Corporation, INC. Any duplication, reproduction, or use by any other party is

FCM Corporation, INC.

Any duplication, reproduction, or use by any other party is prohibited unless prior written authorization is received from FCM Corporation, INC.

PROPOSED RENOVATION/ ADDITION FOR:
FEMRITE OFFICE/ WAREHOUSE BUILDING

PKG/ REV NO. DATE
PRELIM 3/18/15

PROJECT NO:

DRAWN BY: CHECKED BY:

SHEET:

A4.1