

# **City of Madison Fire Department**

314 W Dayton Street, Madison, WI 53703-2506 Phone: 608-266-4420 • Fax: 608-267-1100 • E-mail: fire@cityofmadison.com

Project Address: 4846 Eastpark Blvd - Lot 49-50


Contact Name & Phone #: Greg Held - 608-836-3690


#### FIRE APPARATUS ACCESS AND FIRE HYDRANT WORKSHEET


<ol> <li>Is the building completely protected by an NFPA 13 or 13R automatic fire sprinkler system?</li></ol>	X Yes	☐ No	□ N/A
If non-sprinklered, fire lanes extend to within 150-feet of all portions of the exterior wall?	Ves	☐ No	X N/A
If sprinklered, fire lanes are within 250-feet of all portions of the exterior wall?	X Yes	☐ No	N/A
<ul> <li>2. Is the fire lane constructed of concrete or asphalt, designed to support a minimum load of 85,000 lbs?</li> <li>a) Is the fire lane a minimum unobstructed width of at least 20-feet?</li> <li>b) Is the fire lane unobstructed with a vertical clearance of at least 13<sup>1</sup>/<sub>2</sub>-feet?</li> <li>c) Is the minimum inside turning radius of the fire lane at least 28-feet?</li> <li>d) Is the grade of the fire lane not more than a slope of 8%?</li> <li>e) Is the fire lane posted as fire lane? (Provide detail of signage.)</li> <li>f) Is a roll-able curb used as part of the fire lane? (Provide detail of curb.)</li> <li>g) Is part of a sidewalk used as part of the required fire lane? (Must support +85,000 lbs.)</li> </ul>	X Yes X Yes X Yes X Yes X Yes Yes Yes Yes	□ No □ No □ No □ No □ No ■ No ■ No ■ No	□ N/A □ N/A □ N/A □ N/A □ N/A □ N/A □ N/A
<ul><li>3. Is the fire lane obstructed by security gates or barricades? If yes:</li><li>a) Is the gate a minimum of 20-feet clear opening?</li><li>b) Is an approved means of emergency operations installed, key vault, padlock or key switch?</li></ul>	☐ Yes	X No	N/A
	☐ Yes	No	N/A
	☐ Yes	No	N/A
4. Is the Fire lane dead-ended with a length greater than 150-feet? If yes, does the area for turning around fire apparatus comply with IFC D103?	Yes Yes	X No	N/A X N/A
5. Is any portion of the building to be used for high-piled storage in accordance with IFC Chapter 3206.6 If yes, see IFC 3206.6 for further requirements.	Yes	X No	N/A
6. Is any part of the building greater than 30-feet above the grade plane?	X Yes	🗌 No	N/A
<ul> <li>If yes, answer the following questions:</li> <li>a) Is the aerial apparatus fire lane parallel to one entire side of the building and covering at least 25% of the perimeter?</li> <li>b) Is the near edge of the aerial apparatus fire lane between 15' and 30' from the building?</li> <li>c) Are there any overhead power or utility lines located across the aerial apparatus fire lane?</li> <li>d) Are there any tree canopies expected to grow across the aerial fire lane? (Based on mature canopy width of tree species)</li> </ul>	X Yes	□ No	□ N/A
	Yes	X No	□ N/A
	Yes	X No	□ N/A
	Yes	X No	□ N/A
<ul><li>e) Does the aerial apparatus fire lane have a minimum unobstructed width of 26-feet?</li><li>f) Is the space between the aerial lane and the building free of trees exceeding 20' in heights?</li></ul>	X Yes	☐ No	□ N/A
	Ves	X No	□ N/A
7. Are all portions of the required fire lanes within 500-feet of at least (2) hydrants?	X Yes	🗌 No	N/A
<ul> <li>Note: Distances shall be measured along the path of the hose lay as it comes off the fire apparatus.</li> <li>a) Is the fire lane at least 26' wide for at least 20-feet on each side of the hydrants?</li> <li>b) Is there at least 40' between a hydrant and the building?</li> <li>c) Are the hydrant(s) setback no less than 5-feet nor more than 10-feet from the curb or edge of the street or fire lane?</li> </ul>	X Yes	□ No	□ N/A
	X Yes	□ No	□ N/A
	X Yes	□ No	□ N/A
<ul> <li>d) Are hydrants located in parking lot islands a minimum of 3<sup>1</sup>/<sub>2</sub>-feet from the hydrant to the curb?</li> <li>e) Are there no obstructions, including but not limited to: power poles, trees, bushes, fences, posts located, or grade changes exceeding 1<sup>1</sup>/<sub>2</sub>-feet, within 5-feet of a fire hydrant?</li> <li>Note: Hydrants shall be installed and in-service prior to combustible construction on the project site.</li> </ul>	X Yes	□ No	□ N/A
	X Yes	□ No	□ N/A

Attach an additional sheet if further explanation is required for any answers.

This worksheet is based on MGO 34.503 and IFC 2015 Edition Chapter 5 and Appendix D; please see the codes for further information.

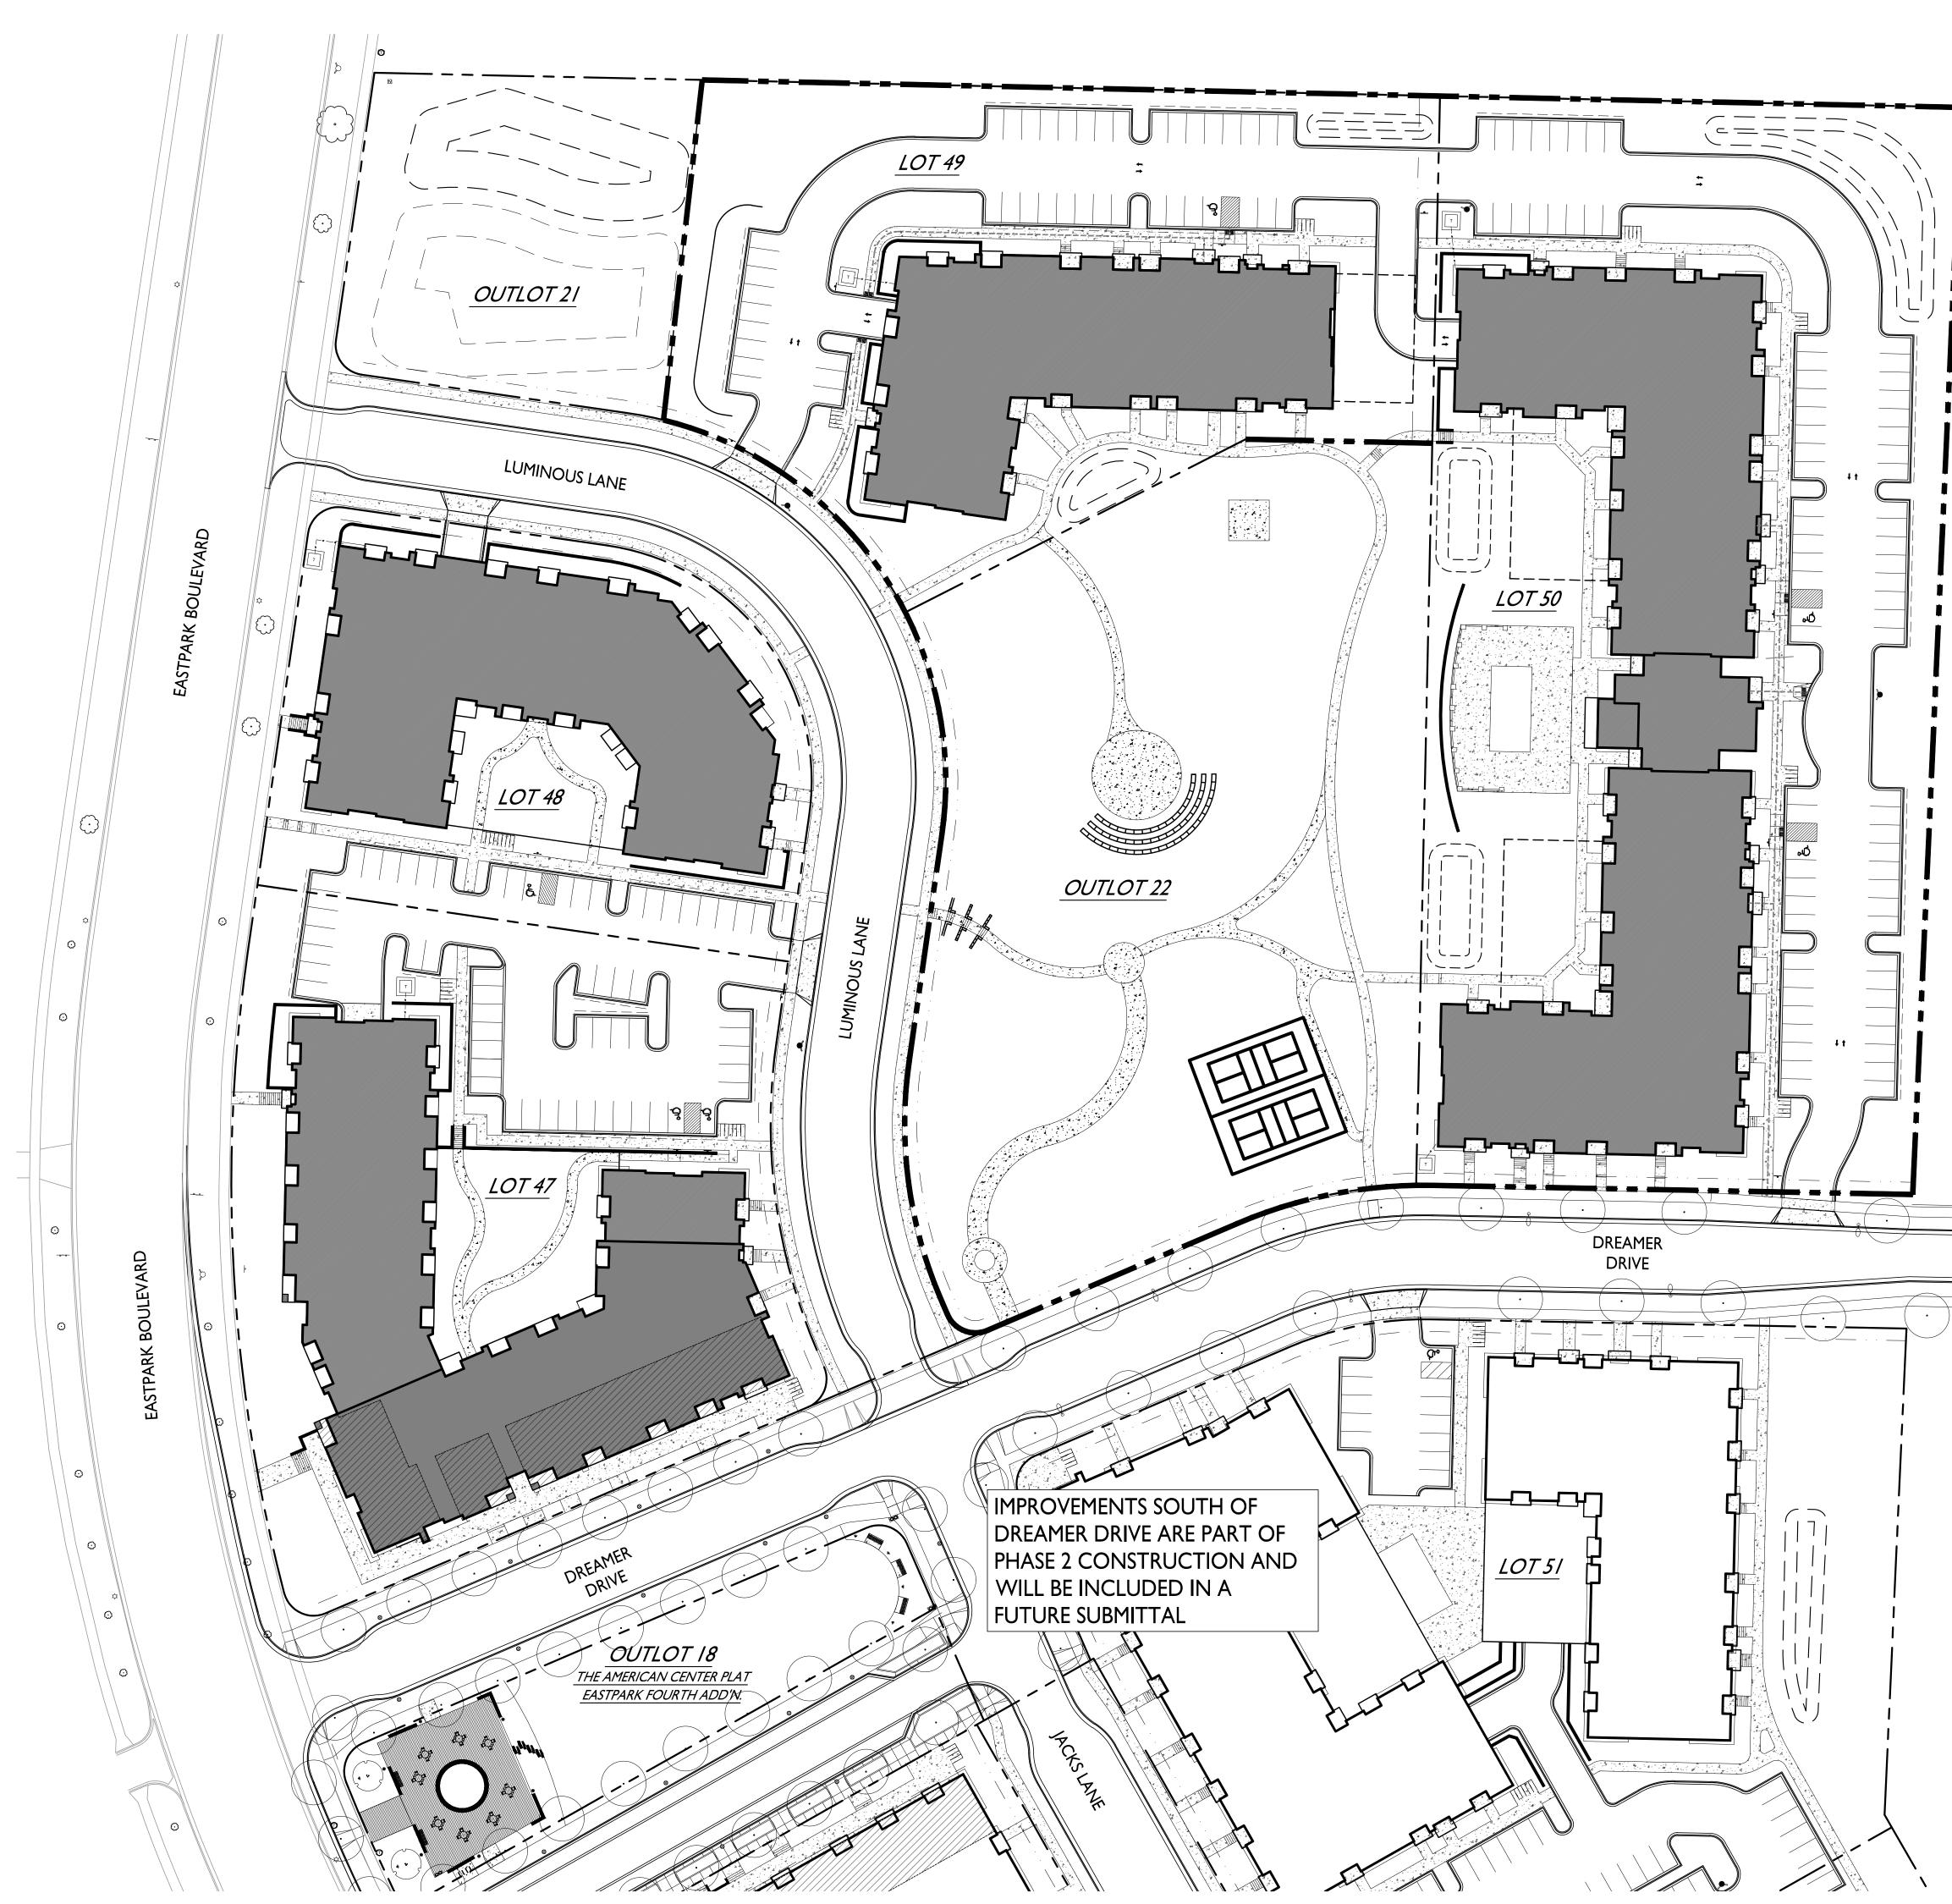

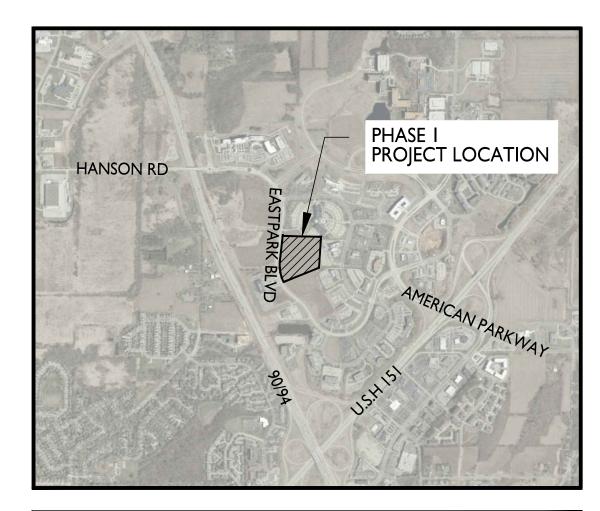

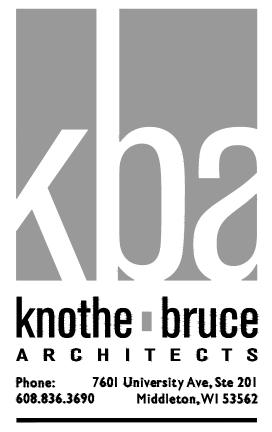

SHEET INDEX	
SITE	
C-1.0	OVERALL SITE PLAN
C-I.I	ENLARGED SITE PLAN LOT 49
C-1.2	ENLARGED SITE PLAN LOT 50 NORTH
C-1.3	ENLARGED SITE PLAN LOT 50 SOUTH
C-2.1	SITE LIGHTING LOT 49
C-2.2	SITE LIGHTING LOT 50 NORTH
C-2.3	SITE LIGHTING LOT 50 SOUTH
C-3.1	LOT COVERAGE LOT 49
C-3.2	LOT COVERAGE LOT 50 NORTH
C-3.3	LOT COVERAGE LOT 50 SOUTH
CI	CIVIL TITLE SHEET
C2	NOTES & LEGENDS
C3	EXISTING CONDITIONS
C4	EROSION CONTROL PLAN
C5	PHASE I OVERALL SITE & UTILITY PLAN
C6	LOT 49 SITE & UTILITY PLAN
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C8	LOT 50 SOUTH SITE & UTILITY PLAN
С9	PHASE I OVERALL GRADING PLAN
CIO	LOT 49 GRADING PLAN
CII	LOT 50 NORTH GRADING PLAN
CI2	LOT 50 SOUTH GRADING PLAN
CI3	FIRE ACCESS PLAN
L100	OVERALL LANDSCAPE PLAN
L103	ENLARGED LANDSCAPE LOT 49
L104	ENLARGED LANDSCAPE LOT 50 NORTH
L105	ENLARGED LANDSCAPE LOT 50 SOUTH
	40
ARCHITECTURAL LOT 4	BASEMENT PLAN
A-1.0 A-1.1	FIRST FLOOR PLAN
A-1.2	SECOND FLOOR PLAN
A-1.3	THIRD FLOOR PLAN
A-1.4	FOURTH FLOOR PLAN
A-2.1	EXTERIOR ELEVATIONS
A-2.2	EXTERIOR ELEVATIONS
A-2.3	ELEVATIONS COLORED
A-2.4	ELEVATIONS COLORED
ARCHITECTURAL LOT	—
A-1.0 A-1.1	BASEMENT PLAN FIRST FLOOR PLAN
A-1.1 A-1.2	SECOND FLOOR PLAN
A-1.2 A-1.3	THIRD FLOOR PLAN
A-1.4	FOURTH FLOOR PLAN
A-2.1	
A-2.2	
A-2.3	
A-2.4	
A-2.5	
A-2.6	
A-2.7 A-2.8	ELEVATIONS COLORED ELEVATIONS COLORED
<u>A-2.0</u>	
	-
RI R2	LOT 49 LOOKING EAST LOT 49 LOOKING SOUTH
RZ R3	LOT 49 LOOKING SOUTH
R3 R4	LOT 49-50 LOOKING SOUTH LOT 50 LOOKING WEST
R4 R5	LOT 50 LOOKING WEST
R6	LOT 50 LOOKING NORTHWEST
R7	LOT 50 LOOKING NORTHEAST

	GRAPH	IC SCALE	
0	40 I	80 I	120
	I INCH = 40 F	Г (24Х36 SHEET)	

ISSUED Issued for LUA & UDC Submittals - February 27, 2023

## PROJECT TITLE CASCADE -THE AMERICAN CENTER EASTPARK FIFTH ADDITION

4846 Eastpark Blvd. Madison, Wl SHEET TITLE Phase I - Overall Site Plan


Lot 49-50

SHEET NUMBER

PROJECT NO.

C-1.0

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Zoning	TR-U2	
Densities:		
Lot Area	74,337 S.F./I.7I AC	RES
Dwelling Units	67 units	
Lot Area / D.U.	I,II0 S.F./D.U.	
Density	39 units/Acre	
	PROVIDED	ZONING REQUIREMENTS
Lot Coverage	40,600 S.F. (53%)	75% Max.
Building Height	4 stories/54 <sup>`</sup> -0"	4 Stories/52' Max.
Gross Building Area	95,002 S.F.	
Dwelling Unit Mix:		
Studio	9	
One Bedroom	30	
Two Bedroom	28	
Total Dwelling Units	67	
Vehicle Parking Stalls:		
Underground Garage	56	
Surface	43	
Total	99	
Electric Vehicle Parking Stalls	:	
EV Installed	2	2 - Min. 2% of Residential Stalls
EV Ready	6	6 - Min. 10% of Residential Stalls
Total	8	8 - Min. EV Required
Bicycle Parking:		
Long-Term Covered Garage	e 67	67 - Min. 100% of Req'd
(49 F.M. & Ĭ		·
Short-Term Guest - Surface		7 - Min. 10% of Units
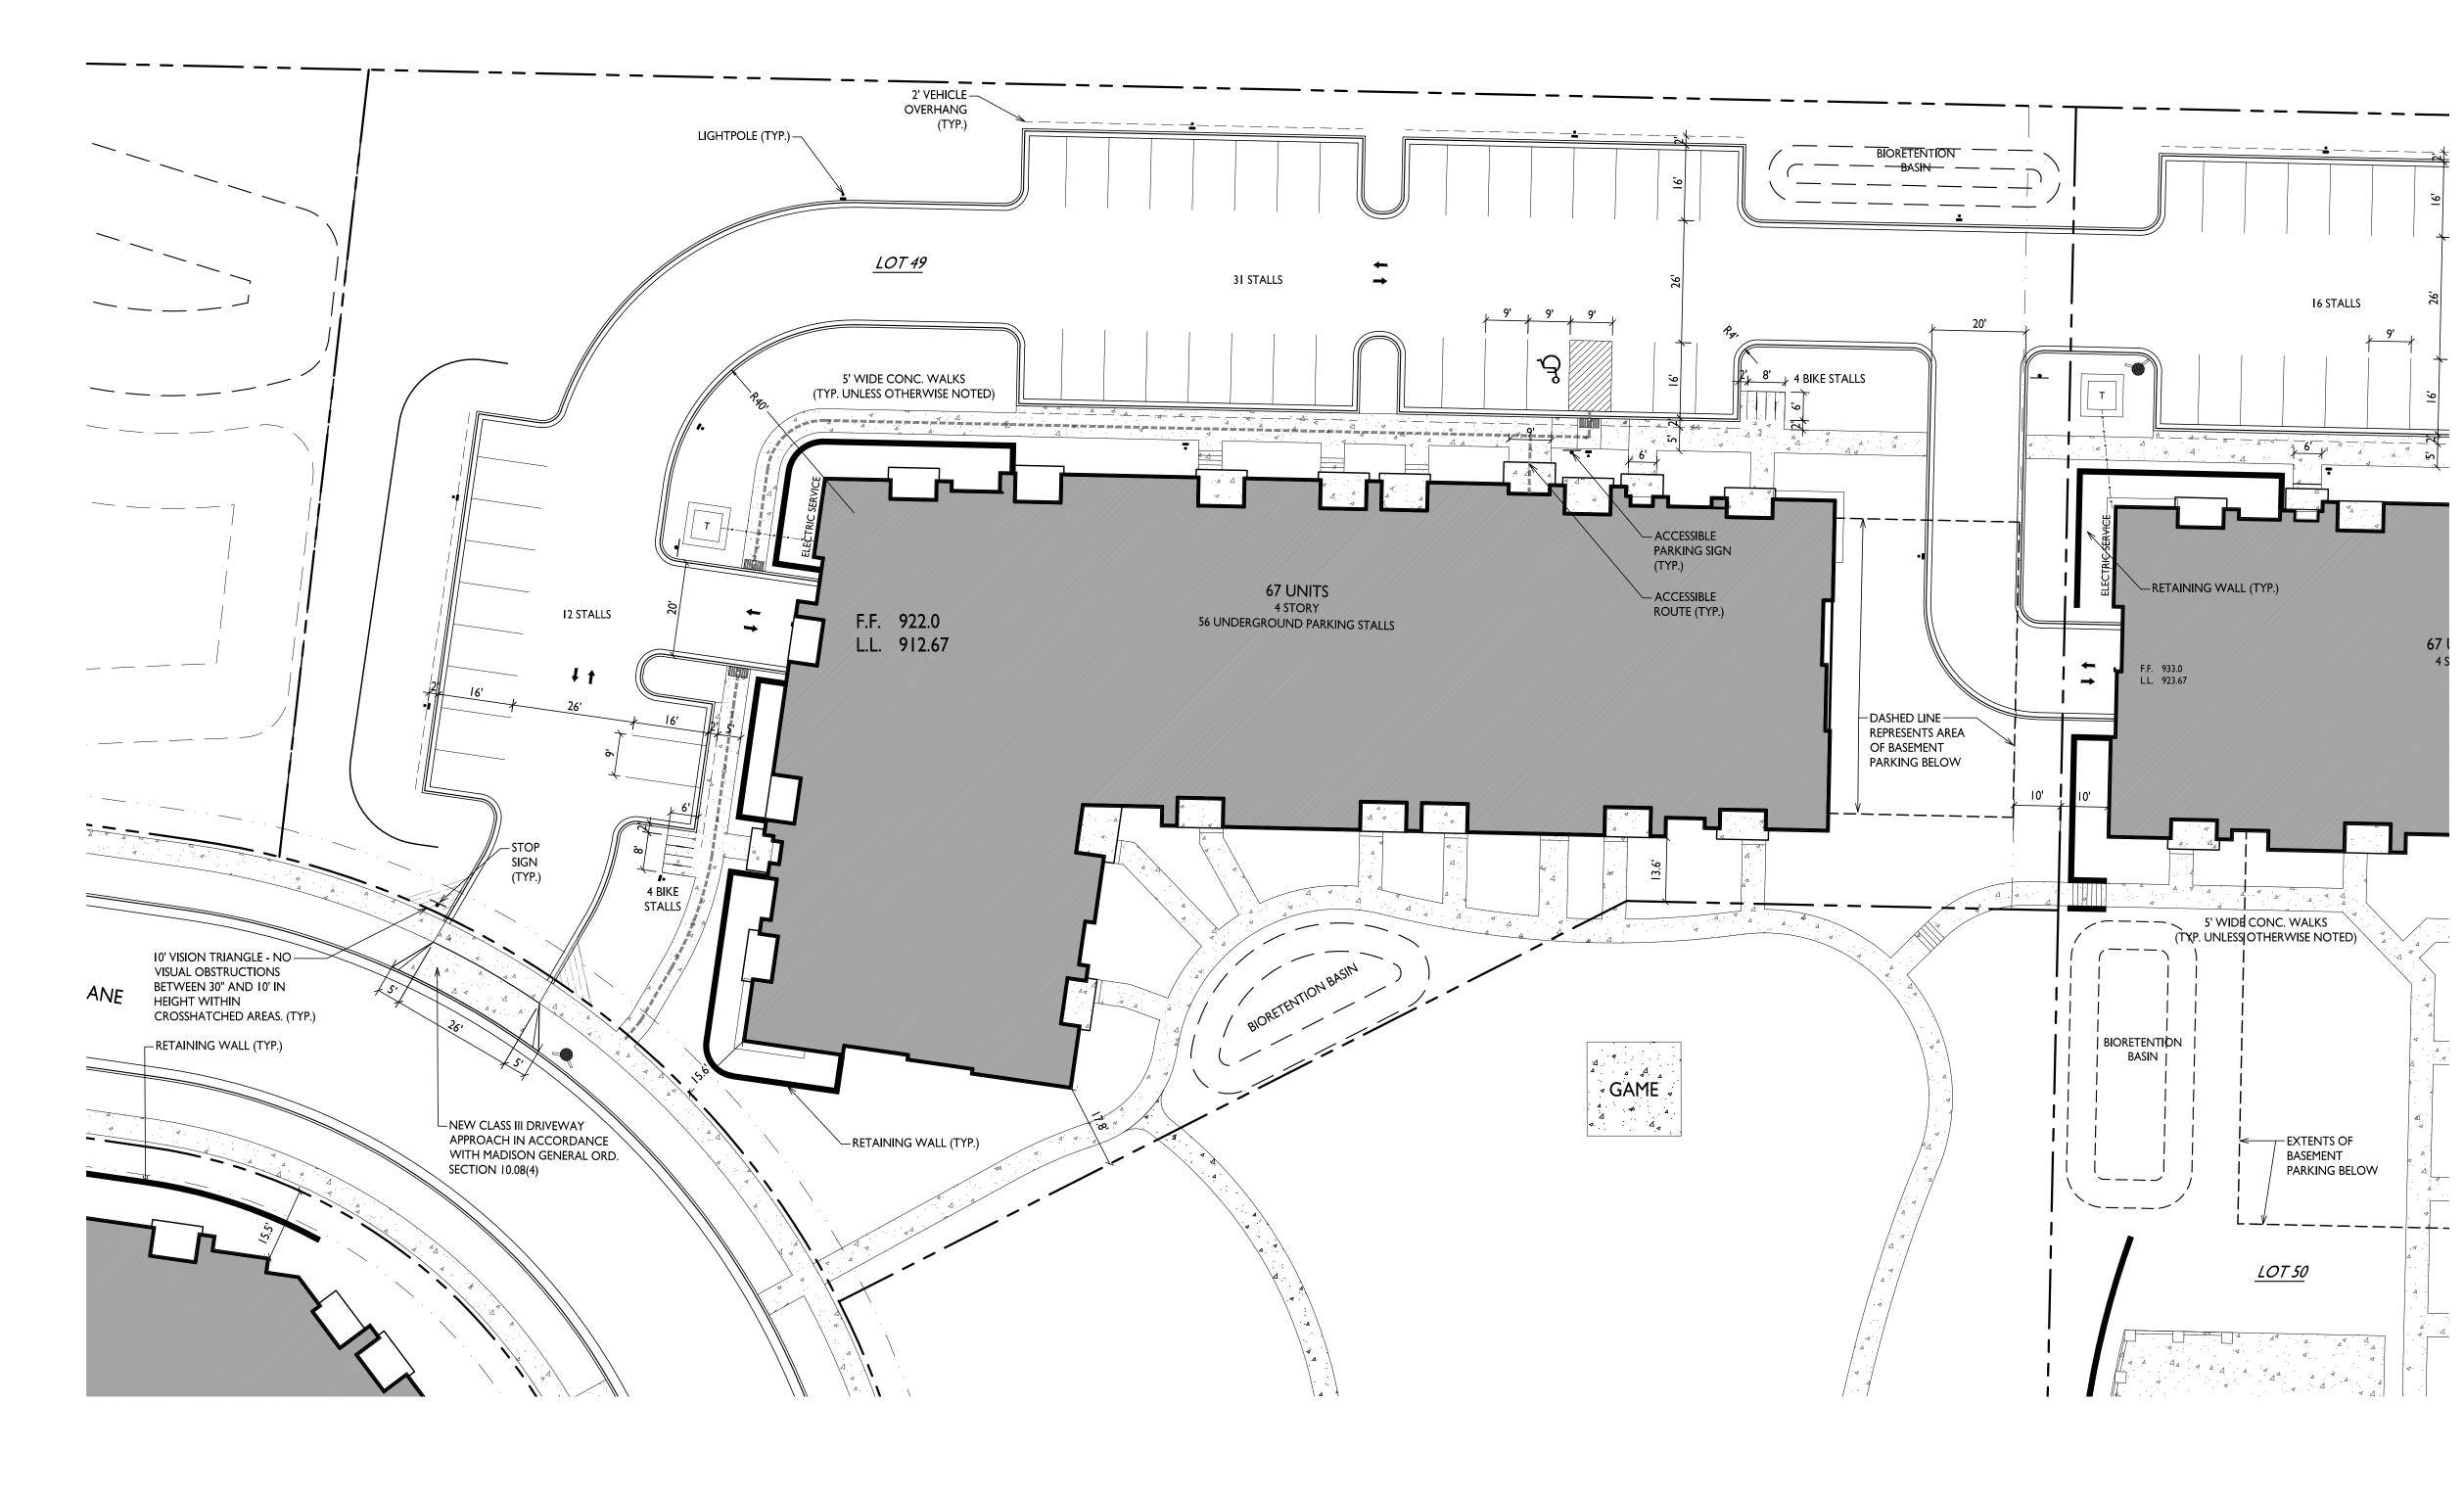
# knothe • bruce ARCHITECTS 7601 University Ave, Ste 201 Phone: 608.836.3690 Middleton, WI 53562

#### GENERAL NOTES:

THE APPLICANT SHALL REPLACE ALL SIDEWALK AND CURB AND GUTTER THAT ABUTS THE PROPERTY THAT IS DAMAGED BY THE CONSTRUCTION, OR ANY SIDEWALK AND CURB AND GUTTER WHICH THE CITY ENGINEER DETERMINES NEEDS TO BE REPLACED BECAUSE IT IS NOT AT A DESIRABLE GRADE, REGARDLESS OF WHETHER THE CONDITION EXISTED PRIOR TO BEGINNING CONSTRUCTION.

2. ALL WORK IN THE PUBLIC RIGHT OF WAY SHALL BE PERFORMED BY A CITY-LICENSED CONTRACTOR.

3. ALL DAMAGE TO THE PAVEMENT ON CITY STREETS, AND ADJACENT TO THIS DEVELOPMENT SHALL BE RESTORED IN ACCORDANCE WITH THE CITY OF MADISON'S PAVEMENT PATCHING CRITERIA.

4. ALL PROPOSED STREET TREE REMOVALS WITHIN THE RIGHT OF WAY SHALL BE REVIEWED BY CITY FORESTRY BEFORE THE PLAN COMMISSION MEETING. STREET TREE REMOVALS REQUIRE APPROVAL AND A TREE REMOVAL PERMIT ISSUED BY CITY FORESTRY. ANY STREET TREE REMOVALS REQUESTED AFTER THE DEVELOPMENT PLAN IS APPROVED BY THE PLAN COMMISSION OR THE BOARD OF PUBLIC WORKS AND CITY FORESTRY WILL REQUIRE A MINIMUM OF A 72-HOUR REVIEW PERIOD WHICH SHALL INCLUDE THE NOTIFICATION OF THE ALDERPERSON WITHIN WHO'S DISTRICT IS AFFECTED BY THE STREET TREE REMOVAL(S) PRIOR TO A TREE REMOVAL PERMIT BEING ISSUED.

5. AS DEFINED BY THE SECTION 107.13 OF CITY OF MADISON STANDARD SPECIFICATIONS FOR PUBLIC WORKS CONSTRUCTION: NO EXCAVATION IS PERMITTED WITHIN 5 FEET OF THE TRUNK OF THE STREET TREE OR WHEN CUTTING ROOTS OVER 3 INCHES IN DIAMETER. IF EXCAVATION IS NECESSARY, THE CONTRACTOR SHALL CONTACT MADISON CITY FORESTRY (266-4816) PRIOR TO EXCAVATION. CITY OF MADISON FORESTRY PERSONNEL SHALL ASSESS THE IMPACT TO THE TREE AND TO ITS ROOT SYSTEM PRIOR TO WORK COMMENCING. TREE PROTECTION SPECIFICATIONS CAN BE FOUND ON THE FOLLOWING WEBSITE: CITYOFMADISON.COM/BUSINESS/PW/SPECS.CFM

6. CONTRACTOR SHALL TAKE PRECAUTIONS DURING CONSTRUCTION TO NOT DISFIGURE, SCAR, OR IMPAIR THE HEALTH OF ANY STREET TREE. CONTRACTOR SHALL OPERATE EQUIPMENT IN A MANNER AS TO NOT DAMAGE THE BRANCHES OF THE STREET TREE(S). THIS MAY REQUIRE USING SMALLER EQUIPMENT AND LOADING AND UNLOADING MATERIALS IN A DESIGNATED SPACE AWAY FROM TREES ON THE CONSTRUCTION SITE. ANY DAMAGE OR INJURY TO EXISTING STREET TREES (EITHER ABOVE OR BELOW GROUND) SHALL BE REPORTED IMMEDIATELY TO CITY FORESTRY AT 266-4816. PENALTIES AND REMEDIATION SHALL BE REQUIRED.

7. SECTION 107.13(G) OF CITY OF MADISON STANDARD SPECIFICATIONS FOR PUBLIC WORKS CONSTRUCTION ADDRESSES SOIL COMPACTION NEAR STREET TREES AND SHALL BE FOLLOWED BY CONTRACTOR. THE STORAGE OF PARKED VEHICLES, CONSTRUCTION EQUIPMENT, BUILDING MATERIALS, REFUSE, EXCAVATED SPOILS OR DUMPING OF POISONOUS MATERIALS ON OR AROUND TREES AND ROOTS WITHIN FIVE (5) FEET OF THE TREE OR WITHIN THE PROTECTION ZONE IS PROHIBITED.


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9. STREET TREE PRUNING SHALL BE COORDINATED WITH MADISON FORESTRY AT A MINIMUM OF TWO WEEKS PRIOR TO THE START OF CONSTRUCTION FOR THIS PROJECT. ALL PRUNING SHALL FOLLOW THE AMERICAN NATIONAL STANDARDS INSTITUTE (ANSI) A300 - PART I STANDARDS FOR PRUNING.

10. AT LEAST ONE WEEK PRIOR TO STREET TREE PLANTING, CONTRACTOR SHALL CONTACT CITY FORESTRY AT (608) 266-4816 TO SCHEDULE INSPECTION AND APPROVAL OF NURSERY TREE STOCK AND REVIEW PLANTING SPECIFICATIONS WITH THE LANDSCAPER.

11. APPROVAL OF PLANS FOR THIS PROJECT DOES NOT INCLUDE ANY APPROVAL TO PRUNE, REMOVE, OR PLANT TREES IN THE PUBLIC RIGHT-OF-WAY. PERMISSION FOR SUCH ACTIVITIES MUST BE OBTAINED FROM THE CITY FORESTER (266-4816).

12. THE PUBLIC RIGHT-OF-WAY IS THE SOLE JURISDICTION OF THE CITY OF MADISON AND IS SUBJECT TO CHANGE AT ANY TIME. NO ITEMS SHOWN ON THIS SITE PLAN IN THE RIGHT-OF-WAY ARE PERMANENT AND MAY NEED TO BE REMOVED AT THE APPLICANTS EXPENSE UPON NOTIFICATION BY THE CITY.

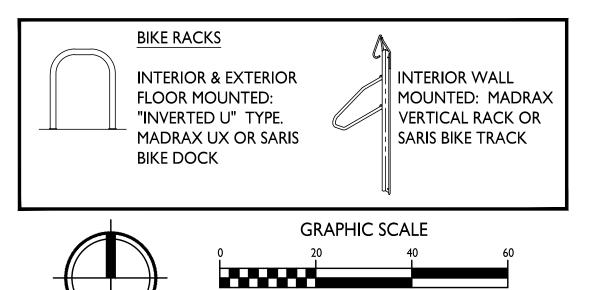

I INCH = 20 FT (24X36 SHEET)

Issued for LUA & UDC Submittals - February 27, 2023

ISSUED

PROJECT TITLE CASCADE -THE AMERICAN CENTER EASTPARK FIFTH ADDITION

4846 Eastpark Blvd. Madison, WI SHEET TITLE Site Plan



SHEET NUMBER

PROJECT NO.



### 2155 © Knothe & Bruce Architects, LLC



<b>Site Development Data:</b> Zoning Densities:	TR-U2	
Lot Area	134,349 S.F./3.08 AC	DEC
Dwelling Units	134 units	.NE3
Lot Area / D.U.	1,003 S.F./D.U.	
Density	43.5 units/Acre	
Density	PROVIDED	ZONING REQUIREMENTS
Lot Coverage	79,200 S.F. (59%)	75% Max.
Building Height	4 stories/54'-0"	4 Stories/52' Max.
Gross Building Area	199,967 S.F.	
Gross Building / Irea	177,707 5.1.	
Dwelling Unit Mix:		
Studio	24	
One Bedroom	54	
One Bedroom + Den	8	
Two Bedroom	48	
Total Dwelling Units	134	
Vehicle Parking Stalls:		
Underground Garage	135	
Surface	78	
Total	213	
Electric Vehicle Parking Stalls:		
EV Installed	3	3 - Min. 2% of Residential Stalls
EV Ready	14	14 - Min. 10% of Residential Stalls
Total	17	17 - Min. EV Required
Bicycle Parking:		
Long-Term Covered Garage	134	134 - Min. 100% of Req'd
(98 F.M. & 36 V	V.M.)	,
Short-Term Guest - Surface	16	14 - Min. 10% of Units
Total	150	148 - Min. Bike Stalls Required



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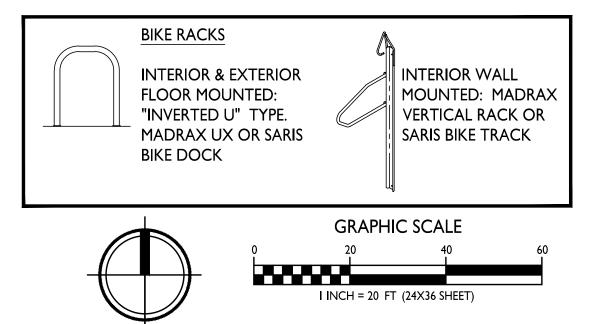
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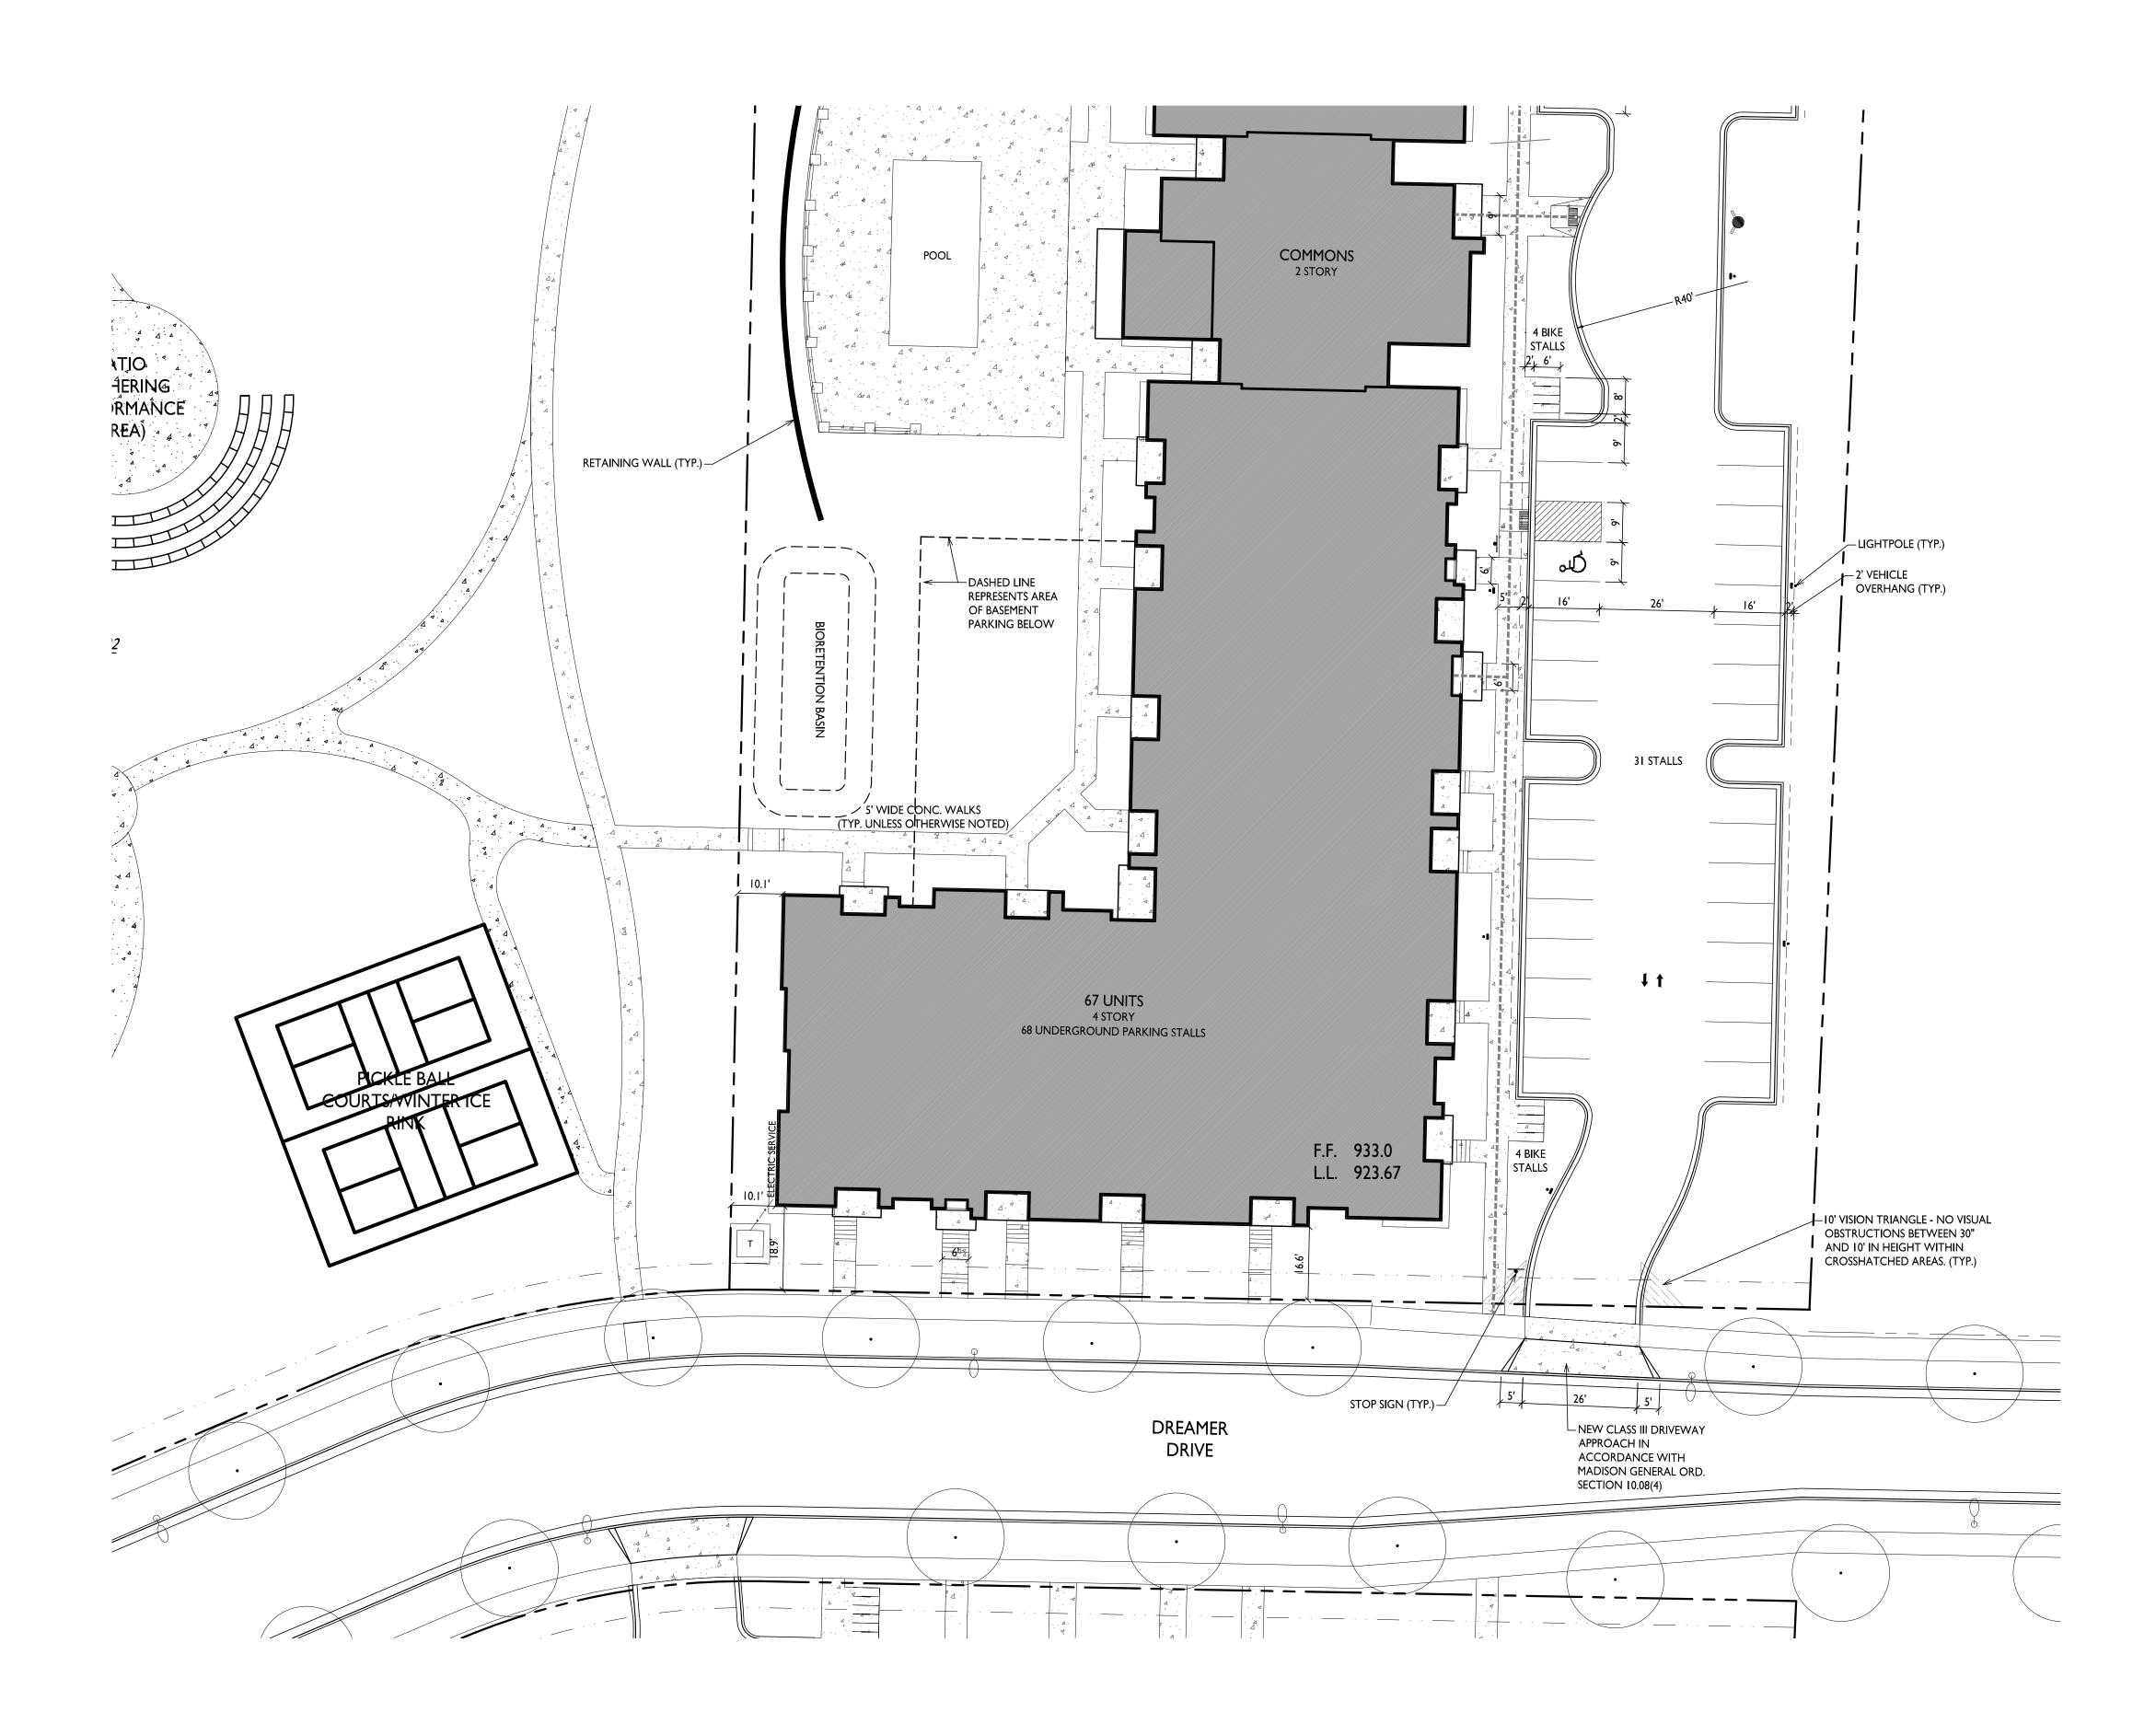
4846 Eastpark Blvd. Madison, WI SHEET TITLE Partial Site Plan -North




C-1.2

PROJECT NO.

2155 © Knothe & Bruce Architects, LLC



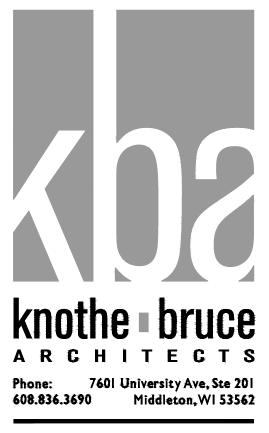

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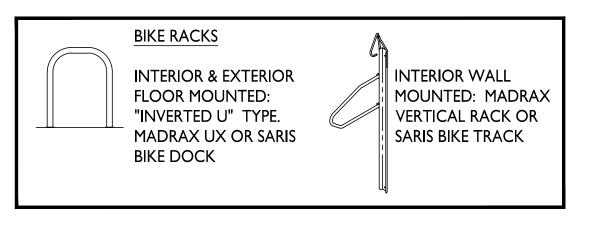
8. ON THIS PROJECT, STREET TREE PROTECTION ZONE FENCING IS REQUIRED. THE FENCING SHALL BE ERECTED BEFORE THE DEMOLITION, GRADING OR CONSTRUCTION BEGINS. THE FENCE SHALL INCLUDE THE ENTIRE WIDTH OF TERRACE AND, EXTEND AT LEAST 5 FEET ON BOTH SIDES OF THE OUTSIDE EDGE OF THE TREE TRUNK. DO NOT REMOVE THE FENCING TO ALLOW FOR DELIVERIES OR EQUIPMENT ACCESS THROUGH THE TREE PROTECTION ZONE.


9. STREET TREE PRUNING SHALL BE COORDINATED WITH MADISON FORESTRY AT A MINIMUM OF TWO WEEKS PRIOR TO THE START OF CONSTRUCTION FOR THIS PROJECT. ALL PRUNING SHALL FOLLOW THE AMERICAN NATIONAL STANDARDS INSTITUTE (ANSI) A300 - PART I STANDARDS FOR PRUNING.

10. AT LEAST ONE WEEK PRIOR TO STREET TREE PLANTING, CONTRACTOR SHALL CONTACT CITY FORESTRY AT (608) 266-4816 TO SCHEDULE INSPECTION AND APPROVAL OF NURSERY TREE STOCK AND REVIEW PLANTING SPECIFICATIONS WITH THE LANDSCAPER.

II. APPROVAL OF PLANS FOR THIS PROJECT DOES NOT INCLUDE ANY APPROVAL TO PRUNE, REMOVE, OR PLANT TREES IN THE PUBLIC RIGHT-OF-WAY. PERMISSION FOR SUCH ACTIVITIES MUST BE OBTAINED FROM THE CITY FORESTER (266-4816).

12. THE PUBLIC RIGHT-OF-WAY IS THE SOLE JURISDICTION OF THE CITY OF MADISON AND IS SUBJECT TO CHANGE AT ANY TIME. NO ITEMS SHOWN ON THIS SITE PLAN IN THE RIGHT-OF-WAY ARE PERMANENT AND MAY NEED TO BE REMOVED AT THE APPLICANTS EXPENSE UPON NOTIFICATION BY THE CITY.



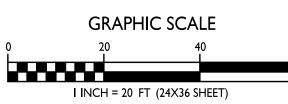

Issued for LUA & UDC Submittals - February 27, 2023

ISSUED

## PROJECT TITLE CASCADE -THE AMERICAN CENTER EASTPARK FIFTH ADDITION


4846 Eastpark Blvd. Madison, WI SHEET TITLE Partial Site Plan -South

# Lot 50

SHEET NUMBER

C-1.3

PROJECT NO. 2155 © Knothe & Bruce Architects, LLC

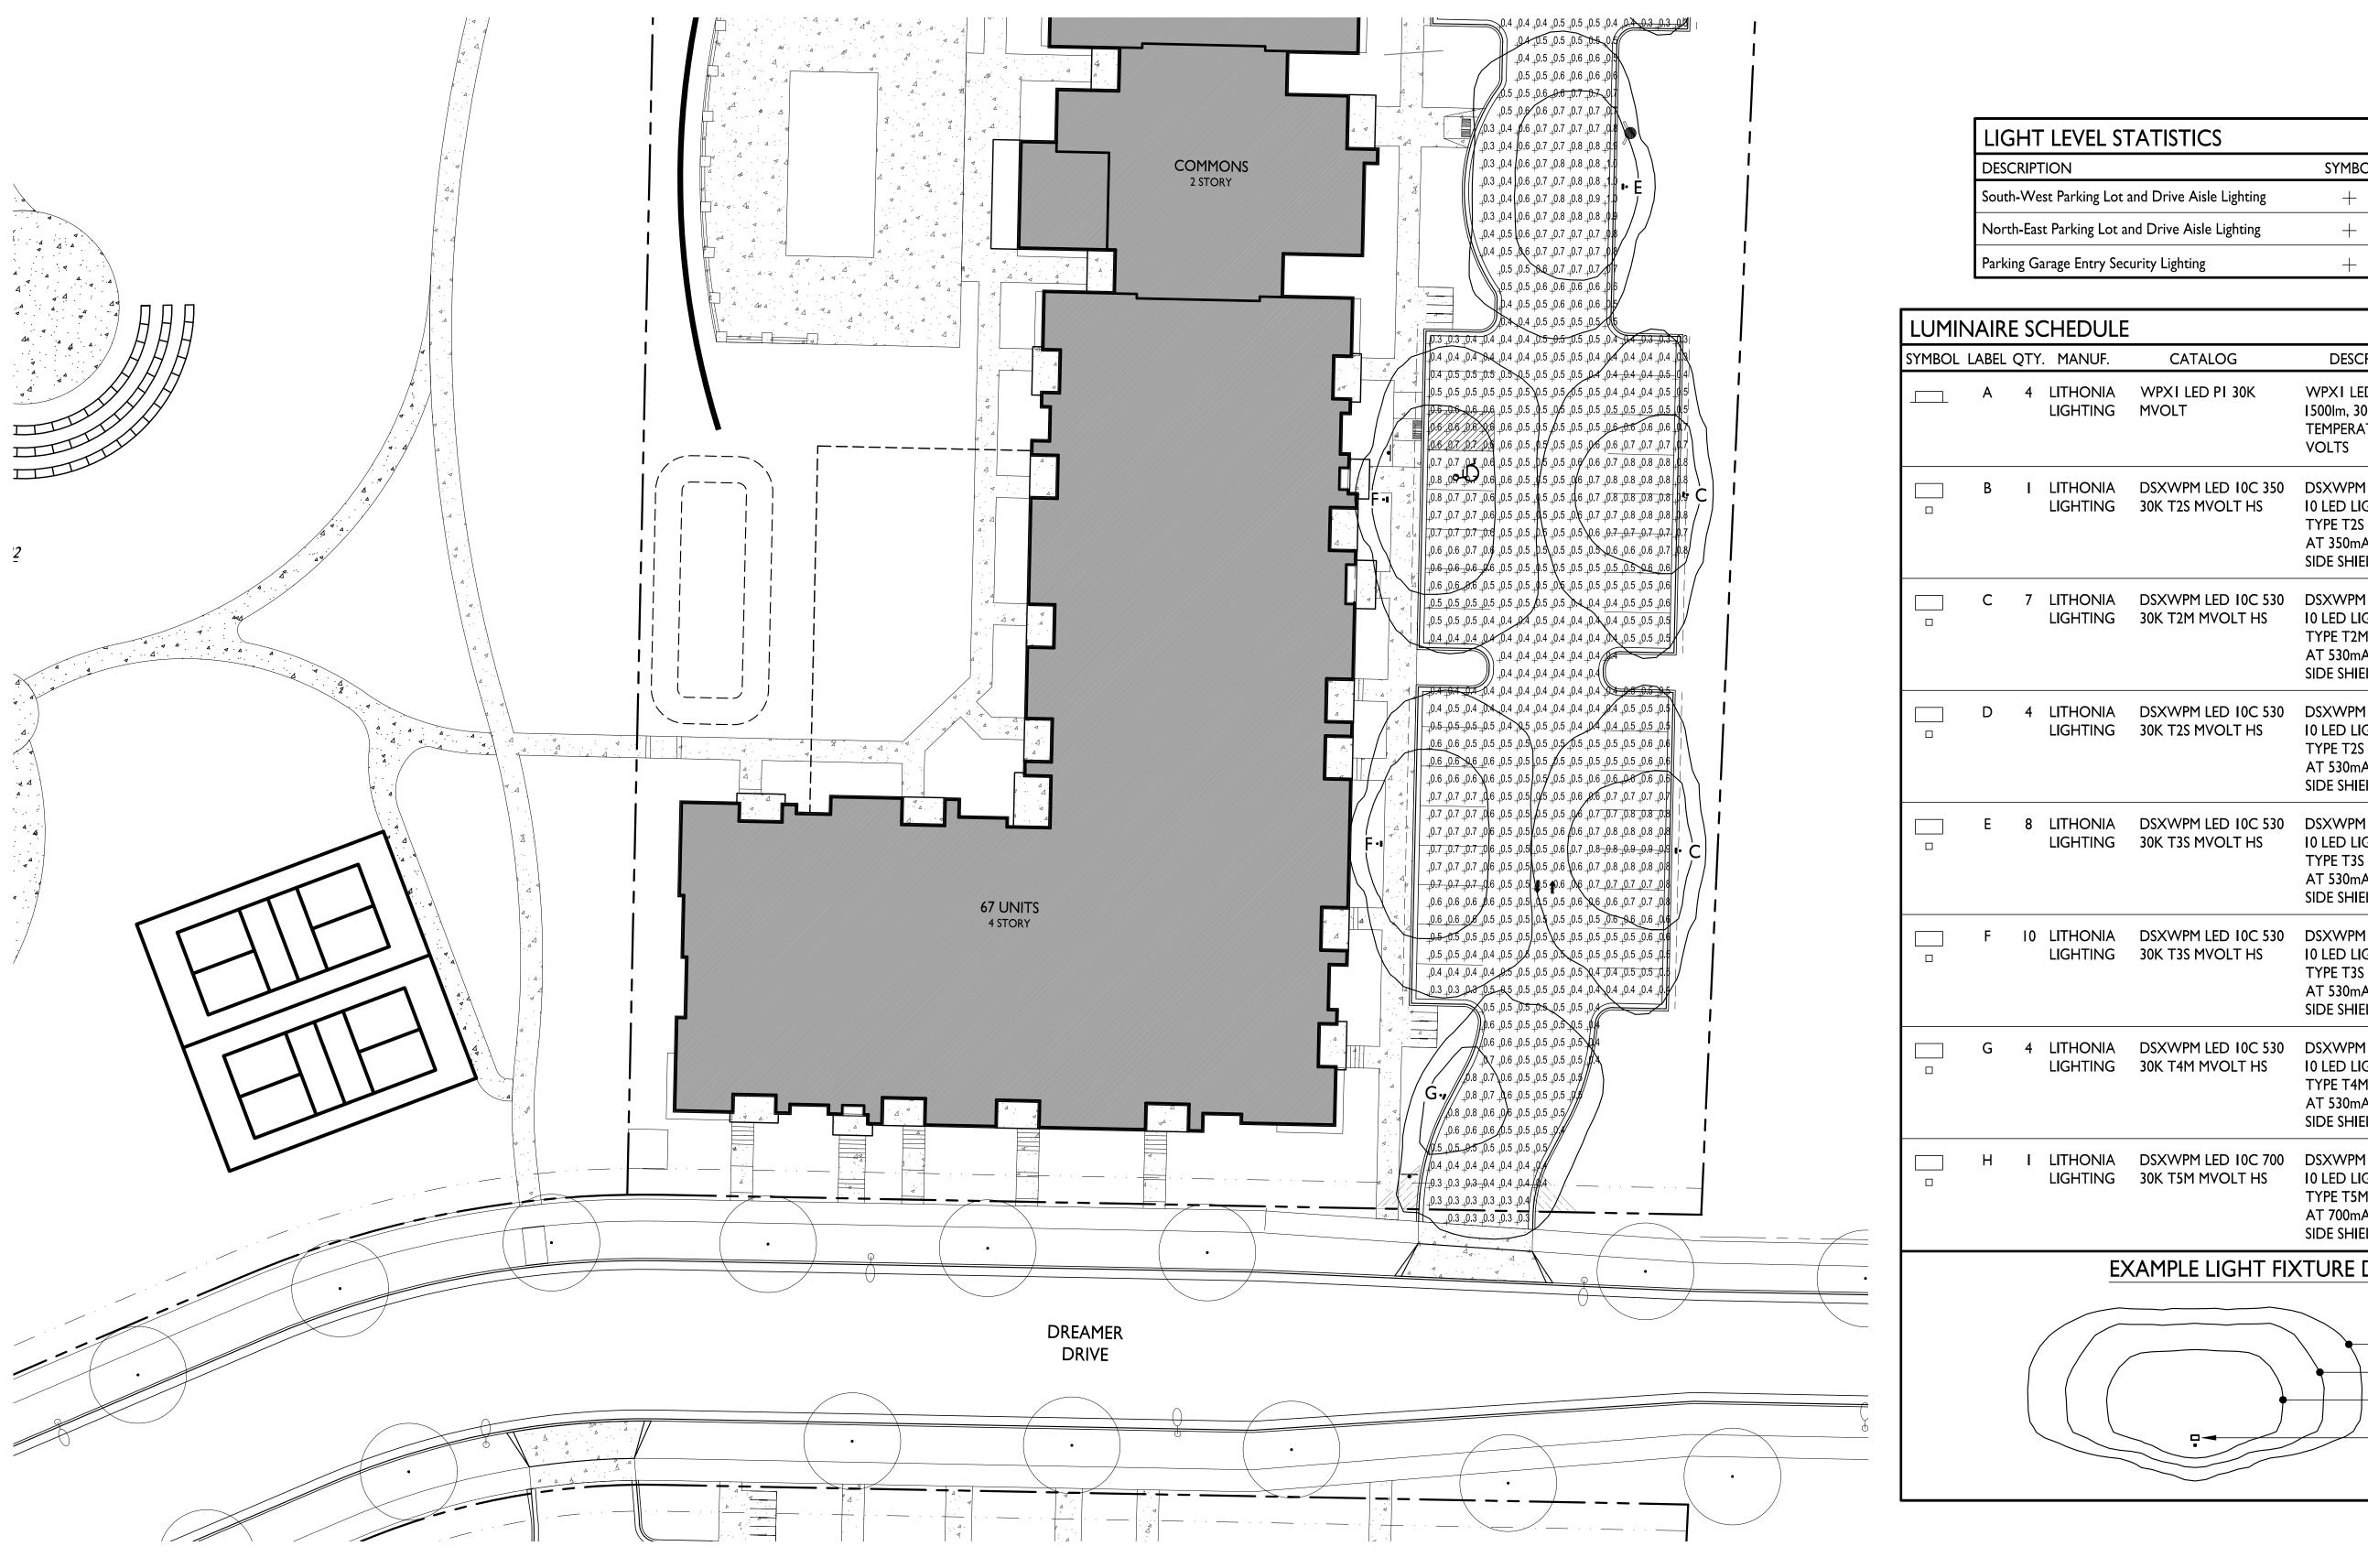

VLL STATISTICS						
	SYMBOL	AVG.	MAX.	MIN.	MAX. / MIN.	AVG. / MIN.
king Lot and Drive Aisle Lighting	+	0.7 fc	6.4 fc	0.2 fc	32.0:I	3.5:I
ing Lot and Drive Aisle Lighting	+	0.6 fc	6.3 fc	0.2 fc	31.5:1	3.0:I
Entry Security Lighting	+	2.4 fc	5.7 fc	0.5 fc	11.4:1	4.8:I

DULE				
NUF.	CATALOG	DESCRIPTION	FILE	MOUNTING
IONIA ITING	WPXI LED PI 30K MVOLT	WPXI LED WALLPACK, I500lm, 3000K COLOR TEMPERATURE, I20-277 VOLTS	WPX1_LED_P1 _30K_MVOLT.ies	8'-0" ABOVE GRADE ON BUILDING
IONIA ITING	DSXWPM LED IOC 350 30K T2S MVOLT HS	DSXWPM LED WITH (I) I0 LED LIGHT ENGINE, TYPE T2S OPTIC, 3000K AT 350mA, WITH HOUSE SIDE SHIELD	DSXWPM_LED_10C _350_30K_T2S _MVOLT_HS.ies	16'-0" POLE ON 2'-0" TALL CONC. BASE
IONIA HTING	DSXWPM LED IOC 530 30K T2M MVOLT HS	DSXWPM LED WITH (I) I0 LED LIGHT ENGINE, TYPE T2M OPTIC, 3000K AT 530mA, WITH HOUSE SIDE SHIELD	DSXWPM_LED_10C _530_30K_T2M _MVOLT_HS.ies	16'-0" POLE ON 2'-0" TALL CONC. BASE
IONIA ITING	DSXWPM LED IOC 530 30K T2S MVOLT HS	DSXWPM LED WITH (I) I0 LED LIGHT ENGINE, TYPE T2S OPTIC, 3000K AT 530mA, WITH HOUSE SIDE SHIELD	DSXWPM_LED_10C _530_30K_T2S _MVOLT_HS.ies	16'-0" POLE ON 2'-0" TALL CONC. BASE
IONIA ITING	DSXWPM LED IOC 530 30K T3S MVOLT HS	DSXWPM LED WITH (I) I0 LED LIGHT ENGINE, TYPE T3S OPTIC, 3000K AT 530mA, WITH HOUSE SIDE SHIELD	DSXWPM_LED_10C _530_30K_T3S _MVOLT_HS.ies	16'-0" POLE ON 2'-0" TALL CONC. BASE
IONIA HTING	DSXWPM LED IOC 530 30K T3S MVOLT HS	DSXWPM LED WITH (I) I0 LED LIGHT ENGINE, TYPE T3S OPTIC, 3000K AT 530mA, WITH HOUSE SIDE SHIELD	DSXWPM_LED_10C _530_30K_T3S _MVOLT_HS.ies	18'-0" POLE ON FLUSH CONC. BASE
IONIA HTING	DSXWPM LED IOC 530 30K T4M MVOLT HS	DSXWPM LED WITH (I) I0 LED LIGHT ENGINE, TYPE T4M OPTIC, 3000K AT 530mA, WITH HOUSE SIDE SHIELD	DSXWPM_LED_10C _530_30K_T4M _MVOLT_HS.ies	16'-0" POLE ON 2'-0" TALL CONC. BASE
IONIA HTING	DSXWPM LED IOC 700 30K T5M MVOLT HS	DSXWPM LED WITH (I) I0 LED LIGHT ENGINE, TYPE T5M OPTIC, 3000K AT 700mA, WITH HOUSE SIDE SHIELD	DSXWPM_LED_10C _700_30K_T5M _MVOLT_HS.ies	16'-0" POLE ON 2'-0" TALL CONC. BASE

## EXAMPLE LIGHT FIXTURE DISTRIBUTION

ISOLUX CONTOUR = 0.25 FC ISOLUX CONTOUR = 0.5 FC ISOLUX CONTOUR = 1.0 FC LIGHT FIXTURE

knothe • bruce ARCHITECTS 
 Phone:
 7601
 University Ave, Ste 201

 608.836.3690
 Middleton, WI 53562

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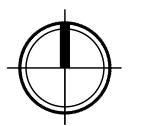
PROJECT TITLE CASCADE -THE AMERICAN CENTER EASTPARK FIFTH ADDITION

4846 Eastpark Blvd. Madison, WI SHEET TITLE Site Lighting Plan -South


Lot 50 SHEET NUMBER

C-2.3

PROJECT NO. 2155 © Knothe & Bruce Architects, LLC



GRAPHIC SCALE I INCH = 20 FT (24X36 SHEET)

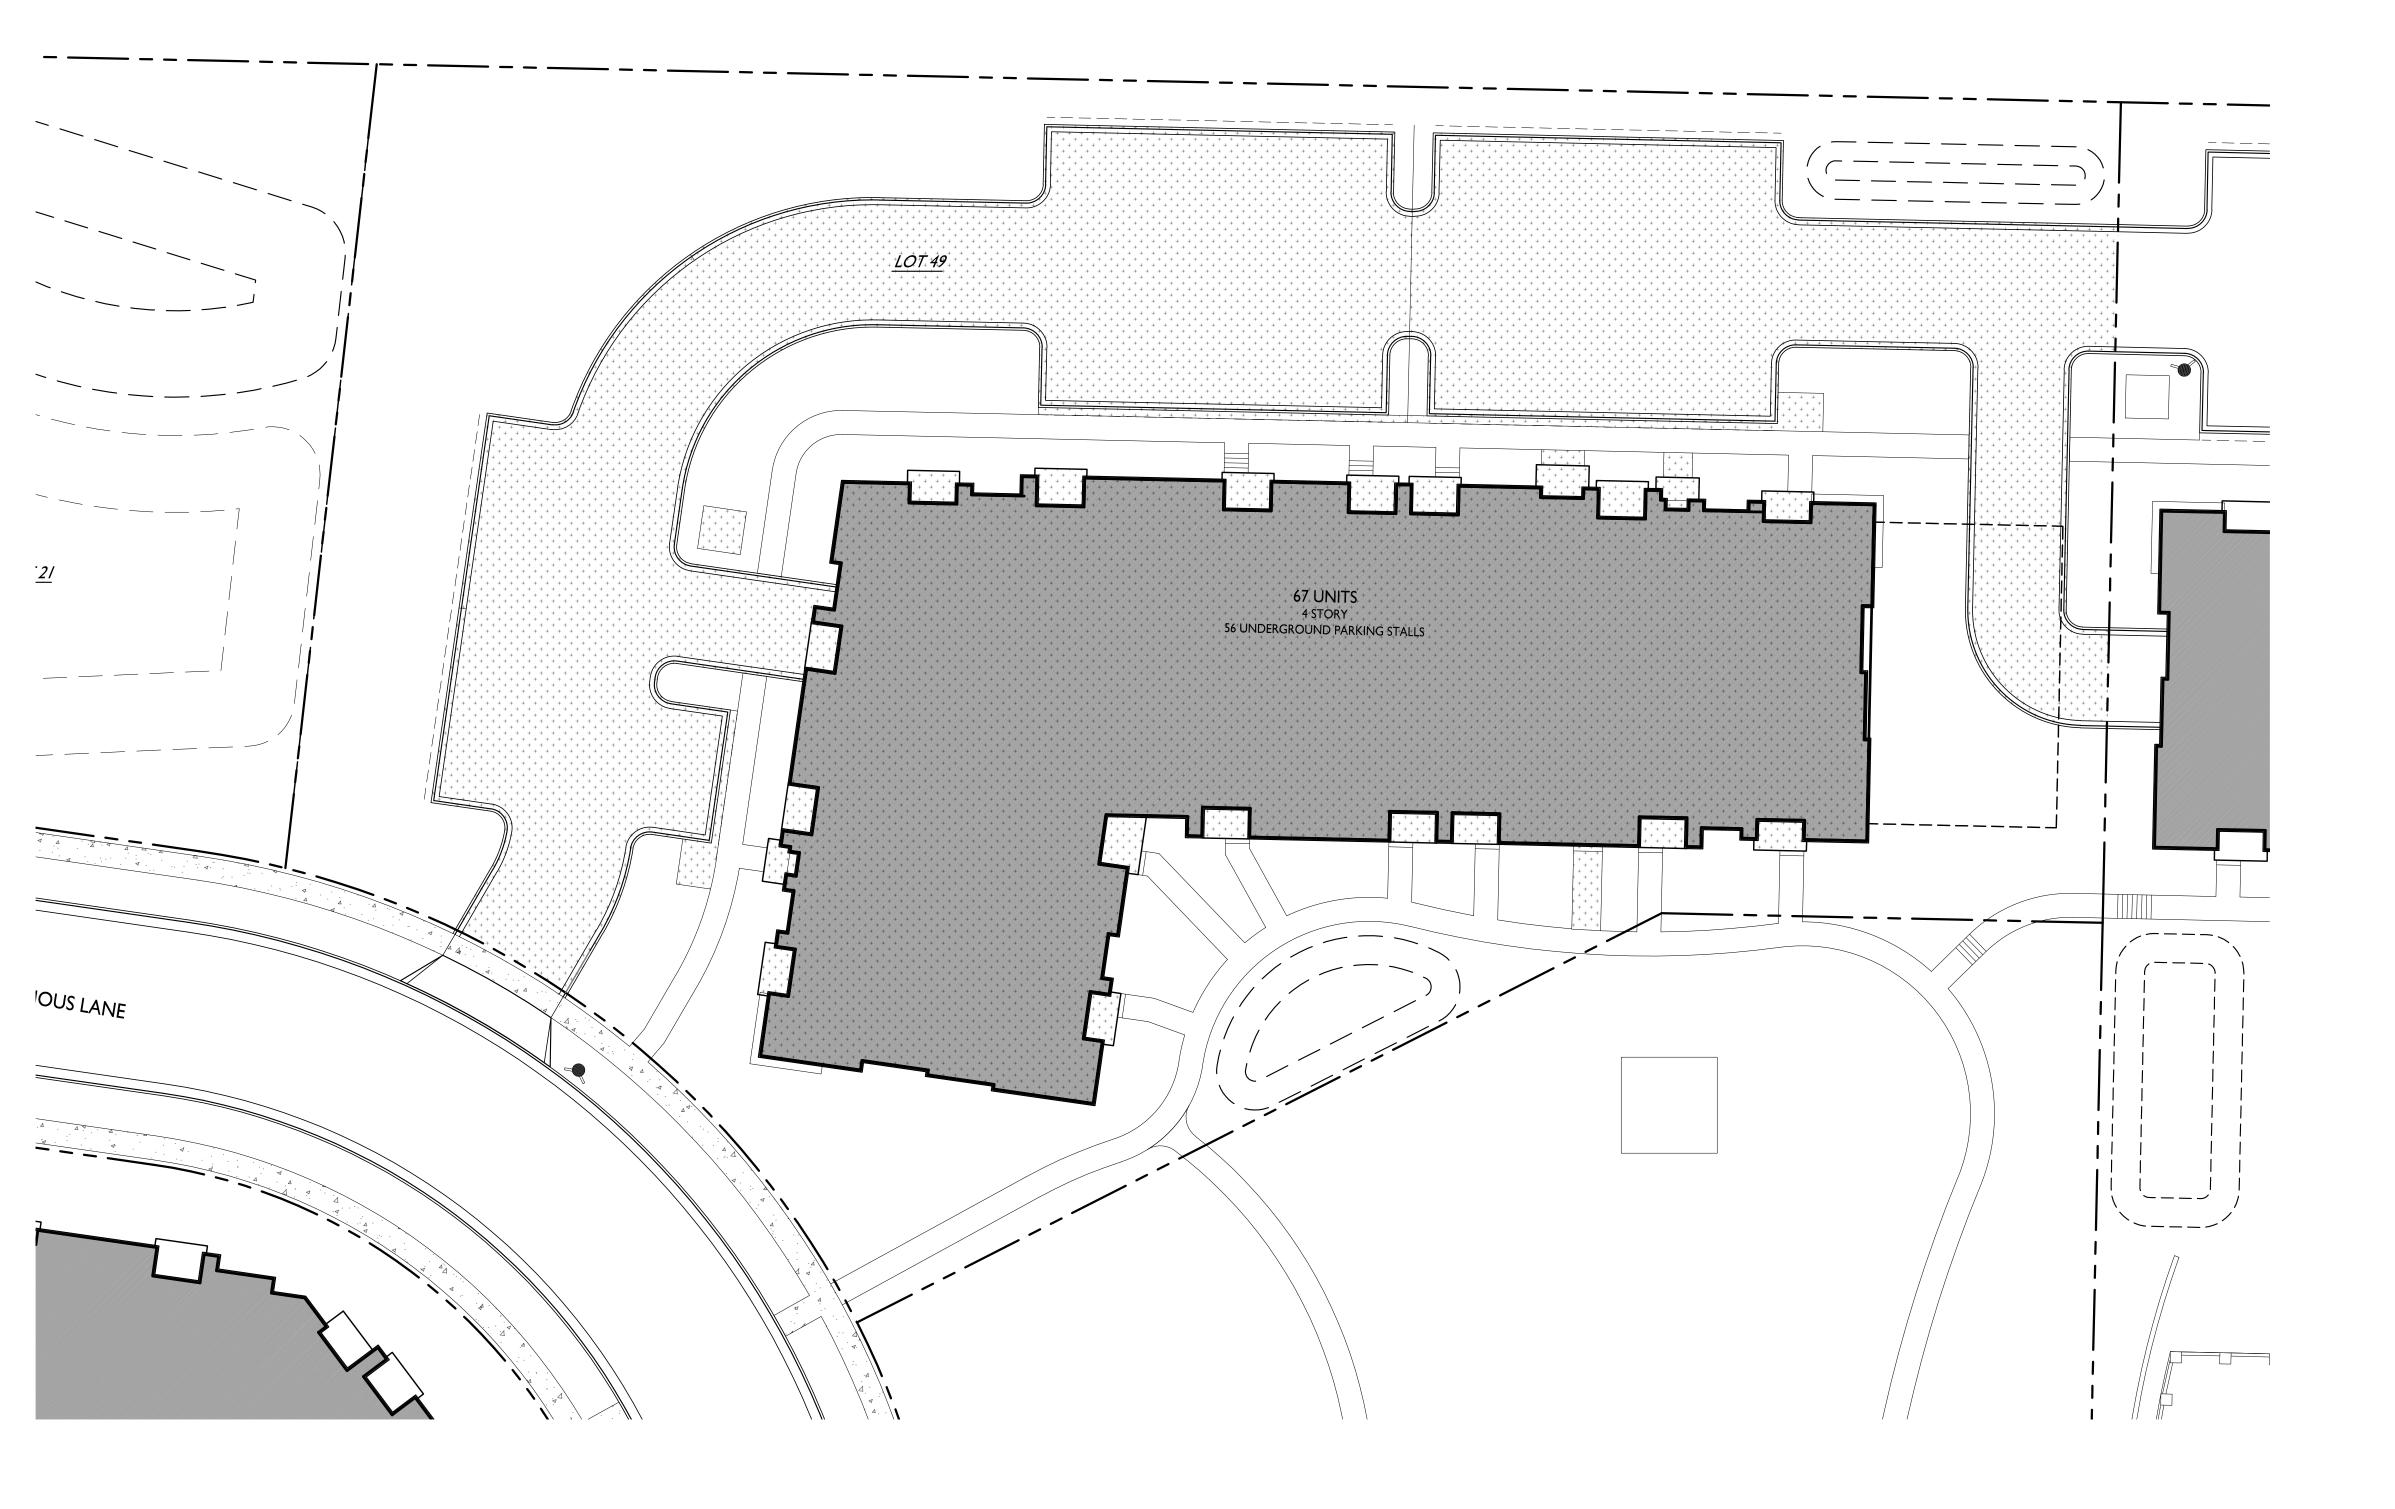


# LOT COVERAGE

ZONING MAXIMUM LOT COVERAGE 80% LOT AREA PROPOSED COVERAGE

74,337 S.F. 40,600 S.F. / 53%

TR-U2

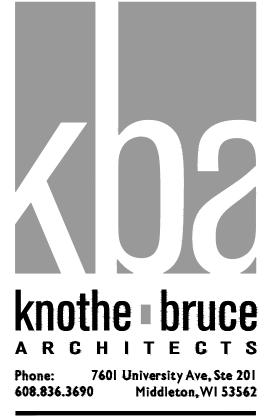

ISSUED Issued for LUA & UDC Submittals - February 27, 2023

# PROJECT TITLE THE AMERICAN CENTER EASTPARK FIFTH ADDITION

4846 Eastpark Blvd. Madison, Wl SHEET TITLE Lot Coverage


Lot 49

Sheet Number


PROJECT NO.

C-3.1

2155 © Knothe & Bruce Architects, LLC

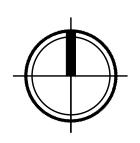

GRAPHIC SCALE I INCH = 20 FT (24X36 SHEET)

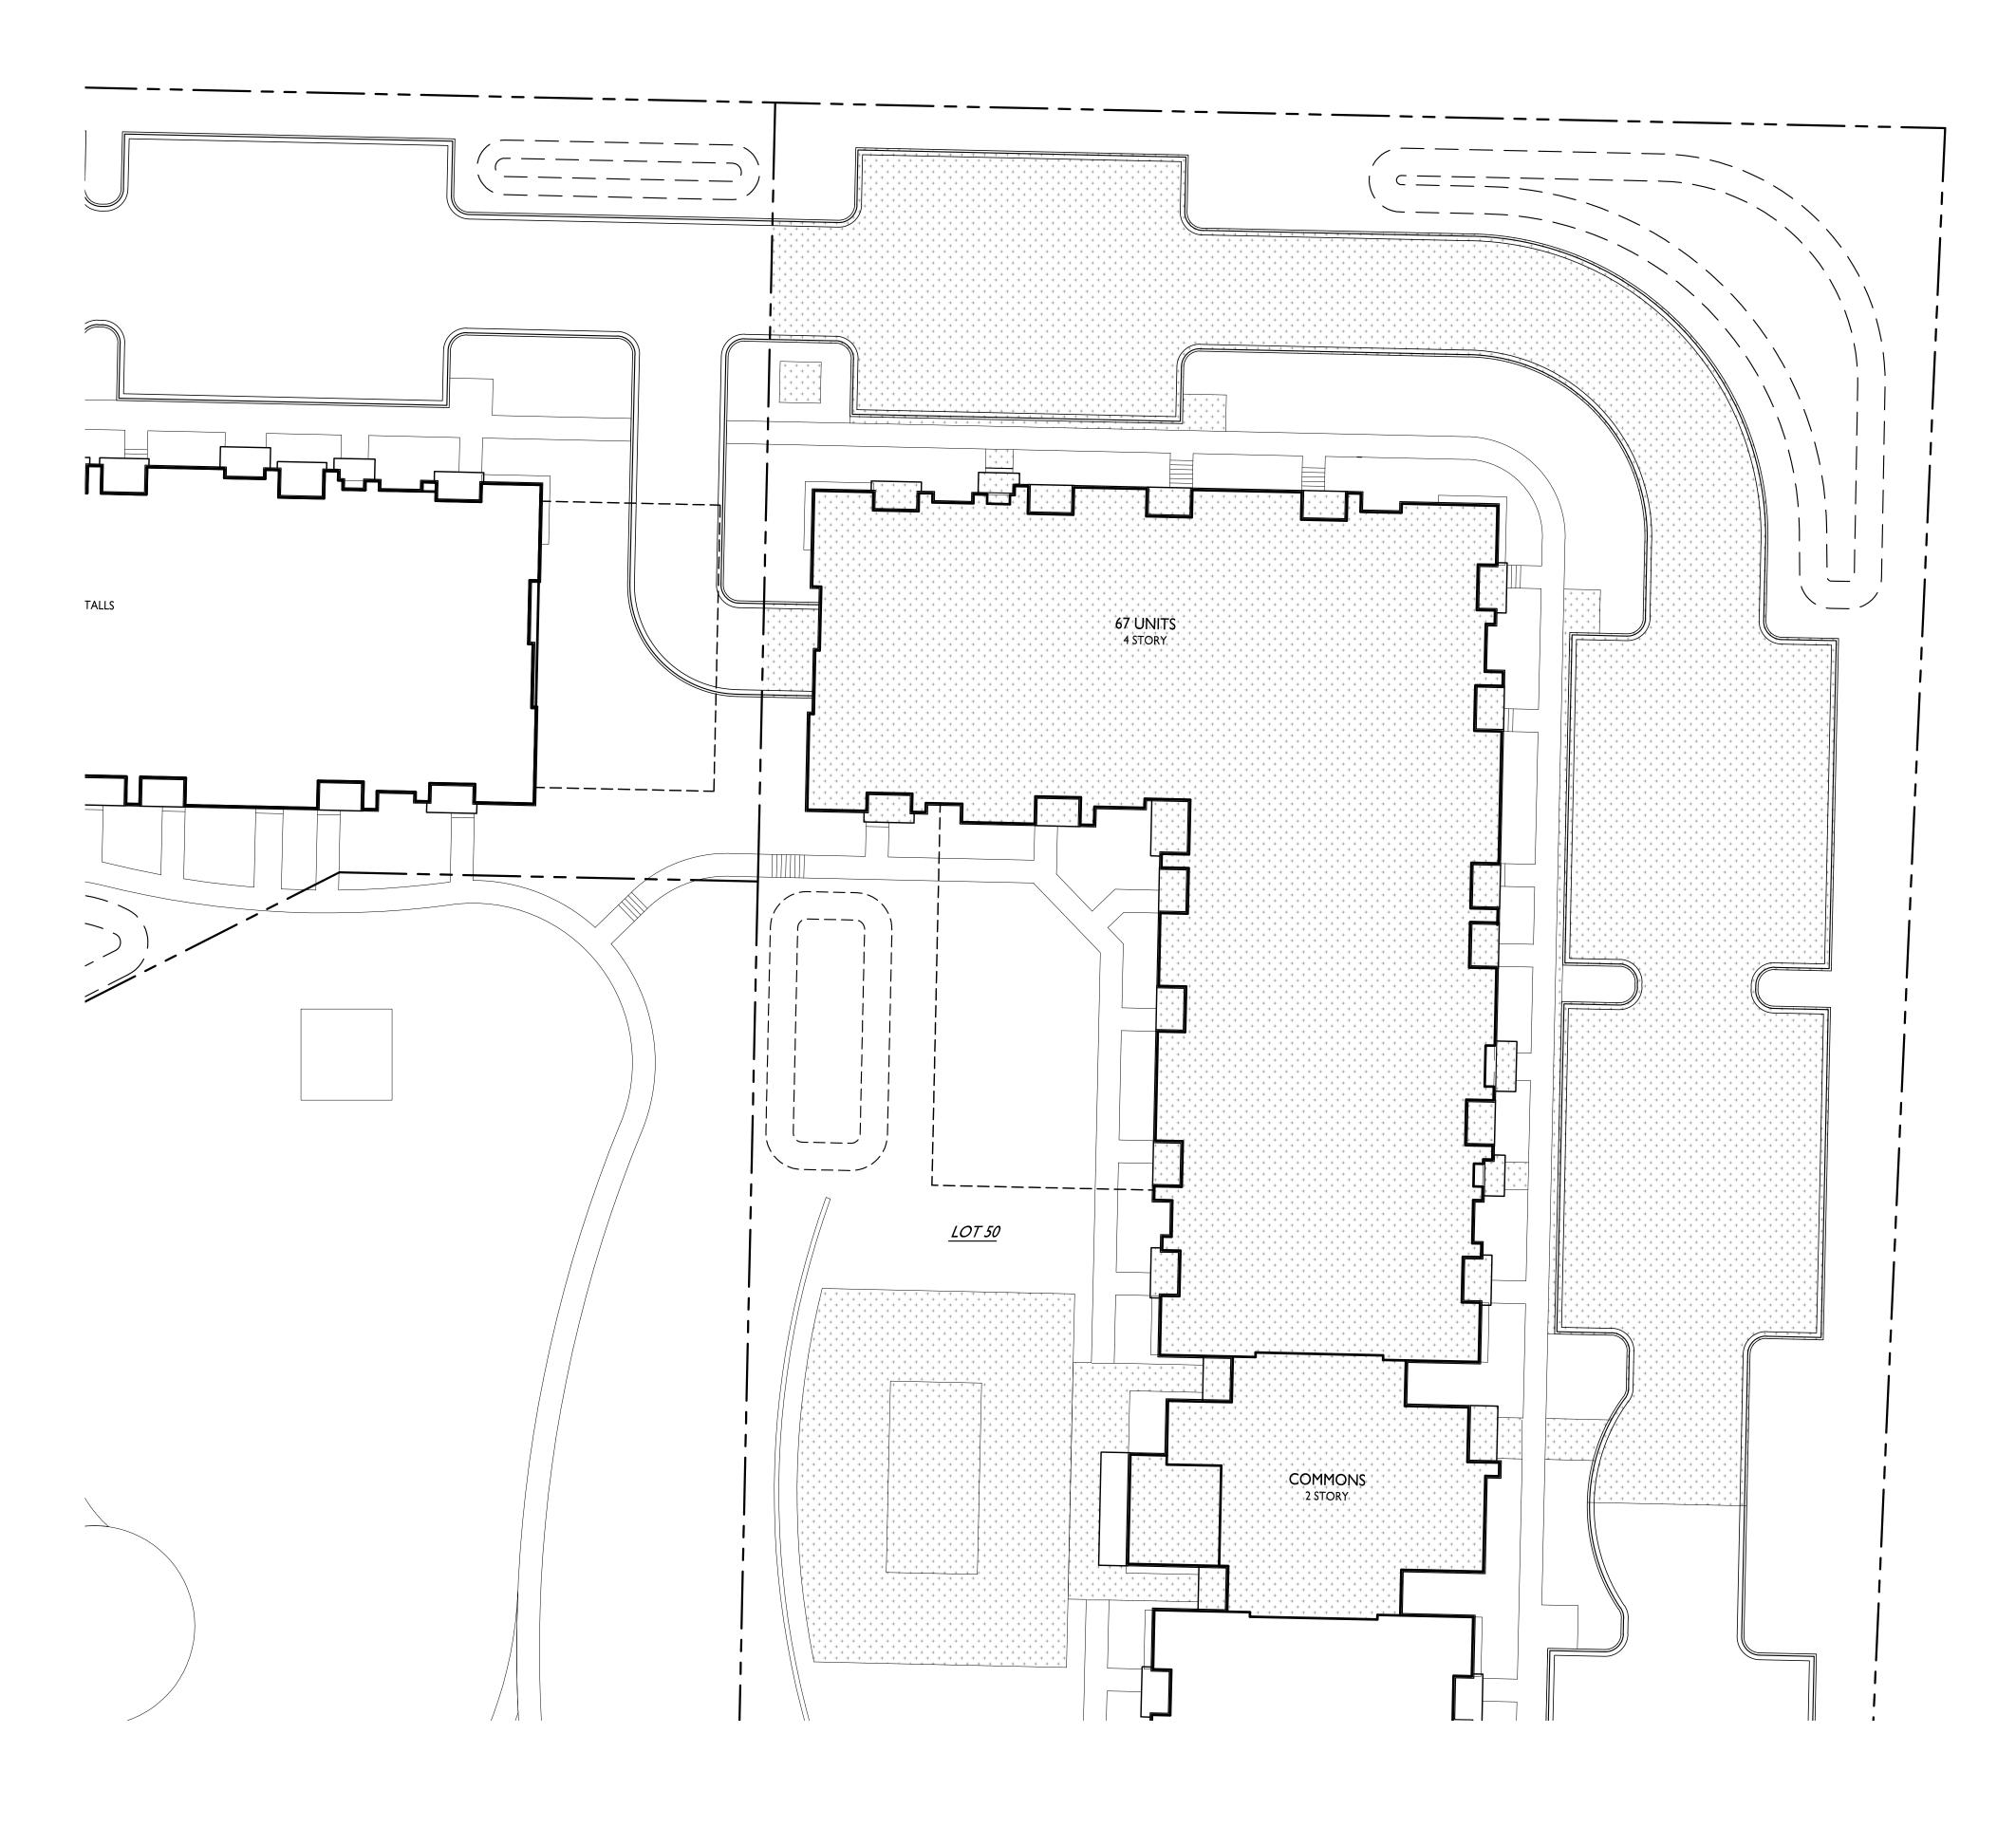


# LOT COVERAGE

ZONING MAXIMUM LOT COVERAGE 80% LOT AREA PROPOSED COVERAGE

134,349 S.F. 79,200 S.F. / 59%

TR-U2

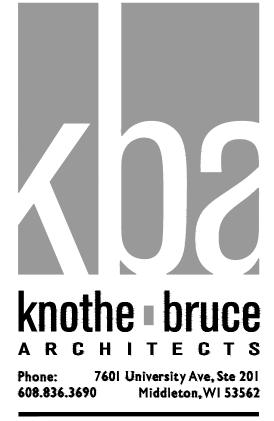

ISSUED Issued for LUA & UDC Submittals - February 27, 2023


# PROJECT TITLE THE AMERICAN CENTER EASTPARK FIFTH ADDITION

4846 Eastpark Blvd. Madison, Wl SHEET TITLE Lot Coverage North




C-3.2


PROJECT NO. 2155 © Knothe & Bruce Architects, LLC

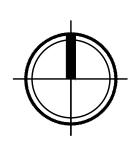

GRAPHIC SCALE I INCH = 20 FT (24X36 SHEET)

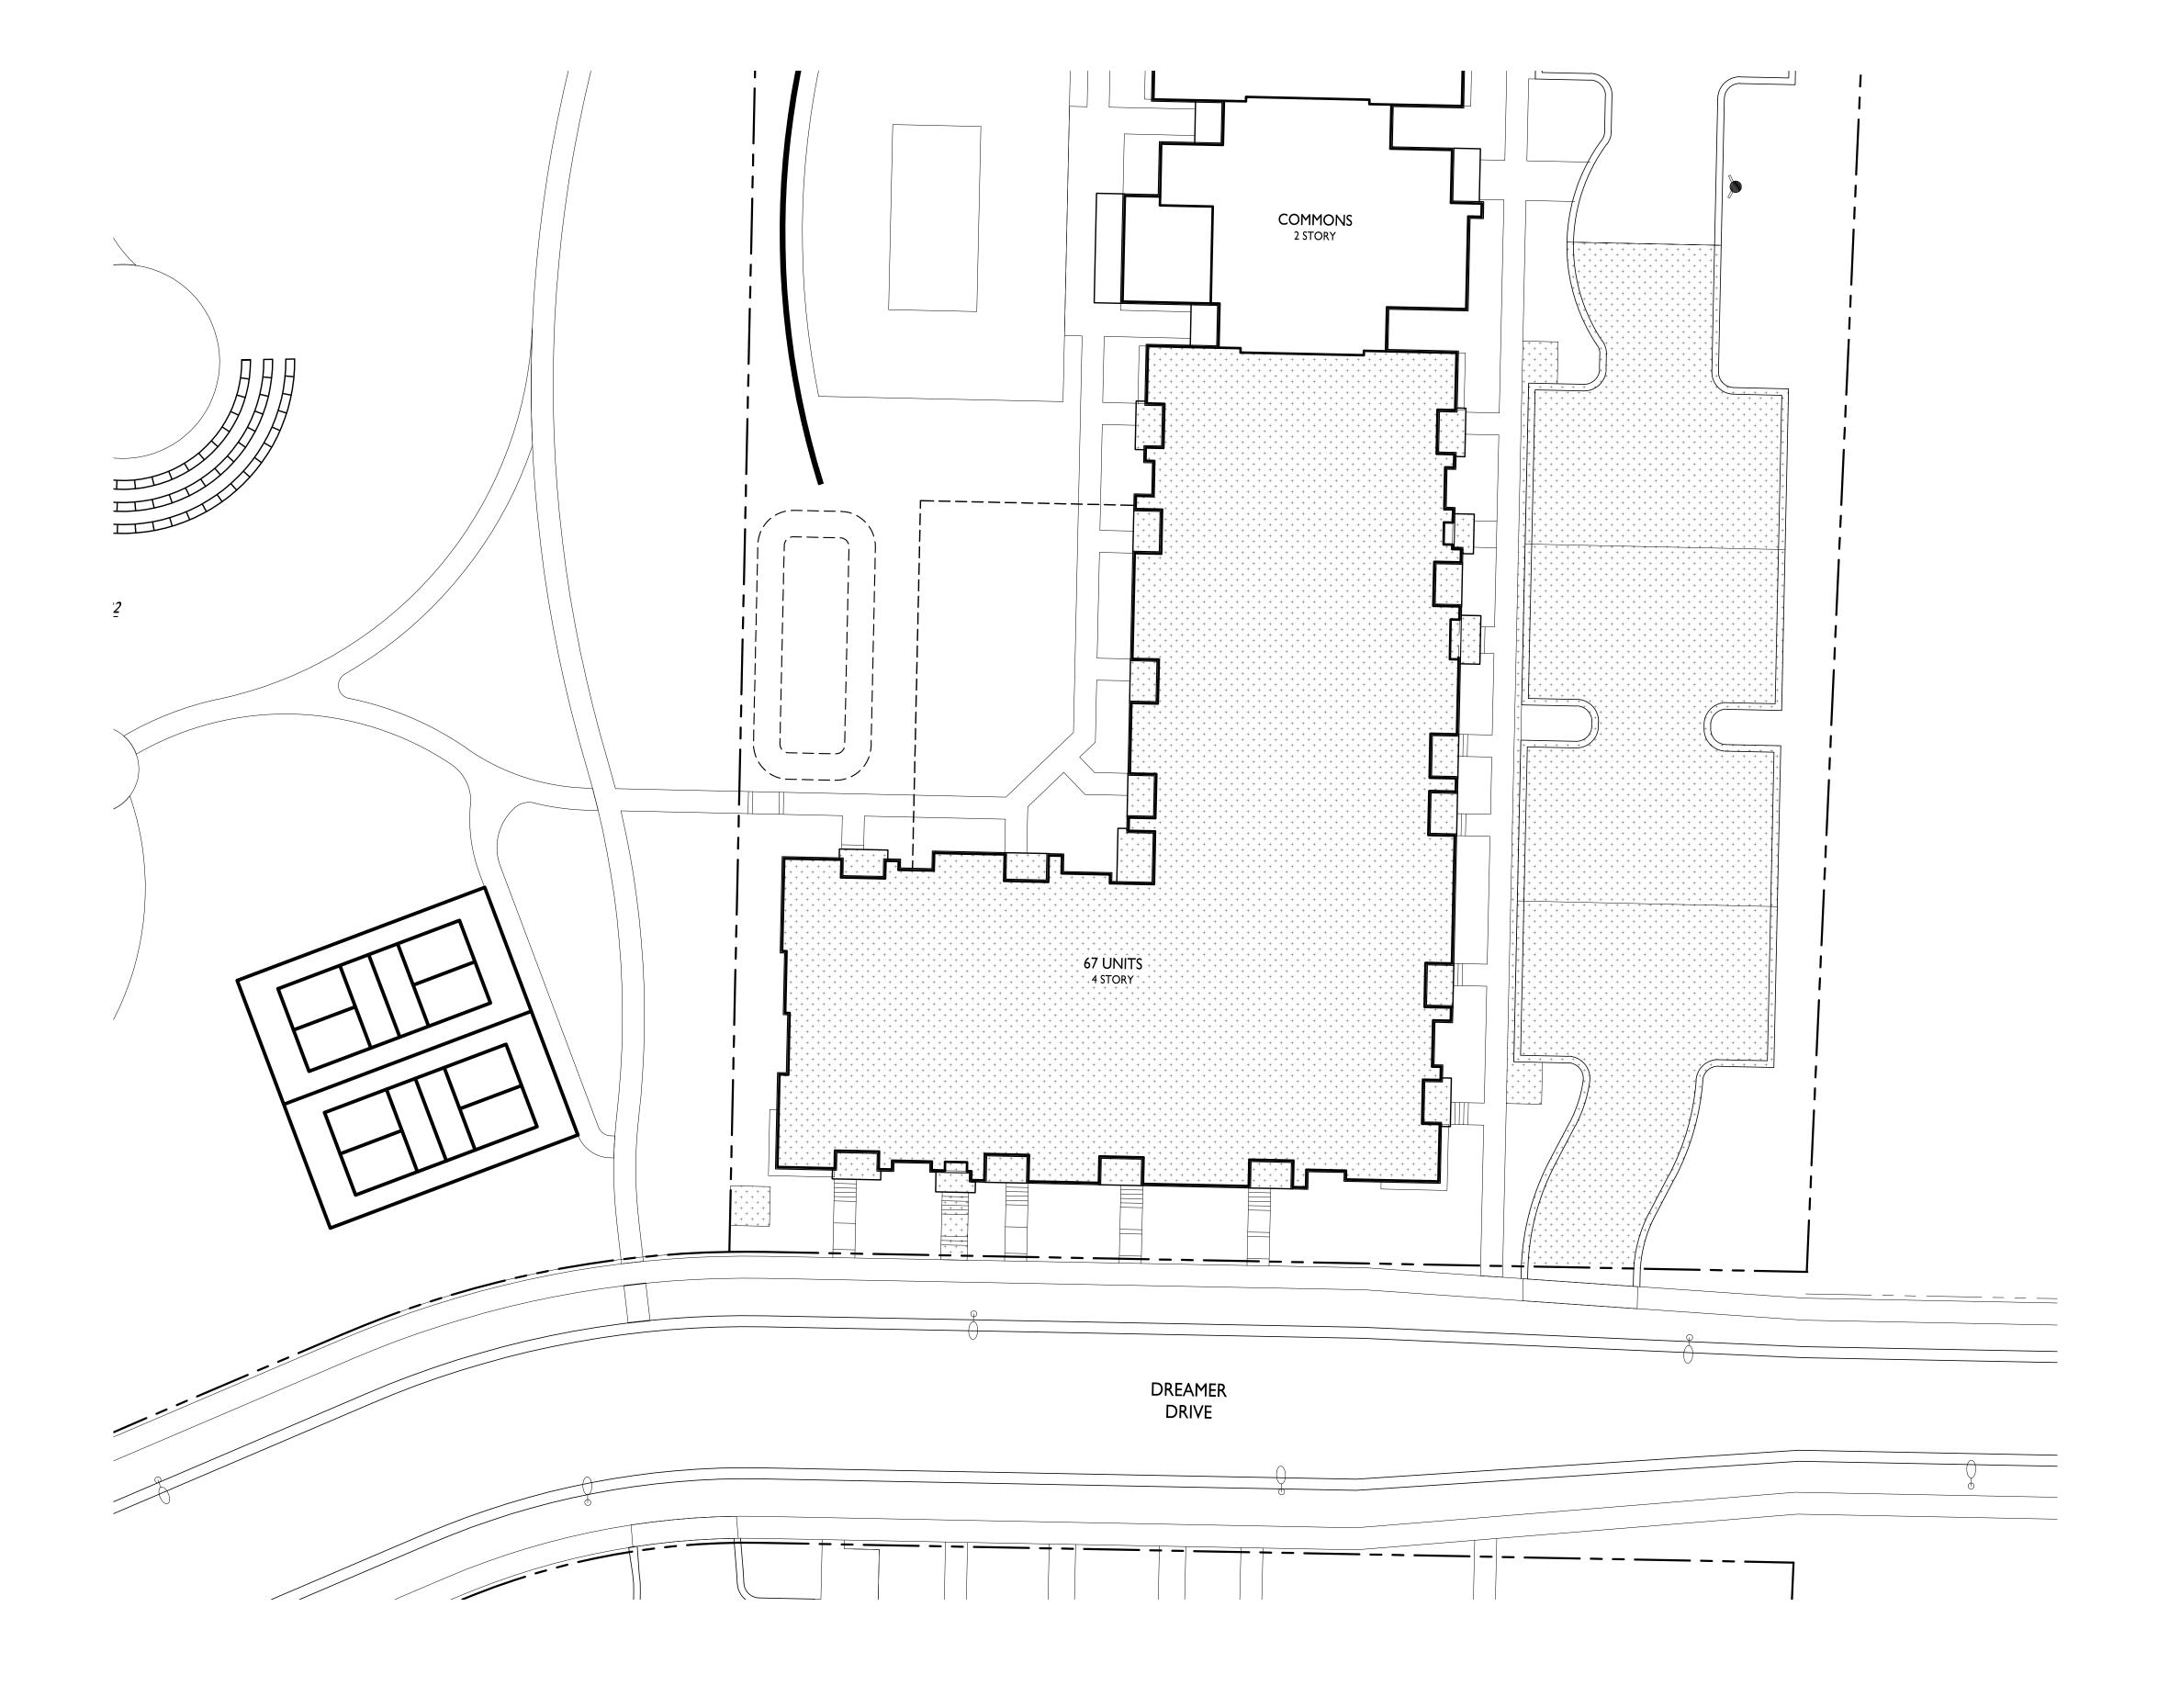

# SEE SHEET C-1.3A FOR LOT COVERAGE DATA

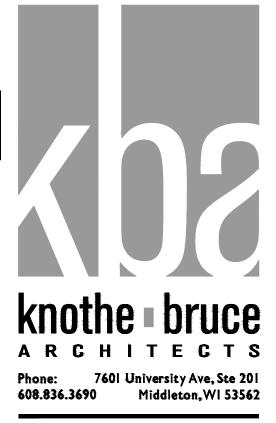

ISSUED Issued for LUA & UDC Submittals - February 27, 2023

## PROJECT TITLE CASCADE -THE AMERICAN CENTER EASTPARK FIFTH ADDITION

4846 Eastpark Blvd. Madison, WI SHEET TITLE Lot Coverage South



C-3.3

	GRAPH	IC SCALE	
0	20	40 I	
	I INCH = 20 F	T (24X36 SHEET)	

PROJECT NO. 2155 © Knothe & Bruce Architects, LLC





THE LOCATION OF EXISTING UTILITIES, BOTH UNDERGROUND AND OVERHEAD ARE APPROXIMATE ONLY AND HAVE NOT BEEN INDEPENDENTLY VERIFIED BY THE OWNER OR ITS REPRESENTATIVE. THE CONTRACTOR SHALL BE RESPONSIBLE FOR DETERMINING THE EXACT LOCATION OF ALL EXISTING UTILITIES WHETHER SHOWN ON THESE PLANS OR NOT, BEFORE COMMENCING WORK, AND SHALL BE FULLY RESPONSIBLE FOR ANY AND ALL DAMAGES WHICH MIGHT BE CAUSED BY THE CONTRACTOR'S FAILURE TO EXACTLY LOCATE AND PRESERVE ANY AND ALL UTILITIES.

> CALL DIGGER'S HOTLINE 1-800-242-8511

## SITE BENCHMARKS



TOP NUT OF HYDRANT ELEV = 910.30

TOP NUT OF HYDRANT

TOP NUT OF HYDRANT

ELEV = 921.17


ELEV = 921.85


2

(4)

TOP NUT OF HYDRANT ELEV = 910.30

# CASCADE - PHASE 1 - SITE IMPROVEMENTS THE AMERICAN CENTER LOTS 49-50 CITY OF MADISON, WISCONSIN

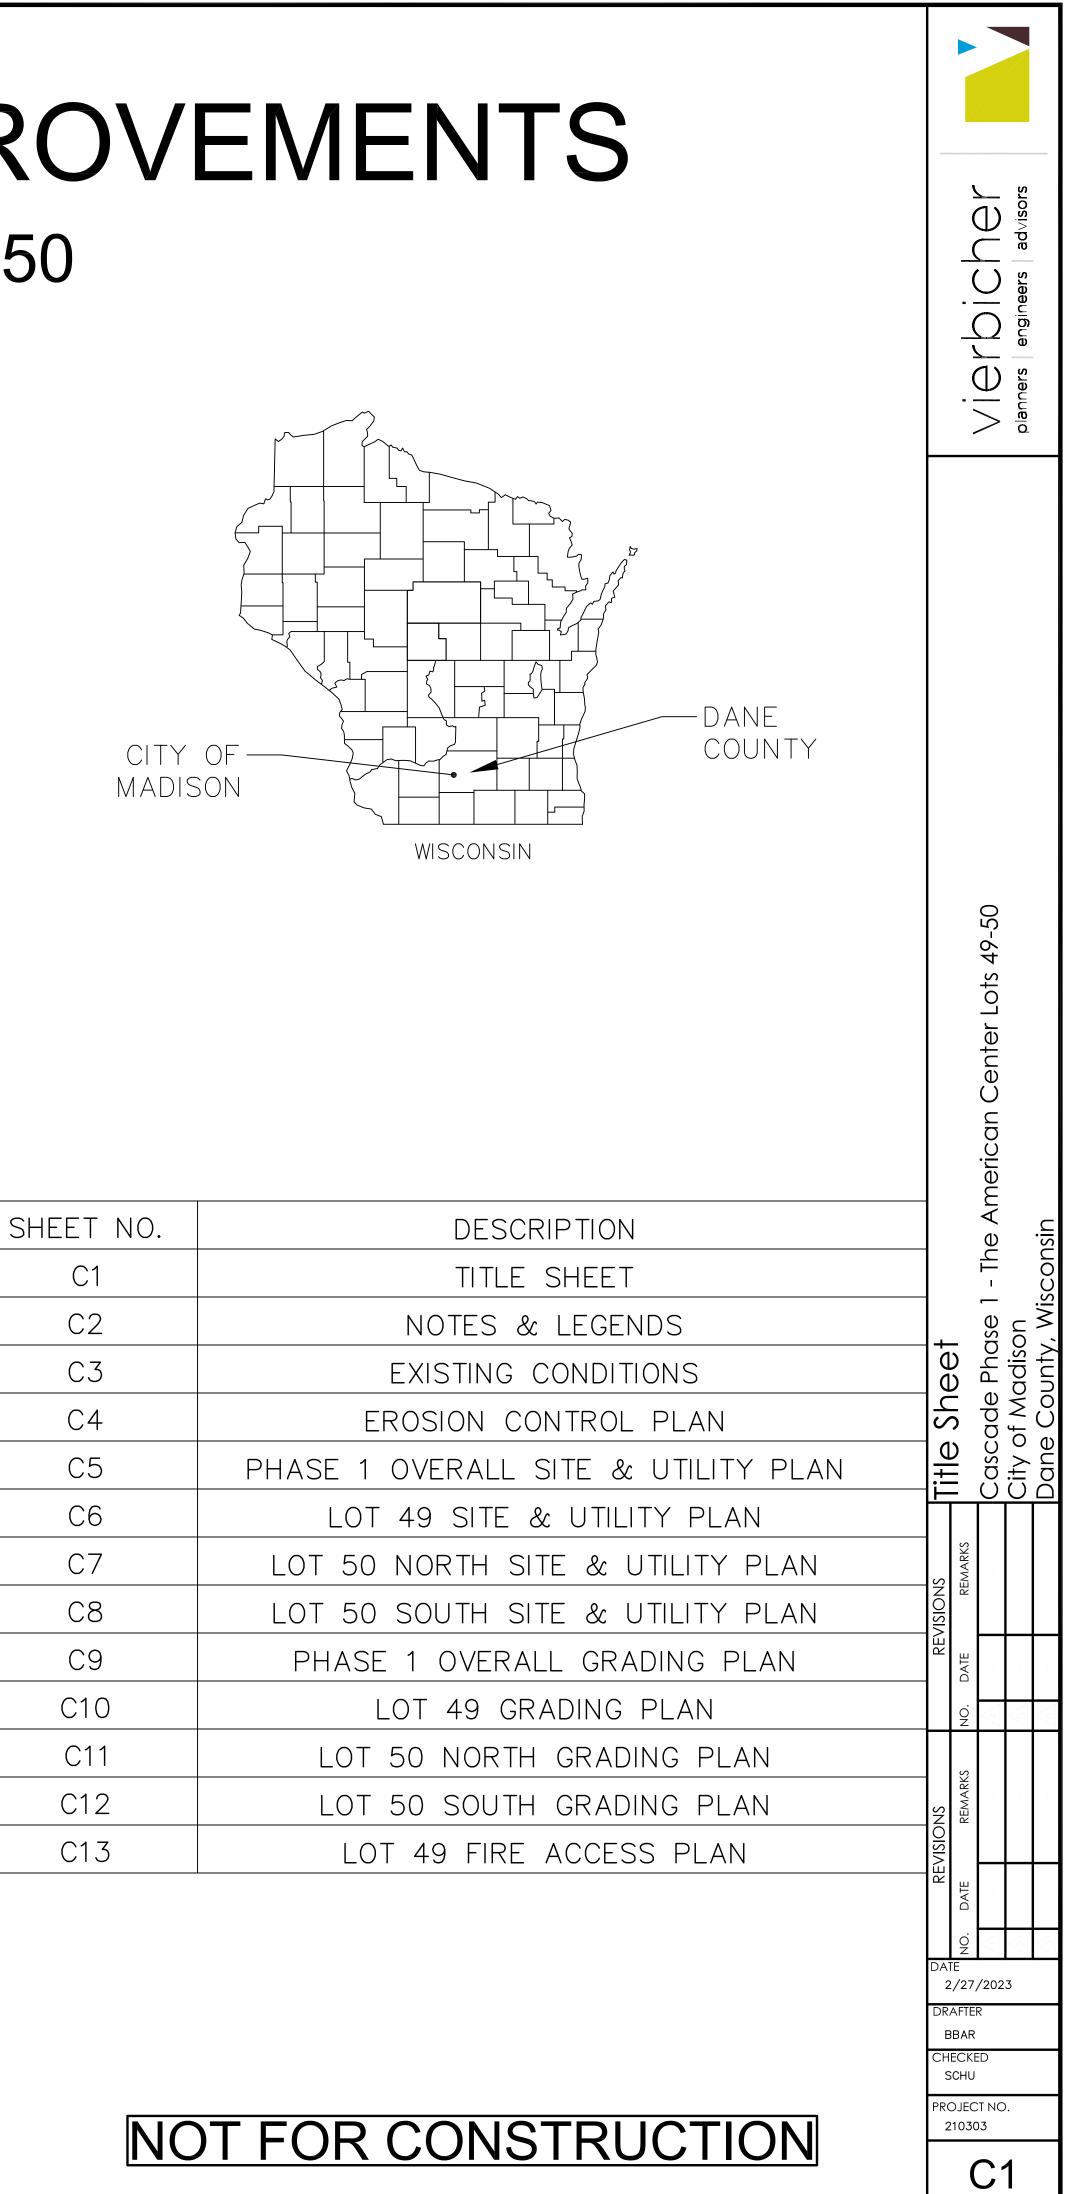

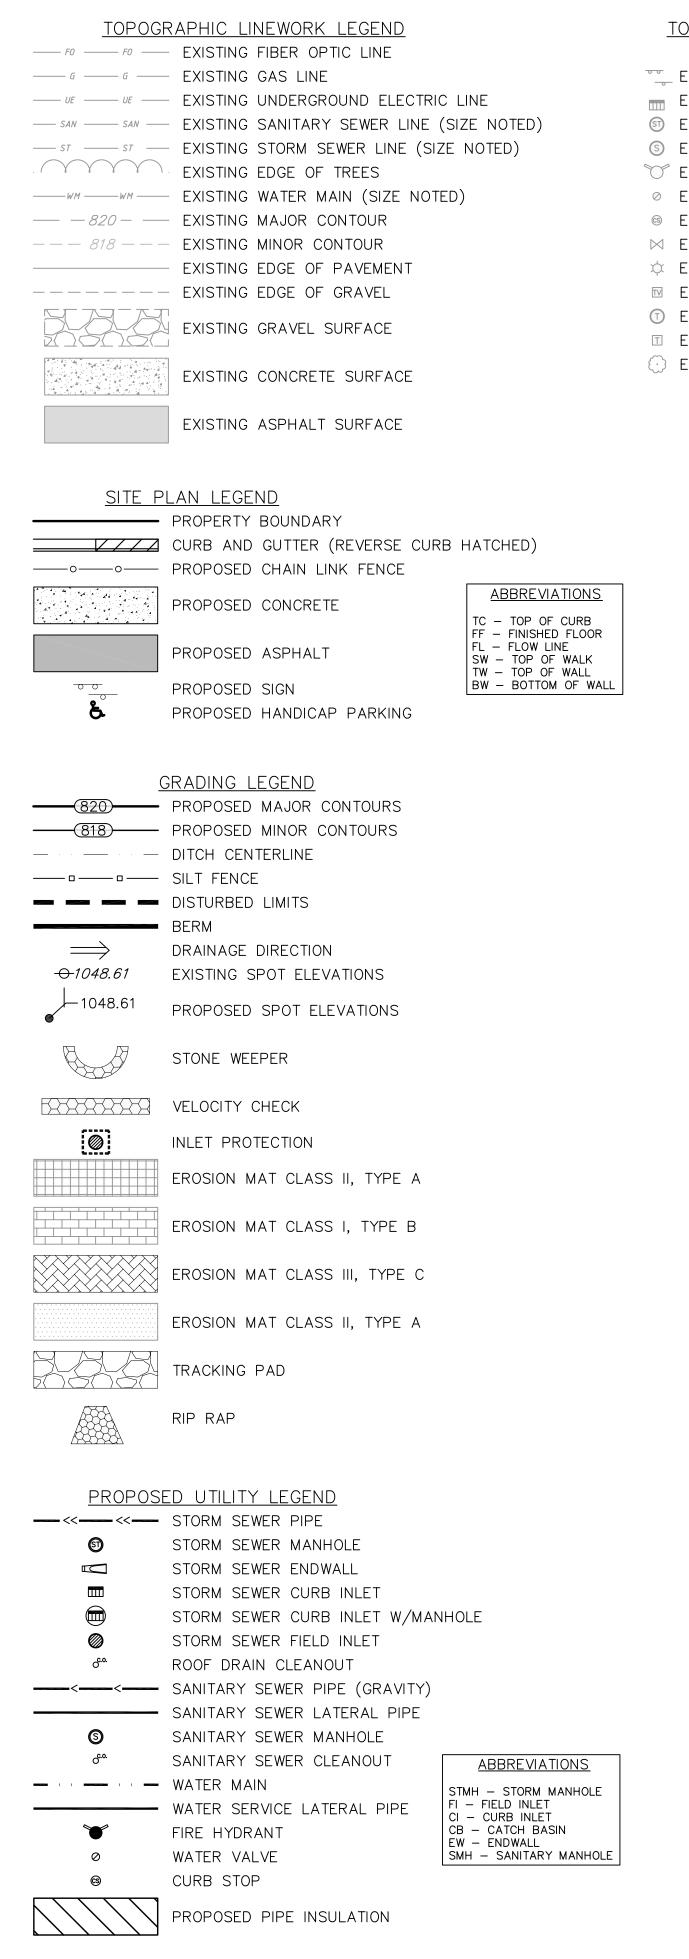

TOPOGRAPHIC SYMBOL LEGEND

- EXISTING SIGN (TYPE NOTED)
- EXISTING CURB INLET
- I EXISTING STORM MANHOLE
- S EXISTING SANITARY MANHOLE
- C EXISTING FIRE HYDRANT
- EXISTING WATER MAIN VALVE
- © EXISTING CURB STOP
- ⋈ EXISTING GAS VALVE
- $\dot{\mathbf{x}}$  EXISTING LIGHT POLE
- EXISTING TV PEDESTAL
- ① EXISTING TELEPHONE MANHOLE
- I EXISTING TELEPHONE PEDESTAL
- (·) EXISTING DECIDUOUS TREE

GENERAL NOTES:

- 1. THE CONTRACTOR IS RESPONSIBLE FOR ANY DAMAGE CAUSED DURING CONSTRUCTION TO PUBLIC PROPERTY, PRIVATE PROPERTY OR UTILITIES.
- 2. THE CONTRACTOR SHALL SUBMIT SHOP DRAWINGS FOR REVIEW BY THE ENGINEER, PRIOR TO PLACING AN ORDER OF ANY SUCH ITEM.
- 3. EXISTING TOPOGRAPHIC INFORMATION IS BASED ON FIELD OBSERVATIONS AND/OR PLAN OF RECORD DRAWINGS. CONTRACTOR SHALL VERIFY TOPOGRAPHIC INFORMATION PRIOR TO STARTING CONSTRUCTION.
- 4. RIGHT OF WAY (ROW) AND PROPERTY LINES ARE APPROXIMATE. CONTRACTOR SHALL BE RESPONSIBLE FOR PROTECTING EXISTING PROPERTY CORNER MONUMENTATION. ANY MONUMENTS DISTURBED BY CONTRACTOR SHALL BE REPLACED AT THE CONTRACTORS EXPENSE.
- 5. CONTRACTOR SHALL COORDINATE WITH DRY UTILITY COMPANY'S REGARDING ANY POTENTIAL CONFLICTS AND COORDINATE RELOCATIONS AS MAY BE REQUIRED. CONTRACTOR SHALL ALSO COORDINATE THE PROPOSED INSTALLATION OF NEW FACILITIES AS REQUIRED.

**DEMOLITION NOTES:** 

- 1. CONTRACTOR SHALL KEEP ALL CITY STREETS FREE AND CLEAR OF CONSTRUCTION RELATED DIRT/DUST/DEBRIS.
- 2. COORDINATE EXISTING UTILITY REMOVAL/ABANDONMENT WITH LOCAL AUTHORITIES AND UTILITY COMPANIES HAVING JURISDICTION.
- ALL SAWCUTTING SHALL BE FULL DEPTH TO PROVIDE A CLEAN EDGE TO MATCH NEW CONSTRUCTION. MATCH EXISTING ELEVATIONS AT POINTS OF CONNECTION FOR NEW AND EXISTING PAVEMENT, CURB, SIDEWALKS, ETC. ALL SAWCUT LOCATIONS SHOWN ARE APPROXIMATE AND MAY BE FIELD ADJUSTED TO ACCOMMODATE CONDITIONS, JOINTS, MATERIAL TYPE, ETC. REMOVE MINIMUM AMOUNT NECESSARY FOR INSTALLATION OF PROPOSED IMPROVEMENTS.
- 4. CONTRACTOR SHALL PROVIDE AND SHALL BE RESPONSIBLE FOR ANY NECESSARY TRAFFIC CONTROL SIGNAGE AND SAFETY MEASURES DURING DEMOLITION AND CONSTRUCTION OPERATIONS WITHIN OR NEAR THE PUBLIC ROADWAY.
- 5. COORDINATE TREE REMOVAL WITH LANDSCAPE ARCHITECT. ALL TREES TO BE REMOVED SHALL BE REMOVED IN THEIR ENTIRETY AND STUMPS SHALL BE GROUND TO 12" BELOW PROPOSED SUBGRADE.
- 6. CONTRACTOR SHALL OBTAIN ANY NECESSARY DEMOLITION AND UTILITY PLUGGING PERMITS.
- 7. ANY DAMAGE TO THE CITY PAVEMENT, INCLUDING DAMAGE RESULTING FROM CURB REPLACEMENT, WILL REQUIRE RESTORATION IN ACCORDANCE WITH THE CITY ENGINEERING PATCHING CRITERIA.

SITE PLAN NOTES:

- 1. CONCRETE TO BE 5" THICK, CONSTRUCTED ON A BASE OF 4" COMPACTED SAND OR CRUSHED STONE.
- CONCRETE FOR DRIVEWAYS AND SIDEWALK AT DRIVEWAY ENTRANCES SHALL BE 7" THICK, CONSTRUCTED ON A BASE OF 5" COMPACTED SAND OR CRUSHED STONE.
- 3. ALL DIMENSIONS WITH CURB & GUTTER ARE REFERENCED TO THE FACE OF CURB.
- 4. CONTRACTOR SHALL DEEP TILL ANY DISTURBED AREAS AFTER CONSTRUCTION IS COMPLETE AND BEFORE RESTORING.
- 5. CONTRACTOR TO OBTAIN ANY NECESSARY DRIVEWAY CONNECTION, RIGHT OF WAY AND EXCAVATION PERMITS PRIOR TO CONSTRUCTION.
- 6. ALL ABANDONED DRIVEWAYS ADJACENT TO THE SITE SHALL BE REPLACED WITH CURB AND THE TERRACE SHALL BE RESTORED WITH GRASS.
- 7. ANY SIDEWALK AND CURB & GUTTER ABUTTING THE PROPERTY SHALL BE REPLACED IF IT IS DAMAGED DURING CONSTRUCTION.

**GRADING NOTES:** 

- 1. CONTOURS ARE SHOWN FOR PURPOSES OF INDICATING ROUGH GRADING. FINAL GRADE SHALL BE ESTABLISHED ON PAVED SURFACES BY USING SPOT GRADES ONLY.
- 2. ALL GRADES SHOWN REFERENCE FINISHED ELEVATIONS.
- 3. CROSS SLOPE OF SIDEWALKS SHALL BE 2.0% UNLESS OTHERWISE NOTED.
- 4. LONGITUDINAL GRADE OF SIDEWALK RAMPS SHALL NOT EXCEED 8.33% (1:12) AND SHALL BE IN ACCORDANCE WITH ADA REQUIREMENTS.
- 5. LONGITUDINAL GRADE OF SIDEWALK SHALL NOT EXCEED 5.0% OR THE ADJACENT STREET GRADE WHICHEVER IS GREATER.
- 6. ACCESSIBLE ROUTES SHALL BE 5.0% MAX LONGITUDINAL SLOPE AND 1.5% MAX CROSS SLOPE. ACCESSIBLE LOADING AREAS OR LANDINGS SHALL BE 2.0% MAX SLOPE IN ANY DIRECTION. RAMPS SHALL BE 8.33% MAX SLOPE.
- 7. NO LAND DISTURBANCE ACTIVITIES SHALL BEGIN UNTIL ALL EROSION CONTROL BMP'S ARE INSTALLED.
- 8. SEE DETAIL SHEETS FOR EROSION CONTROL NOTES AND CONSTRUCTION SEQUENCE.

UTILITY NOTES:

- OF THE DEPARTMENT OF SAFETY AND PROFESSIONAL SERVICES AND OTHER LOCAL INSPECTORS.

- FORESTRY.

**NOT FOR CONSTRUCTION** 

1. CONTRACTOR SHALL OBTAIN ANY NECESSARY WORK IN RIGHT OF WAY, EXCAVATION, UTILITY CONNECTION, PLUGGING AND ABANDONMENT PERMITS PRIOR TO CONSTRUCTION.

2. CONTRACTOR TO VERIFY EXISTING UTILITY LOCATIONS AND ELEVATIONS PRIOR TO STARTING WORK.

3. SANITARY & STORM SEWER LENGTHS SHOWN ARE FROM CENTER OF STRUCTURE TO CENTER OF STRUCTURE. STORM SEWER END SECTIONS ARE INCLUDED IN THE LENGTH AND SLOPE OF THE PIPE.

4. CONTRACTOR SHALL INVESTIGATE ALL UTILITY CROSSINGS PRIOR TO CONSTRUCTION AND NOTIFY ENGINEER OF ANY CONFLICTS.

5. CONTRACTOR SHALL BE RESPONSIBLE FOR ADJUSTING ALL UTILITY STRUCTURES TO FINISHED GRADE (MANHOLE RIMS, WATER VALVES, AND CURB STOPS), IF NECESSARY.

6. FOR ALL SEWER AND WATER MAIN CROSSINGS: PROVIDE MINIMUM 18" SEPARATION WHEN WATER MAIN CROSSES BELOW SEWER AND MINIMUM 6" SEPARATION WHEN WATER MAIN CROSSES ABOVE SEWER. 7. IF DEWATERING OPERATIONS EXCEED 70 GALLONS PER MINUTE OF PUMPING CAPACITY, A DEWATERING

WELL PERMIT SHALL BE OBTAINED PRIOR TO STARTING ANY DEWATERING ACTIVITIES. 8. A COPY OF THE APPROVED UTILITY PLANS, SPECIFICATIONS AND PLUMBING PERMIT APPROVAL LETTER SHALL BE ON-SITE DURING CONSTRUCTION AND OPEN TO INSPECTION BY AUTHORIZED REPRESENTATIVES

9. PROPOSED UTILITY SERVICE LINES SHOWN ARE APPROXIMATE. COORDINATE THE EXACT LOCATIONS WITH THE PLUMBING DRAWINGS. COORDINATE THE LOCATION WITH THE PLUMBING CONTRACTOR AND/OR OWNER'S CONSTRUCTION REPRESENTATIVE PRIOR TO INSTALLATION OF ANY NEW UTILITIES.

10. STORM BUILDING SEWER PIPE SHALL CONFORM TO ONE OF THE STANDARDS LISTED IN TABLE 384.30-6 OF SPS 384.30(3)(c).

11. UNDERGROUND DRAIN AND VENT PIPE/TUBING SHALL CONFORM TO ONE OF THE STANDARDS LISTED IN TABLE 384.30-2 OF SPS 384.30(2).

12. PRIVATE WATER SERVICES AND PRIVATE WATER MAINS SHALL CONFORM TO ONE OF THE STANDARDS LISTED IN TABLE 384.30-7 OF SPS 384.30(4)(d).

13. PRIVATE SANITARY SEWER AND LATERALS SHALL BE POLYVINYL CHLORIDE (PVC) ASTM D3034 - SDR 35 OR APPROVED EQUAL MATERIAL THAT CONFORMS TO ONE OF THE STANDARDS LISTED IN TABLE 384.30-3 OF SPS 384.30(2)(c).

14. A MEANS TO LOCATE BURIED UNDERGROUND EXTERIOR NON METALLIC SEWERS/MAINS AND WATER SERVICES/MAINS MUST BE PROVIDED WITH TRACER WIRE OR OTHER METHODS IN ORDER TO BE LOCATED PER SPS 382.10(11)(h) AND SPS 382.40(8)(k).

15. EXTERIOR WATER SUPPLY PIPING SETBACKS AND CROSSINGS SHALL BE IN ACCORDANCE WITH SPS 382.40(8)(b.).

16. NO PERSON MAY ENGAGE IN PLUMBING WORK IN THE STATE UNLESS LICENSED TO DO SO BY THE DEPARTMENT OF SAFETY AND PROFESSIONAL SERVICES PER S.145.06.

17. SITE CONTRACTOR SHALL LEAVE SANITARY AND WATER LATERALS FIVE (5) FEET SHORT (HORIZONTALLY) FROM THE BUILDING. BUILDING PLUMBER SHALL VERIFY SIZE, LOCATION, AND INVERT ELEVATION OF PROPOSED SANITARY AND WATER LATERALS.

18. IT IS THE CONTRACTOR'S RESPONSIBILITY TO VERIFY THAT THE EXISTING VALVES WILL HOLD THE PRESSURE TEST PRIOR TO CONNECTION. THE CITY IS NOT RESPONSIBLE FOR ANY COSTS INCURRED DUE TO THE CONTRACTOR NOT VERIFYING THAT THE EXISTING VALVE WILL HOLD THE PRESSURE TEST PRIOR TO CONNECTION. IF A NEW VALVE IS REQUIRED, THE APPLICANT WILL BE REQUIRED TO INSTALL ONE AT THEIR EXPENSE. AT THE POINT OF CONNECTION.

19. CONTRACTOR TO CHLORINATE AND BACTERIA TEST BEFORE DOMESTIC SUPPLY PURPOSES

20. CLEAN OUT ALL EXISTING AND PROPOSED STORM INLETS AND CATCH BASINS AT THE COMPLETION OF CONSTRUCTION.

21. SANITARY SEWER MAIN AT BURY DEPTHS GREATER THAN 15' SHALL BE SDR 21. ALL OTHER SANITARY SEWER MAIN SHALL BE SDR 26.

22. ALL WATER MAIN AND SERVICES SHALL BE INSTALLED AT A MINIMUM DEPTH OF 6.5' FROM TOP OF FINISHED GRADE ELEVATION TO TOP OF MAIN. PROVIDE 1.5' CLEAR SEPARATION IF WATER CROSSES BELOW SEWER AND MINIMUM 0.5' IF WATER CROSSES ABOVE.

23. SANITARY MANHOLES WITH SEWER MAIN CONNECTIONS GREATER THAN 2' ABOVE THE LOWEST INVERT SHALL BE CONSTRUCTED WITH AN EXTERNAL DROP. MANHOLES WITH SEWER LATERAL CONNECTIONS GREATER THAT 2' ABOVE THE LOWEST INVERT SHALL BE CONSTRUCTED WITH AN INTERNAL DROP.

24. INSTALL 1 SHEET OF 4'x8'x4" HIGH DENSITY STYROFOAM INSULATION AT ALL LOCATIONS WHERE STORM SEWER CROSSES WATER MAIN OR WATER LATERALS.

### STREET TREE NOTES:

ALL PROPOSED STREET TREE REMOVALS WITHIN THE RIGHT OF WAY SHALL BE REVIEWED BY CITY FORESTRY. STREET TREE REMOVALS REQUIRE APPROVAL AND A TREE REMOVAL PERMIT ISSUED BY CITY

2. CONTRACTOR SHALL TAKE PRECAUTIONS DURING CONSTRUCTION TO NOT DISFIGURE, SCAR, OR IMPAIR THE HEALTH OF ANY STREET TREE. CONTRACTOR SHALL OPERATE EQUIPMENT IN A MANNER AS TO NOT DAMAGE THE BRANCES OF THE STREET TREES. ANY DAMAGE OR INJURY TO EXISTING STREET TREES (EITHER ABOVE OR BELOW GROUND) SHALL BE REPORTED IMMEDIATELY TO CITY FORESTRY.


3. AS DEFINED BY SECTION 107.13 OF CITY OF MADISON STANDARD SPECIFICATIONS FOR PUBLIC WORKS CONSTRUCITON: NO EXCAVATION IS PERMITTED WITHIN 5 FEET OF THE TRUNK OF THE STREET TREE OR WHEN CUTTING ROOTS OVER 3 INCHES IN DIAMETER. IF EXCAVATION IS NECESSARY, THE CONTRACTOR SHALL CONTACT MADISON CITY FORESTRY PRIOR TO EXCAVATION. CITY OF MADISON FORESTRY PERSONNEL SHALL ASSES THE IMPACT TO THE TREE AND TO ITS ROOT SYSTEM PRIOR TO WORK COMMENCING.

SECTION 107.13(g) OF THE CITY OF MADISON STANDARD SPECIFICATIONS FOR PUBLIC WORKS CONSTRUCTION ADDRESSES SOIL COMPACTION NEAR STREET TREES AND SHALL BE FOLLOWED BY CONTRACTOR. THE STORAGE OF PARKED VEHICLES, CONSTRUCTION EQUIPMENT, BUILDING MATERIALS, REFUSE, EXCAVATED SPOILS, OR DUMPING OF POISONOUS MATERIALS ON OR AROUND TREES AND ROOTS WITHIN 5 FEET OF THE TREE OR WITHIN THE PROTECTION ZONE IS PROHIBITED.

5. STREET TREE PRUNING SHALL BE COORDINATED WITH CITY FORESTRY AT A MINIMUM OF TWO WEEKS PRIOR TO THE START OF CONSTRUCTION.

Notes & Legends		Cascade Phase 1 - The American Center Lots 49-50	City of Madison	Dane County, Wisconsin
REVISIONS	REMARKS			
REV	NO. DATE			
	NO.	$\sqrt{4}$	2	<u>\</u>
REVISIONS	REMARKS			
RE	NO. DATE			
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	DJEC 1030	:T NC )3	).	

C2

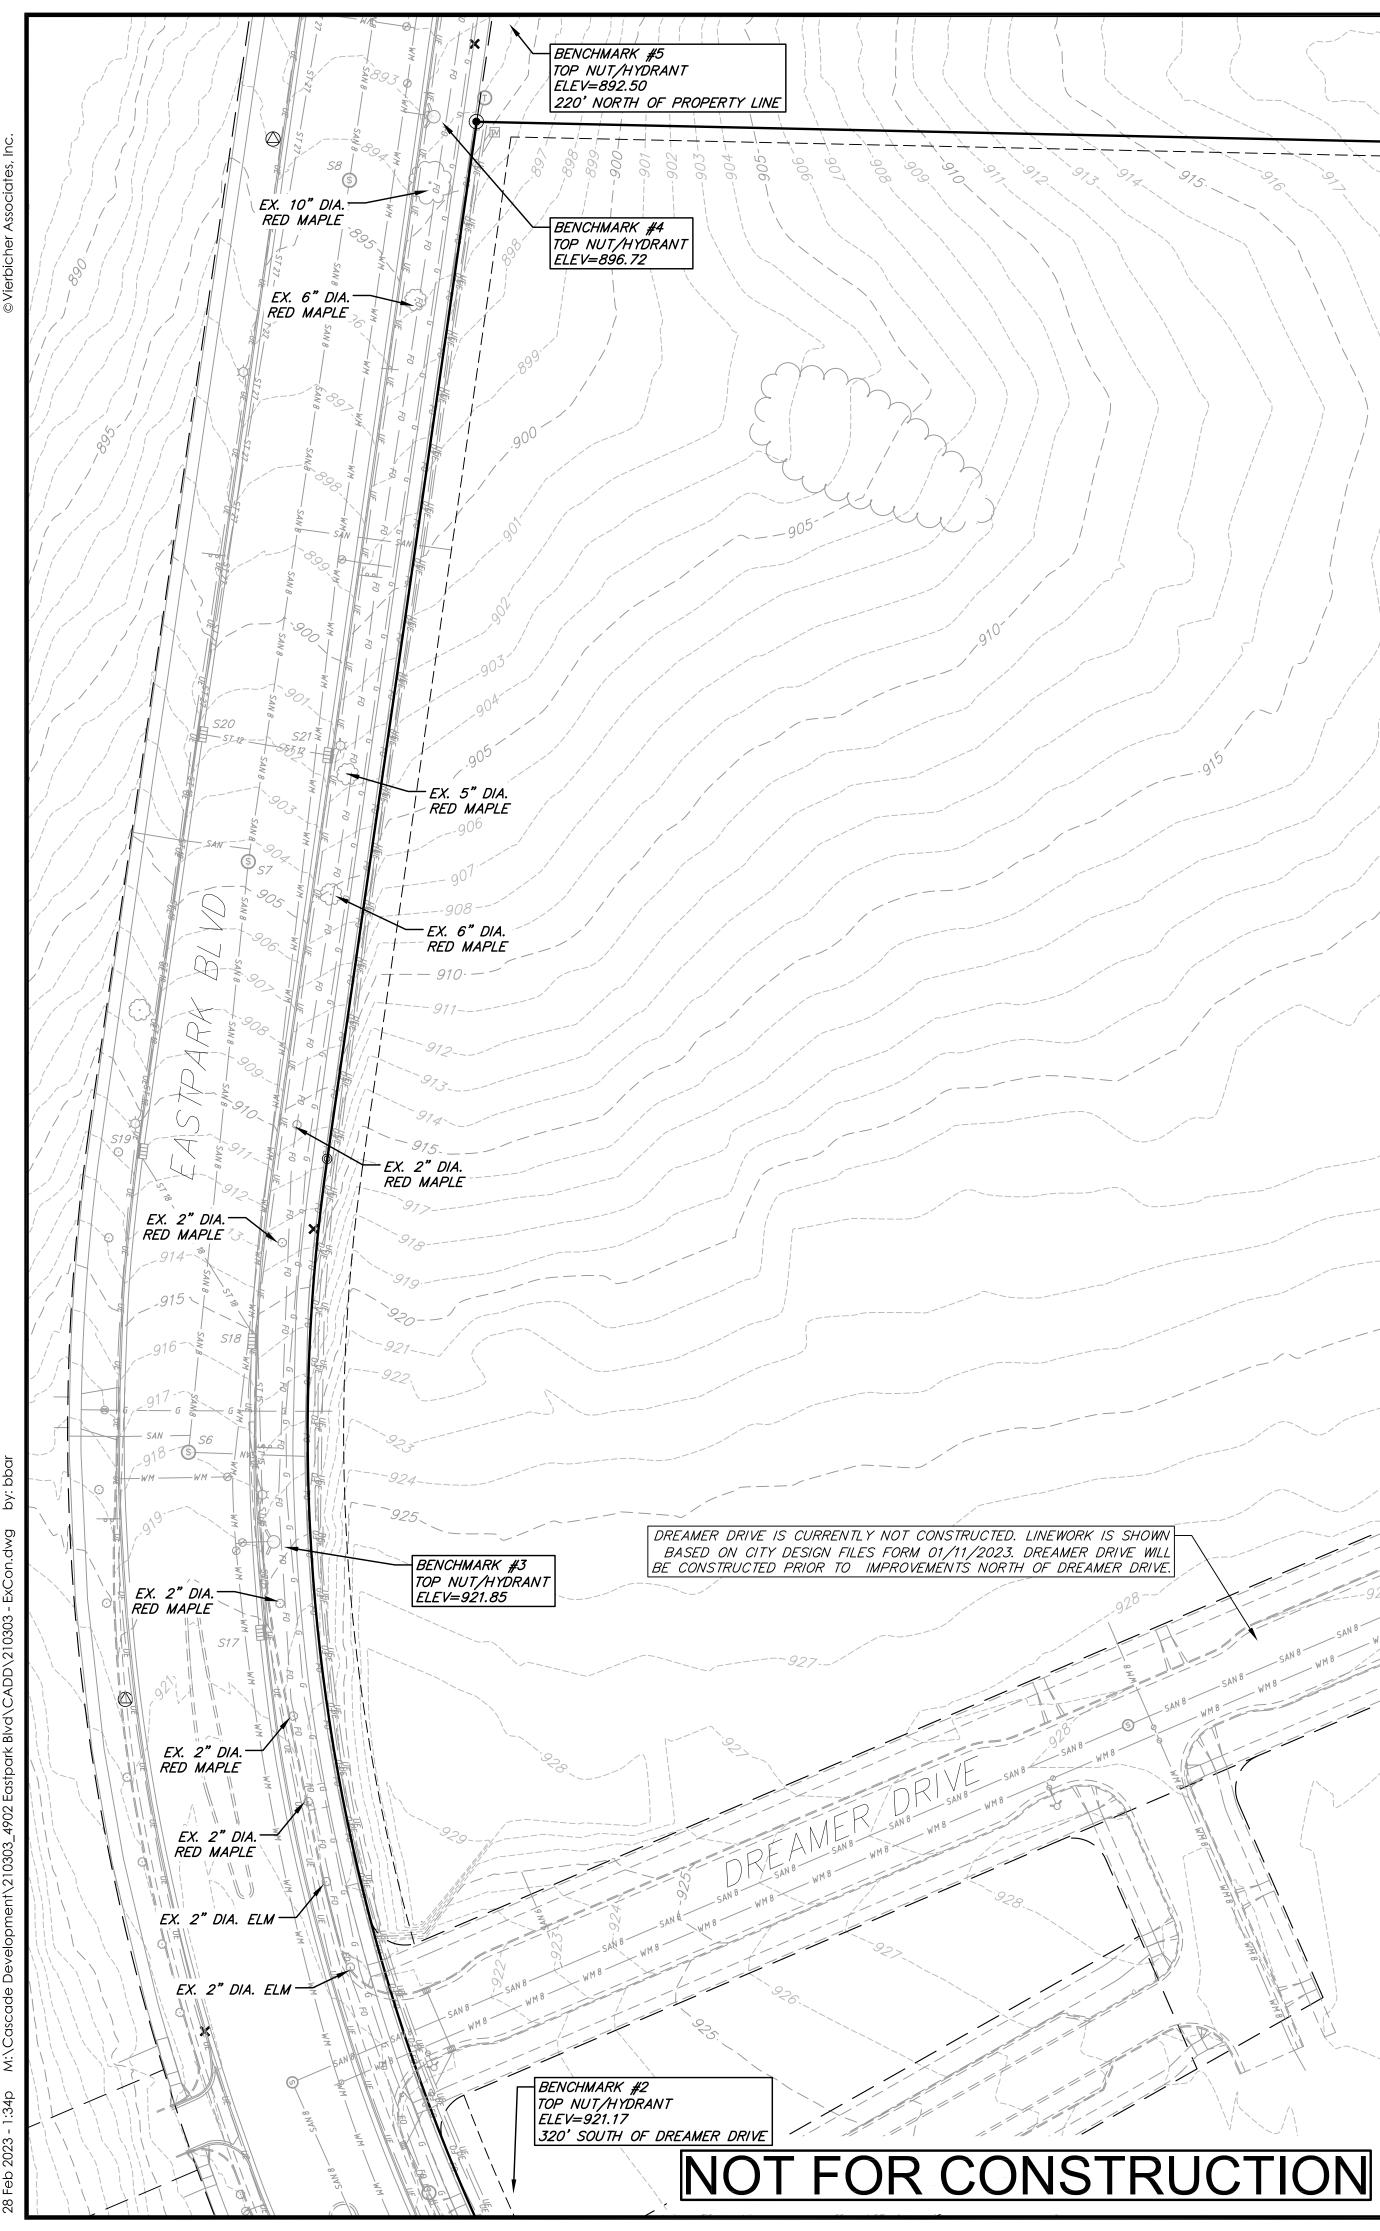

<u>SURVEY LEGEND</u>

- 🖄 BENCHMARK
- × FOUND CHISELED "X"
- PUBLIC LAND CORNER AS NOTED
- FOUND NAIL
- ◎ FOUND 1" Ø IRON PIPE
- FOUND P.K. NAIL
- FOUND 1 1/4" Ø IRON ROD ● FOUND 3/4" ø IRON ROD
- SET NAIL


### TOPOGRAPHIC SYMBOL LEGEND

- EXISTING SIGN (TYPE NOTED)
- EXISTING CURB INLET
- (ST) EXISTING STORM MANHOLE
- S EXISTING SANITARY MANHOLE
- C EXISTING FIRE HYDRANT
- ⊘ EXISTING WATER MAIN VALVE
- © EXISTING CURB STOP
- 🖂 EXISTING GAS VALVE
- $\Diamond$  EXISTING LIGHT POLE
- M EXISTING TV PEDESTAL
- (T) EXISTING TELEPHONE MANHOLE
- EXISTING TELEPHONE PEDESTAL
- EXISTING DECIDUOUS TREE

- ----- EXISTING SILT FENCE

- EXISTING EDGE OF TREES
- ---- 928 ---- EXISTING MINOR CONTOUR



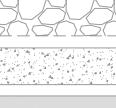






CRADUIC SCALE FEFT

GRA	PHIC	SCALE	FEEI
			·····
0	20	40	80

EXISTING SANITARY STRUCTURE TABLE				
NAME	ΤΥΡΕ	RIM/TC	INVERT	DIRECTION
S1	SMH	903.36	891.16	SE
			891.03	NW
S2	SMH	905.86	889.66	SE
			889.61	SW
			890.81	NW
			895.64	NW
S3	SMH	909.73	899.71	SE
			899.85	NW
S4	SMH	917.44	907.37	SE
			907.47	NW
S5	SMH	921.62	911.72	SE
			911.76	W
			911.83	NW
S6	SMH	917.90	907.28	N
			907.35	E
S7	SMH	904.37	893.84	N
			893.93	S
S8	SMH	894.48	883.69	N
			883.78	S
S9	SMH	890.05	877.47	N
			876.55	S
			876.47	W
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### <u>GENERAL NOTES:</u>

- 1. This plan is not intended to be a property survey as defined in Chapter A–E 7 of the Wisconsin Administrative Code. The property lines shown on this plan are based on found monumentation, Certified Survey Map #15829, recorded as Document # 5778376 and subsequent surveys of record.
- 2. This plan is based upon field survey work performed on August 17, 18 and 24, 2022. Any changes in site conditions after August 24, 2022 are not reflected by this plan.
- 3. This plan is referenced to the Wisconsin County Coordinate System-Dane Zone, NAD 83 (2011). Elevations are referenced to NAVD 88 (2012) datum. Field data was obtained using Robotic Total Station and GPS.
- 4. All underground utilities have been located per markings placed on the ground or maps provided by the utilities (owners) and/or their authorized representatives. Markings are per Digger's Hotline ticket #20223311075 and #20223311078. No private locate request was made. Vierbicher does not warrant the locations marked or mapped by others. Sewer and water pipe sizes were obtained from the City of Madison GTweb site. Some storm sewer pipe sizes were measured during the survey.
- 5. No attempt has been made as a part of this plan to obtain or show data concerning condition,or capacity of any utility or municipal/public service facility. For information regarding these utilities contact the appropriate agencies.
- 6. Surveyor has made no investigation or independent search for easements of record, encumbrances, restrictive covenants, or ownership title evidence, or any other facts that a title search might reveal, except those easements shown on the Creek Crossing At St. Francis plat.

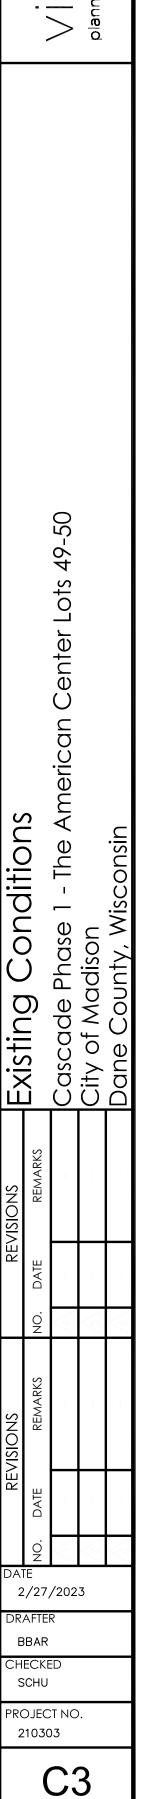

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NAM		E RIM/TC	INVERT	DIRECTIO
S11	L CIN	906.23	901.53	SE
			901.79	NW
S12	2 STM	H 907.63	903.21	NE
			902.89	S
			903.16	NW
S13	3 CIN	907.57	903.68	SW
S14	1 CIN	912.70	909.19	SE
			909.24	NW
S15	5 CIN	919.28	914.88	E
			914.73	SE
			914.93	SW
S16	5 CIN	918.59	915.39	W
S17	7 CIN	920.61	917.21	N
S18	3 CIN	915.63	912.32	S
			912.07	NW
S19	) CIN	911.41	907.32	N
			907.37	SE
S20	) CIN	901.86	896.83	N
			897.30	E
			897.06	S
S21	L CIN	902.02	898.32	w
S22	2 STM	H 890.10	880.45	N
			880.45	E
			883.70	S
			880.40	W
S23	3 CIN	890.31	880.40	N
			880.40	E
			880.40	W
S24	1 CIN	890.38	882.20	NE
			881.73	w

EXISTING STORM STRUCTURE TABLE

\_\_\_\_\_ -----——*<\_\_\_\_*\_\_\_

- \_ \_ \_ \_ \_ \_ \_ \_ \_ \_


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#### TOPOGRAPHIC LINEWORK LEGEND


- ----- FO ----- EXISTING FIBER OPTIC LINE
- ----- G ----- EXISTING GAS LINE
- ----- UE ----- EXISTING UNDERGROUND ELECTRIC LINE
- SAN SAN EXISTING SANITARY SEWER LINE (SIZE NOTED)
- ---- st ----- st ---- EXISTING STORM SEWER LINE (SIZE NOTED)
- - EXISTING EDGE OF PAVEMENT
- ----- EXISTING EDGE OF GRAVEL
  - EXISTING GRAVEL SURFACE
  - EXISTING CONCRETE SURFACE

EXISTING ASPHALT SURFACE






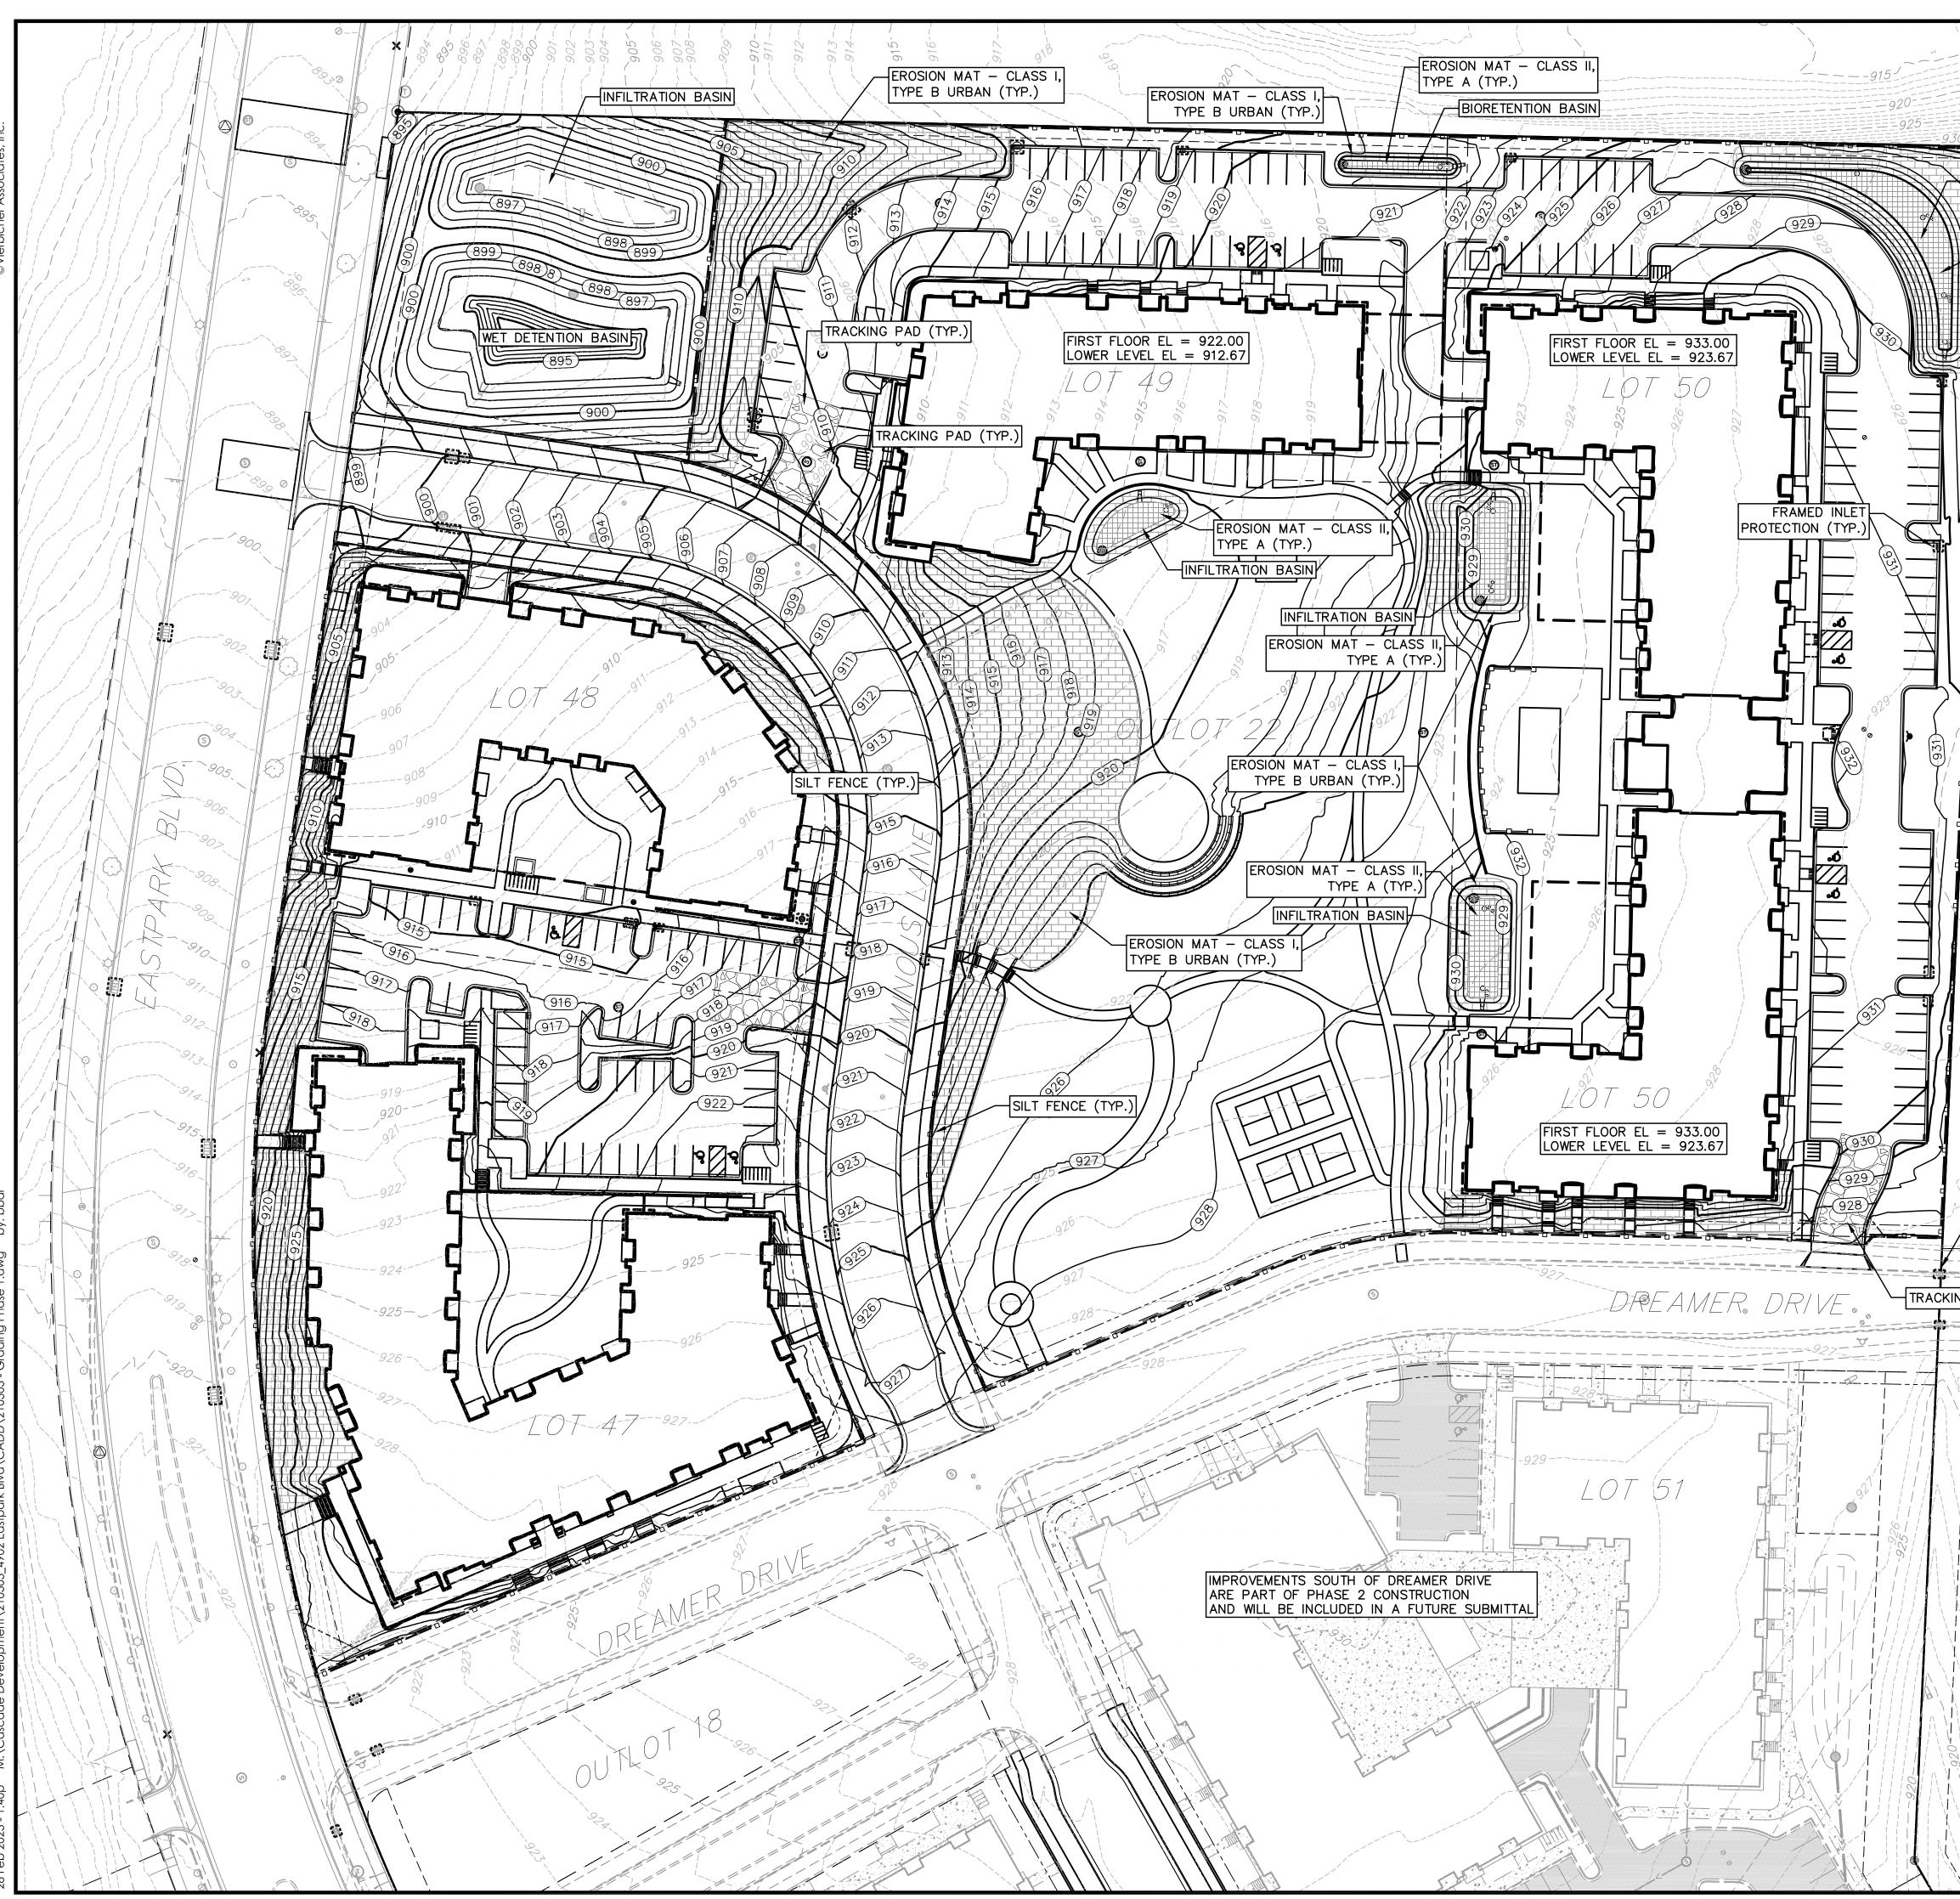


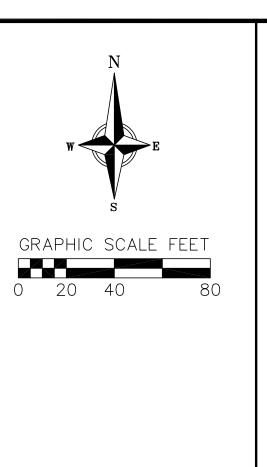


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		VIERDICU	planners engineers ad	
		Center Lots 49-50		
		Cascade Phase 1 - The American Center Lots 49-50	City of Madison	Dane County, Wisconsin
	REMARKS			
	NO. DATE			
	REMARKS			
V U V	NO. DATE		- 1	
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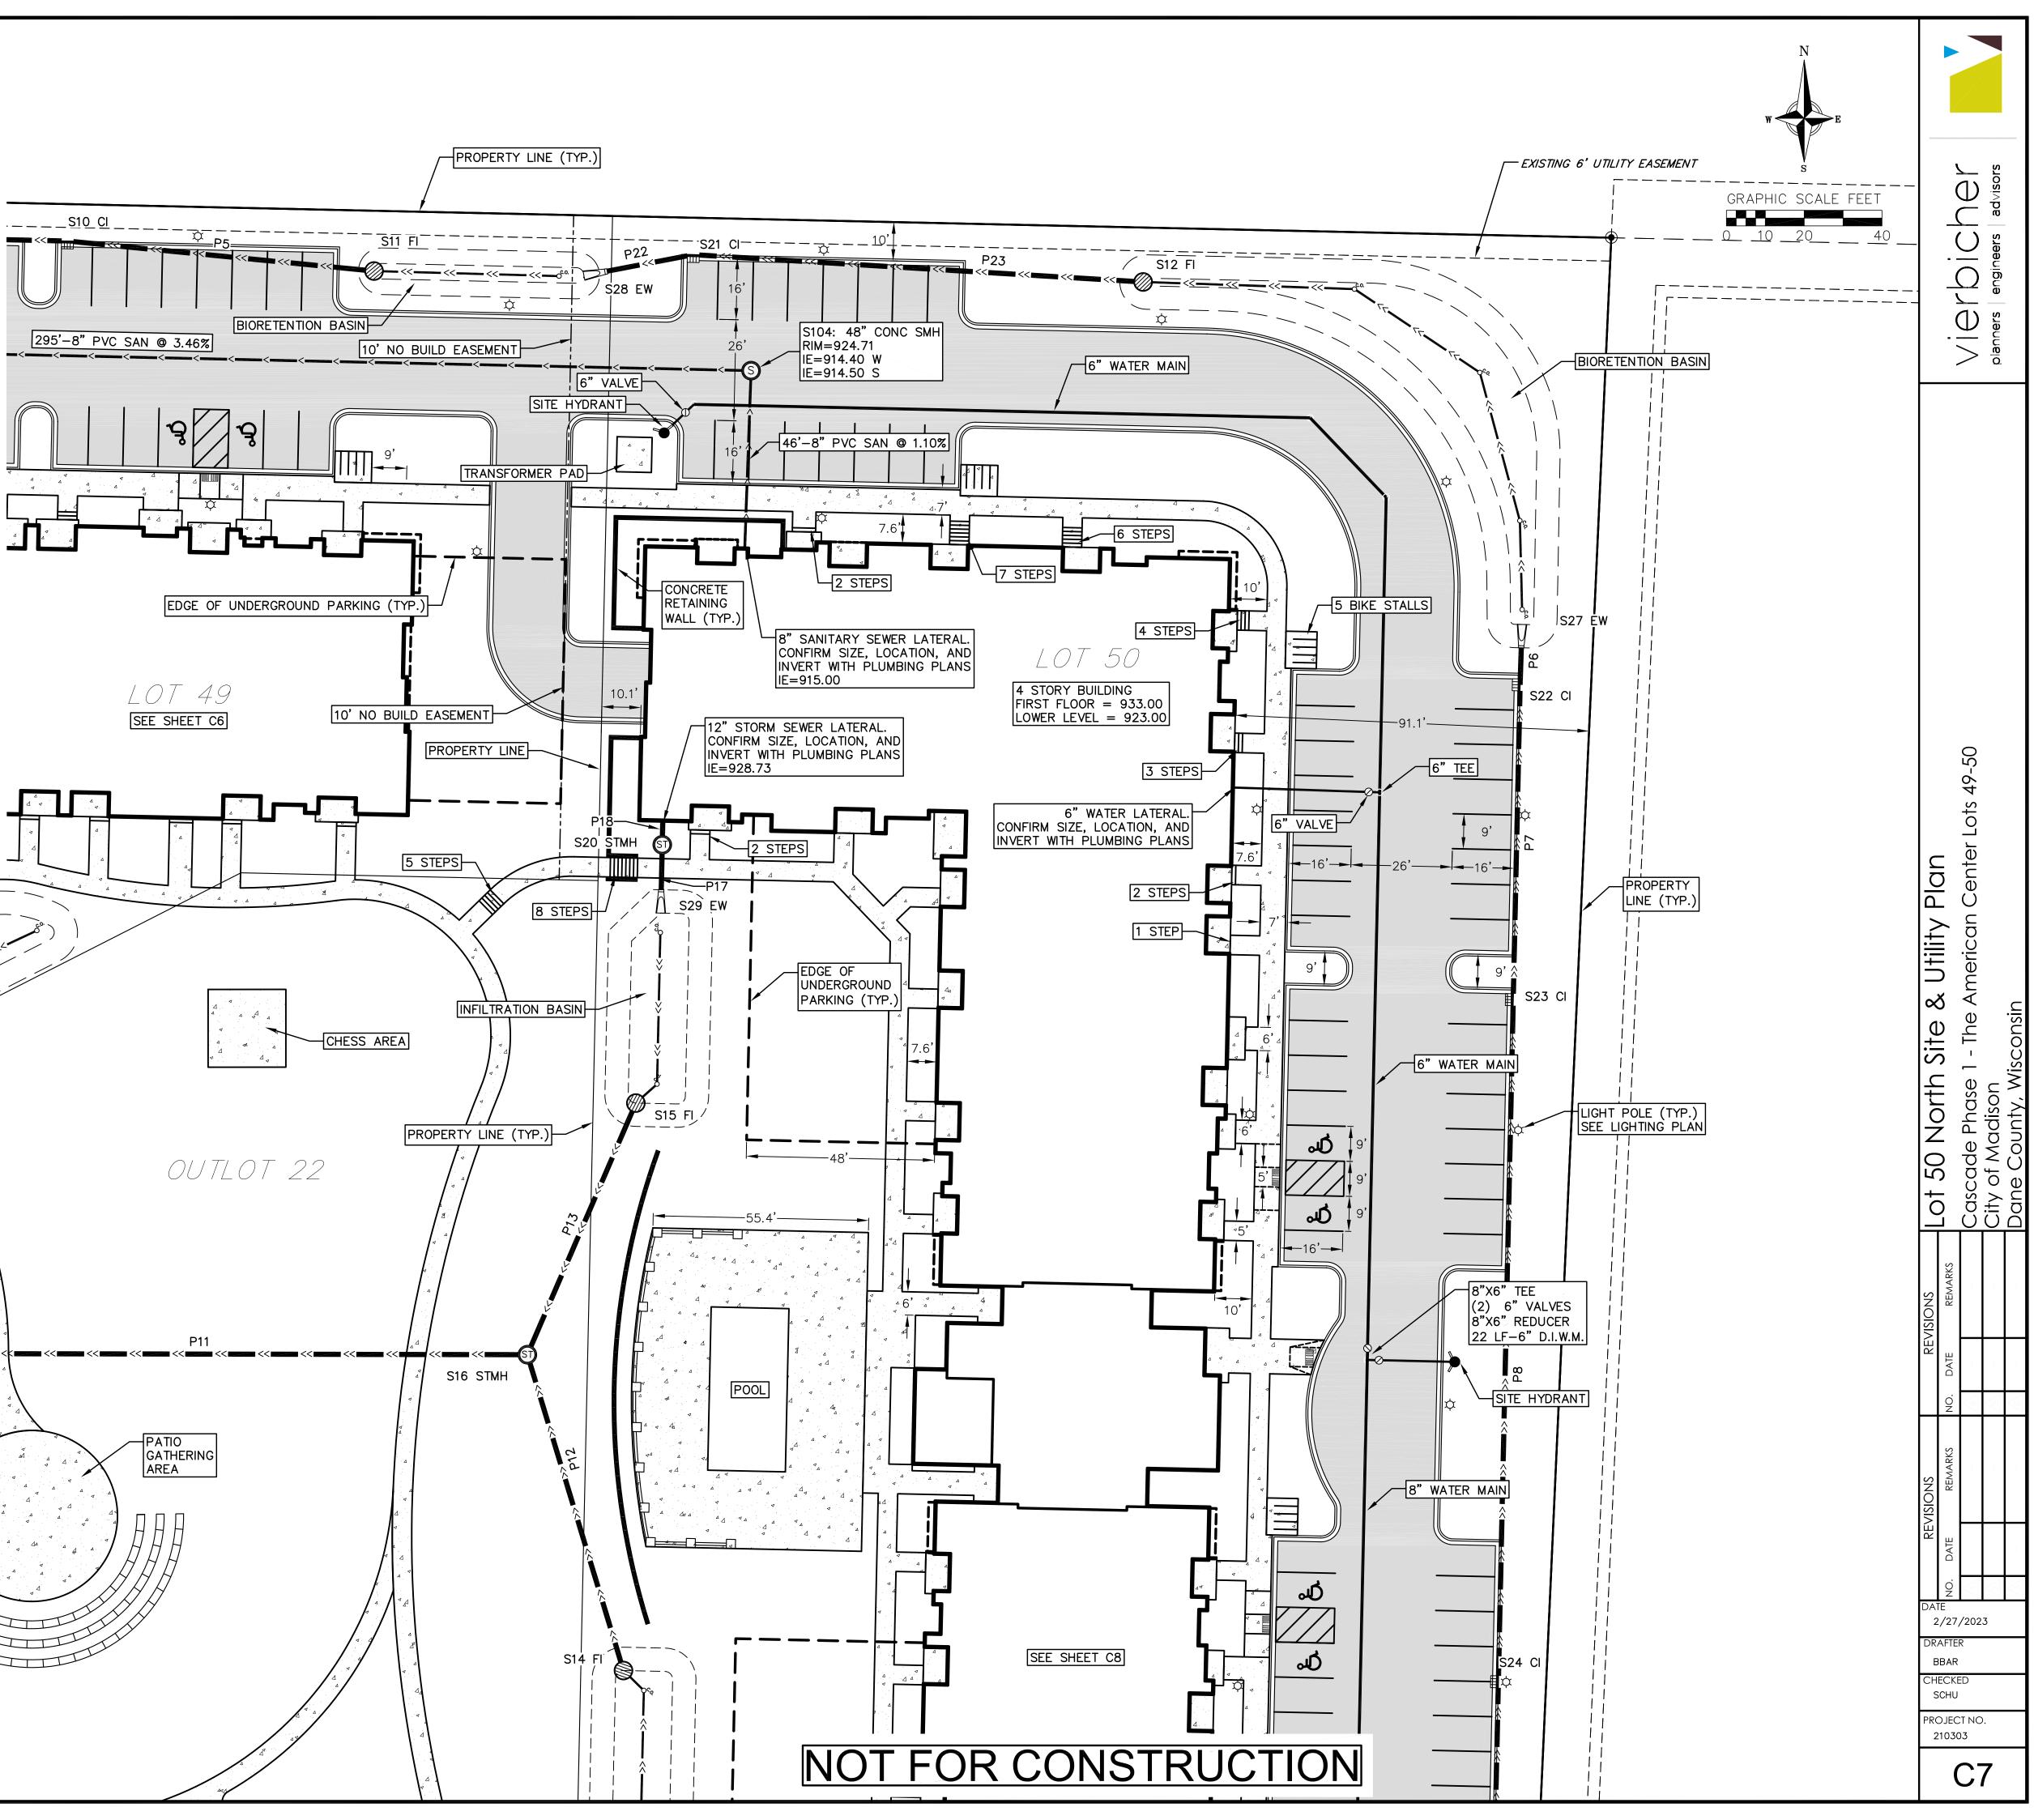





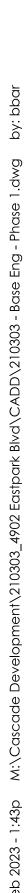


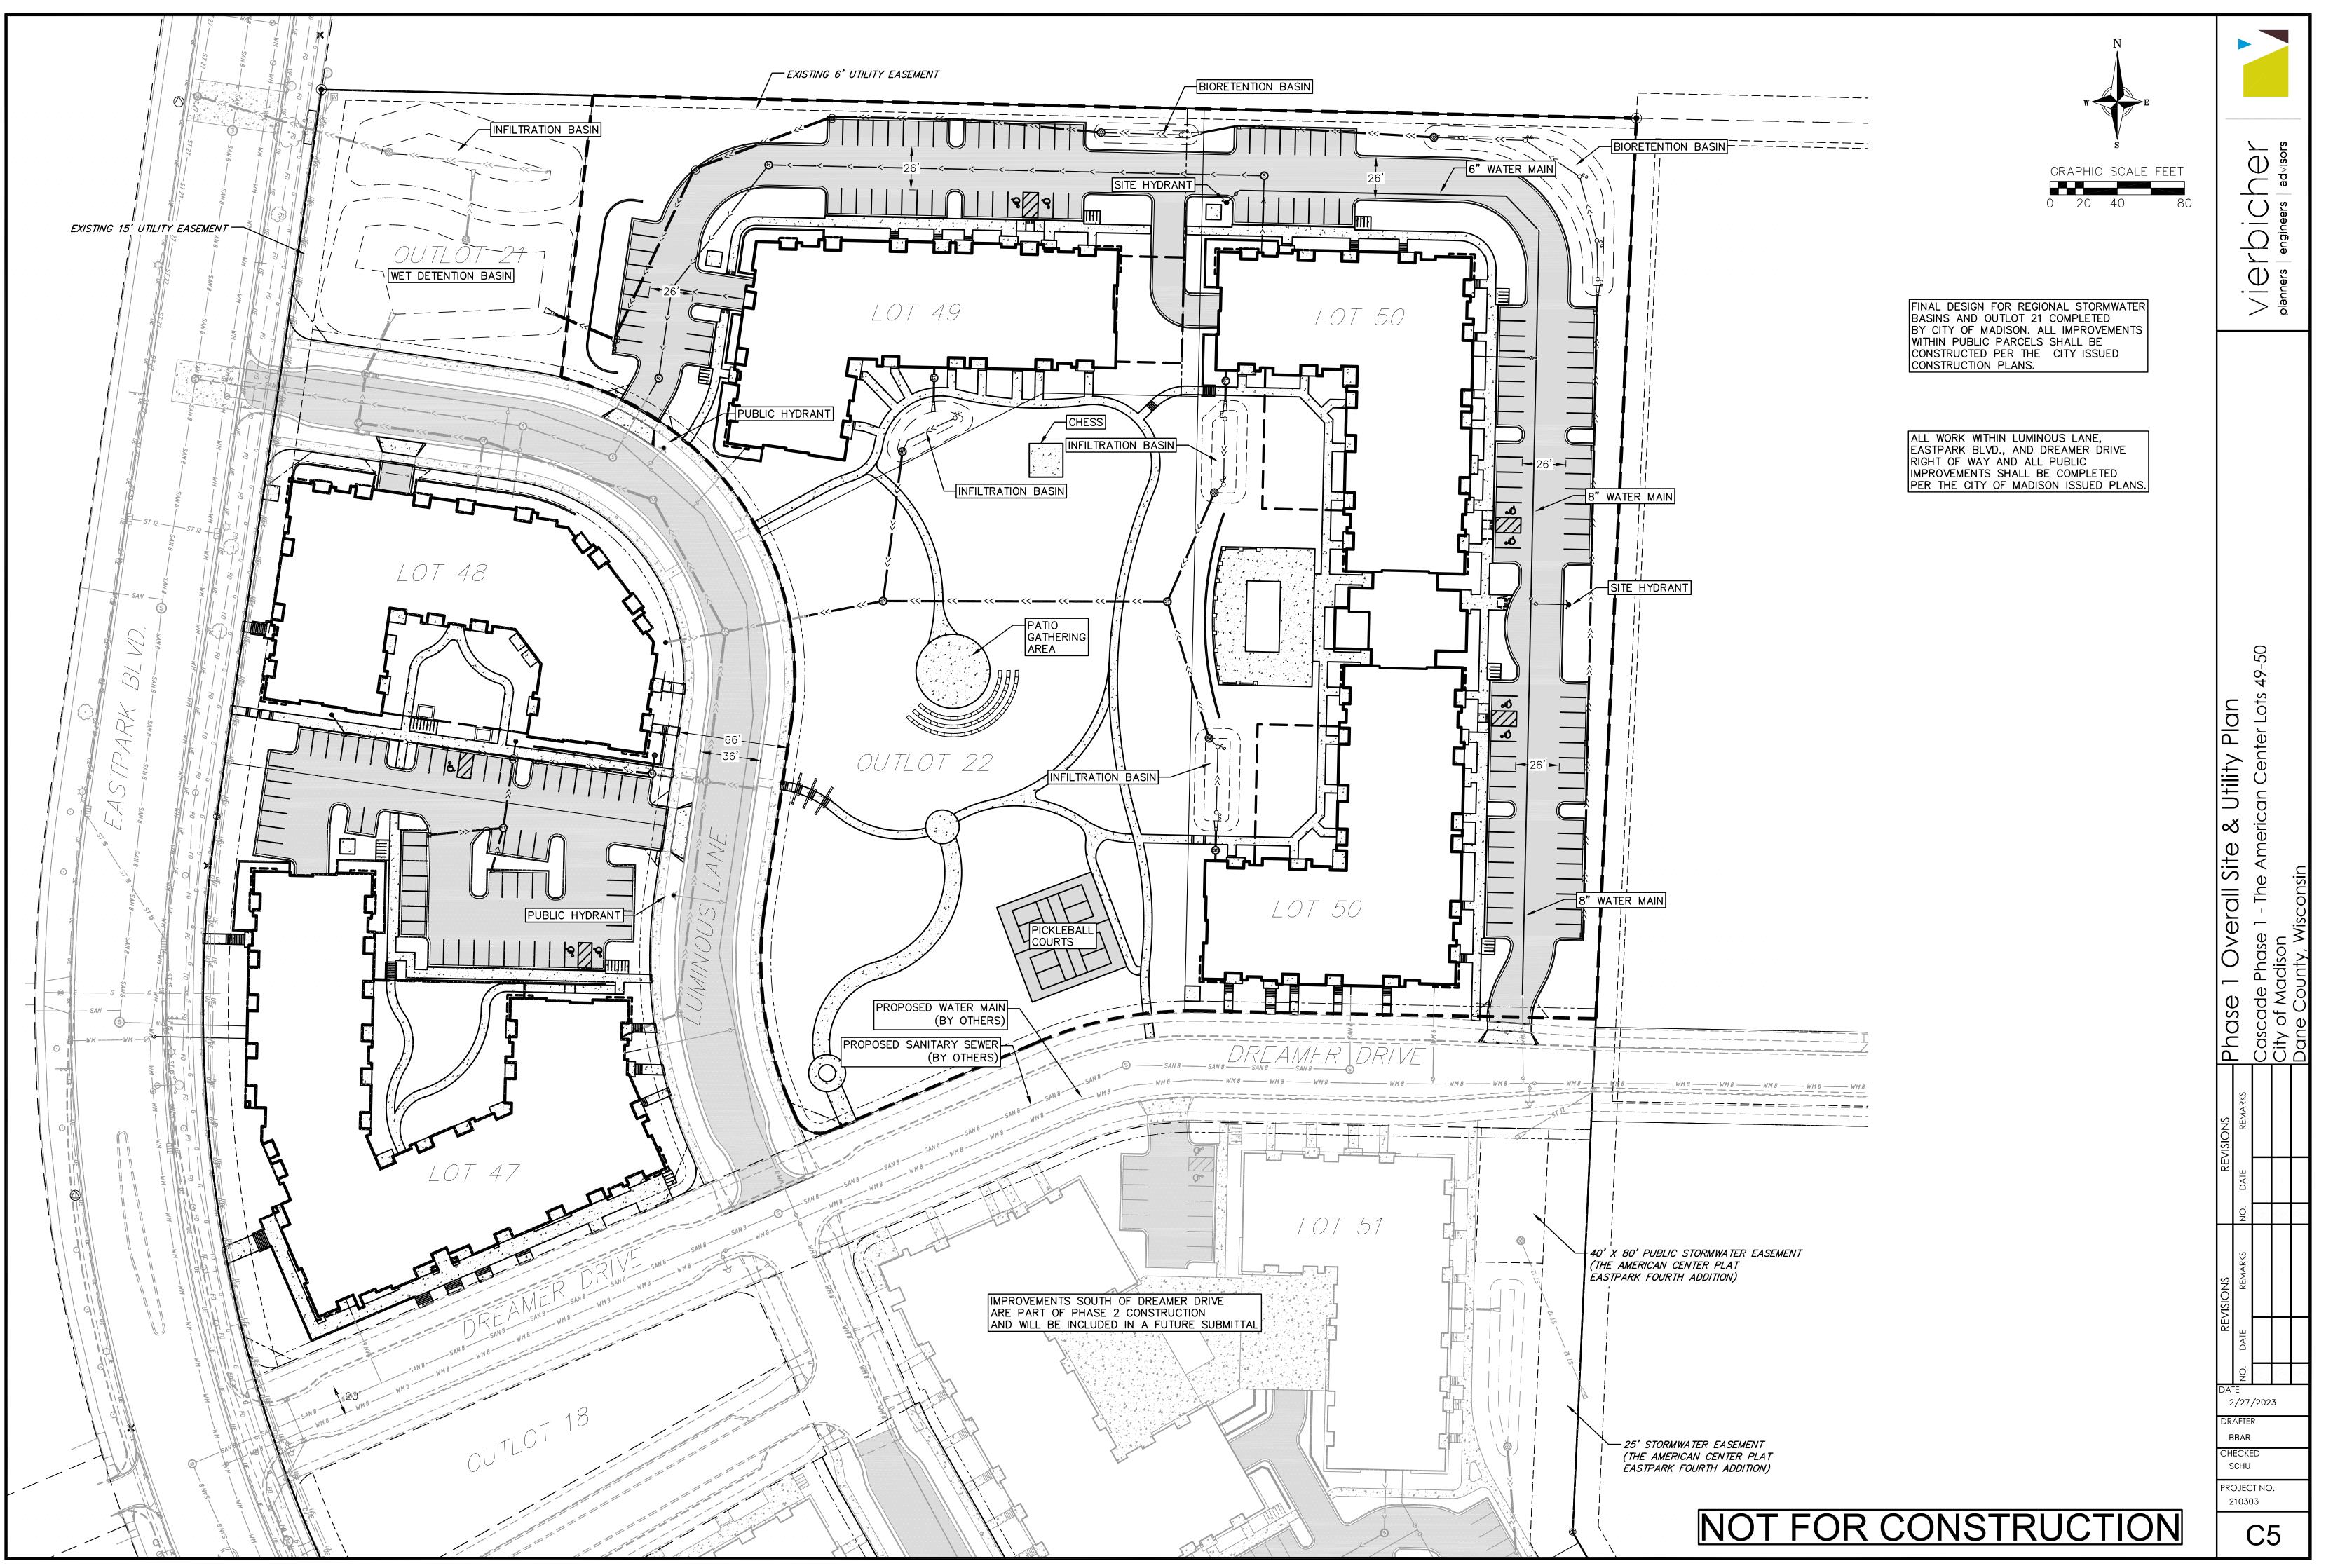		ST	FORM	PIPE	TABLE			
PIPE NAME	PIPE TYPE	SIZE (IN.)	FROM	то	LENGTH (FT)	START INV	END INV	SLOPE
P4	RCP	12	S9	S10	81	911.27	914.77	4.32%
P5	RCP	12	S10	S11	79	914.77	916.50	2.18%
P6	RCP	12	S27	S22	16	925.40	925.48	0.50%
P7	RCP	12	S22	S23	81	925.48	925.88	0.50%
P8	RCP	12	S23	S24	176	925.88	926.76	0.50%
P10	RCP	12	S381	S17	47	909.34	909.81	1.00%
P11	RCP	12	S17	S16	169	909.81	923.18	7.92%
P12	RCP	12	S16	S14	85	923.18	926.00	3.32%
P13	RCP	12	S16	S15	70	923.18	926.00	4.00%
P14	RCP	12	S17	S18	90	909.81	916.00	6.91%
P17	RCP	12	S29	S20	18	928.50	928.68	1.00%
P18	RCP	12	S20		6	928.68	928.74	1.00%

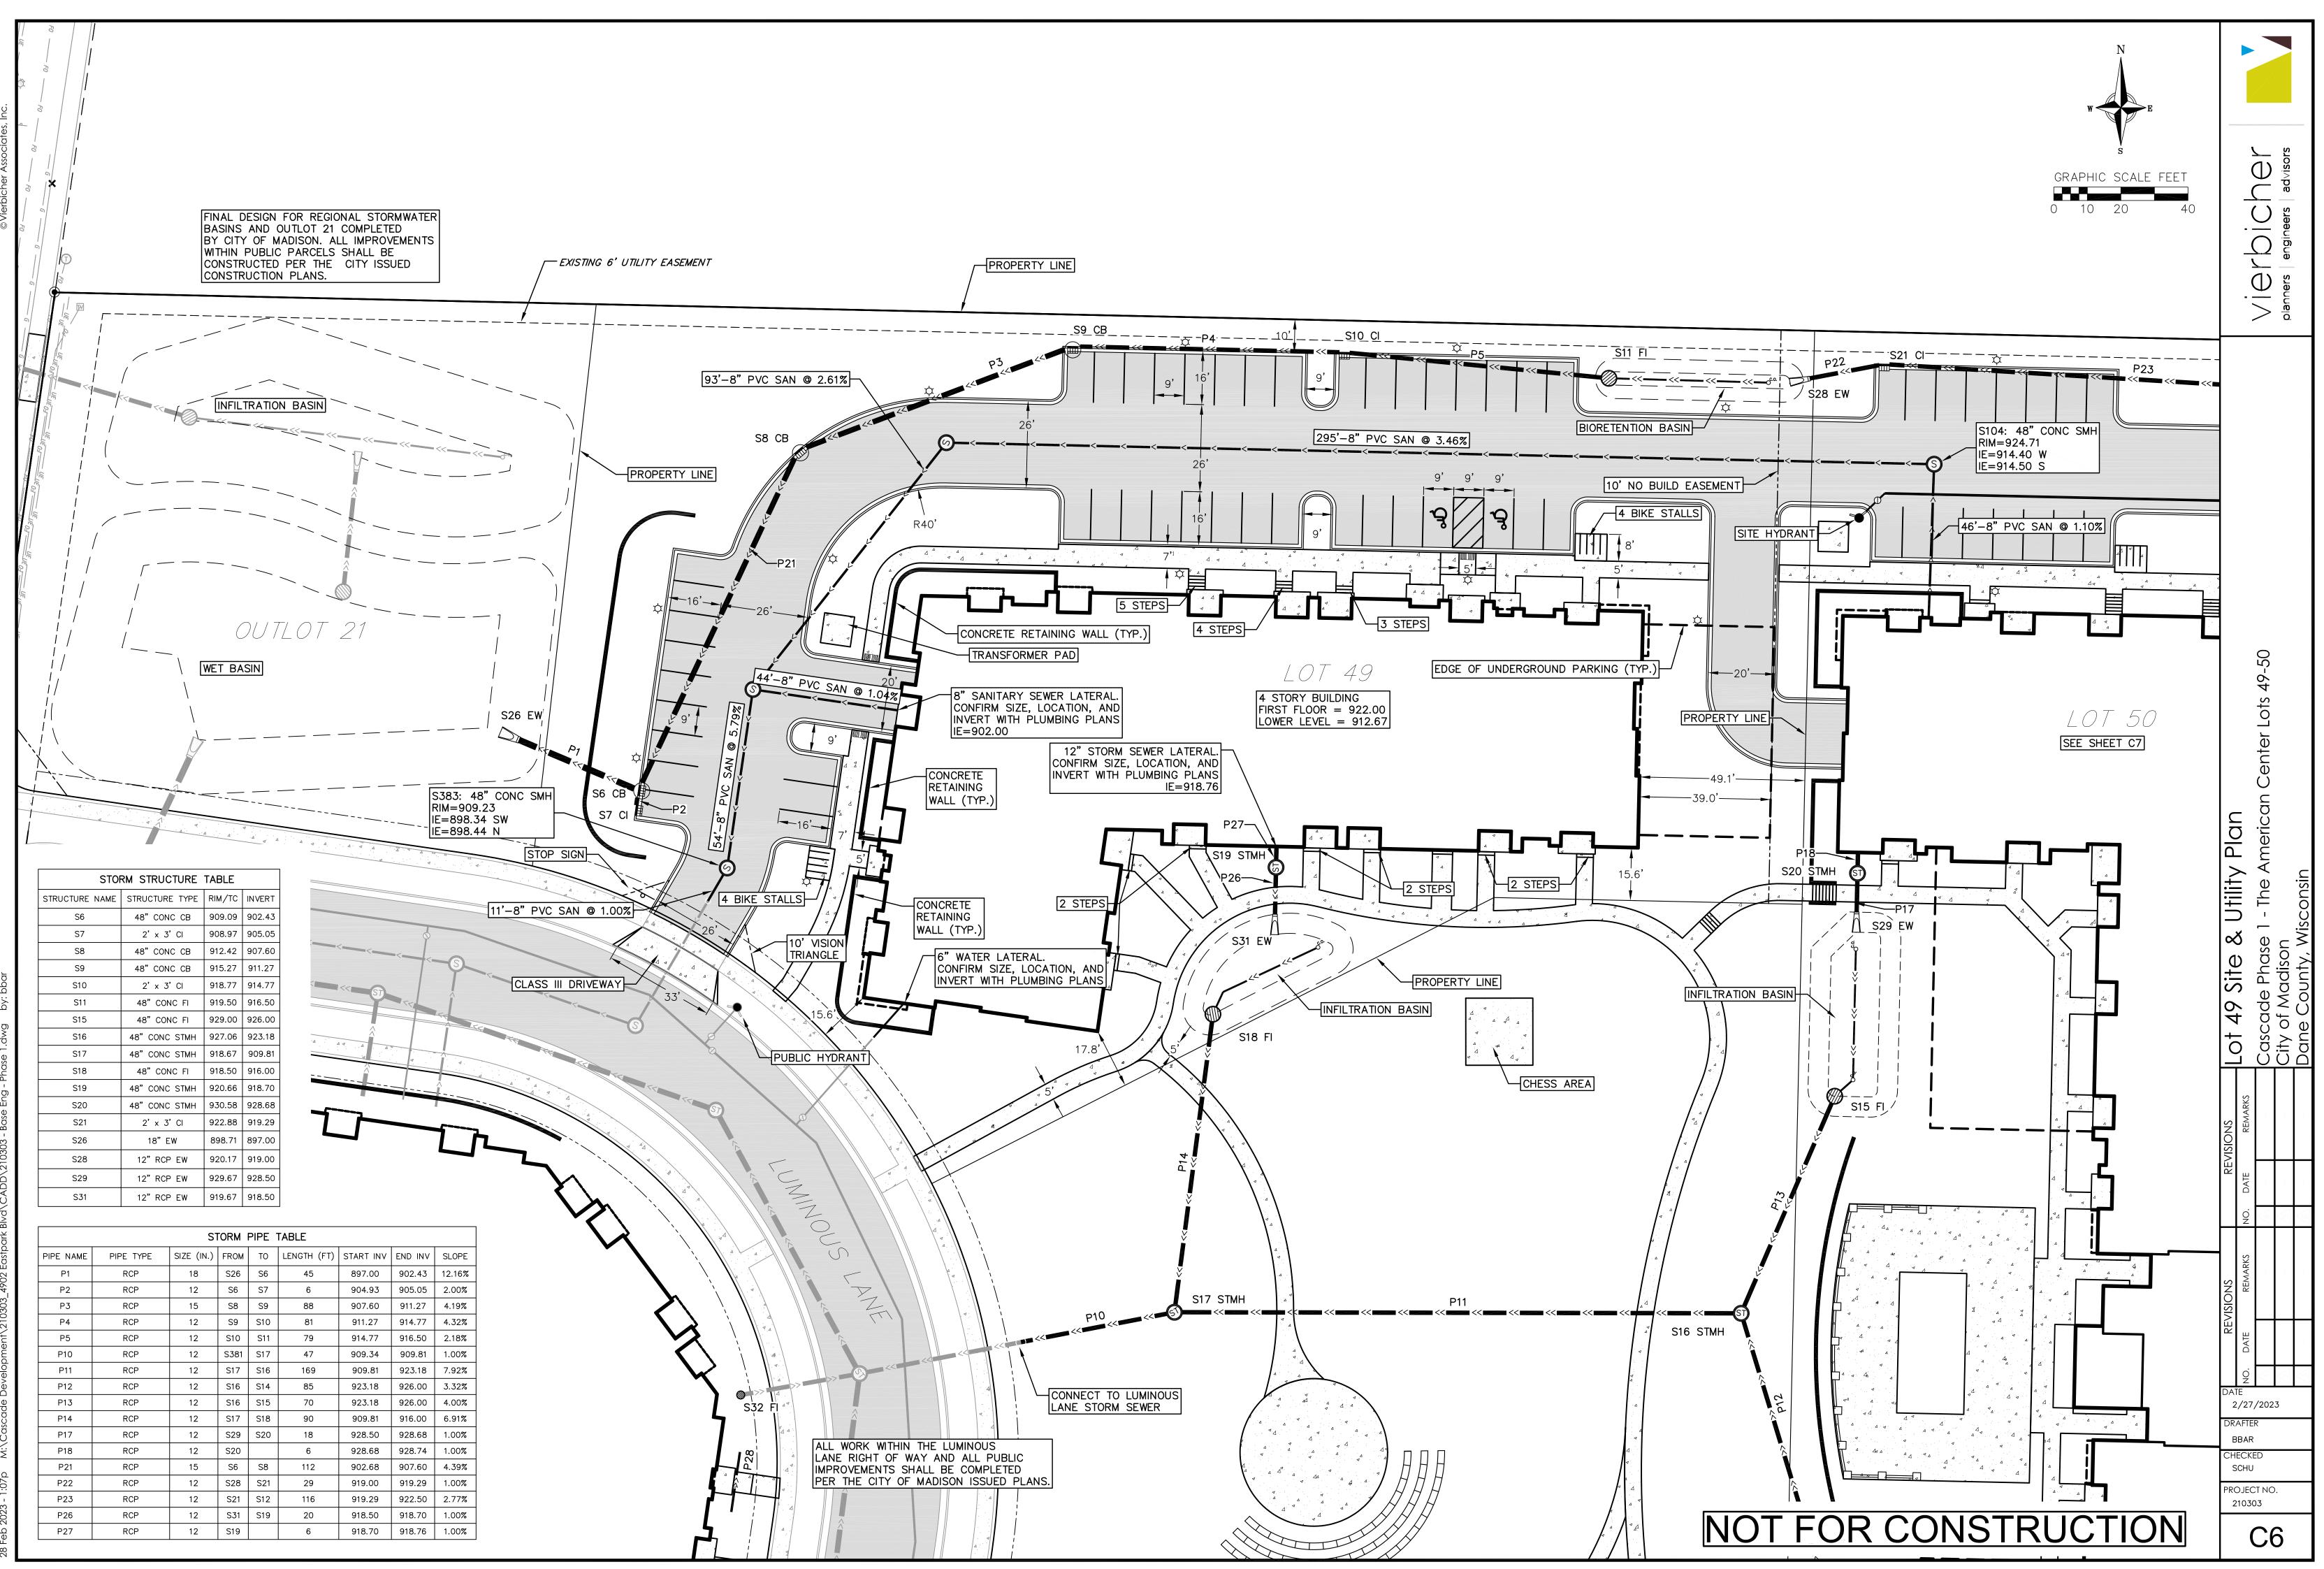
STO	RM STRUCTURE	TABLE	
STRUCTURE NAME	STRUCTURE TYPE	RIM/TC	INVERT
S9	48" CONC CB	915.27	911.27
S10	2' x 3' Cl	918.77	914.77
S11	48" CONC FI	919.50	916.50
S12	48" CONC FI	926.50	922.50
S13	48" CONC STMH	930.92	928.68
S14	48" CONC FI	929.00	926.00
S15	48" CONC FI	929.00	926.00
S16	48" CONC STMH	927.06	923.18
S17	48" CONC STMH	918.67	909.81
S18	48" CONC FI	918.50	916.00
S19	48" CONC STMH	920.66	918.70
S20	48" CONC STMH	930.58	928.68
S21	2' x 3' CI	922.88	919.29
S22	2' x 3' CI	929.75	925.48
S23	2' x 3' CI	930.38	925.88
S24	2' x 3' CI	931.33	926.76
S25	2' x 3' CI	930.17	927.43
S27	12" RCP EW	926.57	925.40
S28	12" RCP EW	920.17	919.00
S29	12" RCP EW	929.67	928.50
S30	12" RCP EW	929.67	928.50
S31	12" RCP EW	919.67	918.50




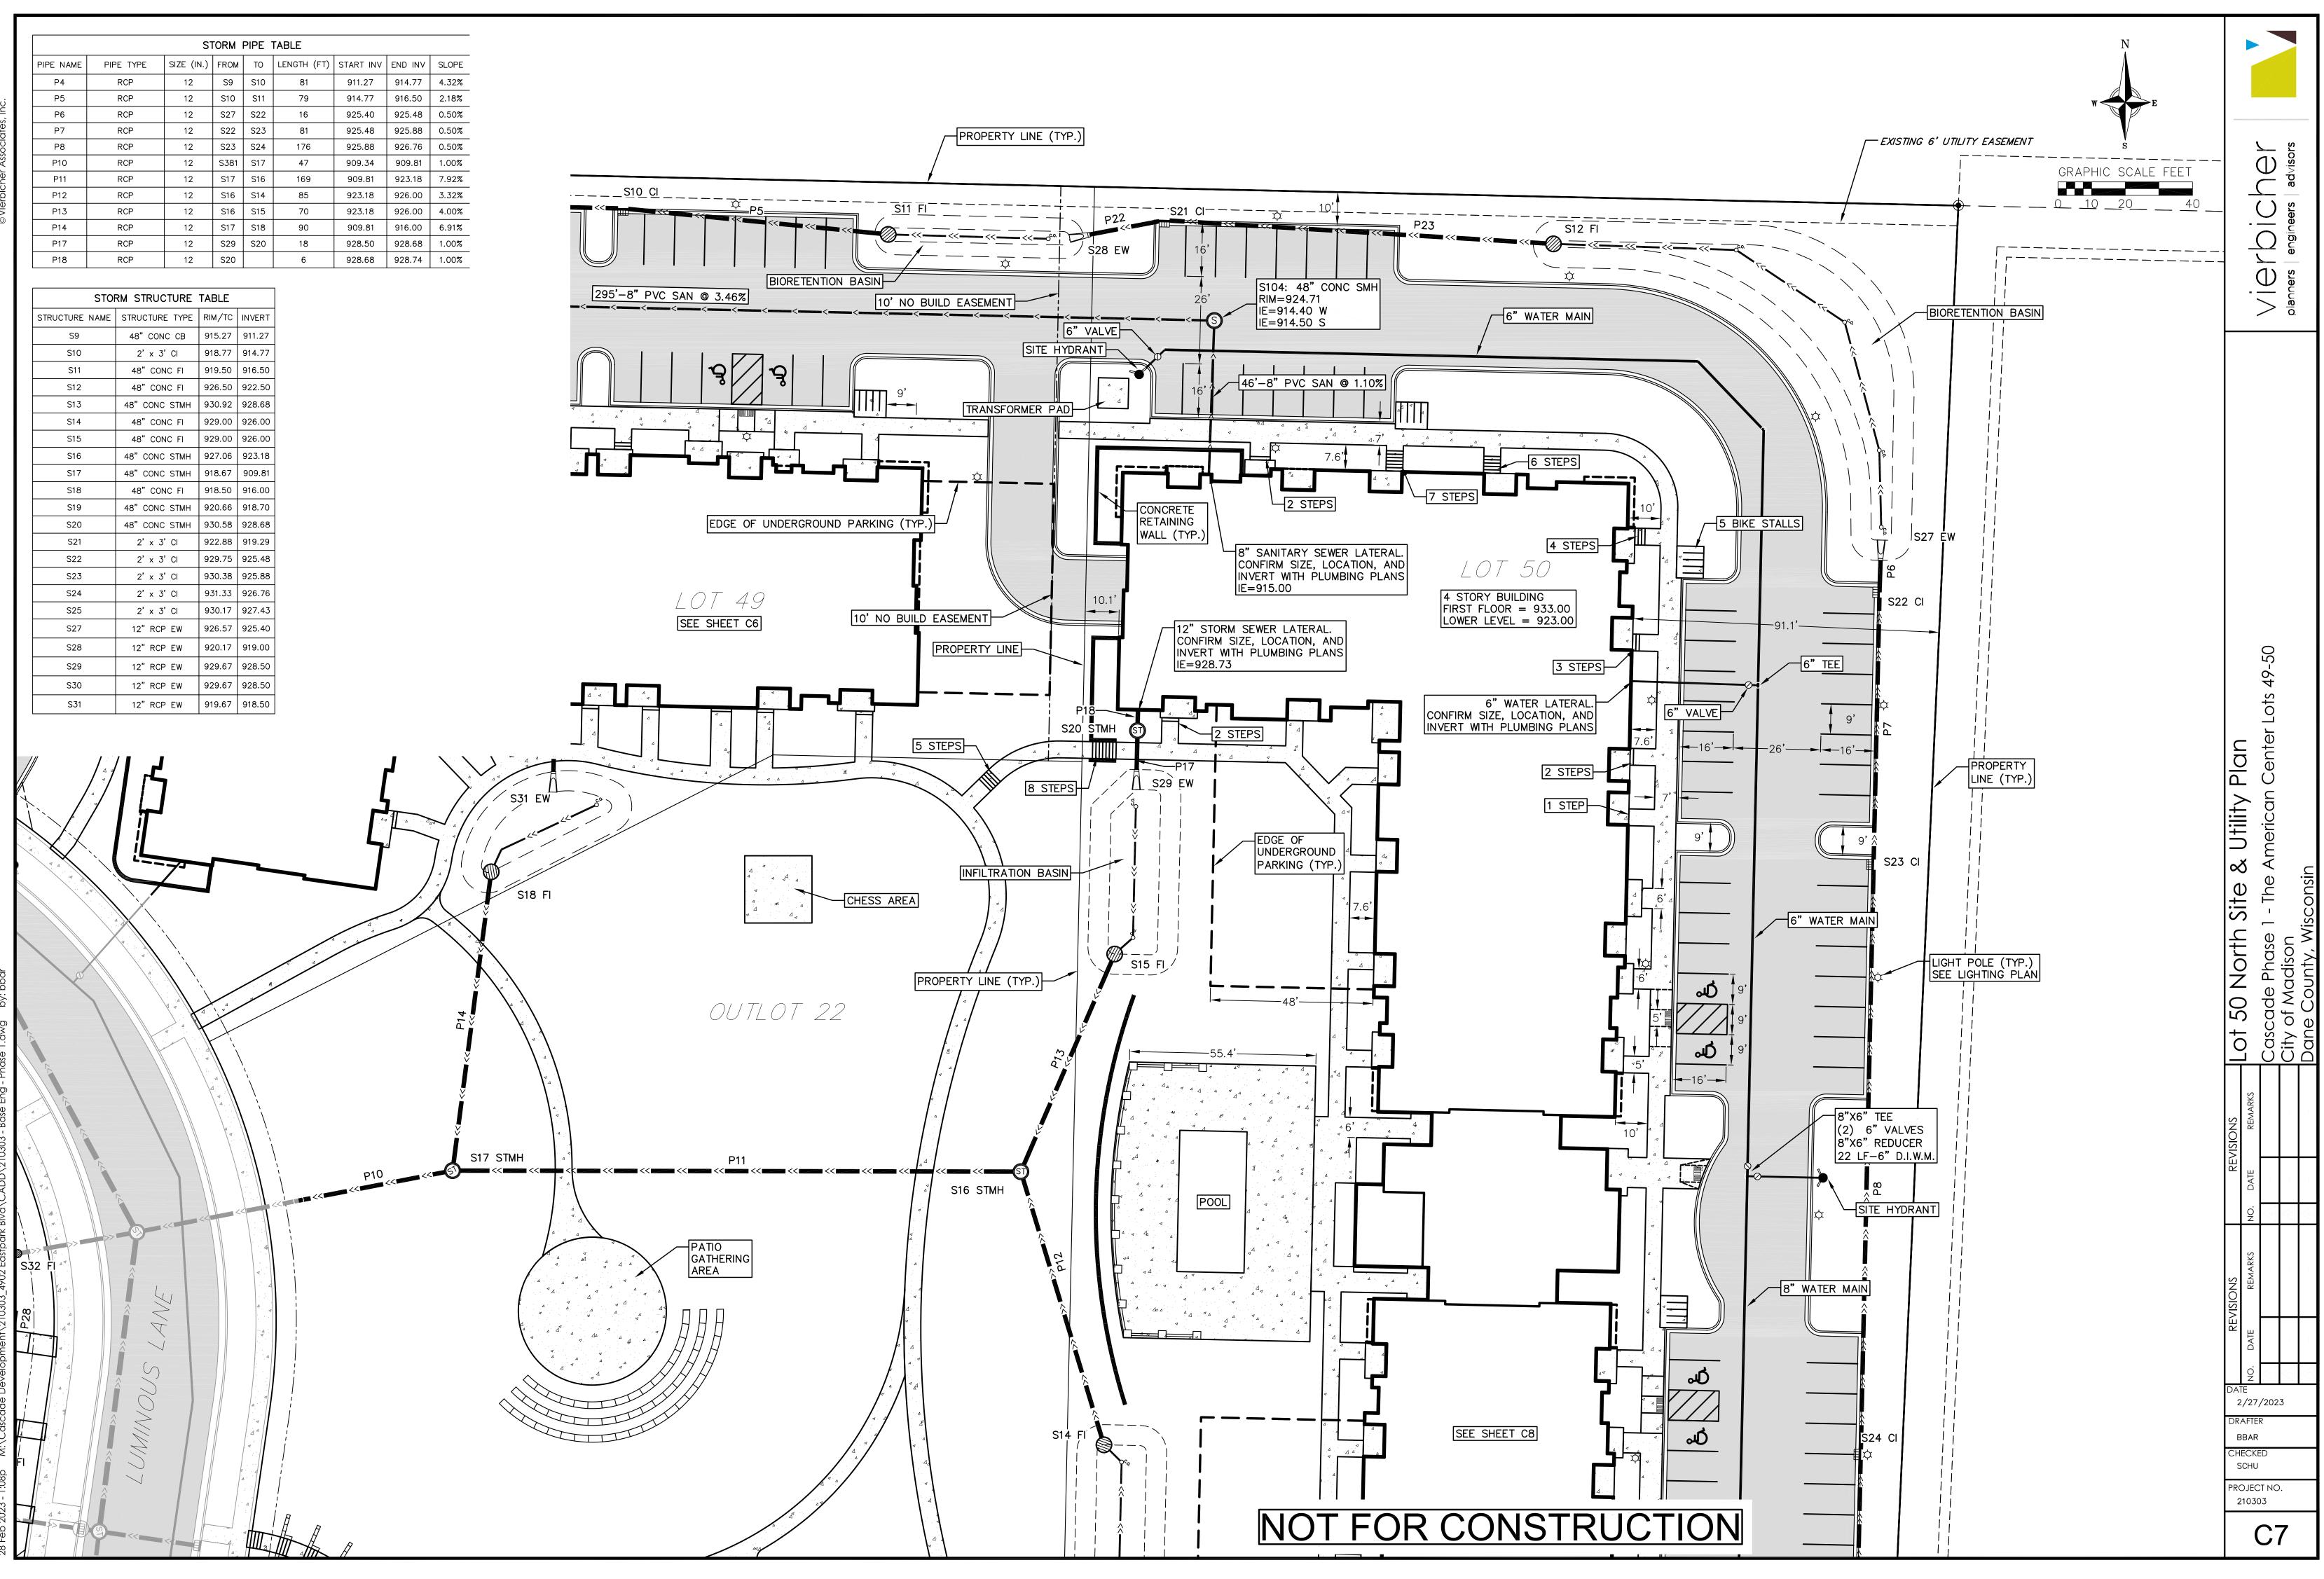


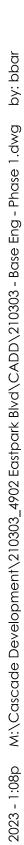




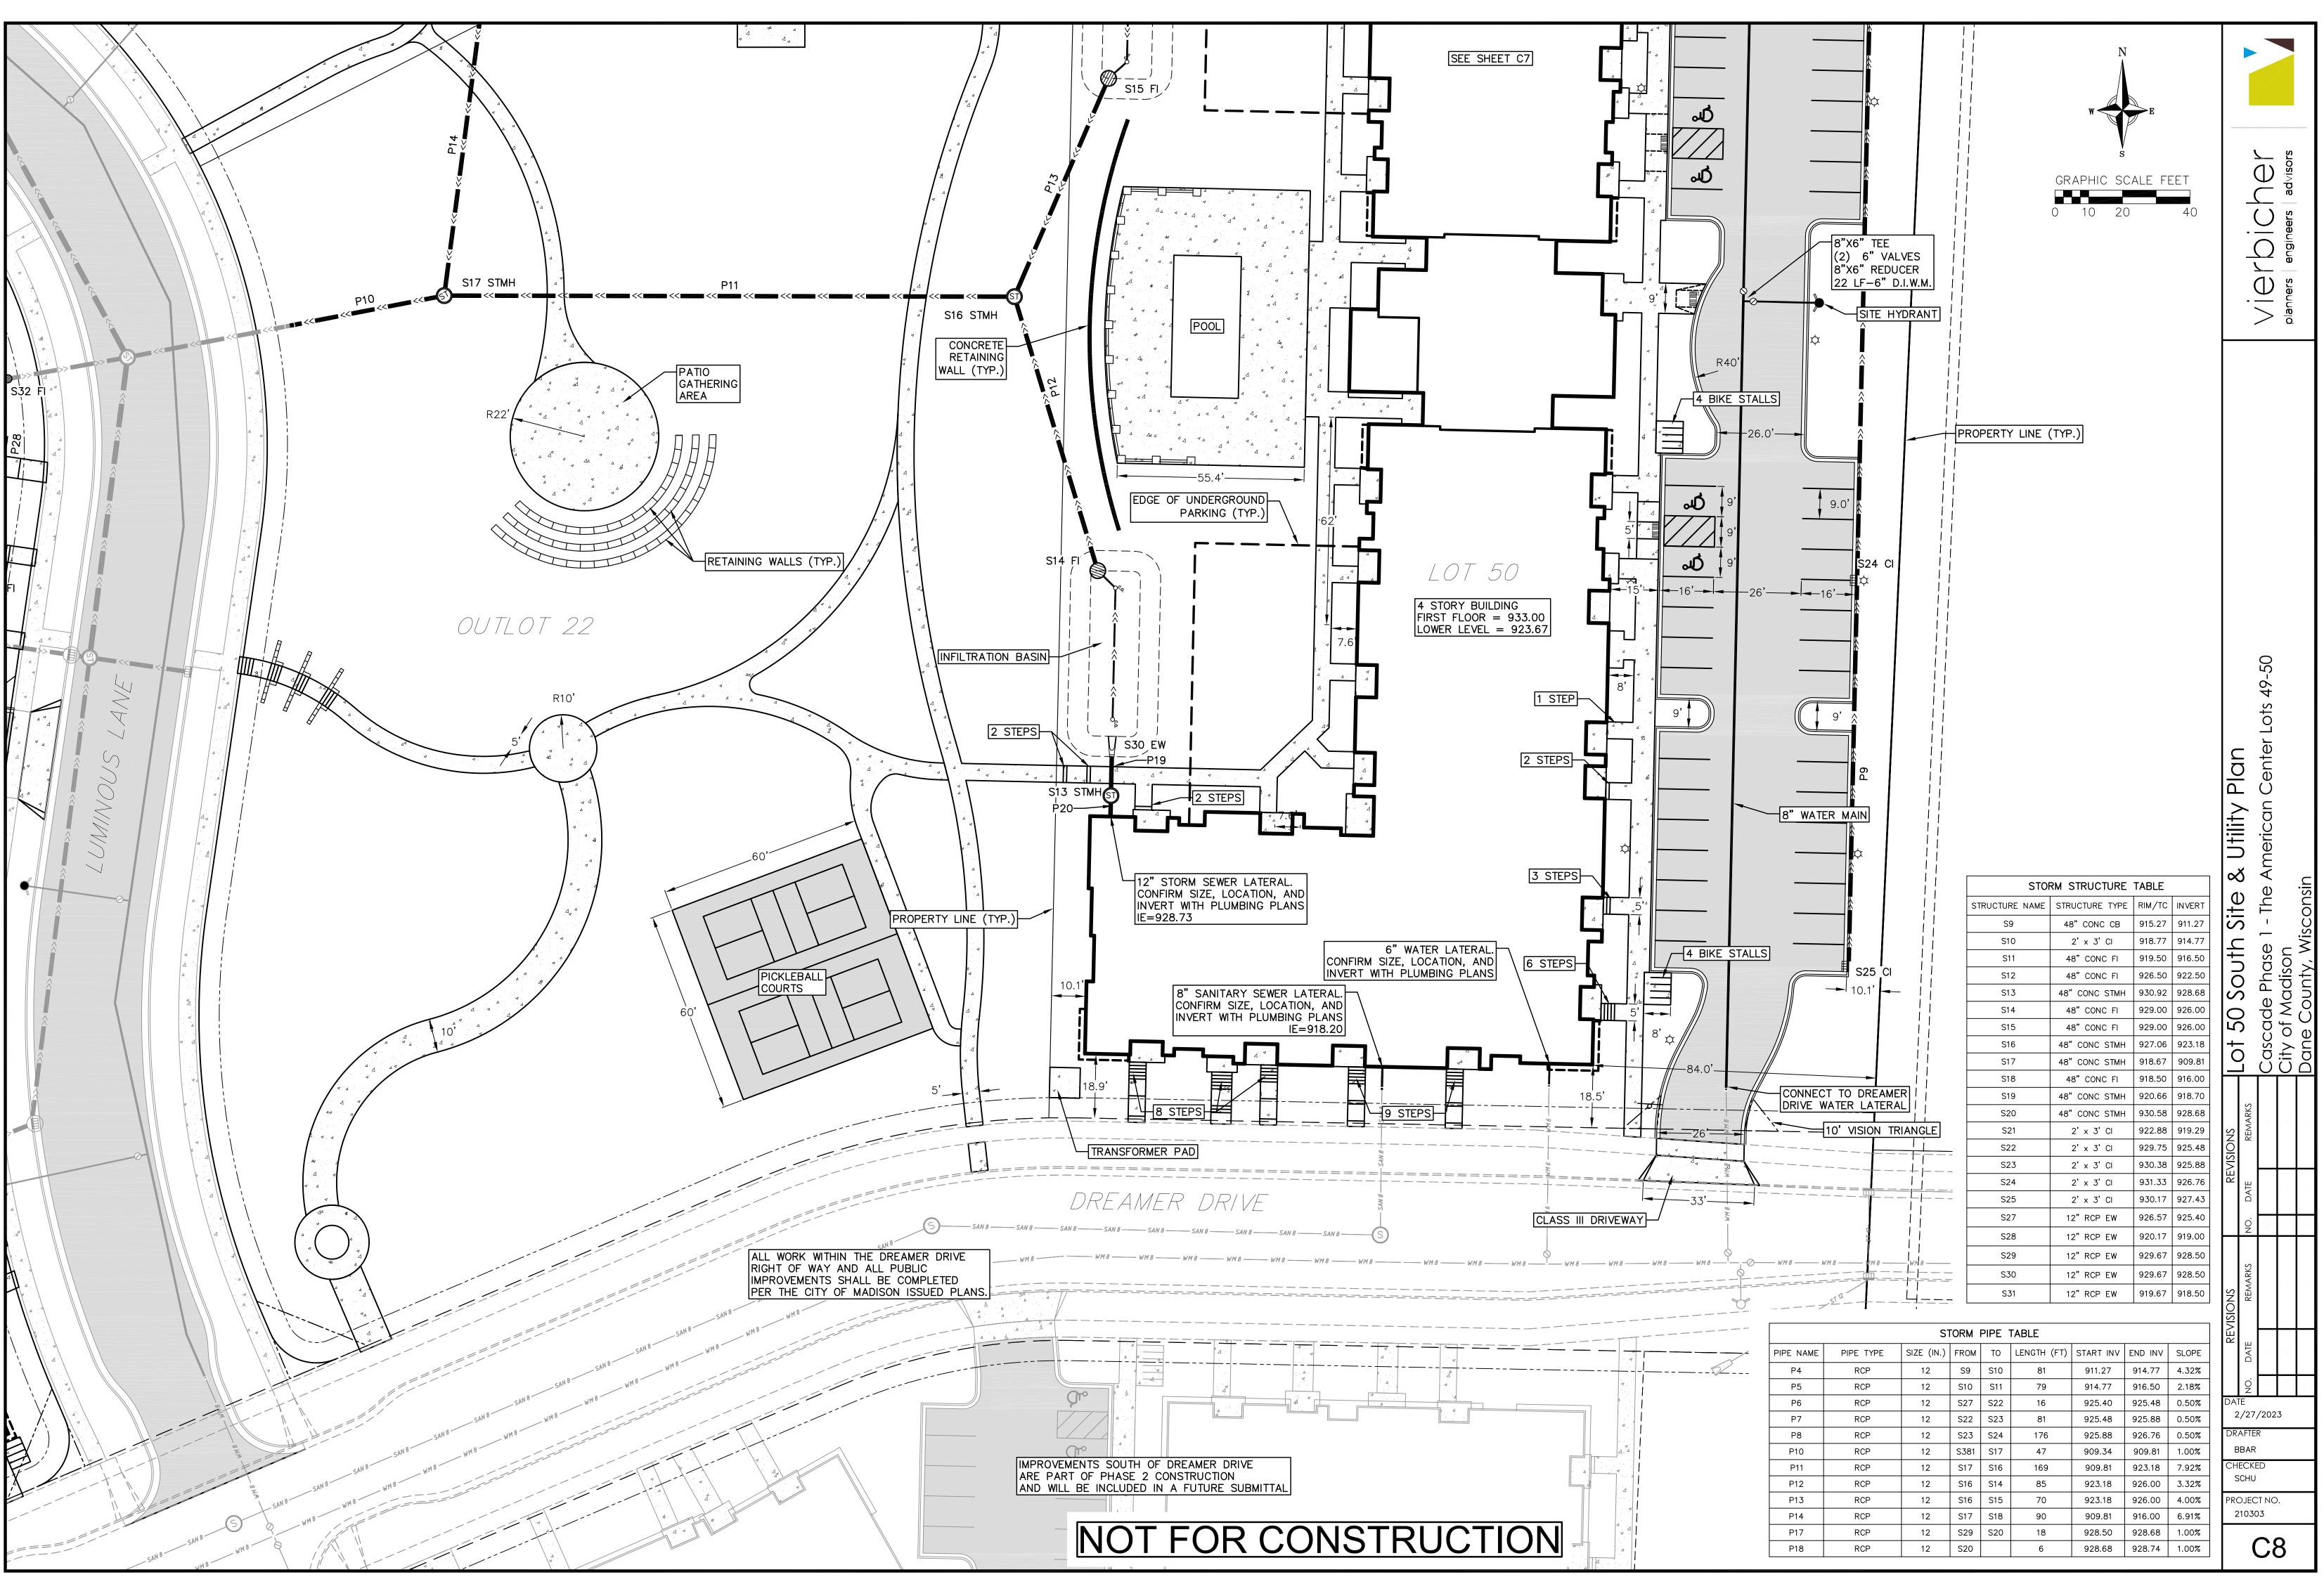

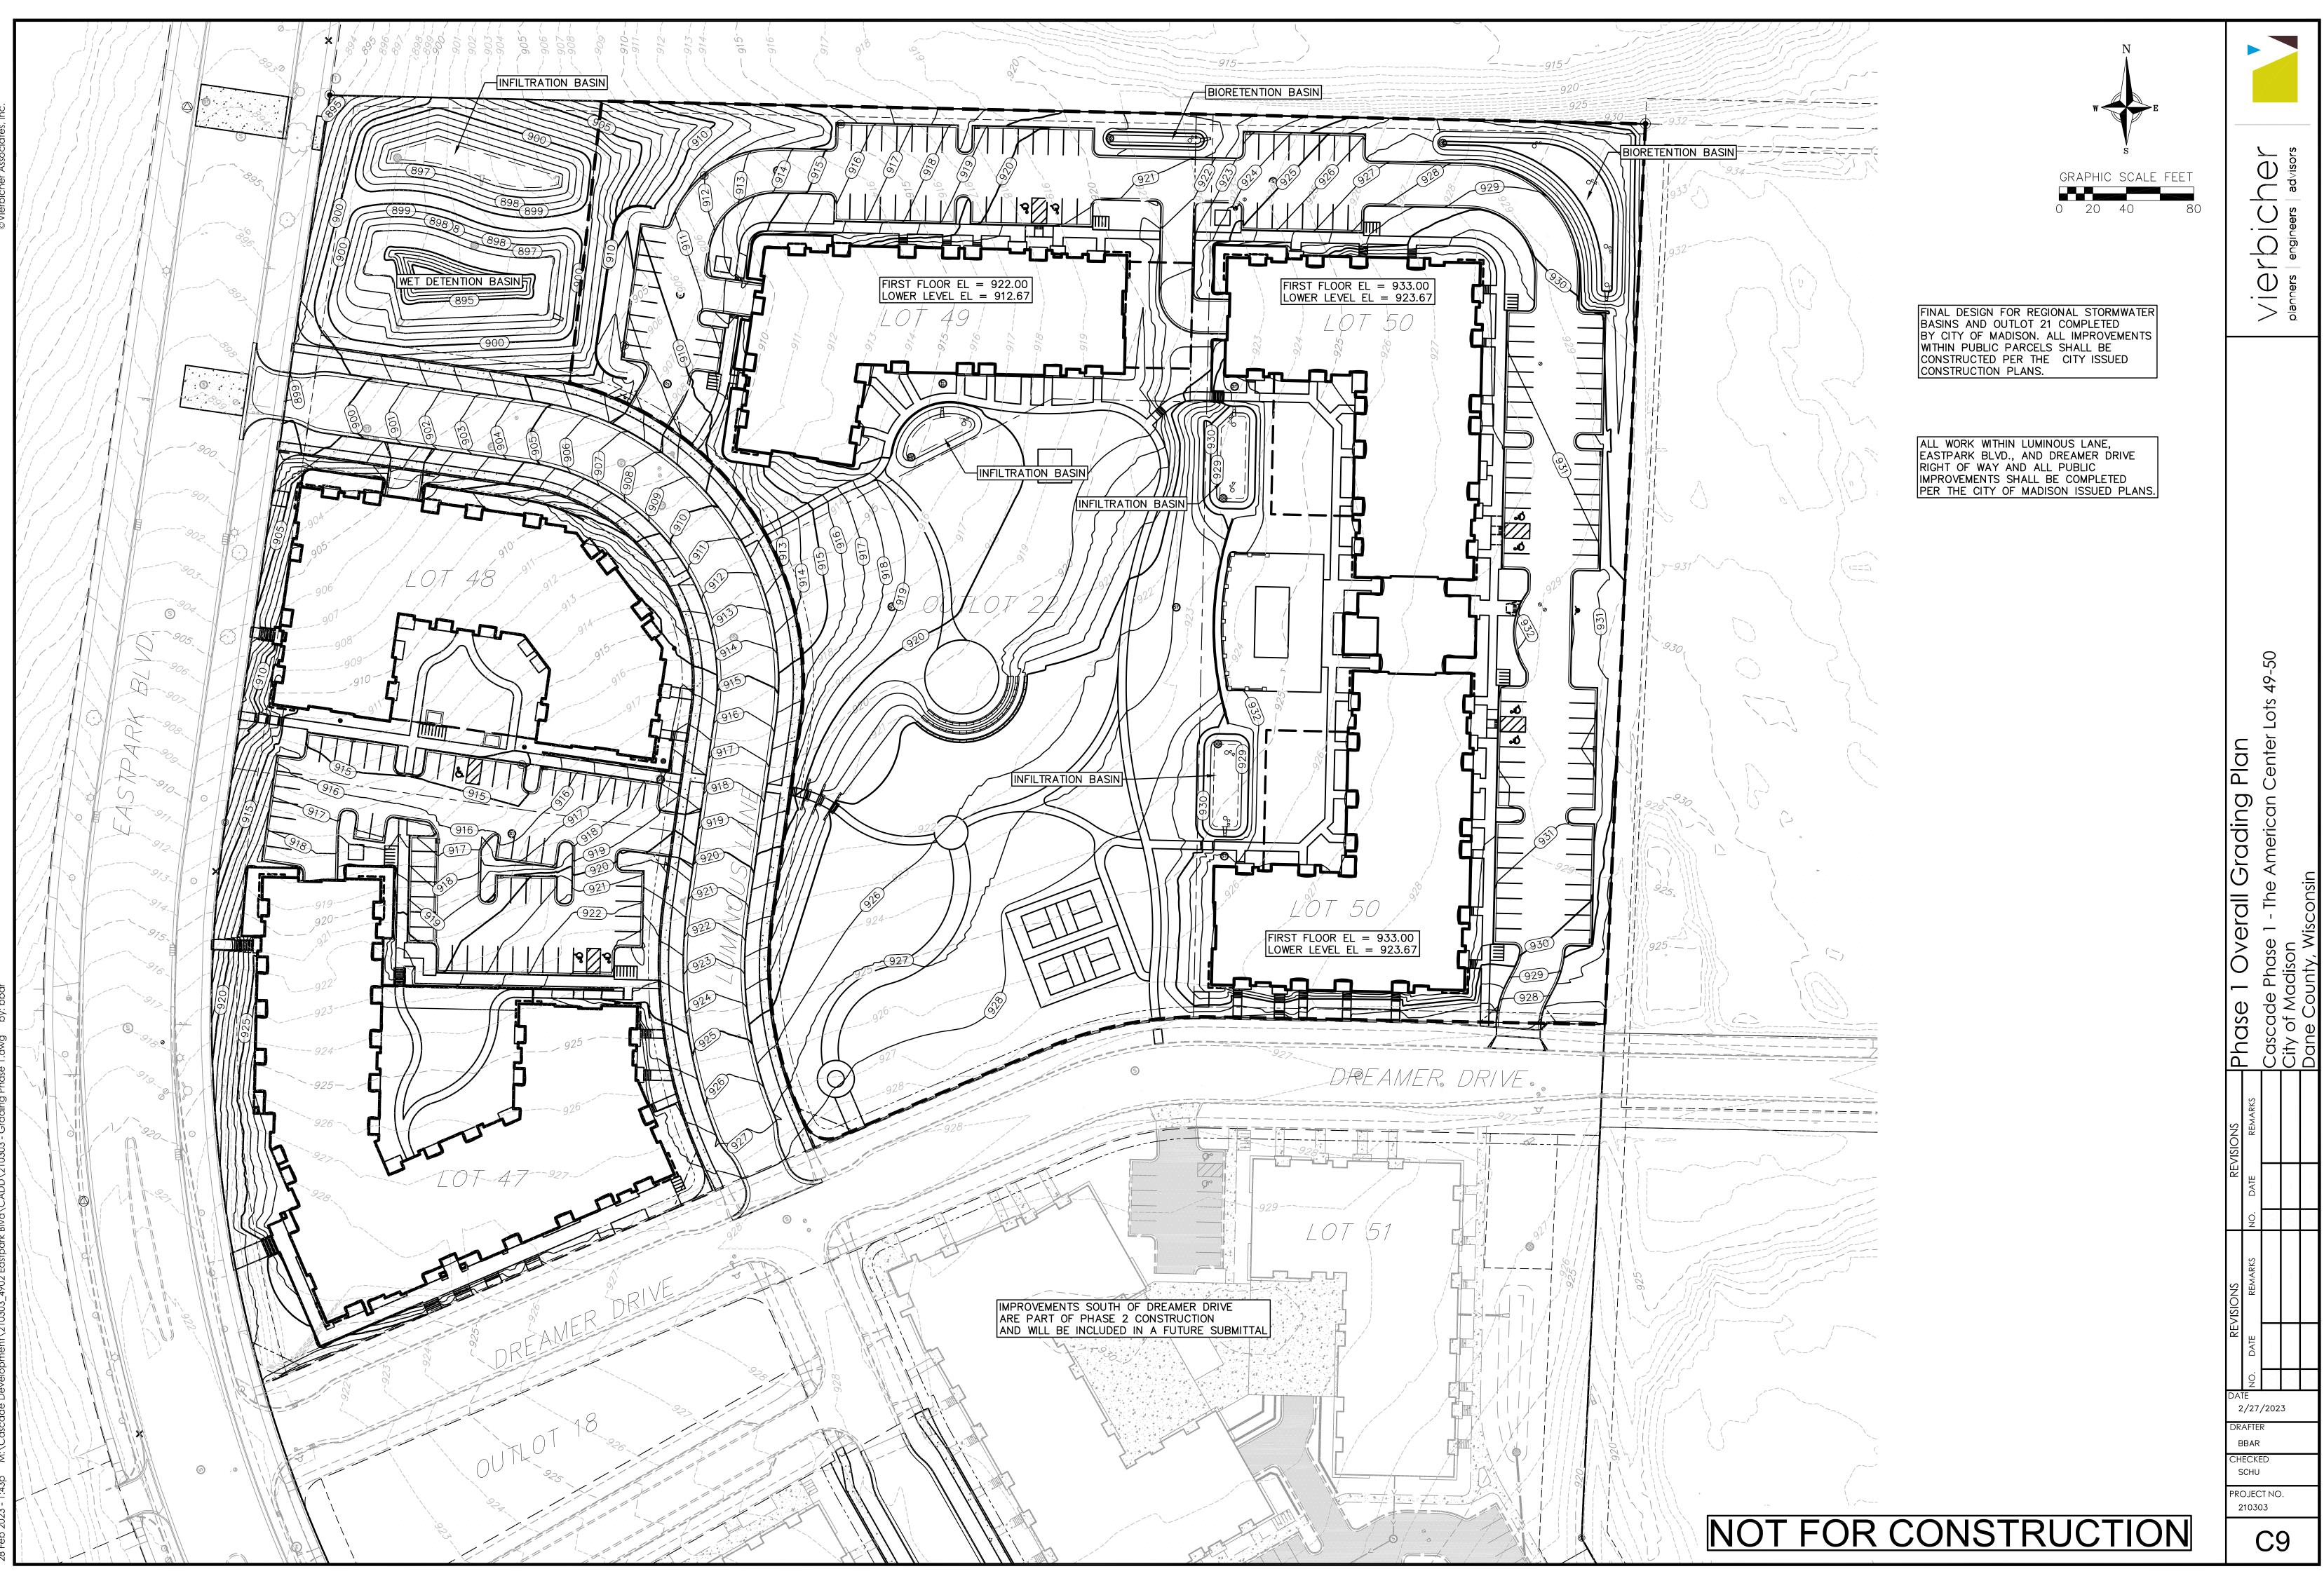


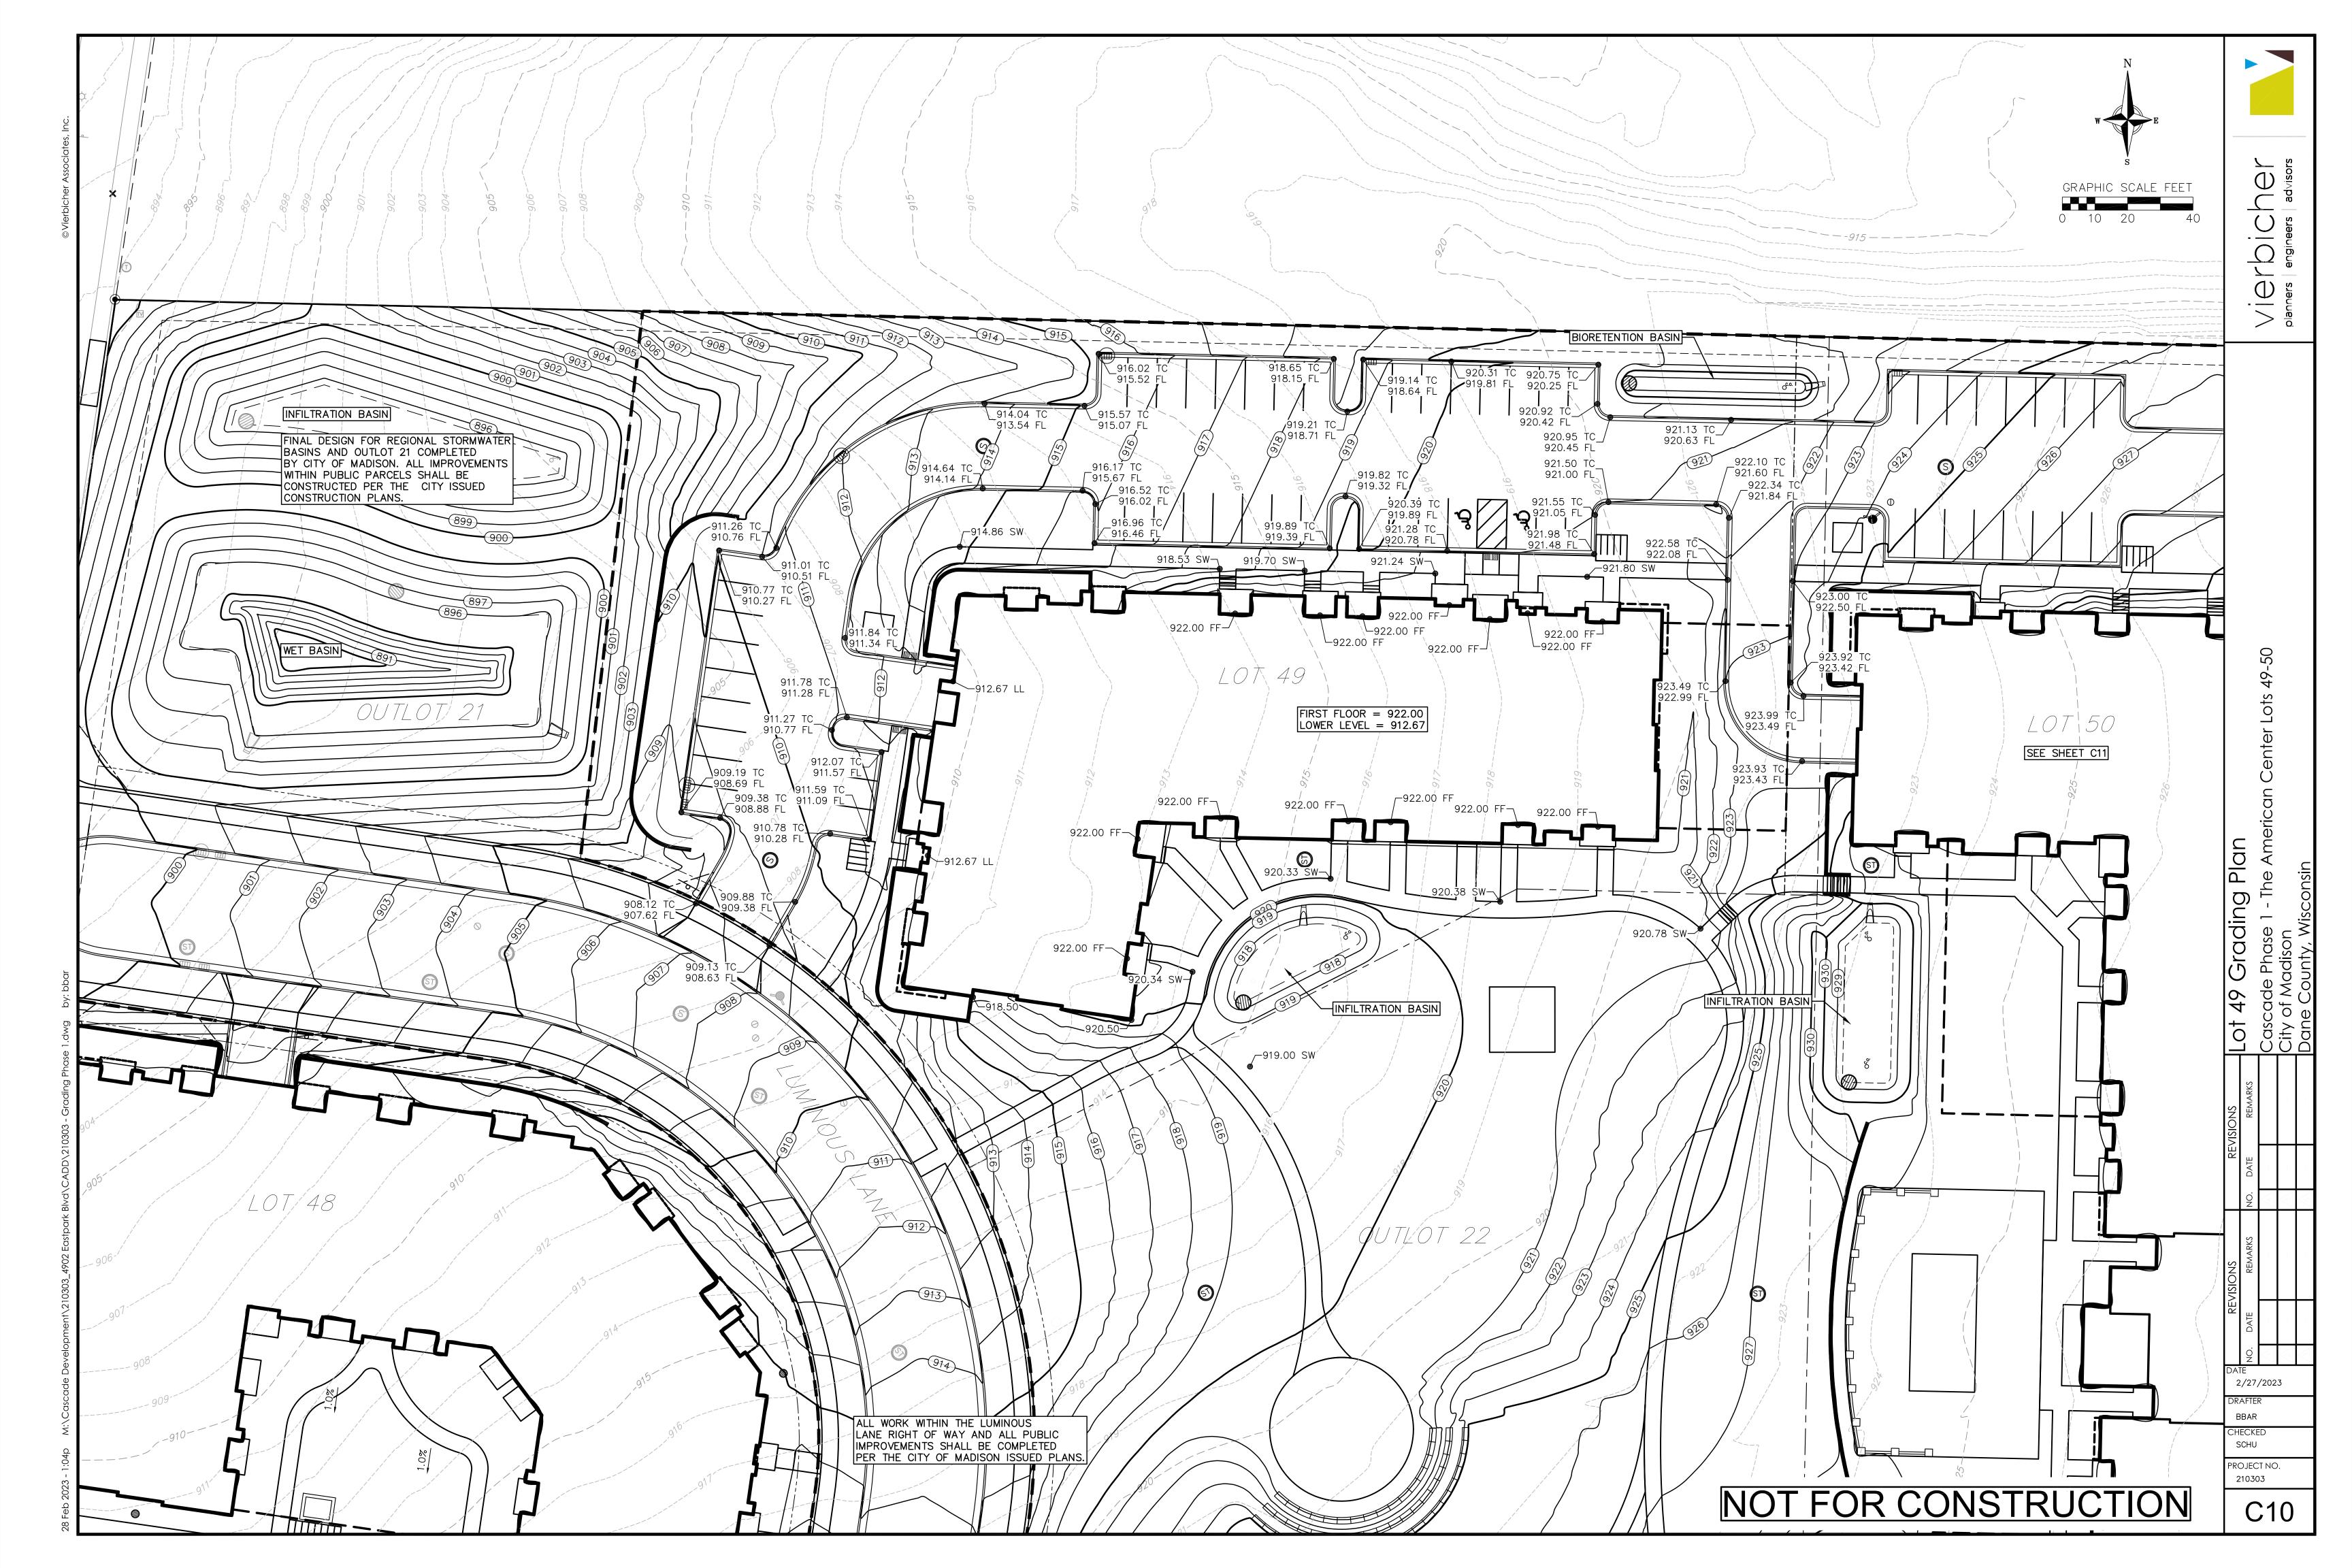





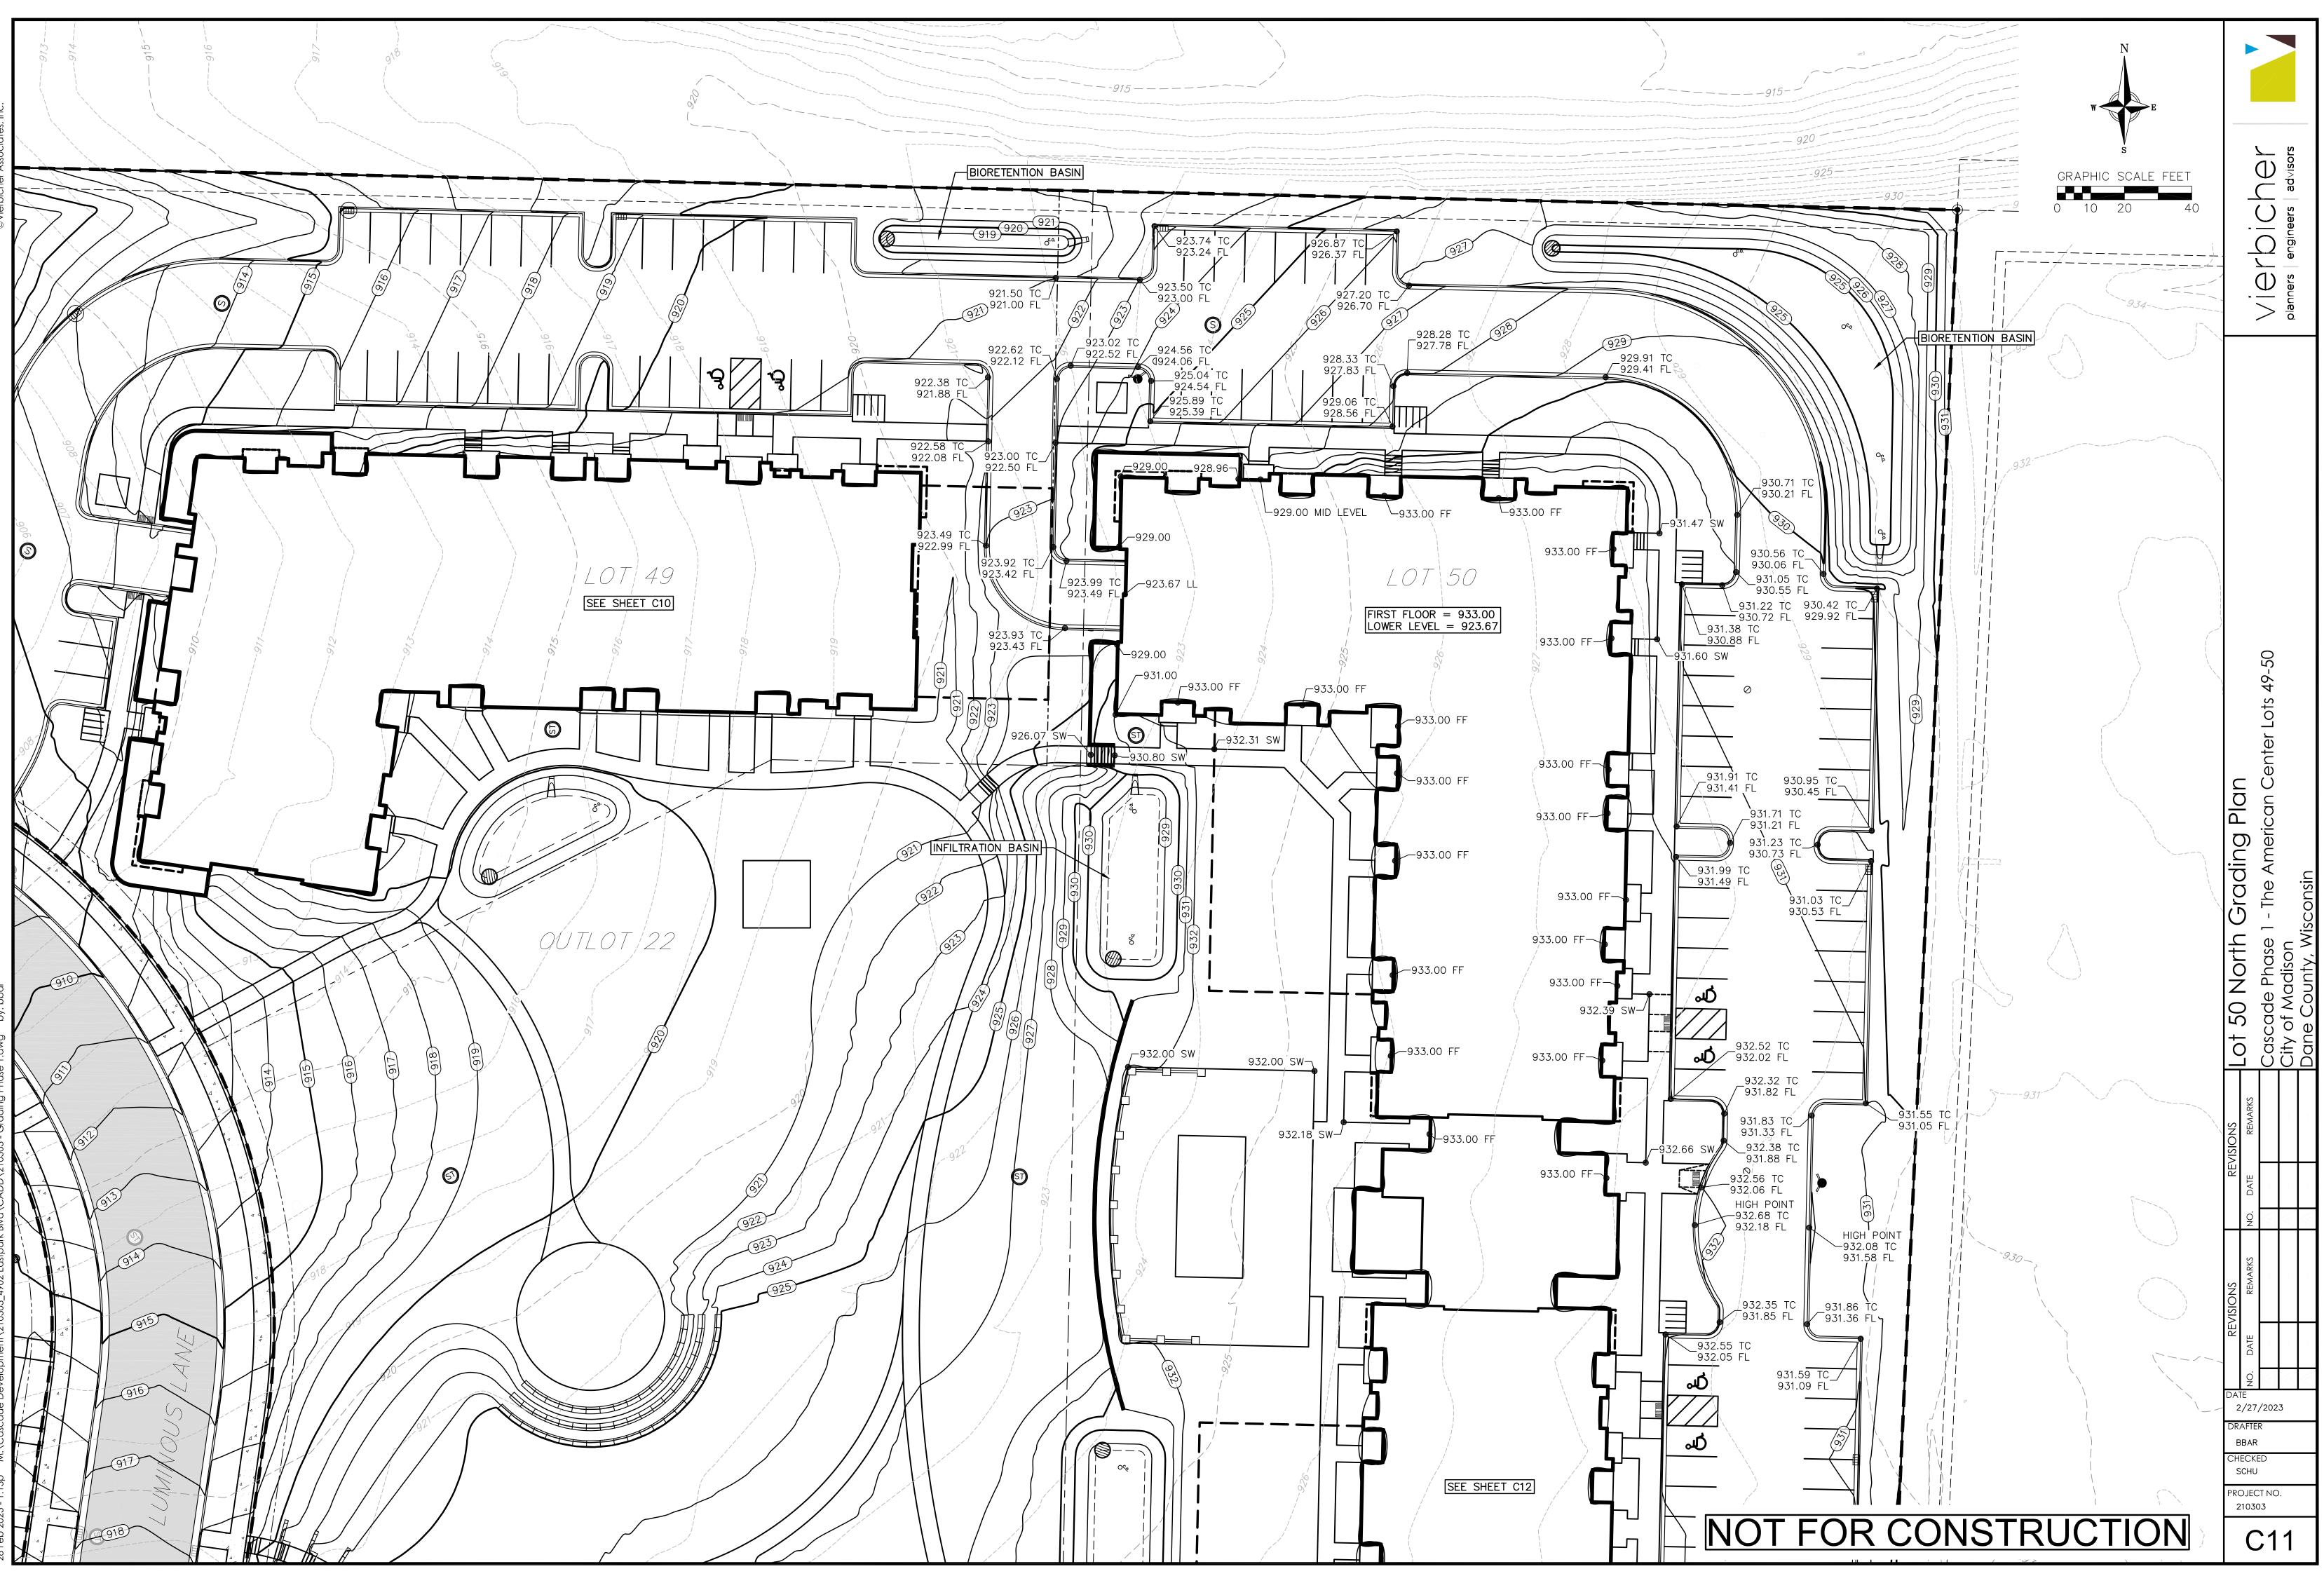


:8 Feb 2023 - 1:13p M:\Cascade Development\210303\_4902 Eastpark Blvd\CADD\210303 - Grading Phase 1.dwg b

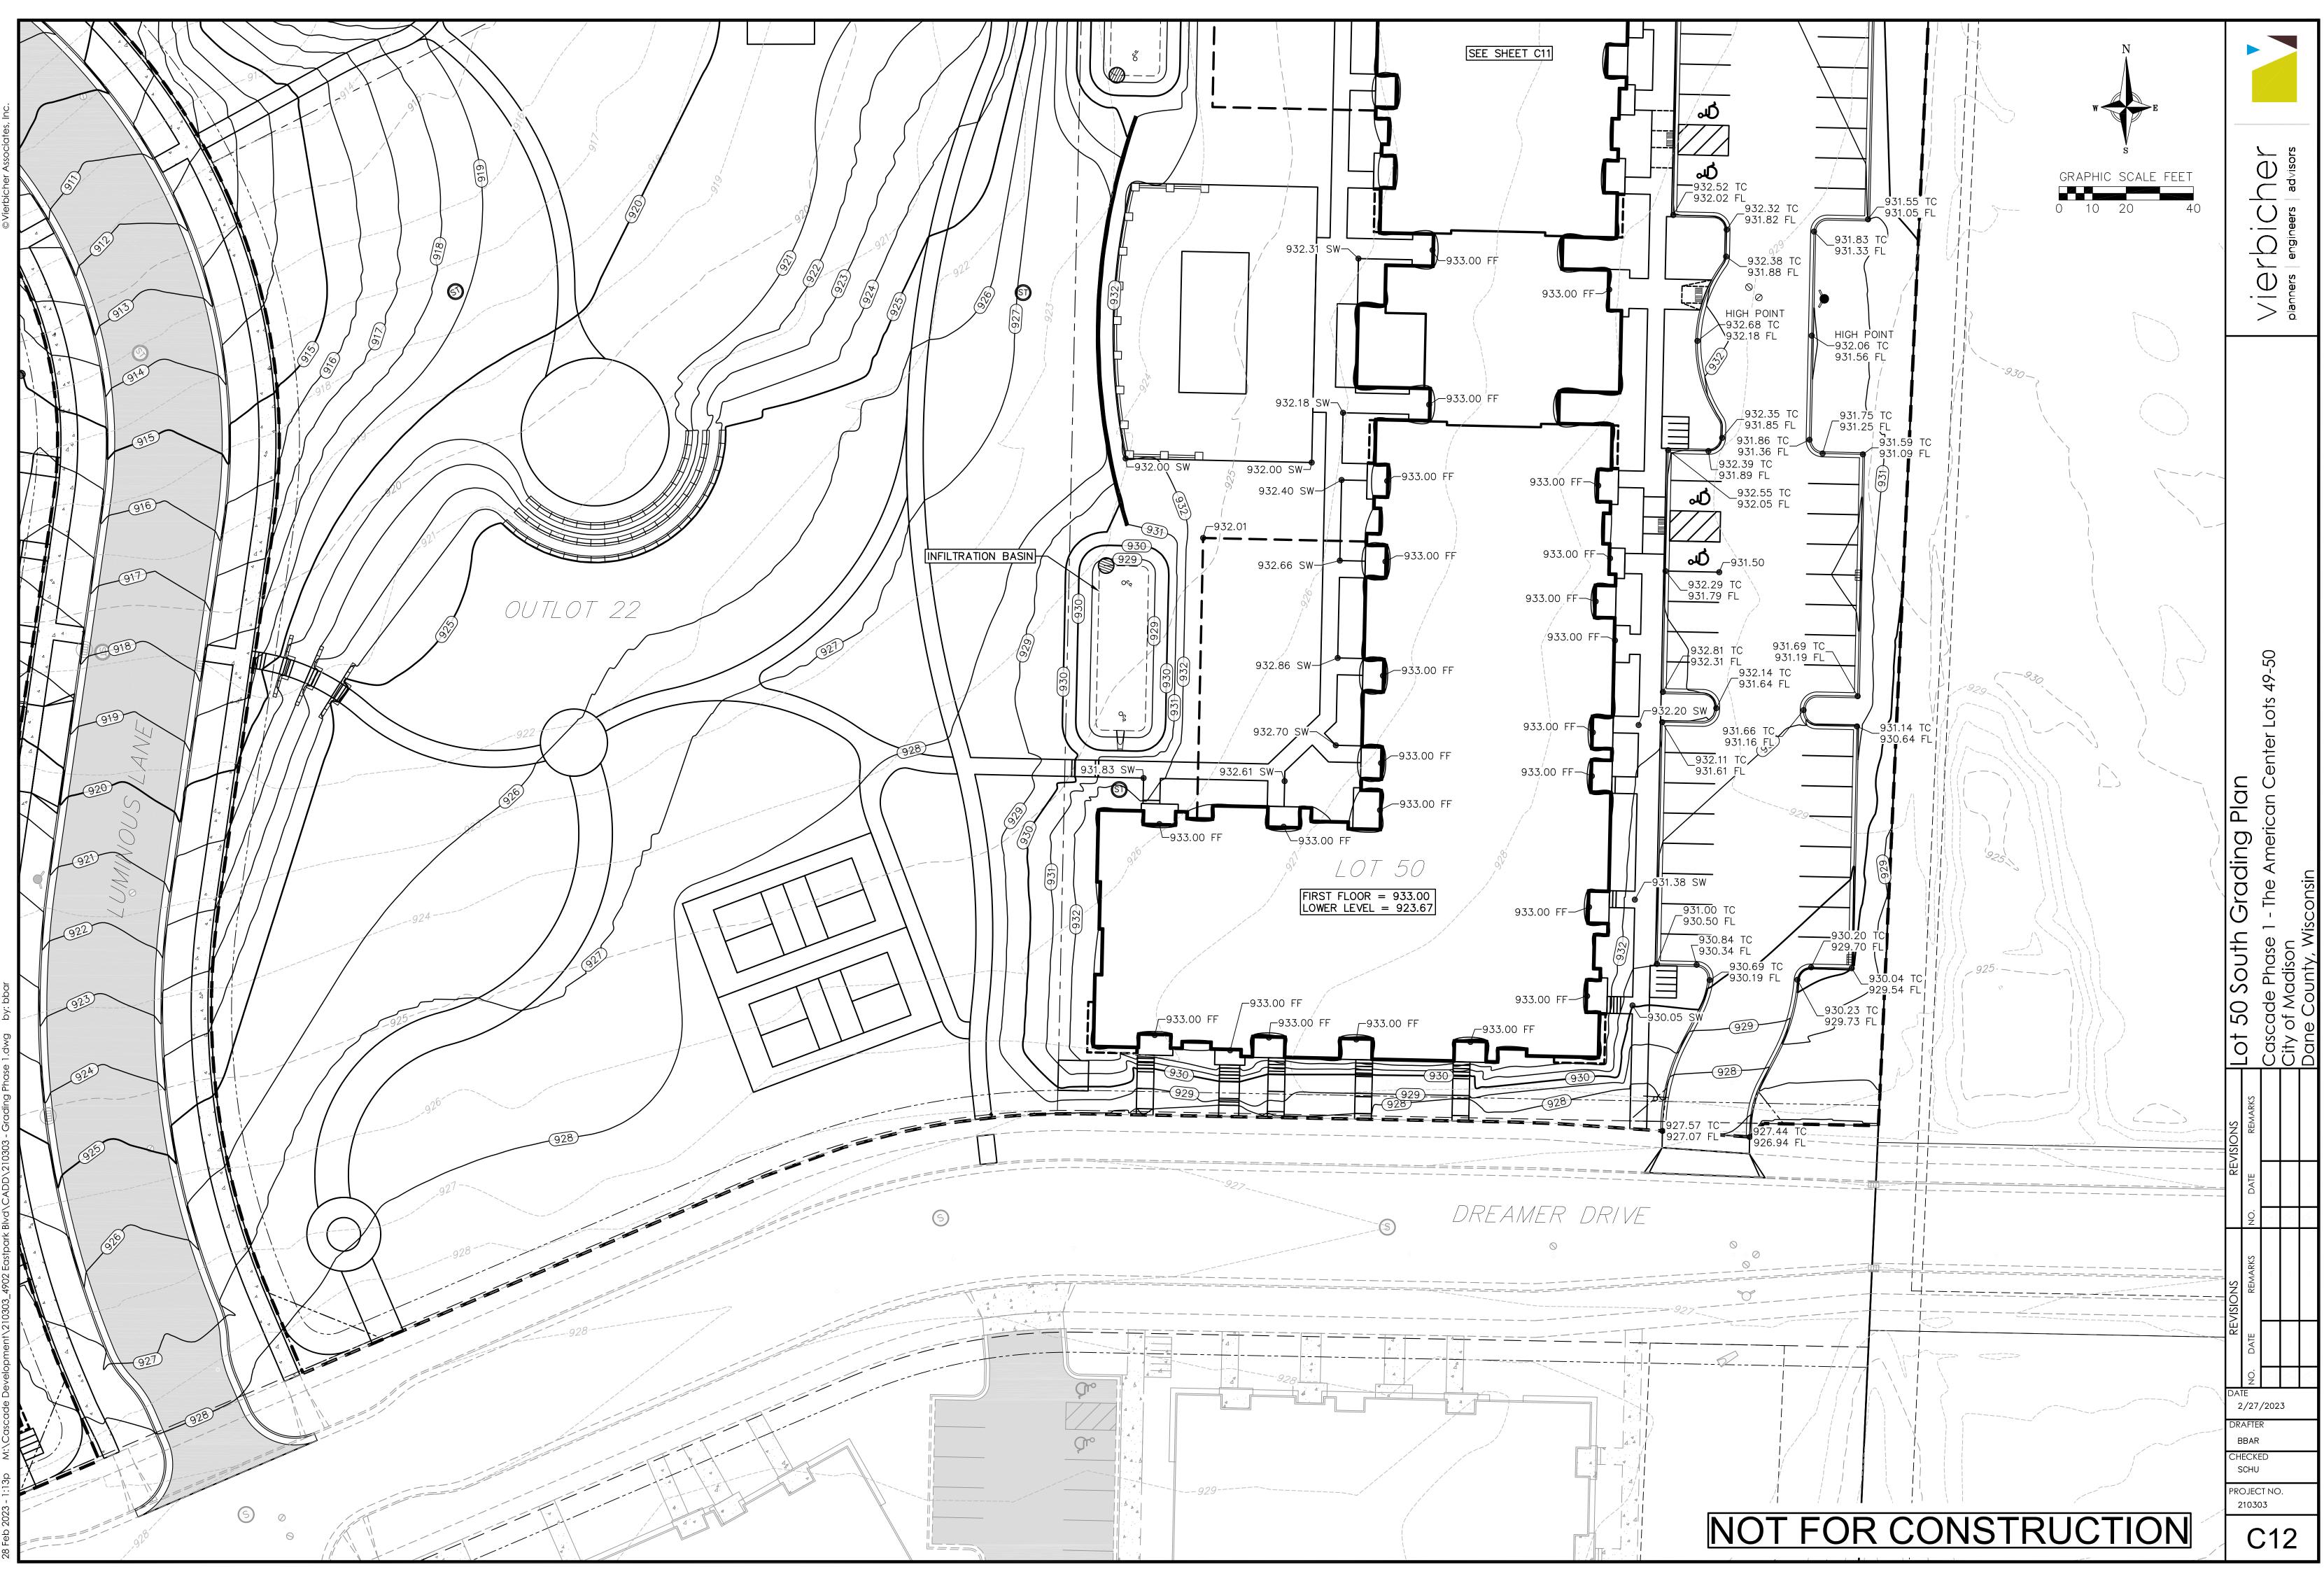

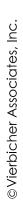

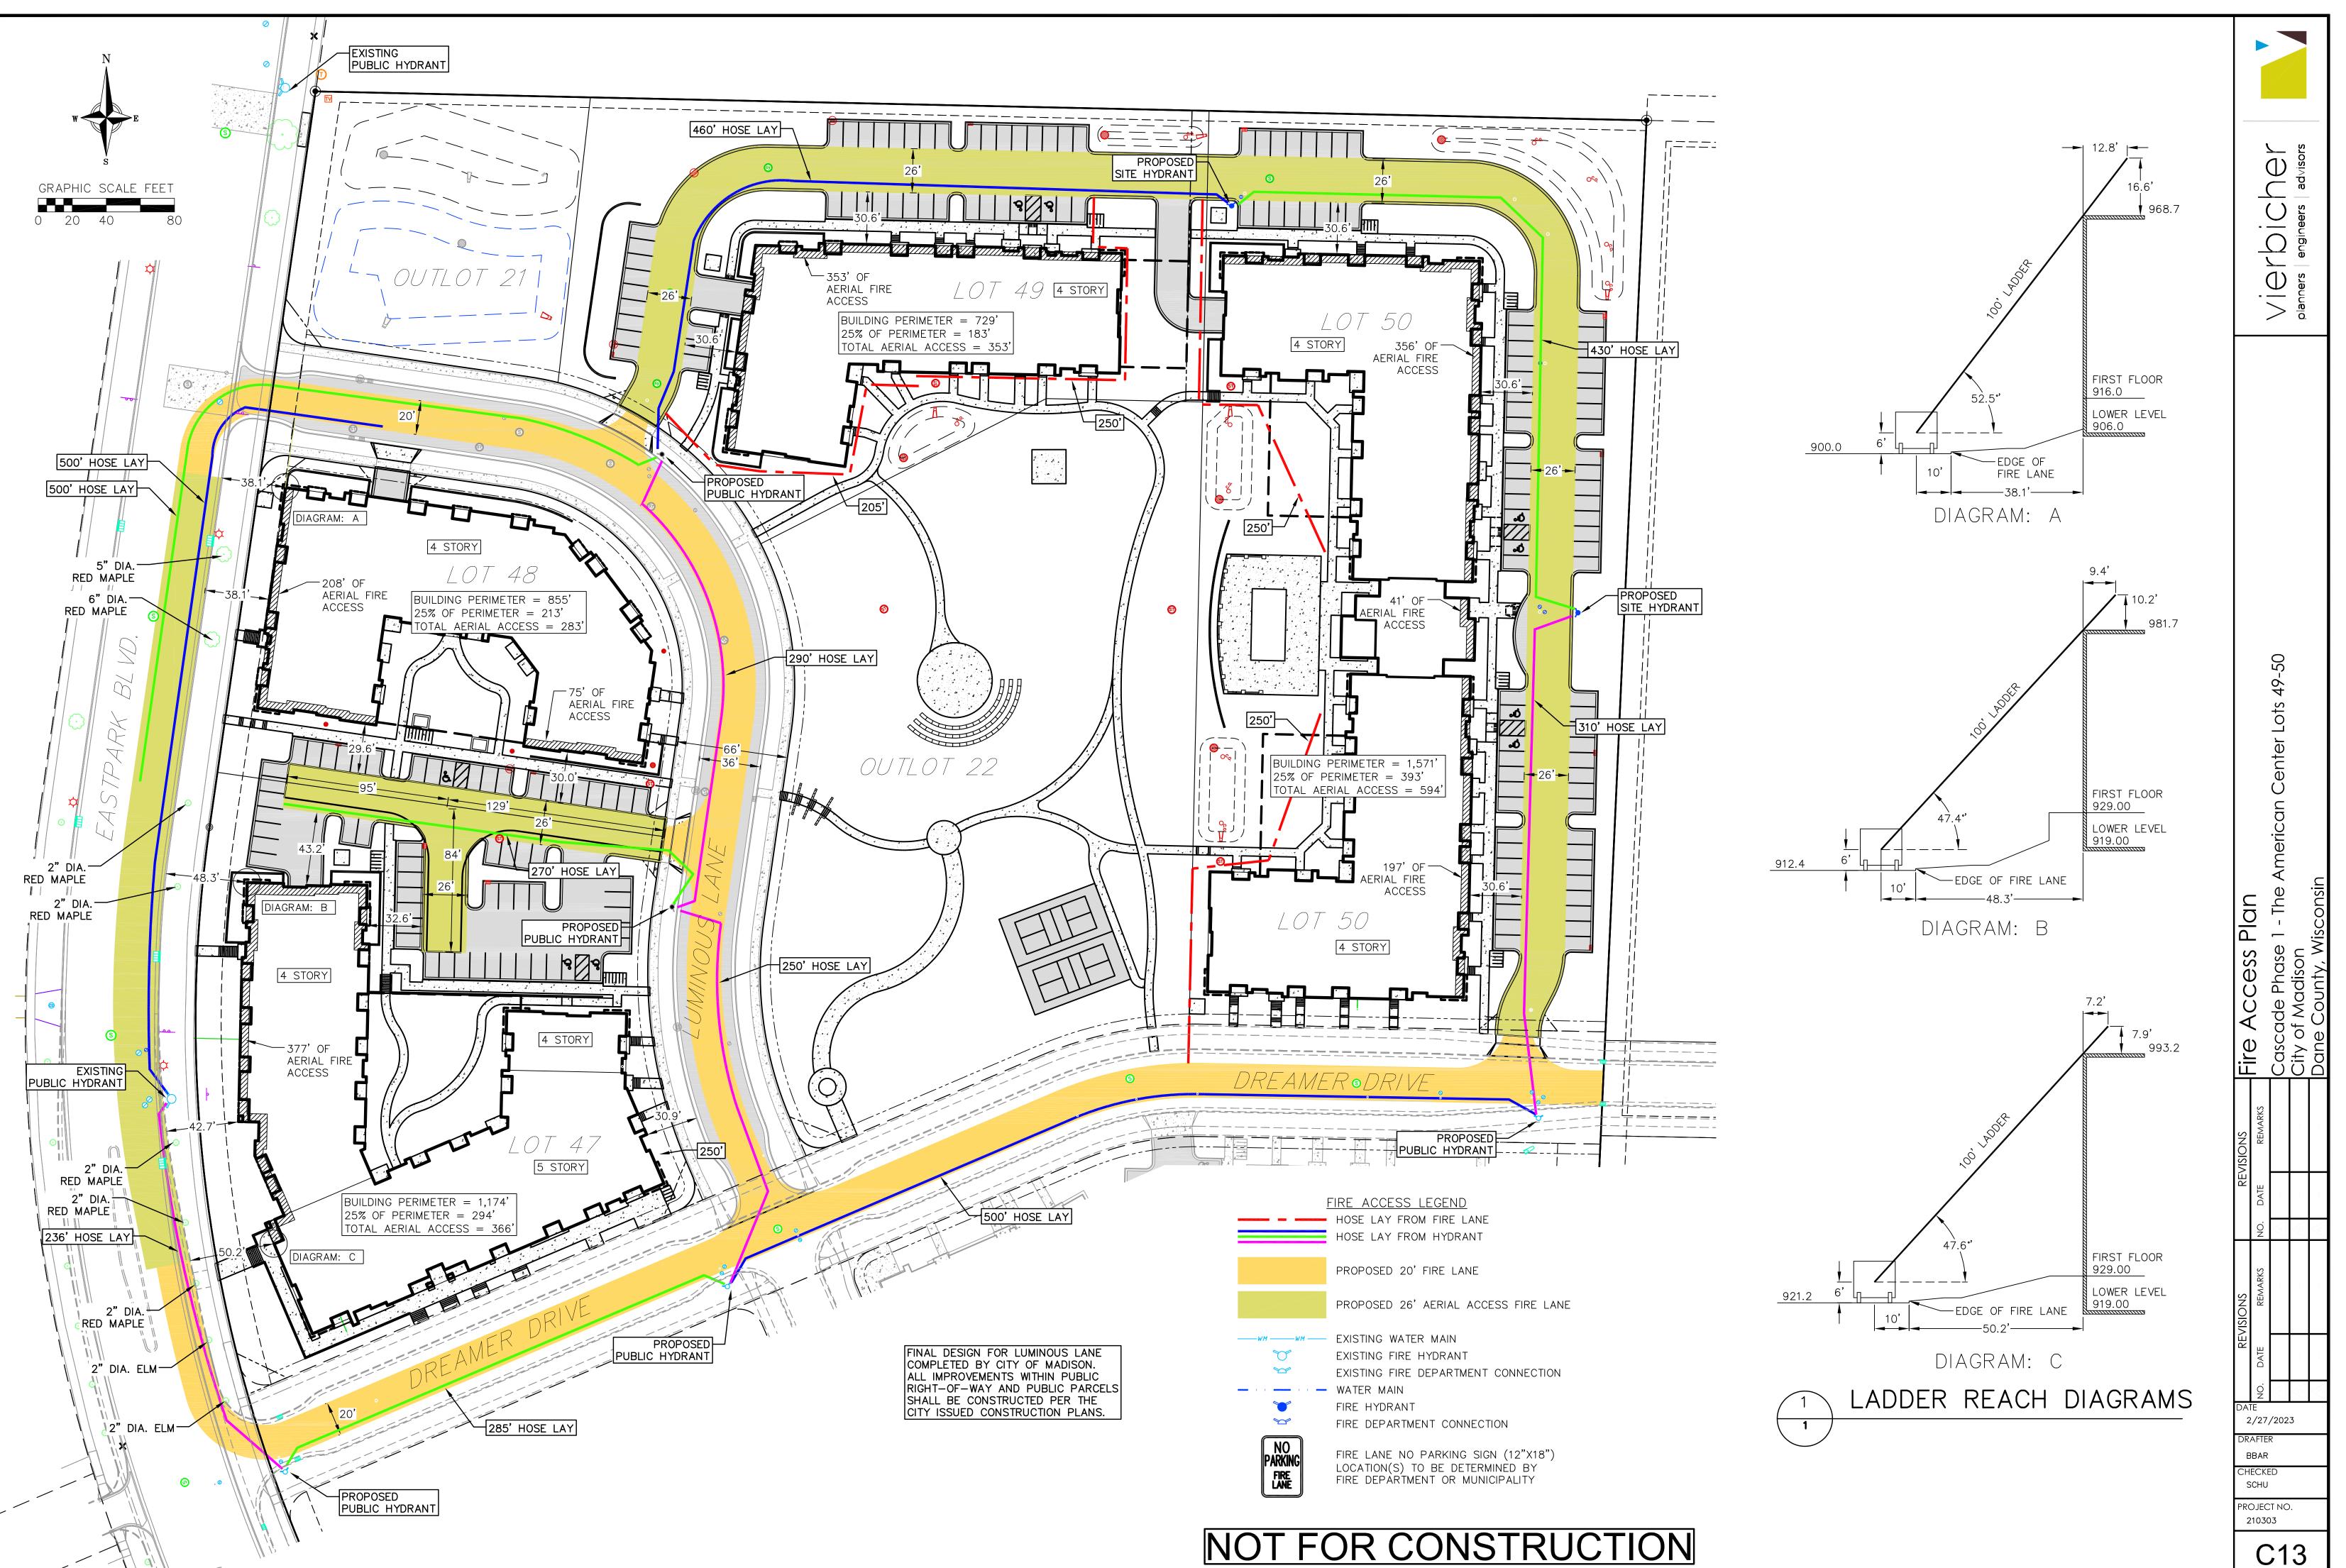

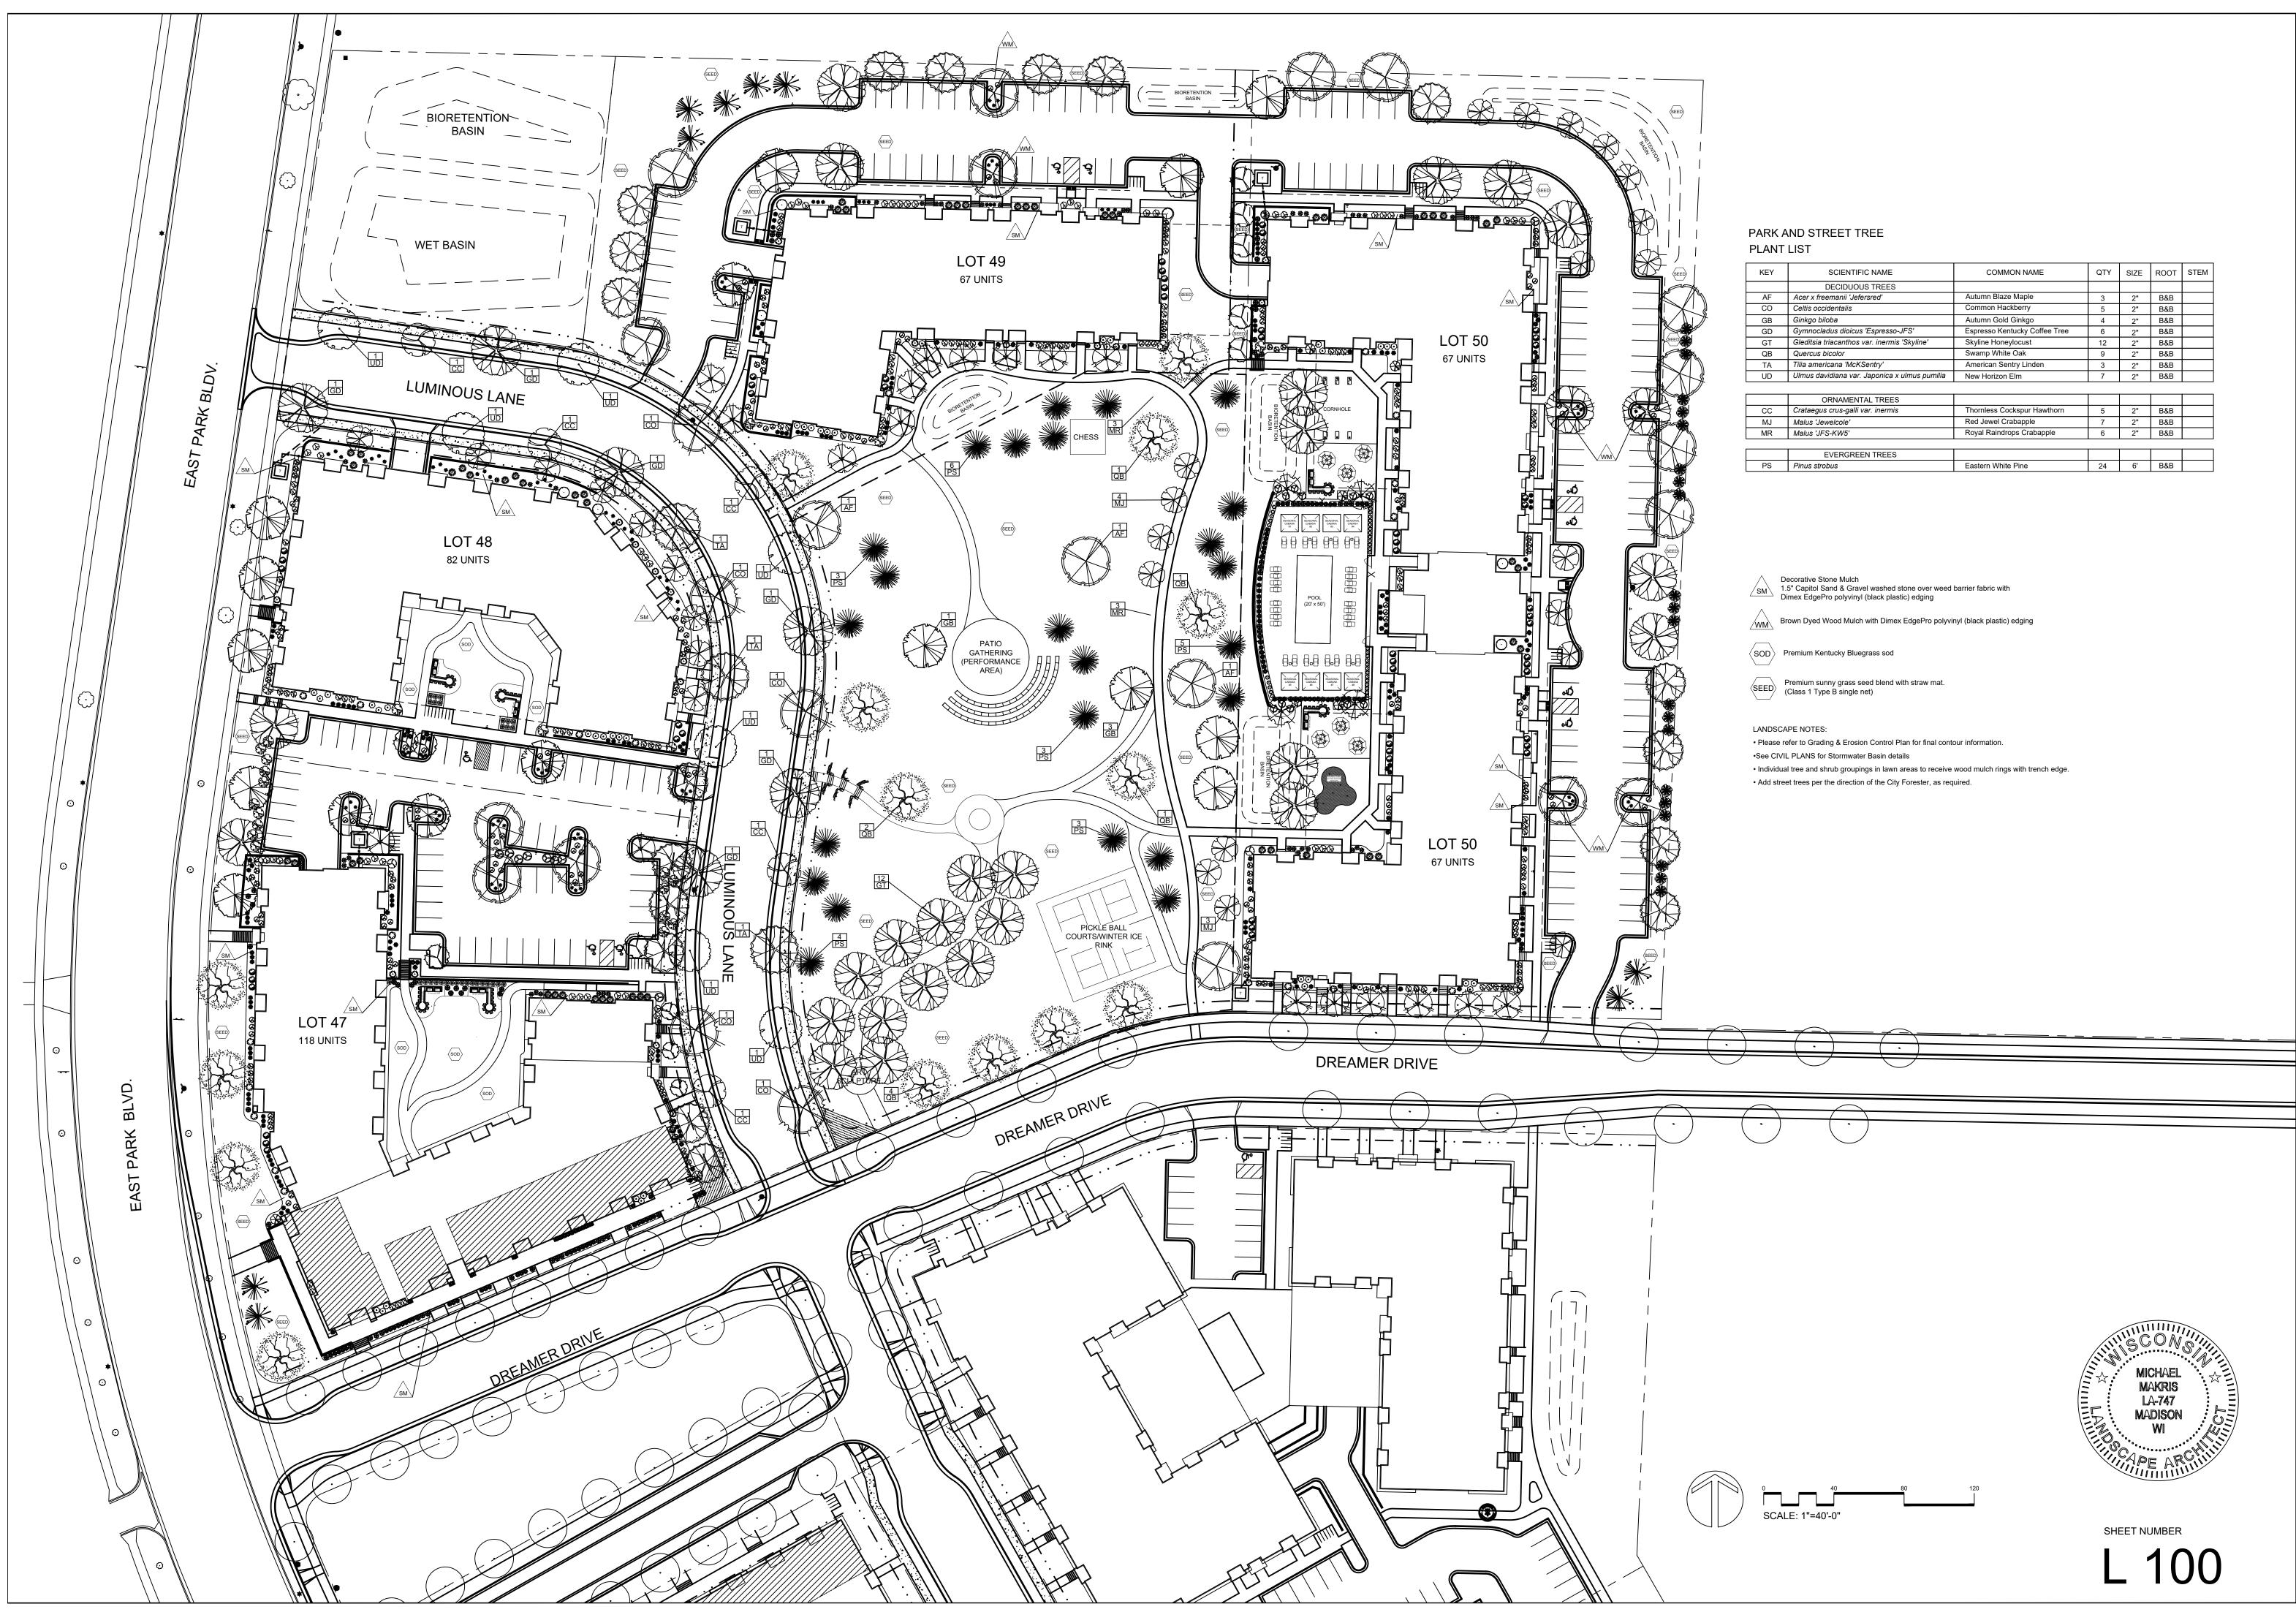



3570 Pioneer Road Verona, WI 53593 PH: (608) 827-9401 FAX: (608) 827-9402 WEB: www.olsontoon.com

KEY	SCIENTIFIC NAME	COMMON NAME	QTY	SIZE	ROOT	STEM
	DECIDUOUS TREES					
AF	Acer x freemanii 'Jefersred'	Autumn Blaze Maple	3	2"	B&B	
CO	Celtis occidentalis	Common Hackberry	5	2"	B&B	
GB	Ginkgo biloba	Autumn Gold Ginkgo	4	2"	B&B	
GD	Gymnocladus dioicus 'Espresso-JFS'	Espresso Kentucky Coffee Tree	6	2"	B&B	
GT	Gleditsia triacanthos var. inermis 'Skyline'	Skyline Honeylocust	12	2"	B&B	
QB	Quercus bicolor	Swamp White Oak	9	2"	B&B	
TA	Tilia americana 'McKSentry'	American Sentry Linden	3	2"	B&B	
UD	Ulmus davidiana var. Japonica x ulmus pumilia	New Horizon Elm	7	2"	B&B	
	ORNAMENTAL TREES					
СС	Crataegus crus-galli var. inermis	Thornless Cockspur Hawthorn	5	2"	B&B	
MJ	Malus 'Jewelcole'	Red Jewel Crabapple	7	2"	B&B	
MR	Malus 'JFS-KW5'	Royal Raindrops Crabapple	6	2"	B&B	
	EVERGREEN TREES					
PS	Pinus strobus	Eastern White Pine	24	6'	B&B	

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Date: January 6, 2023 Scale: 1'-0"=40'-0" Designer: kms Job #

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Seal: To protect against legal liability, the plans presented herein are "schematic," and should not be outsourced as "biddable" or "construction documents" unless approved by the Landscape Designer. This is not an original document unless stamped in red, as ORIGINAL.


Revisions: 2023.01.26 2023.02.17 2023.02.24


Reference Name:

Cascade Development

### LOT 49 PLANT LIST QTY SIZE ROOT STEM KEY SCIENTIFIC NAME COMMON NAME DECIDUOUS TREES AF Acer x freemanii 'Jefersred' Autumn Blaze Maple 4 | 2" | B&B DECIDUOUS SHRUBS GB Ginkgo biloba Autumn Gold Ginkgo 3 2" B&B Cc Cotinus coggygria 'NCC01' GT Gleditsia triacanthos var. inermis 'Skyline' Skyline Honeylocust 2 2" B&B Dk Diervilla 'G2X885411' QB Quercus bicolor Swamp White Oak 2 2" B&B Hp Hydrangea paniculata 'SMHPLQF' TA Tilia americana 'McKSentry' 7 2" B&B American Sentry Linden Itea virginica 'Sprich' lv Po Physocarpus opulifolius 'SMPOTW' ORNAMENTAL TREES Rr Rosa 'BAlset' St Spiraea betulifolia 'Tor' SR Syringa reticulata 'Ivory Silk' Ivory Silk Japanese Tree Lilac 10 2" B&B Vd Viburnum dentatum 'Christom' **ORNAMENTAL GRASSES & PERENNIALS** EVERGREEN TREES ca Calamagrostis x acutiflora 'Karl Foerster' Black Hills Spruce PG Picea glauca var. densata 5 6' B&B Thuja occidentalis 'Emerald Green' hb Hemerocallis 'Going Bananas' то Emerald Green Arborvitae 5 6' B&B hs Hosta 'Rainbow's End' hr Hemerocallis 'Rosy Returns' EVERGREEN SHRUBS hw Heuchera 'Wildberry' Pp Picea pungens 'Globosa' Dwarf Globe Blue Spruce 1 #5 Cont. pa Perovskia atriplicifolia 'Little Spire' Tm *Taxus x media 'Tautonii'* 11 #5 Cont. Taunton Yew 5 PG SEED BIORETENTION $\langle \text{SEED} \rangle$ WET BASIN 3 hr ΤĂ AF 10 SR LUMINOUS LANE

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City of Madison, WI Landscape Worksheet	:				Lot 50
Zoning District Category					
1/6/2023					
City of Madison, Wisconsin Landscape Wo	rksheet				
					LANDSCAPE
DEVELOPED LOTS	SQUARE FEET				POINTS REQ.
Total Developed Area					
134,789 sf (lot) - 40,694 (building footprint)	94,095				1568
		CREDITS / EXISTI	NG LANDSCAPING	NEW / PROF	POSED LANDSCAPING
			POINTS		
PLANT TYPE / ELEMENT	<b>POINT VALUE</b>	QUANTITY	ACHIEVED	QUANTITY	POINTS ACHIEVED
Overstory Deciduous	35		0	25	875
Tall Evergreen Tree	35		0	2	70
Ornamental Tree	15		0	22	330
Upright Evergreen Shrub (i.e. arborvitae)	10		0	24	240
Shrub, deciduous	3		0	182	546
Shrub, evergreen	4		0	23	92
Ornamental Grasses/Perennials	2		0	229	458
Ornamental/Decorative Fencing or Wall					
(4pts / 10LF)	4		0		0
Existing Significant Specimen Tree	14		0		0
Landscape Furniture for public seating					
and/or transit connections	5		0		0
			0		2611

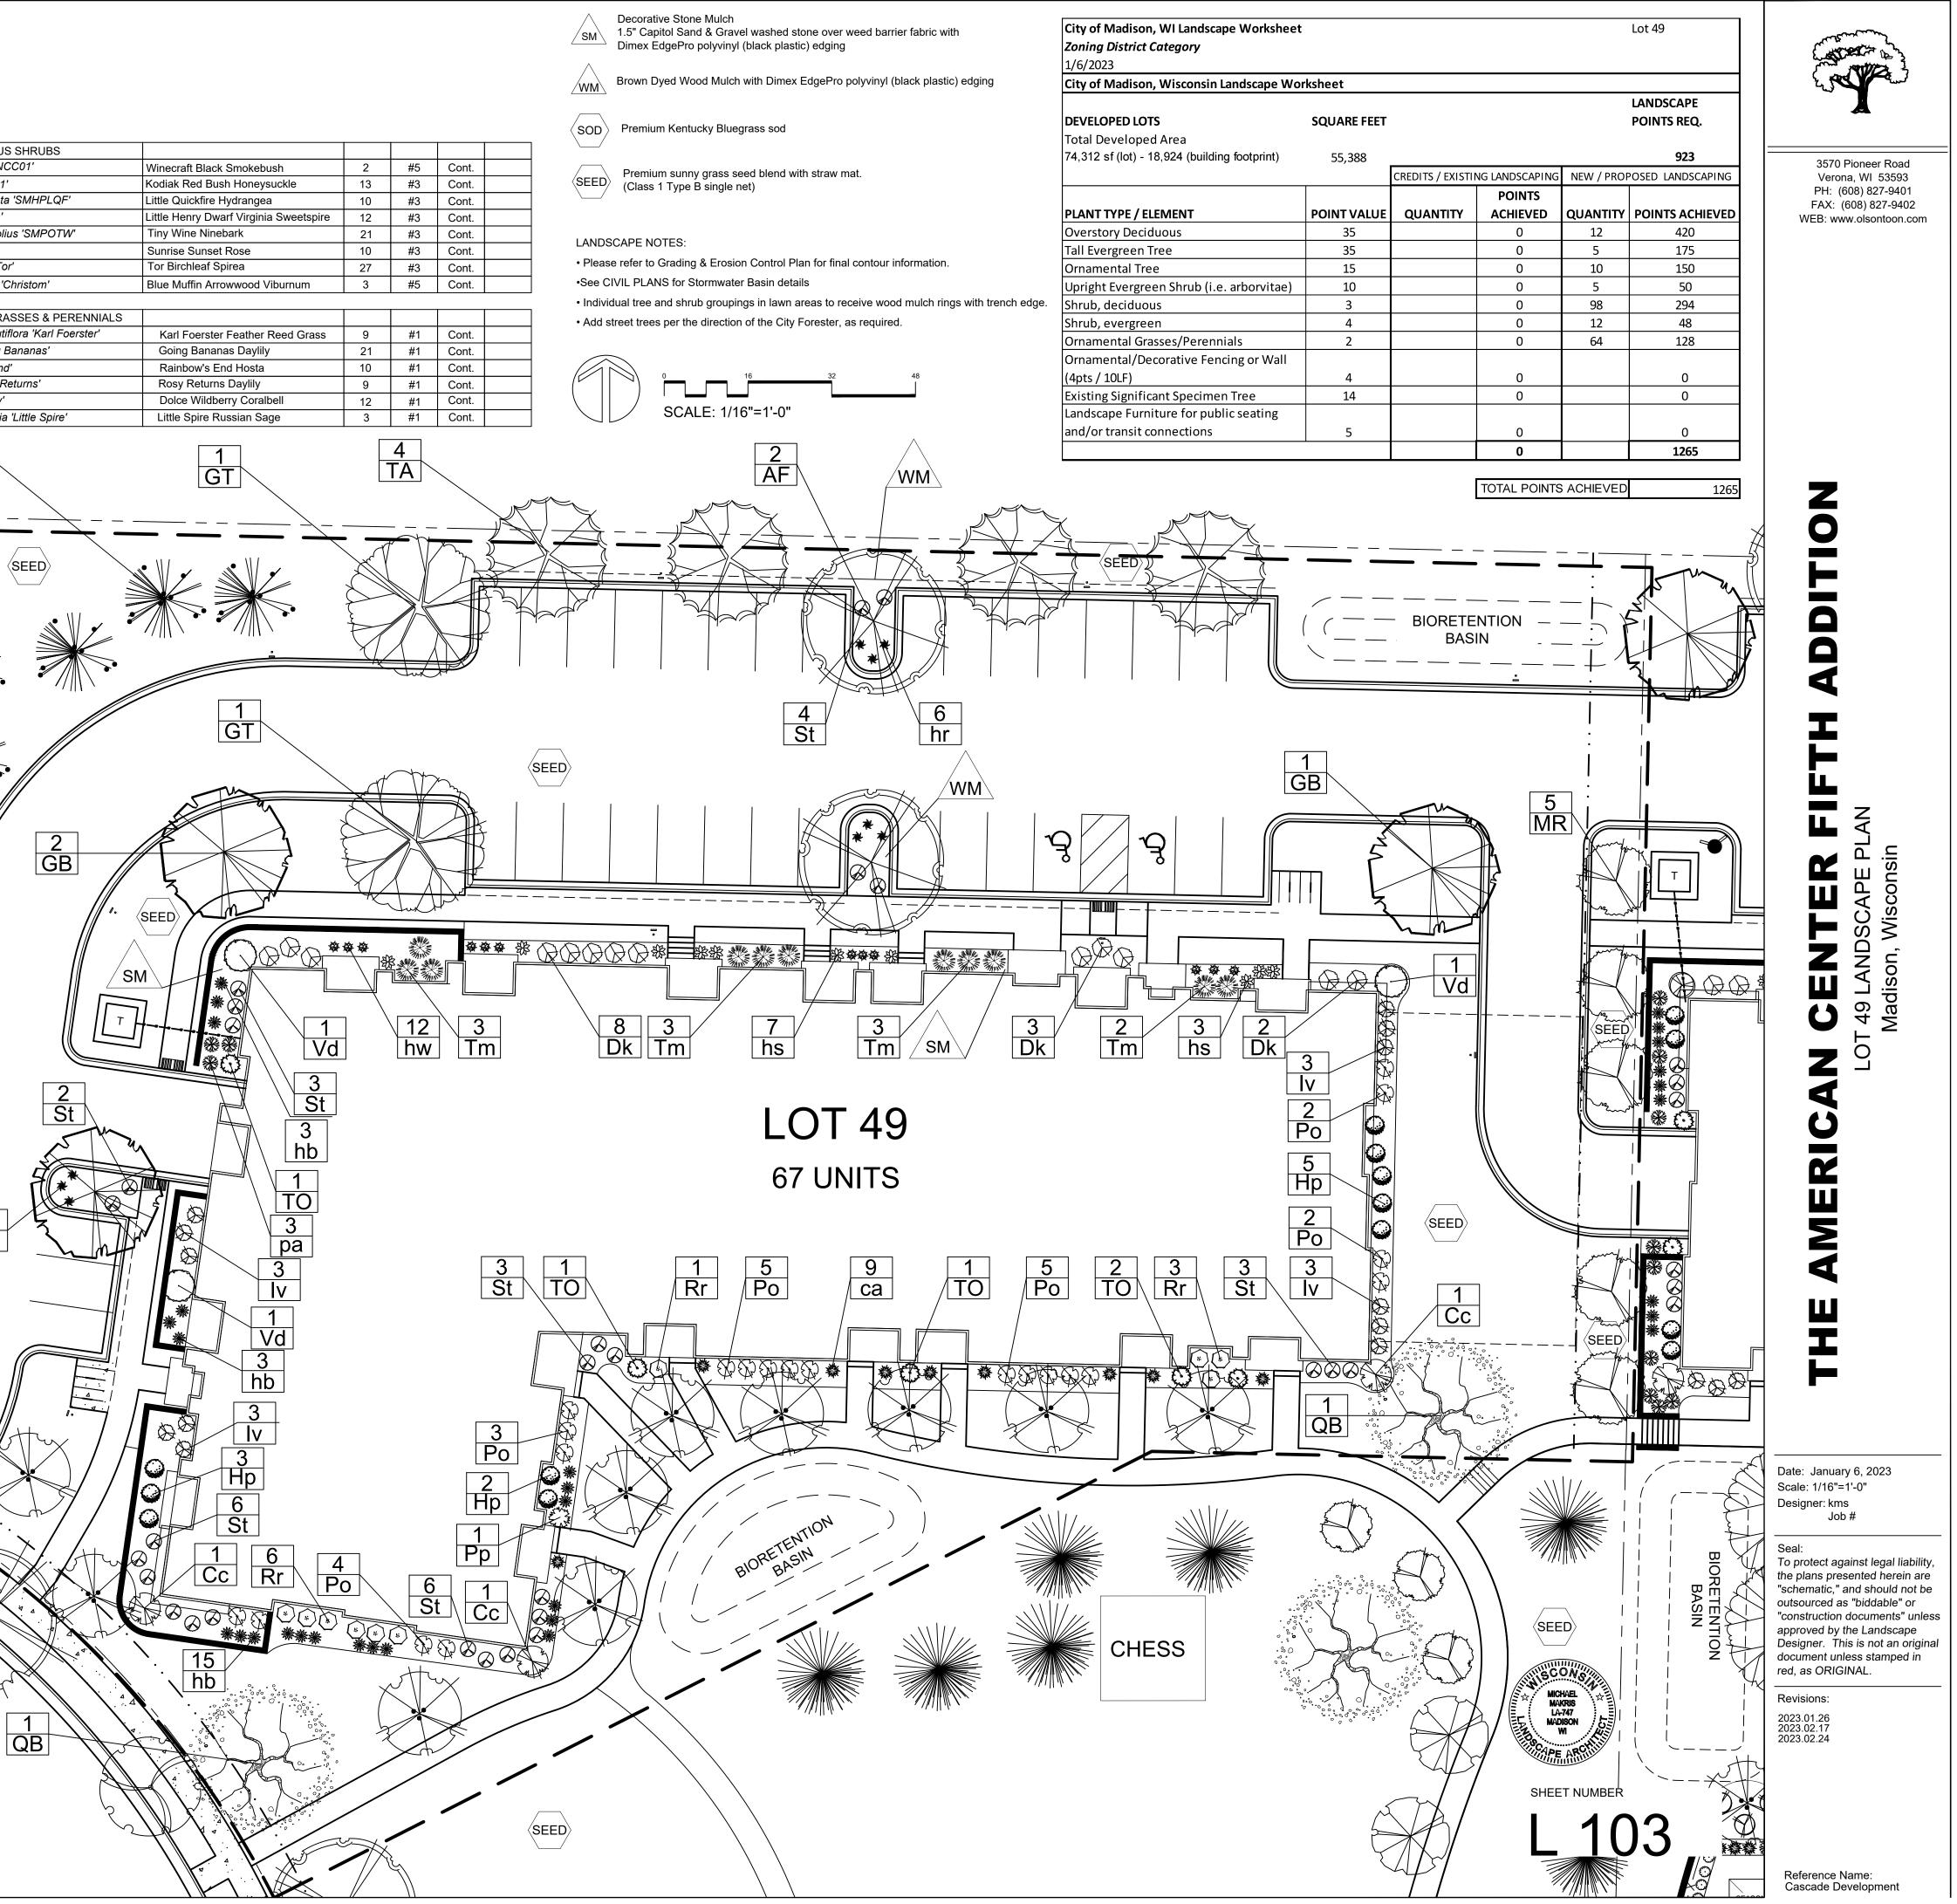
LOT 50	
PLANT	LIST

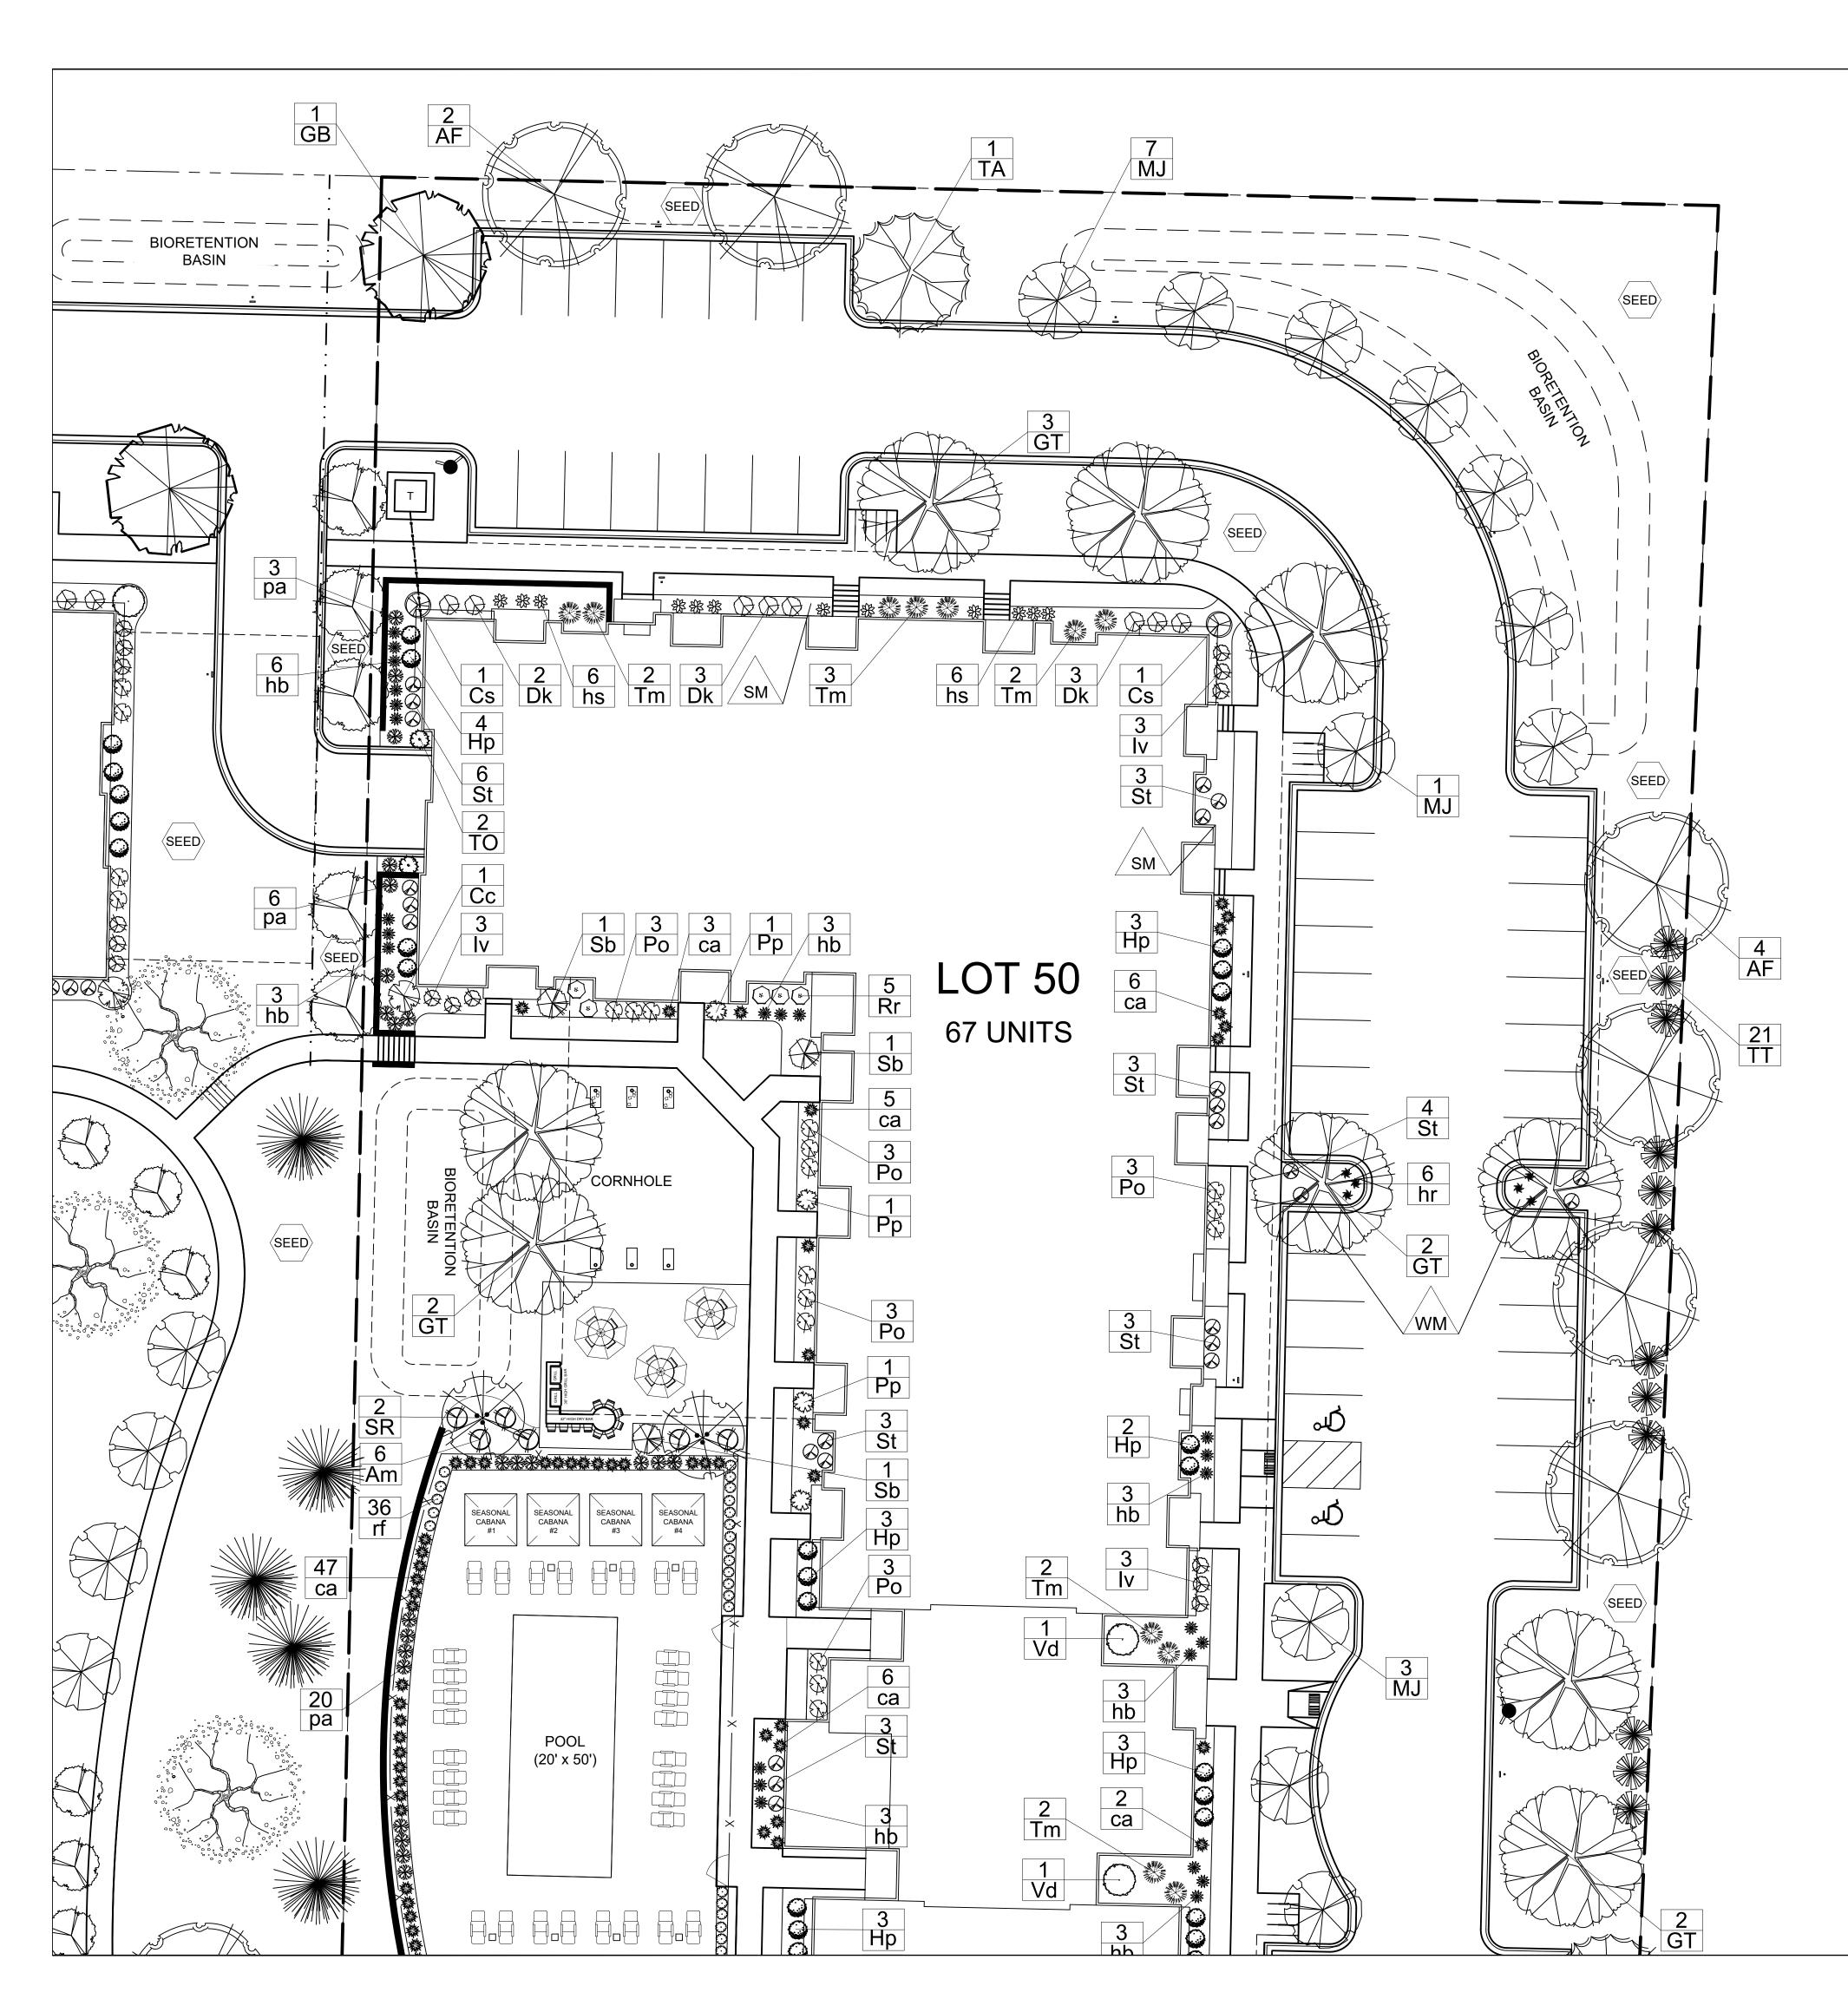SCIENTIFIC NAME	COMMON NAME	QTY	SIZE	ROOT	STE
DECIDUOUS TREES					
Acer x freemanii 'Jefersred'	Autumn Blaze Maple	8	2"	B&B	
Ginkgo biloba	Autumn Gold Ginkgo	1	2"	B&B	
Gleditsia triacanthos var. inermis 'Skyline'	Skyline Honeylocust	11	2"	B&B	
Tilia americana 'McKSentry'	American Sentry Linden	5	2"	B&B	
	Red Jewel Crabapple	12	2"	B&B	
		10	-	Dab	
EVERGREEN TREES					
Picea glauca var. densata	Black Hills Spruce	2	6'	B&B	
Thuja occidentalis 'Smaragd'	Emerald Green Arborvitae	3	6'	B&B	
Thuja occidentalis 'Techny'	Techny Arborvitae	21	6'	B&B	
EVERGREEN SHRUBS					
Picea pungens 'Globosa'	Dwarf Globe Blue Spruce	7	#5	Cont.	
Taxus x media 'Tautonii'	Taunton Yew	16	#5	Cont.	
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Viburnum dentatum 'Christom'	Blue Muffin Arrowwood Viburnum	2	#5	Cont.	
					1
Hemerocallis 'Going Bananas'	Going Bananas Daylily	35	#1	Cont.	
Hosta 'Rainbow's End'	Rainbow's End Hosta Rosy Returns Daylily	20 12	#1 #1	Cont.	
	Nosy Neturns Dayiny	12		Cont.	
Hemerocallis 'Rosy Returns' Perovskia atriplicifolia 'Little Spire'	Little Spire Russian Sage	29	#1	Cont.	
	Tilia americana 'McKSentry' ORNAMENTAL TREES Malus 'Jewelcole' Syringa reticulata 'Ivory Silk' EVERGREEN TREES Picea glauca var. densata Thuja occidentalis 'Smaragd' Thuja occidentalis 'Techny' EVERGREEN SHRUBS Picea pungens 'Globosa' Taxus x media 'Tautonii' DECIDUOUS SHRUBS Aronia melanocarpa 'Morton' Cotinus coggygria 'NCC01' Cornus alba 'Bailhalo' Diervilla 'G2X885411' Hydrangea paniculata 'SMHPLQF' Itea virginica 'Sprich' Physocarpus opulifolius 'Jefam' Physocarpus opulifolius 'SMPOTW' Rosa 'BAIset' Syringa 'SMSJBP7' Spiraea betulifolia 'Tor'	Tilia americana 'McKSentry'       American Sentry Linden         ORNAMENTAL TREES       Red Jewel Crabapple         Malus 'Jewelcole'       Red Jewel Crabapple         Syringa reticulata 'Ivory Silk'       Ivory Silk Japanese Tree Lilac         EVERGREEN TREES       Picea glauca var. densata         Picea glauca var. densata       Black Hills Spruce         Thuja occidentalis 'Smaragd'       Emerald Green Arborvitae         Thuja occidentalis 'Techny'       Techny Arborvitae         EVERGREEN SHRUBS       Dwarf Globe Blue Spruce         Ficea pungens 'Globosa'       Dwarf Globe Blue Spruce         Taxus x media 'Tautonii'       Taunton Yew         DECIDUOUS SHRUBS       Iroquois Beauty Chokeberry         Cotinus coggygria 'NCC01'       Winecraft Black Smokebush         Cornus alba 'Bailhalo'       Ivory Halo Red Twig Dogwood         Diervilla 'G2X885411'       Kodiak Red Bush Honeysuckle         Hydrangea paniculata 'SMHPLQF'       Little Quickfire Hydrangea         Itea virginica 'Sprich'       Little Henry Dwarf Virginia Sweetspire         Physocarpus opulifolius 'Jafam'       Amber Jubilee Ninebark         Physocarpus opulifolius 'SMPOTW'       Tiny Wine Ninebark         Physocarpus opulifolius 'MPOTW'       Bloomerang Dark Purple Lilac         Spiraea betulifolia 'Tor'       Tor Bi	Tilla americana 'McKSentry'       American Sentry Linden       5         ORNAMENTAL TREES       Red Jewel Crabapple       12         Syringa reticulata 'Ivory Silk'       Ivory Silk Japanese Tree Lilac       10         EVERGREEN TREES       Ivory Silk Japanese Tree Lilac       10         Picea glauca var. densata       Black Hills Spruce       2         Thuja occidentalis 'Smaragd'       Emerald Green Arborvitae       3         Thuja occidentalis 'Techny'       Techny Arborvitae       21         EVERGREEN SHRUBS       Image: Slobosa'       2         Picea pungens 'Globosa'       Dwarf Globe Blue Spruce       7         Taxus x media 'Tautonii'       Taunton Yew       16         DECIDUOUS SHRUBS       Image: Slobosa'       1         Cortinus coggygria 'NCC01'       Winecraft Black Smokebush       1         Cortinus coggygria 'NCC01'       Winecraft Black Smokebush       1         Cortinus coggygria 'NCC01'       Kodiak Red Bush Honeysuckle       11         Hydrangea paniculata 'SMHPLQF'       Little Quickfire Hydrangea       30         Itea virginica 'Sprich'       Little Henry Dwarf Virginia Sweetspire       25         Physocarpus opulifolius 'Jefam'       Amber Jubilee Ninebark       1         Physocarpus opulifolius 'SMPOTW'       Tiny W	Tilla americana 'McKSentry'       American Sentry Linden       5       2"         ORNAMENTAL TREES       Image: Comparison of the system of the sys	Tilia americana 'McKSentry'       American Sentry Linden       5       2"       B&B         ORNAMENTAL TREES       Red Jewel Crabapple       12       2"       B&B         Malus' Jewelcole'       Red Jewel Crabapple       12       2"       B&B         Syringa reticulata 'Ivory Silk'       Ivory Silk Japanese Tree Lilac       10       2"       B&B         EVERGREEN TREES       Image: Comparison of the compa

WM	Brown Dyed Wood Mulch with Di
	Premium Kentucky Bluegrass so
SEED	Premium sunny grass seed bler (Class 1 Type B single net)

LANDSCAPE NOTES:

• Please refer to Grading & Erosion Control Plan for final contour information. •See CIVIL PLANS for Stormwater Basin details • Add street trees per the direction of the City Forester, as required.

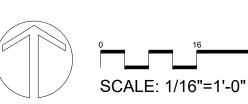

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3570 Pioneer Road Verona, WI 53593 PH: (608) 827-9401 FAX: (608) 827-9402 WEB: www.olsontoon.com

TOTAL POINTS ACHIEVED 2611

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end with straw mat.

• Individual tree and shrub groupings in lawn areas to receive wood mulch rings with trench edge.



SHEET NUMBER



**ADDITION** Z V CENTER A A ANDSCAF - 50 LA Madise Ο Ζ 4 AMERIC THE


Date: January 6, 2023 Scale: 1/16"=1'-0" Designer: kms Job #

Seal:

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Revisions: 2023.01.26 2023.02.17 2023.02.24

> Reference Name: Cascade Development

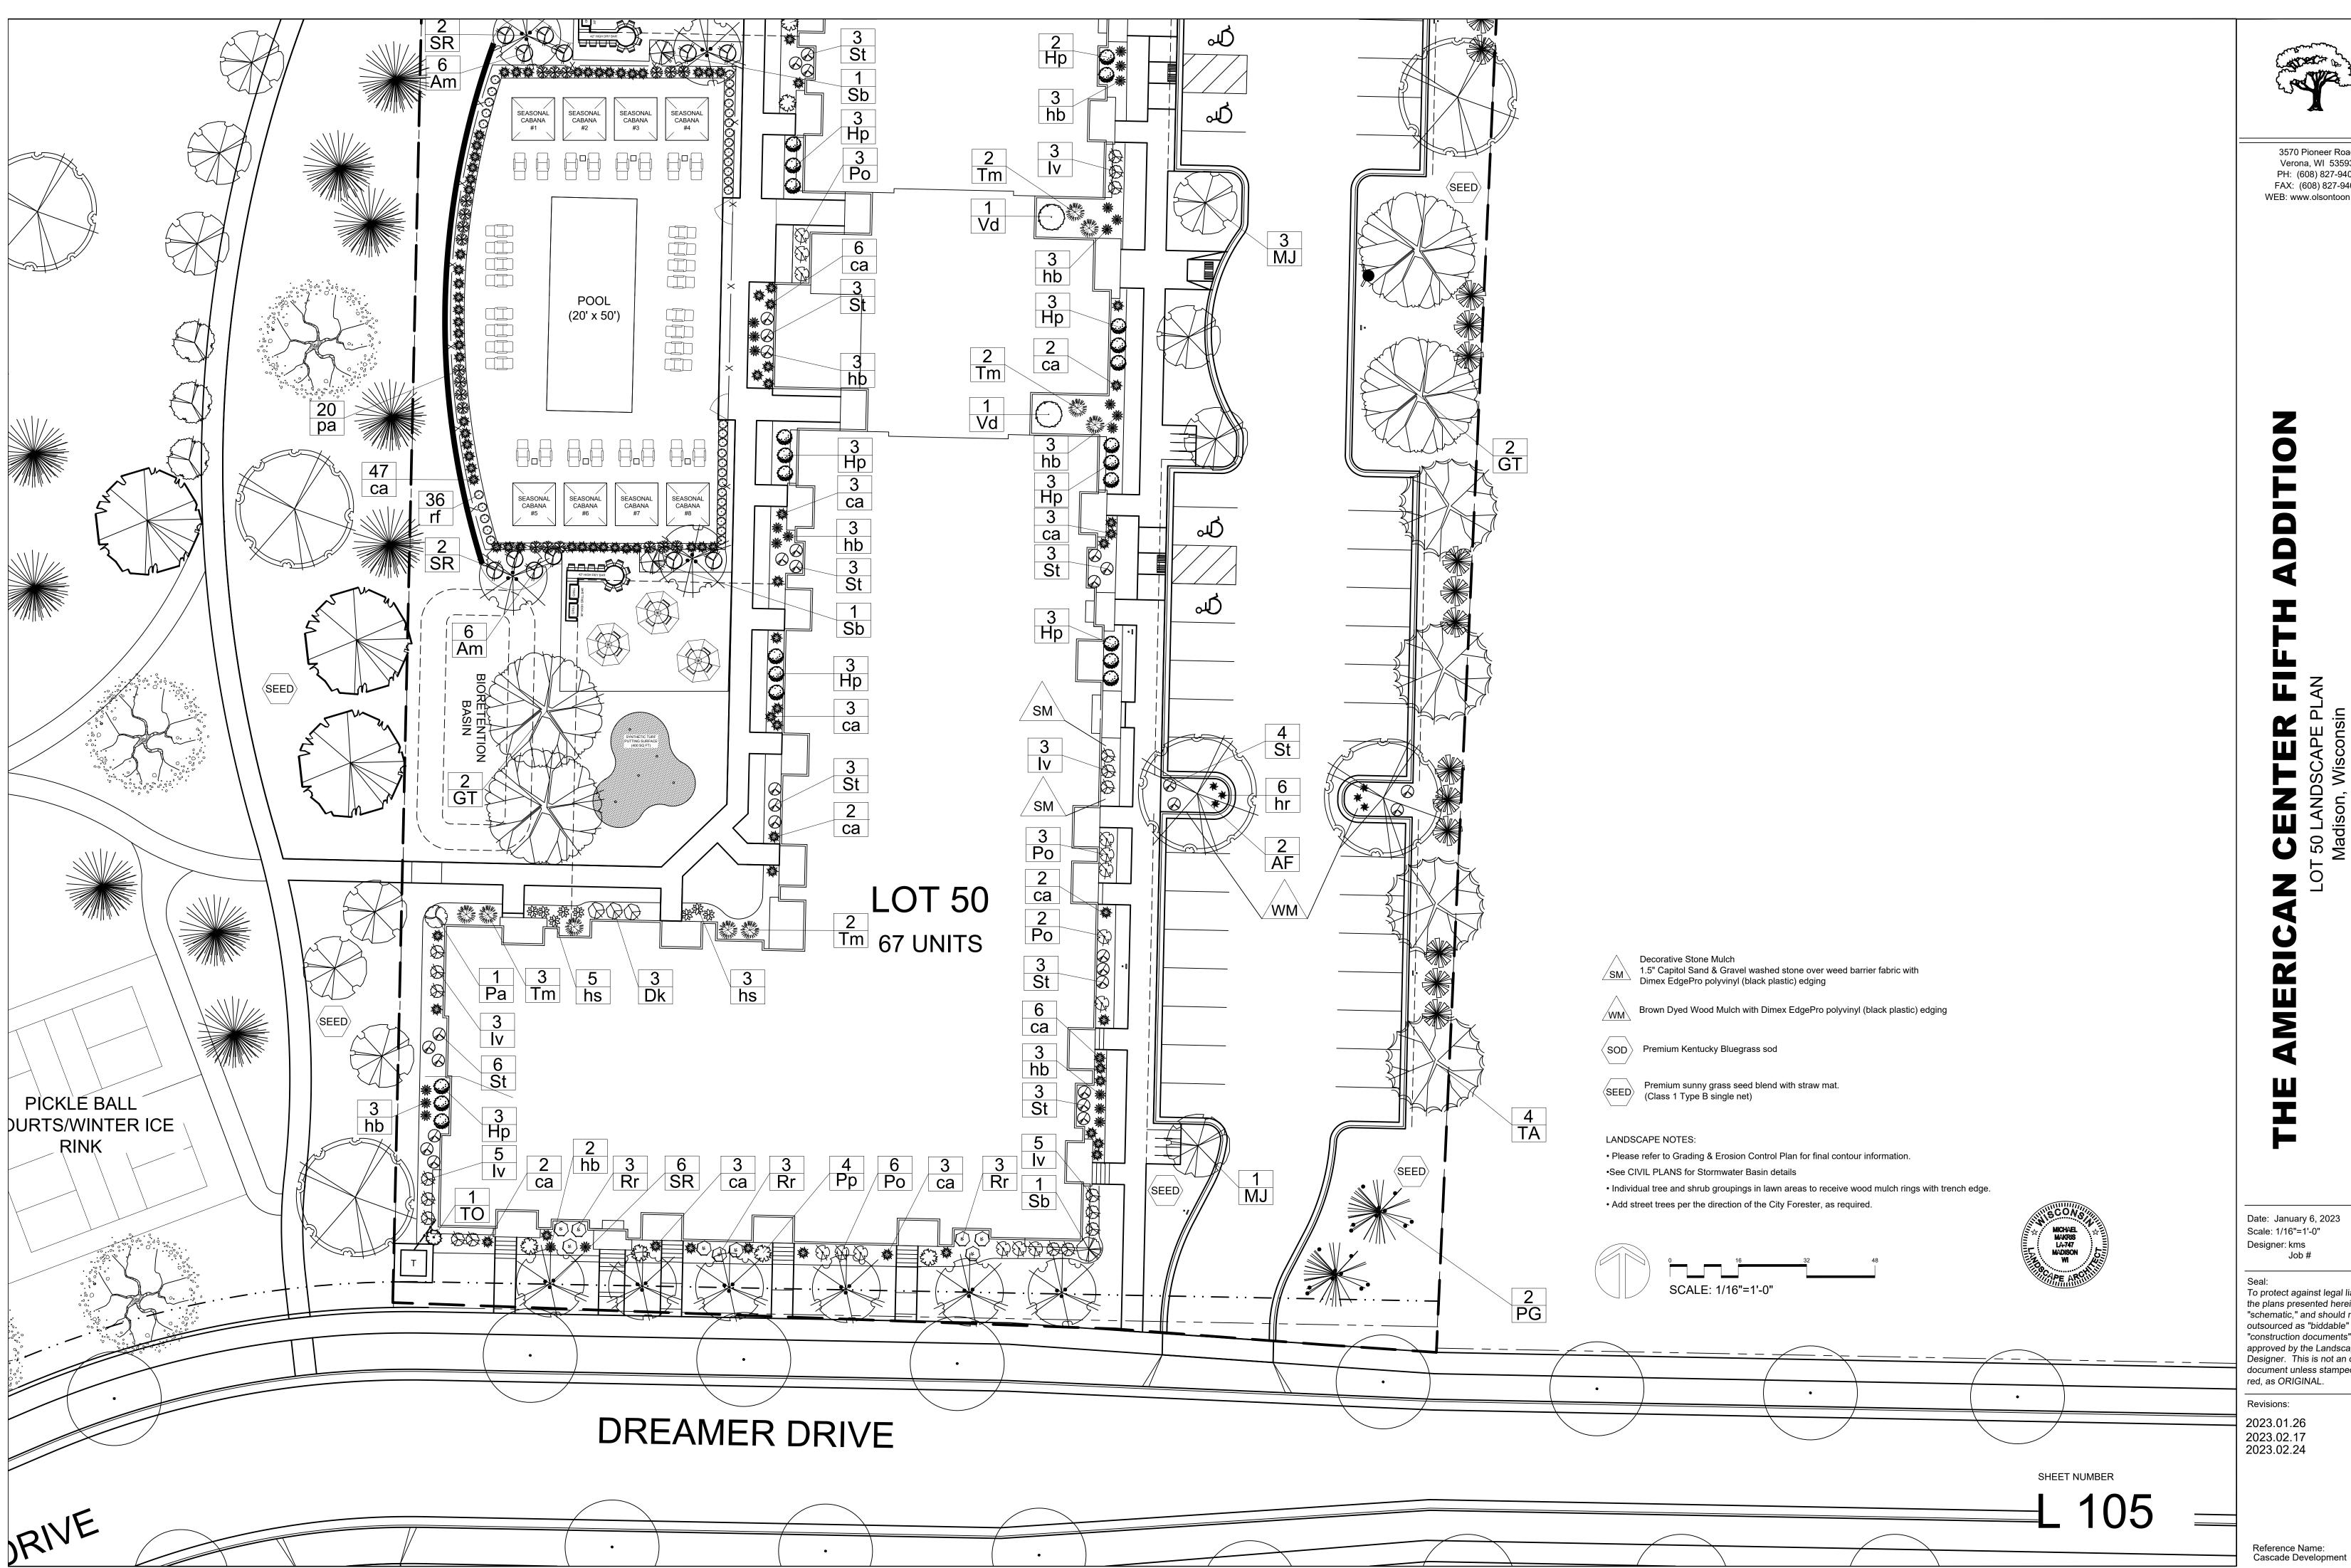

Revisions: 2023.01.26 2023.02.17 2023.02.24

Date: January 6, 2023 Scale: 1/16"=1'-0" Designer: kms Job #

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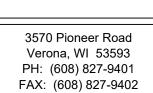
document unless stamped in

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# **ADDITION** A NTER Ŋ **CEI** 50 LAI Madiso 0 AN AMERIC

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