

LANGDON STREET

CURB & GUTTER

Curb Cut

CONCRETE SIDEWALK

STATE STREET
24.2' WIDE TRAVELED WAY

CURB & GUTTER


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Site Development Data:



Densities:	
Lot Area	6,260 S.F./1.14 acres
Dwelling Units	24 units
Lot Area / D.U.	260 S.F./unit
Dwelling Unit Mix:	
Efficiency	12
One Bedroom	8
Two Bedroom	4
Total Dwelling Units	24
Commercial Areas (Approximate)	
Basement Level	1,900 S.F.
First Floor	4,300 S.F.
Second Floor	4,900 S.F.
Building Height	
	6 stories
Residential Bicycle Parking:	
Covered	24
Surface-Guest	8
Total	32

- GENERAL NOTES:**
- BUILDINGS WITHIN THIS DEVELOPMENT ARE SUBJECT TO IMPACT FEES THAT ARE DUE AND PAYABLE AT THE TIME BUILDING PERMITS ARE ISSUED. SANITARY SEWER IMPACT FEE INCLUDES LIFT STATION CONNECTION FEE AND INTERCEPTOR FEE.
 - ALL WORK IN THE PUBLIC RIGHT OF WAY SHALL BE PERFORMED BY A CITY LICENSED CONTRACTOR.
 - ALL DAMAGE TO THE PAVEMENT ADJACENT TO THIS DEVELOPMENT SHALL BE RESTORED IN ACCORDANCE WITH THE CITY OF MADISON'S PAVEMENT PATCHING CRITERIA.
 - THE CONTRACTOR SHALL REPLACE ALL CURB AND GUTTER ADJACENT TO THIS DEVELOPMENT AS DEEMED NECESSARY BY THE CITY ENGINEER.
 - THE MAXIMUM RUNNING SLOPE OF ALL WALKS SHALL BE 1:20. THE MAXIMUM SLOPE OF RAMPS SHALL BE 1:12. THE MAXIMUM CROSS SLOPE AT ALL WALKS & RAMPS SHALL BE 1:50.
 - VERIFY THAT EXISTING SANITARY AND WATER MEET PROPOSED ADDITION DEMANDS.




SITE PLAN
C-1.0 1" = 10'

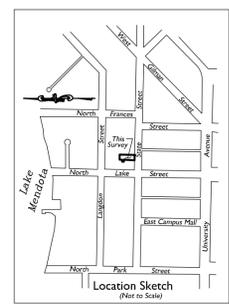NORTH LAKE STREET
66' RIGHT OF WAY

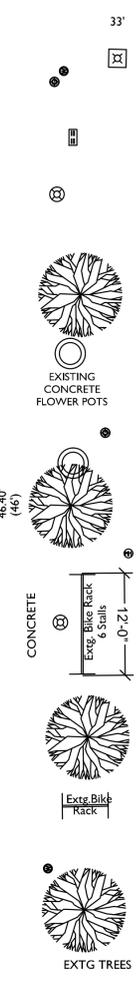
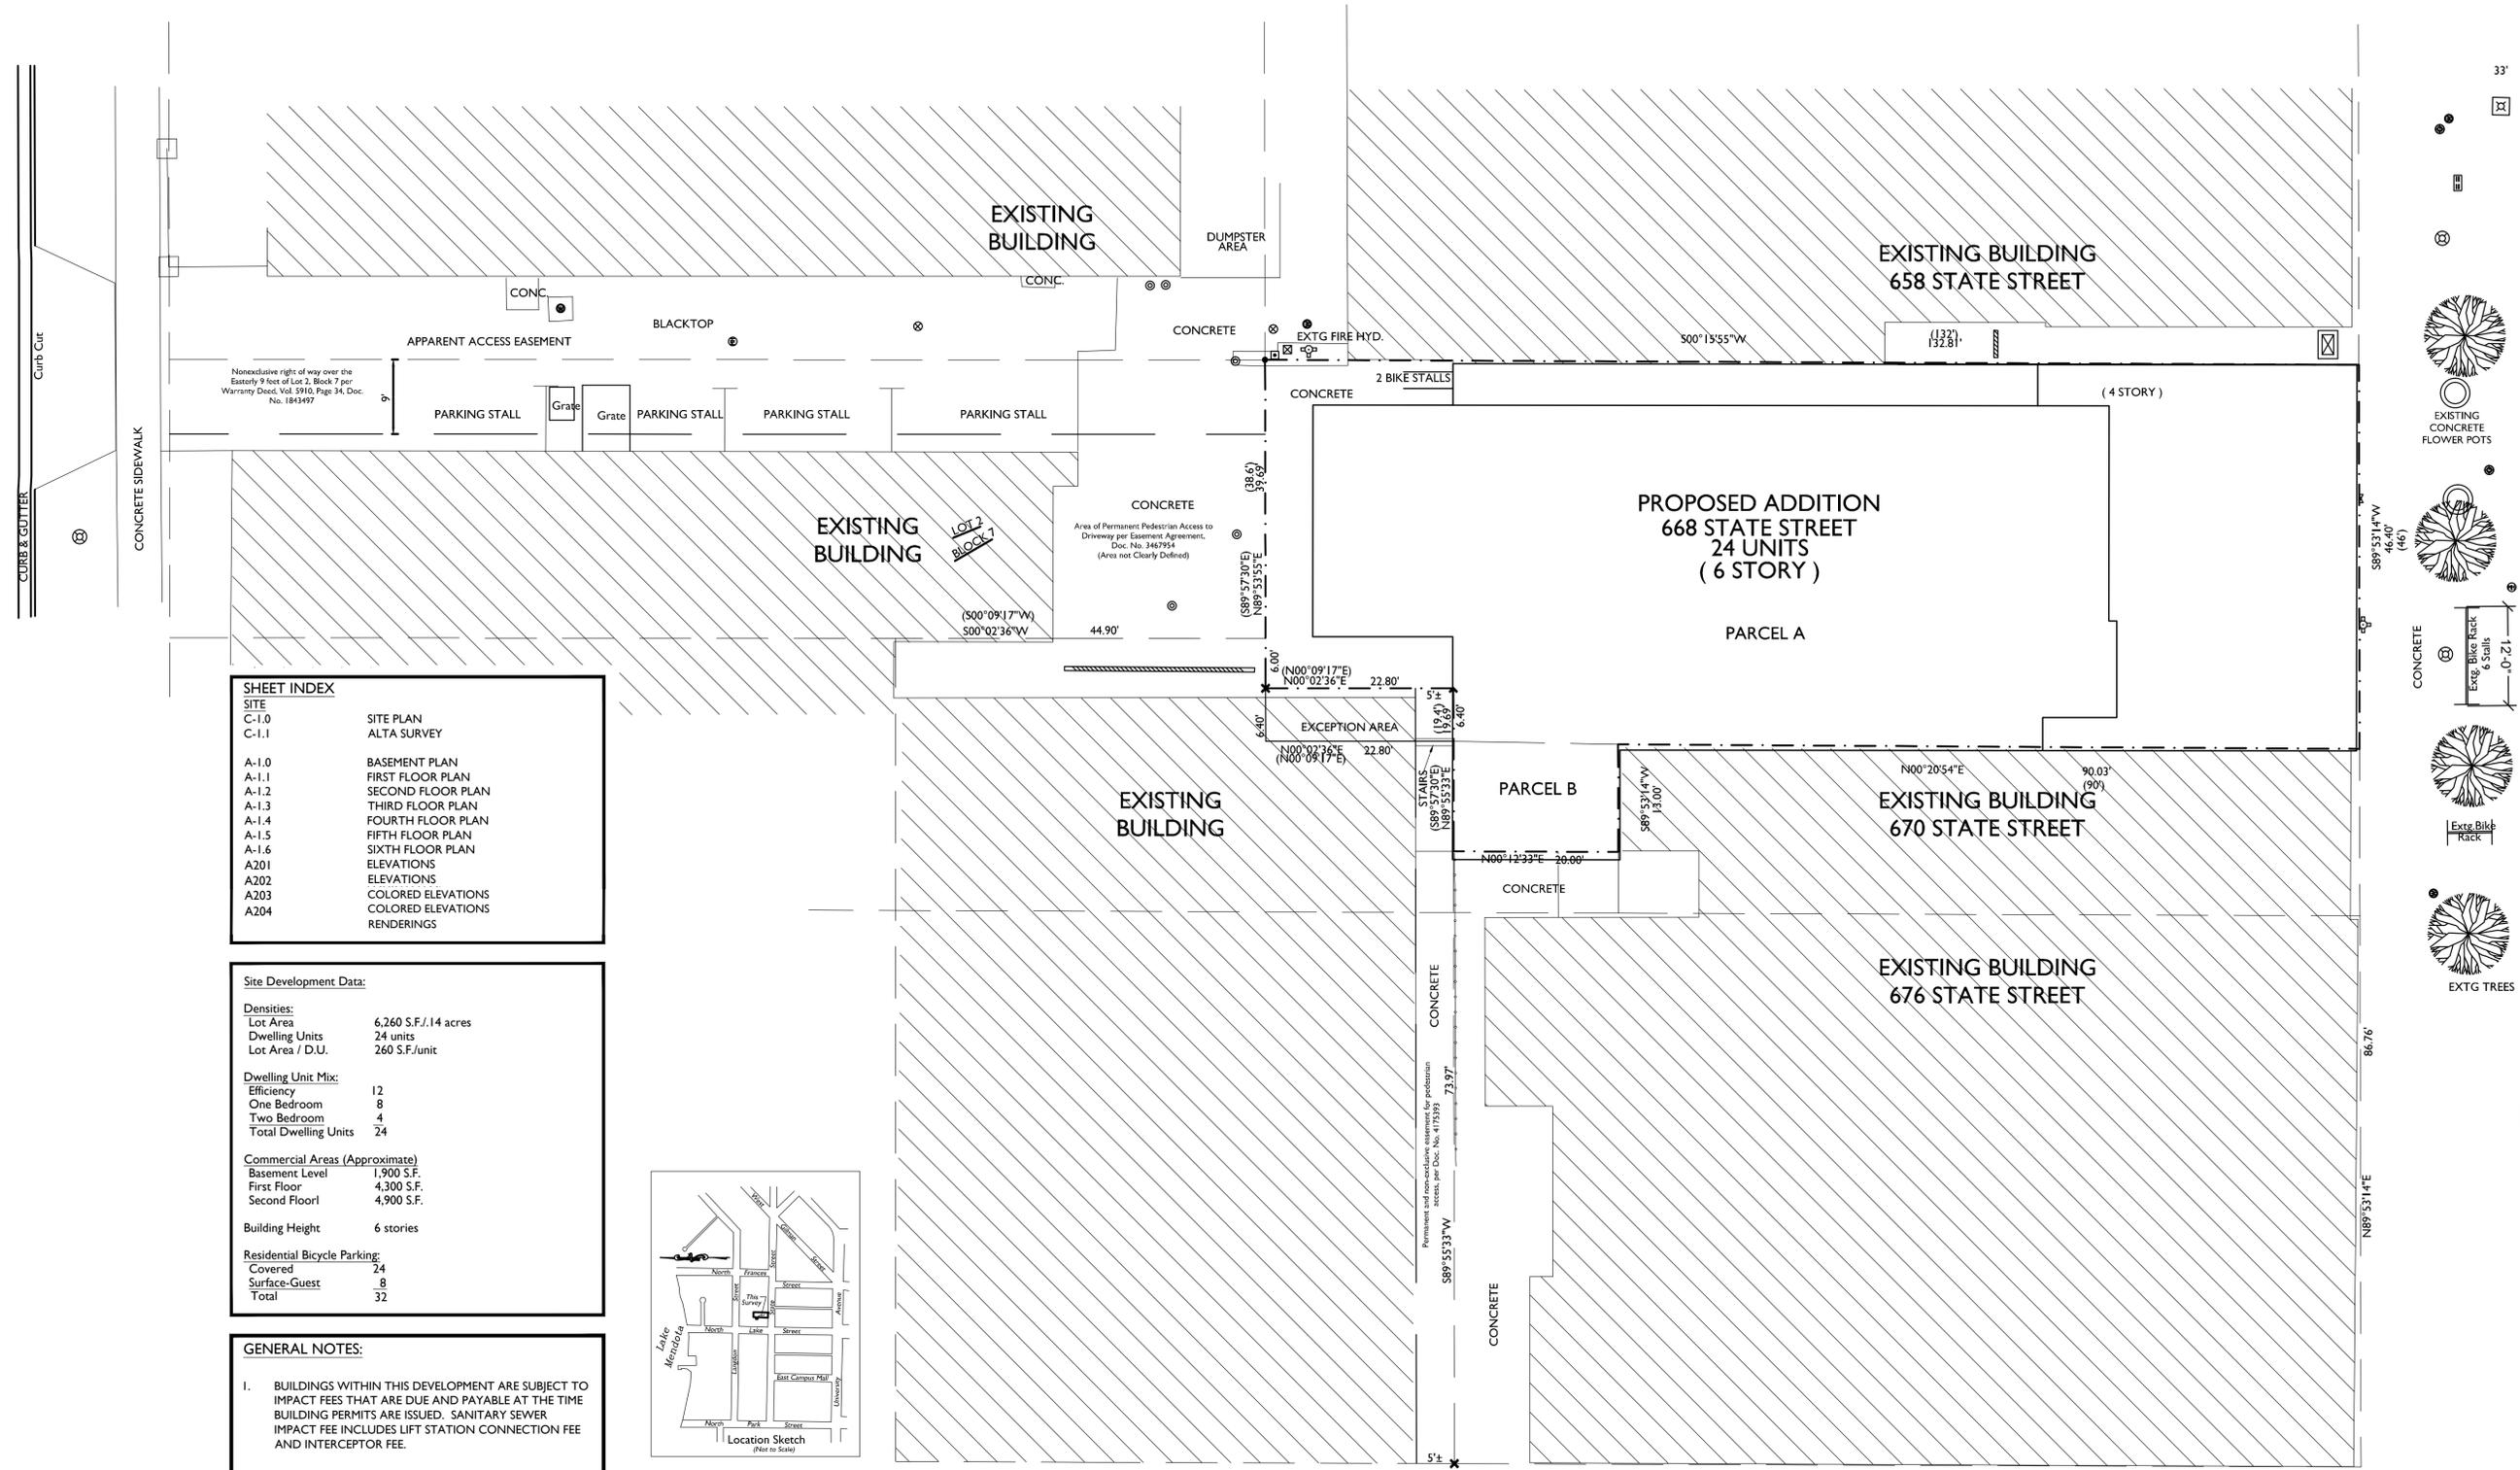


EXTG FIRE HYD.

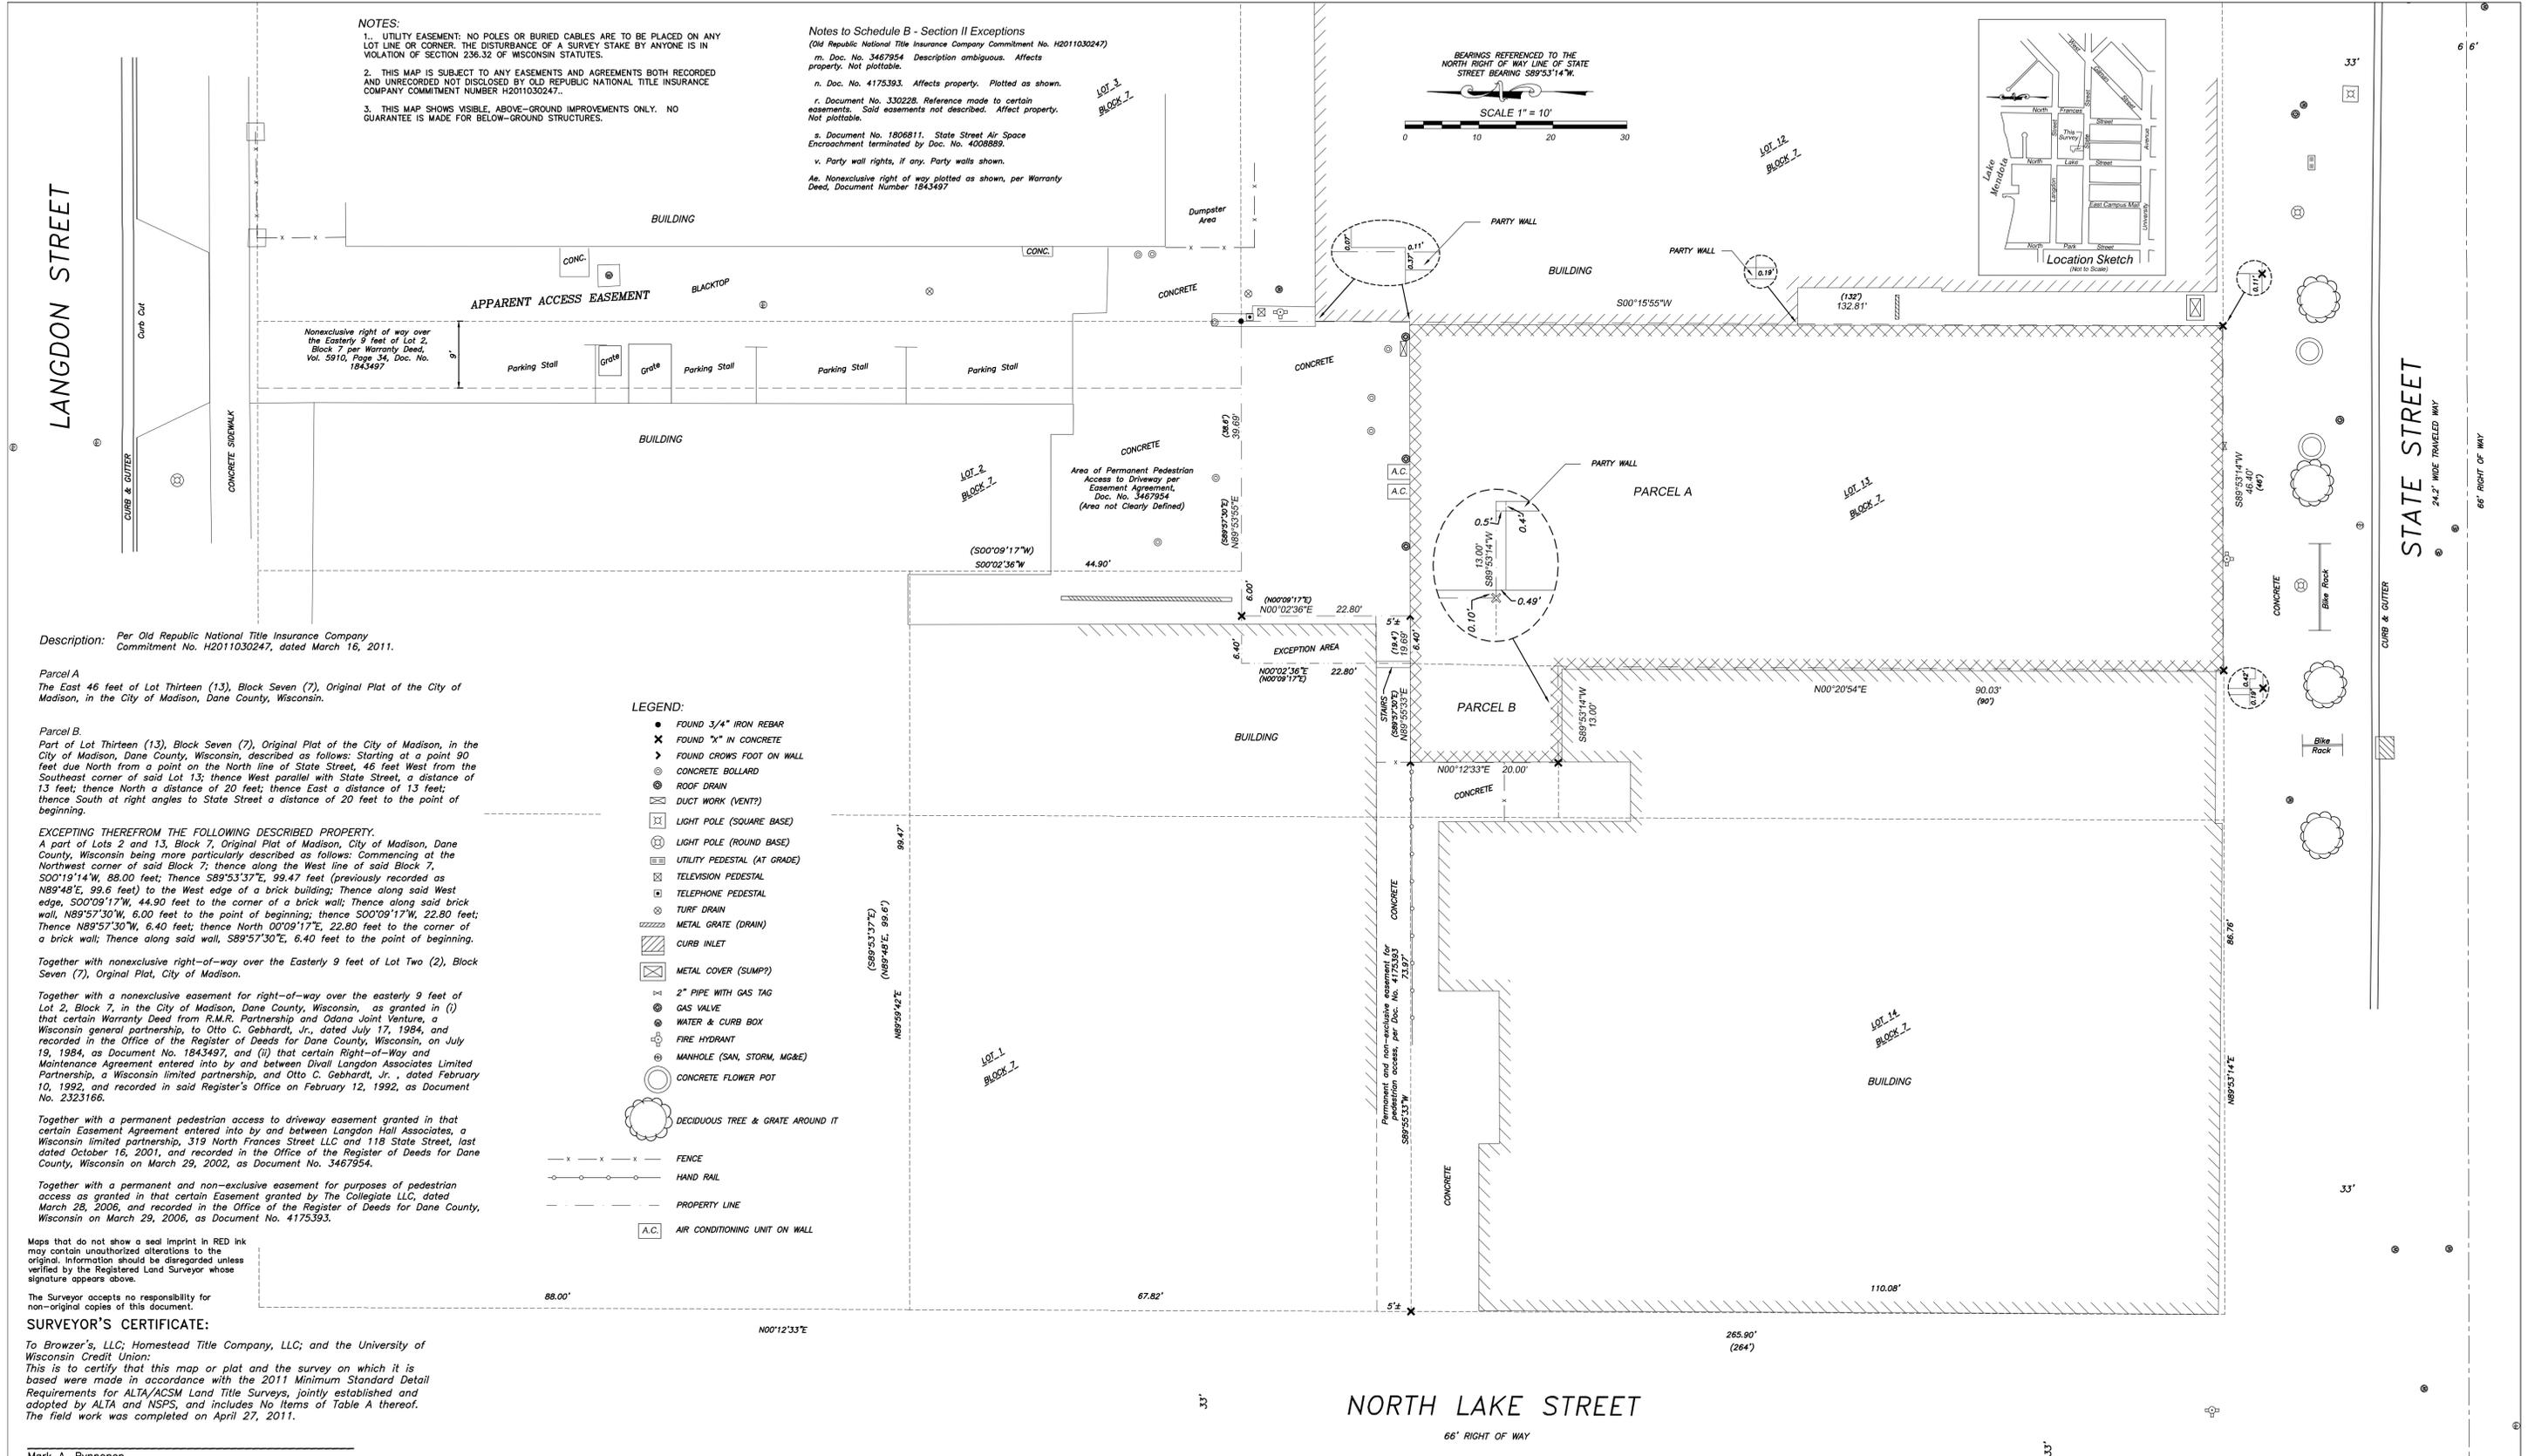

NOTES:
 1. UTILITY EASEMENT: NO POLES OR BURIED CABLES ARE TO BE PLACED ON ANY LOT LINE OR CORNER. THE DISTURBANCE OF A SURVEY STAKE BY ANYONE IS IN VIOLATION OF SECTION 236.32 OF WISCONSIN STATUTES.
 2. THIS MAP IS SUBJECT TO ANY EASEMENTS AND AGREEMENTS BOTH RECORDED AND UNRECORDED NOT DISCLOSED BY OLD REPUBLIC NATIONAL TITLE INSURANCE COMPANY COMMITMENT NUMBER H2011030247.
 3. THIS MAP SHOWS VISIBLE, ABOVE-GROUND IMPROVEMENTS ONLY. NO GUARANTEE IS MADE FOR BELOW-GROUND STRUCTURES.

Notes to Schedule B - Section II Exceptions
 (Old Republic National Title Insurance Company Commitment No. H2011030247)
 m. Doc. No. 3467954 Description ambiguous. Affects property. Not plottable.
 n. Doc. No. 4175393. Affects property. Plotted as shown.
 r. Document No. 330228. Reference made to certain easements. Said easements not described. Affect property. Not plottable.
 s. Document No. 1806811. State Street Air Space Encroachment terminated by Doc. No. 4008889.
 v. Party wall rights, if any. Party walls shown.
 Aa. Nonexclusive right of way plotted as shown, per Warranty Deed, Document Number 1843497

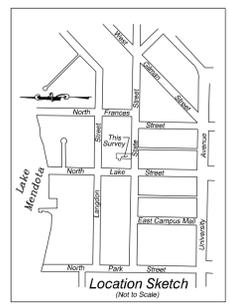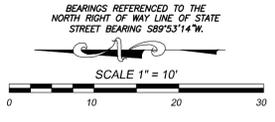

LANGDON STREET

STATE STREET

Description: Per Old Republic National Title Insurance Company Commitment No. H2011030247, dated March 16, 2011.

Parcel A
 The East 46 feet of Lot Thirteen (13), Block Seven (7), Original Plat of the City of Madison, in the City of Madison, Dane County, Wisconsin.

Parcel B
 Part of Lot Thirteen (13), Block Seven (7), Original Plat of the City of Madison, in the City of Madison, Dane County, Wisconsin, described as follows: Starting at a point 90 feet due North from a point on the North line of State Street, 46 feet West from the Southeast corner of said Lot 13; thence West parallel with State Street, a distance of 13 feet; thence North a distance of 20 feet; thence East a distance of 13 feet; thence South at right angles to State Street a distance of 20 feet to the point of beginning.

EXCEPTING THEREFROM THE FOLLOWING DESCRIBED PROPERTY.
 A part of Lots 2 and 13, Block 7, Original Plat of Madison, City of Madison, Dane County, Wisconsin being more particularly described as follows: Commencing at the Northwest corner of said Block 7; thence along the West line of said Block 7, S00°19'14"W, 88.00 feet; thence S89°53'37"E, 99.47 feet (previously recorded as N89°48'E, 99.8 feet) to the West edge of a brick building; thence along said West edge, S00°09'17"W, 44.90 feet to the corner of a brick wall; thence along said brick wall, N89°57'30"W, 6.00 feet to the point of beginning; thence S00°09'17"W, 22.80 feet; thence N89°57'30"W, 6.40 feet; thence North 00°09'17"E, 22.80 feet to the corner of a brick wall; thence along said wall, S89°57'30"E, 6.40 feet to the point of beginning.

Together with nonexclusive right-of-way over the Easterly 9 feet of Lot Two (2), Block Seven (7), Original Plat, City of Madison.

Together with a nonexclusive easement for right-of-way over the easterly 9 feet of Lot 2, Block 7, in the City of Madison, Dane County, Wisconsin, as granted in (i) that certain Warranty Deed from R.M.R. Partnership and Odana Joint Venture, a Wisconsin general partnership, to Otto C. Gebhardt, Jr., dated July 17, 1984, and recorded in the Office of the Register of Deeds for Dane County, Wisconsin, on July 19, 1984, as Document No. 1843497, and (ii) that certain Right-of-Way and Maintenance Agreement entered into by and between Divall Langdon Associates Limited Partnership, a Wisconsin limited partnership, and Otto C. Gebhardt, Jr., dated February 10, 1992, and recorded in said Register's Office on February 12, 1992, as Document No. 2323166.

Together with a permanent pedestrian access to driveway easement granted in that certain Easement Agreement entered into by and between Langdon Hall Associates, a Wisconsin limited partnership, 319 North Frances Street LLC and 118 State Street, last dated October 16, 2001, and recorded in the Office of the Register of Deeds for Dane County, Wisconsin on March 29, 2002, as Document No. 3467954.

Together with a permanent and non-exclusive easement for purposes of pedestrian access as granted in that certain Easement granted by The Collegiate LLC, dated March 28, 2006, and recorded in the Office of the Register of Deeds for Dane County, Wisconsin on March 29, 2006, as Document No. 4175393.

Maps that do not show a seal imprint in RED ink may contain unauthorized alterations to the original. Information should be disregarded unless verified by the Registered Land Surveyor whose signature appears above.

The Surveyor accepts no responsibility for non-original copies of this document.

SURVEYOR'S CERTIFICATE:

To Browzer's, LLC; Homestead Title Company, LLC; and the University of Wisconsin Credit Union:
 This is to certify that this map or plat and the survey on which it is based were made in accordance with the 2011 Minimum Standard Detail Requirements for ALTA/ACSM Land Title Surveys, jointly established and adopted by ALTA and NSPS, and includes No Items of Table A thereof. The field work was completed on April 27, 2011.

Mark A. Pynnnonen
 Wisconsin Registered Land Surveyor No. S-2538.

- LEGEND:**
- FOUND 3/4" IRON REBAR
 - ✕ FOUND "X" IN CONCRETE
 - FOUND CROWS FOOT ON WALL
 - ⊙ CONCRETE BOLLARD
 - ⊕ ROOF DRAIN
 - ⊖ DUCT WORK (VENT?)
 - ⊞ LIGHT POLE (SQUARE BASE)
 - ⊚ LIGHT POLE (ROUND BASE)
 - ⊕ UTILITY PEDESTAL (AT GRADE)
 - ⊞ TELEVISION PEDESTAL
 - ⊕ TELEPHONE PEDESTAL
 - ⊕ TURF DRAIN
 - ⊕ METAL GRATE (DRAIN)
 - ⊕ CURB INLET
 - ⊕ METAL COVER (SLUMP?)
 - ⊕ 2" PIPE WITH GAS TAG
 - ⊕ GAS VALVE
 - ⊕ WATER & CURB BOX
 - ⊕ FIRE HYDRANT
 - ⊕ MANHOLE (SAN, STORM, MG&E)
 - ⊕ CONCRETE FLOWER POT
 - ⊕ DECIDUOUS TREE & GRATE AROUND IT
 - - - - - FENCE
 - - - - - HAND RAIL
 - - - - - PROPERTY LINE
 - A.C. AIR CONDITIONING UNIT ON WALL

BIRRENKOTT SURVEYING INC.
 LAND SURVEYING & PERC TESTING
 P.O. BOX 237 1677 N. BRISTOL ST. SUN PRAIRIE, WIS. 53590
 (608) 837-7463 FAX (608) 837-1081

ALTA/ACSM LAND TITLE SURVEY
 REVISED: MAY 23, 2011 APRIL 27, 2011

SURVEYED BY P.F.M.C./C.K.C.
 DRAWN BY P.F.M.C./M.A.P.
 CHECKED BY M.A.P./D.V.B.
 APPRV'D BY D.V.B.

PREPARED FOR:
BROWZERS, LLP
 513 N. LAKE STREET
 MADISON, WI 53703
 608-576-1132

JOB NO. **110184**
 SHEET **C-1.1**
 FB 321/27-28



knothe • bruce
ARCHITECTS

Phone: 7601 University Ave., Ste 201
608.836.3690 Middleton, WI 53562

ISSUED
Issued for LUA & UDC - September 26, 2022

PROJECT TITLE
668 State Street
Vertical Expansion


664 & 668 State Street,
Madison, Wisconsin
SHEET TITLE
Basement Floor

SHEET NUMBER

A-1.0

PROJECT NO. **1706**

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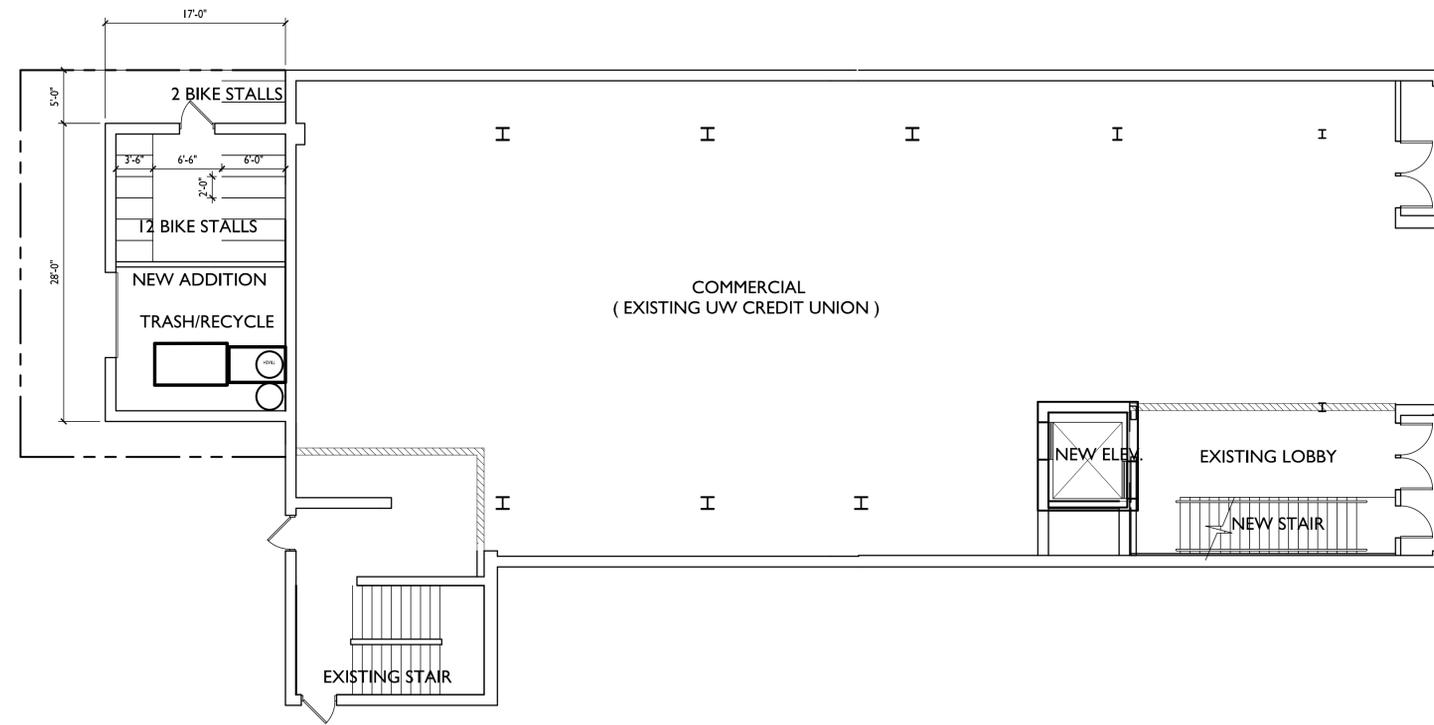
1 BASEMENT FLOOR PLAN
A-1.0 1/8" = 1'-0"

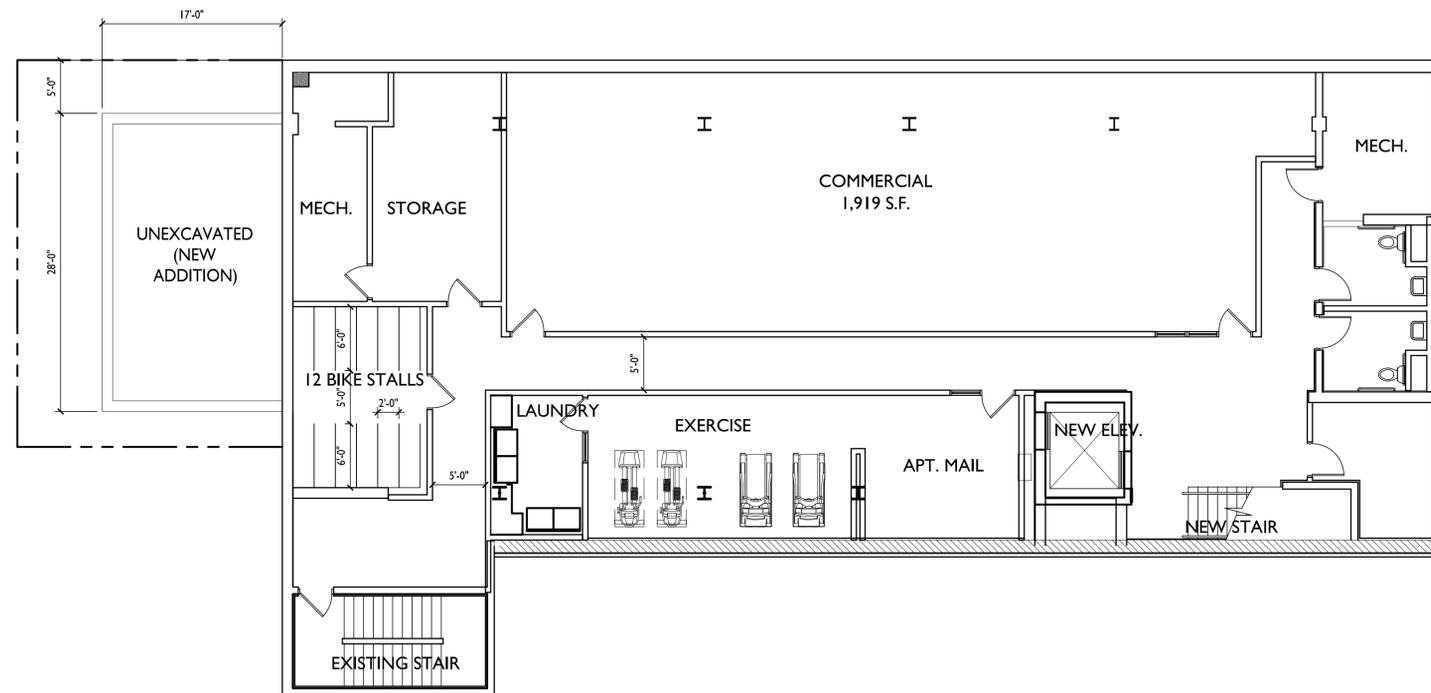



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PROJECT TITLE
668 State Street
Vertical Expansion

664 & 668 State Street,
Madison, Wisconsin
SHEET TITLE
First Floor Plan

1 FIRST FLOOR PLAN
A-1.1 1/8" = 1'-0"



SHEET NUMBER

A-1.1

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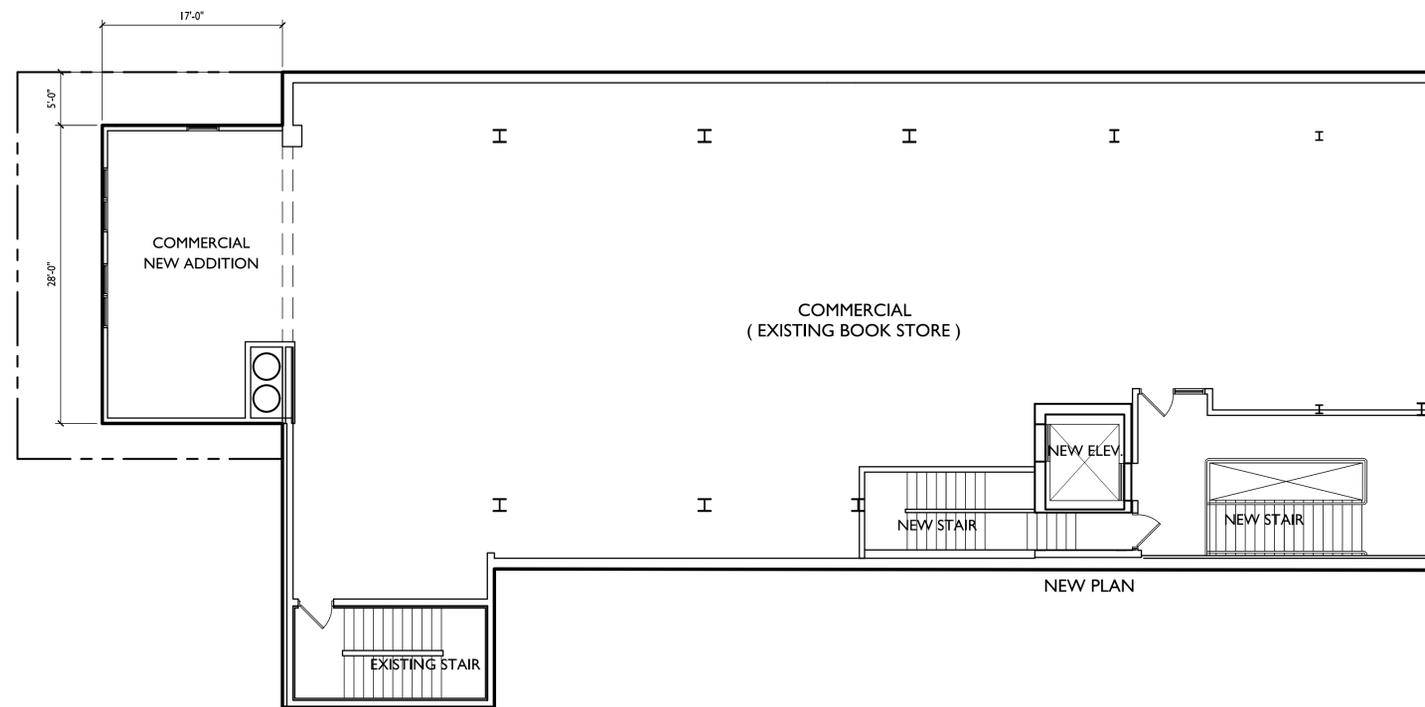
664 & 668 State Street,
Madison, Wisconsin
SHEET TITLE
Second Floor Plan

SHEET NUMBER

A-1.2

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1 SECOND FLOOR PLAN
A-1.2 1/8" = 1'-0"





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PROJECT TITLE
**668 State Street
Vertical Expansion**


664 & 668 State Street,
Madison, Wisconsin
SHEET TITLE
Third Floor Plan

SHEET NUMBER


A-1.3

PROJECT NO. **1706**

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1 THIRD FLOOR PLAN
A-1.3 1/8" = 1'-0"

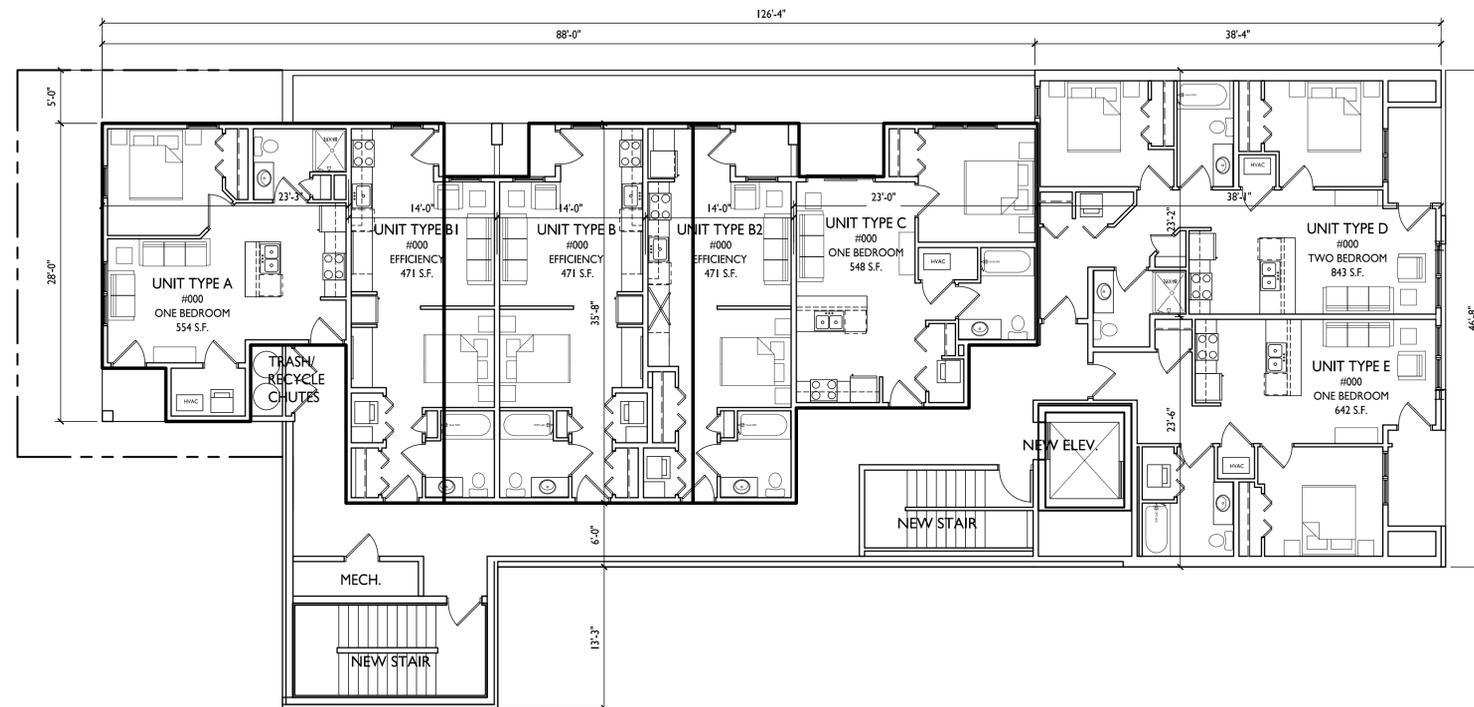

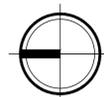

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PROJECT TITLE
**668 State Street
Vertical Expansion**


664 & 668 State Street,
Madison, Wisconsin
SHEET TITLE
Fourth Floor Plan

SHEET NUMBER

A-1.4

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1 FOURTH FLOOR PLAN
A-1.4 1/8" = 1'-0"

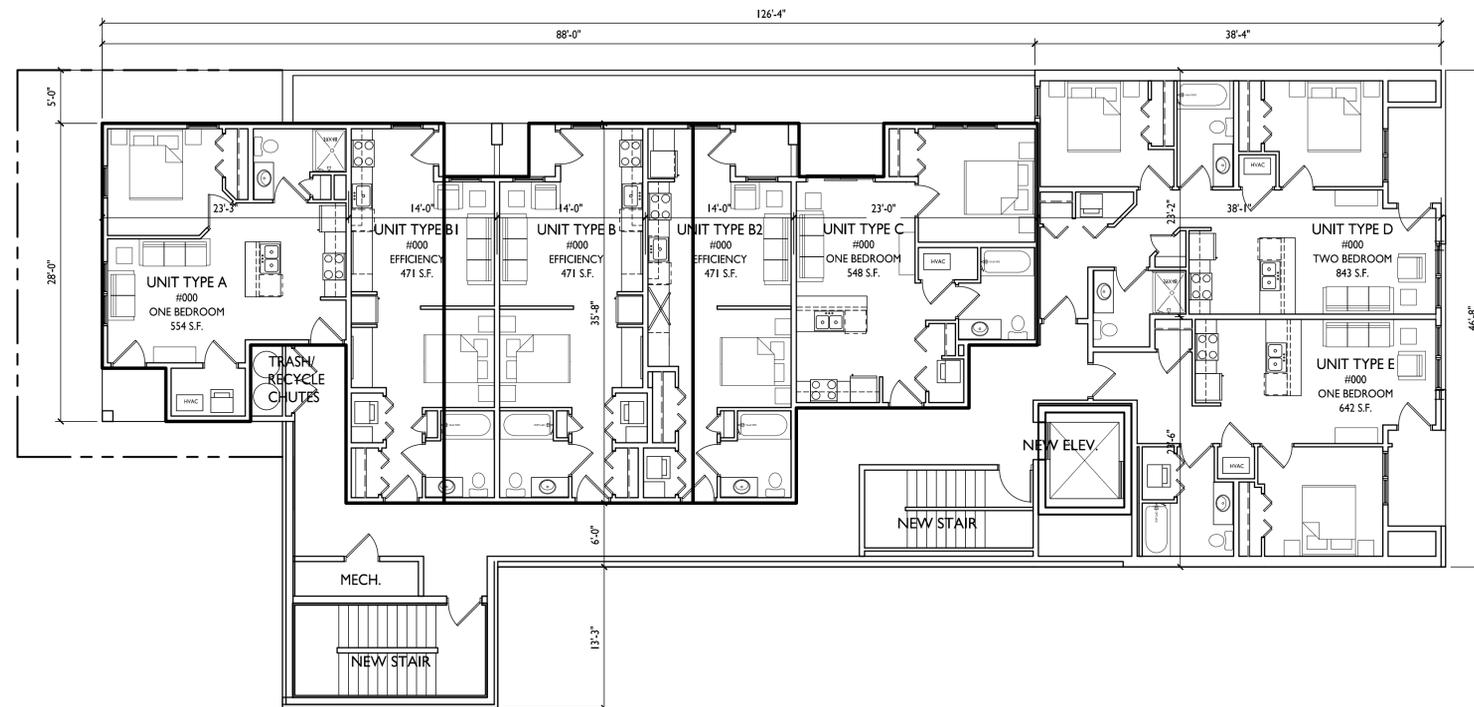

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PROJECT TITLE
668 State Street
Vertical Expansion


664 & 668 State Street,
Madison, Wisconsin
SHEET TITLE
Fifth Floor Plan

SHEET NUMBER

A-1.5

PROJECT NO. **1706**

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FIFTH FLOOR PLAN
A-1.5 1/8" = 1'-0"

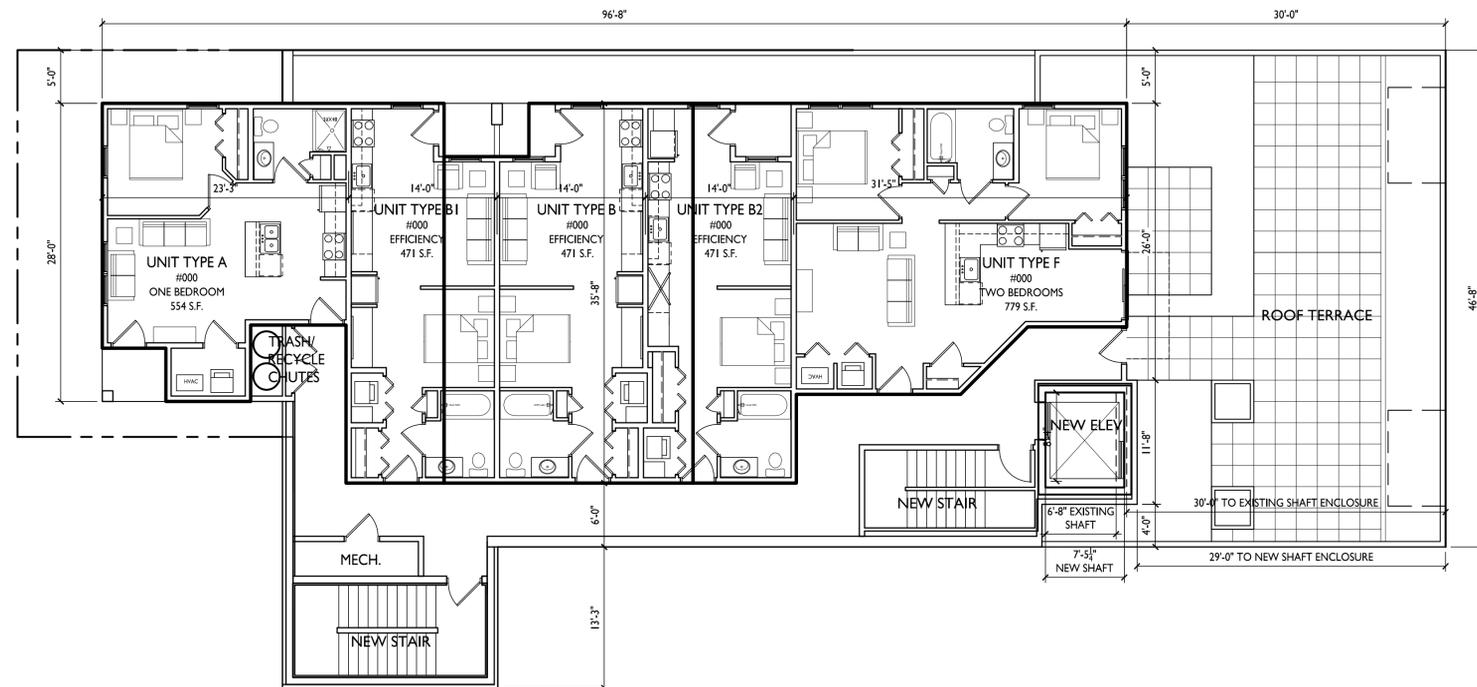



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PROJECT TITLE
668 State Street
Vertical Expansion


664 & 668 State Street,
Madison, Wisconsin
SHEET TITLE
Sixth Floor Plan

SHEET NUMBER

A-1.6

PROJECT NO. **1706**

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SIXTH FLOOR PLAN
A-1.6 1/8" = 1'-0"

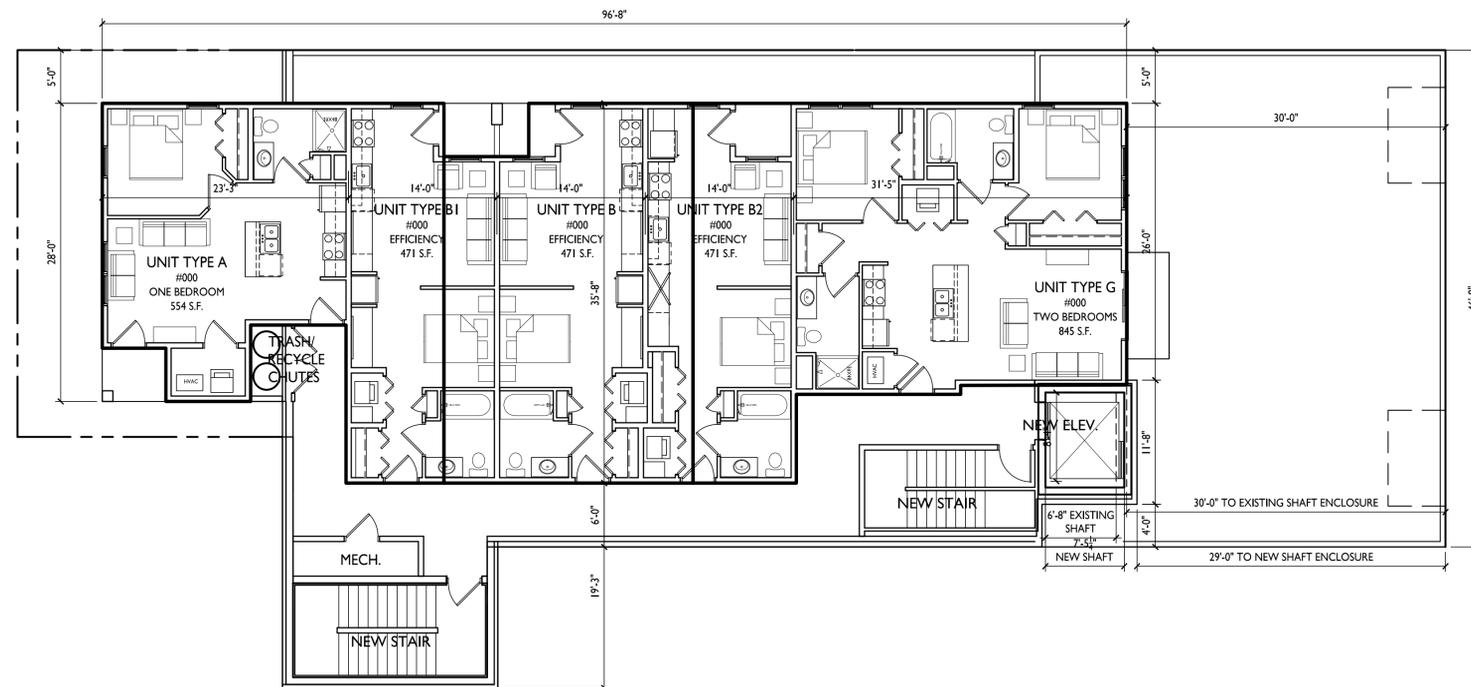

NOT FOR CONSTRUCTION

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PROJECT TITLE
**668 State Street
Vertical
Expansion**

668 State Street
Madison, Wisconsin
SHEET TITLE

**EXTERIOR
ELEVATIONS**

SHEET NUMBER

A201


PROJECT NUMBER 1706



1
A201 ELEVATION - SOUTH
1/8" = 1'-0"



2
A201 ELEVATION - NORTH
1/8" = 1'-0"

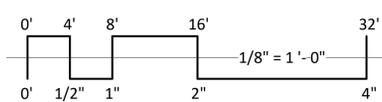

EXTERIOR MATERIAL SCHEDULE		
BUILDING ELEMENT	MANUFACTURER	COLOR
(#1) - VISIONLINE F-SERIES - METAL PANEL	MCELROY METAL	SLATE GRAY
(#2) - MULTI-V - METAL PANEL	MCELROY METAL	SANDSTONE
(#3) - METAL PANEL	MCELROY METAL	PATRICIAN BRONZE
COMPOSITE TRIM	MCELROY METAL	COLOR TO MATCH ADJ. TRIM/SIDING
(#4) - BRICK VENEER	SUMMIT BRICK	MISTY
(#5) - BRICK VENEER - SOLDIER COURSE	SUMMIT BRICK	MISTY
(#6) - CAST STONE BANDS & HEADERS	ROCKCAST	BUR RIDGE
(#7) - COMPOSITE WINDOWS	ANDERSON	BLACK
ALUM. STOREFRONT	N/A	BLACK
CANOPY & BAY SOFFITS	MCELROY	COLOR TO MATCH ADJ. TRIM/SIDING
TREATED-EXPOSED DECK BEAMS	N/A	BROWN TREATED
(#8) - RAILINGS & HANDRAILS	SUPERIOR	BLACK



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PROJECT TITLE
**668 State Street
Vertical
Expansion**

668 State Street
Madison, Wisconsin
SHEET TITLE



**EXTERIOR
ELEVATIONS**

SHEET NUMBER

A202

PROJECT NUMBER **1706**

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EXTERIOR MATERIAL SCHEDULE		
BUILDING ELEMENT	MANUFACTURER	COLOR
(#1) - VISIONLINE F-SERIES - METAL PANEL	MCELROY METAL	SLATE GRAY
(#2) - MULTI-V - METAL PANEL	MCELROY METAL	SANDSTONE
(#3) - METAL PANEL	MCELROY METAL	PATRICIAN BRONZE
COMPOSITE TRIM	MCELROY METAL	COLOR TO MATCH ADJ. TRIM/SIDING
(#4) - BRICK VENEER	SUMMIT BRICK	MISTY
(#5) - BRICK VENEER - SOLDIER COURSE	SUMMIT BRICK	MISTY
(#6) - CAST STONE BANDS & HEADERS	ROCKCAST	BUR RIDGE
(#7) - COMPOSITE WINDOWS	ANDERSON	BLACK
ALUM. STOREFRONT	N/A	BLACK
CANOPY & BAY SOFFITS	MCELROY	COLOR TO MATCH ADJ. TRIM/SIDING
TREATED-EXPOSED DECK BEAMS	N/A	BROWN TREATED
(#8) - RAILINGS & HANDRAILS	SUPERIOR	BLACK

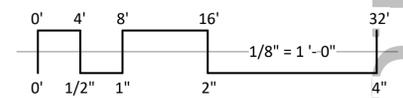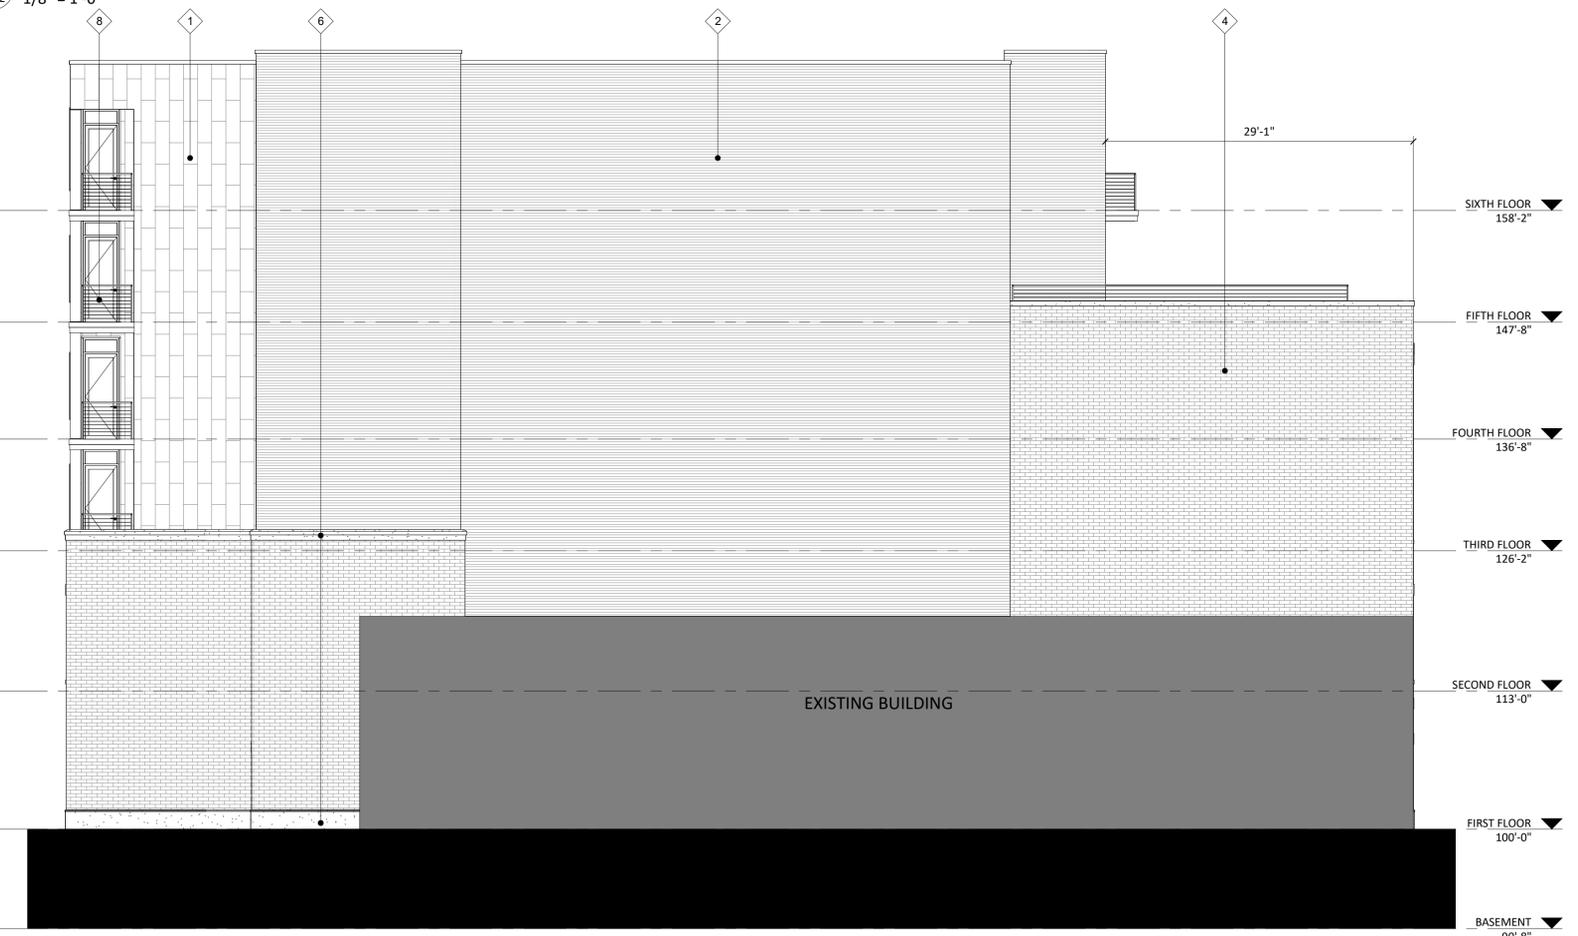NOT FOR CONSTRUCTION

ISSUED
Issued for ZBA - September 16, 2022

PROJECT TITLE
**668 State Street
Vertical
Expansion**

668 State Street
Madison, Wisconsin
SHEET TITLE

**EXTERIOR
ELEVATIONS
COLORED**


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A203


PROJECT NUMBER 1706



1 COLORED ELEVATION - SOUTH
A203 1/8" = 1'-0"

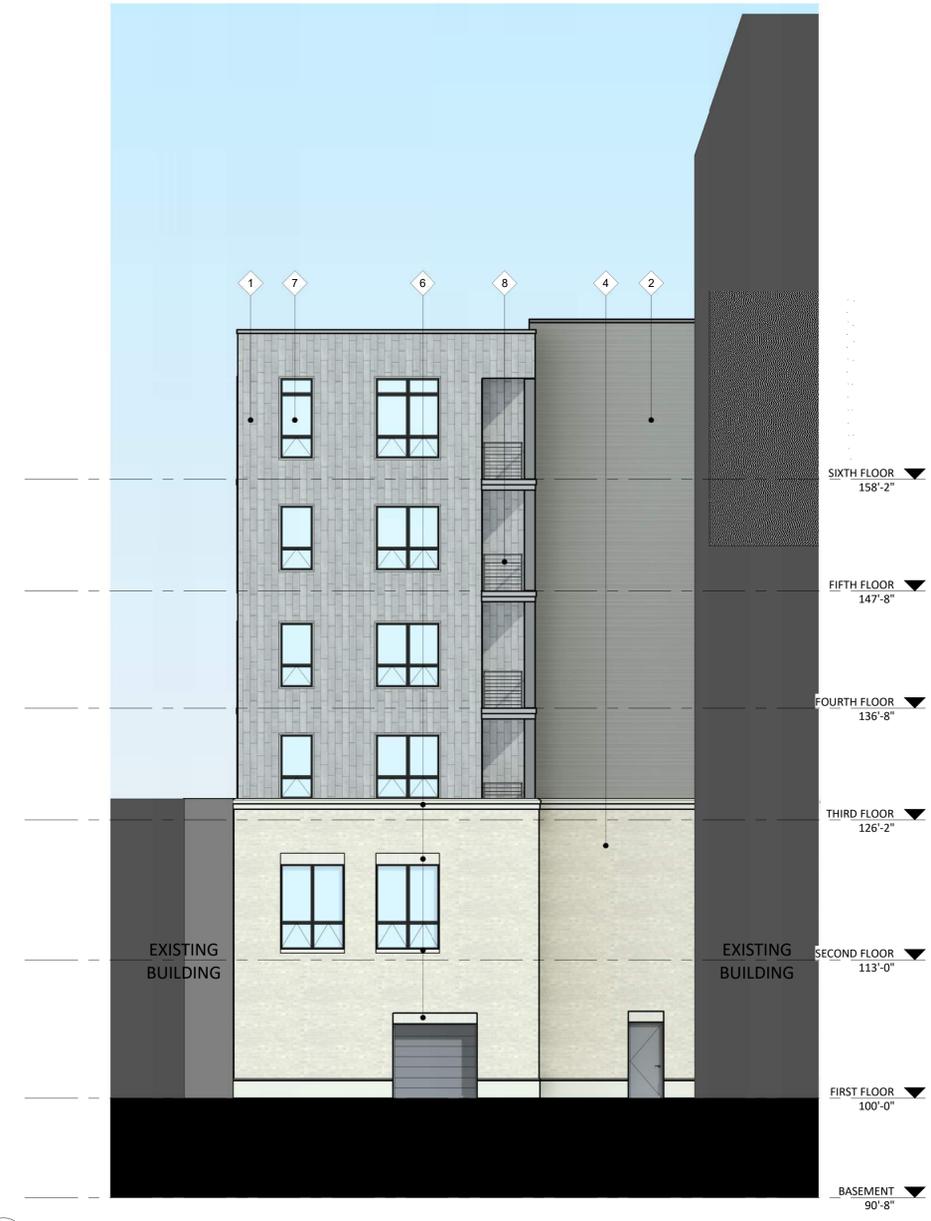


2 COLORED ELEVATION - NORTH
A203 1/8" = 1'-0"

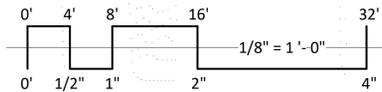


EXTERIOR MATERIAL SCHEDULE		
BUILDING ELEMENT	MANUFACTURER	COLOR
(#1) - VISIONLINE F-SERIES - METAL PANEL	MCELROY METAL	SLATE GRAY
(#2) - MULTI-V - METAL PANEL	MCELROY METAL	SANDSTONE
(#3) - METAL PANEL	MCELROY METAL	PATRICIAN BRONZE
COMPOSITE TRIM	MCELROY METAL	COLOR TO MATCH ADJ. TRIM/SIDING
(#4) - BRICK VENEER	SUMMIT BRICK	MISTY
(#5) - BRICK VENEER - SOLDIER COURSE	SUMMIT BRICK	MISTY
(#6) - CAST STONE BANDS & HEADERS	ROCKCAST	BUR RIDGE
(#7) - COMPOSITE WINDOWS	ANDERSON	BLACK
ALUM. STOREFRONT	N/A	BLACK
CANOPY & BAY SOFFITS	MCELROY	COLOR TO MATCH ADJ. TRIM/SIDING
TREATED-EXPOSED DECK BEAMS	N/A	BROWN TREATED
(#8) - RAILINGS & HANDRAILS	SUPERIOR	BLACK



1 COLORED ELEVATION - EAST
A204 1/8" = 1'-0"

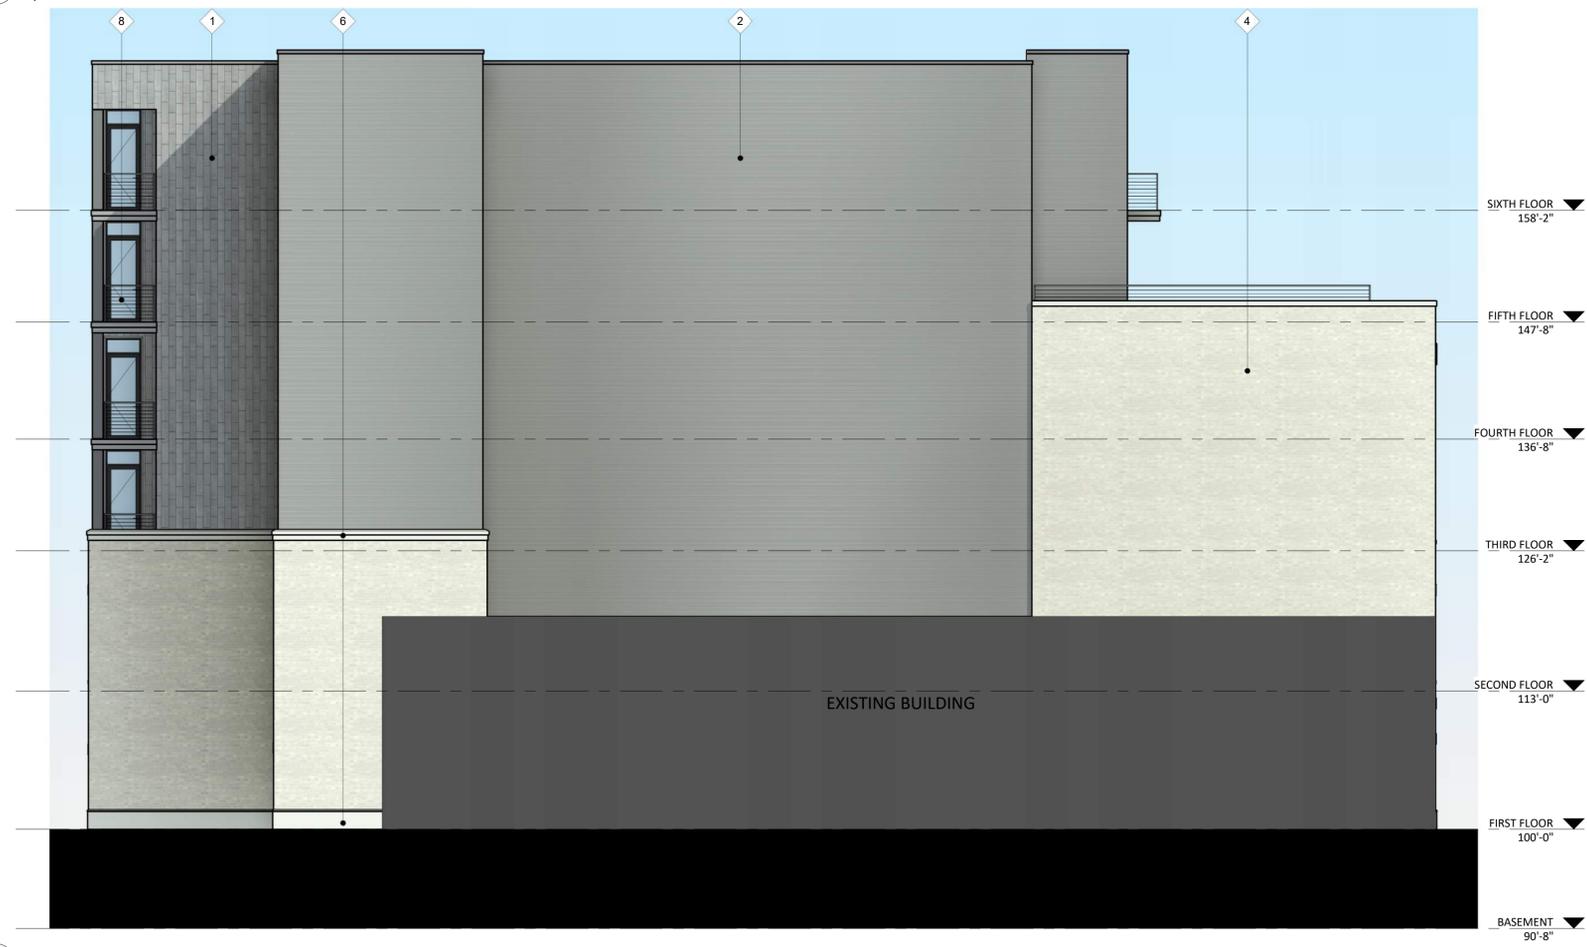

2 COLORED ELEVATION - WEST
A204 1/8" = 1'-0"

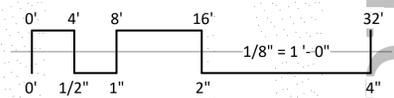

EXTERIOR MATERIAL SCHEDULE		
BUILDING ELEMENT	MANUFACTURER	COLOR
(#1) - VISIONLINE F-SERIES - METAL PANEL	MCELROY METAL	SLATE GRAY
(#2) - MULTI-V - METAL PANEL	MCELROY METAL	SANDSTONE
(#3) - METAL PANEL	MCELROY METAL	PATRICIAN BRONZE
COMPOSITE TRIM	MCELROY METAL	COLOR TO MATCH ADJ. TRIM/SIDING
(#4) - BRICK VENEER	SUMMIT BRICK	MISTY
(#5) - BRICK VENEER - SOLDIER COURSE	SUMMIT BRICK	MISTY
(#6) - CAST STONE BANDS & HEADERS	ROCKCAST	BUR RIDGE
(#7) - COMPOSITE WINDOWS	ANDERSON	BLACK
ALUM. STOREFRONT	N/A	BLACK
CANOPY & BAY SOFFITS	MCELROY	COLOR TO MATCH ADJ. TRIM/SIDING
TREATED-EXPOSED DECK BEAMS	N/A	BROWN TREATED
(#8) - RAILINGS & HANDRAILS	SUPERIOR	BLACK

NOT FOR CONSTRUCTION

ISSUED
 Issued for ZBA - September 16, 2022

PROJECT TITLE
**668 State Street
 Vertical
 Expansion**

668 State Street
 Madison, Wisconsin
 SHEET TITLE

**EXTERIOR
 ELEVATIONS
 COLORED**

SHEET NUMBER

A204

PROJECT NUMBER **1706**



LOOKING NORTH-WEST





LOOKING NORTH-WEST






SIGNAGE

SIGNAGE

Uw Credit Union

CHIPOTLE

LOOKING NORTH

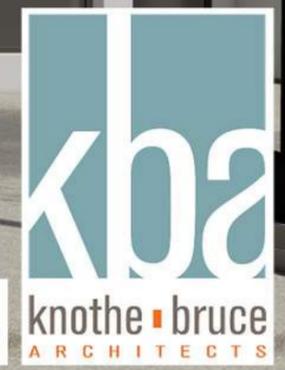



SIGNAGE

SIGNAGE

W Credit Union

LOOKING NORTH






LOOKING NORTH-EAST





LOOKING NORTH-EAST

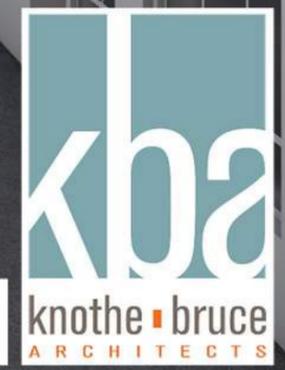



City of Madison Fire Department

314 W Dayton Street, Madison, WI 53703-2506
 Phone: 608-266-4420 • Fax: 608-267-1100 • E-mail: fire@cityofmadison.com

Project Address: 668 State Street

Contact Name & Phone #: Kevin Burow 608-836-3690

FIRE APPARATUS ACCESS AND FIRE HYDRANT WORKSHEET

1. Is the building completely protected by an NFPA 13 or 13R automatic fire sprinkler system? If non-sprinklered , fire lanes extend to within 150-feet of all portions of the exterior wall? If sprinklered , fire lanes are within 250-feet of all portions of the exterior wall?	<input checked="" type="checkbox"/> Yes <input type="checkbox"/> Yes <input checked="" type="checkbox"/> Yes	<input type="checkbox"/> No <input type="checkbox"/> No <input type="checkbox"/> No	<input type="checkbox"/> N/A <input checked="" type="checkbox"/> N/A <input type="checkbox"/> N/A
2. Is the fire lane constructed of concrete or asphalt, designed to support a minimum load of 85,000 lbs? a) Is the fire lane a minimum unobstructed width of at least 20-feet? b) Is the fire lane unobstructed with a vertical clearance of at least 13½-feet? c) Is the minimum inside turning radius of the fire lane at least 28-feet? d) Is the grade of the fire lane not more than a slope of 8%? e) Is the fire lane posted as fire lane? (Provide detail of signage.) f) Is a roll-able curb used as part of the fire lane? (Provide detail of curb.) g) Is part of a sidewalk used as part of the required fire lane? (Must support +85,000 lbs.)	<input checked="" type="checkbox"/> Yes <input checked="" type="checkbox"/> Yes <input checked="" type="checkbox"/> Yes <input checked="" type="checkbox"/> Yes <input type="checkbox"/> Yes <input type="checkbox"/> Yes <input type="checkbox"/> Yes	<input type="checkbox"/> No <input type="checkbox"/> No <input type="checkbox"/> No <input type="checkbox"/> No <input checked="" type="checkbox"/> No <input checked="" type="checkbox"/> No <input checked="" type="checkbox"/> No	<input type="checkbox"/> N/A <input type="checkbox"/> N/A <input type="checkbox"/> N/A <input type="checkbox"/> N/A <input type="checkbox"/> N/A <input type="checkbox"/> N/A <input type="checkbox"/> N/A
3. Is the fire lane obstructed by security gates or barricades? If yes: a) Is the gate a minimum of 20-feet clear opening? b) Is an approved means of emergency operations installed, key vault, padlock or key switch?	<input type="checkbox"/> Yes <input type="checkbox"/> Yes <input type="checkbox"/> Yes	<input checked="" type="checkbox"/> No <input type="checkbox"/> No <input type="checkbox"/> No	<input type="checkbox"/> N/A <input checked="" type="checkbox"/> N/A <input checked="" type="checkbox"/> N/A
4. Is the Fire lane dead-ended with a length greater than 150-feet? If yes, does the area for turning around fire apparatus comply with IFC D103?	<input type="checkbox"/> Yes <input type="checkbox"/> Yes	<input checked="" type="checkbox"/> No <input type="checkbox"/> No <input type="checkbox"/> No	<input type="checkbox"/> N/A <input checked="" type="checkbox"/> N/A
5. Is any portion of the building to be used for high-piled storage in accordance with IFC Chapter 3206.6 If yes, see IFC 3206.6 for further requirements.	<input type="checkbox"/> Yes	<input checked="" type="checkbox"/> No	<input type="checkbox"/> N/A
6. Is any part of the building <u>greater than 30-feet</u> above the grade plane? If yes, answer the following questions: a) Is the aerial apparatus fire lane parallel to one entire side of the building and covering at least 25% of the perimeter? b) Is the near edge of the aerial apparatus fire lane between 15' and 30' from the building? c) Are there any overhead power or utility lines located across the aerial apparatus fire lane? d) Are there any tree canopies expected to grow across the aerial fire lane? (Based on mature canopy width of tree species) e) Does the aerial apparatus fire lane have a minimum unobstructed width of 26-feet? f) Is the space between the aerial lane and the building free of trees exceeding 20' in heights?	<input checked="" type="checkbox"/> Yes <input type="checkbox"/> Yes	<input type="checkbox"/> No <input type="checkbox"/> No <input checked="" type="checkbox"/> No <input type="checkbox"/> No <input type="checkbox"/> No <input checked="" type="checkbox"/> No	<input type="checkbox"/> N/A <input type="checkbox"/> N/A <input type="checkbox"/> N/A <input type="checkbox"/> N/A <input type="checkbox"/> N/A <input type="checkbox"/> N/A
7. Are all portions of the required fire lanes within 500-feet of at least (2) hydrants? <i>Note: Distances shall be measured along the path of the hose lay as it comes off the fire apparatus.</i> a) Is the fire lane at least 26' wide for at least 20-feet on each side of the hydrants? b) Is there at least 40' between a hydrant and the building? c) Are the hydrant(s) setback no less than 5-feet nor more than 10-feet from the curb or edge of the street or fire lane? d) Are hydrants located in parking lot islands a minimum of 3½-feet from the hydrant to the curb? e) Are there no obstructions, including but not limited to: power poles, trees, bushes, fences, posts located, or grade changes exceeding 1½-feet, within 5-feet of a fire hydrant? <i>Note: Hydrants shall be installed and in-service prior to combustible construction on the project site.</i>	<input checked="" type="checkbox"/> Yes <input checked="" type="checkbox"/> Yes <input checked="" type="checkbox"/> Yes <input checked="" type="checkbox"/> Yes <input type="checkbox"/> Yes <input type="checkbox"/> Yes	<input type="checkbox"/> No <input type="checkbox"/> No <input type="checkbox"/> No <input checked="" type="checkbox"/> No <input checked="" type="checkbox"/> No	<input type="checkbox"/> N/A <input type="checkbox"/> N/A <input type="checkbox"/> N/A <input type="checkbox"/> N/A <input type="checkbox"/> N/A

Attach an additional sheet if further explanation is required for any answers.

This worksheet is based on **MGO 34.503** and **IFC 2015 Edition Chapter 5 and Appendix D**; please see the codes for further information.