APPLICATION FOR URBAN DESIGN COMMISSION REVIEW AND APPROVAL

| DATE SUBMITTED: 5.28.08 UDC MEETING DATE: 6.4.08 | Action Requested Informational Presentation Initial Approval and/or Recommendation Final Approval and/or Recommendation |
|--|---|
| PROJECT ADDRESS: Allied Drive, be Aldermanic district: 10 | etween Jenewein of Chescent |
| Phone: P.o. Box 2905 N Phone: 608. 266. 4636 Fax: 608. 261. 9136 | |
| TYPE OF PROJECT: (See Section A for:) Planned Unit Development (PUD) General Development Plan (GDP) Specific Implementation Plan (SIP) Planned Community Development (PCD) General Development Plan (GDP) Specific Implementation Plan (SIP) Planned Residential Development (PRD) New Construction or Exterior Remodeling in arwell as a fee) School, Public Building or Space (Fee may be respectively) | u Urban Design District * (A public hearing is required as |
| (See Section B for:) New Construction or Exterior Remodeling in Construction or Exterior Remode | 4 District (Fee required) |
| (See Section C for:) R.P.S.M. Parking Variance (Fee required) | |
| (See Section D for:) Comprehensive Design Review* (Fee required) Street Graphics Variance* (Fee required) | |
| Other | 1. C. Administrative Detail |
| *Public Hearing Required (Submission Deadline 3 Wee | |
| Where fees are required (as noted above) they apply with | th the first submittal for either initial or final approval of |



LETTER OF INTENT

ALLIED DRIVE NEIGHBORHOOD REDEVELOPMENT Phase I & II: PUD-GDP Phase I: PUD-SIP

May 7, 2008

The following is submitted together with the plans, application and zoning text for staff, Plan Commission and Common Council consideration of approval.

Introduction:

The City of Madison Community Development Authority (CDA) is proposing a residential re-development for properties, which the City acquired and is now transferring to the CDA. The site is an eleven and one-half acre site on Madison's Southwest side, bounded by Allied Drive, Jenewein Road, the City of Fitchburg, and one/two-family properties on Crescent Road to the south. The site is an assemblage of 5 parcels containing eleven apartment buildings. These buildings comprise a total of 145 units sub-standard rental-housing units.

Phase I, which will consist of 48 new rental units (plus a resident manager unit) for households with low- and very low-income, is being supported by approximately \$7.5 million in Low Income Housing Tax Credits authorized by the Wisconsin Housing and Economic Development Authority. Phase II will consist of approximately 60 owner-occupied units, designed and constructed by various parties following the issuance of Requests for Proposals (RFP). The Phase II RFP is budgeted for a late Summer 2008 release.

This project has included extensive public participation, including a four-day AIA sponsored design Charrette in 2006, several neighborhood meetings in 2007 and 2008, ongoing meetings with the neighborhood, including the Allied Area Task Force, broader community meetings, and availability of progress drawings on a public website, created for this project. www.alliedpartnership.com

Phase I & II: PUD-GDP

The subject General Development Plan (GDP) is for 2 apartment buildings (32 units), seven town home buildings (47 units), five duplex buildings (10 units), and twenty-four single-family lots, covering the entire 11.5 acres of the site. Of the 113 housing units proposed, 49 are rental units and 64 are for-sale.

With a focus on affordability & sustainability, the designs feature materials & best management practices toward that end. Amenities include a community room with associated plaza, two tot lots, public art, community gardens, and an off-road bike path. The City Arts Commission will contract with an artist to provide a 'brand' for the

proposed neighborhood. This 'brand' will be used to help form a neighborhood identity and sense-of-place.

Phase I: PUD-SIP

The subject Specific Implementation Plan (SIP) is for the 2 apartment buildings (32 units) and 3 town home buildings (17 units) on approximately the northern 3.3 acres designated as Phase I, as well as two/existing apartment buildings intended for use as interim housing during the demolition/construction phases of Phase I. All proposed new units in Phase I are tax credit rental units, with one property manager/rental office unit. The following is a summary of each of the five proposed new buildings, and site amenities for Phase I.

Project Description:

Building A

Building A at Allied Drive will be a three-story affordable apartment building over one-story of underground parking. The total gross area of the building is 32,026 SF. There are 19 units comprised of: six-3BR, six-2BR, six-1BR, and one Studio. There are a total of 42 bedrooms. The parking garage is designed to provide for 19 cars or one car per unit. Access to the underground parking is from the east end where the grade will naturally fall off. The first floor will have a main entry located on the north side adjacent to Jenewein Road. This will provide accessible entry to all floors of the building. All units on the first floor will have direct access from a balcony or patio at grade.

The exterior design aims to create a contemporary feel with flat roofs and simple forms that fit with the context and respond to the building function. It is the design intent that the building will have sustainable features and materials that will be expressed in the exterior design. All of the units will have a balcony next to the living room. The balcony guards are constructed of a framed steel mesh material. The building will have brick masonry along with cement fiberboard and stucco siding.

Building B

Building B at Allied Drive will be a two-story affordable apartment building over one-story of parking and a community room. The total gross area of the building is 23,438 SF. There are 13 units comprised of four-3BR, four-2BR, two-1BR, and three-Studio. There are a total of 25 bedrooms. The parking garage is designed to provide for 13 cars or one car per unit. Access to the parking is through one door on the south elevation. The first floor will have a main entry located on the west side adjacent to Allied Dr. This entry will provide accessible access to all floors of the building. There will be a Community Room along with

a Business Center on the first floor at the north end of the building. The Community room will open onto an exterior courtyard.

Building B will have the following specific design features; the façade along Allied Drive will have "green screen" trellis's that will add interest to the lower level. The Community Room on the north end will have taller windows so that activities can be seen and will have direct access to the courtyard for outdoor functions. It will also have flat canopy that gives weather protection to those using the courtyard and community room.

Building C

Building C at Allied Drive will be a two-story affordable apartment building containing attached and detached garages. The total gross area of the building is 13,797 SF. There are nine units comprised four-3BR Flats and five-3BR Townhouses. There are a total of 27 bedrooms. The end units will be flat style apartments and will have attached garages that have direct access to the units. The interior units will be three story townhouse style apartments and will have detached garages that will be arranged to create backyards for the townhouse residents. There are nine garages or one car stall per unit. Each unit will have direct access to grade and most will have a covered entry or porch that signifies the entry.

The exterior design has a mix of residential elements including flat roofs and gable forms, overhangs etc. that complement the neighborhood context and will have similar materials to Buildings A and B. Some of the units will have roof decks. It is the design intent that the building will have sustainable features and materials that will be expressed in the exterior design. The building will have some brick masonry along with cement fiber and stucco siding. The pitched roofs will have asphalt shingles.

Building E

Building E at Allied Drive will be a two-story affordable apartment building with attached garages. The total gross area of the building is 5,391 SF. There are four units comprised two-2BR, two-3BR. There are a total of 10 bedrooms. The garages are attached and have direct access to the units. There are four garages or one car stall per unit. Each unit will have direct access to grade and most will have a covered entry or porch that defines the entry.

The exterior design has a mix of forms including flat roofs and gable forms, overhangs etc. that complement the neighborhood context and have similar materials to Buildings A and B. Some of the units will have roof decks. It is the design intent that the building will have sustainable features and materials that will be expressed in the exterior design. The building will have brick masonry at

the base with cement fiber and stucco siding. The pitched roofs will have asphalt shingles.

Building F

Building F at Allied Drive will be a two-story affordable apartment building with attached garages. The total gross area of the building is 6,560 SF. There are four-3BR units. There are a total of 12 bedrooms. The garages are attached and have direct access to the units. There are four garages or one car stall per unit. Each unit will have direct access to grade and most will have a covered entry or porch that defines the entry.

The exterior design has a mix of forms including flat roofs and gable forms, overhangs etc. that complement the neighborhood context and have similar materials to Buildings A and B. Some of the units will have roof decks. It is the design intent that the building will have sustainable features and materials that will be expressed in the exterior design. The building will have brick masonry at the base with cement fiber and stucco siding.

Existing Buildings

Two of the three existing Birch Hill Square Apartment buildings will remain as temporary housing for residents of the property who will need to move as a result of the demolition of other buildings on the site. The Birch Hill Square Apartments consist of three (3) buildings with a mix of one-, two-, and three-bedroom units.

Site Amenities

Gateway/Plaza

The southeast corner of the intersection of Allied Drive and Jenewein Road will serve as a gateway into this re-developed neighborhood. Recognizing the value of this opportunity to set the tone for the redevelopment, sustainable, maintainable, functional, safety and aesthetic features have been incorporated into this gateway.

The gateway leads to a neighborhood gathering space, immediately adjacent to the community room. Multiple doors allow for easy passage, creating flexible spaces for a variety of uses. This plaza is constructed of pervious pavers, and landscaped in a low-maintenance palette with year-round interest. Benches, pedestrian-scale lighting, and trash receptacles are complimentary, durable, and 'green', offering a welcoming open space for residents.

Tot Lot

The Tot Lot is situated between buildings E & F. The play equipment and surfacing here will be made of recycled/recyclable materials in muted colors, and will be geared toward activities for 3-6 year olds. Specific equipment will be selected by a neighborhood committee under the guidance of the CDA Allied Development Sub-Committee, and SAA.

Pedestrian Accessibility

From the gateway and through the tot lot area to the Boys and Girls Club, pedestrian access and safety has been considered. Pedestrian scale lighting, open sight lines, strategically placed benches & trash receptacles, handicap accessibility, and porous paving where possible, combine to create the pedestrian experience. Additionally, curb bump-outs, tabletops, and contrasting street trees identify pedestrian/vehicular intersections for increased pedestrian safety.

Landscaping Plan

An extensive landscaping plan has been developed for the Phase 1 development including the tot lot and gateway plaza.

Property Management

The property will be owned by the Community Development Authority who will contract with a management company to manage the property.

Loading Facilities

The project does not propose any on-site loading zones.

Installation and Maintenance of Landscaping

As the owner, the CDA is responsible for installing and maintaining landscaping. Landscaping will be installed within the first growing season after construction is complete.

Demolition

The application includes the demolition of the buildings on the development site. Demolition of nine of the 11 buildings is scheduled to begin following approval by the Plan Commission. The remaining two buildings will continue to be occupied until Phase 1 is completed.

A recycling and reuse plan will be approved by the City's Recycling Coordinator prior to demolition.

Utilities

A sanitary sewer system, water distribution system and storm water system have been designed and will be installed as part of this project. The sanitary sewer system will consist of PVC main pipe with PVC laterals serving each property. The main for this project will feed into an interceptor pipe, which leads to the Madison Metropolitan Sewerage District Plant for treatment.

The water main and lateral distribution system will be installed with ductile iron pipe. Main will be installed in the street and laterals placed to the properties. The main for the site will be looped with existing main in Allied Drive & Jenewein Road.

The storm sewer system will be installed to convey storm water for the site to an on-site bio-retention system at the south end of the property. Inlets, leads and mains will be installed throughout the streets to capture all storm water runoff. Storm water will be routed through the mainline system to the bio-retention system installed downstream. The system will detain runoff, infiltrate runoff and filter it for a significant reduction in suspended solids prior to discharging to the existing main, which eventually discharges into Dunn's marsh.

Schedule

Demolition, street & utility construction is planned to begin no later than August 14, 2008. The contract for Phase 1 will be approximately 100 calendar days. The construction is expected to begin with demolition, and follow with site grading, underground utilities, curb & gutter, sidewalk, street lighting, stone base and a base course of asphalt pavement. The lower layer of asphalt pavement is expected on or around the first week of November 2008. Phase II of this project is not yet scheduled at this time. It is anticipated that this work will be performed in 2009.

Consultants

Schreiber Anderson Associates (SAA) has been retained to provide Project Management, Site Design, and Landscape Architecture services. Eppstein Uhen Architects (EUA), sub-consultant to SAA, has been retained by SAA to provide Architectural Design services. Dimension Development has been retained by the CDA as the CDA financial consultant. The City of Madison Department of Public Works, Engineering Division serves as the Project Engineer.


| | | | , | ٧ |
|---|--|----|----|---|
| | | | | |
| | | | · | |
| | | | | |
| | | | | |
| | | | | |
| | | | | |
| | | Υ. | | |
| | | | N. | |
| | | | | |
| | | | | |
| | | | | |
| | | | | |
| , | | | | |
| | | | | |
| | | | | |
Allied Drive Neighborhood Redevelopment

Allied Drive Madison, WI 53711

May 12, 2008

Sheet Index Sheet No. Sheet Title TITLE SHEET S.1 **EXISTING CONDITIONS PLAN** S.2 PHASE I & II GDP SITE PLAN S.3 **OVERALL SITE GRADING PLAN** S.4 PHASE ONE SITE PLAN **S.5** PHASE ONE GRADING PLAN S.6 PLAZA BLOW UP S.7 TOT LOT BLOW UP S.8 LIGHTING AND SIGNAGE PLAN A.110 **BUILDING 'A' FLOOR PLAN** A.120 **BUILDING 'B' FLOOR PLAN** A.130 **BUILDING 'C' FLOOR PLAN** A.140 **BUILDING 'E' FLOOR PLAN** A.150 **BUILDING 'F' FLOOR PLAN** A.210 **BUILDING 'A' ELEVATIONS** A.220 **BUILDING 'B' ELEVATIONS** A.230 **BUILDING 'C' ELEVATIONS** A.240 **BUILDING 'E' ELEVATIONS** A.250 **BUILDING 'F' ELEVATIONS** LANDSCAPE KEY L.1 L.2 **OVERALL STREET TREE PLAN** L.3 OVERALL PHASE I LANDSCAPE PLAN L.4 GATEWAY/PLAZA LANDSCAPE PLAN L.5 **BUILDING 'A' LANDSCAPE PLAN** L.6 **BUILDING 'B' LANDSCAPE PLAN** L.7 BUILDING 'C' LANDSCAPE PLAN L.8 BUILDING 'E', TOT LOT, AND **BUILDING 'F' LANDSCAPE PLAN** L.9 (FUTURE SHEET TO BE CREATED) L.10 PLANT LEGEND AND LANDSCAPE DETAILS L.11 **EQUIPMENT DETAILS** NOTE: For all related Civil Engineering drawings, please see the City website at http://www.cityofmadison.com/business/PW/contracts/documents/6212plans.pdf

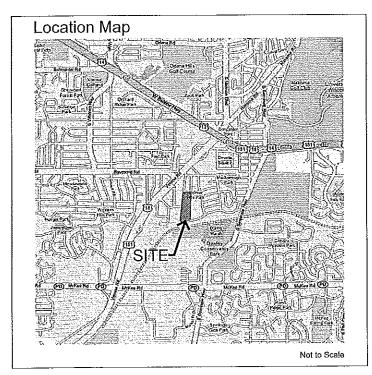

SITE AREA: +/- 3.77 AC.

Owner / Applicant



Community Development Authority 215 Martin Luther King Jr #318 Madison, WI 53703 608.266.4675

Project Management



Schreiber/Anderson Associate:

717 John Nolen Drive Madison, WI 53713 Phone 608-255-0800 Fax 608-255-7750

Architect



eppstein uhen: architects 222 West Washington Avenue Suite 650 Madison, WI 53703 608.442.5350


Engineer




City of Madison 215 Martin Luther King Jr #403 Madison, WI 53703 608.266.4675

REVISIONS: 05-19-08 05-27-08

SAA Project No 2296.01

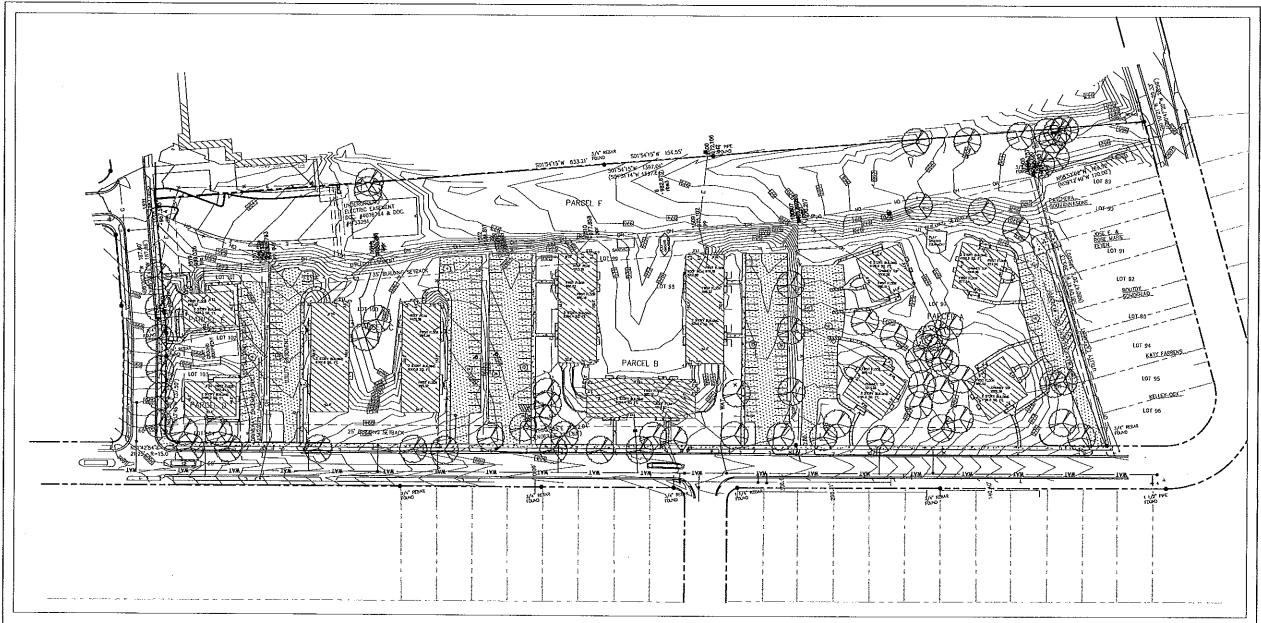

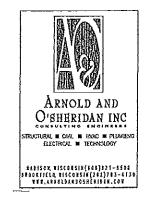

Professional Seal

Allied Drive Neighborhood Redevelopment GDP/SIP



Community


Development Authority

City of Madison Madison, WI


Drawn By: Checked By:

Issued For: Issue Date: Project No. 2296,01

> Sheet Title Existing Conditions Plan

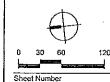

Original ALTA/ACSM Survey by Arnold S and O'Sheridan Inc., 8/13/06.

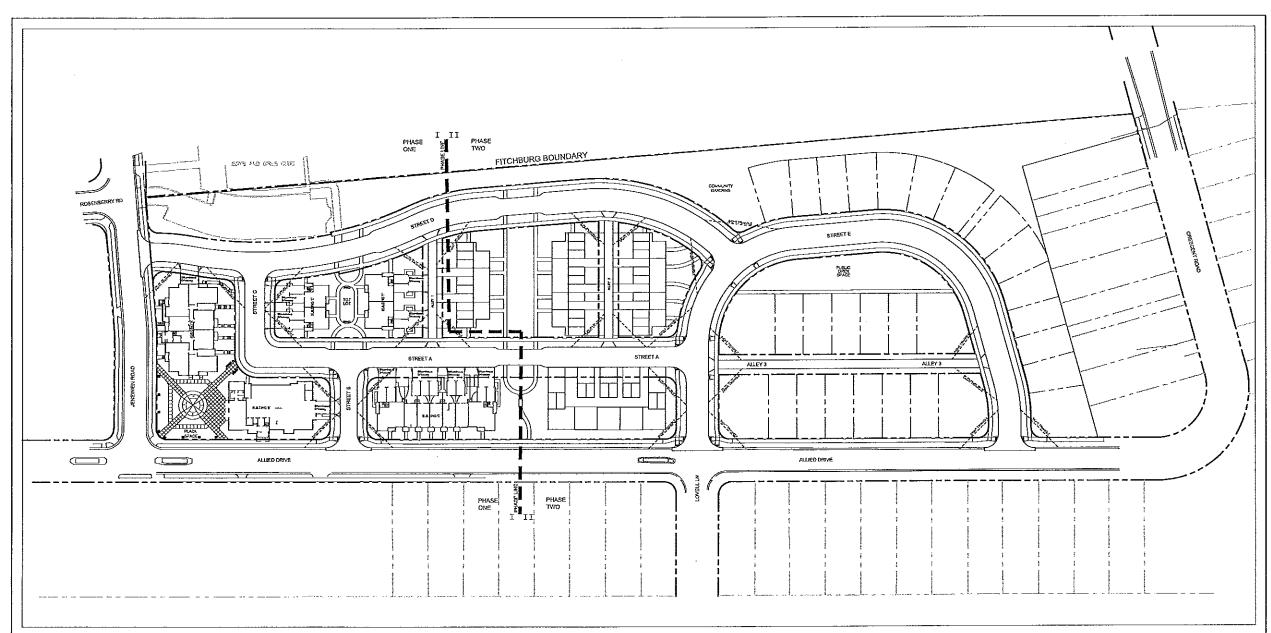

Allied Drive Architectural Data

| Building | Stories | Number of Units |
|----------|-----------|-----------------|
| Α | 3 | 19 * |
| В | 3 | 13 |
| С | 3 | 9 |
| D | r√a | n/a |
| E | 2 | 4 |
| F | 2 | 4 |
| G | 2 | 6 |
| н | 2 | 8 |
| | 2 | 8 |
| J | 3 | 9 |
| S.F. | 2 | 24 |
| Duplex | 2 | 10 |
| То | tal Units | 114 * |
| | | |

*= Includes Manager Occupied Unit In Building 'A'



SCHREIBER / ANDERSON ASSOCIATES, INC. 7817 John Noben Drive Madison, WI 53713 Ph. 698-225, 1710 WWW 488-0128 disco.

Professional Seal

Revision Dat 05/12/0

Project Name

Allied Drive Neighborhood Redevelopment GDP/SIP



Community
Development
Authority

City of Madison Madison, WI

Drawn By: Jjb
Checked By: KS
File: –
Issued For: Review
Issue Date: 05/07/08

Issue Date: 05/07/08 Project No. 2296.01 Sheet Title


Phase I & II GDP Site Plan



0 30 60

Sheet Number

S-2

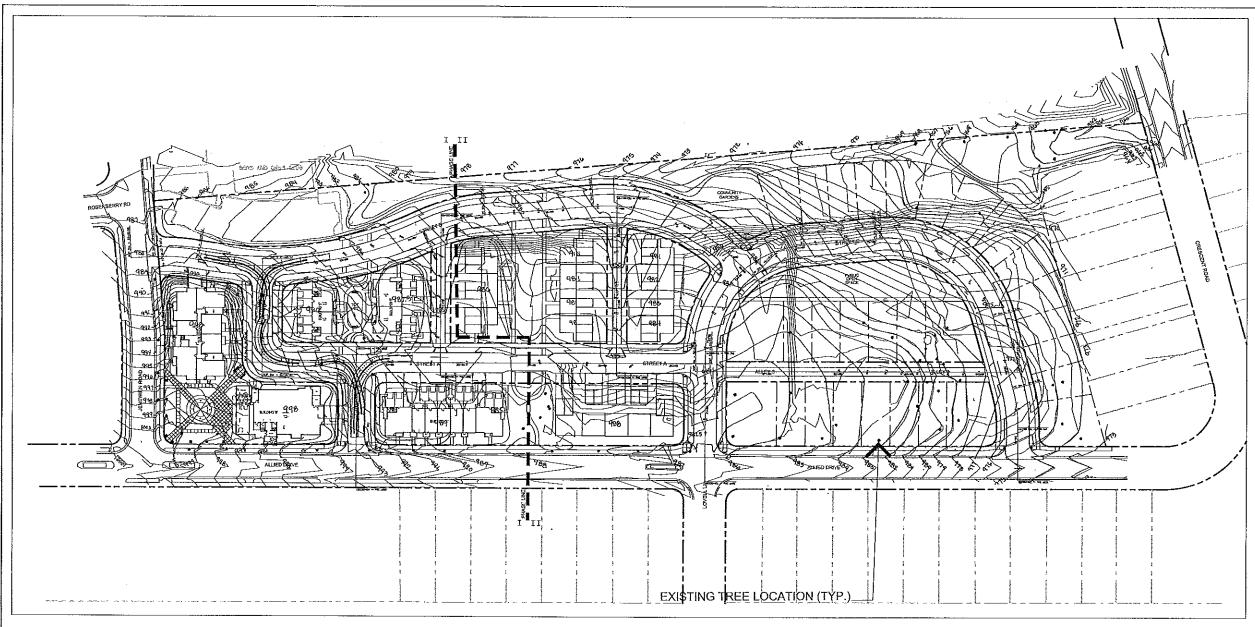



Project Name

Allied Drive Neighborhood Redevelopment GDP/SIP



Community

Development Authority

City of Madison Madison, Wi


Drawn By: Checked By:

Issued For: Review Issue Date: 05/07/08 Project No. 2296.01

Sheet Title Overall Site Grading Plan



Sheet Number

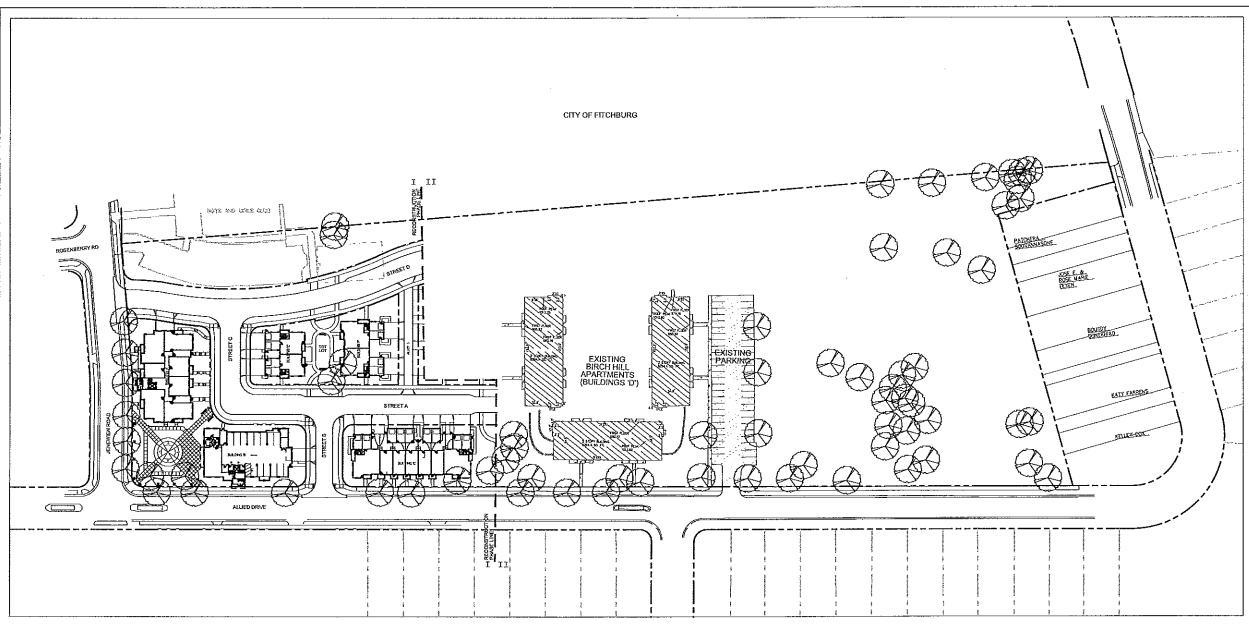

LEGEND



Allied Drive Phase One - Unit Parking Matrix

| Building | Total Units | Parking Reo'd | Parking Provided | Additional Spaces (On-Street) Regid |
|----------|--|---------------|--------------------------------|-------------------------------------|
| Α | (6) 3 BR, (6) 2 BR, (6) 1 BR, (1) Studio | 25 | 19 Garage Spaces | 6 |
| | | | (including 1 accessible stall) | |
| В | (4) 3 BR, (2) 2 BR, (2) 1 BR, (3) Studio | 15 | 13 Garage Spaces | 2 |
| | | | (including 1 accessible stall) | |
| С | (9) 3 BR | 18 | 9 Garage Spaces | - |
| | | | 9 Tandem Spaces | |
| | | | | |
| D | пlа | n/a | 54 Surface Spaces | - |
| | | | | |
| E, | (2) 3 BR, (2) 2 BR | 6 | 4 Garage Spaces | - |
| | | | 4 Tandem Spaces | |
| | | | | |
| F | (4) 3 BR | 8 | 4 Garage Spaces | - |
| | | | 4 Tandem Spaces | |

Allied Drive Phase One - Usable Open Space (UOS)

| Building | Stories | Number of Units | UOS Required | UOS Provided |
|----------|---------|----------------------------------|--------------|--------------|
| Α | 3 | 19 Dwelling Units x 70 s.f./d.u | 1,120 s.f. | 7,328 s.f. |
| B | 3 | 11 Dwelling Units x 70 s.f./d.u. | 770 s.f. | 6,224 s.f |
| С | 3 | 9 Dwelfing Units x 70 s.f./d.u. | 630 s.f. | 5,756 s.f. |
| D | 2 | n/a (existing units) | | |
| E | 2 | 4 Dwelling Units x 70 s.f./d.u. | 280 s.f. | 2,795 s.f |
| F | 2 | 4 Dwelling Units x 70 s.f./d.u. | 280 s.f. | 4,915 s.f. |



Professional Seal

Revision Dat 05/12/0

Project Name

Allied Drive Neighborhood Redevelopment GDP/SIP



Community
Development

Authority

City of Madison Madison, WI


Drawn By: jjb
Checked By: KS
File: –
Issued For: Review
Issue Date: 05/07/08
Project No. 2296.01

Sheet Title
Phase One Site Plan
SIP

 \bigoplus

0 30 60 Sheet Number

S-4

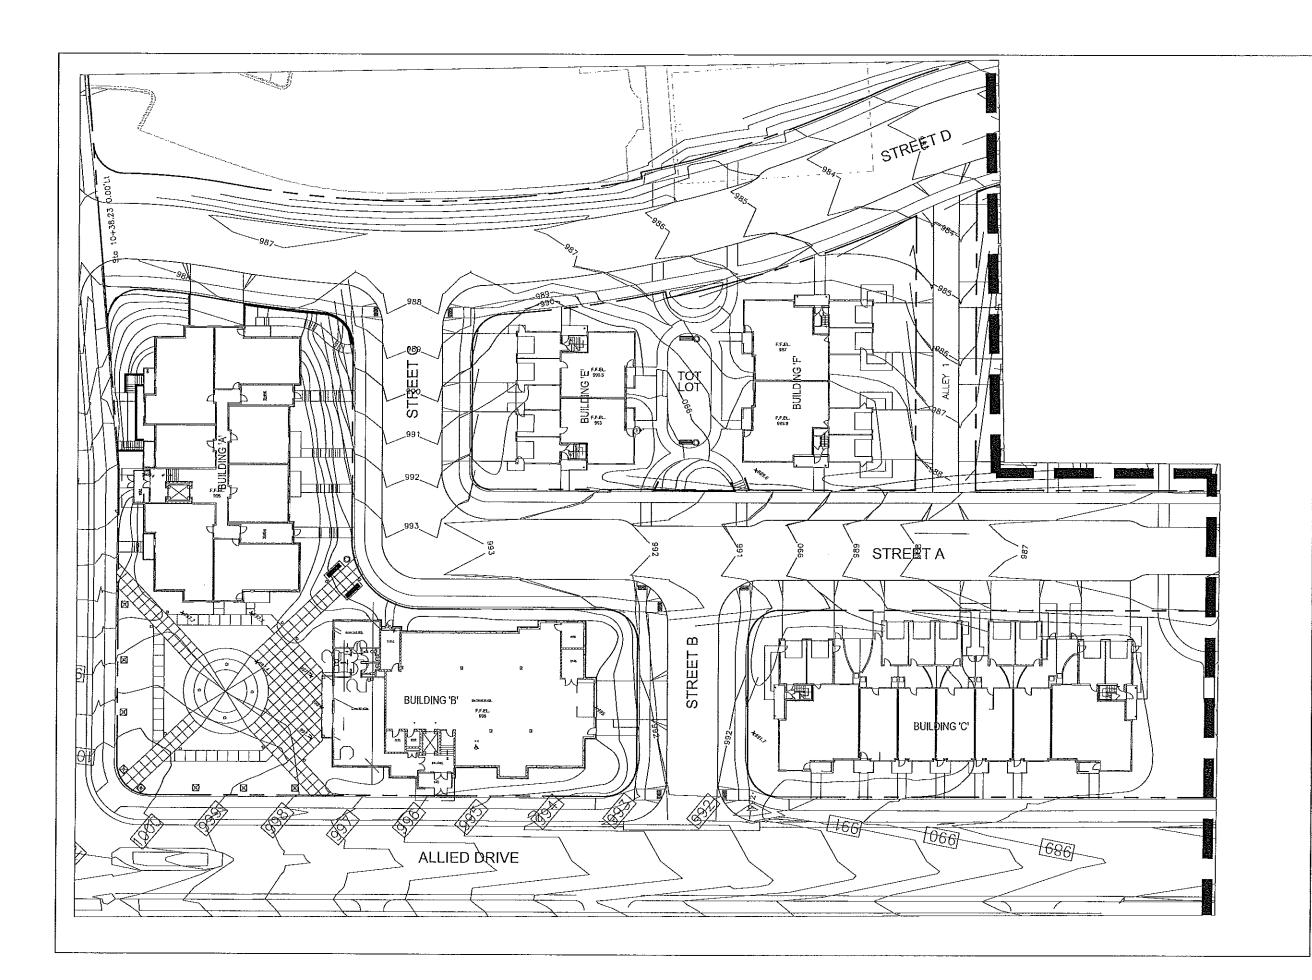



Professional Seal

sion Date 05/12/08

Project Name

Allied Drive Neighborhood Redevelopment GDP/SIP



Community

Development Authority

City of Madison Madison, WI

Drawn By: jjb
Checked By: KS
File: -Issued For: Review
Issue Date: 05/07/08

Project No. 2296,01

Sheet Title


Phase One


0 10 20

Grading Plan

Sheet Number

CI

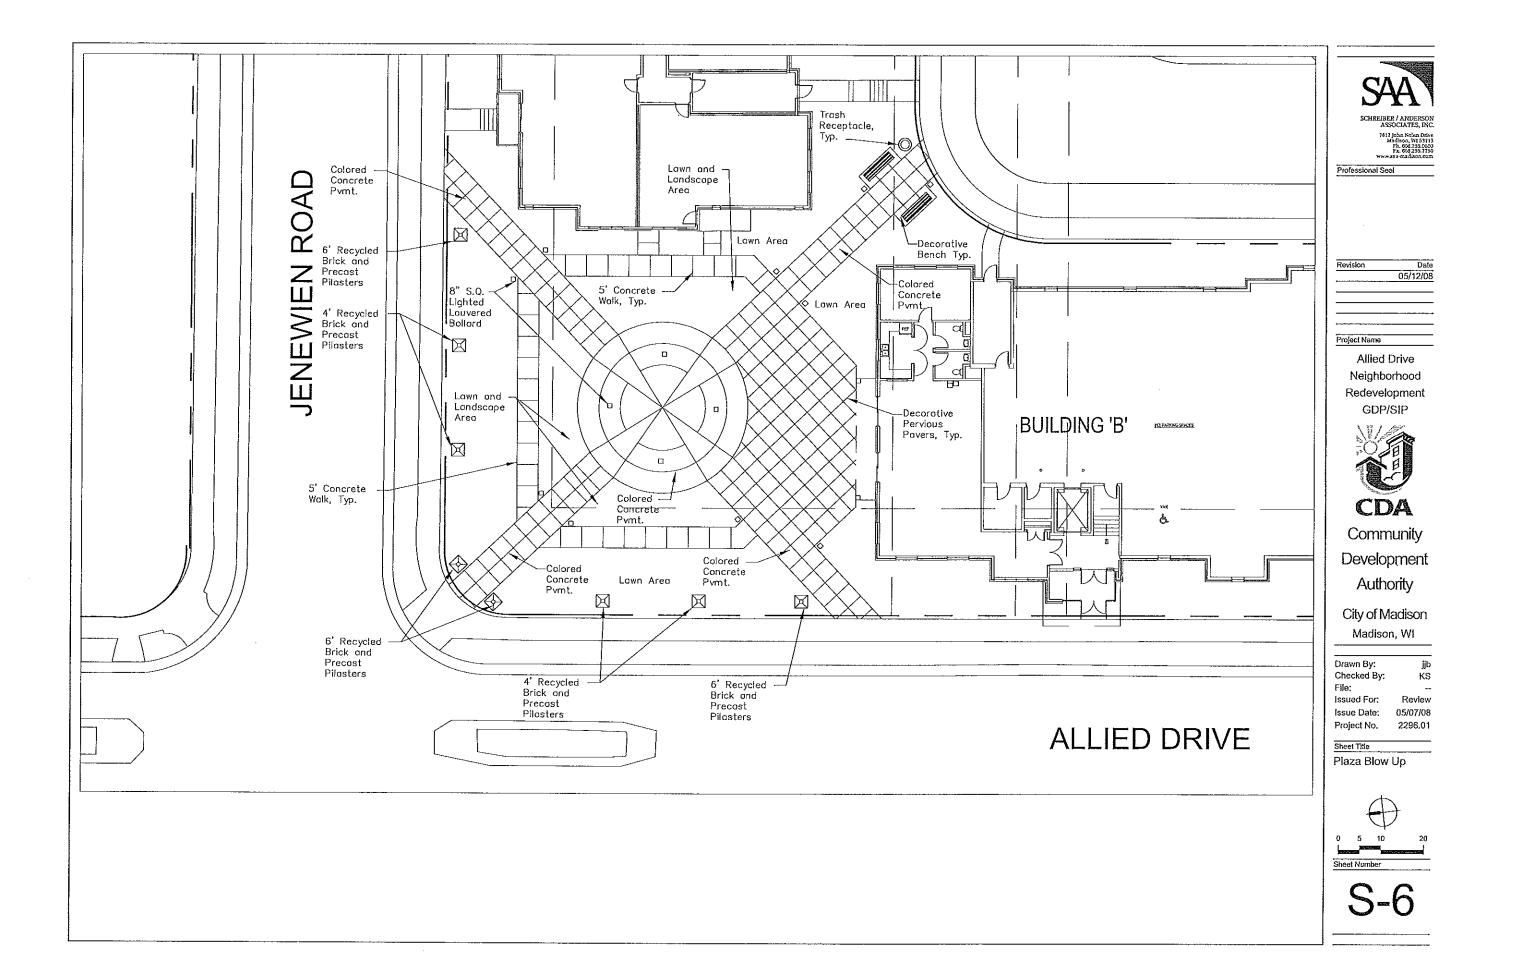

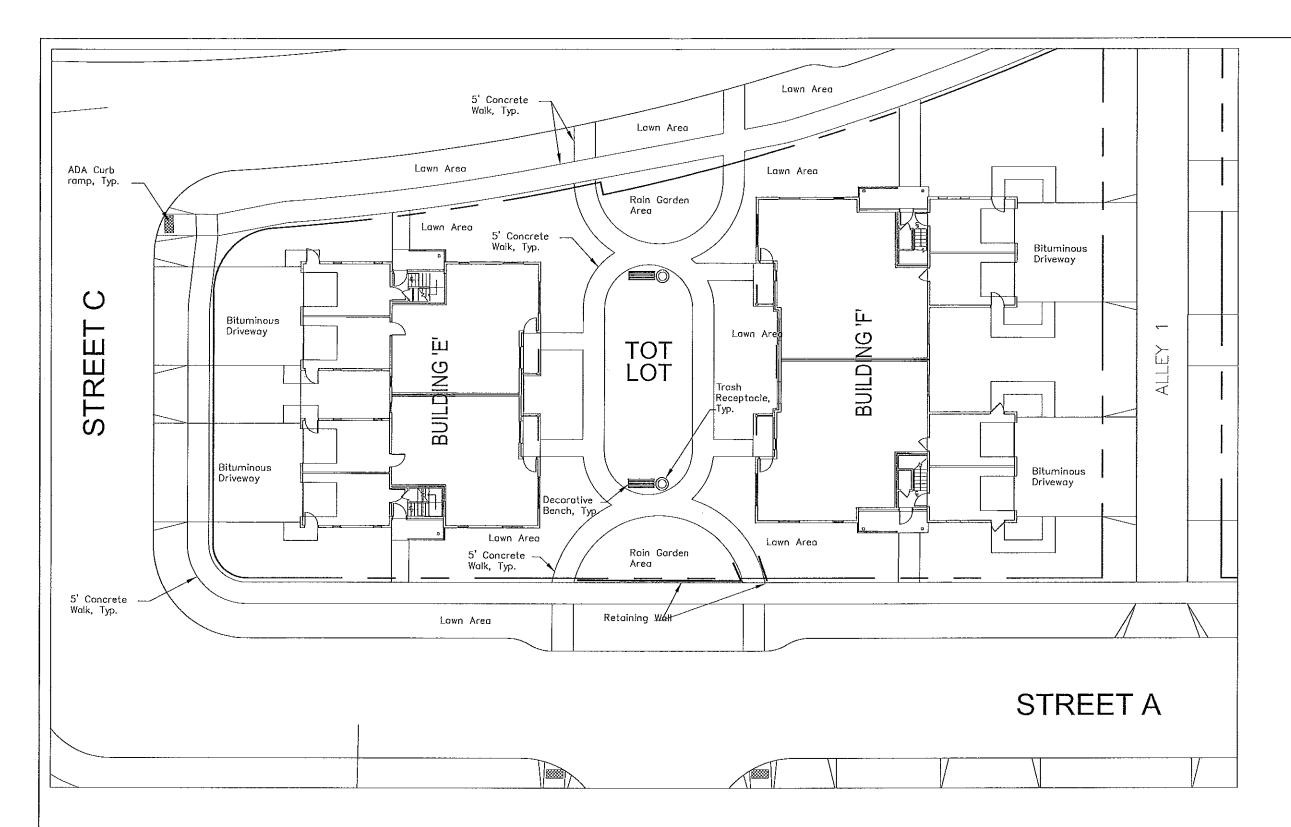



Project Name

Allied Drive Neighborhood Redevelopment GDP/SIP



Community
Development


Authority

City of Madison Madison, WI


Drawn By: Jjb
Checked By: KS
File: Issued For: Review
Issue Date: 05/07/08
Project No. 2296.01

Sheet Title

Tot Lot Blow Up

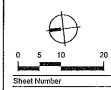

S-7

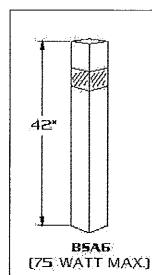

SPECIFICATIONS
HDUSING: HEAVY WALL EXTRUDED ALUMINUM CONSTRUCTION.
TOP CAP: DURABLE, CORROSION RESISTANT CAST ALUMINUM OPTICAL TRAIN: (TR)CLEAR ACRYLIC LENS, 14" MINIMUM WALL THICKNESS, LENS SURROUNDS CLEAR ANODIZED TWIN REFLECTOR (IL) CLEAR ACRYLIC LENS SURROUNDS ANODIZED ALUMINUM LOUVER TRAIN. (C.L.) DURABLE, CORROSION RESISTANT CAST ALUMINUM LOUVER SYSTEM

SYSTEM
PROVIDES 30° CUT-OFF FOR BRIGHTINESS CONTROL INTERNAL
CICEAR GLASS CYLINDER SURROUNDS LAMP.
(PO) CLEAR ACRYLIC LENS SURROUNDS PRISMATIC GLASS
REFRACTOR.
(NA) OPAL ACRYLIC LENS.
GASKETING: CLOSED CELL SILICONE.
LAMP, HOLDER: MEDILIM BASE PORCELAIN.
LAMP; BY OTHERS)
BALLAST: H.P.F. C.W.A. AUTOTRANSFORMER. • 20 ° STARTING
TEMPERATURE. ELECTRICAL
COMPONENTS ARE MOUNTED TO REMOVABLE BALLAST TRAY FOR
MAINTENANCE

MAINTENANCE EASE, BALLAST EQUIPPED WITH FACTORY INSTALLED QUICK

DISCONNECT PLUG, BASE PLATE: PRECISE ONE PIECE CAST ALUMINUM CONSTRUCTION, ANCHOR PLATE IS MECHANICALLY FASTENED TO HOUSING.
ANCHORAGE: (4) 36"X10" FULLY GALVANIZED ANCHOR BOUTS EACH
SUPPLIED WITH TWO NUTS AND TWO WASHERS.
EINISH: POLYESTER POWDER COAT-STATE OF THE ART 20 PSI PRESSURE POWER WASH AT 140 *TEMPERATURE INCORPORATES FOUR STEP IRON PHOSPHATE PROCESS TO CLEANSE AND PRETREAT THE METAL SURFACE FOR MAXIMUM PAINT ADHESION. THE METAL SURFACE FOR MAJANUM PAINT ADDIESSON.
ELECTROSTATICALLY APPLIED TEXTURED POLYESTER POWDER
TOPCOAT IS BAKED AT 400" TEMPERATURE FOR MAXIMUM HARDNESS
AND EXTERIOR DURABILITY.



THE UTILITY WASHINGTON POSTLITE LUMINAIRE IS DESIGNED FOR EASE OF MAINTENANCE WITH THE PLUG-IN ELECTRICAL MODULE COMMON TO EACH OF THE LUMINAIRES IN HOLOPHANE UTILITY LUMINAIRE SERIES, THE TRADITIONAL ACORN SHAPED LUMINAIRE, WHILE REMINISCENT OF THE 1920'S, CONTAINS A PRECISION OPTICAL SYSTEM THAT MAXIMIZES POST SPACING WHILE MAINTAINING UNIFORM ILLUMINATION

OFTICAL SYSTEM
THE OPTICAL ASSEMBLY IS A PRECISELY MOLDED THERMAL RESISTANT BOROSILICATE GLASS REFLECTOR AND REFRACTOR, THE UPPER PORTION OF THIS SYSTEM INCORPORATES A SERIES OF REFLECTING PRISMS THAT REDRECT OVER 50% OF THE UPWARD LIGHT BYTO THE CONTROLLING REFRACTOR WHALE ALLOWING THAT REDRECT OVER 50% OF THE UPWARD LIGHT BYTO THE CONTROLLING REFRACTOR WHALE ALLOWING TOR COVER OPTIONS ARE AVAILABLE. THE LOVER PORTION BESS PRECISELY MOLDED REFRACTING PRISMS TO CONTROL THE DISTRIBUTION OF LIGHT TO MAXIMIZE UTILIZATION, UNFORMITY, AND LUMINAME SPACENS. THE VERY TOP OF THIS ASSEMBLY IS A REMOVABLE PRISMATIC GLASS COVER WITH DECORATIVE FINAL FOR TOOLLESS ENTRY WITO THE LAMP CHAUBER. THERE UNIQUE OPTICAL ASSEMBLES ARE AVAILABLE, DESIGNED FOR IES TYPE ID, TYPE IV, AND TYPE V DISTRIBUTION. LUMINAME HOUSING
THE LUMINAME HOUSING, CAST OF ALUMINUM, PROVIDES AN ENCLOSURE FOR THE PLUG-IN ELECTRICAL MODULE. THE NICKEL PLATED LAMP GRAP SOCKET AND THREE STATION INCOMING LINE TERMINAL BLOCK ARE PREVINED TO A FIVE CONDUCTOR RECEPTACLE FOR EASE IN CONNECTION THE ELECTRICAL MODULE.
THE SUPPRITTER WILL ACCEPT A 3" BY 2-7/8" TO 3-1/8" O.D. TENON.

LUMINAIRE HOUSING / DOOR CAST OF ALLIMINUM, THE HOUSING / DOOR IS REMOVABLE WITHOUT THE USE OF TOOLS AND IS RETAINED BY A NONCONDUCTIVE LANYARD, ATTACHED TO THE DOOR AND TO THE HOUSING. FOR UNITS WITH AN E.E.L.N.E.M.A. TWIST LOCK PHOTOCELL, RECEPTACLE, THE DOOR CONTAINS AN ACRYLIC "WINDOW" TO ALLOW LIGHT TO REACH THE CELL.

THE RALL AST COMPONENTS ARE MOUNTED ON A STEEL PLATE THAT IS REMOVABLE WITHOUT THE USE OF THE BALLAST COMPUTER IS ARE MOUNTED ON A STEEL PITTE THAT IS REMOVABLE WITHOUT THE USE OF TOOLS. A MATCHING PIVE CONDUCTOR PLUG CONNECTS TO THE RECEPTACLE IN THE LUMANIZE HOUSING TO COMPLETE THE WIRNIG. WHERE A STARTING AND IS REQUIRED, IT IS PROVIDED WITH A SEPARATE PLUGB CONNECTOR AND CAN BE REPLACED WITHOUT THE USE OF TOOLS. FOR PHOTOELECTRIC OPERATION, THE ELECTRICAL MODULE IS PROVIDED WITH AN E.E.I.-N.E.M.A. TWIST LOCK PHOTOCELL RECEPTACLE.

ELECTRICAL MODULE IS PROVIDED WITH AN E.E.I-ALEMA. TWIST LOCK PHOTOCELL RECEPTACLE.
BALLASTS
(REFER TO BALLAST DATA SHEET FOR SPECIFIC OPERATION CHARACTERISTICS)
SO WAIT TIES VOILT HIGH PRESSURE SODIUM (HPS) BALLASTS ARE HIGH POWER FACTOR REACTOR TYPE, ALL
OTHER HPS BALLAST ARE HIGH POWER FACTOR AUTOTRANSFORMER TYPE.
175 WATT METAL HALDIC (WITH BALLAST) ARE PERAL LEAD AUTOTRANSFORMER TYPE, 70 AND 100 WAIT MH
UNITS ARE AVAILABLE ONLY WITH HIGH POWER FACTOR HIGH REACTANCE TYPE BALLAST.

Finish
The Luminaire is finished with polyester powder paint applied after a seven stage
Pretreatment precess to insure maximum durability.

UL THE LUMINAIRE IS ULLISTED AS SUITABLE FOR WET LOCATIONS AT A MAXIMUM OF 40 DEGREES C AMBIENT


DESCRIPTION
THE LIGHTING POST SHALL BE ALL CAST IRON CONSTRUCTION,
MASSIVELY TAPERED WITH A DEEP, 16-FLUTE PATTERN ON THE SHAFT
AND BASE. THE POST SHALL BE HOLOPHANE'S CATALOG NUMBER C XX /
17-CL/FINISH.
MATERIALS
HATERIALS
THE POST MATERIAL SHALL BE ASTM A48, CLASS 30 CAST IRON, FORMED
TRUE TO THE PATTERN WITH COMPLETE DETAIL. ALL EXPOSED
HARDWARE SHALL BE TAMPER RESISTANT STAINLESS STEEL. ANCHOR
BOLTS TO BE COMPLETELY HOT DIP GALVANIZED. PARTIALLY
GALVANIZED BOLTS ARE NOT ACCEPTABLE.
INSTALLATION

GALVANZEU BUS TA MER NOT ACCEPTIBLE.

INSTALLATION

THE POST SHALL BE PROVIDED WITH FOUR X* DIAMETER, LITYPE
ANCHOR BOLTS TO BE INSTALLED ON A 12* DIAMETER BOLT CIRCLE. A
DOOR SHALL BE PROVIDED IN THE BASE FOR ANCHORAGE AND WARNS
ACCESS. A GROUZE SCREW SHALL BE PROVIDED INSTE THE BASE OPPOSITE THE DOOR. FOR FINISH SPECIFICATIONS AND COLOR OPTION, SEE "FINISH" SECTION IN CATALOG.

THE POST SHALL BE X-XX' IN HEIGHT WITH A 17' DIAMETER RASE. THE THE POST SHALL BE X-XX* IN HEIGHT WITH A 17* DIAMETER BASE. THE POST SHALL TAPER FROM Y'D DIAMETER AT THE FOOD OF THE BASE TO 4.5* DIAMETER AT THE POST TOP. AN INTEGRAL 3* O.D. TENON SHALL BE PROVIDED AT THE TOP FOR LUMINAIRE MOUNTING. THE POST TOP SHALL INCLUDE A TRANSITIONAL DONUT BETWEEN THE FLUTEO SHAFT AND THE TENON.

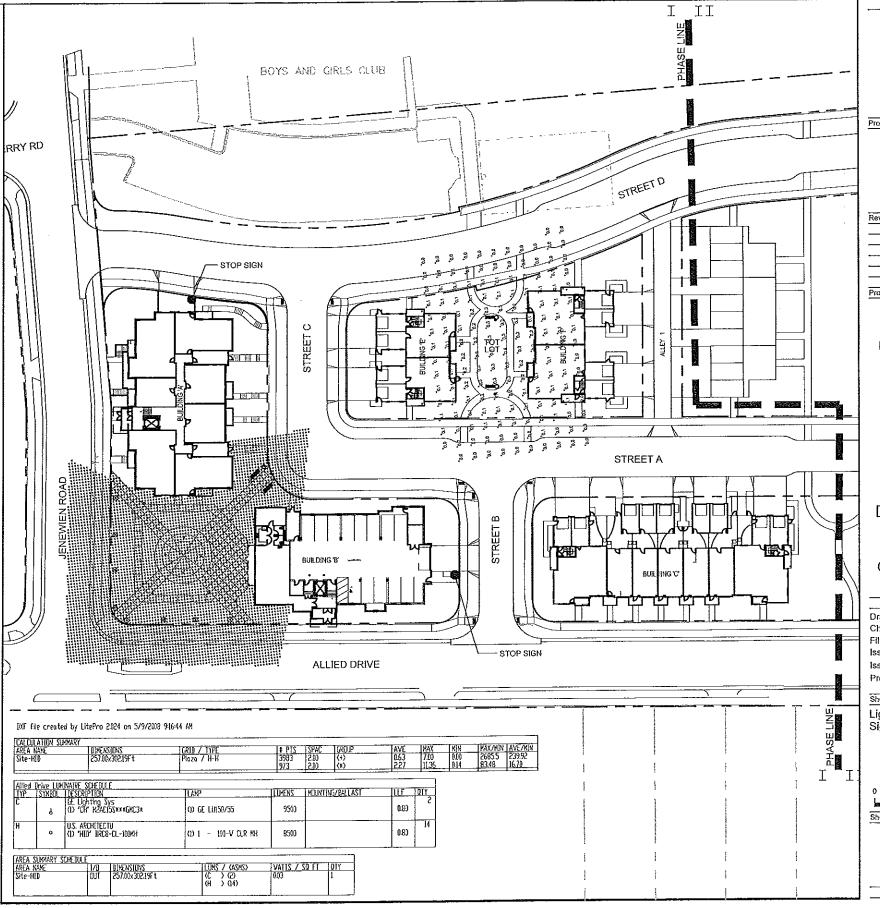



Date 05/12/08

Project Name

Allied Drive Neighborhood Redevelopment GDP/SIP



Community Development Authority


City of Madison Madison, WI

Drawn By: Checked By: KS P-E.DWG File: Review Issued For. 05/07/08 Issue Date: 2296,01 Project No.

Sheet Title


Lighting and Signage Plan



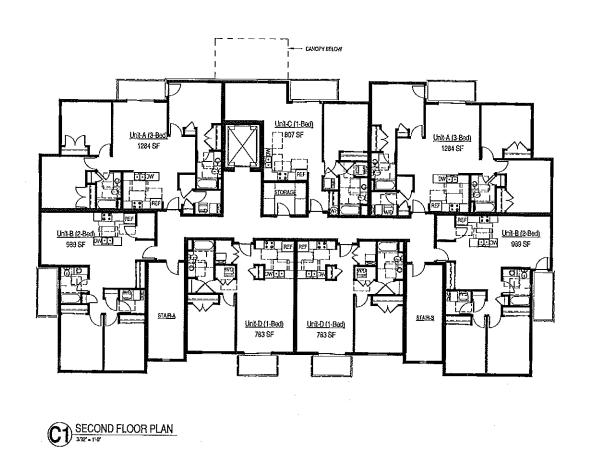

D

C

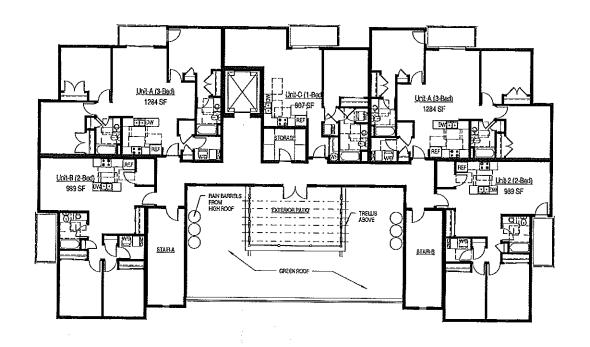



SD PROGRESS SET

eppstein uhen : architects


PROJECT NFORMATION ALLIED DRIVE **APARTMENTS -**

BUILDING A


DRIVE

NORTH ALLIED

MADISON, WI

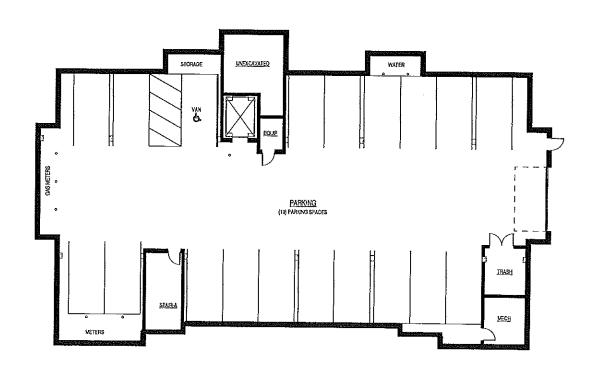

PARKING LEVEL

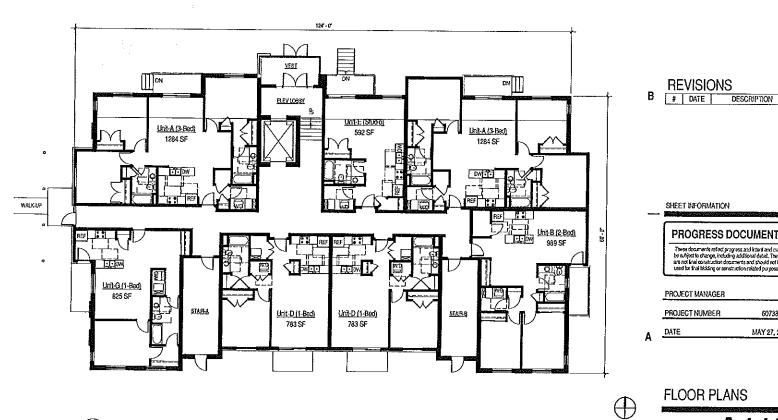

FLOOR PLANS

SHEET INFORMATION

PROJECT MANAGER

PROJECT NUMBER


PROGRESS DOCUMENTS These documents reflect progress and intent and may be subject to change, including additional detail. These are not linal construction documents and should not be used for final bidding or construction-related purposes.


607380-02

MAY 27, 2008

FIRST FLOOR PLAN

THIRD FLOOR

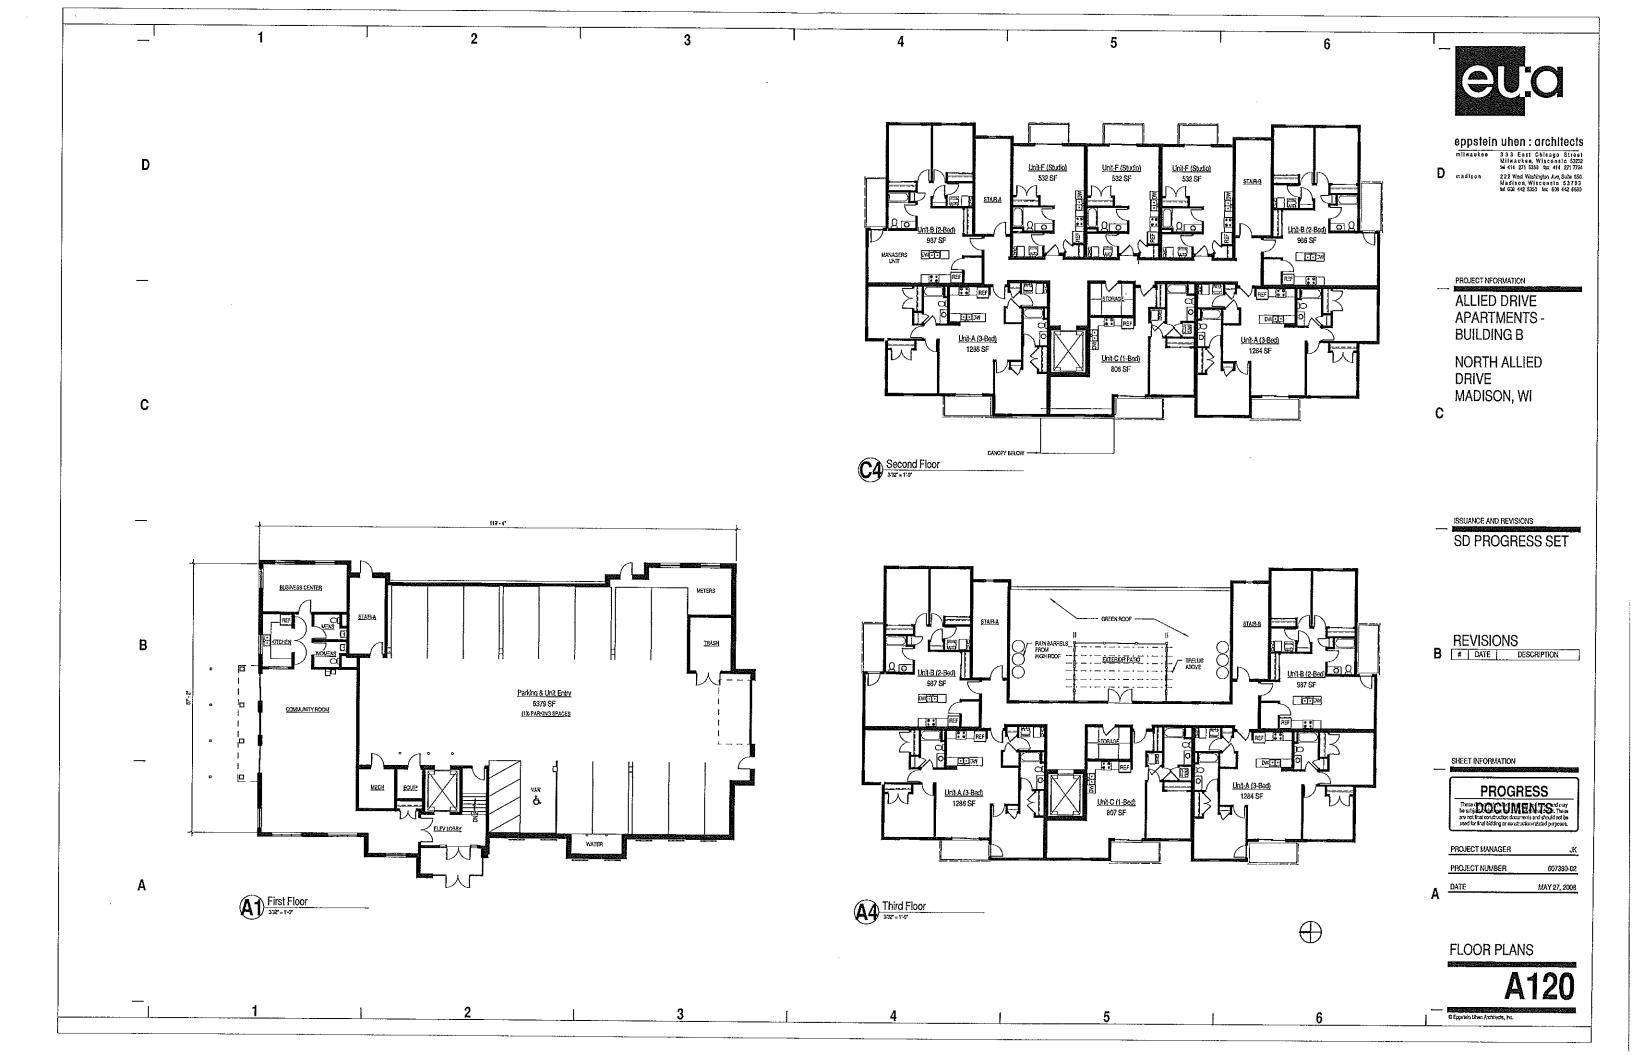

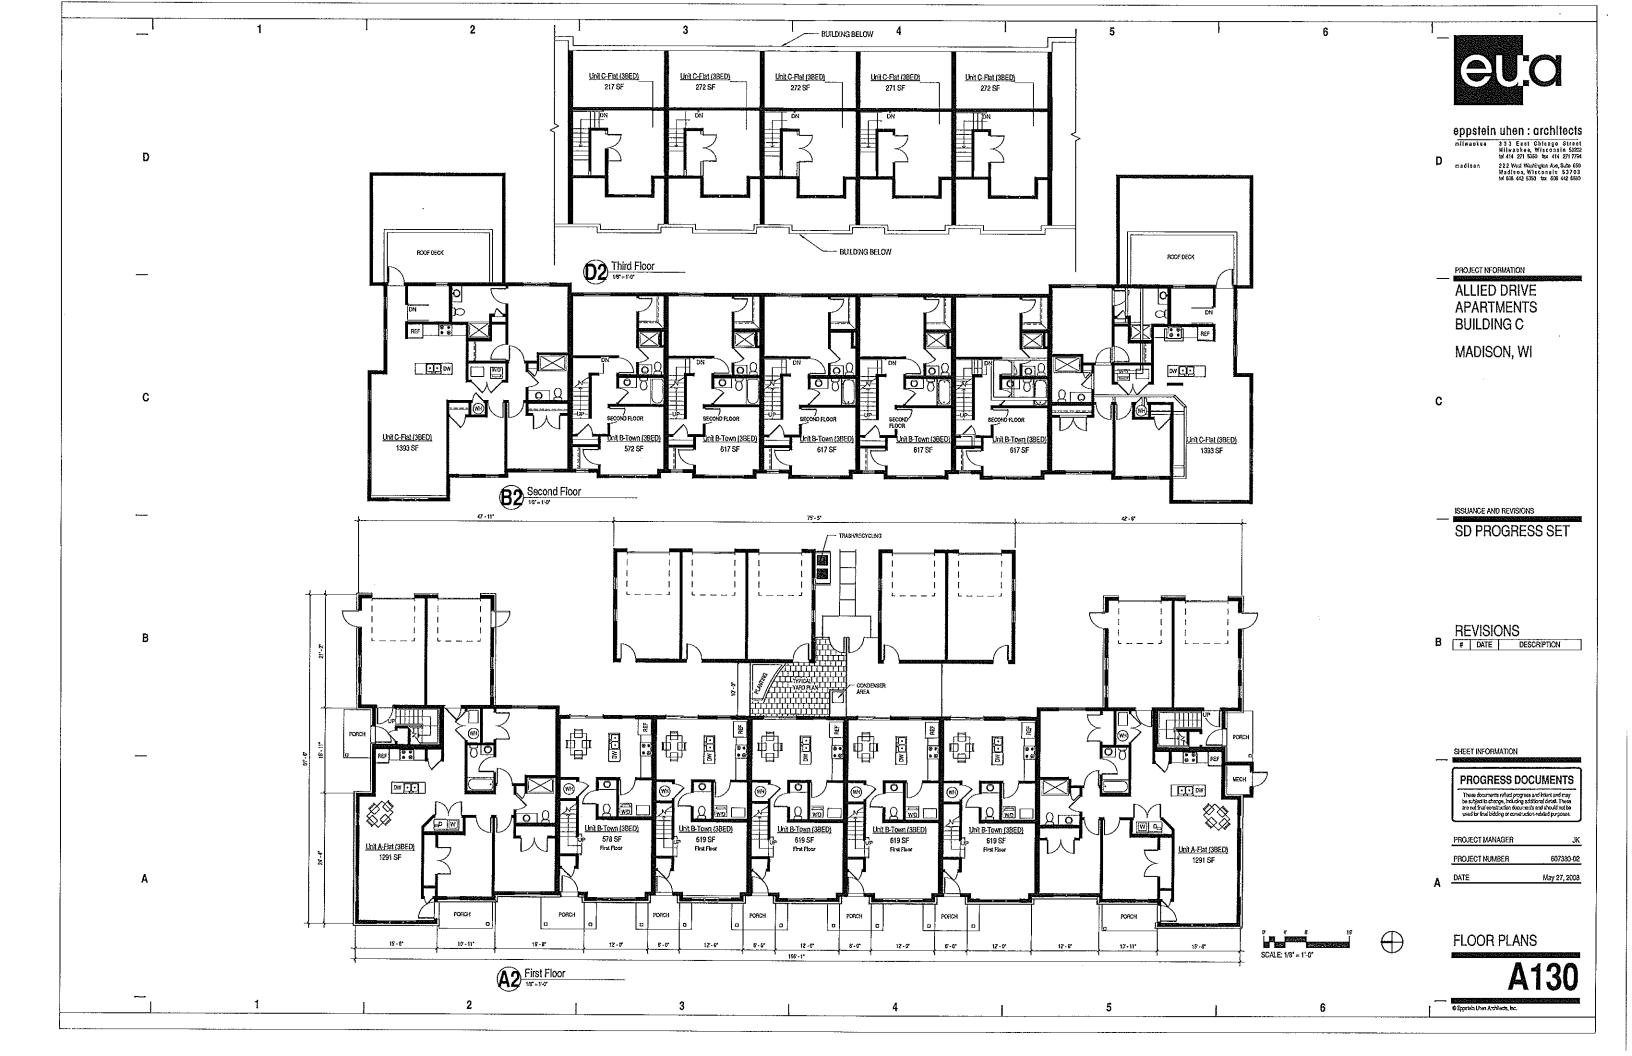



eppstein uhen : architects
milwankes 33 3 East Chicago Street
Milwankes, Wisconsia 5322
tal 414 273 5350 Ma 414 273 7744
madison
madison
Madison, Wisconsia 53703
wi 608 442 5350 tax 608 442 6560

PROJECT NFORMATION

ALLIED DRIVE **APARTMENTS BUILDING E**

MADISON, WI

С

Unit E-Flat (2 BEO) Unit E-Flat (2 BED) 914 SF DW - -

SD PROGRESS SET

ISSUANCE AND REVISIONS

B | REVISIONS | B | B | DESCRIPTION |

SHEET INFORMATION


PROGRESS DOCUMENTS


PROJECT MANAGER

PROJECT NUMBER

MAY 27, 2008

FLOOR PLANS

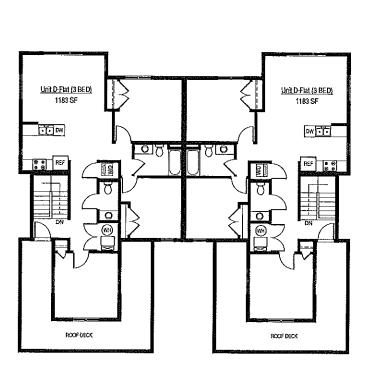


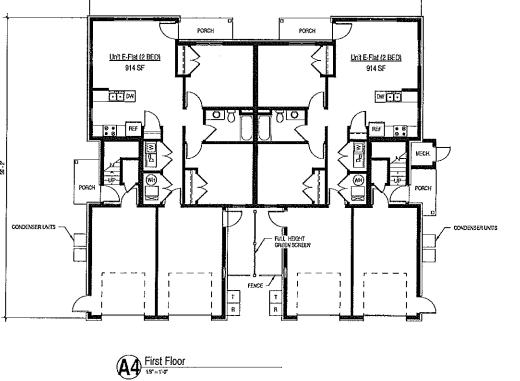


Second Floor

D


C

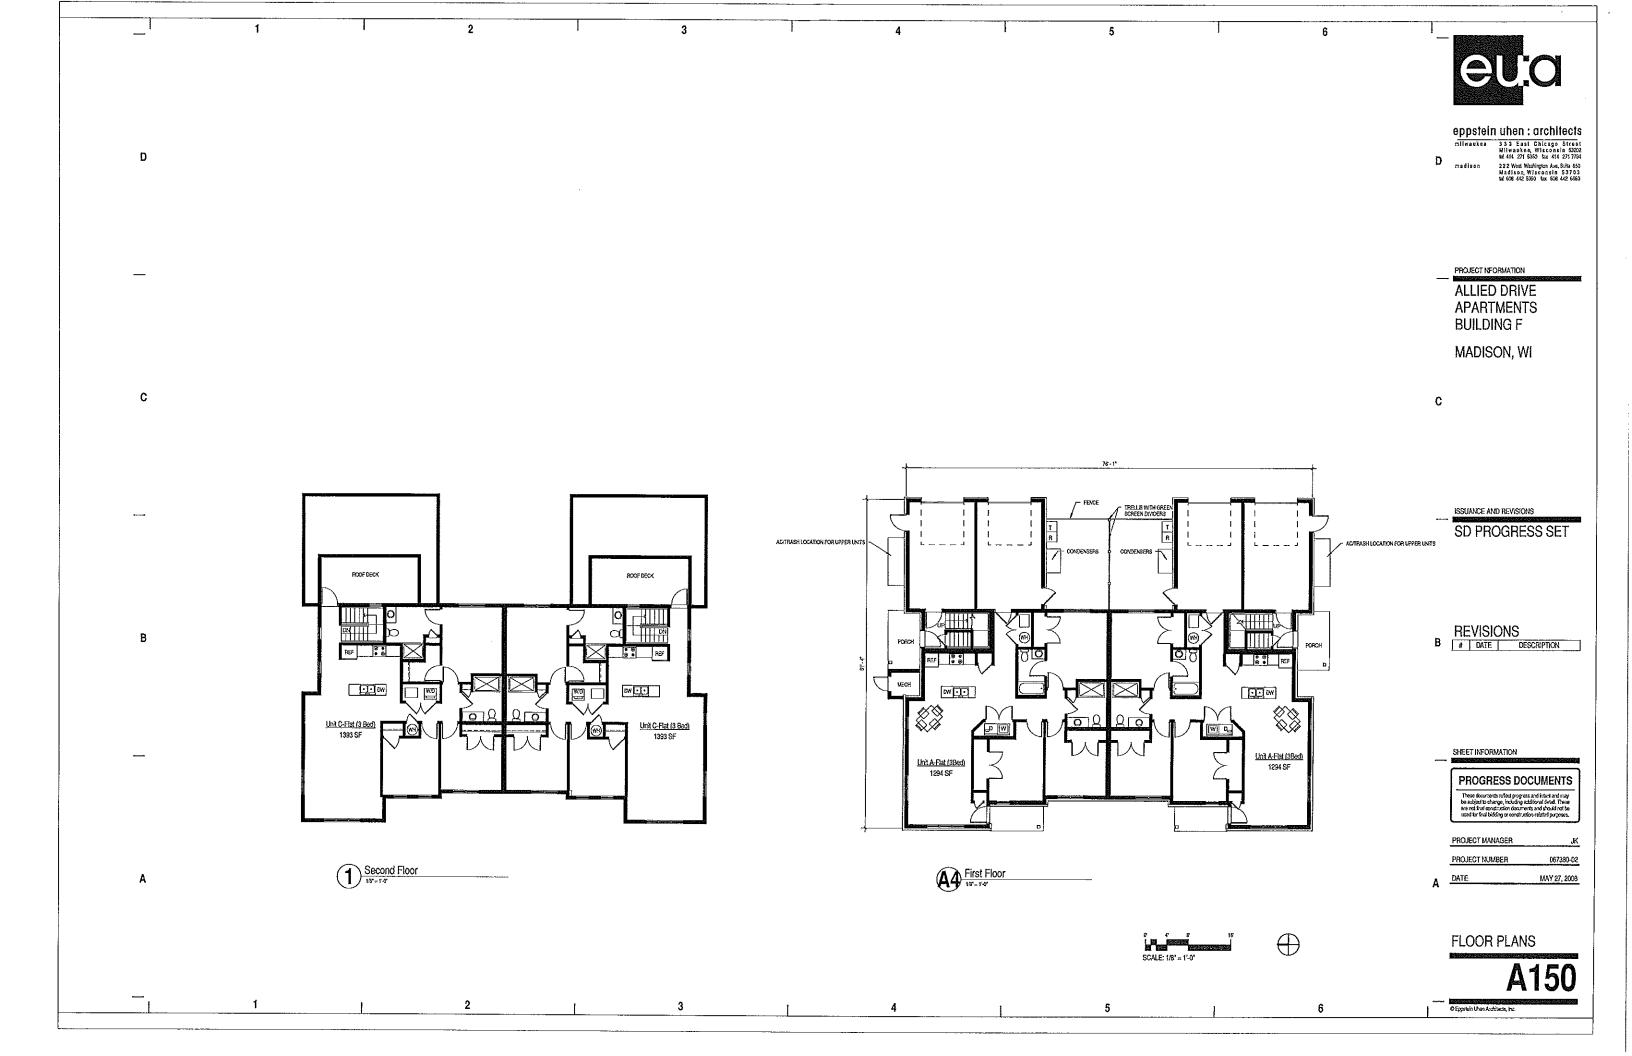

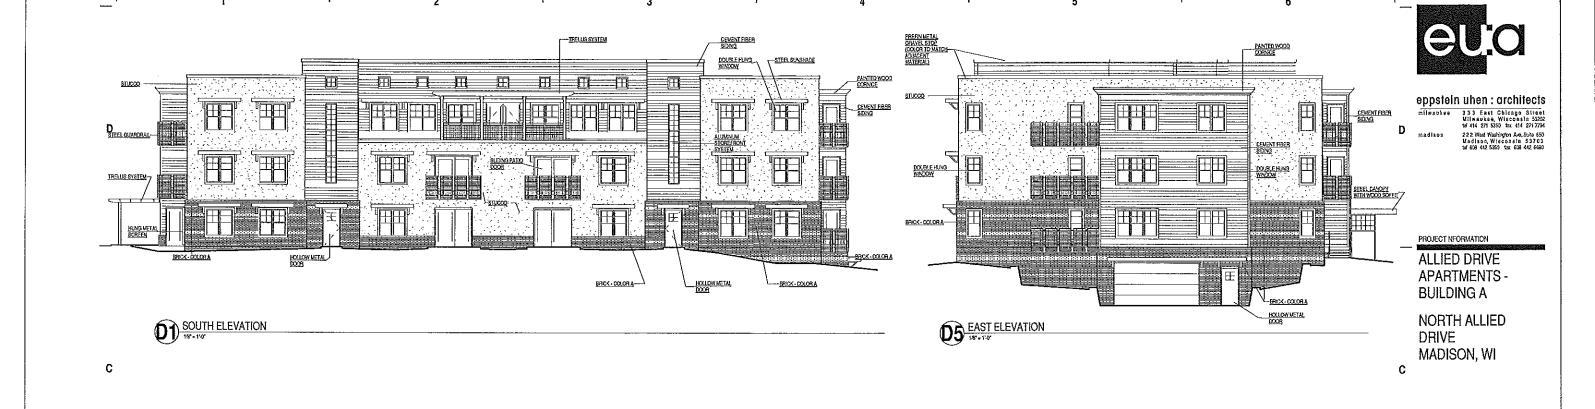

ISSUANCE AND REVISIONS

SD PROGRESS SET

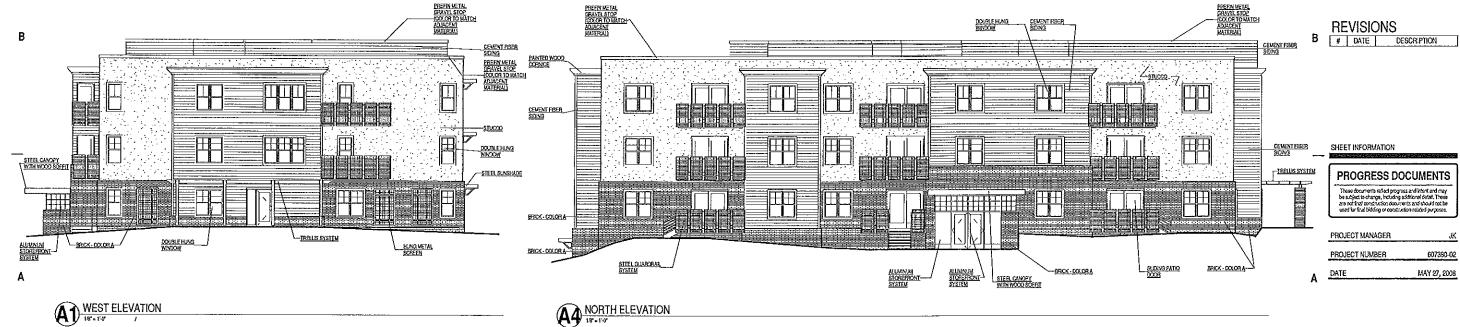

NORTH ELEVATION

ELEVATIONS

A210

© Eccatain Uhan Architects, Inc.







ASPIALT SHINGLES-С CEVENT FISER BOARD AND BATTEN PREFINAL COPAG ASPHALT SHINGLES -WOOD WITH GLASS LITES DOOR ASPHALT SHINGLES ASSHALT SHINGLES-

2

PREFINISHED METAL OVERHEAD DOOR

D

В

-CEVENT FIBER PAKE TRAL PREFINIVETAL COPING-CENENT FREE BOARD AND BATTEN STEEL SUNSHADE -PREFINIMETAL COPING -STUCCO DOUBLE HUNG WINDOW SCUPPER WITH DOWNSPOUT WOOD WITH GLASS LITES DOOR CEVENT FEER PAKE TRAI

PROJECT NFORMATION **ALLIED DRIVE APARTMENTS BUILDING F** MADISON, WI

ISSUANCE AND REVISIONS

SD PROGRESS SET

B REVISIONS

B | DATE | DESCRIPTION |

SHEET INFORMATION

PROJECT MANAGER


PROJECT NUMBER

PROGRESS DOCUMENTS

These documents reflect progress and Intentional may be subject to change, including additional detail. These are not final construction documents and should not be used for final bidding or construction-related purposes.

PREFINIVETAL COPING —STUCCO STEEL SUNSHADE PREFIN METAL COPING PRECAST STONE SILL BRICK-COLORA-ERICK - DOLOR A

CEMENT FIREH BOARD AND BATTEN DOUBLE HUNG WINDOW - SCUPPER WITH DOWNSPOUT WOOD WITH GLASS LITTES DOOR-West West

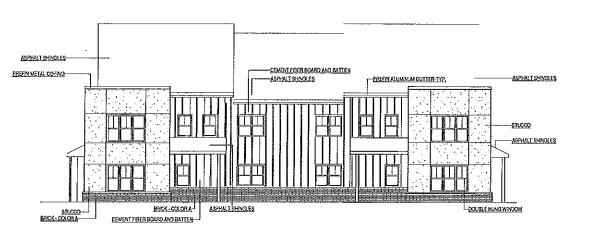




ELEVATIONS

067380-02

MAY 27, 2008

SCALE: 1/8" = 1'-0"

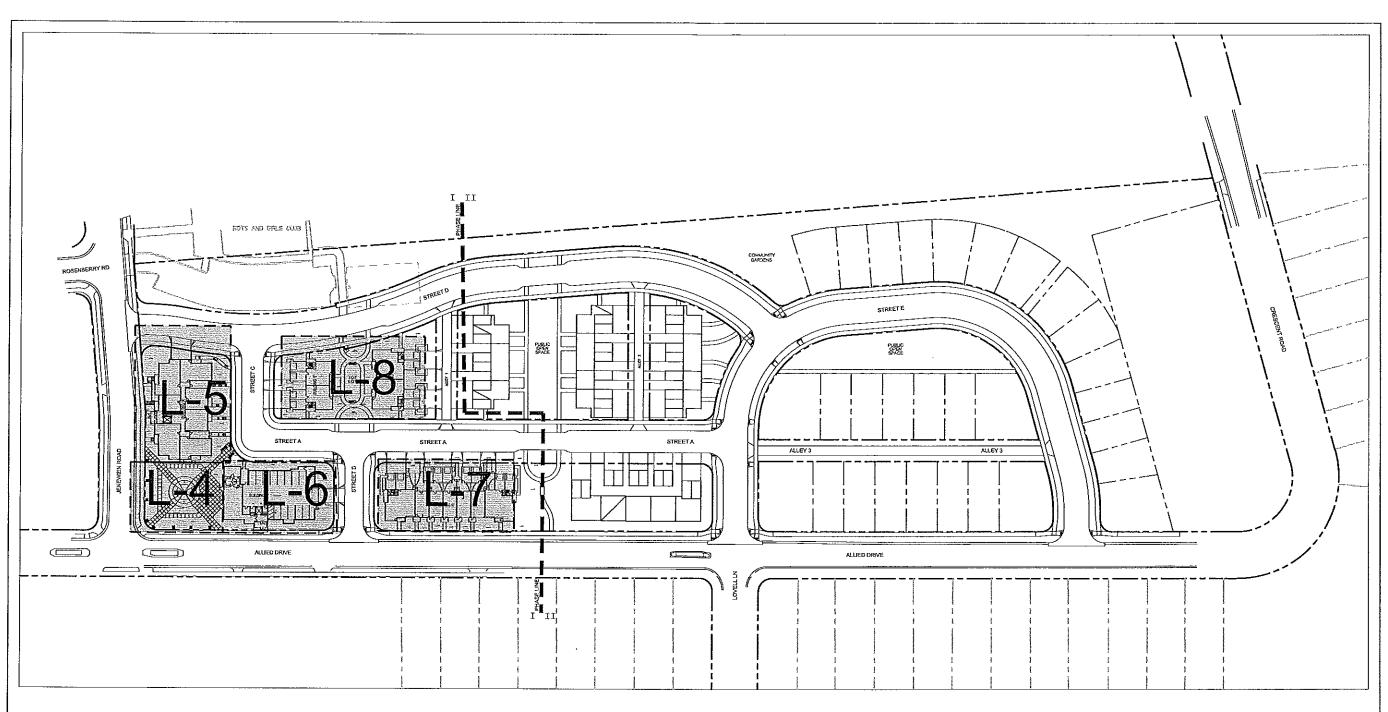



Professional Seal

Revision Date 05/19/00

Project Name

Allied Drive Neighborhood Redevelopment GDP/SIP



Community
Development
Authority

City of Madison Madison, WI

Orawn By:
Checked By:
File:
Issued For:
Revie

05/07/08

2296.01


issued For: issue Date: Project No.

Sheet Title Landscape Key



Sheet Number

•

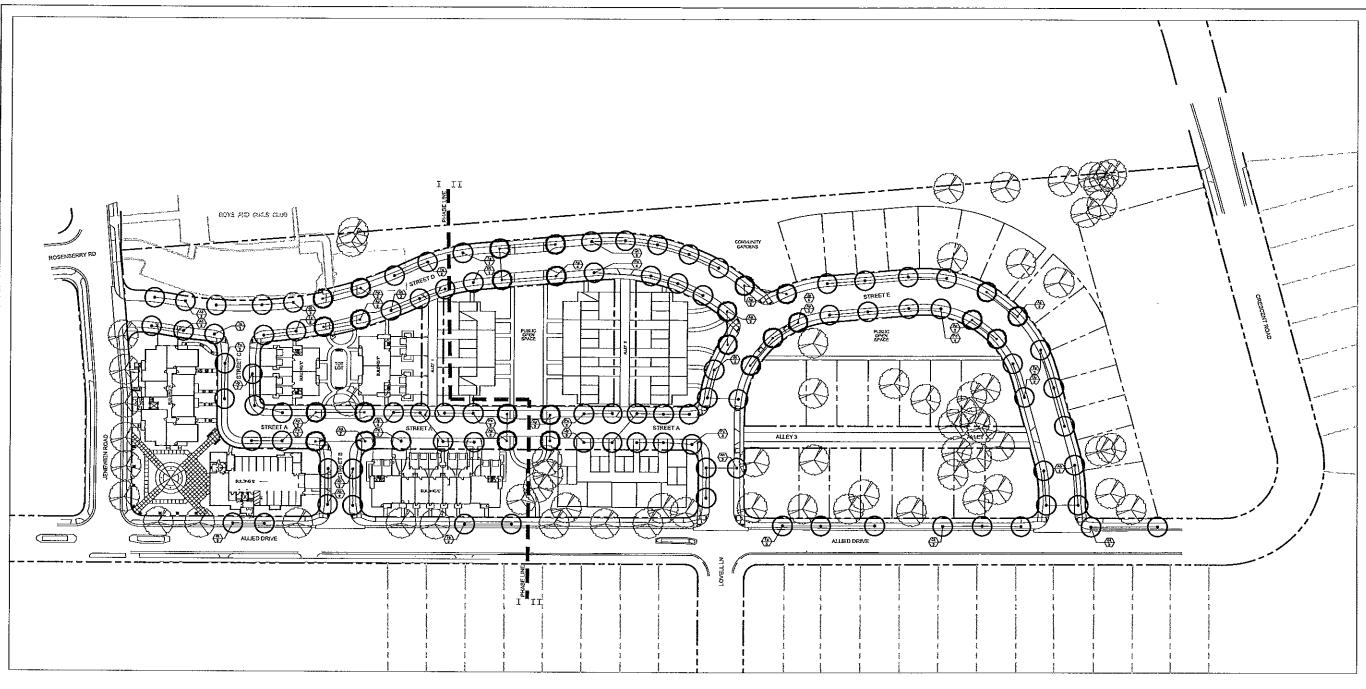

NOTE:
ONLY PLANT MATERIAL SHOWN ON THIS PLAN FOR PHASE I IS
REFLECTED IN THE TOTAL QUANTITIES LISTED ON SHEET L-10 PHASE II PLANT MATERIAL IS SHOWN FOR REFERENCE ONLY



Professional Seal

| sion | Date |
|------|----------|
| | 05/19/08 |
| | 05/27/08 |

Project Name

Allied Drive Neighborhood Redevelopment GDP/SIP



Community Development Authority

City of Madison Madison, WI


Drawn By: Checked By: Issued For:

Issue Date: 05/07/08 Project No.

Sheet Title

Overall Street Tree Plan



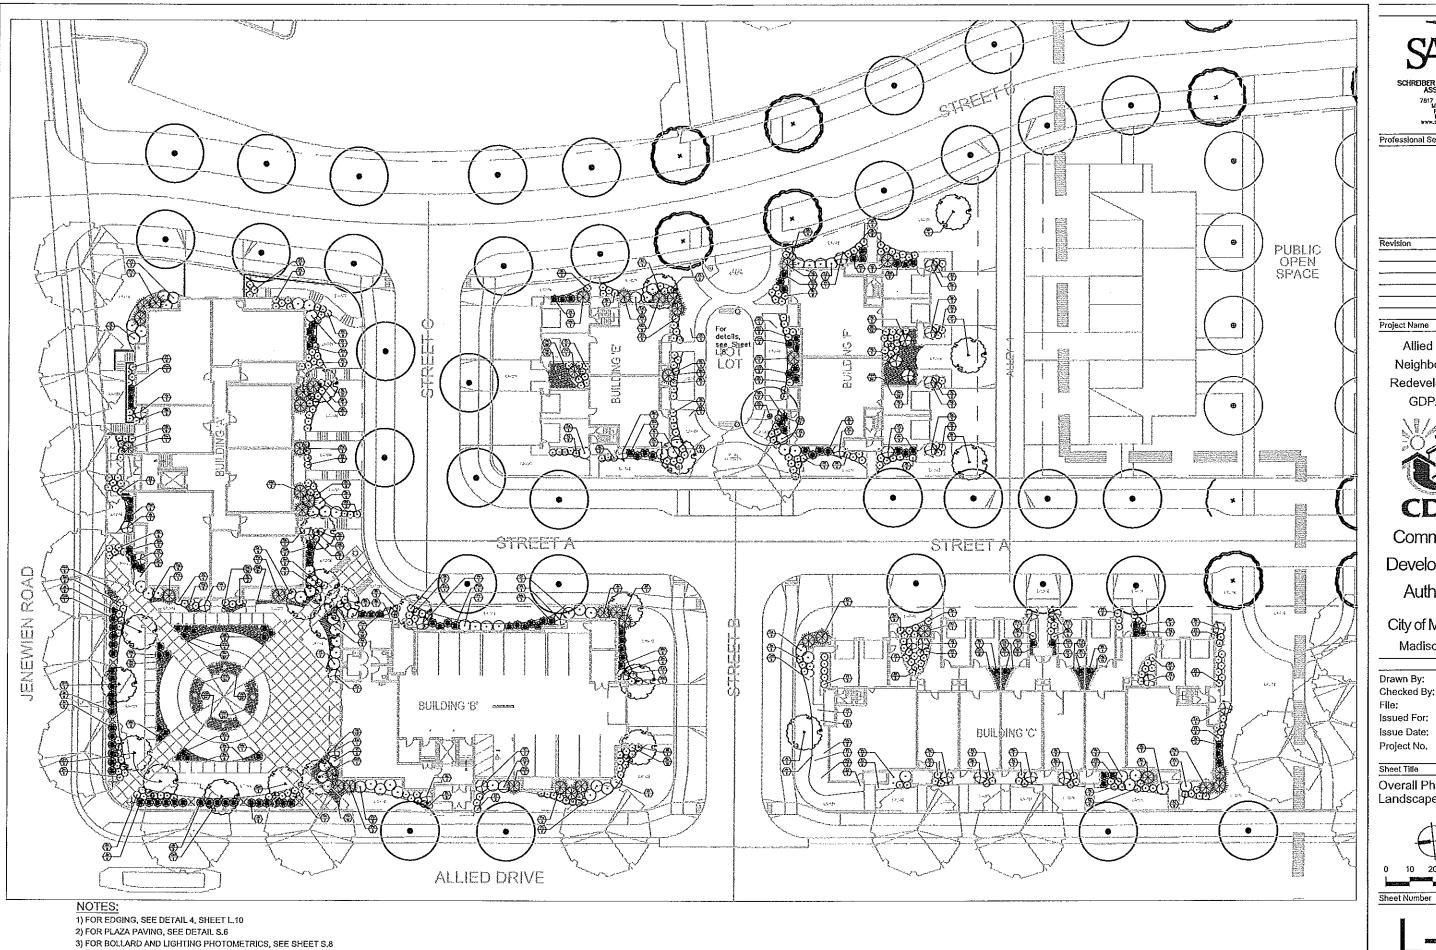

4) FOR PILASTER, SEE DETAIL 1, SHEET L.11

5) FOR STREET TREE TYPES AND LOCATIONS, SEE SHEET L.2 6) FOR EXISTING TREE TYPES AND LOCATIONS, SEE SHEET S.1

7817 John Nolen Drive Modison, W 53713 Ph. 608.255.0800 Fx. 608.255.7750

Professional Seal

Date 05/19/08 05/27/08

Project Name

Allied Drive Neighborhood Redevelopment GDP/SIP



CDA Community

Development Authority


City of Madison Madison, WI

Drawn By: Checked By: KS File: Review Issued For: Issue Date: 05/07/08


2296,01

Sheet Title

Overall Phase 1 Landscape Plan

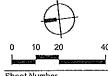

Sheet Number

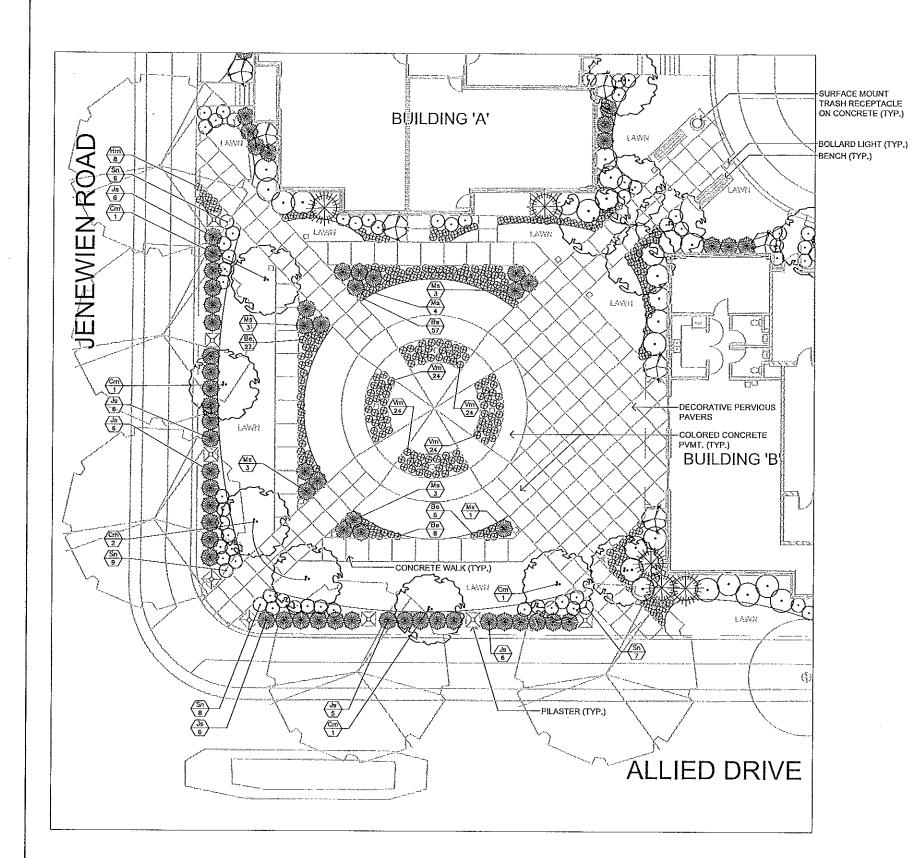

- 1) FOR EDGING, SEE DETAIL 4, SHEET L.10
- 2) FOR PLAZA PAVING, SEE DETAIL S.6
- 3) FOR BOLLARD AND LIGHTING PHOTOMETRICS, SEE SHEET S.8
- 4) FOR PILASTER, SEE DETAIL 1, SHEET L.11
- 5) FOR STREET TREE TYPES AND LOCATIONS, SEE SHEET L.2
- 6) FOR EXISTING TREE TYPES AND LOCATIONS, SEE SHEET S.1



Professional Seal

| vision | Date |
|--------|----------|
| | 05/19/08 |
| | 05/27/08 |

Project Name

Allied Drive Neighborhood Redevelopment GDP/SIP



Community
Development

Authority

City of Madison Madison, WI


Drawn By: jjb
Checked By: KS
File: -Issued For: Review
Issue Date: 05/07/08


2296.01

Issue Date: Project No.

Sheet Title

Gateway/Plaza Landscape Plan

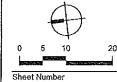

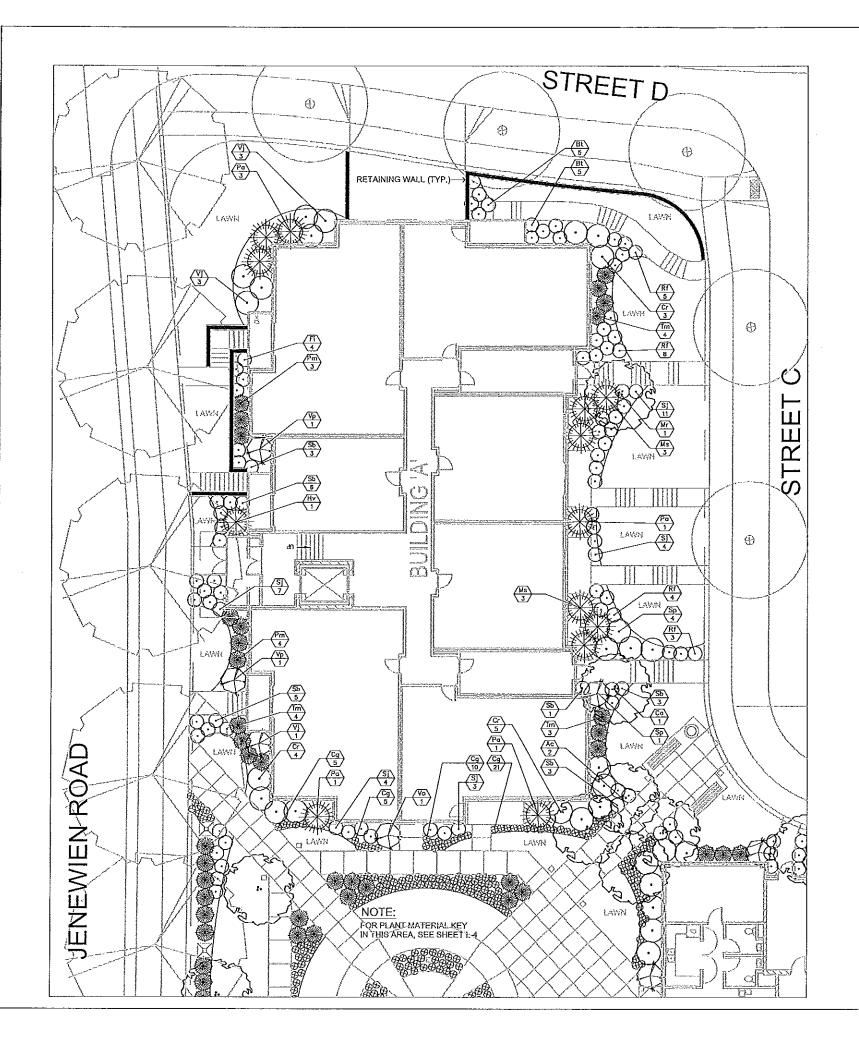

- 1) FOR EDGING, SEE DETAIL 4, SHEET L.10
- 2) FOR PLAZA PAVING, SEE DETAIL S.6
- 3) FOR BOLLARD AND LIGHTING PHOTOMETRICS, SEE SHEET S.8
- 4) FOR PILASTER, SEE DETAIL 1, SHEET L.11
- 5) FOR STREET TREE TYPES AND LOCATIONS, SEE SHEET L.2
- 6) FOR EXISTING TREE TYPES AND LOCATIONS, SEE SHEET S.1



Professional Seal

Revision Date 05/19/08

Project Name

Allied Drive Neighborhood Redevelopment GDP/SIP



Community
Development
Authority


City of Madison Madison, WI


Drawn By: Jjb
Checked By: KS
File: -Issued For: Review

Issue Date: Project No.

Sheet Title
Building 'A'
Landscape Plan

A

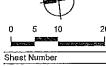

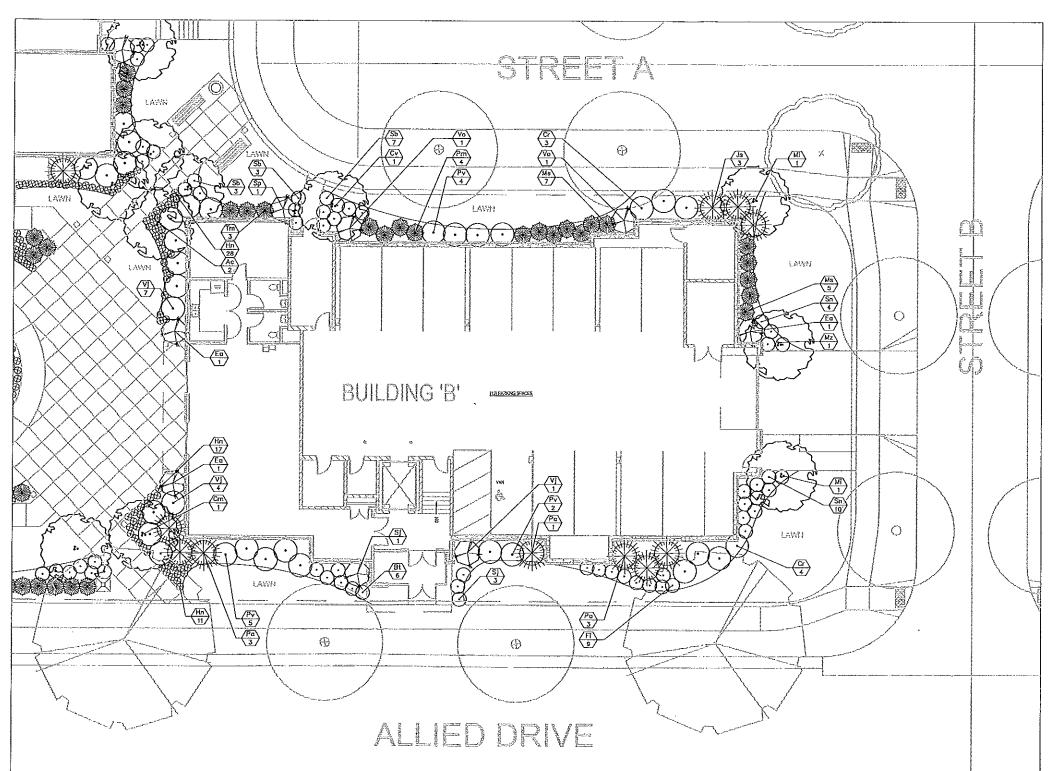

1) FOR EDGING, SEE DETAIL 4, SHEET L.10
2) FOR PLAZA PAVING, SEE DETAIL S.6
3) FOR BOLLARD AND LIGHTING PHOTOMETRICS, SEE SHEET S.8
4) FOR PILASTER, SEE DETAIL 1, SHEET L.11
5) FOR STREET TREE TYPES AND LOCATIONS, SEE SHEET L.2

6) FOR EXISTING TREE TYPES AND LOCATIONS, SEE SHEET S.1

7) FOR BUILDING 'B' FLOOR PLANS, SEE SHEET A.120



Professional Seal

Revision Date 05/19/08

Project Name

Allied Drive Neighborhood Redevelopment GDP/SIP



Community
Development
Authority

City of Madison Madison, WI

Drawn By: Checked By: File: Issued For: Re


Issue Date: 05/07/08 Project No. 2296.01

Sheet Title

Building 'B' Landscape Plan



Sheet Number

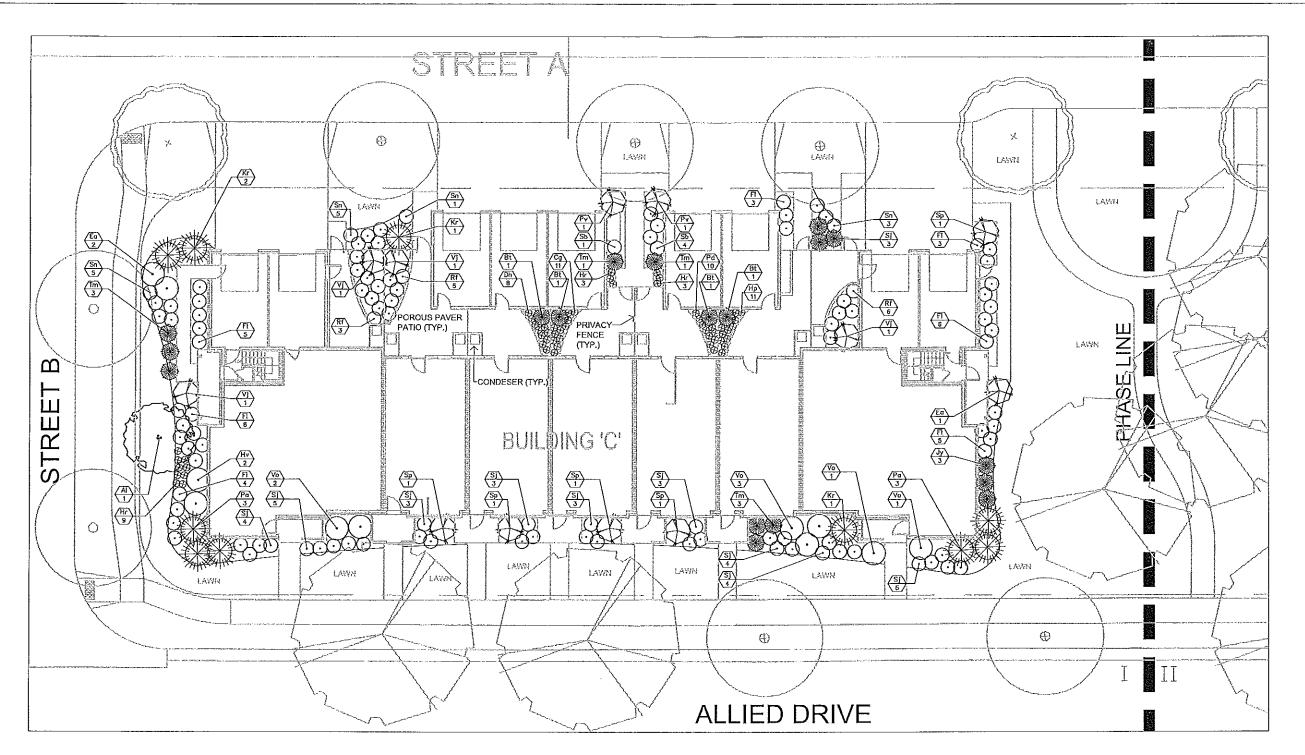

1) FOR EDGING, SEE DETAIL 4, SHEET L.10 2) FOR PLAZA PAVING, SEE DETAIL S.6

3) FOR BOLLARD AND LIGHTING PHOTOMETRICS, SEE SHEET S.8

4) FOR PILASTER, SEE DETAIL 1, SHEET L.11

5) FOR STREET TREE TYPES AND LOCATIONS, SEE SHEET L.2

6) FOR EXISTING TREE TYPES AND LOCATIONS, SEE SHEET S.1



Professional Seal

| Revision | Date |
|----------|----------|
| | 05/19/08 |
| | 05/27/08 |

Project Name

Allied Drive Neighborhood Redevelopment GDP/SIP



Community Development

Authority

City of Madison Madison, WI

Drawn By: Checked By: KS File: Issued For:


05/07/08


2296.01

Issue Date: Project No.

Sheet Title

Building 'C' Landscape Plan

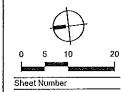

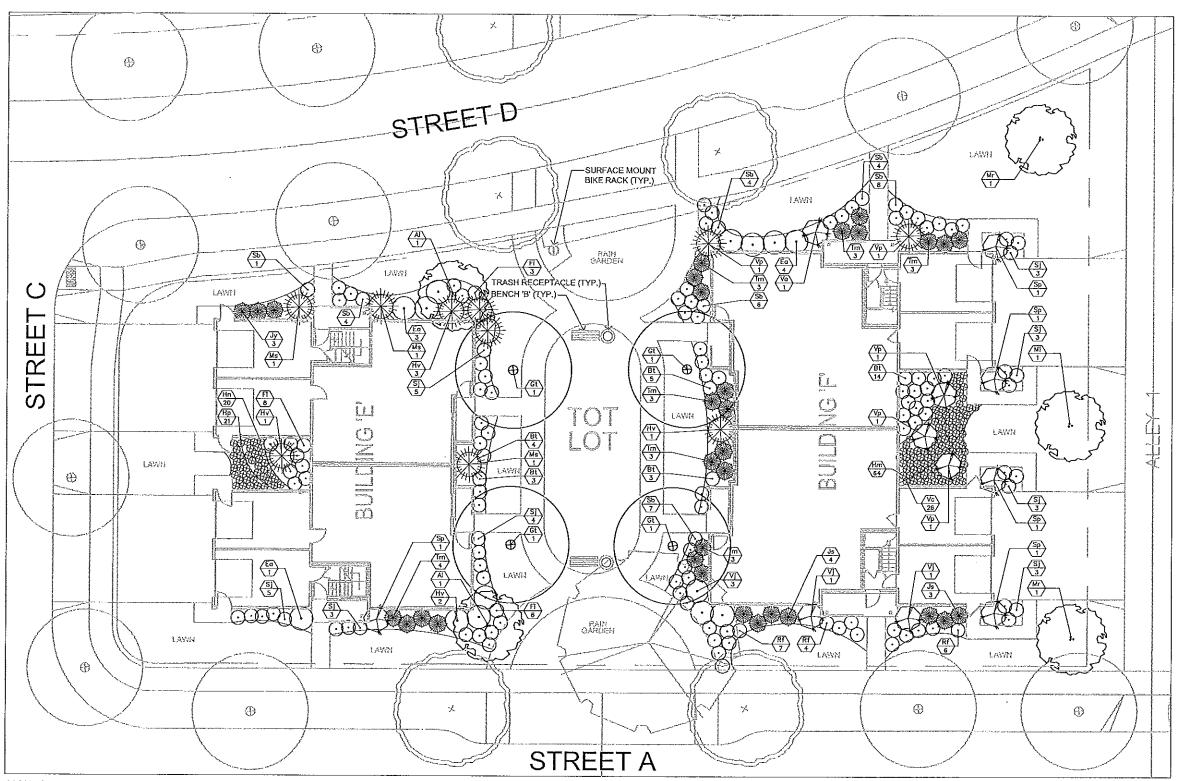

- 1) FOR EDGING, SEE DETAIL 4, SHEET L.10
- 2) FOR PLAZA PAVING, SEE DETAIL S.6
- 3) FOR BOLLARD AND LIGHTING PHOTOMETRICS, SEE SHEET S,8
- 4) FOR PILASTER, SEE DETAIL 1, SHEET L.11
- 5) FOR STREET TREE TYPES AND LOCATIONS, SEE SHEET L.2
- 6) FOR EXISTING TREE TYPES AND LOCATIONS, SEE SHEET S.1
- 7) FOR BUILDINGS 'E' AND 'F' FLOOR PLANS, SEET SHEETS A.140 & A.150
- 8) FOR BENCH 'B' DETAILS, SEE DETAIL 5, L.11
- 9) FOR TRASH RECEPTACLE DETAILS, SEE DETAIL 3, SHEET L.11
- 10) FOR RAIN GARDEN DETAILS, SEE SHEET L.9
- 11) FOR TOT LOT EQUIPMENT AND SURFACING, SEE LETTER OF INTENT
- 12) UNLESS OTHERWISE INDICATED, ALL LANDSCAPE AREAS OF PLAN TO BE BLUEGRASS SOD, MINIMUM 4 VARIETIES.



Professional Seal

Revision Date 05/19/08 05/27/08

Project Name

Allied Drive Neighborhood Redevelopment GDP/SIP



Community
Development
Authority

City of Madison Madison, WI

Review

05/07/08


2296,01

Drawn By: Checked By: File: Issued For:

Issue Date: Project No.


Sheet Title


Building E, Tot Lot, and Building F Landscape Plan

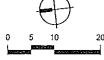


Sheet Number


| у. | Symbol | | Common Name | Size | Root | Remarks |
|----------|----------|---|---------------------------------------|----------------------|---------------------------------------|----------------------------------|
| SHA | VDE TREE | | | | · · · · · · · · · · · · · · · · · · · | |
| 8 | Αb | Acer x freemonii Autumn Bloze | Autumn Bloze Mople | 2 1/2" Col. | 8&8 | Street Tree |
| 10 | Ар | Acer platanoides 'Schwedler' | Schwedier Norway Mople | 2 1/2" Cal. | 848 | Street Tree |
| 12 | Gt | Gleditsia triaconthos mermis 'Skyline' | Skyline Honeylocust | 2 1/2" Cal. | 848 | Street Tree |
| 7 | Τg | Tilia cordata Greenspire | Greenspire Littleleaf Linden | 2 1/2" Cal. | B&B | Street Tree |
| 5 | Pc | Pyrus colleryono | Chanticleer Pear | 2 1/2" Col. | 8&8 | Street Tree |
| 7 | Up | Ulmus porviflora 'Dynasty' | Dynasty Elm | 2 1/2" Cal. | B&B | Street Tree |
| ORA | NAMENTA | AL TREES | | | | |
| 4 | Ac | Amelanchier conodensis | Shadblow Serviceberry | 6' ~ 8' HL | 848 | Multi-stem |
| 3 | AJ | Amelonchier loevis | Allegheny Serviceberry | 6' ~ 8' HL | 8&8 | Multi-stem |
| 1 | Ca | Cornus alternifolia | Pagoda Dogwood | 6' ~ 8' Ht. | 848 | Wulti-stem |
| 7 | Cm | Cornus mas | Cornelian Cherry Dogwood | 6' - 8' Ht. | B&B | Wulti-stem |
| 1 | Cv | Crotaegus virdis "Winter King" | Winter King Howthorn | 1 1/2" Cal. | Е&В | Tree Form |
| 3 | Mi | Maius Indian Summer | Indian Summer | 1 1/2" Cal. | B&B | Tree Form |
| 3 | Мг | Maius Red Splendor | Flawering Crob Red Splendor | 1 1/2" Cal. | 8&8 | Tree Form |
| 1 | Mz | Malus x 'zumi' colocarpa | Zumi Flowering Crab | 1 1/2" Cal. | 888 | Tree Form |
| | | SHRUBS | | r syz col. | L LOCAL CO. | 1 |
| 49 | BL | Berberis thunbergi | Crimson Pygmy Barberry | 15" Ht. | Castation | |
| | Cr | 'Crimson Pygmy' Cornus sericea 'Baileys' | | 35" Ht. | Container | |
| 19 | Ea | 1 " | Rediwig Dogwood | | Container | |
| 14 | | Eucnymous alata Compacta Forsythia x intermedia | Dworf Burning Bush | 30" Ht. | Container | |
| 64 | Fi | Forsythia x intermedia Lynwood Gold | Lynwood Gold Forsythia | 36" Ht. | Container | |
| 10 | Hv | Homomelis vernolis Philadelphus x virgininolis | Vernal Witchhozel Minnesota Snowflake | 36" Ht. | Container | |
| 13 | Pv | Minnesota Snowflake | Mockorange | 30" Ht. | Container | |
| 56 | Rf | Rosa 'Nearly Wild' | Nearly Wild Rose | 15" Ht. | Container | |
| 69 | \$b | Spiraea x burnalda Anthony Waterer | Anthony Waterer Spirea | 15" Ht. | Contoiner | |
| 99 | Sj | Spiraea joponica Little Princess | Little Princess Spireo | 15" Ht. | Container | |
| 58 | 5n | Spiraea nipponica 'Snowmound' | Snowmound Spirea | 15" Ht. | Container | |
| 16 | Sp | Şyringa potula Miss Kim | Miss Kim Litoc | 24" HL | Contoiner | |
| 28 | ٧ĵ | Viburnum x juddi | Juddi Viburnum | 24" HŁ | Container | |
| 11 | Vo | Viburnum opulus 'Nanum' | Dworf Cronberry Viburnum | 18" Ht. | Container | |
| 7 | ۷р | Viburnum pronifetiom | Blackhow Viburnum | 36" Ht. | Container | |
| EVE | RGREEN | SHRUBS | | | | |
| 45 | Js | Juniperus chinensis 'Seo Green' | Sea Green Juniper | 5 Gel. | Pot | |
| Б | Jy | Juniperus horizontalis Youngstown | Andora Juniper | 5 Gd. | Pot | |
| 11 | Pm | Pinus muga "Mugo" | Dwarf Muga Pine | 5 Gal. | Pot | |
| 44 | Tras | Taxus media "Nigra" | Nigra Yew | 5 Gal. | Pat | |
| | SSES | | 7 | | | |
| 4 | Kſ | Colomogrostis | Feother Reed Gross | 1 Gal. | Pot | |
| 38 | Ms | acutifolia 'Korl Forester' Miscanthus, sinensis | Maidengrass | 1 Gat. | Pot | |
| 19 | Pa | 'Gracillimus' | - | | Pot | |
| | ENNIALS | Pennisetum olopecuroides & GROUNDCOVER | Fountain Grass | 1 Cal. | rut | |
| Т | Be | Rudbeckia fulgida | Black Eyed Suson | 4.5" Pot | Det | Seece 15" 0.C |
| 98 | Cg | Goldsturm Coreopsis grandiflara Sunray | Coreopsis | 4.5" Pot | Pot | Space 15" O.C. Space 24" O.C. |
| 52 | | | | 4.5 Pot | Pot | Space 24" O.C. |
| 10 | Dh Hm | Dianthus allwoodii 'Helen' Hemerocollis | Helen Dionthus | 4.5" Pot | Pot | Space 24" O.C. |
| 72 76 | Hn | Hoppy Returns Hemerocollis | Daylikes (Dworf) Daylikes (Dworf) | | Pot | Space 24" O.C. |
| | Нр | "Bononzo" | Purple Polace Corol Bells | 4.5" Pot 4.5" Pot | Pot | Space 15" O.C. |
| 32 | Hr | Fluechera micracantha Purple Palace | | | Pot | Space 24" O.C. |
| 15 | Pd | Hosto 'Royal Standard' Phlox divericata | Hosto Wild Sweet William | 4.5" Pot | Pot | Space 15* O.C. |
| 10 | Vc | Verbena conodensis | | 4.5" Fot 4.5" Pot | Pot | Space 24° O.C. |
| 26 | . '` | vencena conadensis | Rose Vervoin | 01 | 1.00 | apace ze o.o. |

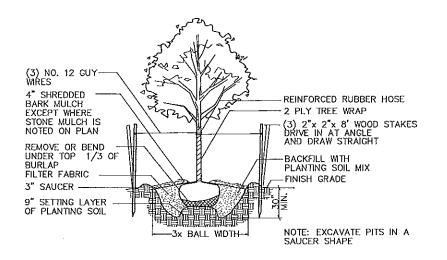


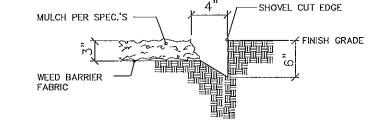



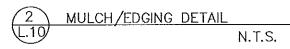


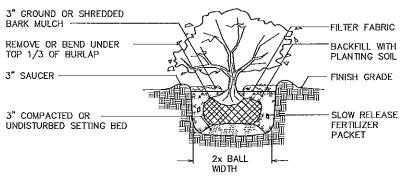

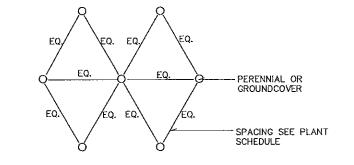





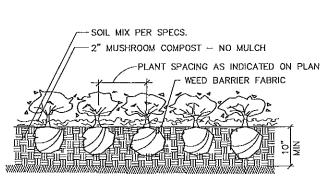





 Revision
 Date

 05/19/08

05/27/08

Professional Seal

Project Name

Allied Drive Neighborhood Redevelopment GDP/SIP



Community
Development
Authority

City of Madison Madison, WI

Drawn By: jjb
Checked By: KS
File: -Issued For: Review


Issue Date: 05/07/08 Project No. 2296.01

Sheet Title

Plant Legend and Landscape Details



No Scale Sheet Number

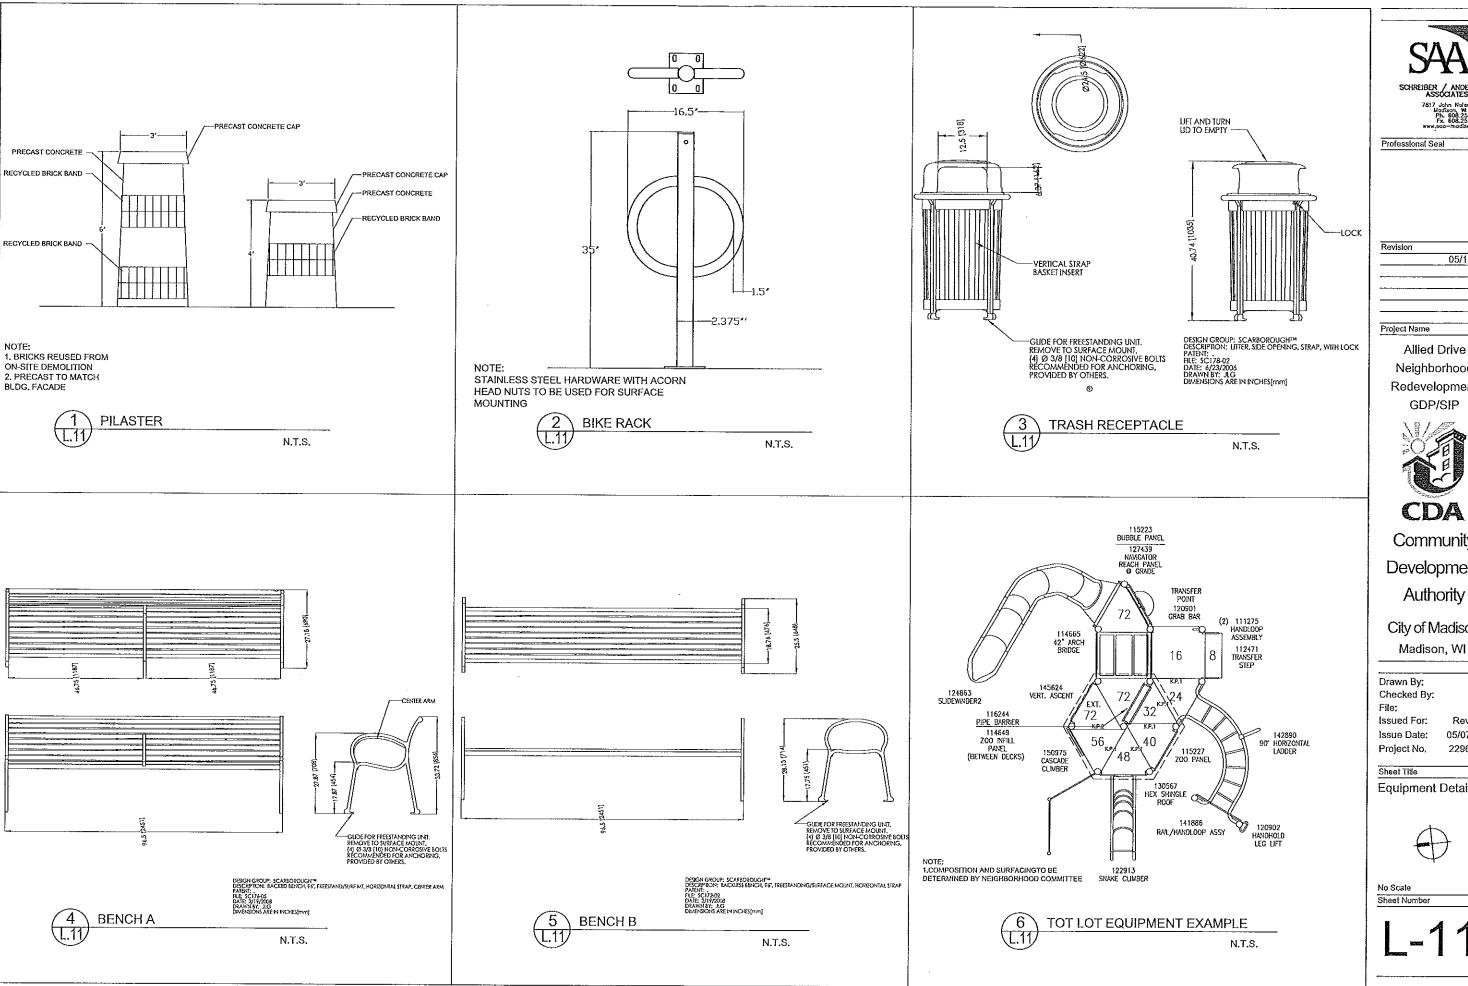

Professional Seal

05/19/08

Allied Drive Neighborhood Redevelopment GDP/SIP



Community Development Authority

City of Madison

Drawn By: Checked By: Issued For: Review

Issue Date: 05/07/08 2296.01 Project No.

Equipment Details



No Scale Sheet Number

| | | * * * |
|--|---|-------|
| | | |
| | | |
| | | |
| | | |
| | | |
| | | |
| | · | |
| | | |
| | | |
| | | : |
| | | |
| | | |
| | | I |
| | | |
| | | İ |
| | | |
| | | |
| | | |
| | | |
| | | J |