

NOTE: THIS IMAGE IS AN ARTISTIC IMPRESSION ONLY AND MAY NOT EXACTLY REFLECT THE ACTUAL CONSTRUCTION AS DEFINED BY THE CONSTRUCTION DOCUMENTS

PROJECT TEAM


OWNER STATE OF WISCONSIN Division of Facilities Development 101 E. Wilson St. Madison, WI 53703-3405	OCCUPANT UNIVERSITY OF WISCONSIN - MADISON College of Letters and Science
PRIME ARCHITECT RAMLOWSTEIN ARCHITECTURE + INTERIORS 322 East Michigan Street, #400 Milwaukee, Wisconsin 53202 Telephone: (414)271-8899	CIVIL ENGINEER KAPUR 7711 N. Port Washington Rd. Milwaukee, WI 53217 Telephone: (414) 751-7200
ASSOCIATE ARCHITECT SCPSA ARCHITECTS 720 SW Washington St. # 800 Portland, OR 97205 Telephone: (503) 226-1575	LANDSCAPE ARCHITECTURE SAKI DESIGN 1110 S. Park St. Madison, WI 53715 Telephone: (608) 261-3800
STRUCTURAL ENGINEERING GRAEF 1010 E. Washington Ave # 202 Madison, WI 53703 Telephone: (608) 242-1550	AUDIO / VISUAL DESIGN THE SHALLECK COLLABORATIVE, INC. 1553 Martin Luther King Jr. Way Berkeley, CA Telephone: (415) 956-4100
HVAC ENGINEERING HEAD & HUNT 2440 Deming Way Middleton, WI 53562 Telephone: (608) 273-6380	ACOUSTICS JAFPE HOLDEN 114A Washington St. Norwalk, CT 06854 Telephone: (203) 638-4167
ELECTRICAL, FIRE ALARM, TELECOM, AND SECURITY ENGINEERING HEAD & HUNT 10700 W. Research Dr. Suite 155 Milwaukee, WI 53226 Telephone: (262) 750-0232	OWNER ABATEMENT CONSULTANT PLACE HOLDER
PLUMBING ENGINEERING FIRE SUPPRESSION THUNDERBIRD ENGINEERING 1651 John Q. Hammons Dr. Suite 101 Middleton, WI 53563 Telephone: (608) 820-1201	COMMISSIONING PROVIDER GRUMMAN BOUTKUS 1011 N. Mayfair Rd. Suite 300 Wausau, WI 54980 Telephone: (414) 476-8980

NEW ACADEMIC BUILDING LEVY HALL UNIVERSITY OF WISCONSIN - MADISON MADISON, WISCONSIN

05/22/2023 LUA


DFD PROJECT NO: 20K1G-01

UW - MADISON - COLLEGE OF LETTERS AND SCIENCE
232 N. PARK ST.
MADISON, WI 53715

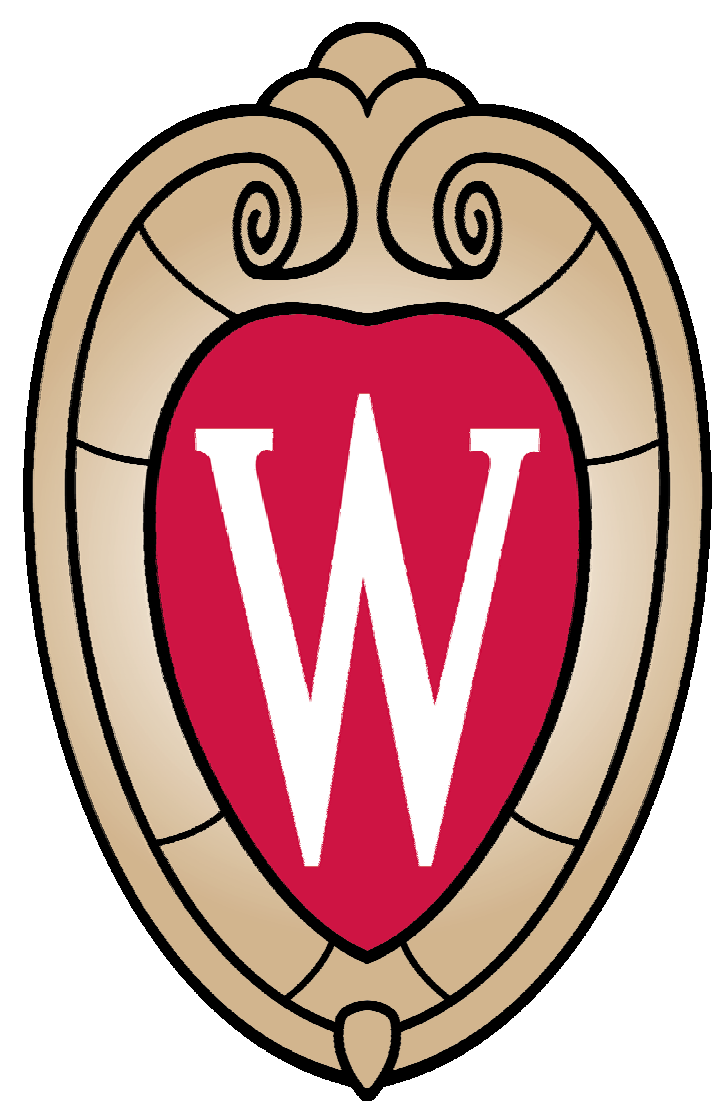

WISCONSIN

UNIVERSITY OF WISCONSIN-MADISON

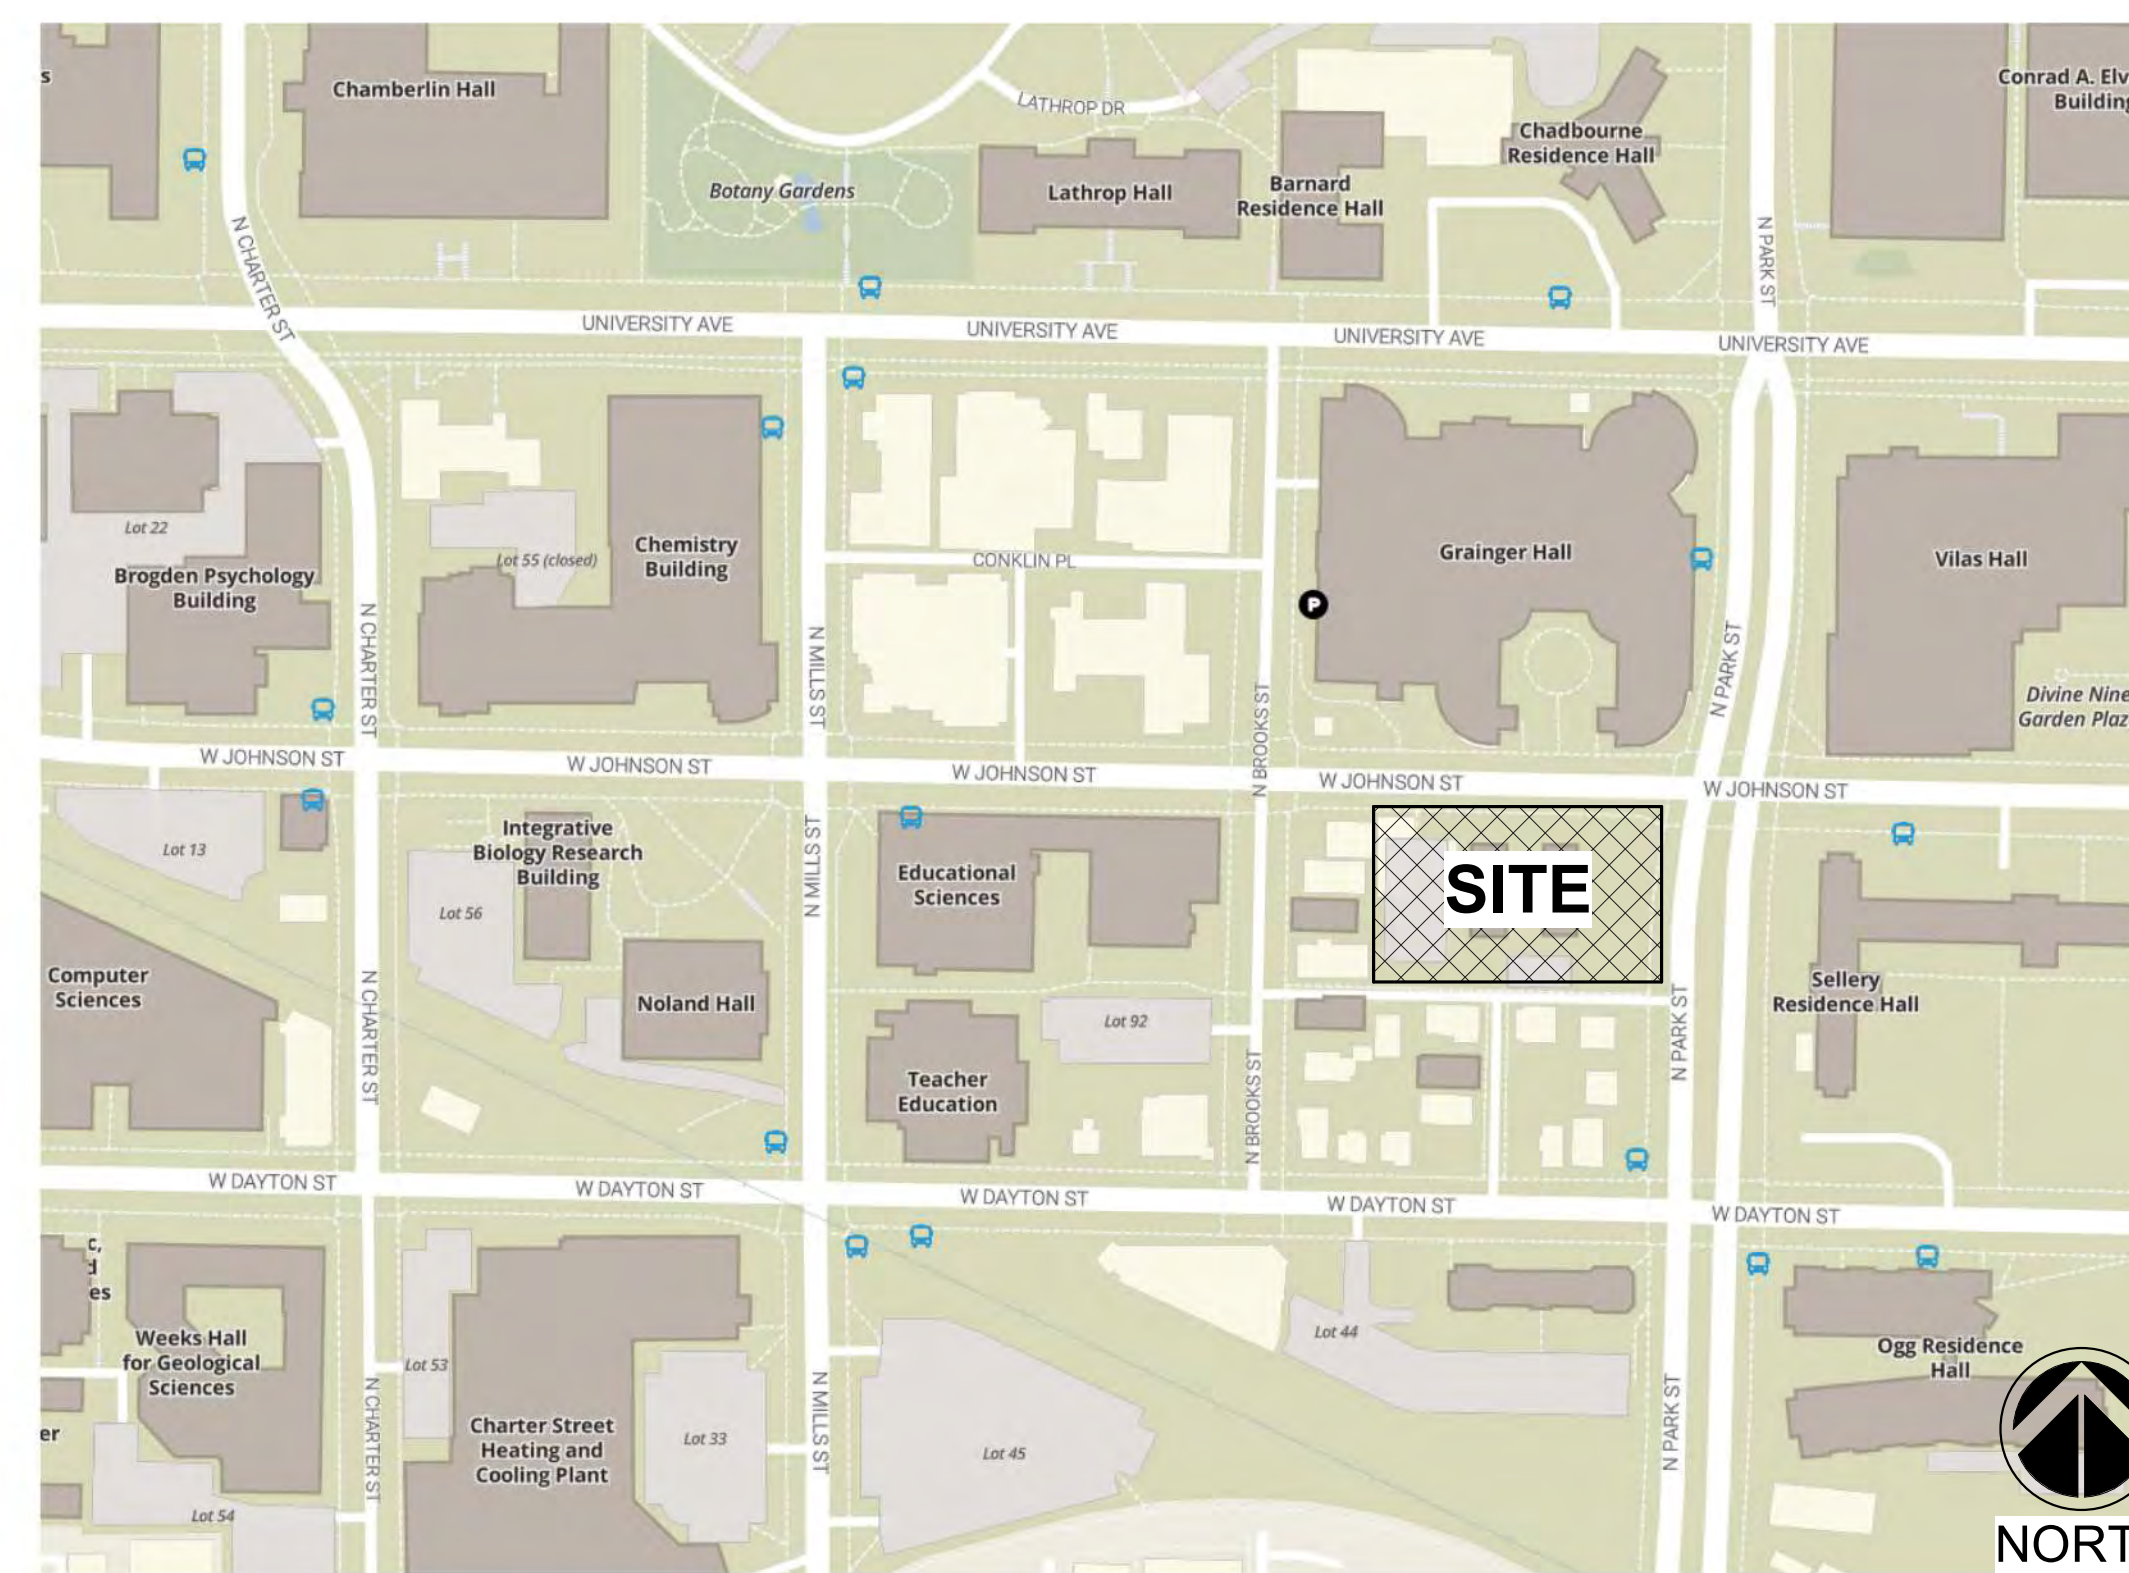


PROJECT SITE MAP



Consultant:

State of Wisconsin
Department of Administration
Division of Facilities Development

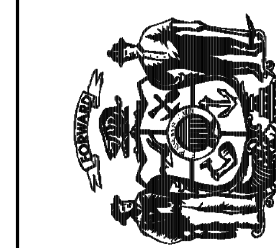

232 N. PARK ST.
MADISON, WI 53715

NEW ACADEMIC BUILDING
LEVY HALL
UNIVERSITY OF WISCONSIN - MADISON
MADISON, WISCONSIN

TITLE SHEET

Revisions:	No.	Date:	Description:

Graphic Scale	Net to Scale
DFD Number	20K1G-01
Set Type	LUA
Date Issued	05/22/2023
Sheet Number	G005

NOTE: MULTIPLE DOCUMENTS: CONSTRUCTION DOCUMENTS FOR THIS PROJECT WILL BE ISSUED IN MULTIPLE VOLUMES. EACH CONTRACTOR SHALL BE RESPONSIBLE FOR UNDERSTANDING AND CONFIRMING SCOPE OF THE PROJECT IDENTIFIED AND DOCUMENTED IN ALL VOLUMES.

SITE SURVEY AND BENCHMARKS

PART OF THE NW 1/4 OF THE NW 1/4 OF SECTION 23 TOWN 7 NORTH RANGE 9 EAST IN THE CITY OF MADISON, DANE COUNTY, WISCONSIN

POINT #	NORTHING	EASTING	ELEVATION	DESCRIPTION
CP 100	481500.360	816250.240	858.710	PK NAIL
CP 101	481920.560	816784.300	871.880	PK NAIL
CP 304	481672.534	816506.436	861.996	PK NAIL
BM 1178	481941.330	816319.300	871.170	BURYBOLT ON HYD.
BM 1534	481525.990	816297.330	861.520	BURYBOLT ON HYD.
BM 1713	481669.430	816502.110	864.010	BURYBOLT ON HYD.




VICINITY MAP
NOT TO SCALE

BEARINGS ARE BASED ON
WISCONSIN-DANE COUNTY (2015)
VERTICAL DATUM IS REFERENCED
TO NAVD 88
PARCELS ARE IN ZONE X PER FEMA
FLOOD MAP 5025C0409G,
EFFECTIVE DATE JANUARY 12, 2009.



Toll Free (800)242-8511
Milwaukee Area (414)259-1181
Hearing Impaired TDD (800)542-2289
www.DiggersHotline.com
REGISTERS HOTLINE TICKETS:
20213907425, 20213907434, 20213907485, 20213907489,
20213907596, 20213907603, 20213907636, 20213907641
ALTHOUGH DIGGERS' HOTLINE HAS NOTIFIED THIS SURVEY DOES NOT
GUARANTEE THAT ALL UTILITIES HAVE BEEN LOCATED ON SITE.
SOME OF THE UTILITIES MAY HAVE BEEN DRAWN IN PER PLAN
BASED ON MAPS RECEIVED FROM MEMBERS NOTIFIED. PLACING
EXCAVATION THE EXACT LOCATION OF UNDERGROUND FEATURES
CANNOT BE ACCURATELY, COMPLETELY AND RELIABLY DEPICTED.
WHERE ADDITIONAL OR MORE DETAILED INFORMATION IS REQUIRED,
THE CLIENT IS ADVISED THAT EXCAVATION MAY BE NECESSARY.

LEGEND	
⊕	= BENCH MARK
△	= CONTROL POINT
○	= 1 1/4" IRON PIPE O.D. FOUND OR AS NOTED
●	= 1-1/4" O.D. x 18" LONG IRON PIPE SET, WEIGHING 1.68 LBS./FT.
■	= SECTION CORNER MON.
(R.A.)	= RECORDED AS
O.D.	= OUTSIDE DIAMETER
⊕	= WATER VALVE
⊕	= FIRE HYDRANT
970.90	= SPOT ELEVATION
⊕	= BUSH, SHRUB
⊕	= POLE/POST/BOLLARD
⊕	= BOULDER
⊕	= PULLBOX
⊕	= MANHOLE TYPE NOTED
⊕	= SANITARY SEWER MANHOLE
⊕	= STORM SEWER MANHOLE
⊕	= ELECTRIC MANHOLE
⊕	= TELEPHONE MANHOLE
⊕	= WATER MANHOLE
⊕	= UTILITY METER
⊕	= GUY WIRE POLE
⊕	= TRAFFIC SIGNAL POLE
⊕	= CANTILEVERED TRAFFIC SIGNAL
⊕	= LIGHT POLE
⊕	= PEDESTAL
⊕	= POWER POLE
⊕	= INLET
⊕	= CURB INLET
⊕	= GAS VALVE
⊕	= LIGHT POLE WITH MAST
⊕	= TREE (CONIFEROUS) DRIP LINE SCALABLE
⊕	= TREE (DECIDUOUS) DRIP LINE SCALABLE
⊕	= CLEANOUT
⊕	= FLAG POLE
⊕	= UTILITY MARKER POST
⊕	= SIGN ON POST
⊕	= UTILITY CONTROL BOX
⊕	= UNKNOWN UTILITY VALVE
FL EL.	= FIRST FLOOR ELEVATION
---	= BUILDING OUTLINE
---	= MINOR CONTOUR
---	= MAJOR CONTOUR
---	= PROJECT LIMITS
---	= FENCE
---	= BEAM GUARD
---	= CHAINLINK FENCE
---	= WOODED AREA/SHRUB EDGE
---	= WATER MAIN
---	= STORM SEWER
---	= SANITARY SEWER
---	= NATURAL GAS MAIN
---	= UNDERGROUND TELEPHONE
---	= UNDERGROUND ELECTRIC
---	= OVERHEAD UTILITY LINES
---	= UNDERGROUND FIBER OPTIC
---	= UNDERGROUND CABLE TV
---	= COMMUNICATION CONDUIT
---	= ASPHALT SURFACE
---	= CONCRETE SURFACE
---	= CRUSHED AGGREGATE

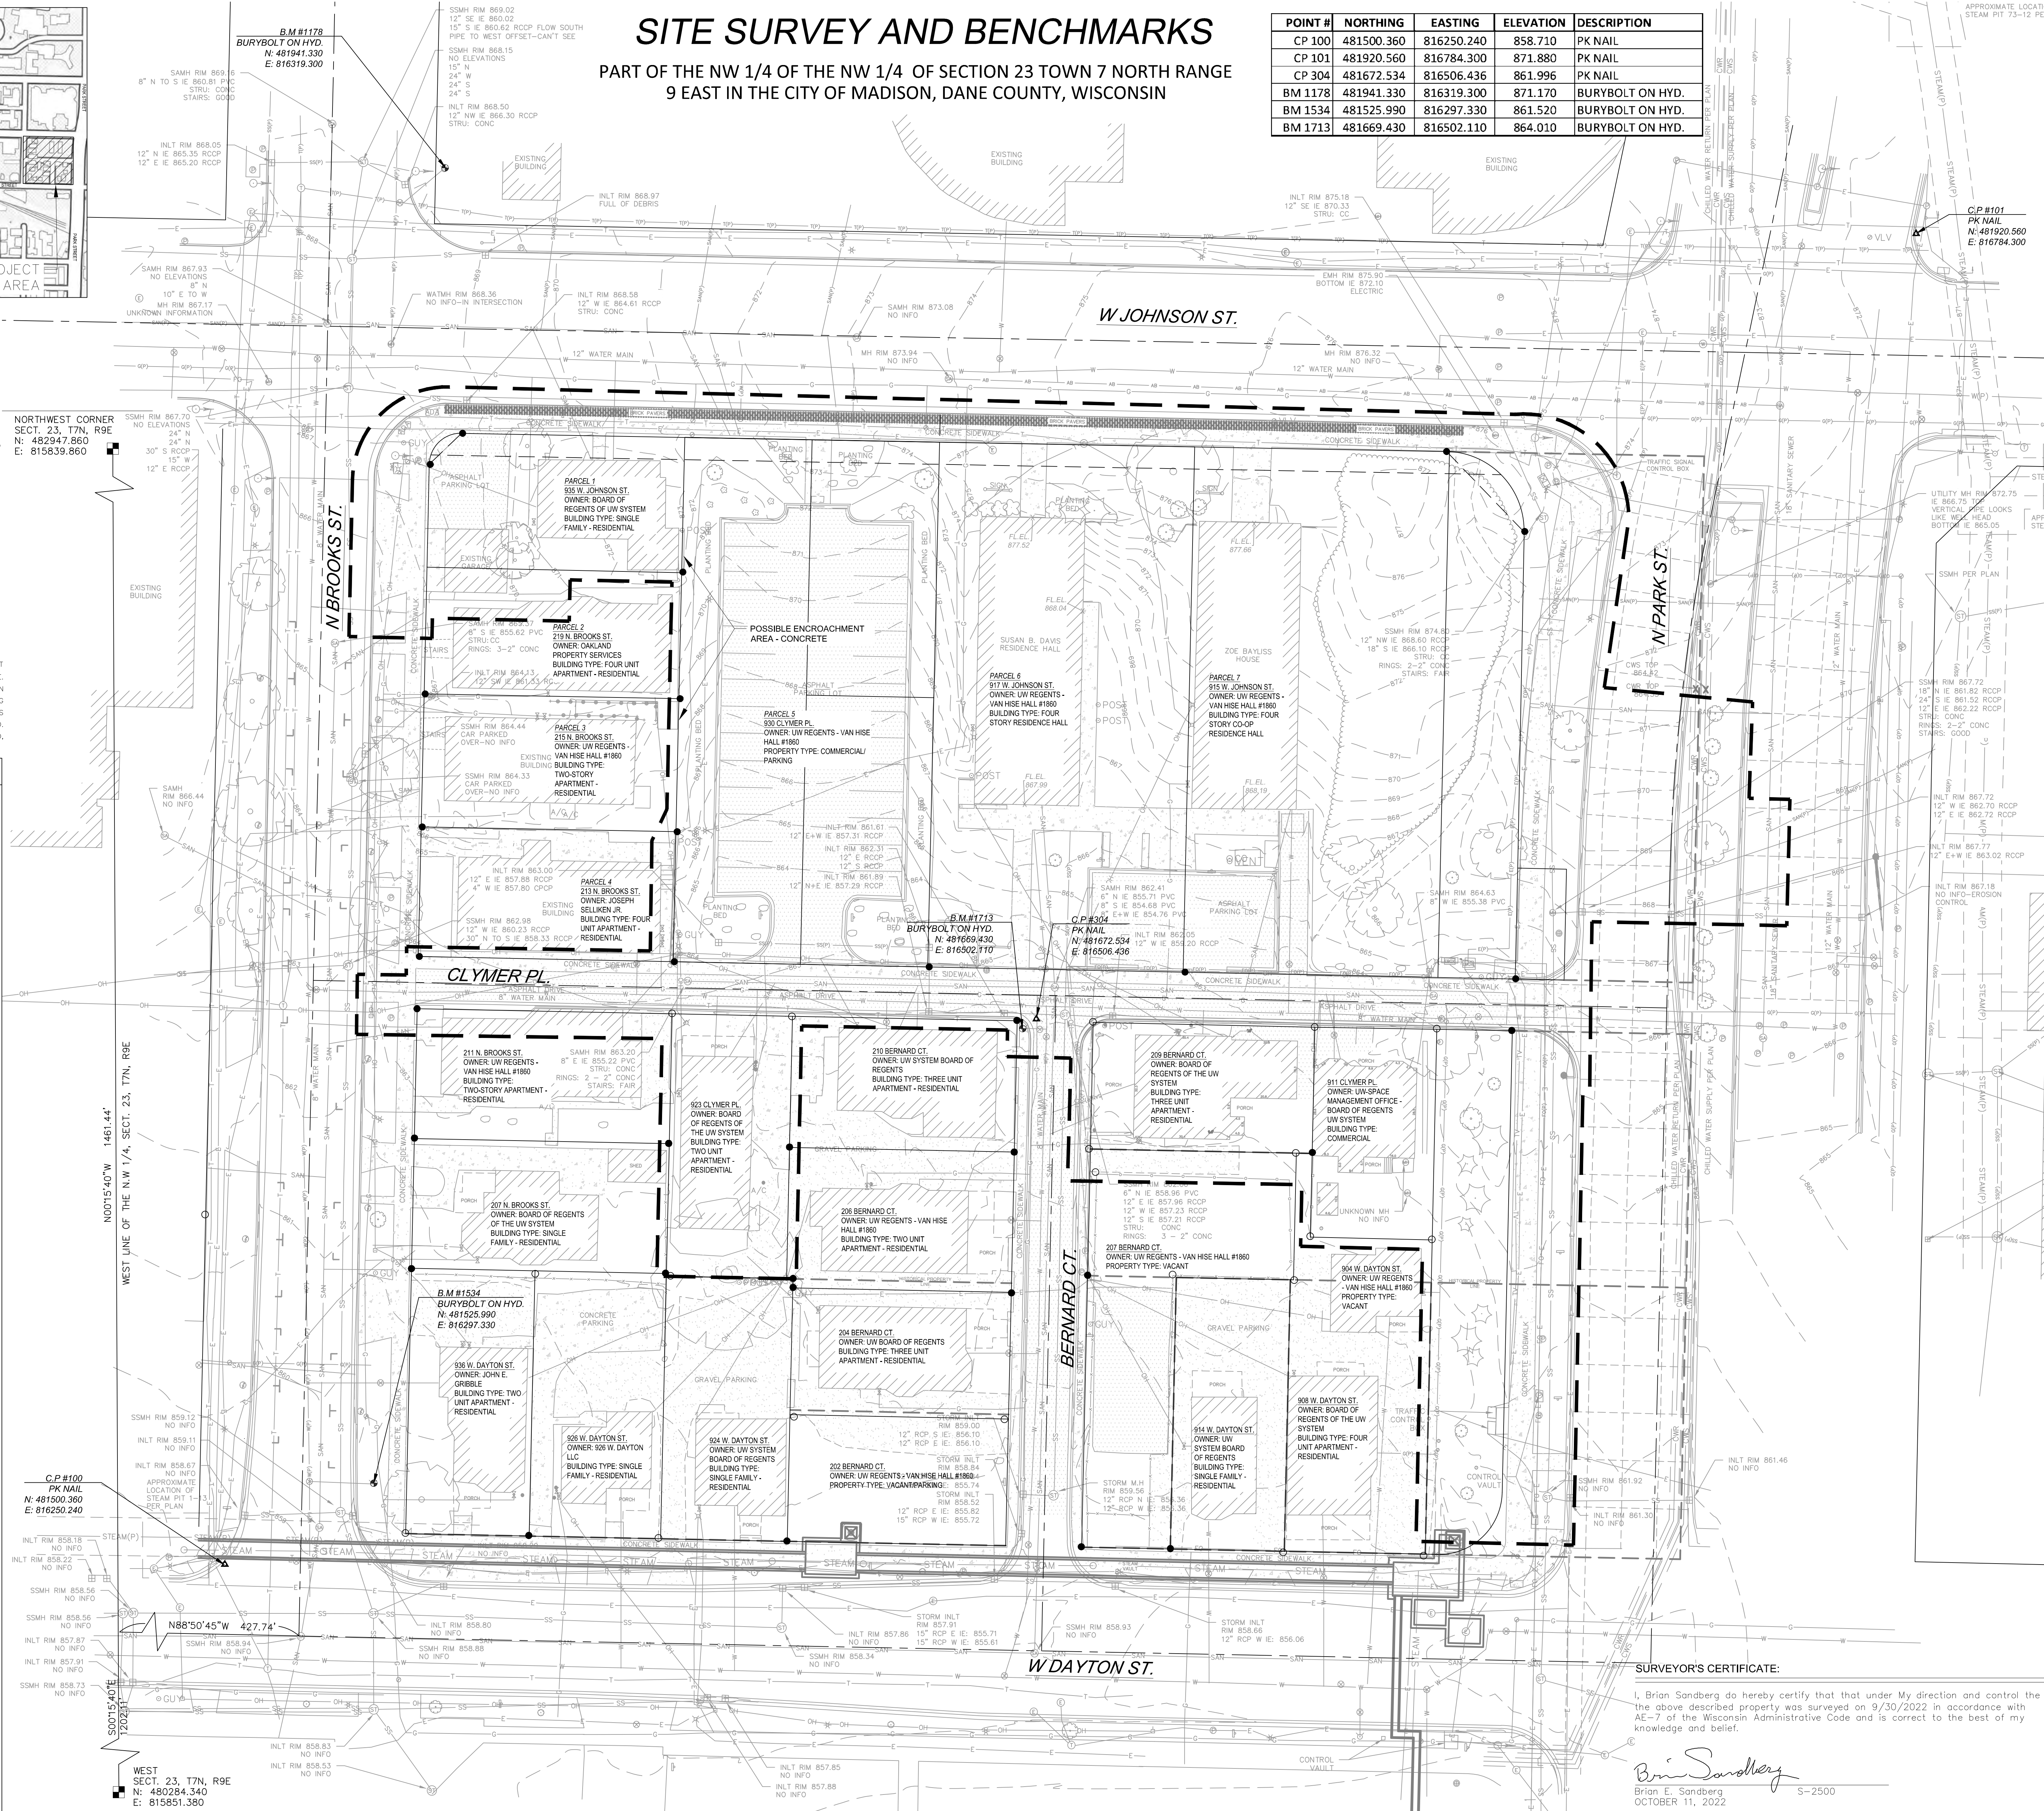

Consultant:
Kapur
400 E. Wisconsin Ave.
Milwaukee, WI 53202
www.kapurinc.com

State of Wisconsin
Department of Administration
Division of Facilities Development

NEW ACADEMIC BUILDING
LEVY HALL
UNIVERSITY OF WISCONSIN - MADISON
MADISON, WISCONSIN

Revisions:		
No.	Date:	Description:

Graphic Scale: 0 5' 10' 20' 30'

DFD Number: 20K1G-01

Set Type: LUA



Date Issued: 05/22/2023

Sheet Number: C010

SURVEYOR'S CERTIFICATE:
I, Brian Sandberg do hereby certify that that under My direction and control the
the above described property was surveyed on 9/30/2022 in accordance with
AE-7 of the Wisconsin Administrative Code and is correct to the best of my
knowledge and belief.
Brian Sandberg
Brian E. Sandberg S-2500
OCTOBER 11, 2022

GENERAL EROSION CONTROL NOTES

1. REFER TO SHEET C001 CIVIL GENERAL NOTES FOR GENERAL EROSION CONTROL NOTES AND SCHEDULE.

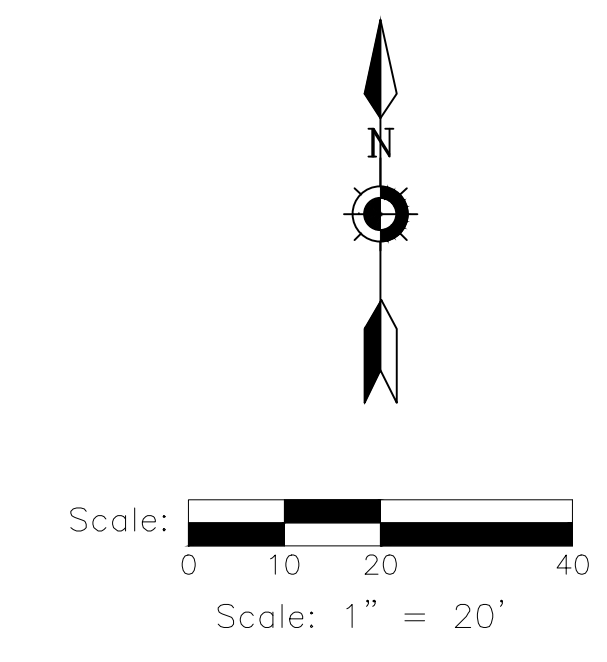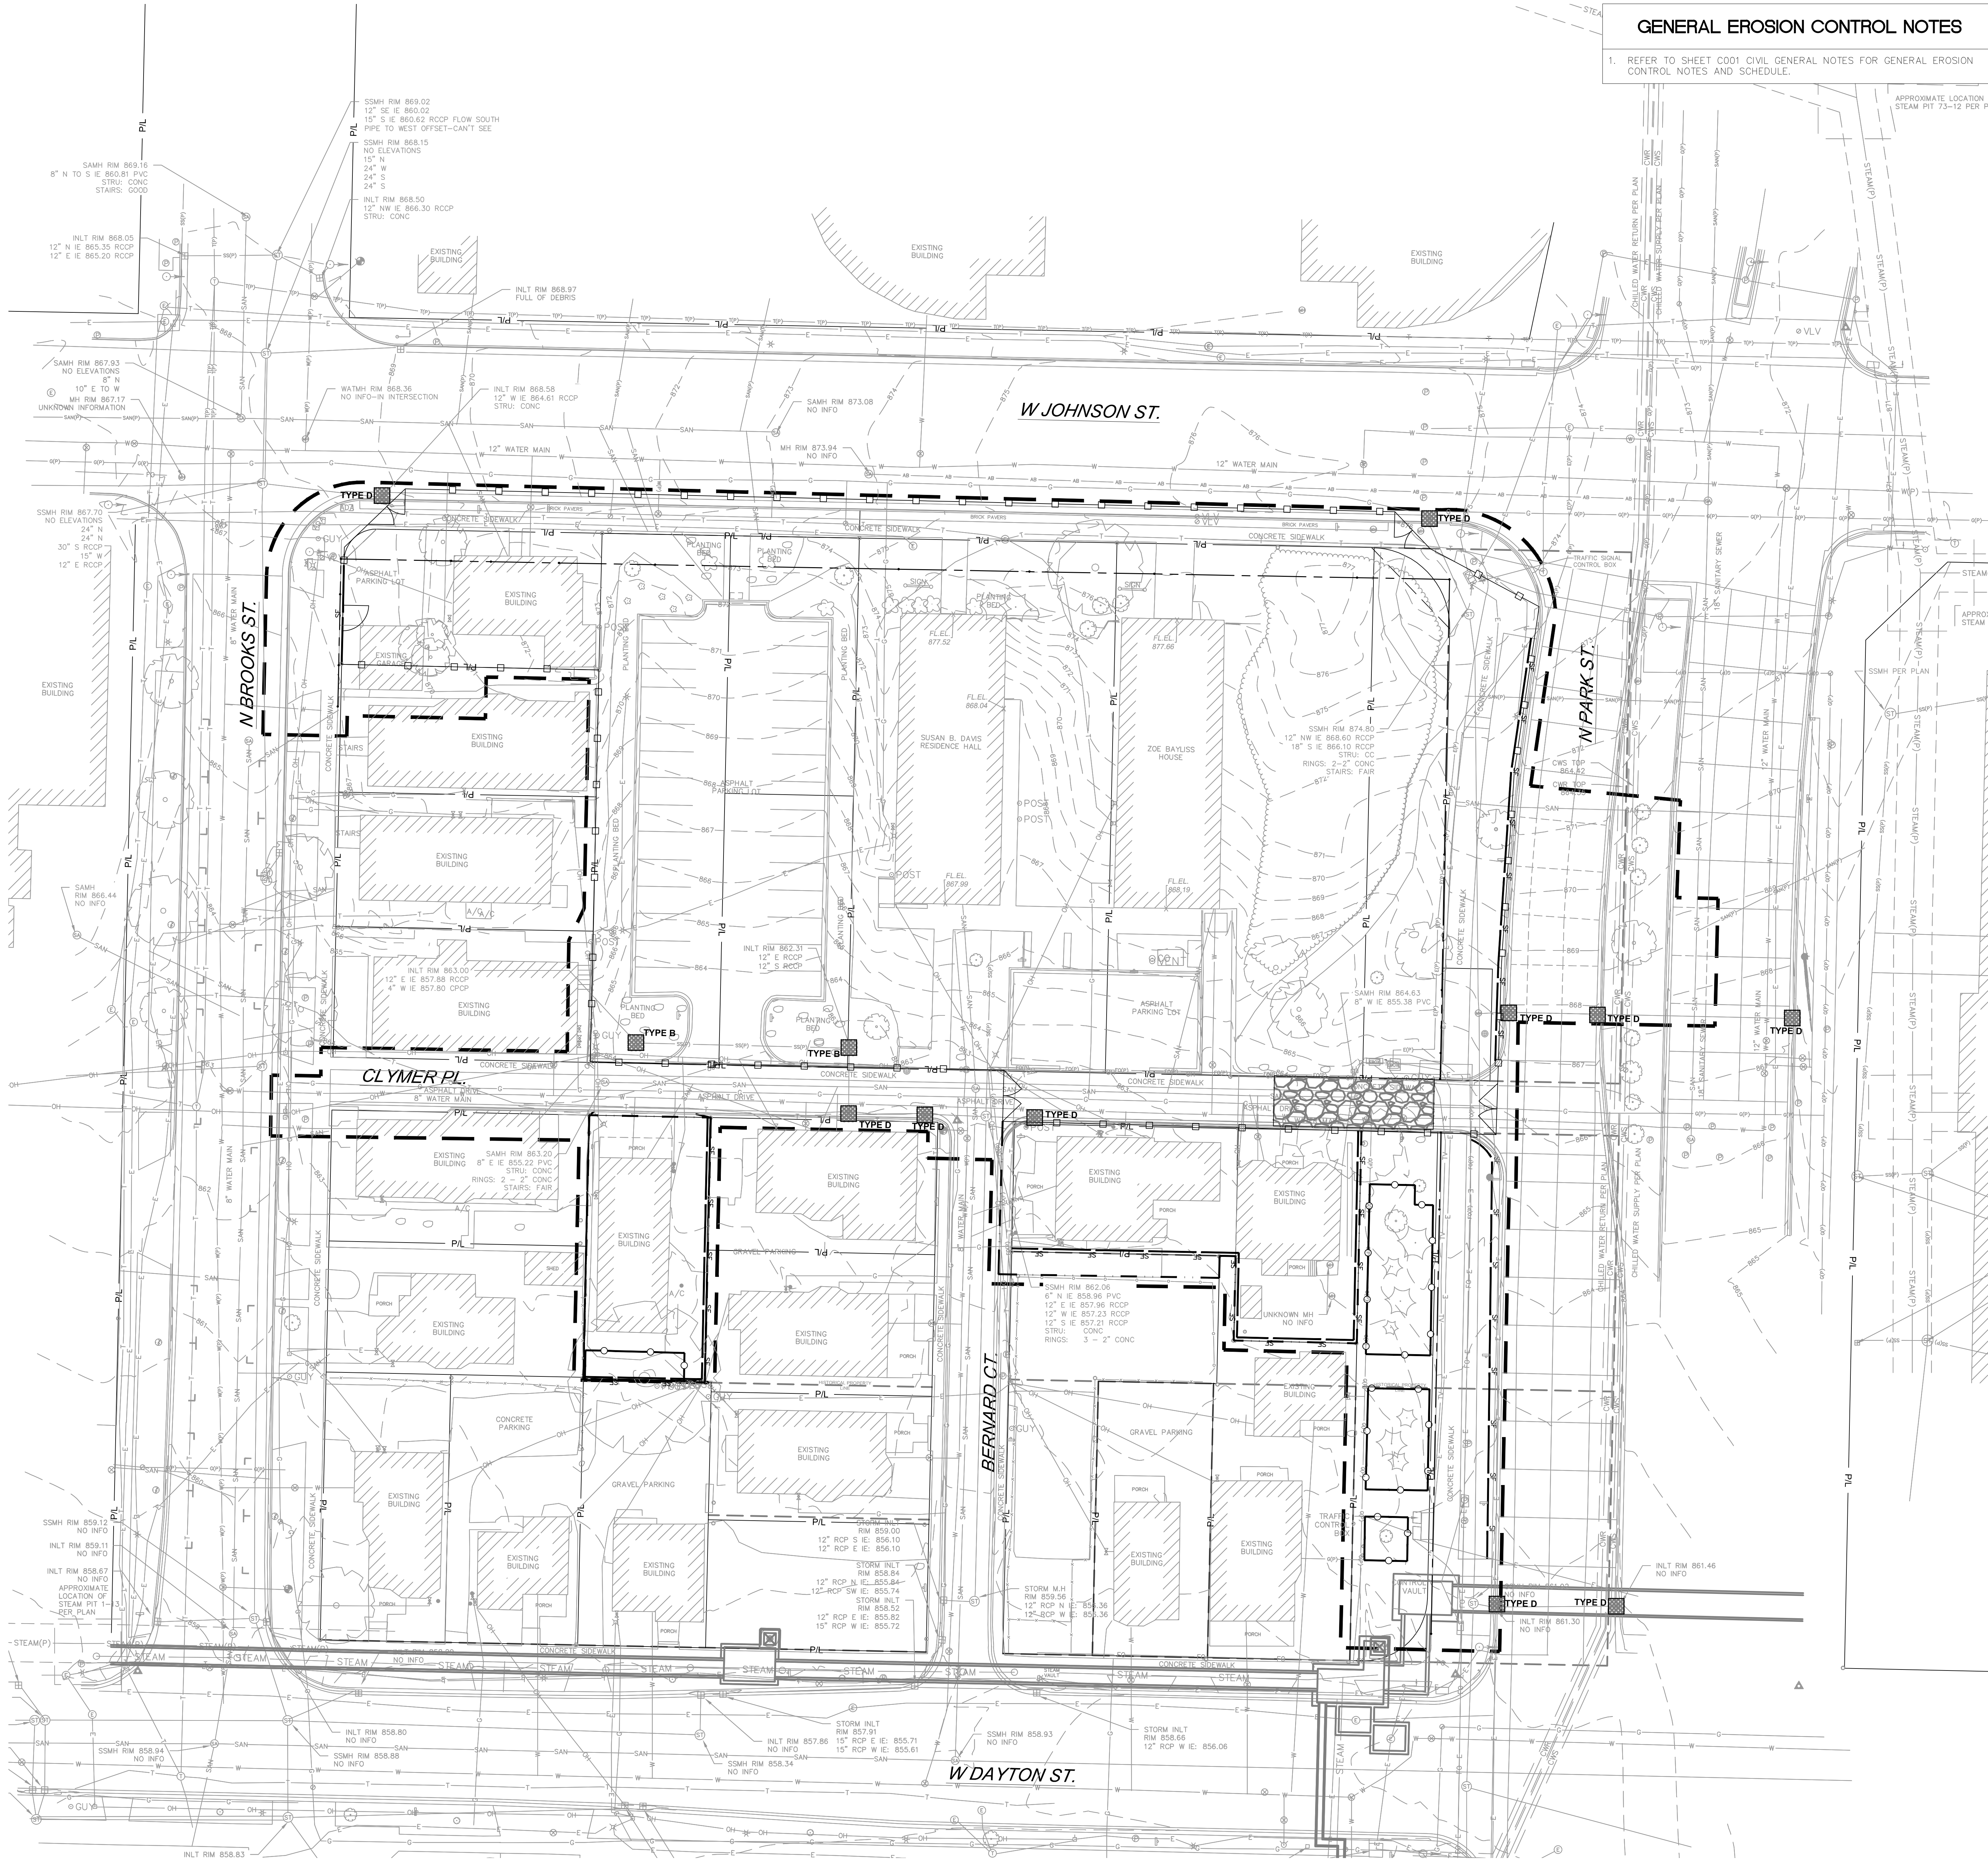

DIGGERS HOTLINE
Dial 811 or (800)242-8511
www.DiggersHotline.com

EROSION NOTES

INSPECT ALL EROSION CONTROL MEASURES PRIOR TO COMMENCING GRADING. GRUBBING OR OTHER LAND DISTURBING ACTIVITIES. EROSION CONTROL MEASURES MUST BE INSPECTED WEEKLY AND WITHIN 24 HOURS OF EVERY PRECIPITATION EVENT OF 0.25 INCH OR GREATER. IN ADDITION THE CONTRACTOR SHALL CONDUCT DAILY INSPECTIONS AND DOCUMENT CONDITIONS AND REPAIRS MADE ALONG WITH DATE, TIME OF INSPECTION AND WEATHER CONDITIONS IN A DAILY LOG BOOK. THE DAILY LOG BOOK, WEEKLY / 0.25 INCH PRECIPITATION REPORTS, APPROVED PLANS AND WRPS PERMIT SHALL BE KEPT IN AN ACCESSIBLE LOCATION, LIKE A MAILBOX, WITHIN THE STAGING AREA.

AT ABSOLUTELY NO TIME MAY CONSTRUCTION EQUIPMENT, DEBRIS, FILL, ETC. BE PLACED WITHIN WETLANDS, WATERWAYS OR FLOOD PLAINS UNLESS IDENTIFIED IN THE PLANS.

POINTS OF CONTACT


OWNER CONTACT:
MATTHEW DAPP - TEAM LEADER
WISCONSIN DEPARTMENT OF ADMINISTRATION
BUREAU OF ARCHITECTURE & ENGINEERING
DIVISION OF FACILITIES DEVELOPMENT
101 E. WILSON STREET
MADISON, WI 53703
PHONE: (608) 513-8220

PROJECT ENGINEER:
RYAN BIRSCHBACH
KAPUR & ASSOCIATES, INC
400 E. WISCONSIN AVENUE
MILWAUKEE, WI 53202
PHONE: (262) 768-6035

CONSTRUCTION MANAGER:
TBD

KEY INDEX


- PROJECT LIMITS
 - SE FILTER FABRIC FENCE
 - CONSTRUCTION FENCE
 - CONSTRUCTION FENCE BY 20K1G-02 CONTRACTOR
 - TREE PROTECTION FENCING
 - STONE TRACKING PAD REQUIRED. LOCATION TO BE DETERMINED BY SELECTED CONTRACTOR'S APPROVED WORK PLAN.
 - DESIGNATES EXISTING INLETS THAT MUST BE PROTECTED
- | | |
|---|-----|
| 1 | (1) |
| 2 | (2) |
| 3 | (3) |
| 4 | (4) |

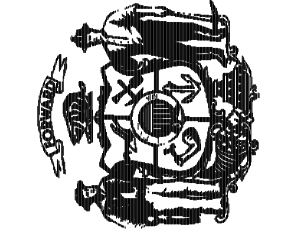

Revisions:	
No.	Description:

Graphic Scale: 0 5 10 20 30'

DFD Number:	20K1G-01
Set Type:	LUA
Date Issued:	05/22/2023
Sheet Number:	C100

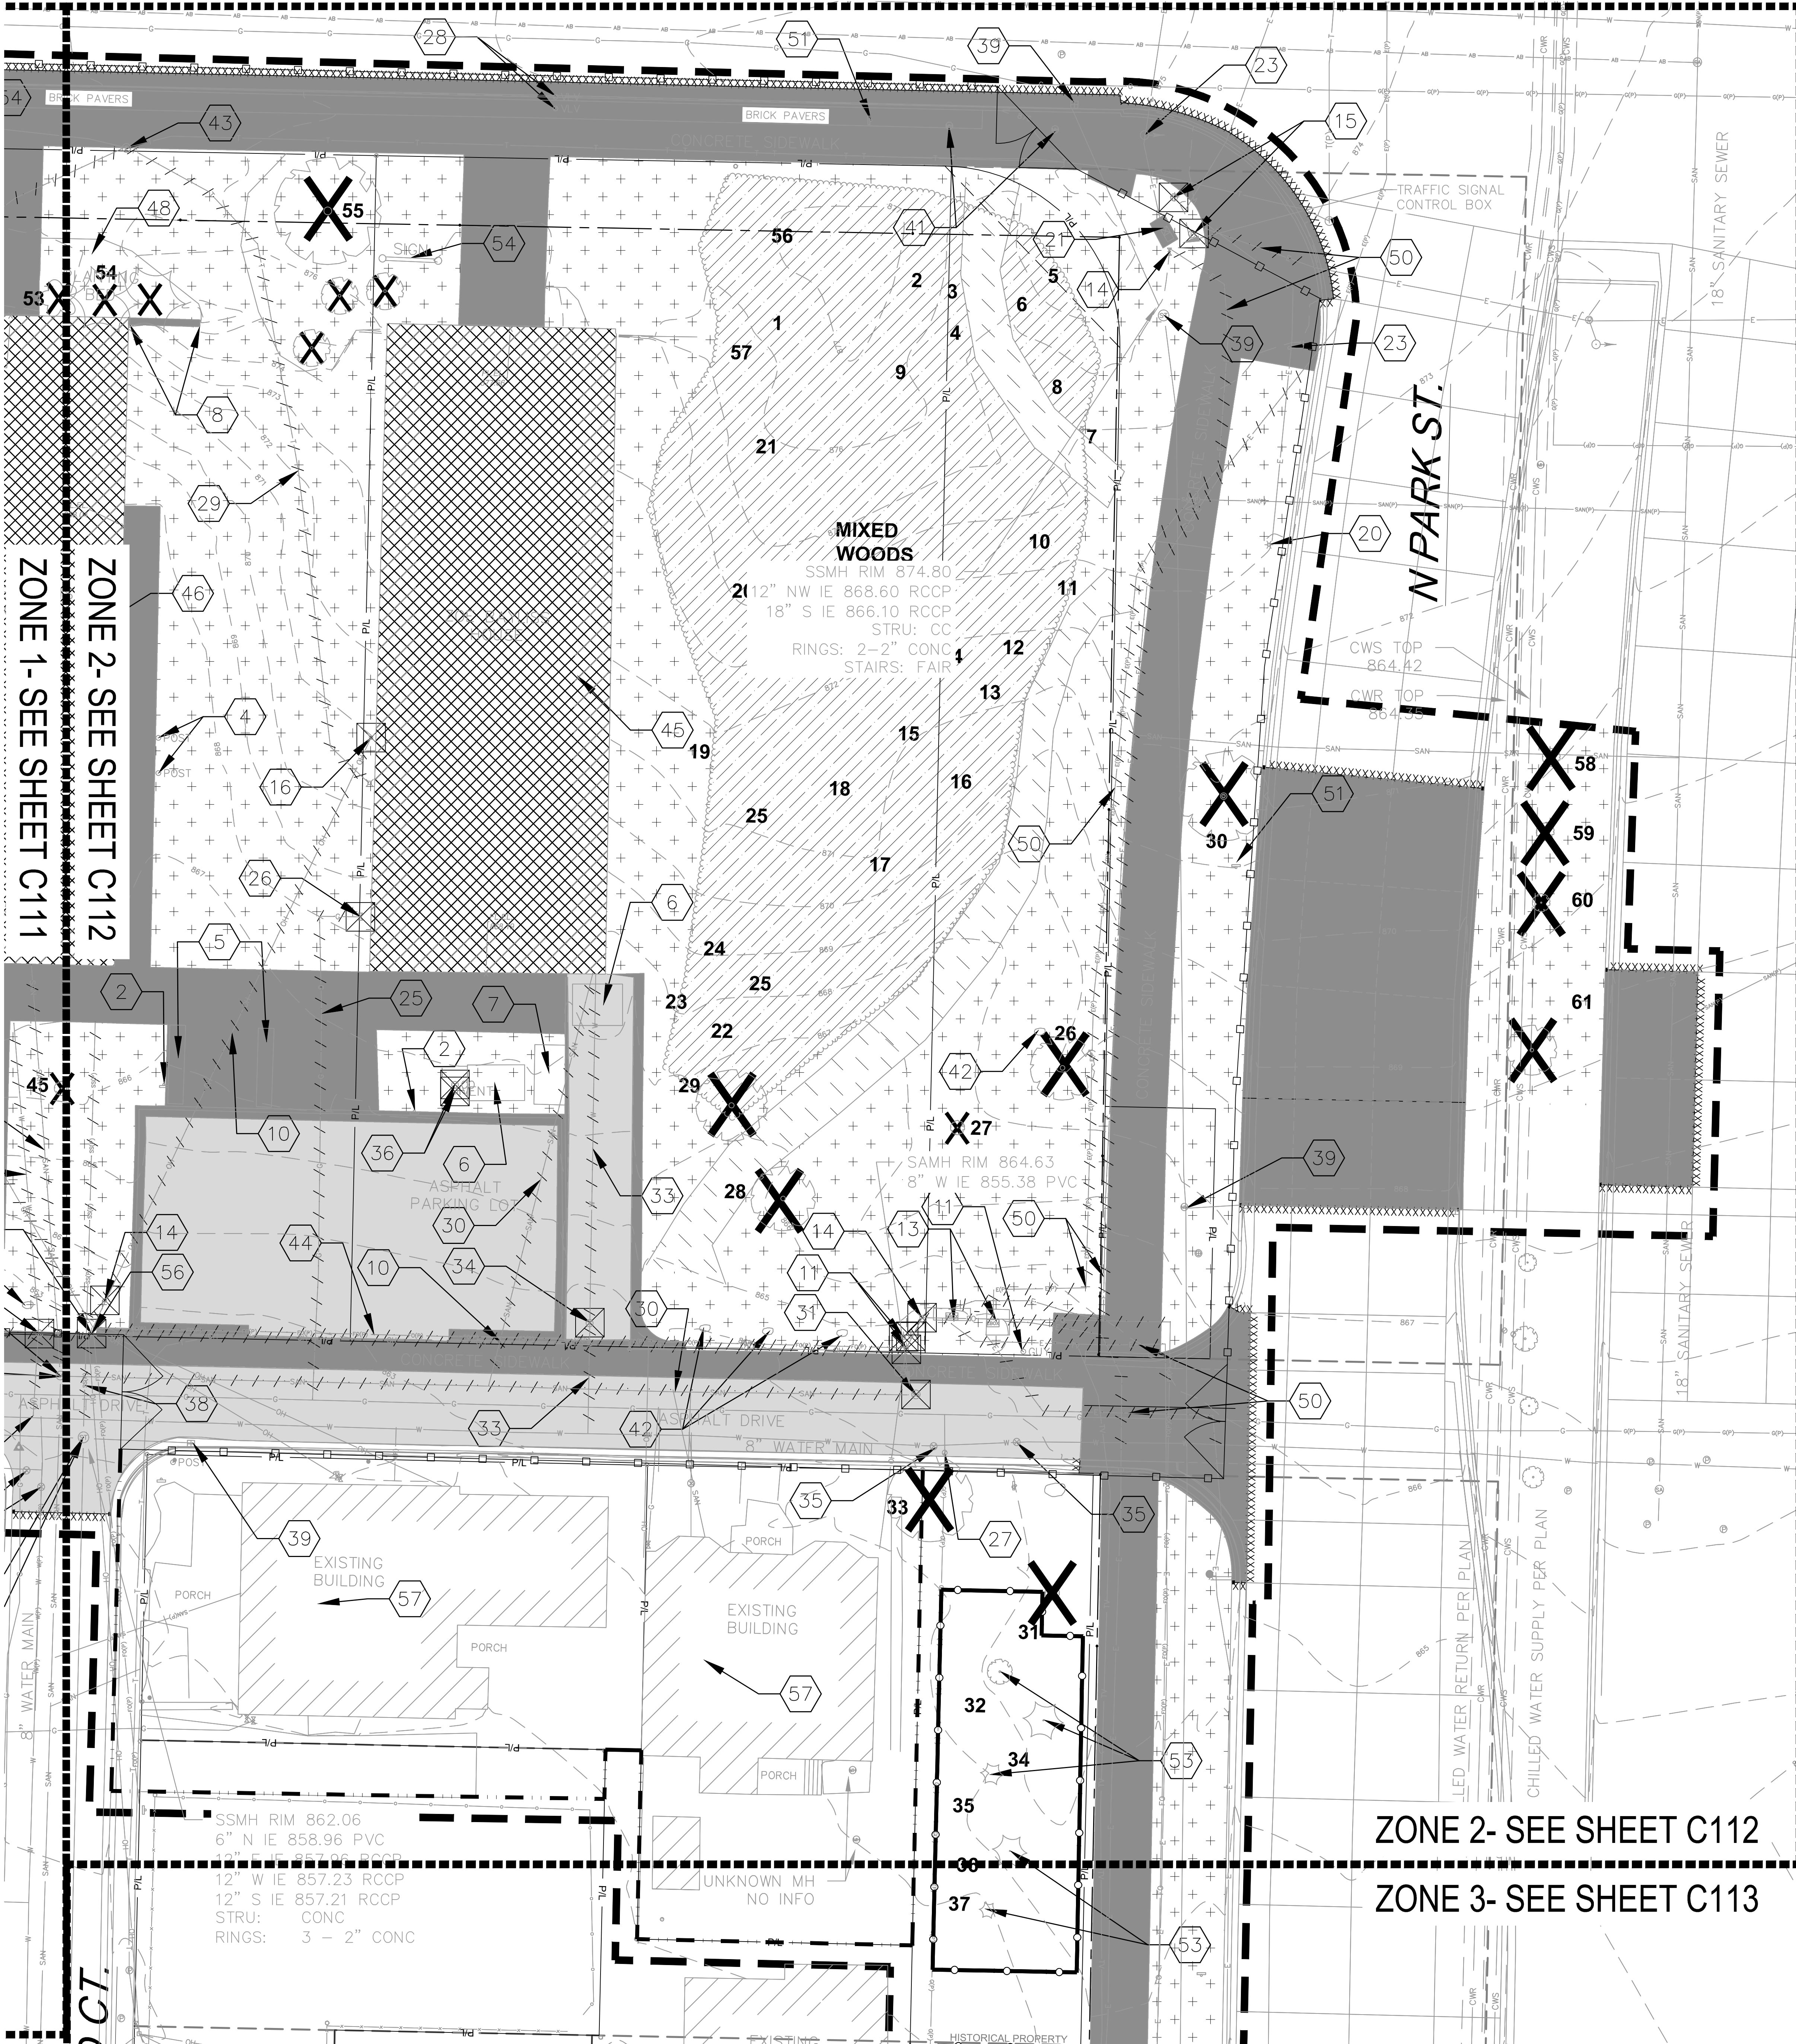


GENERAL SITE DEMOLITION NOTES

1. REFER TO SHEET C001 CIVIL GENERAL NOTES FOR GENERAL DEMOLITION, CITY FORESTRY NOTES, & EROSION CONTROL NOTES.

KEY INDEX

- PROJECT LIMITS
- VEGETATION TO BE REMOVED & DISPOSED OFFSITE. UNUSED TOPSOIL TO BE REMOVED OFFSITE. TOPSOIL THICKNESS MAY VARY. REFER TO GEOTECHNICAL REPORT.
- ASPHALT PAVEMENT & BASE MATERIAL TO BE REMOVED TO SUB-BASE & DISPOSED OFFSITE. ASPHALT PAVEMENT & BASE THICKNESS MAY VARY. REFER TO GEOTECHNICAL REPORT.
- CONCRETE & BASE MATERIAL TO BE REMOVED TO SUB-BASE & DISPOSED OFFSITE. CONCRETE & BASE THICKNESS MAY VARY. REFER TO GEOTECHNICAL REPORT.
- GRAVEL MATERIAL TO BE REMOVED & DISPOSED OFFSITE. UNUSED GRAVEL MATERIAL TO BE REMOVED OFFSITE. GRAVEL THICKNESS MAY VARY. REFER TO GEOTECHNICAL REPORT.
- CLEAR & GRUB VEGETATION, REMOVE ROOTS & STUMPS. REMOVE & DISPOSE OF OFFSITE.
- EXISTING BUILDING & FOUNDATION TO BE RAZED. REFER TO ARCHITECTURAL & STRUCTURAL DRAWINGS FOR ADDITIONAL INFORMATION.
- XXXXXXXXXX SAWCUT FULL DEPTH
- X TREES & STUMPS TO BE REMOVED
- DENOTES UTILITIES TO BE ABANDONED & REMOVED.
- AB DENOTES UTILITIES TO BE ABANDONED IN PLACE.
- ☒ -UTILITY STRUCTURE REMOVAL/ABANDONMENT
- 30 TREE CODE
- CONSTRUCTION FENCE
- CONSTRUCTION FENCE BY 20K16-02 CONTRACTOR
- TREE PROTECTION FENCING
- 1 REMOVE & SALVAGE EXISTING LIGHT POLES. RETURN TO UW MADISON. COORDINATE DELIVERY WITH UW MADISON C.P.A.
- 2 REMOVE & DISPOSE OF EXISTING SIGN INCLUDING POST & FOOTING
- 3 REMOVE & DISPOSE OF EXISTING POST & FOOTING
- 4 REMOVE AND DISPOSE OF EXISTING GRILLS.
- 5 REMOVE AND DISPOSE OF EXISTING BIKE RACKS.
- 6 REMOVE AND DISPOSE OF EXISTING TABLES.
- 7 REMOVE AND DISPOSE OF EXISTING RAISED GARDEN.
- 8 REMOVE AND DISPOSE OF EXISTING CONCRETE RETAINING WALL.
- 9 REMOVE AND DISPOSE OF EXISTING BURIED ELECTRICAL LINE.
- 10 REMOVE AND DISPOSE OF EXISTING OVERHEAD ELECTRICAL LINE. COORDINATE REMOVAL WITH MADISON GAS & ELECTRIC.
- 11 REMOVE AND DISPOSE OF EXISTING OVERHEAD POLE. COORDINATE REMOVAL WITH MADISON GAS & ELECTRIC.
- 12 REMOVE AND DISPOSE OF EXISTING GUY WIRE. COORDINATE REMOVAL WITH MADISON GAS & ELECTRIC.
- 13 REMOVE AND DISPOSE OF EXISTING ELECTRICAL BOX. ELECTRICAL BOX TO REMAIN IN SERVICE UNTIL NEW ELECTRICAL BOX IS INSTALLED. REFER TO SITE UTILITY PLANS SHEETS C500'S FOR PROPOSED ELECTRICAL BOX LOCATION. COORDINATE REMOVAL WITH MADISON GAS & ELECTRIC.
- 14 REMOVE AND DISPOSE OF EXISTING PEDESTAL. COORDINATE REMOVAL WITH MADISON GAS & ELECTRIC.
- 15 REMOVE AND DISPOSE OF EXISTING PULLEXBOX. COORDINATE REMOVAL WITH MADISON GAS & ELECTRIC.
- 16 REMOVE AND DISPOSE OF EXISTING ELECTRICAL METER.
- 17 EXISTING GUY WIRE TO REMAIN. CONTRACTOR TO PROTECT THROUGHOUT CONSTRUCTION.
- 18 EXISTING OVERHEAD POLE TO REMAIN. CONTRACTOR TO PROTECT THROUGHOUT CONSTRUCTION.
- 19 EXISTING ELECTRIC METER TO REMAIN. CONTRACTOR TO PROTECT THROUGHOUT CONSTRUCTION.
- 20 EXISTING LIGHT POLE TO REMAIN. CONTRACTOR TO PROTECT THROUGHOUT CONSTRUCTION.
- 21 REMOVE AND RELOCATE EXISTING TRAFFIC CONTROL BOX. REFER TO SITE UTILITY PLANS SHEETS C500'S FOR TEMPORARY AND PROPOSED TRAFFIC CONTROL BOX LOCATIONS.
- 22 EXISTING TRAFFIC CONTROL BOX AND ELECTRIC METER TO REMAIN. CONTRACTOR TO PROTECT THROUGHOUT CONSTRUCTION.
- 23 EXISTING TRAFFIC SIGNAL TO REMAIN. CONTRACTOR TO PROTECT THROUGHOUT CONSTRUCTION.
- 24 REMOVE AND DISPOSE OF EXISTING GAS LINE. FROM EXISTING BUILDING TO PROPERTY LINE. CAP GAS PIPE AT PROPERTY LINE. COORDINATE REMOVAL WITH MADISON GAS & ELECTRIC.
- 25 REMOVE AND DISPOSE OF GAS LATERAL TO EXISTING GAS MAIN.
- 26 REMOVE AND DISPOSE OF EXISTING GAS METER. COORDINATE REMOVAL WITH MADISON GAS & ELECTRIC.
- 27 EXISTING GAS VALVE TO REMAIN. CONTRACTOR TO PROTECT THROUGHOUT CONSTRUCTION.
- 28 EXISTING VALVE TO REMAIN. CONTRACTOR TO PROTECT THROUGHOUT CONSTRUCTION.
- 29 REMOVE AND DISPOSE OF EXISTING CHARTER TELECOMMUNICATIONS LINE TO EXISTING POLE BOX AT RIGHT OF WAY.
- 30 REMOVE AND DISPOSE OF EXISTING SANITARY SEWER PIPE.
- 31 REMOVE AND DISPOSE OF EXISTING SANITARY SEWER MANHOLE.
- 32 EXISTING SANITARY MANHOLE TO REMAIN. CONTRACTOR TO PROTECT THROUGHOUT CONSTRUCTION.
- 33 REMOVE AND DISPOSE OF EXISTING WATERMAIN.
- 34 REMOVE AND DISPOSE OF EXISTING WATER VALVE.
- 35 EXISTING WATER VALVE TO REMAIN. CONTRACTOR TO PROTECT THROUGHOUT CONSTRUCTION.
- 36 CONTRACTOR TO REMOVE AND DISPOSE OF EXISTING CLEANOUT AND PIPE.
- 37 REMOVE AND DISPOSE OF EXISTING STORM SEWER STRUCTURE.
- 38 REMOVE AND DISPOSE OF EXISTING STORM SEWER PIPE.
- 39 EXISTING STORM SEWER STRUCTURE TO REMAIN. CONTRACTOR TO PROTECT THROUGHOUT CONSTRUCTION.
- 40 CAP REMOVED PIPE AT EXISTING STRUCTURE TO REMAIN.
- 41 EXISTING MANHOLE TO REMAIN. CONTRACTOR TO PROTECT THROUGHOUT CONSTRUCTION. REFER TO C500 SHEETS FOR RIM ADJUSTMENTS.
- 42 REMOVE AND SALVAGE EXISTING BOLLERS. CONTRACTOR TO RETURN TO UW MADISON.
- 43 EXISTING PULLEXBOX TO REMAIN. CONTRACTOR TO PROTECT THROUGHOUT CONSTRUCTION.
- 44 REMOVE AND DISPOSE OF EXISTING FIBER OPTIC LINE. COORDINATE REMOVAL WITH UTILITY OWNER. CONTRACTOR TO DEMOLISH JOE BAYLESS HOUSE. REFER TO SHEETS AG10, P010 & M010 FOR MORE INFORMATION.
- 45 EXISTING PULLEXBOX TO REMAIN. CONTRACTOR TO PROTECT THROUGHOUT CONSTRUCTION.
- 46 CONTRACTOR TO DEMOLISH SUSAN B. DAVIS RESIDENCE HALL. REFER TO SHEETS AD11, P011 & M011 FOR MORE INFORMATION.
- 47 CONTRACTOR TO DEMOLISH NORTHWEST RESIDENCE BUILDING AND GARAGE.
- 48 CONTRACTOR TO REMOVE AND DISPOSE OF EXISTING PLANTING BED PLANTS AND MULCH.

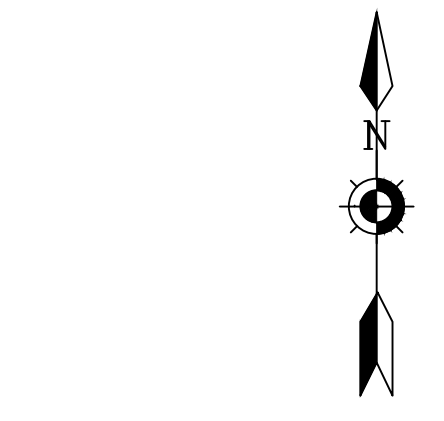

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UW LETTERS AND SCIENCE - LEVY HALL TREE SURVEY

TREE CODE	SPECIES	DBH	NOTES
1	Black Cherry	4"	Multi-stem
2	Basswood	14"	Multi-stem
3	Basswood	12"	Multi-stem
4	Basswood	10"	Multi-stem
5	Eastern Cottonwood	10"	
6	Eastern Cottonwood	10"	
7	Eastern Cottonwood	10"	
8	Sumac	4"	Multi-stem
9	Northern Hackberry	16"	
10	Sumac	6"	
11	American Elm	4"	
12	Black Cherry	4"	
13	Black Cherry	4"	
14	Black Cherry	4"	
15	Northern Red Oak	18"	
16	Basswood	12"	
17	Basswood	30"	
18	Black Walnut	18"	
19	Basswood	24"	
20	Sugar maple	18"	
21	Eastern Red Cedar	6"	
22	Basswood	18"	
23	Basswood	16"	
24	Black Walnut	16"	
25	Black Walnut	6"	
26	Northern Hackberry	24"	
27	Hop-hornbeam	4"	
28	Norway Maple	24"	
29	Basswood	18"	
30	Chinquapin Oak	2"	Within ROW
31	River Birch	8"	Multi-stem Within ROW
32	River Birch	8"	Multi-stem Within ROW
33	Basswood	30"	Multi-stem Within ROW
34	River Birch	8"	Multi-stem Within ROW
35	Arborvitae	4"	Multi-stem Within ROW
36	Arborvitae	6"	Multi-stem Within ROW
37	Arborvitae	6"	Multi-stem Within ROW
38	Arborvitae	6"	Multi-stem Within ROW
39	Arborvitae	6"	Multi-stem Within ROW
40	Arborvitae	6"	Multi-stem Within ROW
41	Elm	2"	Within ROW Removed in 15K1F 01
42	River Birch	4"	Multi-stem Within ROW Removed in 15K1F 01
43	River Birch	6"	Multi-stem Within ROW Removed in 15K1F 01
44	River Birch	8"	Multi-stem Within ROW
45	Hop-hornbeam	6"	Within ROW
46	Amur Maple	12"	Within ROW
47	Northern Hackberry	14"	Within ROW
48	Northern Hackberry	18"	Within ROW
49	Black Walnut	12"	Within ROW
50	Norway Maple	12"	Within ROW
51	Northern Hackberry	8"	Within ROW
52	Northern Hackberry	10"	Within ROW
53	Arborvitae	6"	Within ROW
54	Arborvitae	6"	Within ROW
55	Sugar Maple	36"	Within ROW
56	American Elm	12"	Within ROW
57	River Birch	6"	Within ROW
58	Crabapple	5"	Within ROW
59	Crabapple	4"	Within ROW
60	Crabapple	5"	Within ROW
61	Elm	14"	Within ROW

Thickets of young sumac, eastern cottonwood, norway maple, and black cherry. < 4"

KEY INDEX

- 49 REMOVE AND DISPOSE OF EXISTING WATERMAIN LATERAL PIPE FROM EXISTING BUILDING TO PROPERTY LINE. DRAIN, PLUG, & CAP PIPE AT PROPERTY LINE.
- 50 REMOVE AND DISPOSE OF EXISTING BURIED ELECTRICAL LINE. ELECTRICAL LINE TO REMAIN IN SERVICE UNTIL NEW ELECTRICAL LINES IS INSTALLED. REFER TO SITE UTILITY PLANS SHEETS C500'S FOR PROPOSED ELECTRICAL LINE LOCATION. COORDINATE REMOVAL WITH MADISON GAS & ELECTRIC.
- 51 EXISTING SIGN TO REMAIN. CONTRACTOR TO PROTECT THROUGHOUT CONSTRUCTION.
- 52 REMOVE AND DISPOSE OF EXISTING CONCRETE STAIRS.
- 53 EXISTING TREE TO REMAIN. CONTRACTOR TO PROTECT THROUGHOUT CONSTRUCTION.
- 54 STANDARD BUILDING ID SIGNS TO BE SALVAGED AND RETURNED TO UW MADISON FOR REUSE. REMOVED WITH CARE. CUT SIGNPOST AT TOP OF CONCRETE FOOTING. CONTRACTOR TO DELIVER SIGN TO UW HORSE BARN. COORDINATE DELIVERY WITH UW MADISON C.P.A.
- 55 EXISTING CONTROL VAULT TO REMAIN. CONTRACTOR TO PROTECT THROUGHOUT CONSTRUCTION.
- 56 CONTRACTOR TO REMOVE AND SALVAGE EXISTING LIGHT FIXTURE. REFER TO C500 SITE UTILITY PLAN SHEETS FOR PROPOSED LOCATION.
- 57 AT THE CONCLUSION OF PROJECT 20K16-02, THE -01 GENERAL CONTRACTOR SHALL BE RESPONSIBLE FOR BACKFILLING THE HOLES CREATED BY THE FOUNDATION REMOVALS OF THE THREE STRUCTURES.
- 58 REMOVE AND DISPOSE OF EXISTING SANITARY SEWER PIPE FROM EXISTING BUILDING TO PROPERTY LINE. CAP PIPE AT PROPERTY LINE.

ZONE 1- SEE SHEET C111
 ZONE 2- SEE SHEET C112


ZONE 2- SEE SHEET C112
 ZONE 3- SEE SHEET C113

SITE DEMOLITION PLAN - ZONE 2 ENLARGEMENT
 SCALE: 1"=10'-0"



consultant:
Kapur
 400 E. Wisconsin Ave.
 Milwaukee, WI 53202
 www.kapurinc.com

State of Wisconsin
 Department of Administration
 Division of Facilities Development

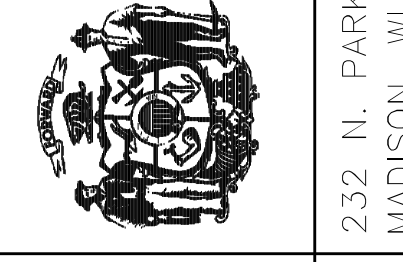

NEW ACADEMIC BUILDING
 LEVY HALL
 UNIVERSITY OF WISCONSIN - MADISON
 MADISON, WISCONSIN

232 HT. PARK ST.
 MADISON, WI 53715

GRAPHIC SCALE: 0 2.5' 5' 10' 15'

DFD Number: 20K16-01
 Set Type: LUA
 Date Issued: 05/22/2023
 Sheet Number: C112

NOTES

1. FIELD VERIFY SURVEY INFORMATION PRIOR TO START OF CONSTRUCTION AND REPORT ANY DISCREPANCIES TO THE DFD REPRESENTATIVE.
2. CONTACT DIGGER'S HOTLINE TO LOCATE ALL PUBLIC AND PRIVATE UTILITIES PRIOR TO STARTING WORK.
3. FIELD VERIFY ALL EXISTING SITE CONDITIONS AND UTILITIES PRIOR TO STARTING WORK. ANY DAMAGE CAUSED TO UTILITIES, EITHER SHOWN OR NOT, SHALL BE REPAIRED AND PAID FOR AT THE CONTRACTOR'S EXPENSE.
4. PROTECT OR RELOCATE ALL BENCHMARKS. RELOCATED BENCHMARKS TO BE INCLUDED WITH CONTRACT OR AS-BUILTS.
5. PROTECT ALL EXISTING PAVEMENTS, CURBS, UTILITIES, AND OTHER IMPROVEMENTS (TO REMAIN) FROM CONSTRUCTION ACTIVITIES. RESTORE ALL AREAS DISTURBED BY CONSTRUCTION RELATED ACTIVITIES TO EXISTING CONDITIONS AT COMPLETION OF WORK UNLESS SHOWN OTHERWISE ON PLANS.
6. CONTRACTOR IS RESPONSIBLE FOR STAKING SITE FOR HORIZONTAL AND VERTICAL ALIGNMENT.
7. ANY DEVIATION FROM THE LAYOUT AND DIMENSION SHOWN ON THIS PLAN SHALL REQUIRE APPROVAL BY THE DFD REPRESENTATIVE PRIOR TO PROCEEDING WITH MODIFICATIONS.
8. SUBMIT CONCRETE CONSTRUCTION JOINT LAYOUT PLAN ACCORDANCE WITH SECTION 32 13 13 - CONCRETE PAVING.
9. ALL DISTURBED PAVEMENT AREAS SHALL BE RESTORED WITH RIGID PAVEMENT EITHER TEMPORARILY OR PER THE FINAL PAVEMENT CONDITION AS SHOWN ON THE DRAWINGS. GRAVEL, SOIL, OR OTHER BACKFILL MATERIALS ARE NOT ACCEPTABLE.
10. CONTRACTOR SHALL TAKE PRECAUTIONS DURING CONSTRUCTION TO NOT DISFIGURE, SCAR, OR IMPAIR THE HEALTH OF ANY STREET TREE(S). CONTRACTOR SHALL OPERATE EQUIPMENT IN A MANNER AS TO NOT DAMAGE THE BRANCHES OF THE STREET TREES. THIS MAY REQUIRE USING SMALLER EQUIPMENT AND LOADING AND UNLOADING MATERIALS IN A DESIGNATED SPACE AWAY FROM TREES ON THE CONSTRUCTION SITE. ANY DAMAGE OR INJURY TO EXISTING STREET TREES (EITHER ABOVE OR BELOW GROUND) SHALL BE REPORTED IMMEDIATELY TO CITY FORESTRY AT (608) 266-4816. PENALTIES AND REMEDIATION SHALL BE REQUIRED.
11. AS DEFINED BY THE SECTION 107.13 OF CITY OF MADISON STANDARD SPECIFICATIONS FOR PUBLIC WORKS CONSTRUCTION: NO EXCAVATION IS PERMITTED WITHIN 5 FEET OF THE TRUNK OF THE STREET TREE OR WHEN CUTTING ROOTS OVER 3 INCHES IN DIAMETER. IF EXCAVATION IS NECESSARY, THE CONTRACTOR SHALL CONTACT MADISON CITY FORESTRY AT (608) 266-4816 PRIOR TO EXCAVATION. CITY OF MADISON FORESTRY PERSONNEL SHALL ASSESS THE IMPACT TO THE TREE AND TO ITS ROOT SYSTEM PRIOR TO WORK COMMENCING. TREE PROTECTION SPECIFICATIONS CAN BE FOUND ON THE FOLLOWING WEBSITE: [HTTPS://WWW.CITYOFMADISON.COM/BUSINESS/PW/SPECS.CFM](https://www.cityofmadison.com/business/pw/specs.cfm)
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13. NO LATER THAN FIVE BUSINESS DAYS PRIOR TO FORMING CONCRETE AND CONSTRUCTING TREE GRATE SITES, THE CONTRACTOR SHALL CONTACT CITY FORESTRY AT (608) 266-4816 TO IDENTIFY AND LOCATE UNDERGROUND CONFLICTS (UTILITIES, VAULTS, CONDUIT) OR OTHER UNDERGROUND OBSTRUCTIONS AND DETERMINE GRATE LOCATIONS. THE CONTRACTOR WILL BE REQUIRED TO OBTAIN THE GRATE, MATCHING FRAME AND/OR TREE GUARD. TREE GRATE TYPE AND MATCHING FRAME: NEENAH 4X8 (R-8815-A). TREE GUARD NEENAH (R-8501-4818).

LEGEND

- 8" DEPTH COMPACTED DENSE GRADED BASE
- UW ASPHALTIC CONCRETE PAVEMENT (3 C804)
- UW STANDARD DUTY CONCRETE PAVEMENT (1 C804)
- UW HEAVY DUTY CONCRETE PAVEMENT (2 C804)
- CITY OF MADISON CONCRETE PAVEMENT (4 C804)
- UNIT PAVERS, TYPE 1 CITY R.O.W. PAVERS (NON-PERMEABLE) (1 C801)
- UNIT PAVERS, TYPE 2 NON-PERMEABLE (4 C801)
- UNIT PAVERS, TYPE 2 PERMEABLE (3 C801)
- SALVAGED LIMESTONE PAVERS SEE SHEET LA100
- MODULAR SOIL VAULTS (1 C800)
- CONSTRUCTION LIMITS
- PROPERTY LINE/R.O.W.
- TREE PROTECTION FENCING
- CONSTRUCTION FENCING
- LIGHT POLES
- UTILITY INLETS & MANHOLES

BIKE PARKING SUMMARY


INTERIOR: 26 STALLS
 EXTERIOR: 248 STALLS
 TOTAL = 274 STALLS

VEHICLE PARKING SUMMARY


UW SERVICE VEHICLES:
 2 STALLS

LAND USE SUMMARY

	Levy Hall		923 Clymer Pl.		209 Bernard Ct. & 911 Clymer Pl.		All Lots Total	
	SF	Acres	SF	Acres	SF	Acres	SF	Acres
Lot Size	47347	1.09	3149	0.07	5352	0.12	55848	1.28
Existing Site Impervious	21258	0.49	2320	0.05	3224	0.08	26802	0.62
Existing Building Coverage	7344	0.17	1360	0.03	2808	0.06	11512	0.26
Proposed Site Impervious	41729	0.96	1629	0.04	1366	0.03	44724	1.03
Proposed Building Coverage	31557	0.72	0	0.00	0	0.00	31557	0.72
Useable Open Space	5618	0.13	1520	0.03	3986	0.09	11124	0.26
Total Disturbed Area							89787	2.06

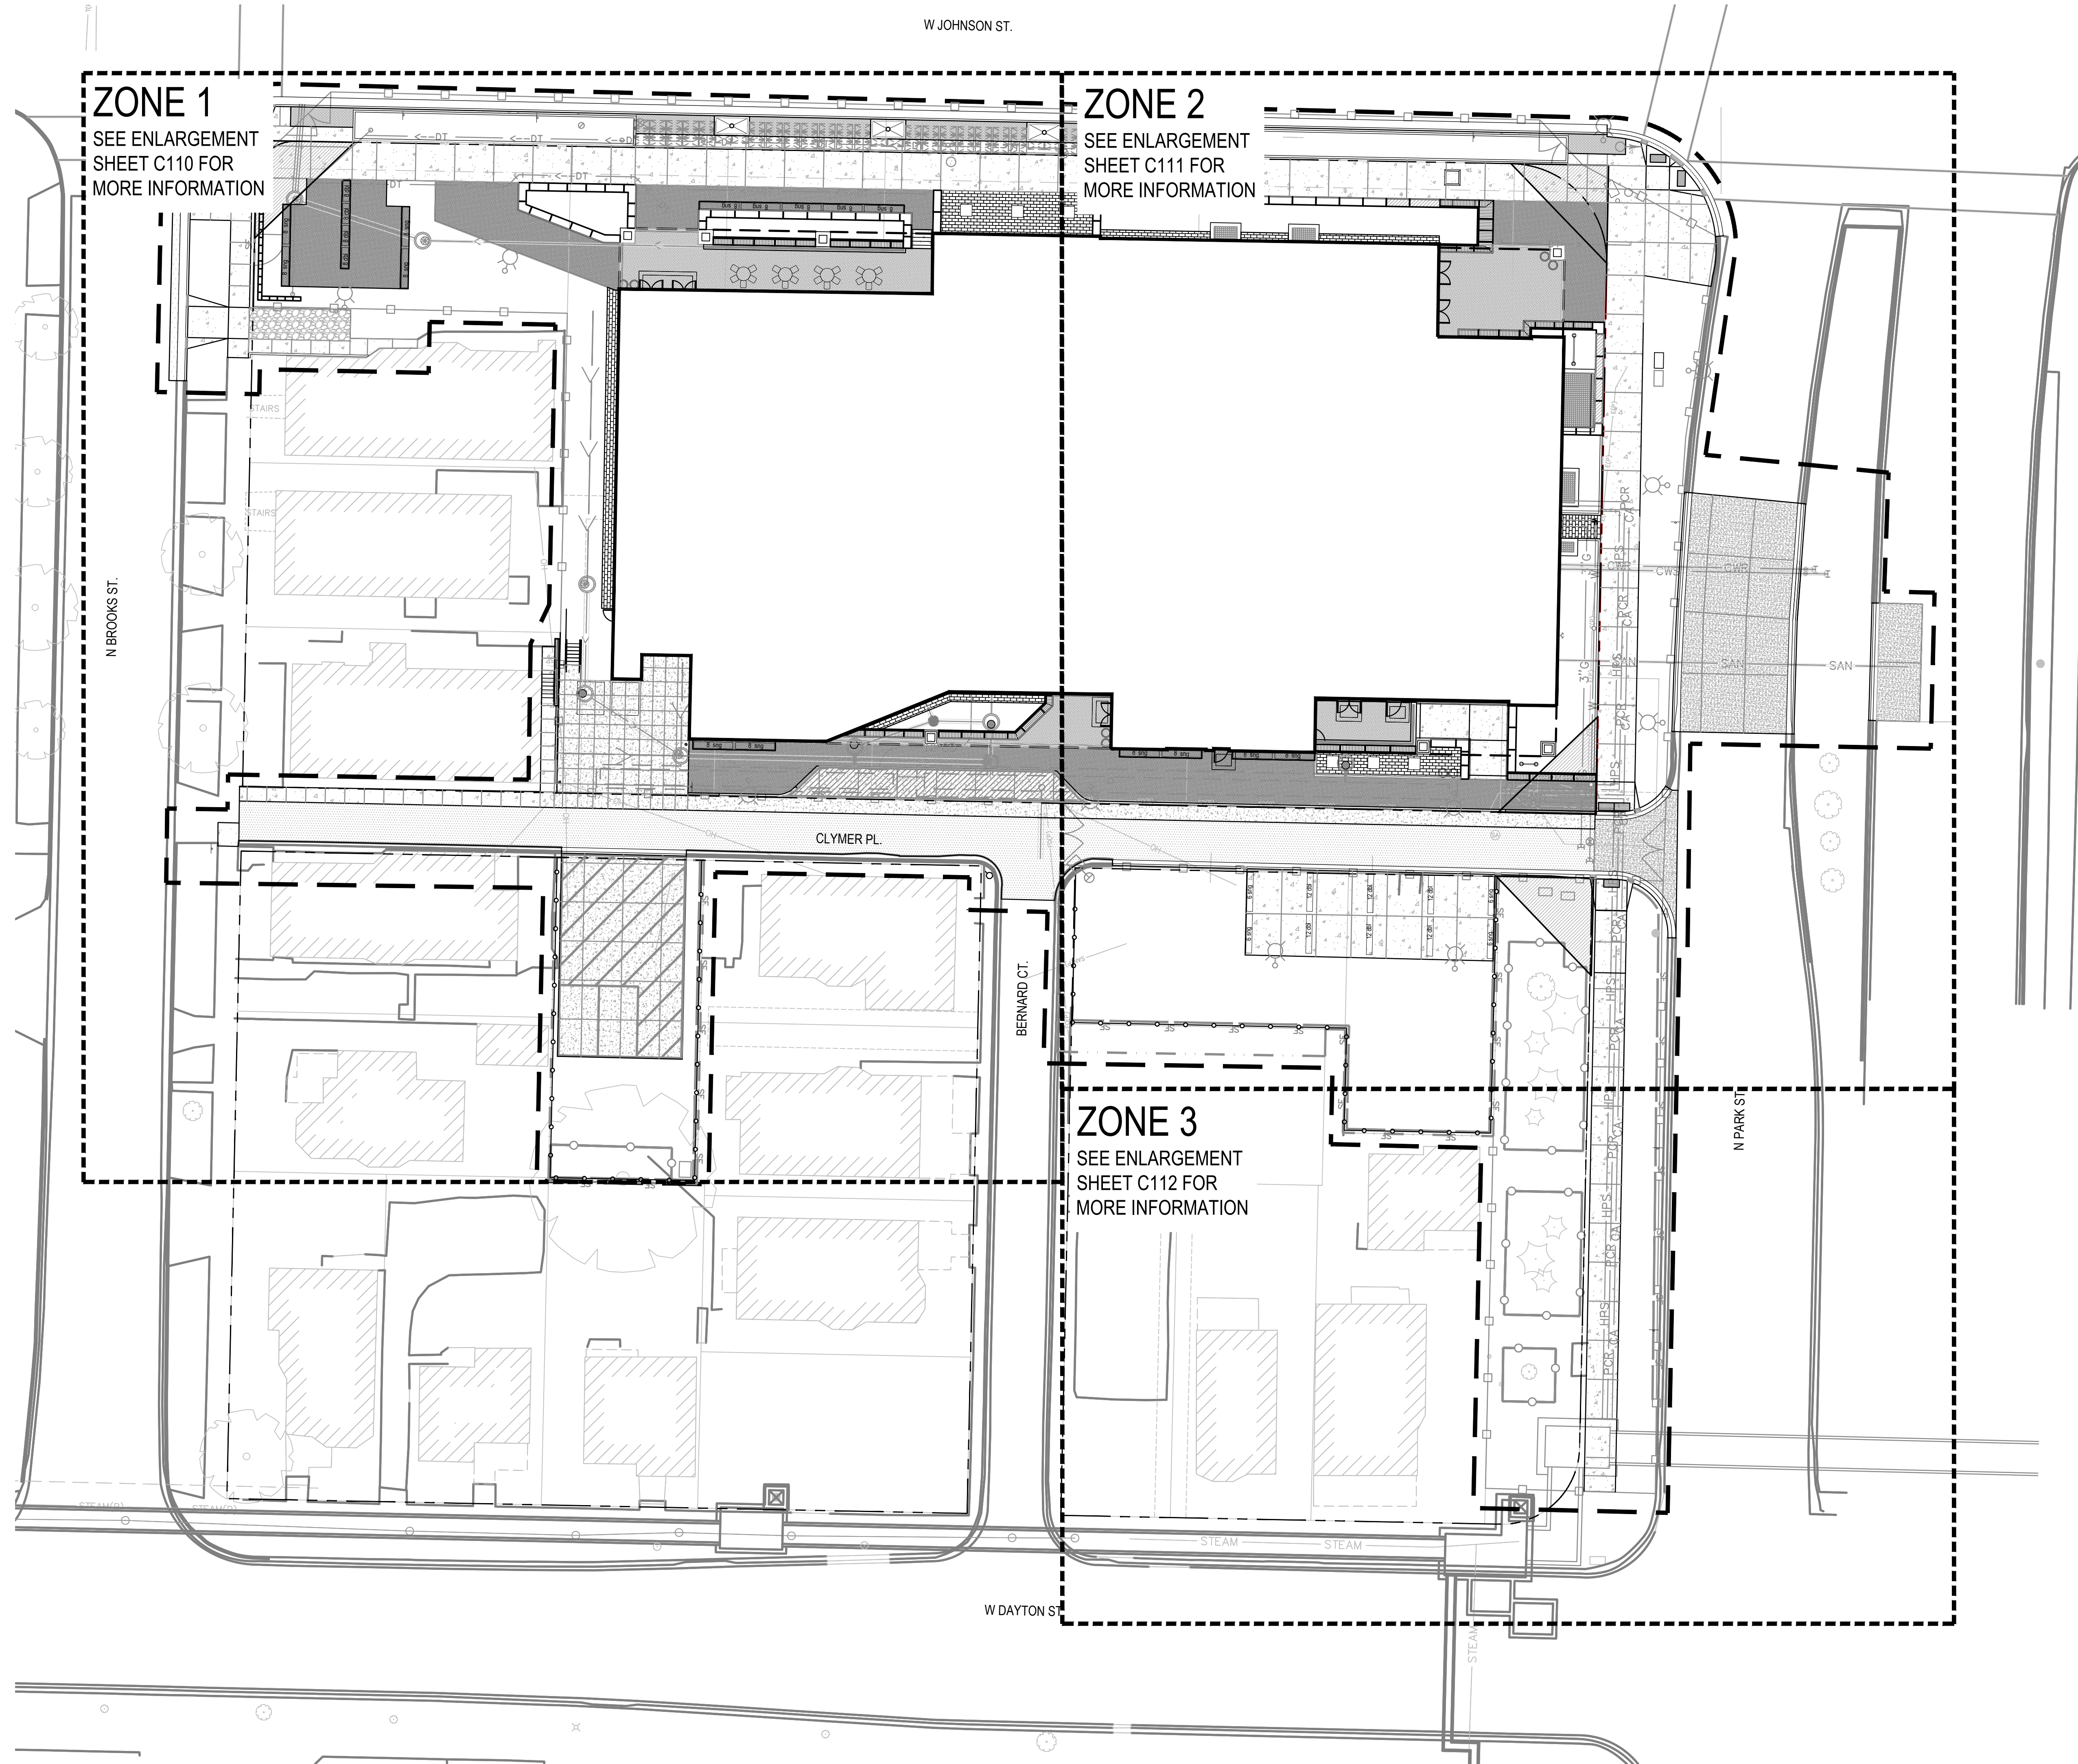

1 SITE LAYOUT PLAN - OVERALL
 SCALE: 1"=20'-0"

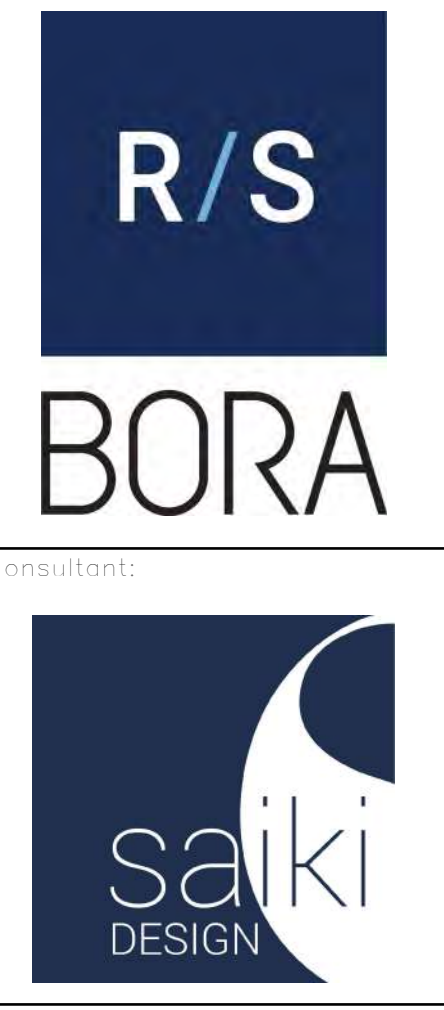

State of Wisconsin
 Department of Administration
 Division of Facilities Development

232 N. PARK ST.
 MADISON, WI 53715

NEW ACADEMIC BUILDING
 LEVY HALL
 UNIVERSITY OF WISCONSIN - MADISON
 MADISON, WISCONSIN

SITE LAYOUT PLAN - OVERALL

Revisions:

No.	Date	Description


Graphic Scale: 1" = 20'

DFD Number: 20K1G-01

Set Type: LUA

Date Issued: 05/22/2023


Sheet Number: **C200**

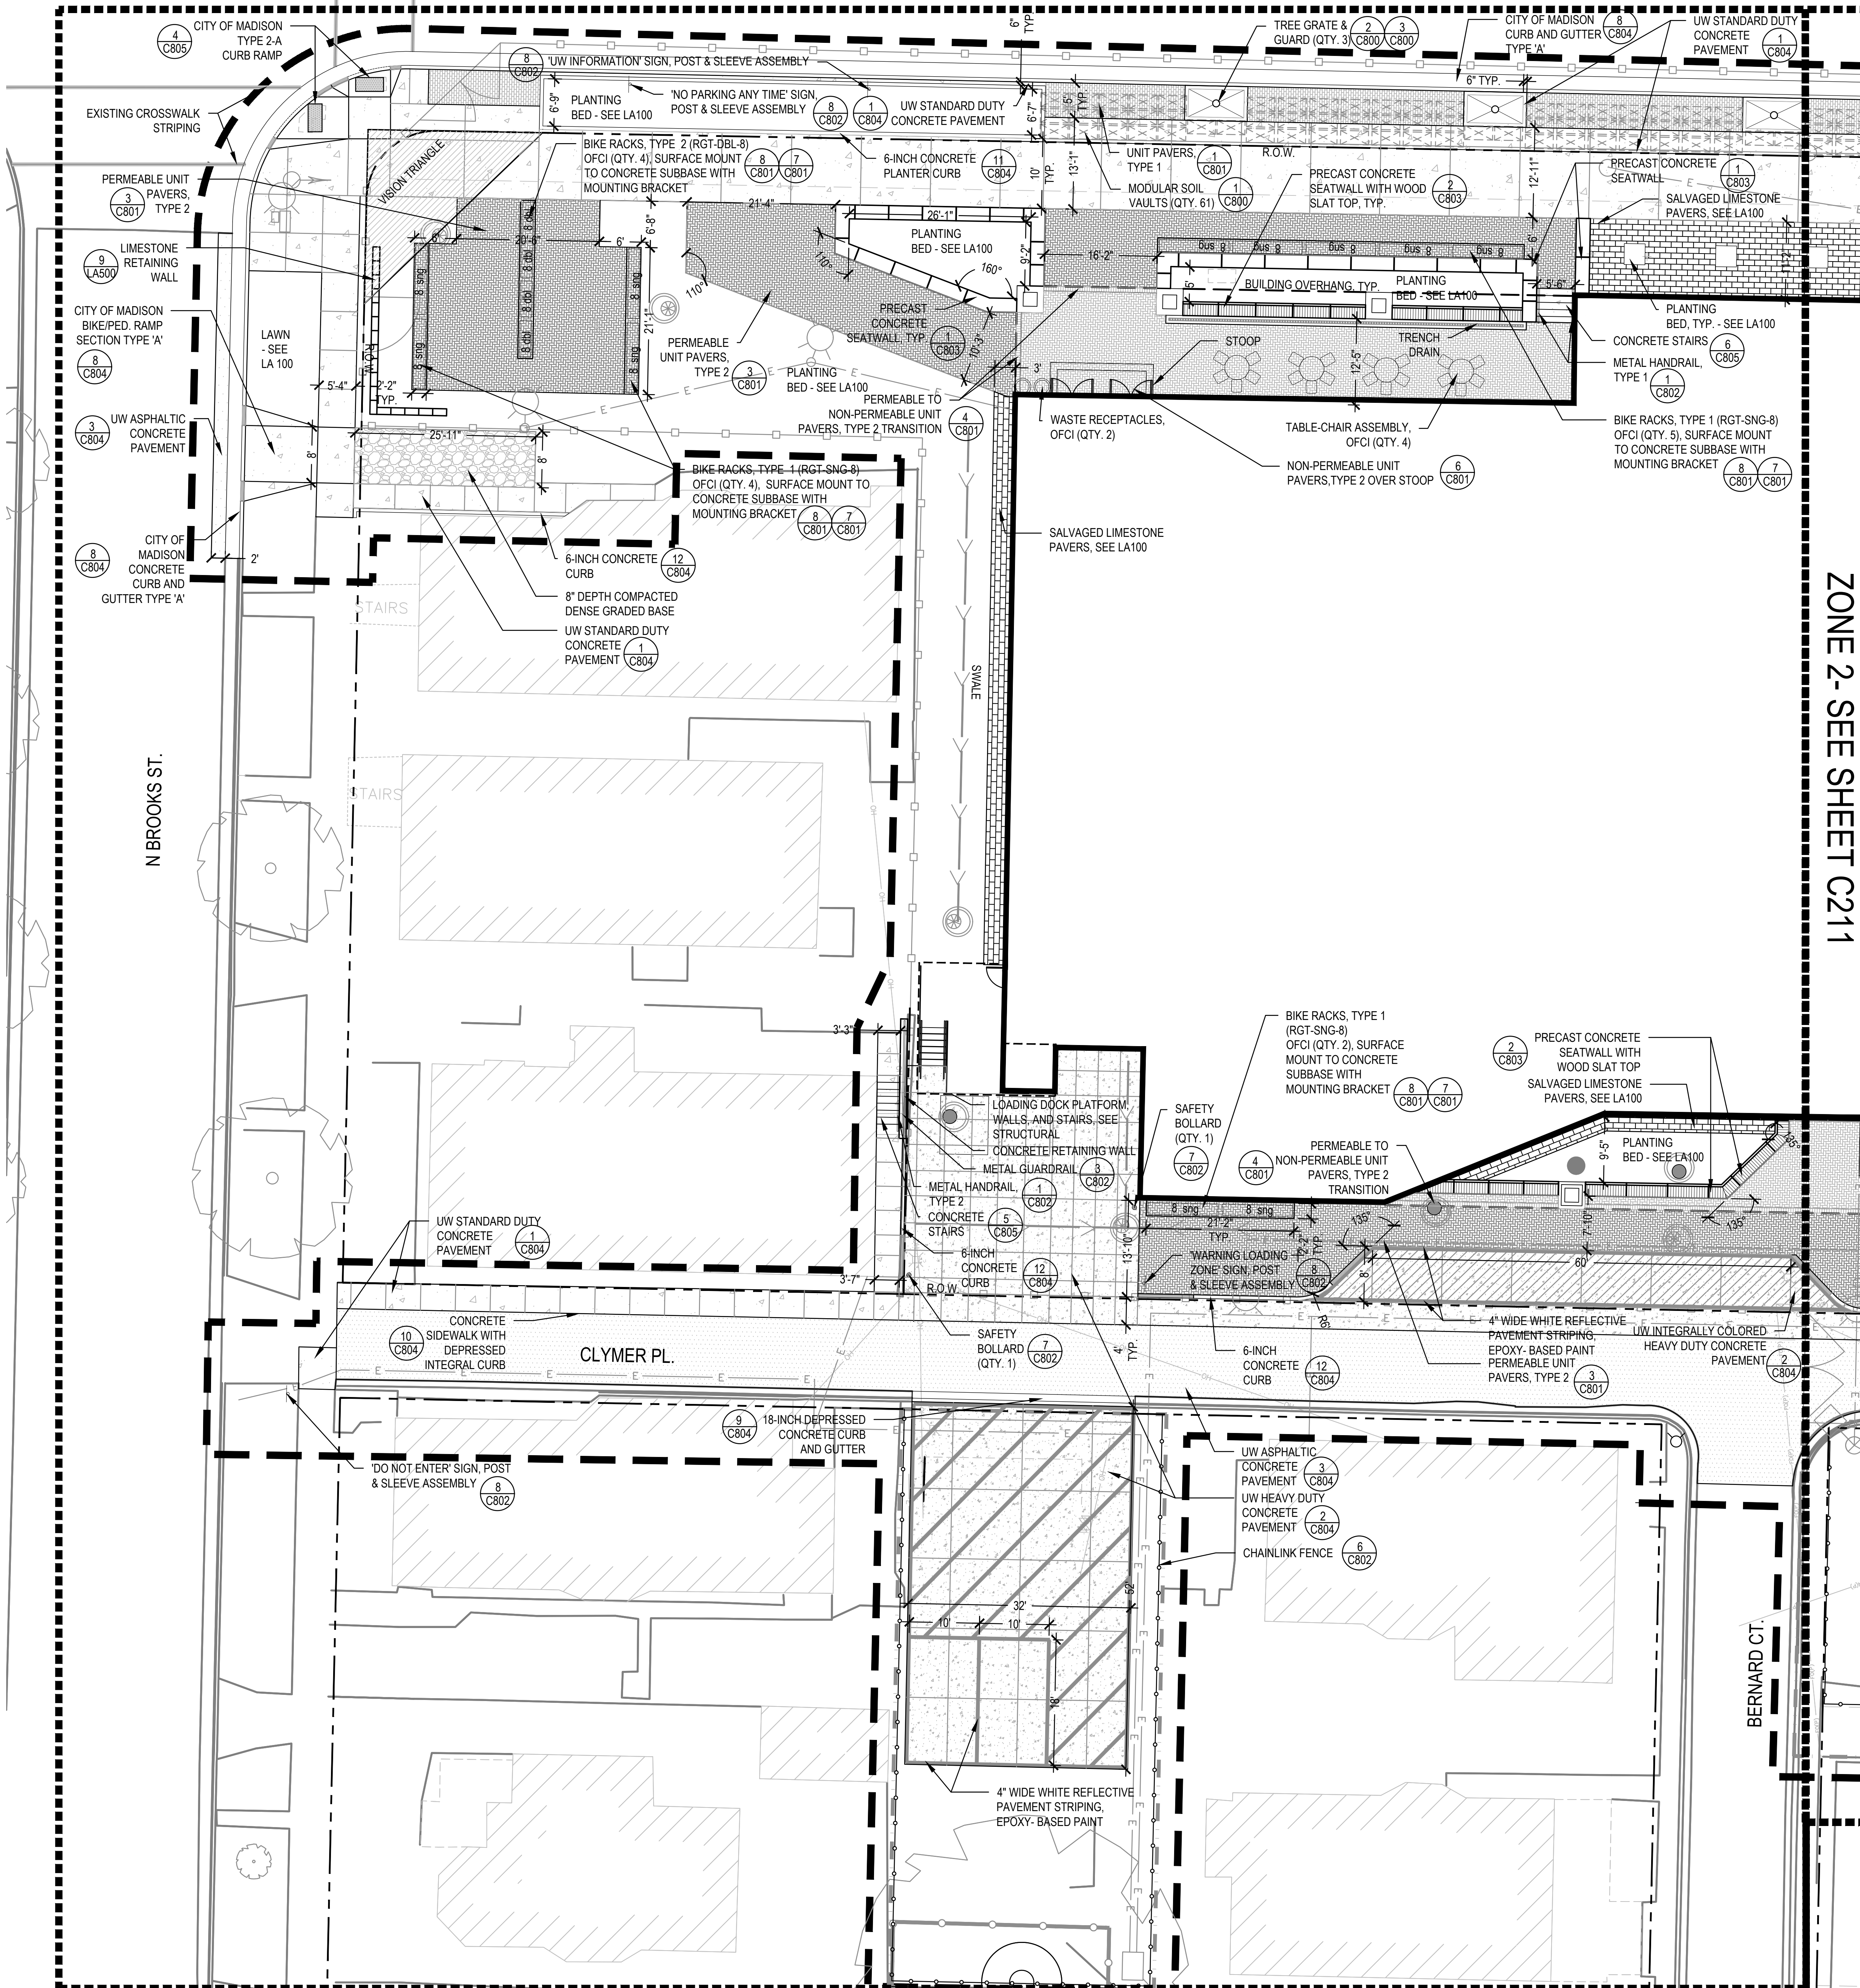

NOTES

- FIELD VERIFY SURVEY INFORMATION PRIOR TO START OF CONSTRUCTION AND REPORT ANY DISCREPANCIES TO THE DFD REPRESENTATIVE.
- CONTACT DIGGER'S HOTLINE TO LOCATE ALL PUBLIC AND PRIVATE UTILITIES PRIOR TO STARTING WORK.
- FIELD VERIFY ALL EXISTING SITE CONDITIONS AND UTILITIES PRIOR TO STARTING WORK. ANY DAMAGE CAUSED TO UTILITIES, EITHER SHOWN OR NOT, SHALL BE REPAIRED AND PAID FOR AT THE CONTRACTOR'S EXPENSE.
- PROTECT ALL BENCHMARKS.
- PROTECT ALL EXISTING PAVEMENTS, CURBS, UTILITIES, AND OTHER IMPROVEMENTS (TO REMAIN) FROM CONSTRUCTION ACTIVITIES. RESTORE ALL AREAS DISTURBED BY CONSTRUCTION RELATED ACTIVITIES TO EXISTING CONDITIONS AT COMPLETION OF WORK UNLESS SHOWN OTHERWISE ON PLANS.
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LEGEND

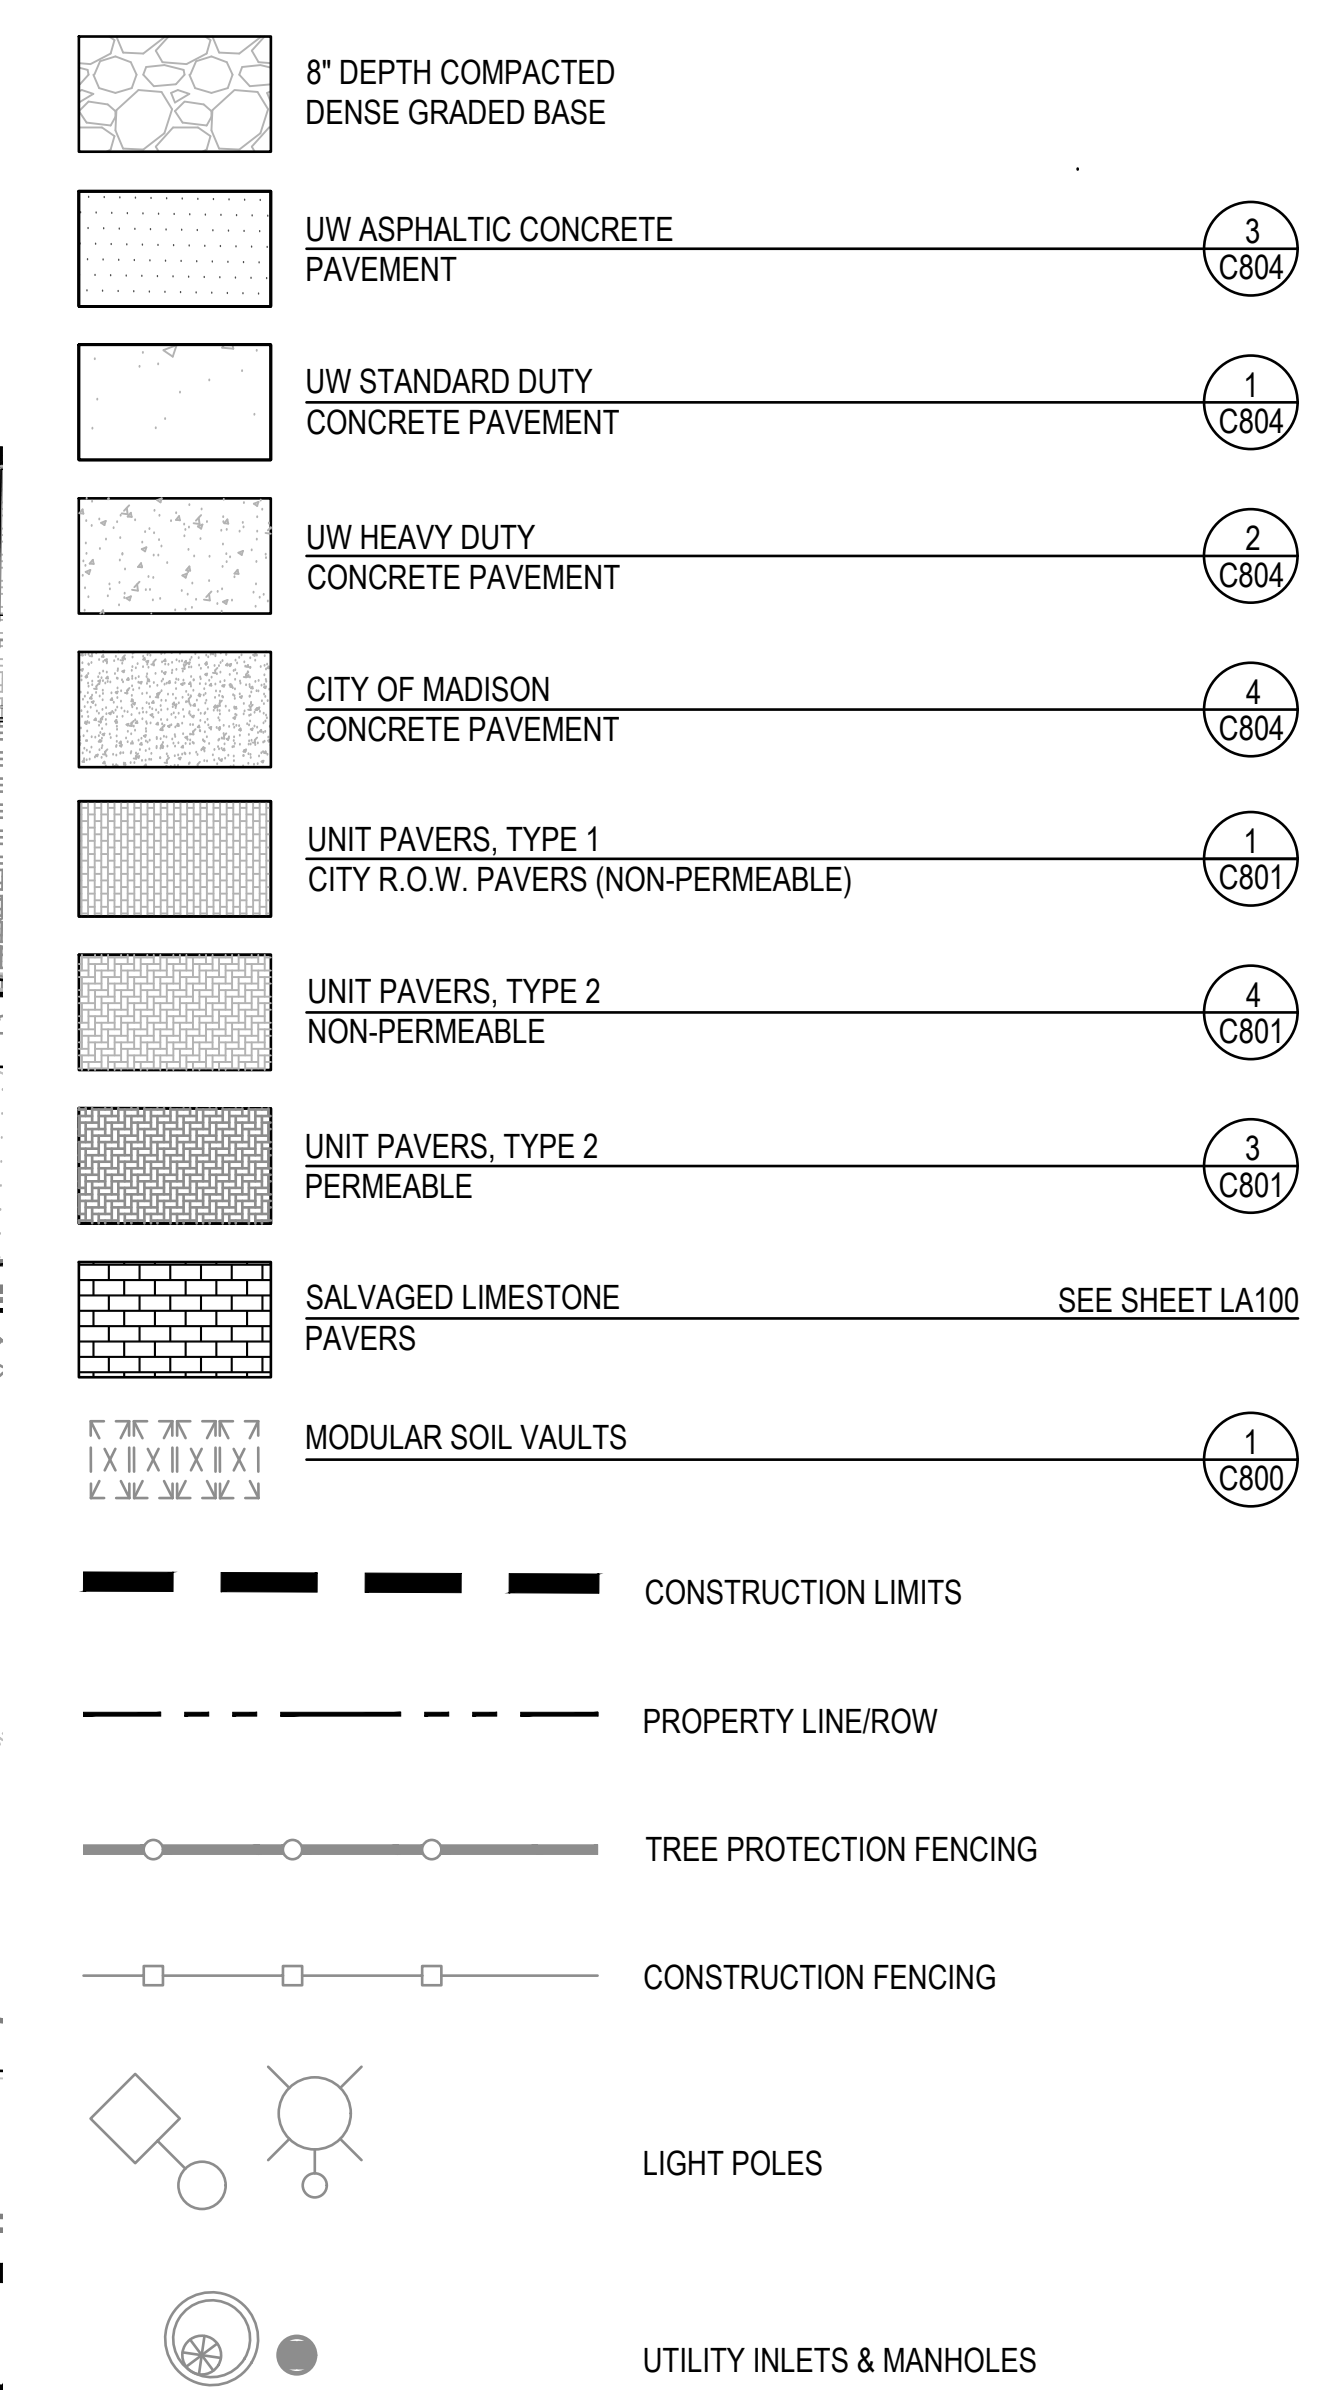


ZONE 2- SEE SHEET C211

1 SITE LAYOUT PLAN - ZONE 1 ENLARGEMENT
SCALE: 1"=10'-0"

Revisions:		
No.	Date	Description

Graphic Scale	0 10
DFD Number	20K1G-01
Set Type	LUA
Date Issued	05/22/2023
Sheet Number	C210

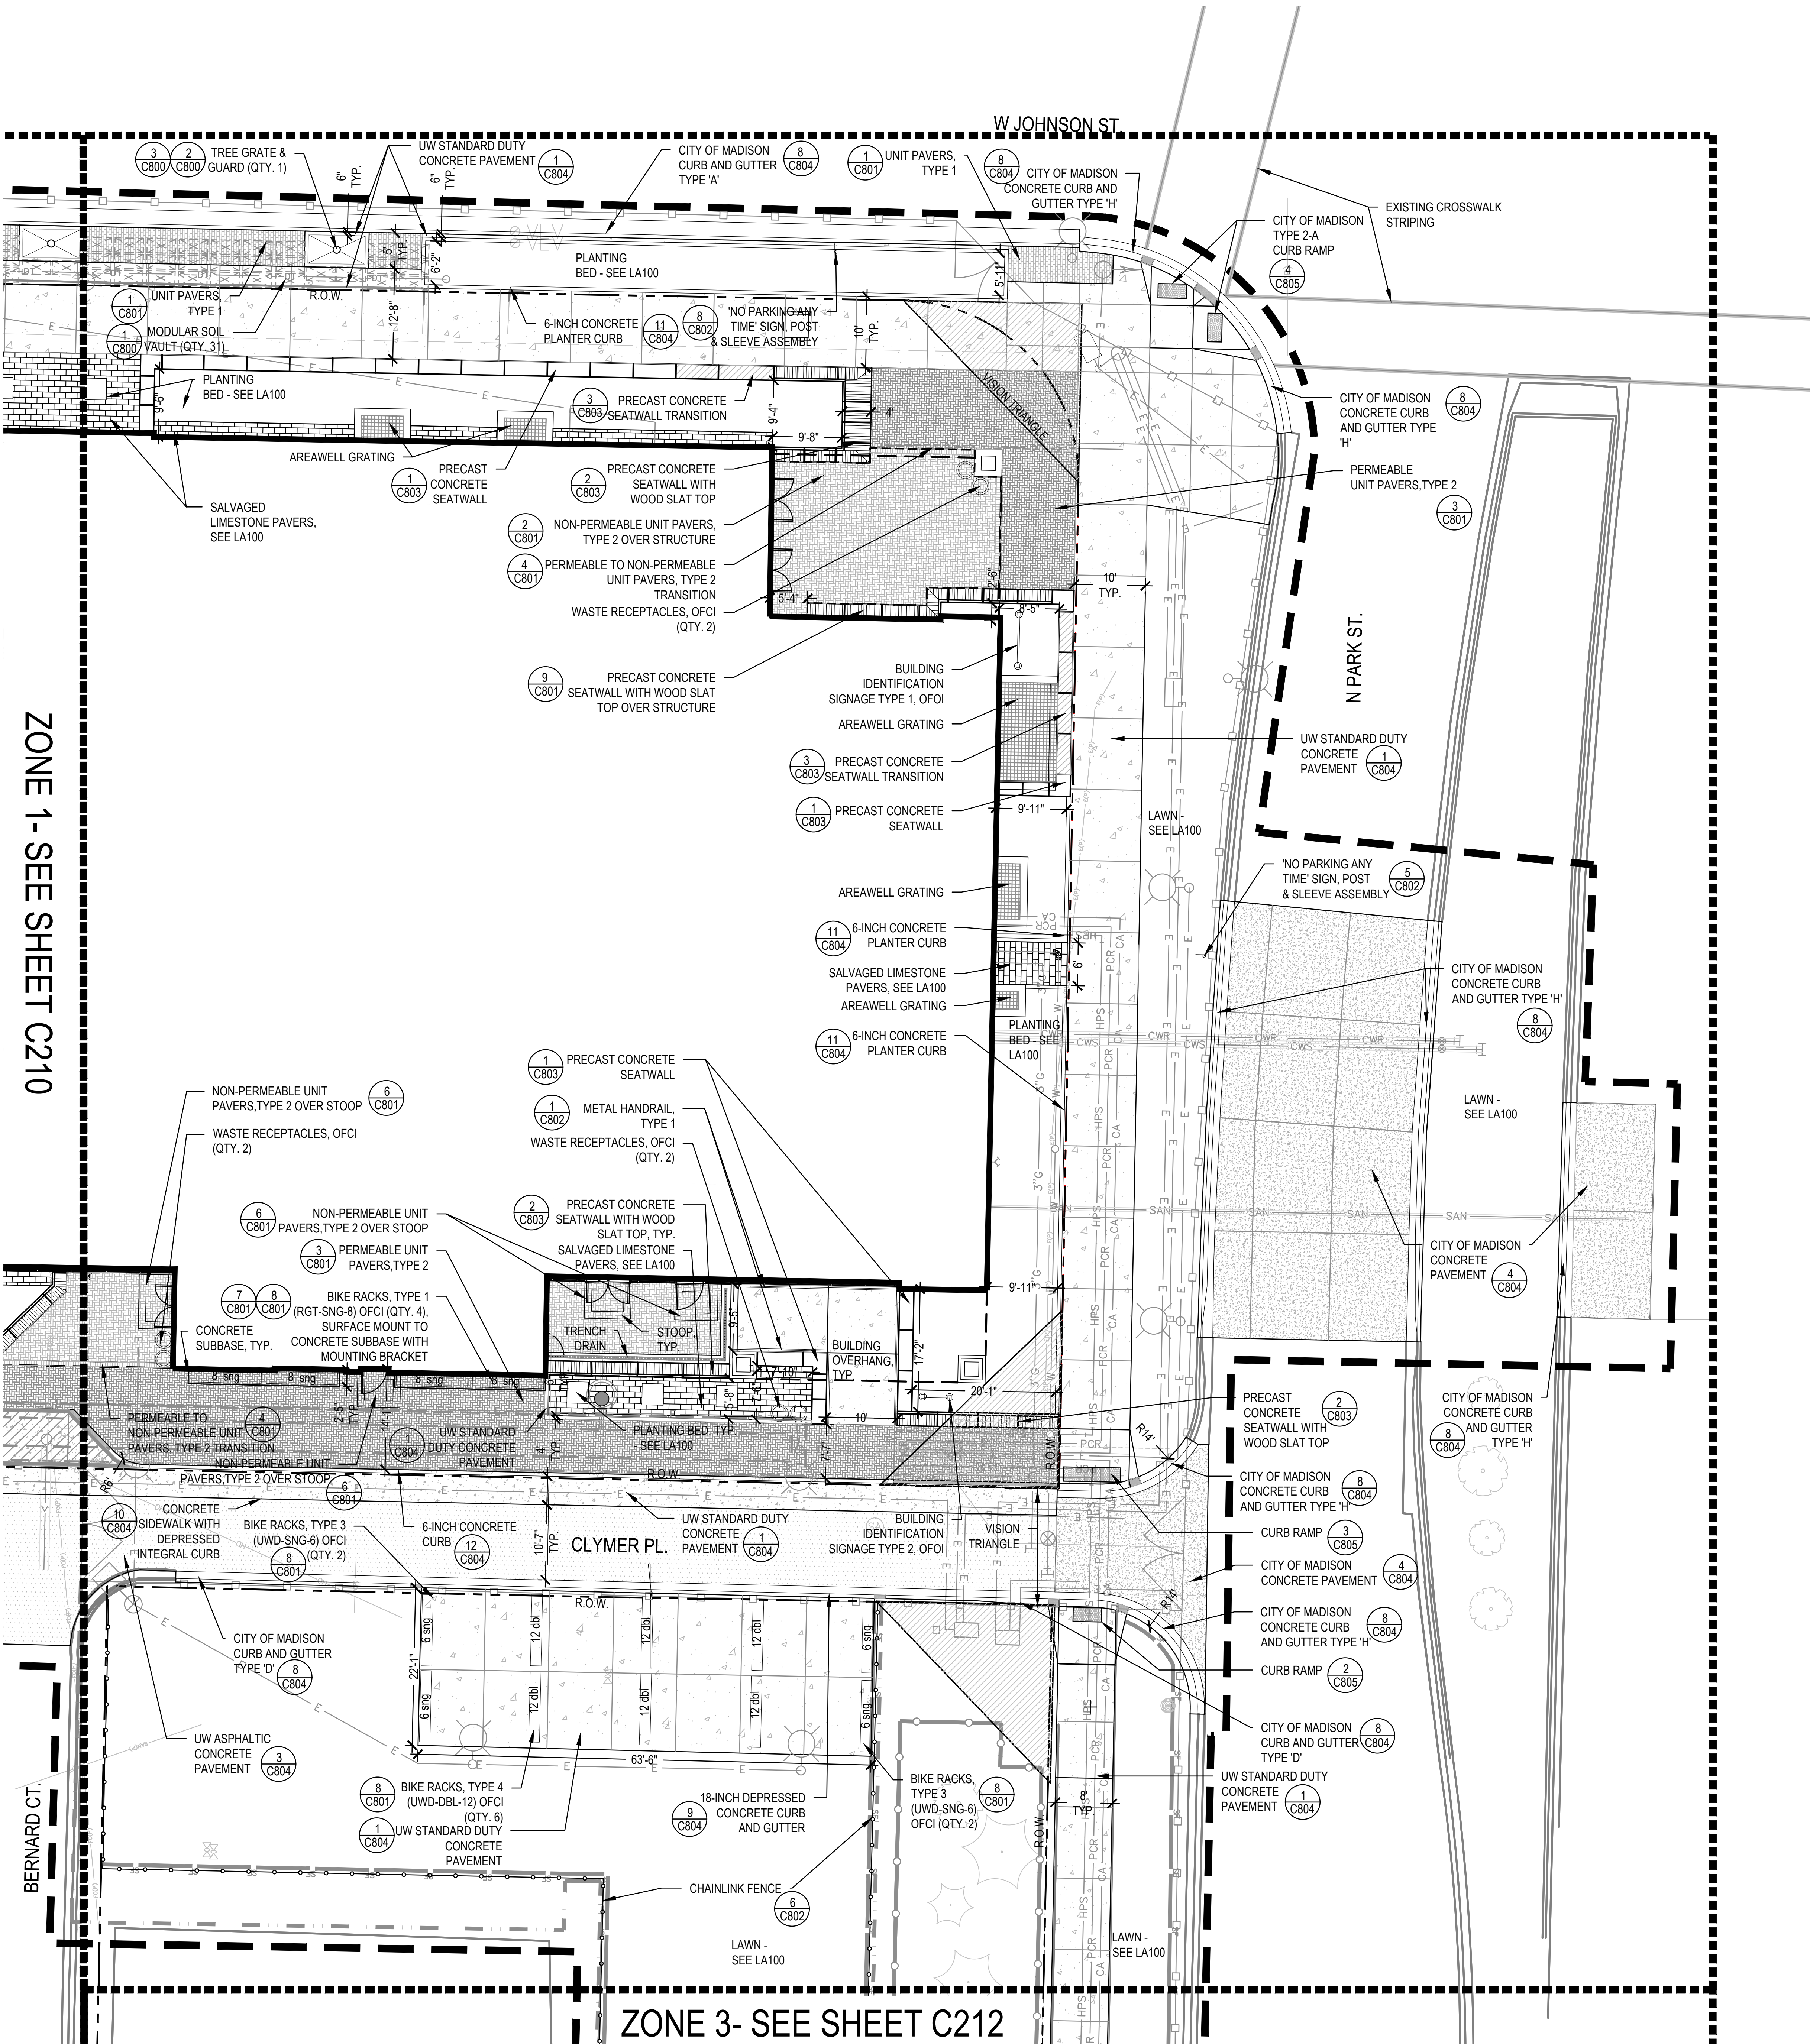

ZONE 1- SEE SHEET C210

ZONE 3- SEE SHEET C212

1 SITE LAYOUT PLAN - ZONE 2 ENLARGEMENT
SCALE: 1"=10'-0"

NOTES


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2. CONTACT DIGGER'S HOTLINE TO LOCATE ALL PUBLIC AND PRIVATE UTILITIES PRIOR TO STARTING WORK.
3. FIELD VERIFY ALL EXISTING SITE CONDITIONS AND UTILITIES PRIOR TO STARTING WORK. ANY DAMAGE CAUSED TO UTILITIES, EITHER SHOWN OR NOT, SHALL BE REPAIRED AND PAID FOR AT THE CONTRACTOR'S EXPENSE.
4. PROTECT ALL BENCHMARKS.
5. PROTECT ALL EXISTING PAVEMENTS, CURBS, UTILITIES, AND OTHER IMPROVEMENTS (TO REMAIN) FROM CONSTRUCTION ACTIVITIES. RESTORE ALL AREAS DISTURBED BY CONSTRUCTION RELATED ACTIVITIES TO EXISTING CONDITIONS AT COMPLETION OF WORK UNLESS SHOWN OTHERWISE ON PLANS.
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LEGEND

- - UW ASPHALTIC CONCRETE PAVEMENT 3 C804
 - UW STANDARD DUTY CONCRETE PAVEMENT 1 C804
 - UW HEAVY DUTY CONCRETE PAVEMENT 2 C804
 - CITY OF MADISON CONCRETE PAVEMENT 4 C804
 - UNIT PAVERS, TYPE 1 1 C801
 - UNIT PAVERS, TYPE 2 NON-PERMEABLE 4 C801
 - UNIT PAVERS, TYPE 2 PERMEABLE 3 C801
 - SALVAGED LIMESTONE PAVERS SEE SHEET LA100
 - MODULAR SOIL VAULTS 1 C800
-
- CONSTRUCTION LIMITS
 - PROPERTY LINE/ROW
 - TREE PROTECTION FENCING
 - CONSTRUCTION FENCING
 - LIGHT POLES
 - UTILITY INLETS & MANHOLES

NOTES

- FIELD VERIFY SURVEY INFORMATION PRIOR TO START OF CONSTRUCTION AND REPORT ANY DISCREPANCIES TO THE DFD CONSTRUCTION REPRESENTATIVE.
- CONTACT DIGGER'S HOTLINE, CITY OF MADISON, AND UW-MADISON TO LOCATE ALL PUBLIC AND PRIVATE UTILITIES PRIOR TO STARTING WORK.
- FIELD VERIFY ALL EXISTING SITE CONDITIONS AND UTILITIES PRIOR TO STARTING WORK. ANY DAMAGE CAUSED TO UTILITIES, EITHER SHOWN OR NOT, SHALL BE REPAIRED AND PAID FOR AT THE CONTRACTOR'S EXPENSE.
- PROTECT OR RELOCATE ALL BENCHMARKS. RELOCATED BENCHMARKS TO BE INCLUDED WITH CONTRACTOR.
- PROTECT ALL EXISTING PAVEMENTS, CURBS, UTILITIES, AND OTHER IMPROVEMENTS (TO REMAIN) FROM CONSTRUCTION ACTIVITIES. RESTORE ALL AREAS DISTURBED BY CONSTRUCTION RELATED ACTIVITIES TO EXISTING CONDITIONS AT COMPLETION OF WORK UNLESS SHOWN OTHERWISE ON PLANS.
- SUBMIT TOPSOIL TESTING REQUIREMENTS PER SECTION 32 91 13 SOIL PREPARATION.
- VERIFY THAT SPECIFIED TOPSOIL AND PLANTING MIXTURE DEPTHS ARE PRESENT PRIOR TO PLANTING PER SECTIONS 32 91 13 SOIL PREPARATION. NOTIFY DFD CONSTRUCTION REPRESENTATIVE OF ANY PROBLEMS.
- SPACE PLANTINGS PER PLANT SCHEDULE.
- ALL WRAPPINGS, WIRE BASKETS, BURLAP, AND OTHER MISCELLANEOUS MATERIAL SHALL BE COMPLETELY REMOVED FROM ALL SHRUB AND TREE ROOT BALLS PRIOR TO INSTALLATION.
- ALL EXISTING LAWN AREAS WITHIN AND ADJACENT TO THE PROJECT SITE THAT ARE DISTURBED BY CONSTRUCTION ACTIVITIES INCLUDING, BUT NOT LIMITED TO, UTILITY TRENCHING, ACCESS, OR MATERIALS STORAGE SHALL BE REPAIRED WITH SOD PER SECTION 32 92 23 SODDING.
- APPLY MYCHROIZAL FUNGI TO ALL PLANTINGS PER SECTION 32 92 00 PLANTS.
- CONTRACTOR SHALL TAKE PRECAUTIONS DURING CONSTRUCTION TO NOT DISFIGURE, SCAR, OR IMPAIR THE HEALTH OF ANY STREET TREE. CONTRACTOR SHALL OPERATE EQUIPMENT IN A MANNER AS TO NOT DAMAGE THE BRANCHES OF THE STREET TREE(S). THIS MAY REQUIRE USING SMALLER EQUIPMENT AND LOADING AND UNLOADING MATERIALS IN A DESIGNATED SPACE AWAY FROM TREES ON THE CONSTRUCTION SITE. ANY DAMAGE OR INJURY TO EXISTING STREET TREES (EITHER ABOVE OR BELOW GROUND) SHALL BE REPORTED IMMEDIATELY TO CITY FORESTRY AT (608) 266-4816. PENALTIES AND REMEDIATION SHALL BE REQUIRED.
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- STREET TREE PRUNING SHALL BE COORDINATED WITH CITY FORESTRY AT A MINIMUM OF TWO WEEKS PRIOR TO THE START OF CONSTRUCTION FOR THIS PROJECT. CONTACT CITY FORESTRY AT (608)266-4816. ALL PRUNING SHALL FOLLOW THE AMERICAN NATIONAL STANDARDS INSTITUTE (ANSI) A300 - PART 1 STANDARDS FOR PRUNING.
- CONTRACTOR SHALL CONTACT CITY FORESTRY AT (608) 266-4816 TO SCHEDULE INSPECTION AND APPROVAL OF NURSERY TREE STOCK AND REVIEW PLANTING SPECIFICATIONS WITH THE LANDSCAPER AT LEAST ONE WEEK PRIOR TO STREET TREE PLANTING.
- NO LATER THAN FIVE BUSINESS DAYS PRIOR TO FORMING CONCRETE AND CONSTRUCTING TREE GRATE SITES, THE CONTRACTOR SHALL CONTACT CITY FORESTRY AT (608) 266-4816 TO IDENTIFY AND LOCATE UNDERGROUND CONFLICTS (UTILITIES, WALLS, CONDUIT) OR OTHER UNDERGROUND OBSTRUCTIONS AND DETERMINE GRATE LOCATIONS. THE CONTRACTOR WILL BE REQUIRED TO OBTAIN THE GRATE, MATCHING FRAME AND/OR TREE GUARD. TREE GRATE TYPE AND MATCHING FRAME: NENAH 4X8 (R-8815-A), TREE GUARD NENAH (R-8501-4818).
- CITY FORESTRY WILL ISSUE A STREET TREE REMOVAL PERMIT FOR SIX TREES: ONE 2" OAK & ONE 2" ELM WITHIN WEST SIDE OF NORTH PARK STREET TERRACE, TWO 5" CRABAPPLES, ONE 4" CRABAPPLE & ONE 14" ELM WITHIN THE CENTER MEDIAN OF NORTH PARK STREET DUE TO UNDERGROUND UTILITY INSTALLATION. THE CONTRACTOR SHALL CONTACT CITY FORESTRY AT (608) 266-4816 TO OBTAIN PERMIT
- ANY ADDITIONAL STREET TREE REMOVALS REQUESTED WILL REQUIRE A MINIMUM OF A 72-HOUR REVIEW PERIOD WHICH SHALL INCLUDE THE NOTIFICATION OF THE ALDERPERSON WITHIN WHO'S DISTRICT IS AFFECTED BY THE STREET TREE REMOVAL(S) PRIOR TO AN ADDITIONAL STREET TREE REMOVAL PERMIT BEING ISSUED BY CITY FORESTRY.
- CONTACT UW-MADISON CAMPUS REPRESENTATIVE A MINIMUM OF 5 DAYS PRIOR TO ANTICIPATED PRUNING OF ANY TREES TO SCHEDULE A REVIEW & CONSULTATION WITH CAMPUS GROUNDS STAFF PRIOR TO PERFORMING ANY PRUNING.

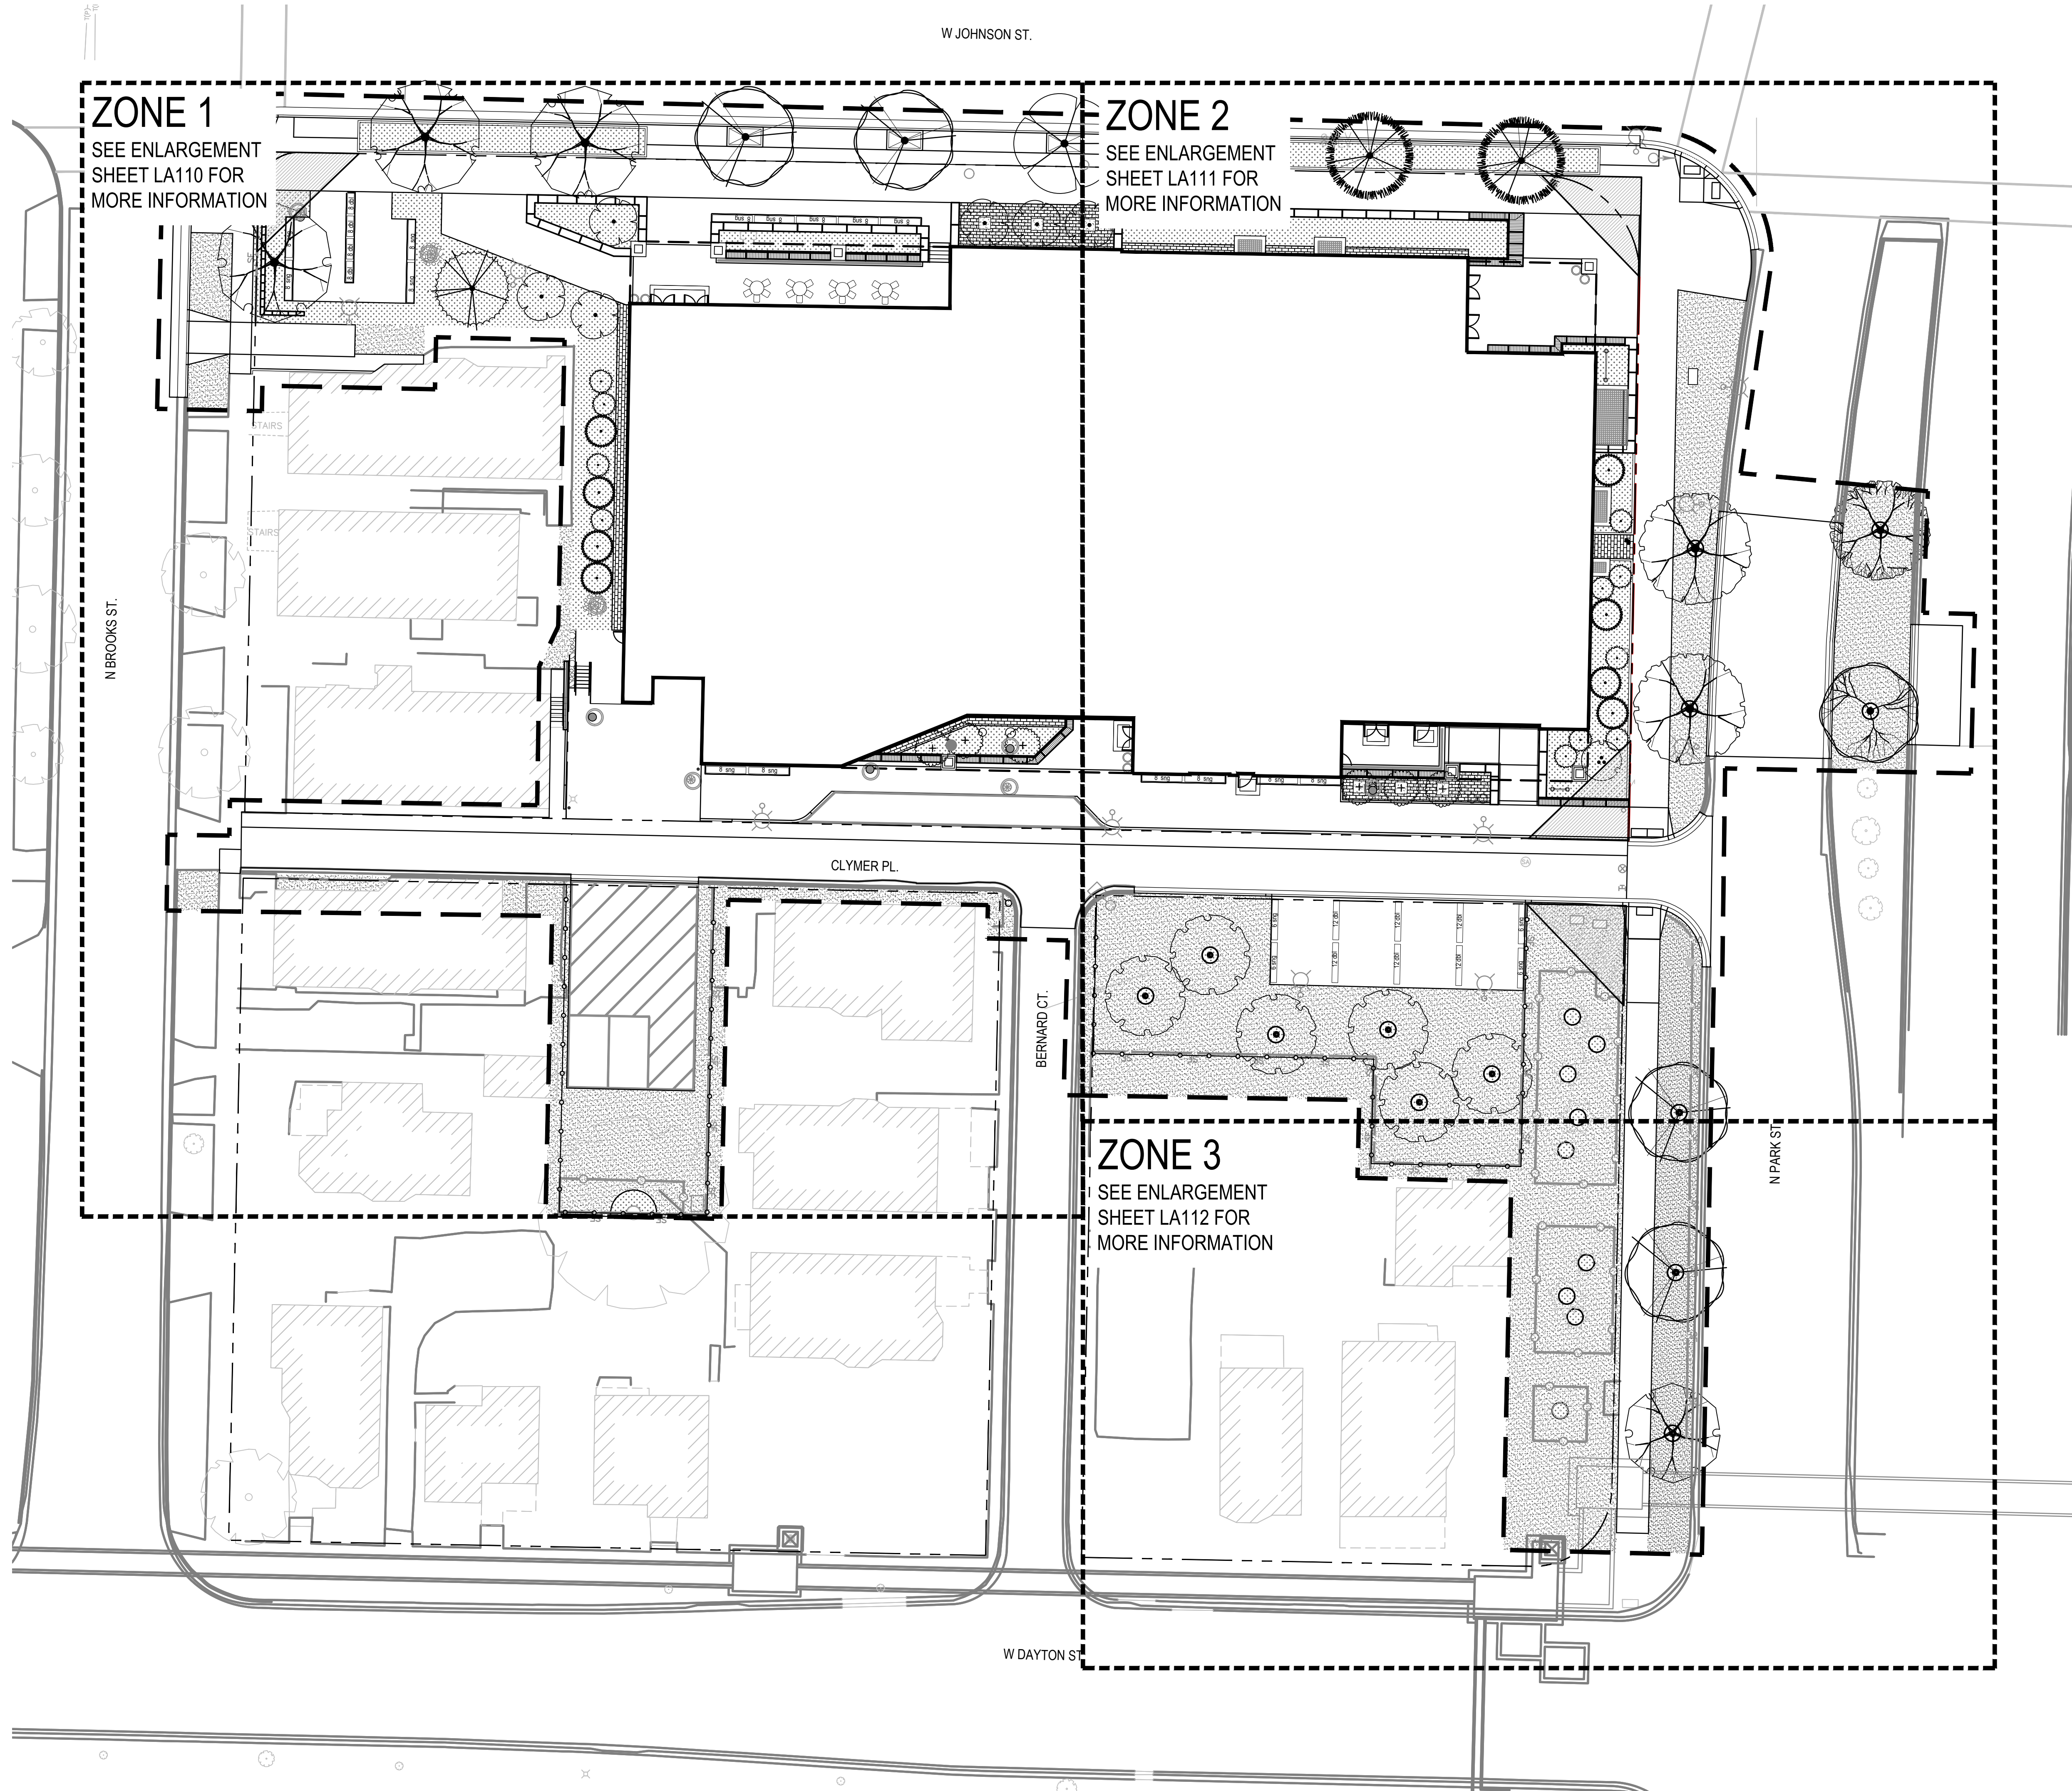

LEGEND

- 1 SALVAGED LIMESTONE PAVER MAINTENANCE EDGE, SEE DETAIL 10/LA500
- 2 SALVAGED LIMESTONE PAVERS WITH PLANTED PLUGS, SEE DETAIL 8/LA500
- 3 MIXED PLANTING BED WITH 3" DEPTH TWICE SHREDDED HARDWOOD BARK MULCH
- 4 SOD
- 5 4' DIAMETER TREE MULCH RING WITH 3" DEPTH TWICE SHREDDED HARDWOOD BARK MULCH
- CONSTRUCTION LIMITS
- PROPERTY LINE R.O.W.
- TREE PROTECTION FENCE
- CONSTRUCTION FENCING
- LIGHT POLES
- INLETS

City of Madison Landscape Worksheet
232 North Park Street
May 22, 2023
Campus-Institutional District

Developed Lots	SF	Minimum Open Space Required (SF)	Landscape Units Required	Landscape Points Subtotal
Total Developed Area	24,291	n/a	81	405
			Landscape Points Required	405

Development Frontage - North Park Street	LF	Overstory Tree Req. (or x2 for Orn./Evrgrn. Tree Sub.)	Shrubs Required
Total LF of Street Frontage Between Bldg./Parking & Streets	130	4	22

Element	Point Value	Quantity Proposed	Quantity Existing	Points Achieved
Overstory Deciduous Tree	35	0	0	0
Ornamental Tree	15	0	0	0
Evergreen Tree	15	8	0	120
Shrub, deciduous	2	0	0	0
Shrub, evergreen	3	10	0	30
Ornamental Grasses/Perennials	2	123	0	246
Ornamental/Decorative Fence or Wall (4 pts/10 LF)	4	0	0	0
Development Frontage Points Total				396

Development Frontage - West Johnson Street	LF	Overstory Tree Req. (or x2 for Orn./Evrgrn. Tree Sub.)	Shrubs Required
Total LF of Street Frontage Between Bldg./Parking & Streets	345	12	58

Element	Point Value	Quantity Proposed	Quantity Existing	Points Achieved
Overstory Deciduous Tree	35	0	0	0
Ornamental Tree	15	6	0	90
Evergreen Tree	15	0	0	0
Shrub, deciduous	2	28	0	56
Shrub, evergreen	3	11	0	33
Ornamental Grasses/Perennials	2	740	0	1480
Ornamental/Decorative Fence or Wall (4 pts/10 LF)	4	0	0	0
Development Frontage Points Total				1659

Development Frontage - Clymer Place	LF	Overstory Tree Req. (or x2 for Orn./Evrgrn. Tree Sub.)	Shrubs Required
Total LF of Street Frontage Between Bldg./Parking & Streets	266	9	44

Element	Point Value	Quantity Proposed	Quantity Existing	Points Achieved
Overstory Deciduous Tree	35	0	0	0
Ornamental Tree	15	7	0	105
Evergreen Tree	15	3	0	45
Shrub, deciduous	2	0	0	0
Shrub, evergreen	2	3	0	6
Ornamental Grasses/Perennials	2	256	0	512
Ornamental/Decorative Fence or Wall (4 pts/10 LF)	4	0	0	0
Development Frontage Points Total				668

Interior Parking Lots	N/A			
Total Parking Lot Area	n/a			

General Site, Foundation, Screening	Point Value	Quantity Proposed	Quantity Existing	Points Achieved
Overstory Deciduous Tree	35	7	0	245
Ornamental Tree	15	0	0	0
Evergreen Tree	15	9	0	135
Shrub, deciduous	2	80	0	160
Shrub, evergreen	3	11	0	33
Ornamental Grasses/Perennials	2	77	0	154
Ornamental/Decorative Fence or Wall (4 pts/10 LF)	4	0	0	0
General Site Plantings Total				727

TOTAL LANDSCAPE POINTS				
				3450

R/S
BORA
saiki DESIGN

Abbie Madison
LA-673
Madison
Wisconsin
Alaine Molien
5/10/2023

State of Wisconsin
Department of Administration
Division of Facilities Development

NEW ACADEMIC BUILDING
LEVY HALL
UNIVERSITY OF WISCONSIN - MADISON
MADISON, WISCONSIN

Revisions:
No. Date Description

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