APPLICATION FOR URBAN DESIGN COMMISSION PEVIEW AND APPROVAL

AGENDA ITEM#	
Project #	The second se
05902	

REVIEW AND APPROVAL	02902
DATE SUBMITTED:	Action Requested Informational Presentation Initial Approval and/or Recommendation Final Approval and/or Recommendation
UDC MEETING DATE: March 8, 2006	X Final Approval and/or Recommendation
PROJECT ADDRESS: 4841 Annamark Drive	
ALDERMANIC DISTRICT: 17th District (Sa	_
OWNER/DEVELOPER (Partners and/or Principals)	Jennifer Mowen, agent for Texas Roadhouse
Raymond & Loraine Zeier c/o Annamark Corporation	c/o GreenbergFarrow
2211 N. Stoughton Road	3455 Salt Creek Lane, Suite 100
Madison, WI 53704	Arlington Heights, IL 60005
CONTACT PERSON: Jennifer Mowen, Green	bergFarrow
Address: 3455 Salt Creek Lane,	
Arlington Heights, II	
Phone: (847) 788=9200	
Fax: (847) 788 9537	
E-mail address:jmowen@greenbergfarro	w.com
well as a fee) School, Public Building or Space (Fee may be r New Construction or Addition to or Remodeling Sq. Ft. X Planned Commercial Site	n Urban Design District * (A public hearing is required as required) g of a Retail, Hotel or Motel Building Exceeding 50,000
(See Section B for:) New Construction or Exterior Remodeling in C	4 District (Fee required)
(See Section C for:) R.P.S.M. Parking Variance (Fee required)	
(See Section D for:) Comprehensive Design Review* (Fee required) Street Graphics Variance* (Fee required)	
Other	
*Public Hearing Required (Submission Deadline 3 Wee	eks in Advance of Meeting Date)
	MD III I MATERIAL OF TITLESCOPE STATES
F:\PLROOT\WORDP\PL\UDC\Miscellaneous\udcreviewapprovalFeb05.doc	

3455 Salt Creek Lane Suite 100 Arlington Heights, IL 60005

t: 847 788 9200 f: 847 788 9536

GreenbergFarrow

ATLANTA
NEW YORK
CHICAGO
LOS ANGELES
BOSTON
DALLAS
NEW JERSEY

Via Federal Express Priority

February 27, 2006

Mr. Al Martin
Dept. of Planning & Development
Room LL-100
City of Madison
215 Martin Luther King, Jr. Blvd.
Madison, WI 53701-2985
Tel 608.267.8740, ext. 221

Project Texas Roadhouse Madison, WI

Project # 20050922.2

Re Resubmittal: Urban Design Commission - Final Approval

Dear Mr. Martin,

On behalf of Texas Roadhouse, we hereby resubmit the attached "Application for Urban Design Commission Review and Approval" and fourteen (14) sets of the following plans/documents as requested:

- 1) Location Map, dated 12/28/05, as prepared by GreenbergFarrow (8½x11)
- 2) Site Photo Board, dated 12/28/05, as prepared by GreenbergFarrow (11x17)
- 3) Recorded Certified Survey Map, Sheets 1 thru 4 of 4, dated 01/03/05, as prepared by D'Onofrio, Kottke & Associates (11x17)
- 4) Approved Concept Plan, dated 10/12/04, as prepared by Dimension IV Madison (11x17 copies)
- 5) ALTA Survey, dated 02/20/06, as prepared by D'Onofrio, Kottke & Associates (11x17)
- 6) Site Plan WI-50922A6, Sheets 1 & 2 of 2, dated 02/13/06, as prepared by GreenbergFarrow (11x17)
- 7) Civil Engineering Plans, dated 02/17/06, as prepared by GreenbergFarrow (11x17)
- 8) Landscape Plan L-1.0, L1.1 & L1.2, dated 02/08/06, as prepared by Schreiber/Anderson Associates (11x17
- 9) Landscape Worksheet, undated
- 10) Building Elevations A2.1, dated 02/08/06, as prepared by GreenbergFarrow (11x17)
- 11) Building Elevations A2.2, dated 02/08/06, as prepared by GreenbergFarrow (11x17)
- 12) Floor Plan Exhibit A1.0, dated 02/08/06, as prepared by GreenbergFarrow (11x17)
- 13) Signage Exhibit Sheets 1, 2 & 3, dated 01/18/06, as prepared by Federal Heath Sign Company
- 14) Seating Plan Exhibit A1.1, dated 02/08/06, as prepared by GreenbergFarrow (11x17)
- 15) Site Lighting Cut Sheets Versalux, as prepared by USA Architectural Lighting; Texas Roadhouse Exterior Specification (Wall Lighting Type F12; Exterior Decorative Lighting Type F16 & F17; and Exterior Soffit Recessed Lighting Type F18)
- 16) Letter addressed to Santiago Rosas, 17th District Alderperson, dated 11/01/05, as prepared by GreenbergFarrow
- 17) Letter of Intent to Plan Commission Members, dated 12/21/05, as prepared by GreenbergFarrow
- 18) Contact List, as prepared by GreenbergFarrow
- 19) 3D Elevations, Front & Rear Views, dated xx/xx/xx, as prepared by GreenbergFarrow

Please note the following revisions to the documents listed above:

- 1. The photometric plan (Sheets C7.0 & C7.1 of the Civil Engineering Plan Set) has been revised to further reduce the "hot spots."
- The architectural elevations have been revised to now show the "Type F12" emergency wall-pack fixtures located at the rear of the building. I have included the manufacturer's cut sheet for this wallpack that indicates it is rated as a full cutoff fixture and is dark-sky approved.
- 3. The floor and seating plans have been updated to show the outdoor patio layout.

Mr. Al Martin, Dept. of Planning & Development, City of Madison RE: TRH Madison, WI – Urban Design Commission – Final Approval 02/27/06 2 of 2 pages

- 4. The landscape and site plans have been revised to incorporate several large deciduous trees along the northernmost row of parking along Annamark Drive. In order to eliminate a conflict with the pylon sign in this area, the sign was moved several parking spaces to the east. A new island was created around the base of the sign to afford enough room for landscaping. As such, the island that previously held the pylon sign was resized to accommodate the "lost" parking space for the new sign location. The total on-site parking count remains at 115 spaces.
- 5. The site plan was also revised to reflect a fire lane turnaround per Fire Department review comments.

With this submission, we look forward to the March 8, 2006 Urban Design Review meeting. Please confirm that we are on the agenda as scheduled.

As always, thank you for your continued help with this project. If you have any questions or require additional information, please contact me at 847.788.9200, ext. 225.

Sincerely,

Jennifer M. Mowen, ASLA Site Development Coordinator

Enclosures

Copies

Santiago Rosas, 17th District Alderperson (w/encl.) (via FedEx Standard)

Peter Olson, City Planner, City of Madison (w/encl.) (via FedEx Standard)

Kerri Smith, Texas Roadhouse (w/encl.) (via FedEx Standard)

Raymond & Loraine Zieir, Annamark Group Z, LLC (w/encl.) (via FedEx Standard)


John Frank, Lathrop & Clark LLP (w/encl.) (via FedEx Standard)

Dave Behrens, GreenbergFarrow MW (w/encl.)


Jennifer Mowen, GreenbergFarrow MW (w/encl.)

Julie Wehmeyer, GreenbergFarrow MW (w/elev., site plan, signage)


01 Project Letter 07.01.05 J:\ADMIN\2005\20050922\20050922 Project Letter To Al Martin_Urban Design Review 02_27_2006A.doc

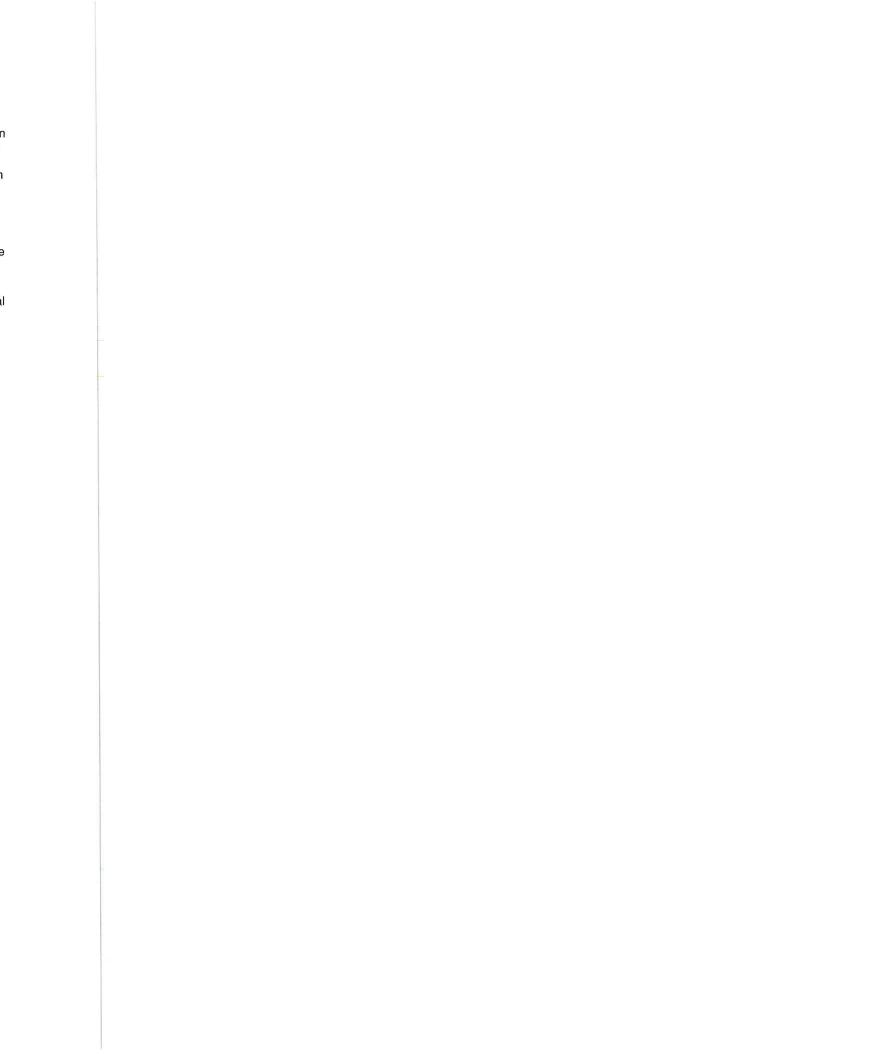

LOCATION MAPS

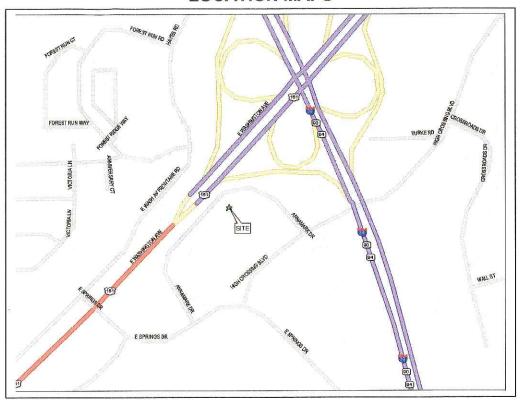


Local map.

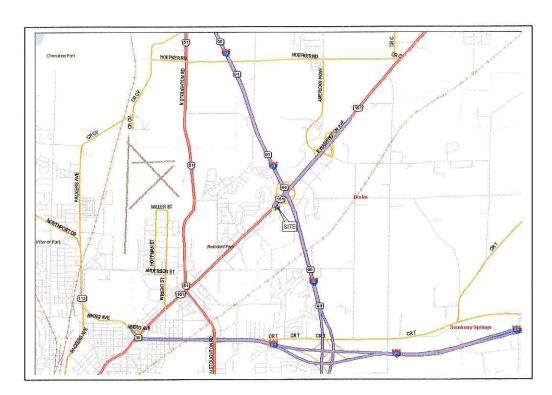

Regional map.

Texas Roadhouse – Madison, WI (SWQ) US 151 (Washington Ave) & I-39 GFA Project No.20050922.2 12/28/05

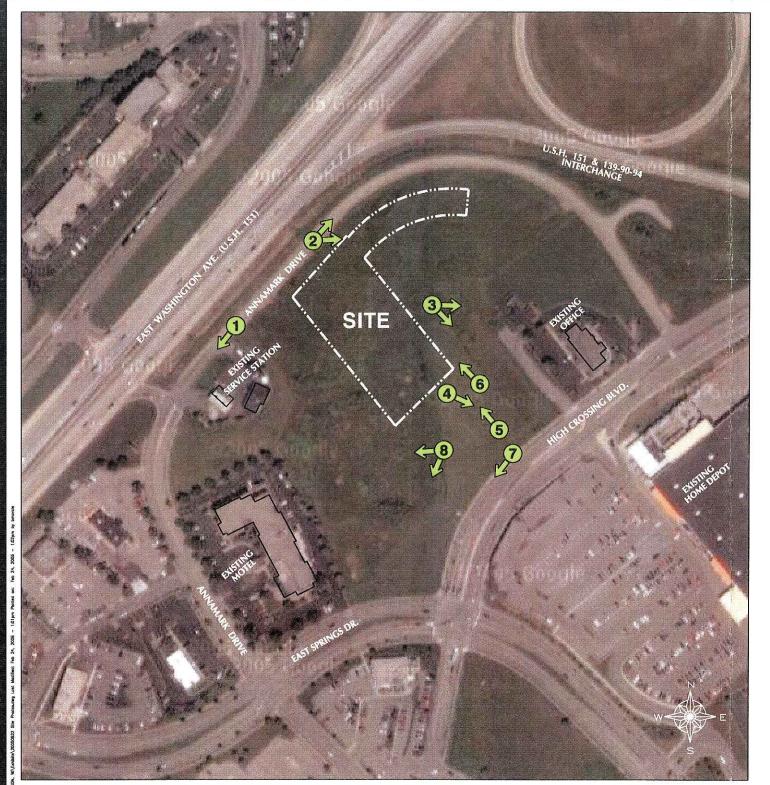





(1)







3)







(5)








Greenberg Farrow 3455 Salt Creek Lane, Suite 100 Arlington Heights, Illinois 60005 t: 847 788 9200 f: 847 788 9536 # Existing site photographs
(Arrow points to direction of view)

TEXAS ROADHOUSE MADISON, WISCONSIN



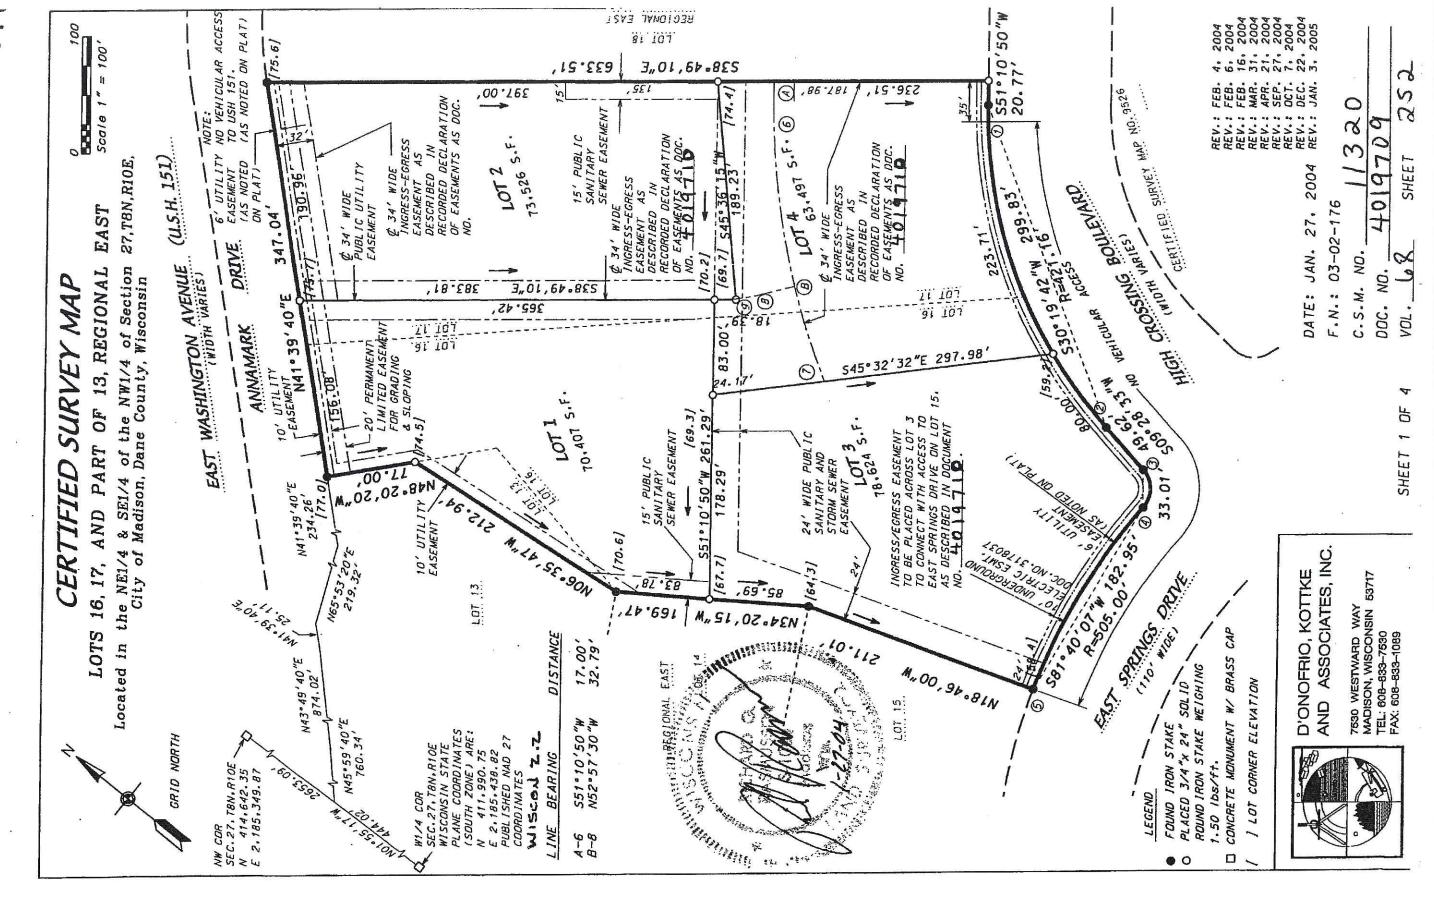

CERTIFIED SURVEY MAP

SURVEYOR'S CERTIFICATE

I. Richard G. Rasmussen. Registered Land Surveyor. S-1034. do hereby certify that this survey is in full compliance with Chapter 236.34 of the Wisconsin Statutes and the Subdivision Regulations of the City of Madison and under the direction of the owners listed below. I have surveyed, divided, and mapped the lands described herein and that the map is a correctly dimensioned representation in accordance with the information furnished.

2774 Dated this

teronne day of

Richard

, 2004.

LEGAL DESCRIPTION

Lots 16 and 17 and part of Lot 13. Regional East. recorded in Volume 56-6B of plats on NW1/4 of Section 27. 18N. R10E. City of Madison. Dane County. Wisconsin. to-wit:

NW1/4 of Section 27. 18N. R10E. City of Madison. Dane County. Wisconsin. to-wit:

Commencing at the west quarter corner of said Section 27: thence NO1°55'17"W, 444.02 feet:
thence NA5°59'40"E. 760.34 feet: thence NA3°49'40"E. 814.02 feet: thence NA1°39'40"E. 25.11
feet: thence N65°53'20"E. 219.32 feet: thence N41°39'40"E. 834.26 feet to the point of
Section 100"W, 20.77 feet to a point of curve: thence southwesterly on a curve to the left which
Sos'28'34"W, 20.77 feet to a point of curve: thence southwesterly on a curve to the left which
sos a radius of 42.00 feet and a chord which bears \$30°42"W, 299.83 feet: thence
has a radius of 25.00 feet and a chord which bears \$50°47'25"W, 33.01 feet to a point of reverse
which bears \$81°40'07"W, 182.95 feet: thence N18°46'00"W, 211.01 feet: thence N34°20'15"W,
beginning. Containing 6.567 ocres.

OWNER'S CERTIFICATE

Annamark Group Z. LLC. a limited liability company duly organized and existing under and by virtue of the laws of the State of Wisconsin. Owner. does hereby certify that said limited liability company caused the lands described on the Certified Survey to be surveyed. divided and mapped as represented on this Certified Survey Map.

5 0 gg IN WITNESS WHEREDF. soid Annamark Group Z. LLC has caused these presents taigned by its member listed below. and its seal to be hereunto affixed on this factors.

ANNAMARK GROUP Z. LLC

Taymod Goor Raymond CZeler member Theire a Brier Loraine A Zeier, Member STATE OF WISCONSIN) COUNTY OF DANE

named member to me known to be the person who executed the foregoing instrument and acknowledged the same.

My commission is germaned

Idean John C Frank Notary Public, Dane County, Misconsin

AND ASSOCIATES, INC. D'ONOFRIO, KOTTKE

7630 WESTWARD WAY MADISON, WISCONSIN 53717 TEL: 608–833–7530 FAX: 608–833–1089

253 0 4019709 SHEET C.S.M. NO. DOC. NO. VOL.

2 OF

SHEET

2004

27,

DATE: JAN.

F.N.: 03-02-176

CERTIFIED SURVEY MAP

CITY OF MADISON APPROVAL

2005. Gity of Madison Plan Commission Action of Approved for recording

Cotory, City of Words and Block

REGISTER OF DEEDS CERTIFICATE


2005. at 7: 3,410ck of Certified Surveys on pages 252-255 February day of 8件 Received for recording this_ 8 A.M. in Volume

Document Number 4019709.

Jane Licht. Dane County Register of Deeds

CURVE DATA

TANGENT	4-N87°53'44"W 5-S71°13'58"W 7-S29°13'14"W B-S36°56'24"W
CENTRAL	41.42'16" 30.48'16" 10.54'00" 82.37'42" 21.57'36" 14.14'26" 07.43'10"
CHORD BEARING	530° 19' 42"W 535° 46' 42"W 514° 55' 34"W 550° 47' 25"W 581° 40' 07"W 540° 12' 02"W 544° 03' 37"W 533° 04' 49"W N49° 25' 44"W
ARC (FEET)	306.55 226.43 80.12 36.05 183.96 249.13 161.55
CHORD (FEET)	299.83 223.71 80.00 33.01 182.95 247.61 161.14
RADIUS (FEET)	421.16 421.16 421.16 25.00 505.00 650.00 650.00
101	4 W
CURVE NUMBER LOT	- 64668 - 1-1-1-8 - 2-1-1-1-9

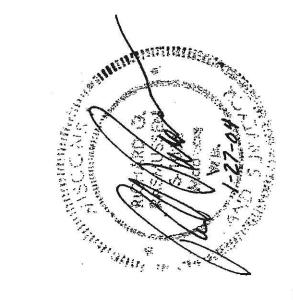

D'ONOFRIO, KOTTKE
AND ASSOCIATES, INC.
7530 WESTWARD WAY
MADISON, WISCONSIN 53717
TEL: 608-833-7530
FAX: 608-833-1089

DATE: JAN. 27. 2004 F.N.: 03-02-176

F.N.: 03-02-176 C.S.M. NO. 1-0197

OF 4 VOL. 68 SHEET

SHEET 3 OF


CERTIFIED SURVEY MAP


NOTES:

- These lots are individually responsible for compliance with Chapter 37 of the Madison General Ordinances in regard to storm water detention at the time is develops.
- Š
- The lands within this certified survey map are subject to a Declaration of Conditions Covenants as Doc. No. 1960296. E,
 - The lands within this certified survey map are subject to a Declaration of Conditions and Covenants as Doc. No. 1960297. The londs within this certified survey map are subject to a Restrictive Covenant as Doc. No. 1987523.
 - The lands within this Certified Survey Map are subject to a Declaration of Covenants. Conditions. and Restrictions as Doc. No. 2013034.

 - The lands within this Certified Survey Map are subject to the First Amendment to Declaration of Covenants. Conditions and Restrictions as Doc. No. 2273112. The lands within this Certified Survey Map are subject to the Second Amendment Deciaration of Covenants. Conditions and Restrictions as Doc. No. 2316295.

 - The lands within this Certified Survey Map are subject to a Declaration of Restriction as Doc. No. 2517162.
- as Doc. The lands within this Certified Survey Map are subject to a Declaration Covenant No. 3172798.
- The lands within this Certified Survey Map are subject to a Declaration of Use Restriction as Doc. No. 3173174. 10.
- The lands within this Certified Survey Map are subject to the Third Amendment to Declaration of Covenants. Conditions and Restrictions as Doc. No. 3172800 & 3181461. 11.
 - The lands within this Certified Survey Map are subject to a Termination of Use Restriction as Doc. No. 3173153. 12
- Arrows indicate the direction of surface drainage swale at individual property lines. drainage swale shall be graded with the construction of each principal structure and maintained by the low owner unless modified with the approval of the City Engineer. Elevations given are for property corners at ground level and shall be maintained by lot owner. 13.
- All lots within this survey are subject to a non-exclusive easement for drainage purposes which shall be a minimum of 6 feet in width measured from the property line to the interior of each lot except that the easement shall be 12 feet in width on the perimeter the survey. Easements shall not be required on property lines shared with greenways or public streets. 14.
 - to a joint driveway agreement as Doc. The lands within the Certified Survey are subject No. 3173175. 15.

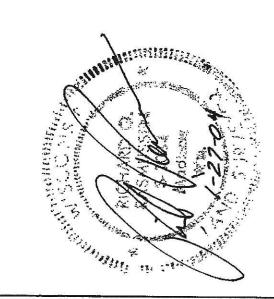

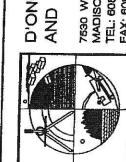

AND ASSOCIATES, INC. D'ONOFRIO, KOTTKE


7530 WESTWARD WAY MADISON, WISCONSIN 53717 TEL: 608-833-7530 FAX: 608-833-1089


2004 03-02-176 27. DATE: JAN. F.N.:


4019709 SHEET NO. VOL. GR DOC. NO. C. S. M.

000

4 4 OF SHEET

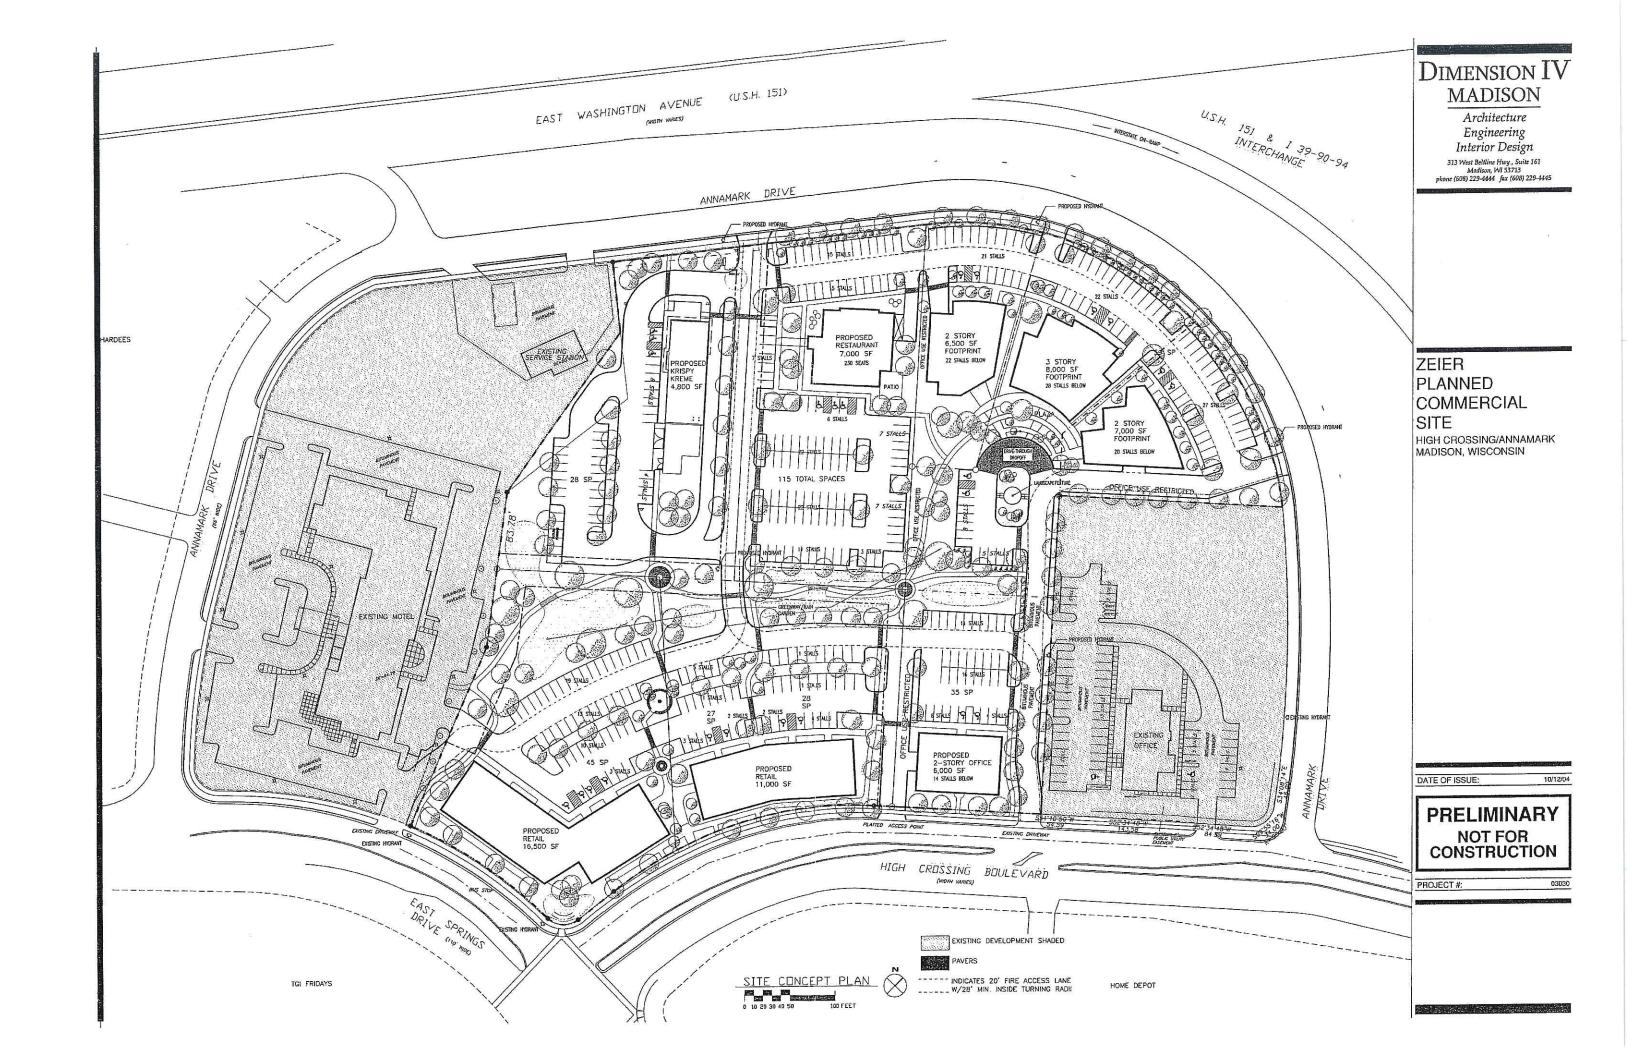

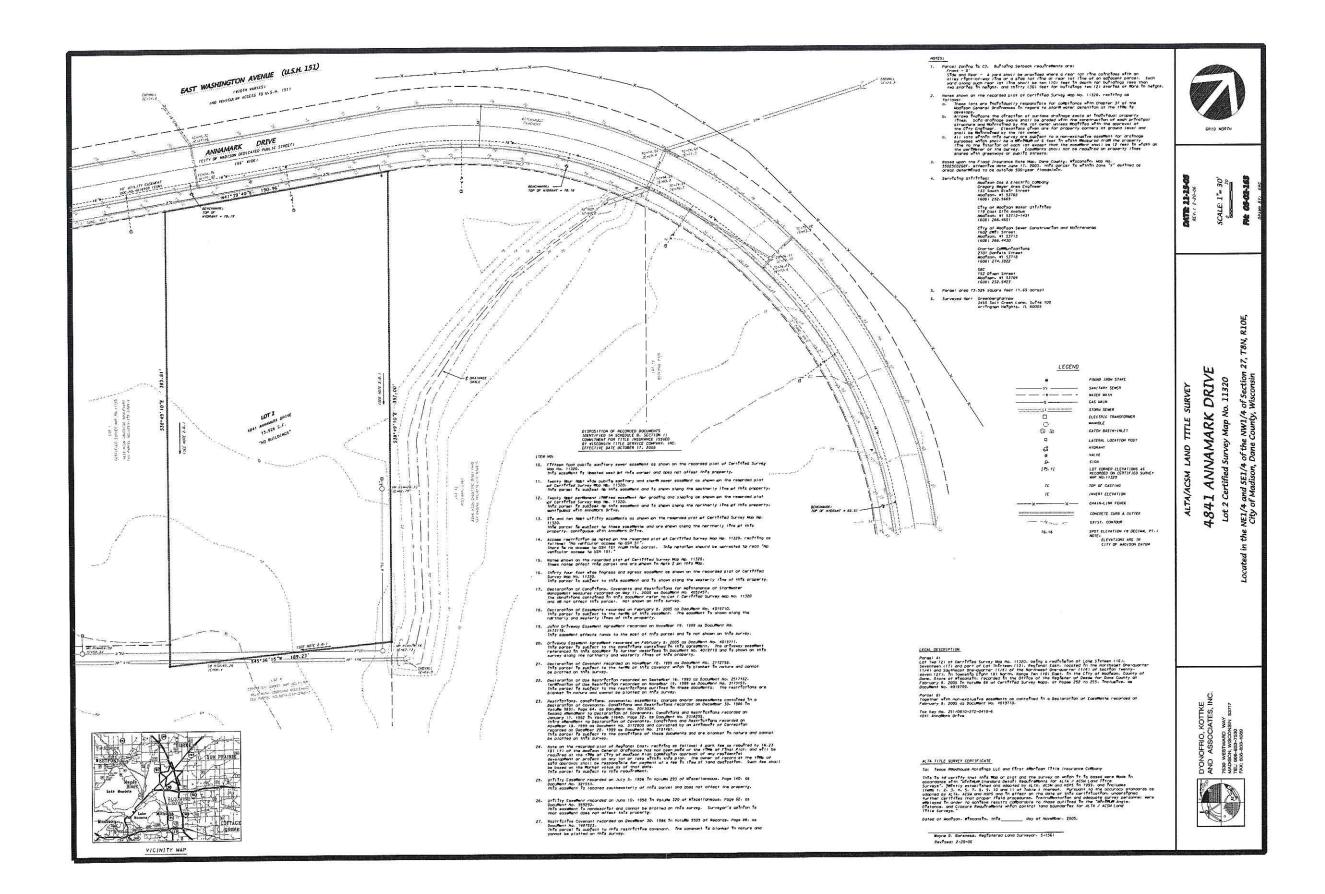

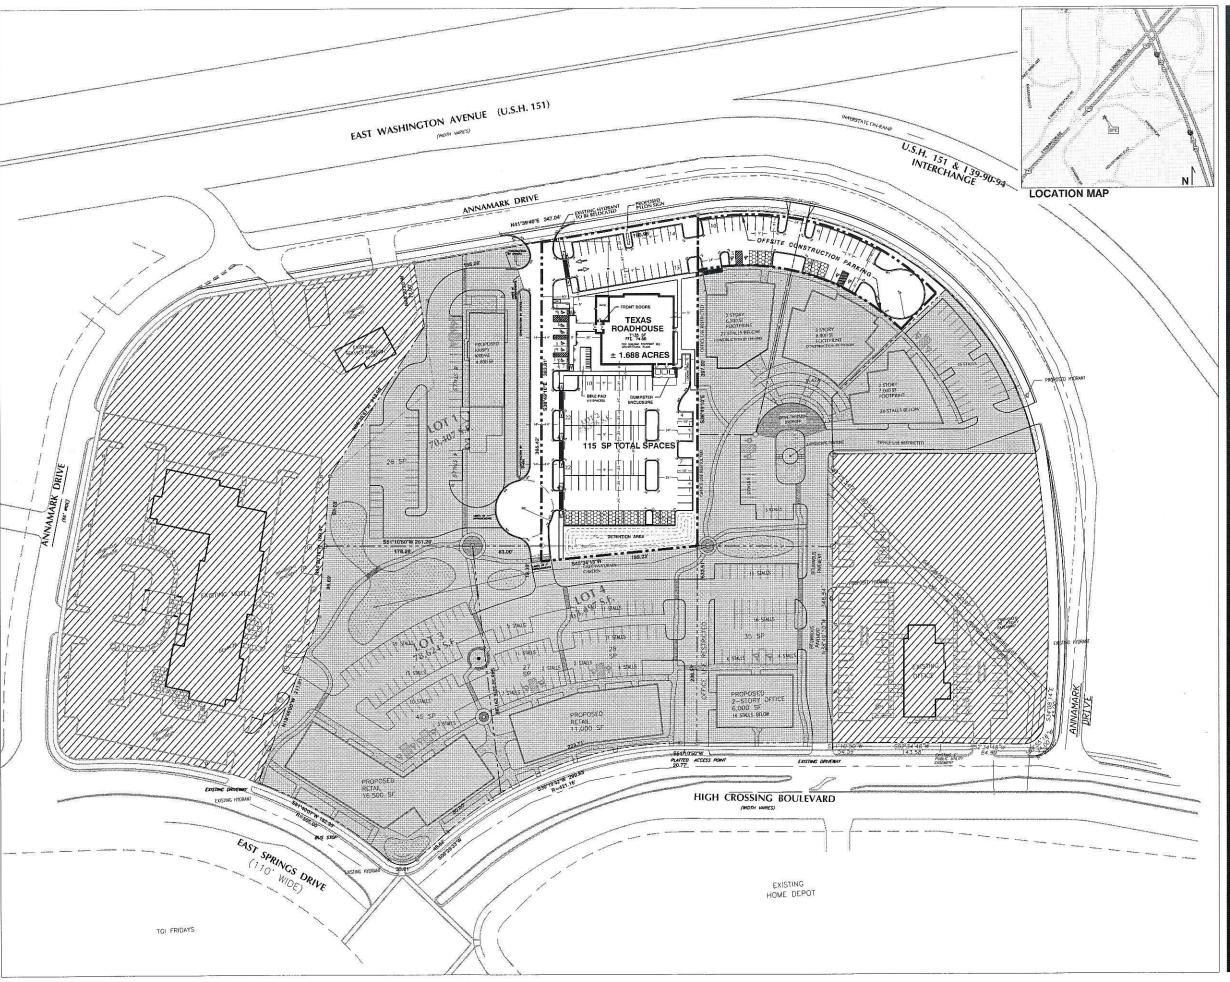

Greenberg Farrow 3455 Salt Creek Lane, Suite 100

Arlington Heights, Illinois 60005 t: 847 788 9200 f: 847 788 9536

PROJECT INFORMATION

SITE AREA TEXAS ROADHOUSE

1.688 ACRES

BUILDING AREA
TEXAS ROADHOUSE

7,135 SF

16.2 SP/1,000 SF

PARKING SUMMARY

USER	RATIO REQUIRED	SPACES REO'D	SPACES PROV'
TEXAS ROADHOUSE	SEE NOTE*	83	115
OFFSITE CONSTRUCTION	PARKING		3

PARKING RATIO PROVIDED

30% OF THE CAPACITY IN PERSONS OF DINING/ BAR/WAITING AREAS CAPACITY= 275

ZONING CLASSIFICATION

CITY OF MADISON, WI JURISDICTION EXISTING ZONING C-3: PLANNED COMMERCIAL REQUIRED ZONING C-3: PLANNED COMMERCIAL

SIGNAGE REGULATIONS

LANDSCAPE REGULATIONS

BUILDING SETBACKS

TBV SIDE TBV

LEGEND



EXISTING DEVELOPMENT



PROPOSED **FUTURE DEVELOPMENT**

PROPOSED PERMEABLE AREA

PROJECT NOTES

- , THIS CONCEPTUAL SITE PLAN IS FOR PLANNING PURPOSES ONLY: SITE SPECIFIC INFORMATION SUCH AS EXISTING CONDITIONS, ZONING, PARKING LANDSCAPE REQUIREMENTS MUST BE VERIFIED.

DRAWING ISSUE/REVISION RECORD
DATE NARRATIVE

DATE NAHRATIVE
09/107/05 INITIAL RELEASE
09/13/05 CUL-DE-SAC
11/07/05 REVISED PARKING, SURVEY INFO
12/28/05 INSERTED REVISED SITE PLAN & SURVEY
01/30/06 SHOW PROP PERMEABLE AREA
02/13/06 REVISED PER FIRE DEPT/UDC COMMENTS





(SWQ) US 151 (Washington Ave) & I-39

GFA PROJECT NUMBER 20050922.2



WI-50922A6 SHEET 1 of 2

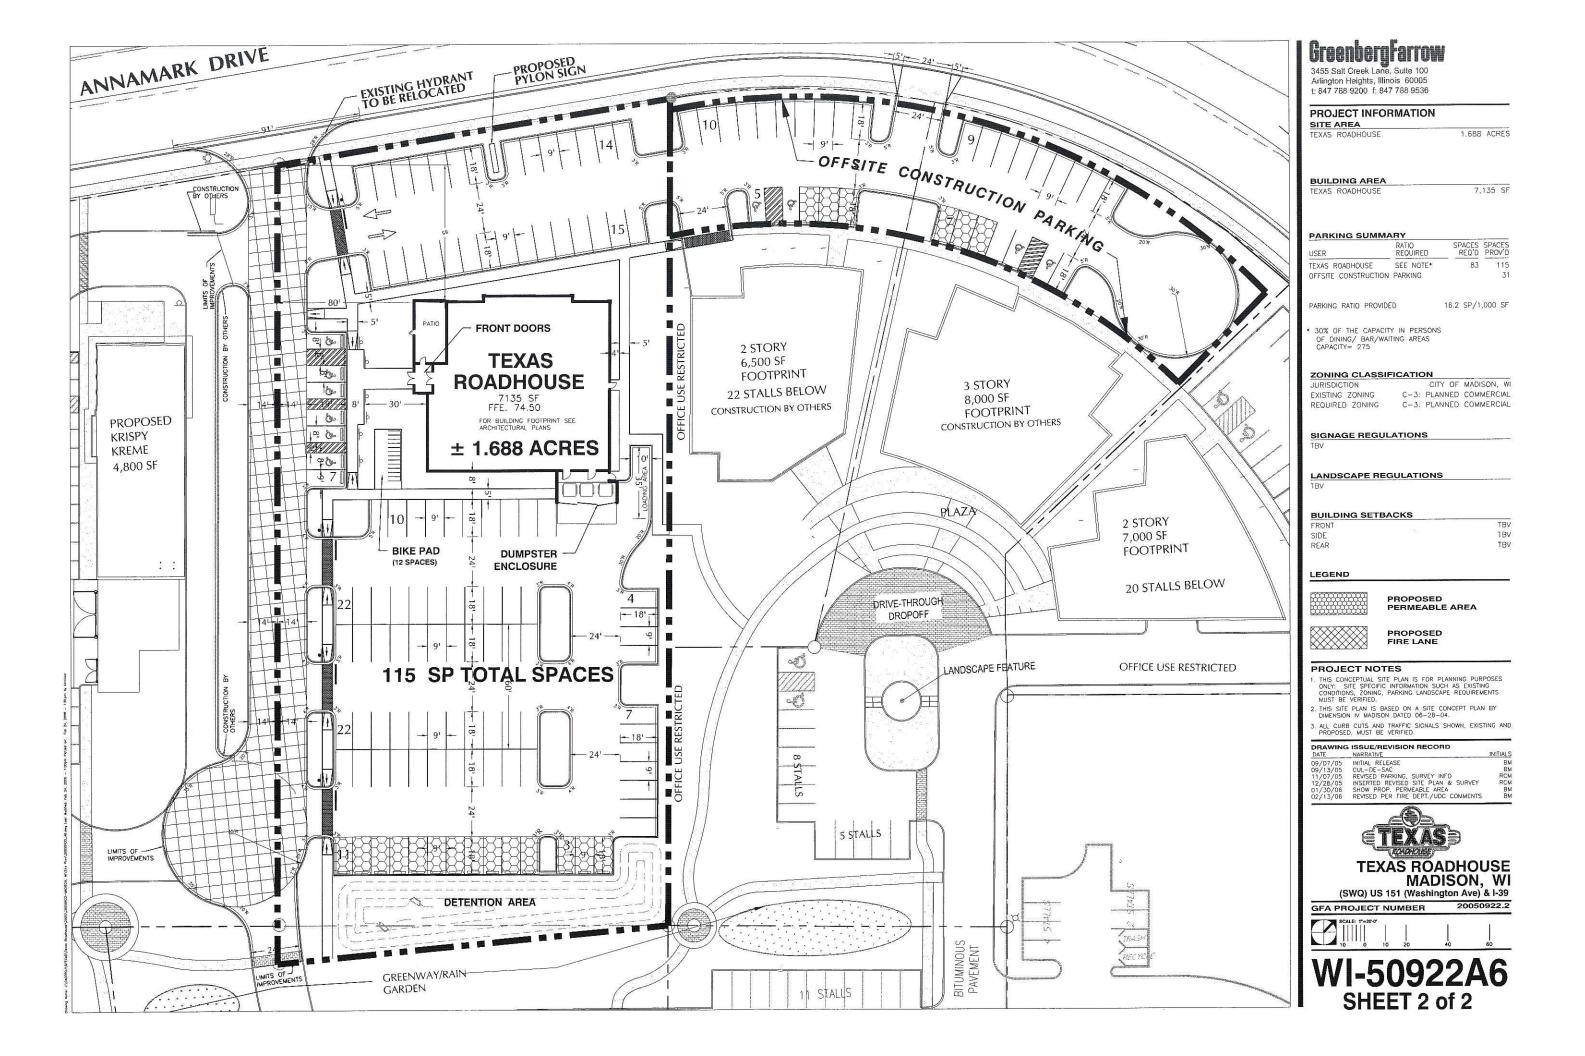

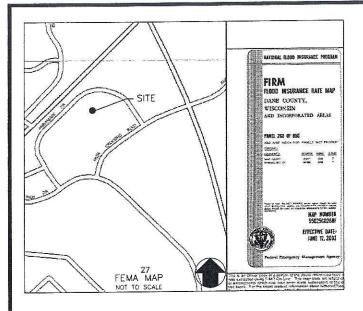



MADISON, WISCONSIN

4841 ANNAMARK DRIVE (SWO) US 151 (WASHINGTON AVENUE) & I-39

ZONING: C3

OWNER/DEVELOPER:

TEXAS ROADHOUSE

CONTACT: KERRI SMITH
(24 HR EMERGENCY CONTACT)
TEXAS ROADHOUSE HOLDING, LLC
6060 DUTCHMANS LANE, SUITE 400
LOUISVILLE, KENTUCKY 40205
(502) 515-7301

ENGINEER:

GreenbergFarrow

CONTACT: JOHN NOURZAD, PE (VICE-PRESIDENT)
ALFONSO INCHAUSTI, PE (PROJECT MANAGER)
1755 THE EXCHANGE
ATLANTA, GEORGIA 30339
770-303-1033

JENNIFER MOWEN
(SITE DEVELOPMENT COORDINATOR)
3455 SALT CREEK LANE, SUITE 100
ARLINGTON, IL 60005
(847) 788-9200



CALL DIGGERS HOTLINE
1-800-242-9511
TOLL FREE
VIS STATUTE 188,0175(1974)
REDURES WHI 3 VORK DATS
NOTICE BEFORE YOU EXCAVATE

REDURES MIN 3 VORK DAYS
NOTICE BEFORE YOU EXCAVATE
MILW. AREA 259-1181

UTILITIES

LOCATION MAP

SEWERS

OTTY OF MADISON PUBLIC WORKS
ENGINEERING DIVISION
CONTACT: GREG FRIES
210 MARTIN LUTHER KING, JR. BOULEVARD
ROOM 115
MADISON, WISCONSIN 53703
PH: (608) 2664–4751
FAX: (608) 2644–9273
EMAIL: GFRIES@CITYOFMADISON.COM

WATER UTILITY:

CITY OF MADISON 119 EAST OLIN AVENUE MADISON, WSCONSIN 53713 PH: (608) 266-4651 FAX: (608) 266-4644

ELECTRICITY AND GAS:

MADISON GAS AND ELECTRIC COMPANY GREGORY MEYER, AREA ENGINEER 133 SOUTH BLAIR STREET MADISON, WISONSIN 53703 PH: (608) 252-5669 FAX: (608) 252-5523 CELL: (608) 444-9617 EMAIL: CMEYER®MGE.COM

TELEPHONE:

SBC 152 DIXON STREET MADISON, WISCONSIN 53704 PH: (608) 252-5423

SHEET INDEX

L-1.0

L-1.1

COVER SHEET C-0.0**EXISTING CONDITIONS (TOPOGRAPHIC SURVEY)** C-1.0 **GENERAL NOTES** C-2.0LAYOUT PLAN **GRADING & DRAINAGE PLAN** C - 3.0C-4.0 **UTILITY PLAN EROSION CONTROL PLAN** C-5.0C-6.0**DETAILS 1 DETAILS 2** C-6.1 SITE LIGHTING PLAN C-7.0SITE LIGHTING PLAN C-7.1

LAND TITLE SURVEY: D'ONOFRIO, KOTTKE AND ASSOCIATES, INC.

LANDSCAPE LAYOUT PLAN

LANDSCAPE PLANT LEGEND

7530 WESTWARD WAY MADISON, WISCONSIN 53717 PH: (608) 833-7530 FAX: (608) 833-1089

SITE LIGHTING CONSULTANT: ACCU SERV LIGHTING AND EQUIPMENT


CONTACT: KEVIN LOEHLE
PH: (877) 707-7378
FAX: (502) 961-0357
EMAIL: KLOEHLE®ACCU-SERV.COM

UNDERGROUND FACILITIES, STRUCTURES AND UTILITIES HAVE BEEN PLOTTED FROM AVAILABLE SURVEYS AND RECORDS, THEREFORE; THEIR LOCATIONS MUST BE CONSIDERED APPROXIMATE ONLY. THERE MAY BE OTHERS, OF WHICH THE EXISTENCE IS PRESENTLY NOT KNOWN. IT IS THE RESPONSIBILITY OF THE CONTRACTOR TO HAVE ALL UTILITIES LOCATED IN THE FIELD PRIOR TO CONSTRUCTION.

REVISION RECORD

NO. DATE SHT No. DESCRIPTION

JOB NO. 20050922 DATE: 2-17-06

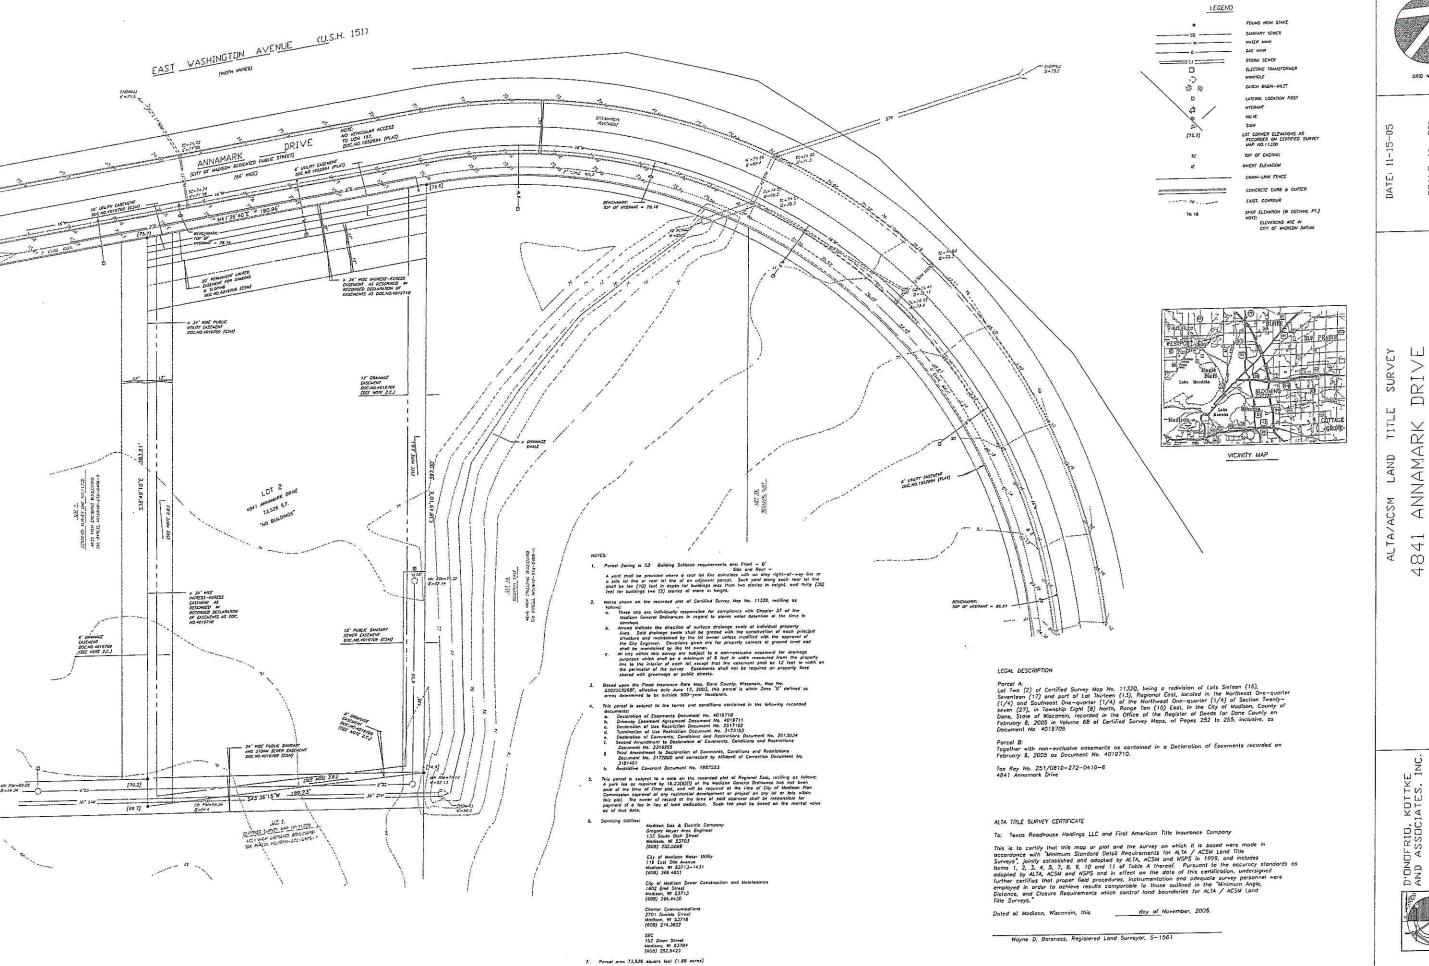

6. Surveyed for: GreenbergForrow 3455 Soft Creek Lone, Suite 100 Arlington Heights, N. 60005

= <u>'</u>1 SCALE:

R10E,F

05-02-

NW1/4 of y, Wisconsir No. 11320 Мар of the NE1/4 and SE1/4 c of Madison, Dane Sur

ANNAMARK tified Cer 4841 α Lot 2.

D'ONOFRIO, KOTTKE AND ASSOCIATES, INC. 7530 VESTVARD VAY MADISON, VISCONSIN 53717 TEU 608-833-7530 FAX: 608-833-1089

GENERAL NOTES

- 1. THE CONTRACTOR IS RESPONSIBLE FOR SITE SAFETY AND WAYS, MEANS AND METHODS OF CONSTRUCTION.
- THE CONTRACTOR SHALL COMPLY WITH APPLICABLE STATE, FEDERAL, AND LOCAL CODES AND OBTAIN ALL NECESSARY LICENSES AND PERMITS
- 3 THE GENERAL SPECIFICATION WHICH APPLY TO THE CONSTRUCTION WORK AS SHOWN ON THE ENGINEERING PLANS, ARE CONTAINED IN STANDARD SPECIFICATIONS, CONSTRUCTION DETAILS, AND/OR THE CITY'S ENGINEERING DEPARTMENT.

- A. MAINTAIN PROPER SITE DRAINAGE AT ALL TIMES DURING THE COURSE OF CONTRUCTION, AND PREVENT STORM WATER FROM RUNNING INTO OR STANDING IN EXCAVATED AREAS.
- B. SPREAD AND COMPACT UNIFORMLY TO THE DEGREE SPECIFIED ALL EXCESS TRENCH SPOIL AFTER COMPLETION OF THE UNDERGROUND IMPROVEMENTS. (EARTHWORK CONTRACTOR SHALL MAKE APPROPRIATE ADJUSTMENTS IN ROUGH GRADING TO
- C. PROVIDE WATER TO ADD TO DRY MATERIAL IN ORDER TO ADJUST THE MOISTURE CONTENT FOR THE PURPOSE OF ACHIEVING THE SPECIFIED COMPACTION.
- D. BACKFILL THE CURB AND GUTTER AFTERS ITS CONSTRUCTION AND PRIOR TO THE PLACEMENT OF BASE COURSE MATERIAL.
- E. UNSUITABLE MATERIAL SHALL BE CONSIDERED AS MATERIAL WHICH IS NOT SUITABLE FOR THE SUPPORT OF PAVEMENT AND BUILDING CONSTRUCTION, AND IS ENCOUNTERED BELOW NORMAL TOPSOIL DEPTHS AND THE PROPOSED SUB-GRADE ELEVATION, THE DECISION TO REMOVE SAID MATERIAL, AND TO WHAT EXTENT, SHALL BE MADE BY A SOILS ENINEER WITH THE CONCURRENCE OF THE OWNER.
- 5. GENERAL PAVING
- THE PAVING CONTRACTOR SHALL:
- A. REPAIR ANY BASE COURSE AND BINDER COURSE FAILURES PRIOR TO THE INSTALLATION OF THE FINAL BITUMINOUS/
- B. SWEEP CLEAN THE BINDER COURSE PRIOR TO THE INSTALLATION OF THE FINAL BITUMINOUS CONCRETE SURFACE COURSE. EXCESSIVE CLEANING OF THE BINDER COURSE THAT MAY BE REQUIRED, AND IS NOT THE FAULT OF THE PAVING CONTRACTOR, SHALL BE THE RESPONSIBILITY OF THE GENERAL CONTRACTOR.
- 6. INCIDENTAL TO CONSTRUCTION
- A. ADHERE TO THE CRITERIA FOR THE SEPARATION BETWEEN WATERMAINS AND THE STORM AND SANITARY SEWER LINES AS A. ADHERE TO THE CRITERIA FOR THE SEPARATION SELVER WATERMAINS AND THE STORM AND SANDRAT FOR THE SEVEN CHOICE.

 DESCRIBE: WHEREEVER A SANITARY/COMBINED SEWER CROSSES UNDER A WATERMAIN, THE MINIMUM VERTICAL DISTANCE FROM
 THE TOP OF THE SEWER TO THE BOTTOM OF THE WATERMAIN SHALL BE 18 INCHES. FURTHERMORE, A MINIMUM HORIZONTAL
 DISTANCE OF 10 FEET BETWEEN SANITARY/COMBINED SEWERS AND WATERMAIN SHALL BE MAINTAINED UNLESS: THE SEWER IS
 LAID IN A SEPARATE TRENCH, KEEPING A MINIMUM 18 INCH VERTICAL SEPARATION: OR THE SEWER IS LAID IN THE SAME
 TRENCH WITH THE WATERMAIN LOCATED AT THE OPPOSITE SIDE ON A BENCH OF UNDISTURBED EARTH, KEEPING A MINIMUM 18
 INCH VERTICAL SEPARATION. THE CONTRACTOR SHALL NOTIFY THE ENGINEER IF EITHER THE VERTICAL OR HORIZONTAL DISTANCES DESCRIBED ABOVE CANNOT BE MAINTAINED.
- B. BE RESPONSIBLE TO PLACE GRADE AND COORDINATE WITH OTHER CONTRACTORS, ALL UNDERGROUND UTILTY STRUCTURE FRAMES SUCH AS MANHOLES, CATCH BASINS, AND INLETS.
- C. BE AWARE OF POTENTIAL CONFLICTS WITH EXISTING UTILITIES. THE CONTRACTOR SHALL EXCAVATE AROUND THE EXISTING UTILITIES TO DETERMINE THEIR EXACT LOCATIONS AND ELEVATIONS PRIOR TO THE CONSTRUCTION OF THE PROPOSED UTILITY
- D. PROVE POURED CONCRETE FILLETS CONFORMING TO THE SHAPE OF THE PIPE IN ALL SANITARY AND STORM MANHOLES,
- E. BE RESPONSIBLE FOR MAINTAINING THE TOP OF ANY UTILITY TRENCH AT LEAST TWO (2) FEET AWAY FROM ANY EXISTING OR PROPOSED CURB OR PAVEMENT, IN THOSE INSTANCES WHERE THE TRENCH RUNS PARALLEL TO THE SAID CURB OR
- F. BE RESPONSIBLE FOR THE DE-WATERING OF UTILITY TRENCHES DURING CONSTRUCTION AND PROVIDING THE NECESSARY TRENCH BRACING THAT MAY BE REDUIRED IN ORDER TO ADHERE TO CURRENT SAFETY STANDARDS.
- G. REMOVE SOFT MATERIAL THAT MAY BE ENCOUNTERED AT THE PIPE INVERT ELEVATION TO A DEPTH OF AT LEAST ONE (1) FOOT BELOW THE BOTTOM OF THE PIPE, AND BACKFILL WITH COMPACTED BEDDING MATERIAL.
- H. REMOVE ALL EXCESS MATERIAL OFF THE SITE OR TO AN APPROVED LOCATIONS DESIGNATED BY THE OWNER.
- I. COMPLETE ANY REQUIRED ADJUSTMENTS OR RECONSTRUCTION TO ANY EXISTING UTILITY STRUCTURES TO THE SATISFACTION OF THE UTILITY OWNER, ADJUSTMENTS AND/OR RECONSTRUCTION NOT CALLED FOR ON THE PLANS SHALL BE CONSIDERED INCIDENTAL TO THE CONTRACT. NO MORE THAN A TOTAL OF EIGHT (B) INCHES OF ADJUSTING RINGS SHALL BE ALLOWED.
- 7. TESTING AND FINAL ACCEPTANCE
- A. THE CONTRACTOR SHALL PROVIDE AS A MINIMUM, A FULLY LOADED SIX-WHEEL TRUCK FOR PROOF ROLLING THE PAVEMENT SUB-GRADE PRIOR TO THE PLACEMENT OF THE CURB AND GUTTER AND THE BASE MATERIAL.
- B. SPECIFIC COMPACTING TESTING MAY BE REQUIRED BY THE OWNER IN SELECTED FILL AREAS. THE CONTRACTOR SHALL BEAR THE COST OF COMPACTION TESTING AS WELL AS THE RESPONSIBILITY FOR THE NECESSARY CORRECTIONS.
- C. APPROVAL OF THE PAVEMENT SUB-GRADE BY THE OWNER'S GEOTECHNICAL ENGINEER SHALL BE REQUIRED PRIOR TO THE PLACEMENT OF THE PAVEMENT MATERIAL
- D. SANITARY SEWER MAINS AND SERVICES SHALL BE TESTED FOR LEAKAGE AND DEFLECTION IN ACCORDANCE WITH THE REQUIREMENT OF THE LOCAL JURISDICTIONAL AUTHORITIES PRIOR TO THEIR FINAL ACCEPTANCE. ALLOWABLE TESTING LIMITS SHALL BE AS DESCRIBED IN THE "GENERAL SPECIFICATIONS" UNLESS THE LOCAL REQUIREMENTS ARE MORE RESTRICTIVE. SERVICE STUBS MUST BE PROPERLY PLUGGED AND SEALED AND CLEARLY LOCATED AT THEIR TERMINATION POINTS PRIOR TO TESTING. ALL SWEEP HAMIS SERVICE LINES AND MANUFACTES SHALL BE CLEAN AND FEEL OF A DEDUS DRIVED TO THE TESTING. ALL SEWER MAINS, SERVICE LINES, AND MANHOLES SHALL BE CLEAN AND FREE OF DEBRIS PRIOR TO THEIR FINAL
- WATERMAINS SHALL BE TESTED IN ACCORDANCE WITH THE LOCAL JURISDICTIONAL REQUIREMENTS PRIOR TO ITS FINAL E. WALEMMAINS SHALL BE INSTITUTED IN VIEW AND LEAKAGE TESTS AND DISINFECTION OF THE MAINS SHALL BE DESCRIBED IN THE SPECIFICATIONS OF FROM THE LOCAL REQUIREMENTS, WHICH EVER ARE MORE RESTRICTIVE. ALL VALVE VAULTS SHALL BE CLEAN AND FREE OF DEBRIS AND WATER PRIOR TO THEIR FINAL ACCEPTANCE. THE INDIVIDUAL SERVICE BOXES SHALL BE VISIBLE AND CLEARLY LOCATED PRIOR TO THEIR FINAL ACCEPTANCE.
- F. SPECIAL CONDITIONS ALTERNATE SOLUTIONS SHALL BE PRESENTED TO THE CITY OR STATE APPLICABLE AGENCIES WHEN EXTREME TOPOGRAPHICAL, GEOLOGICAL OR EXISTING STRUCTURAL CONDITIONS MAKE STRICT COMPLIANCE WITH THE ABOVE (D) OR (E) TECHNICALLY AND ECONOMICALLY IMPRACTICAL. ALTERNATE SOLUTIONS WILL BE APPROVED PROVIDED WATERTIGHT CONSTRUCTION STRUCTURALLY EQUIVALENT TO APPROVED WATERMAIN MATERIAL IS PROPOSED.
- WATERMAINS AND WATER SERVICE LINES SHALL BE PROTECTED AGAINST ENTRANCE OF HYDROCARBONS THROUGH DIFFUSION AND THROUGH ANY MATERIAL USED IN CONSTRUCTION OF THE LINE.

- 8. MINIMUM REQUIRMENT FOR MANHOLE STRUCTURES
- THE FRAME LIP SHALL BE CLEANED OF ALL MUD AND DEBRIS TO PROVIDE WATERTIGHT SEAL BETWEEN THE FRAME AND
- B. MORTAR SHALL BE USED BETWEEN THE FRAME AND ADJUSTING RINGS AND BETWEEN ADJUSTING RINGS AND THE CONE SECTION IN ALL PAVED AREAS. E-Z STICK MAY BE USED IN LANDSCAPE AREAS.
- C. ALL STEPS MUST BE INSTALLED, ALIGNED AND CLEANED.
- D. ALL PINHOLES MUST BE MORTARED WITH BRUSH FINISH TO PROVIDE A WATERTICHT SEAL.
- E. THE UPSTREAM AND DOWNSTREAM PIPE CAVITIES MUST BE FILLED WITH MORTAR AND SMOOTHED WITH A BRUSH FINISH.
- F. THE UPSTREAM AND DOWNSTREAM FLOW LINES (INVERTS) SHALL HAVE A SMOOTH TRANSISTION FROM THE PIPE TO THE
- G. ALL MANHOLE STRUCTURES SHALL BE FREE OF ANY TYPE OF INFILTRATION (WATER LEAKING INTO THE STRUCTURE).
- H. IF THERE IS AN INTERNAL DROP IN THE STRUCTURE THERE MUST BE A SMOOTH TRANSITION FROM THE PIPE TO THE INVERT (I.E. CHANNEL THE FLOW FROM THE PIPE TO THE MANHOLE INVERT).
- ALL MANHOLES SHALL BE CLEANED OF ANY ACCUMULATON OF SILT, DEBRIS, OR FOREIGN MATTER OF ANY KIND, AND SHALL BE FREE FROM SUCH ACCUMULATIONS AT THE TIME OF FINAL INSPECTION.

GreenbergFarrow

1755 The Exchange Atlanta, GA 30339 t: 770 303 1033 f: 770 303 2333

| DATE | DESCRIPTION | 12-21-05 | 90% DTY SUBMITTAL | 01-30-06 | CITY RESUBMITTAL | 02-17-06 | COORDINATION SET

PROFESSIONAL SEAL

PROFESSIONAL IN CHARGE PROJECT MANAGE ALFONSO INCHAUSTI. PE QUALITY CONTROL SOMSAK KAGSWAST, PE

DAN ANGSPATT, EIT PROJECT NAME

TEXAS ROADHOUSE

MADISON WISCONSIN

4841 ANNAMARK DRIVE





20050922 8


SHEET TITLE


GENERAL NOTES


PRELIMINARY

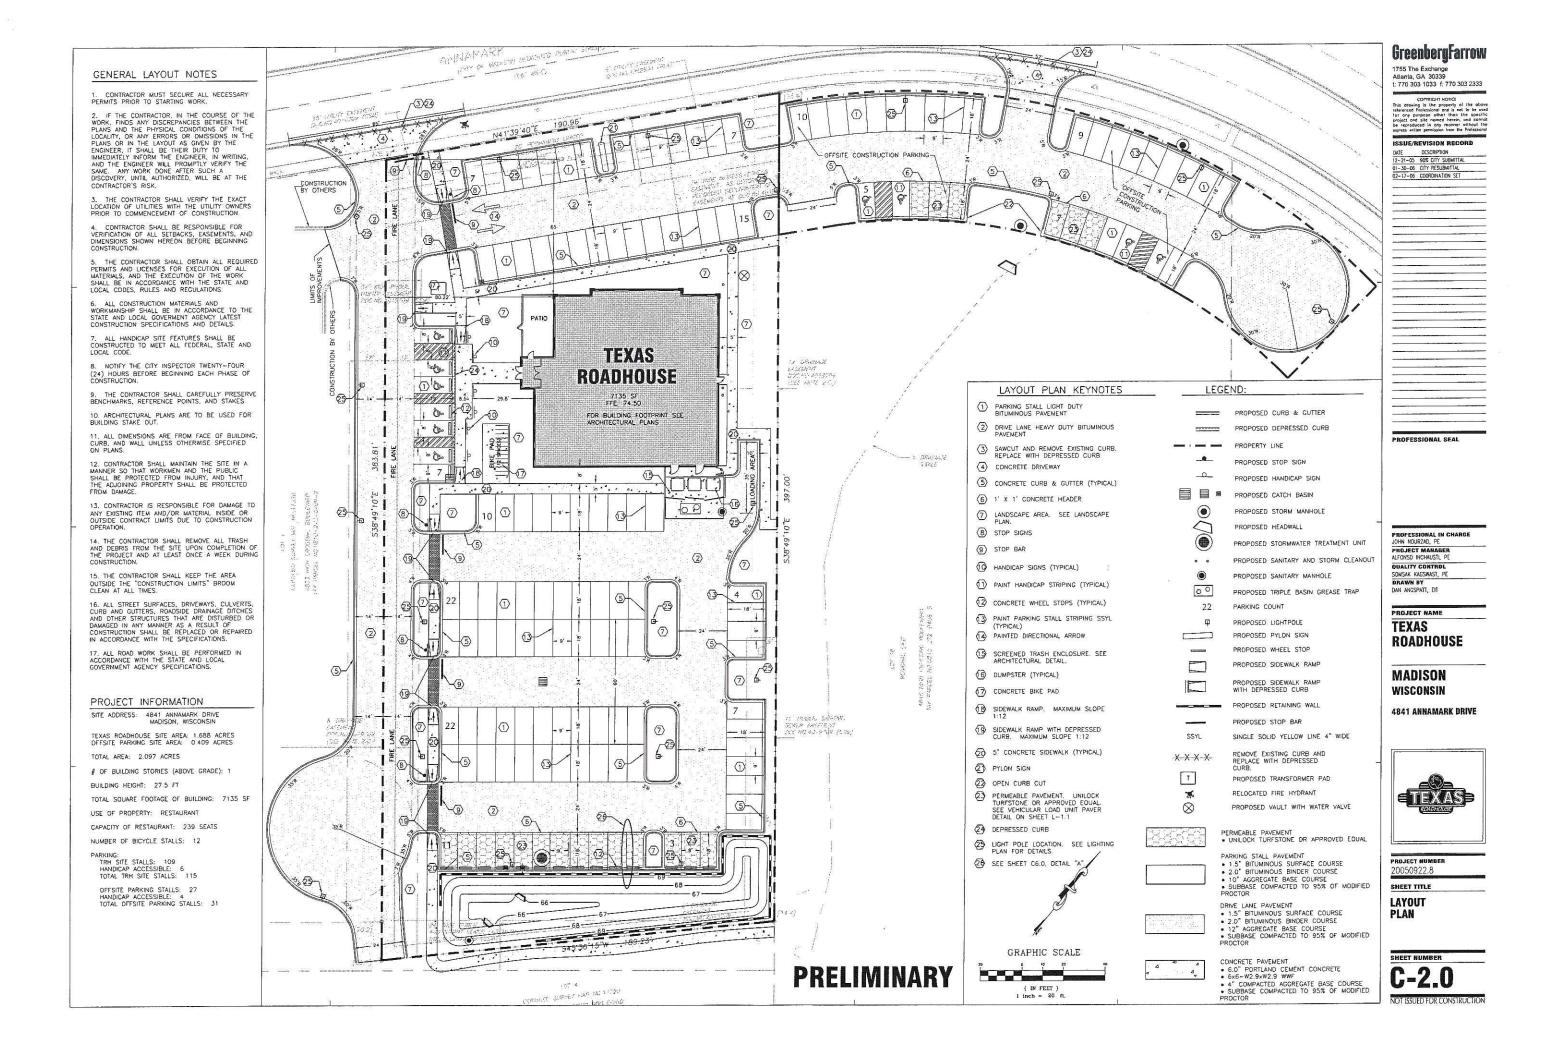


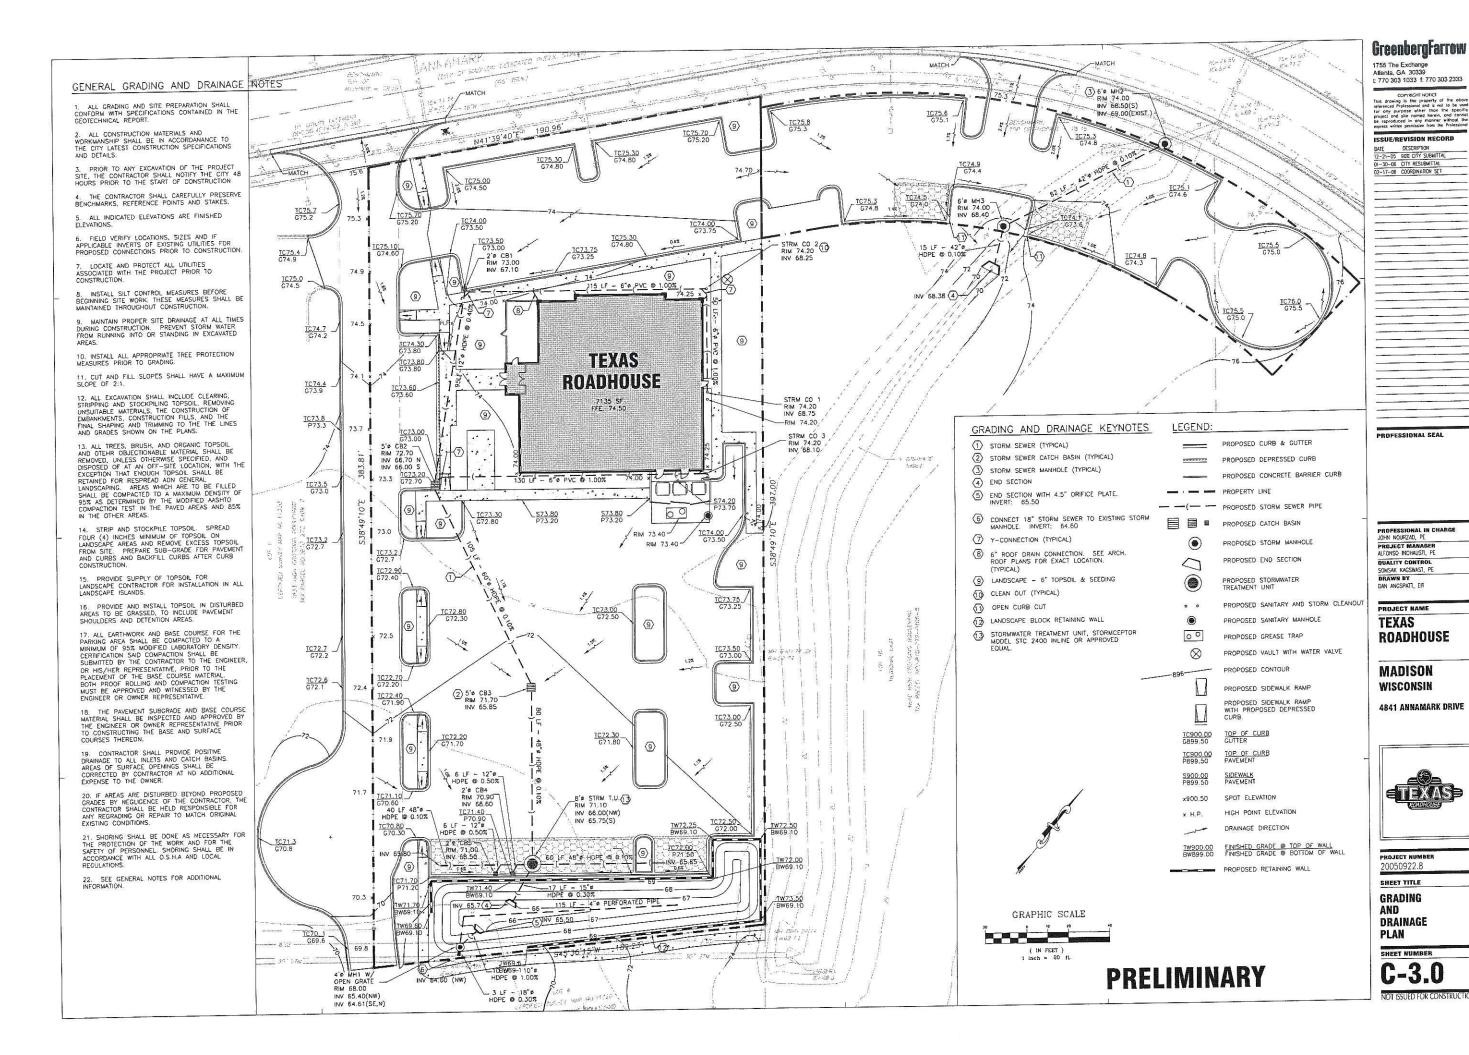

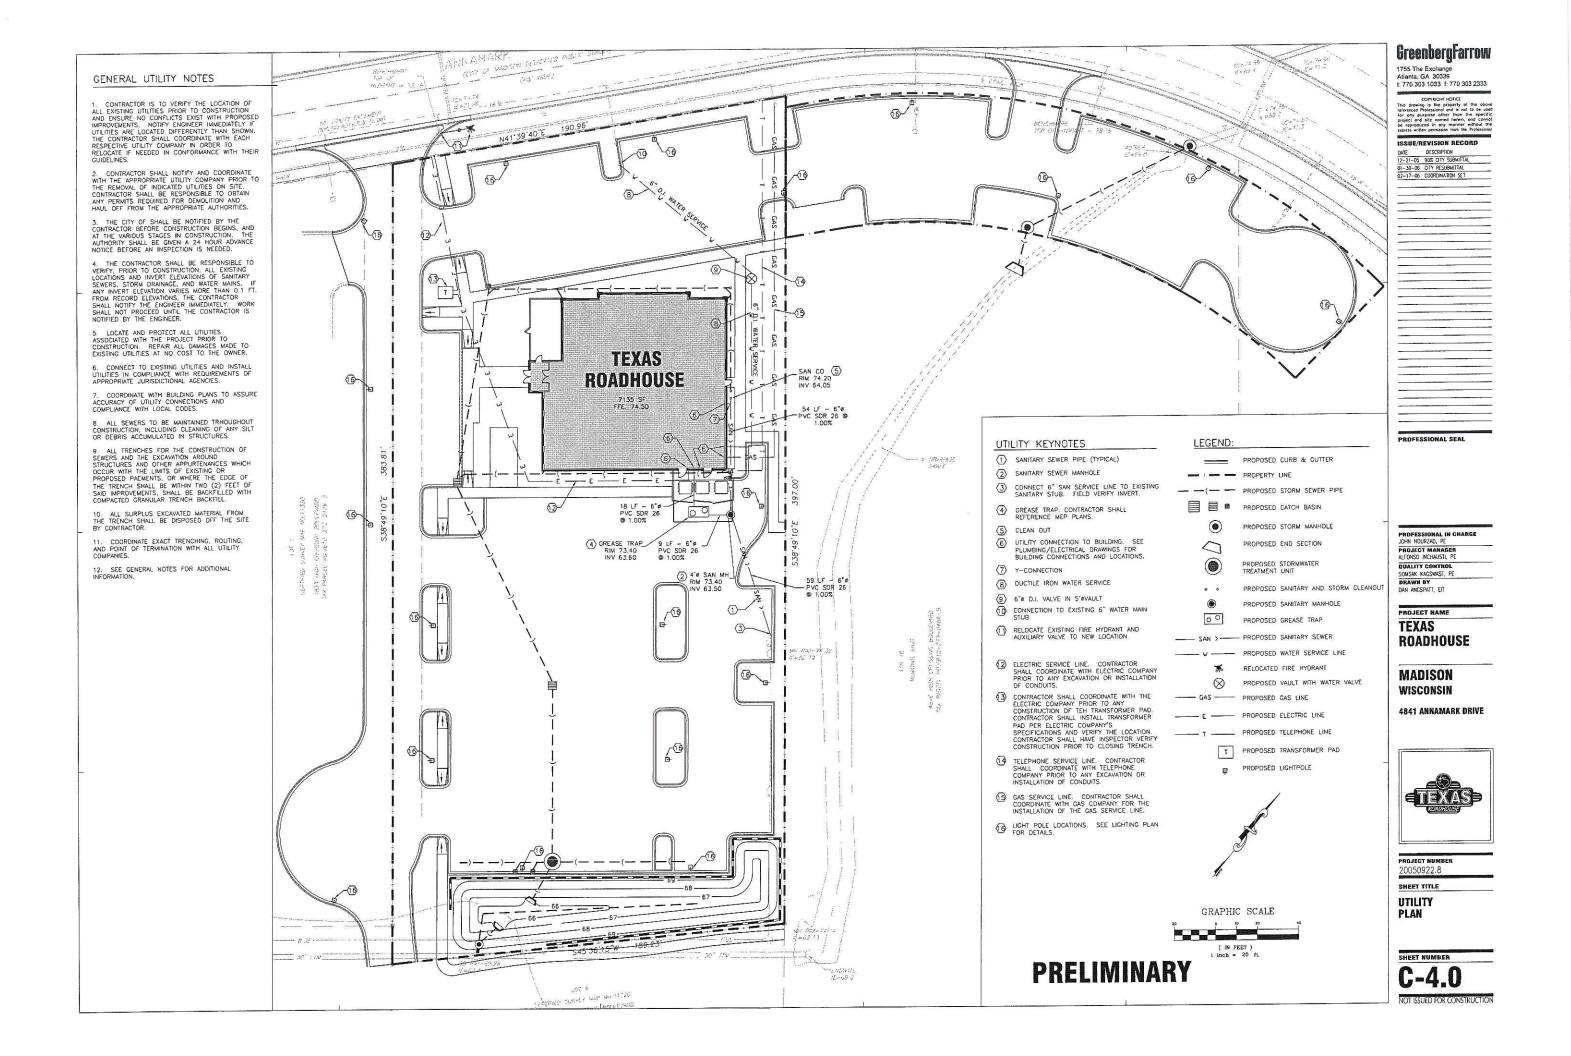


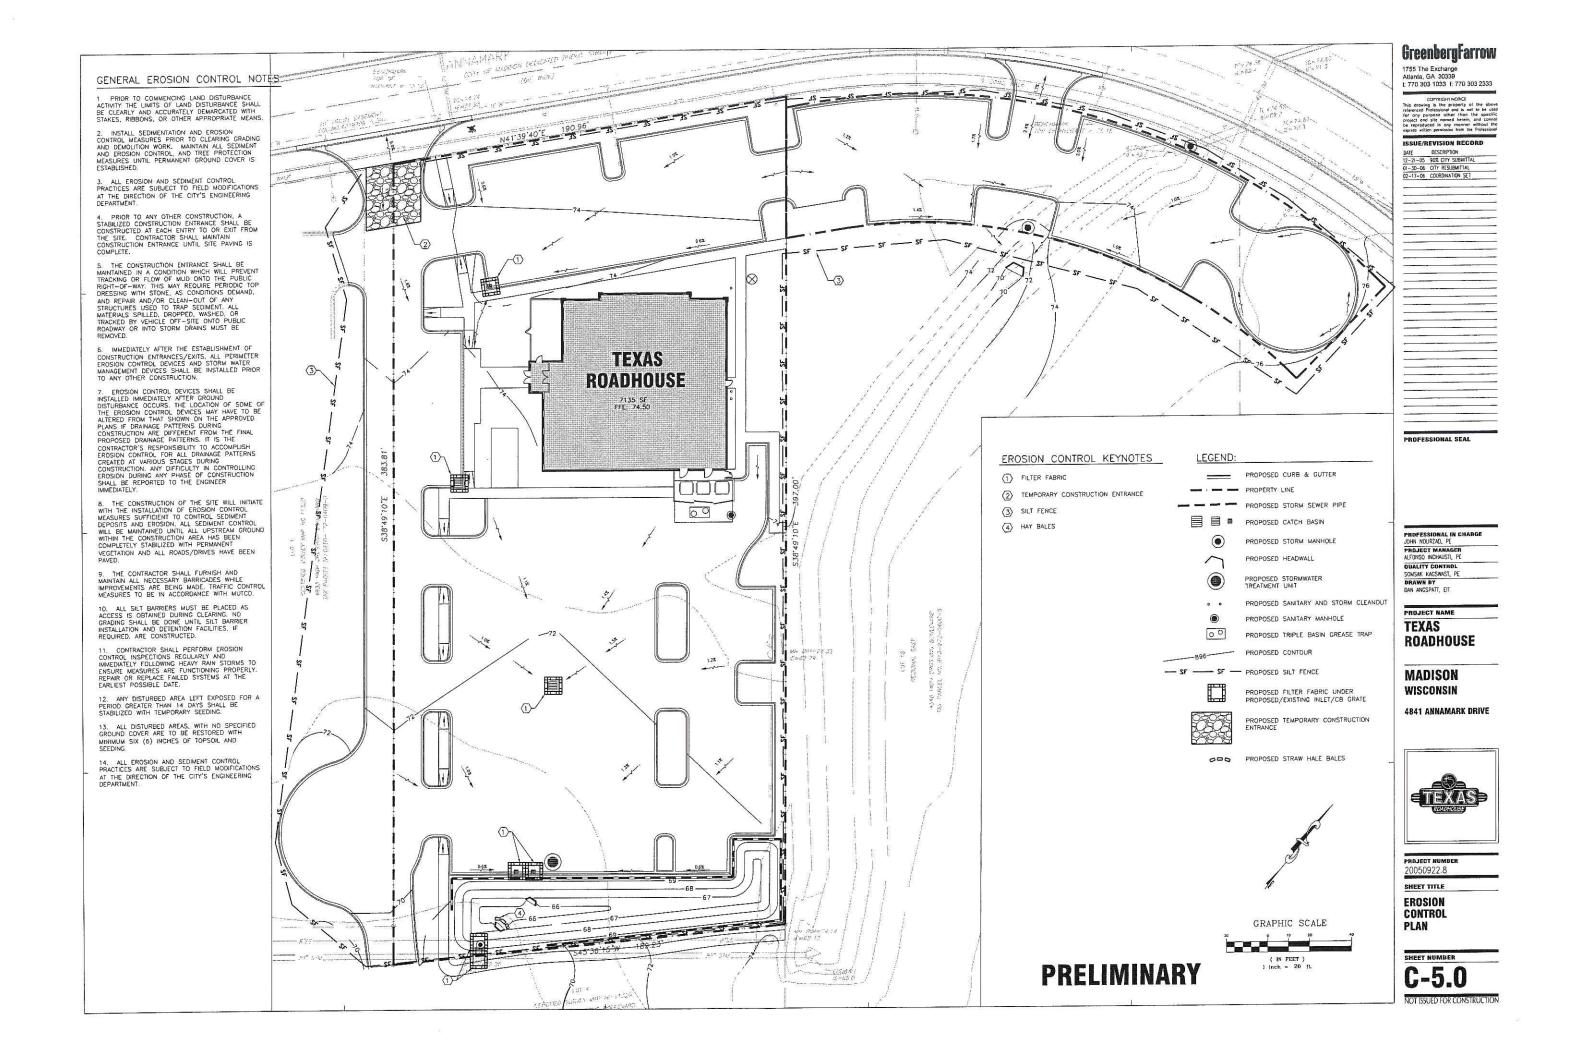

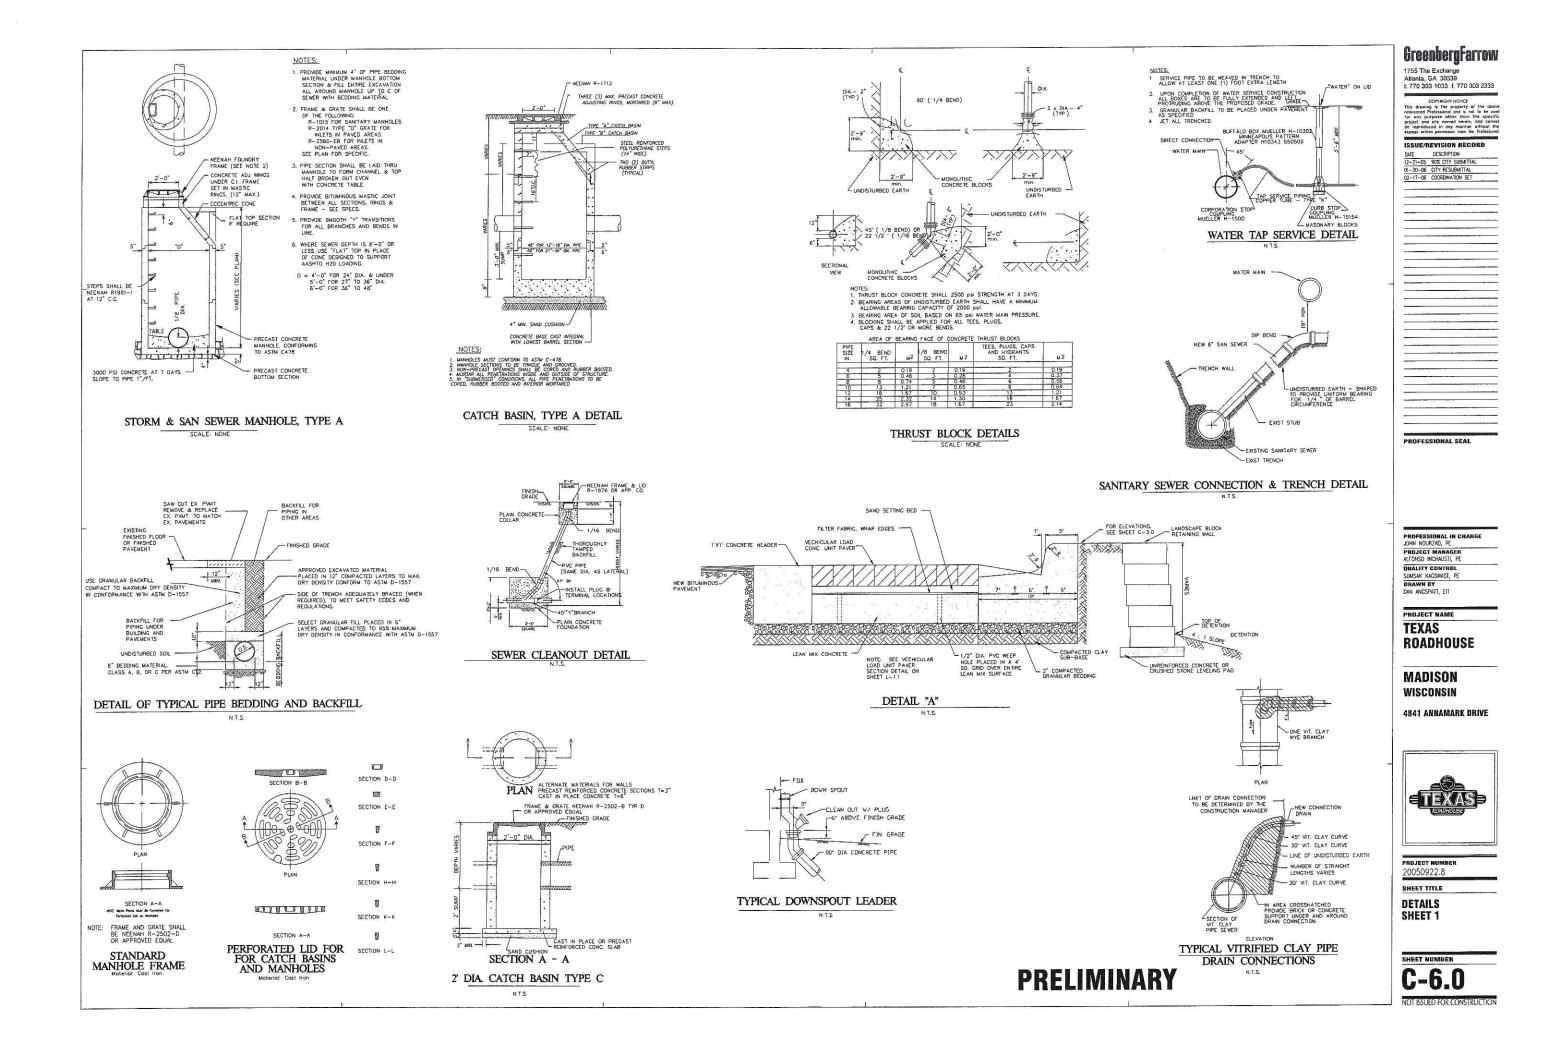


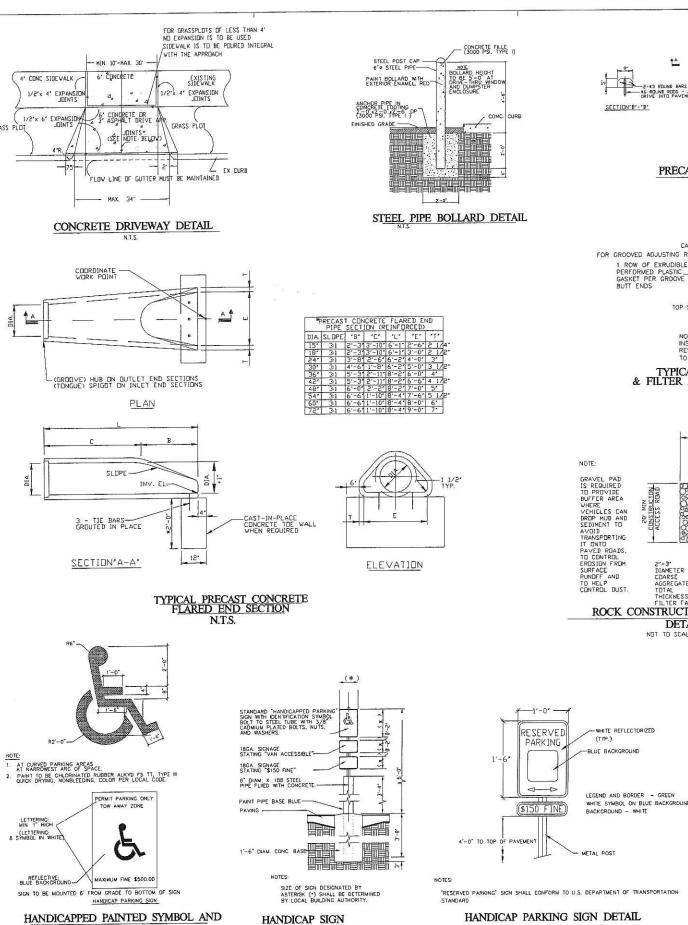


PARKING STALL DIMENSIONS

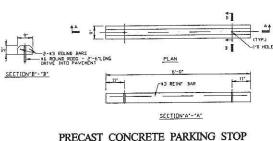

PRECAST CONCRETE PARKING STOP

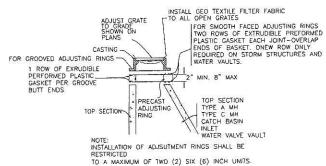


TYPICAL CASTING ADJUSTMENT & FILTER FABRIC INSTALLATION DETAIL NOT TO SCALE

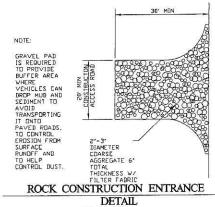

NOT TO SCALE

- WHITE REFLECTORIZED

(TYP.)

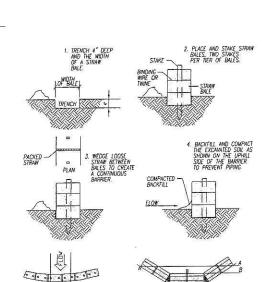

STRAW BALE BARRIER DETAIL

POINT "A" SHOULD BE HIGHER THAN POINT "B"

BOTTOM OF DRAINAGE WAY PLAN

PRELIMINARY


SECTION A-A

N.T.S.


SILT FENCE DETAIL

WIRE FENCE FILTER FABR

BURY TOE OF -FABRIC 12" (±)

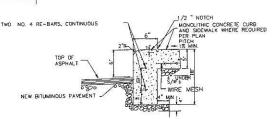

SIDEWALK-CURB COMBINATION DETAIL

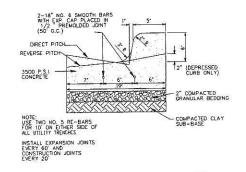

B6-12 CURB & GUTTER CURB



PROFESSIONAL SEAL

GreenbergFarrow 1755 The Exchange Atlanta, GA 30339 t: 770 303 1033 f: 770 303 2333

ISSUE/REVISION RECORD

PROJECT NAME **TEXAS** ROADHOUSE

MADISON WISCONSIN

4841 ANNAMARK DRIVE




PROJECT NUMBER

SHEET TITLE

DETAILS SHEET 2

SHEET NUMBER C-6.1

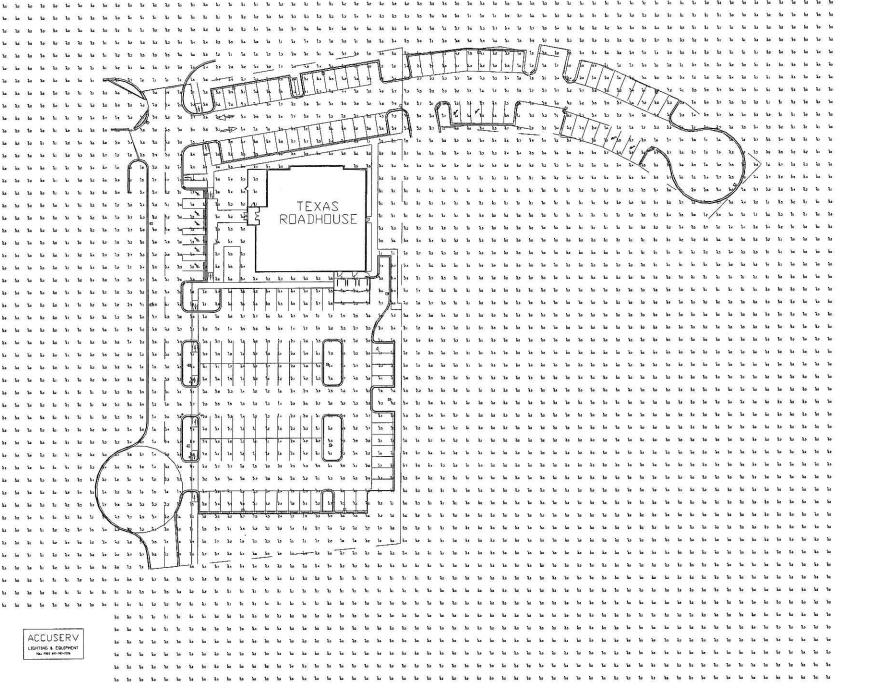

TEXAS ROADHOUSE MADISON, WI PREPARED BY: KEVIN LOEHLE ACCUSERV LIGHTING & EQUIPMENT TF: 877-707-7378 FX: 502-961-0357 kloehle@accu-serv.com FEBRUARY 15, 2006

PROFESSIONAL IN CHARGE
JOHN NOURZAD, PE
PROJECT MANAGER
ALFONSO INCHAUSTI, PE
QUALITY CONTROL
SOMSAK KAGSWAST, PE
DRAWN BY
DAN ANGSPAIT, EIT

GreenbergFarrow
1755 The Exchange
Atlanta, GA 30339
1: 770 303 1033 1: 770 303 2333

PROJECT NAME TEXAS

ROADHOUSE **MADISON**

WISCONSIN

4841 ANNAMARK DRIVE




SHEET TITLE

SITE LIGHTING PLAN

SHEET NUMBER

Statistical Area Summary Project: All Projects Avg 3.07 Avg/Min Max/Min Label Max 7.68 TRH PARKING AREA 9.5 23.75

_uminaine Sc	hedule					
roject: All	Projects	**************************************				
Symbol	Qty	Label	Arrangement	Lumens	LLF	Description
, H	15	A	SINGLE	36000	0.700	ACCVRSV400MHMT1DBM (2.5' BASE+20' POLE=22.5MH) SNTS2057SINGLEDBM
	4	В	SINGLE	36000	0.700	ACCVRSV400MHMT1DBM (2.5' BASE+20' PDLE=22.5MH) SNTS2057SINGLEDBM

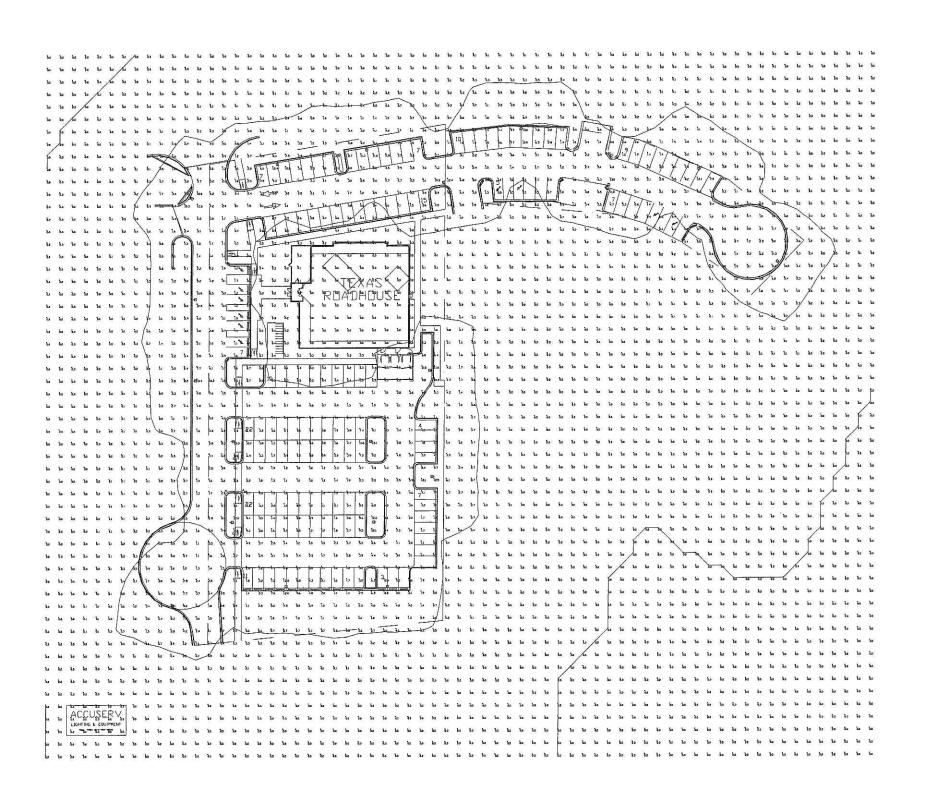

GreenbergFarrow

1755 The Exchange Atlanta, GA 30339 t: 770 303 1033 f: 770 303 2333

PROFESSIONAL SEAL

PROFESSIONAL IN CHARGE
JOHN NOURZAD, PE
PROJECT MANABER
ALFONSO INCHAUSII, PE
QUALITY CONTROL
SOMSAK KAGSWAST, PE
DRAWN BY
DAN ANGSPATT, EIT

PROJECT NAME

TEXAS ROADHOUSE

MADISON WISCONSIN


4841 ANNAMARK DRIVE




PROJECT NUMBER

SHEET TITLE

SITE LIGHTING PLAN

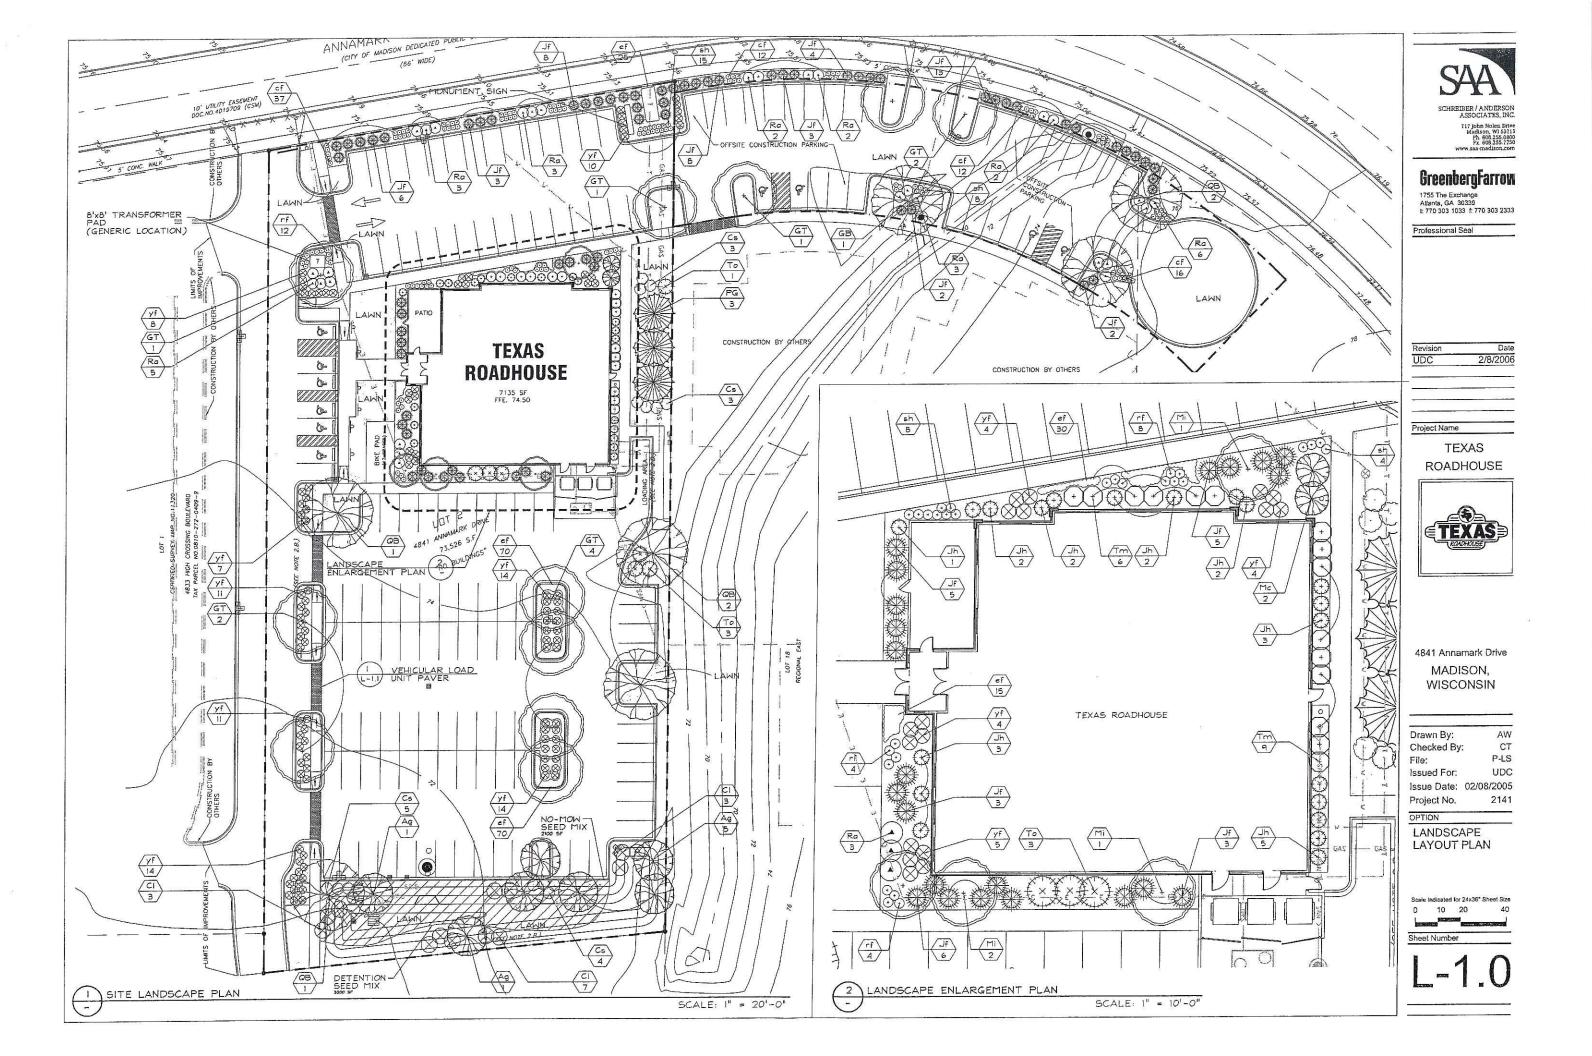

ORNA Ag Ag Mc (1)	DE TREES Gleditsia triocanthos var. inermis Skyline Quercus bicolor	Skyline Honeylocust Swamp White Oak	3" Cal.	B∮B			
ORNA Ag Ag Mc (1)	inermis Skyline Quercus bicolor AMENTAL TREES		2016 TIO-681400	B/B			
ORNA Ag Ag Mc (1) M	Quercus bicolor AMENTAL TREES	Swamp White Oak	3" Cal.	040	11	Small leaves	JN, BC, MC
Ag Ag Mc (1) Mc				B¢B	7	Tolerant to salt	JN, BC, MC
Ag Ag Mc (1) M				<u> </u>			
Mc (1) M	Amelanchier x Grand Autumn Brilliance'	Autumn Brill Serviceberry	6' MS	B¢B	7	20' O.C. spacing, Multi-stern	JN, BC, MC
71 (1) [Malus sp. 'Camelat'	Carnzarn (Comelot) Crabapple	2" Cal.	B¢B	2	10'Hx8'W, Rose pink flowers	JN, BC
	Malus sp. 'Indian Magic'	Indian Magic Crabapple	2" Cal.	B¢B	4	15'Hx15'W, Rose pink flowers	JN, MC, MI,
				4			1 2
	Picea glauca var. densata	Black Hills Spruce	6' Ht.	Cont.	3	15' O.C. spacing	JN, BC, MC,
EVER	GREEN SHRUBS					9	
F (2) J	luniperus chinensis 'Fruitlandii'	Fruitland Juniper	18" Ht.	Cont.	69	3'Hx6'W, bright green foliage	See Alts.
h (1) J	Juniperus chinensis 'Hooks'	Hooks' Juniper	4' Ht.	Cont.	20	15'Hx3'W, AKA - Hooks #6	IM , ML
m(1) T	Taxus x media 'Densiformis'	Dense Yew	24" Ht.	Cont.	15	5'Hx6'W, dark green foliage	JN, BC, LI,
o (1) T	Thuja occidentalis 'Holmstrup'	Holmstrup Arborvitae	3' Ht.	Cont.	7	12'Hx4'W, upright pyramidal	JN, MC, MI
DECID	DUOUS SHRUBS						
.1 (01	lethra alnifolia 'Ruby Spice'	Ruby Spice Clethra	5 Gal.	Cont.	13	5' O.C. spacing	JN, BC
s C	Cornus sericea 'Isanti'	Isanti Redtwig Dogwood	5 Gal.	Cont.	15	5' O.C. spacing	JN, MC, LI,
Ra R	Rhus aromatica 'Gro Lo'	Grow Lo Sumac	5 Gal.	Cont.	31	5' O.C. spacing	JN, MC, LI,
PEREI	NNIALS / GRASSES						
	alamagrostis acutiflora Karl Foerster'	Feather Reed Grass	2 Gal.	Cont.	77	21 O.C. spacing	JN, BC, MC,
	Rudbeckia hirta	Black-Eyed Susan	2 Gal.	Cont.	28	2'-6" O.C. spacing	JN, BC, MC,
h S	oprobolus heterolepsis	Prairie Dropseed	2 Gal.	Cont.	35	3' O.C. spacing	JN, BC, MC,
f Y	Tucca filamentosa	Adam's-needle Yucca	2 Gal.	Cont.	106	3' O.C. spacing	BC, MC, LI
CPO!!	NDCOVER5						
c (II) E		Purpleleaf Wintercreeper	2" P.P.	Cont	215	12" Q.C. spacing	JN, BC, MC

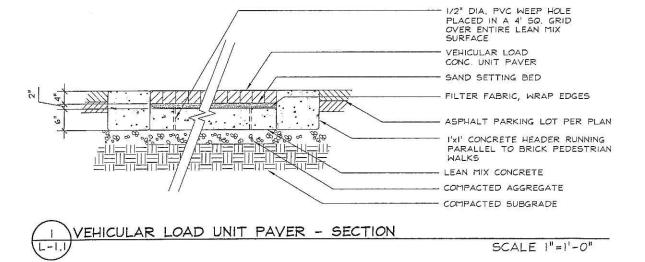

NOTES:

(I) VEGETATION PER TEXAS ROADHOUSE LANDSCAPE MANUAL (OHIO VALLEY LIST)

(2) ALTERNATIVES / SUPPLIERS FOR FRUITLAND JUNIPER

Juniperus chinensis 'Sea Green' Sea Green Juniper
 Juniperus x Pfitzeriana 'Kallay's Compocta' Kallay's Compoct Pfitzer

4'Hx6'W, mint green JN, MC, MI 3'Hx6'W, bright green JN, MC, MI

* SUPPLIER INFORMATION:

JOHNSON'S NURSERY, INC WIBO NG257 MARCY ROAD MENOMONEE FALLS, WI 53051 262.252.4950 P 262.252.4495 F

THE BRUCE COMPANY OF WISCONSIN P.O. BOX 620330 MIDDLETON, WI 53562 608.836.7041 P 608.836.0920 F

McKAY NURSERY 750 SOUTH MONROE STREET WATERLOO, WI 53594 800,236,4242 P 920,478,3615 F

MINOR'S GARDEN CENTER 7777 NORTH 76TH ST. MILWAUKEE, WI 53223 414.354.4830 F 414.354.5205 F

LIEDS NURSERY FARMS, INC. N63 W22039 HWY 74 SUSSEX, WI 53059 262.246.690! P 262.246.3822 F LI -

I. THE GENERAL CONTRACTOR SHALL LEAVE THE SITE AT FINISH GRADE. THE LANDSCAPE CONTRACTOR SHALL REVISE GRADES AT A MINIMUM TO ENSURE SMOOTH TRANSITIONS BETWEEN PLANTING BEDS AND LAWN AREAS

2. PLANT MATERIAL: SHALL BE HEALTHY, VIGOROUS AND REPRESENTATIVE OF SPECIES SPECIFIED; ALL PLANTS SHALL BE WELL BRANCHED AND PROPORTIONED AND FREE OF ALL INSECTS AND DISEASES.

3. PLANT GUARANTEE: ALL PLANTS SHALL BE GUARANTEED TO LIVE FOR TWELVE (12) MONTHS. THE GUARANTEE SHALL COMMENCE UPON FINAL ACCEPTANCE OF THE PROJECT. IF ANY PLANTS ARE DEAD OR IN AN UNHEALTHY CONDITION BEFORE FINAL ACCEPTANCE, THE LANDSCAPE CONTRACTOR SHALL REPLACE THEM AT HIS EXPENSE. THE REPLACEMENT SHALL NOT BE CONSIDERED A "GUARANTEED" REPLACEMENT.

4. TOPSOIL REQUIREMENTS FOR PLANTING OPERATIONS AND GRADING/MOUNDS SHALL BE NATURAL FRIABLE, FERTILE SOIL CHARACTERISTIC OF PRODUCTIVE SOIL IN THE VICINITY. IT SHALL BE FREE OF CLAY LUMPS, STONES, ROOTS AND OTHER FOREIGN MATTER.

5. MULCH: ALL PLANTING BEDS SHALL BE MULCHED WITH CRUSHED RED BRICK MULCH OR APPROVED EQUAL - 3" DEEP OVER WEED PREV. FABRIC. MULCH ALONG THE PERIMETER OF THE BUILDING SHALL BE 3/4" -1 1/4" WASHED RIVER GRAVEL 3" DEEP OVER WEED PREV. FABRIC.

6. PLANTING PERIOD: EXECUTE ALL LAWNWORK AND PLANTING BETWEEN MARCH 15TH AND MAY 15TH OR BETWEEN SEPTEMBER 1ST AND NOVEMBER 15TH, OR AS OTHERWISE DIRECTED BY OWNER.

7. INSTALLATION OF PLANT MATERIAL SHALL BE IN ACCORDANCE WITH THE AMERICAN ASSOCIATION OF NURSERYMEN LANDSCAPE STANDARDS AND WITH THE GENERAL PLANTING SPECIFICATIONS AS SET FORTH BY THE GOVERNING MUNICIPALITY.

8. ALL PLANT MATERIAL SHALL BE PLACED WITHIN A MULCHED PLANTING BED AS INDICATED IN NOTE NO. 5, AND ALL BEDS (EXCLUDING INDIVIDUAL TREE PLANTINGS) SHALL BE "EDGED" W/STEEL EDGING.

9. LAWN AND PLANT BEDS WILL BE IRRIGATED. THE IRRIGATION SYSTEM WILL INCLUDE ALL PIPING, HEADS, CONTROLLER, BACKFLOW PRESENTER, WIRING, SLEEVES UNDER HARD SURFACES AND OTHER NORMAL EQUIPMENT TO PROVIDE 100% COVERAGE OF ALL PLANTED AND LAWN AREAS.

10. ALL PLANT MATERIAL SHALL BE TREATED WITH A 'PREEN' APPLICATION

II. 'LAWN' AREAS SHALL BE FINISH-GRADED AND SEEDED AT A RATE OF 4 LBS. PER

12. AREAS LABELED 'LAWN' SHALL RECEIVE A MIXTURE OF THE FOLLOWING TYPES:
40% PALMER RYEGRASS
20% NASSAU BLUEGRASS
20% PENNLAWN CREEPING RED FESCUE

13. AREA LABELED 'DETENTION SEED MIX' SHALL BE SEEDED WITH PRAIRIE NURSERY (OR APPROVED EQUAL) "DETENTION BASIN MIX" ITEM # 50062 - 1.800.476.9453 (SEE LANDSCAPE PLANT LEGEND)

146 stalls

75 points

Il trees 712 points

115 stalls 31 stalls

LANDSCAPE POINTS / BUILDING DATA

CITY OF MADISON REQUIREMENTS Parking Stalls Provided Total Texas Roadhouse Parking Offsite Construction Parking

Loading Area Canopy Trees Required Required Landscape Points

TEXAS ROADHOUSE LANDSCAPE POINTS

Required Canopy Trees 0 Pts. = 35 Pts. = Canopy Trees 2-2.5" Trees 245 x 15 Pts. = 165 x 15 Pts. = 450 Canopy Trees 1.5"-2" 11 Trees 30 Trees Evergreen Trees 3'+ Ht. 2 Pts. 59 Shrubs Deciduous Shrub III Shrubs x 3 Pts 333 Evergreen Shrub

TOTAL LANDSCAPE POINTS Required Landscape Pts. Additional Pts.

229 Units

1301 Pts. 712 Pts. 589 Pts.



Ph. 608.255.0800 Fx. 608.255.7750

GreenbergFarrow

1755 The Exchange Atlanta, GA 30339 t: 770 303 1033 f: 770 303 2333

Professional Seal

Date UDC 2/8/2006

Project Name

TEXAS ROADHOUSE



4841 Annamark Drive MADISON. WISCONSIN


Drawn By: AW CT Checked By: P-LS UDC Issued For: Issue Date: 02/08/2005 2141 Project No. OPTION

LANDSCAPE


PLANT LEGEND

Scale Indicated for 24x36" Sheet Size

Sheet Number

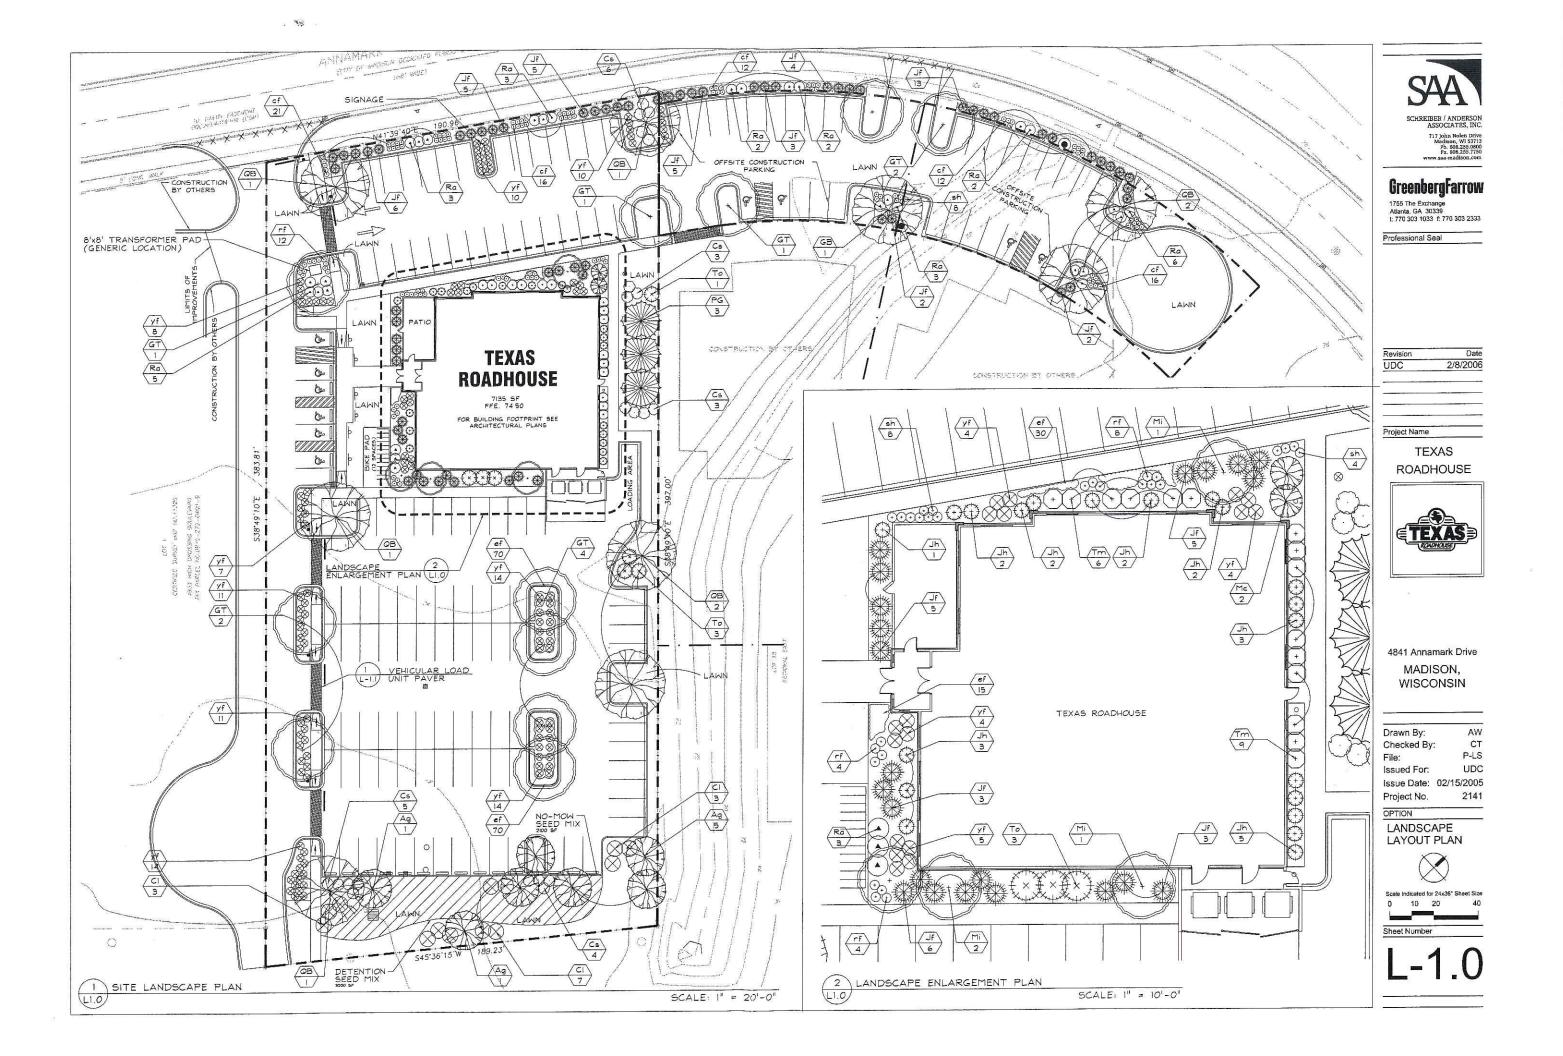

vmbol	Botanical name	Common Name	Size	Root	Quanity	Comments	Suppliers *
	DE TREES	A TOTAL CONTROL OF THE PARTY OF				10	
GT	Gleditsia triacanthos var.	Skyline Honeylocust	3" Cal.	B¢B	11	Small leaves	JN, BC, MC
OB.	inermis Skyline Quercus bicolor	Swamp White Oak	3" Cal.	B¢B	9	Tolerant to salt	JN, BC, MC, I
	SACTOR SECTION AND TOUR						
ORN	NAMENTAL TREES						
Ag	Amelanchier x Grand 'Autumn Brilliance'	Autumn Brill Serviceberry	6' M5	B≰B	7	20' O.C. spacing, Multi-stem	JN, BC, MC,
Mc (1)	Malus sp. 'Camelot'	Camzam (Camelol) Crabapple	2" Cal.	B#B	2	10'Hx8'W, Rose pink flowers	JN, BC
Mi (1)	Malus sp. 'Indian Magic'	Indian Magic Crabapple	2" Cal.	B¢B	4	15'Hx15'W, Rose pink flowers	JN, MC, MI, L
	TREES TREES						
PG EVE	RGREEN TREES Picea glauca var. densata	Black Hills Spruce	6' Ht.	Cont.	3	15' O.C. spacing	JN, BC, MC,
ı G	Title gjeres ta testes						
EVE	RGREEN SHRUBS						
Jf (2)	Juniperus chinensis 'Fruitlandii'	Fruitland Juniper	18" Ht.	Cont.	63	3'Hx6'W, bright green foliage	See Alts.
Jh (1)	Juniperus chinensis 'Hooks'	Hooks' Juniper	4' Ht.	Cont.	20	15'Hx3'W, AKA - Hooks #6	JN, MI
(1) m	Taxus x media 'Densiformis'	Dense Yew	24" Ht.	Cont.	15	5'Hx6'W, dark green foliage	JN, BC, LI, F
To (1)	Thuja occidentalis 'Holmstrup'	Holmstrup Arborvitae	3' Ht.	Cont.	7	12'Hx4'W, upright pyramidal	JN, MC, MI
DEC	IDUOUS SHRUBS						
CI	Clethra alnifolia 'Ruby Spice'	Ruby Spice Clethra	5 Gol.	Cont.	13	5' O.C. spacing	JN, BC
Cs	Cornus sericea 'Isanti'	Isanti Redtwig Dogwood	5 Gal.	Cont.	21	5' O.C. spacing	JN, MC, LI, T
Ra	Rhus aromatica 'Gro Lo'	Grow Lo Sumac	5 Gal.	Cont.	31	5' O.C. spacing	JN, MC, LI, M
							1
PER	RENNIALS / GRASSES				T	221 (22 Car.) Washington	IN BC MC
cf	Calamagrostis acutiflora 'Karl Foerster'	Feather Reed Grass	2 Gal.	Cont.	77	2' O.C. spacing	JN, BC, MC,
rf	Rudbeckia hirta	Black-Eyed Susan	2 Gal.	Cont.	28	2'-6" O.C. spacing	JN, BC, MC,
sh	Sprobolus heterolepsis	Prairie Dropseed	2 Gal.	Cont.	21	3' O.C. spacing	JN, BC, MC,
yf	Yucca filamentosa	Adam's-needle Yucca	2 Gal.	Cont.	106	3' O.C. spacing	BC, MC, LI
CBC	DUNDCOVERS	4	<u> </u>				1
GKC	Euonymus fortunei var.				215	12" O.C. spacing	JN, BC, MC

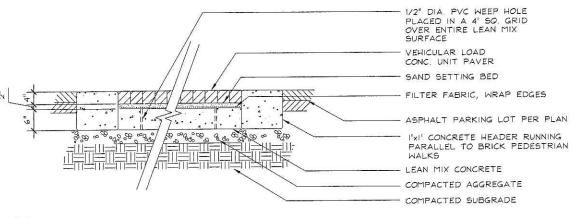

I VEHICULAR LOAD UNIT PAVER - SECTION

SCALE 1"=1'-0"

NOTES:

(1) VEGETATION PER TEXAS ROADHOUSE LANDSCAPE MANUAL (OHIO VALLEY LIST)

(2) ALTERNATIVES / SUPPLIERS FOR FRUITLAND JUNIPER

Juniperus chinensis 'Sea Green'
 Sea Green Juniper
 Juniperus x Pfikterinan 'Kallay's Compacta'
 Kallay's Compact Pfikter

4'Hx6'W, mint green JN, MC, MI 3'Hx6'W, bright green JN, MC, MI

* SUPPLIER INFORMATION:

IN - JOHNSON'S NURSERY, INC WIBO N6257 MARCY ROAD MENOMONEE FALLS, WI 53051 262.252.4980 P 262.252.4995 F

BC - THE BRUCE COMPANY OF WISCONSIN P.O. BOX 620330 MIDDLETON, MI 53562 608.836 7041 P 608.836 0720 F

MC - McKAY NURSERY 750 SOUTH MONROE STREET WATERLOO, WI 13594 800,236 4242 P 920,478,3615 F MI - MINOR'S GARDEN CENTER 7777 NORTH 76TH ST. MILWAUKEE, WI 53223 414.354.4830 P 414.354.5205 F

LI - LIEDS NURSERY FARMS, INC. N63 M22039 HMT 74 SUSSEX, MI 53089 262,246,6401 P 262,246,8622 F

I. THE GENERAL CONTRACTOR SHALL LEAVE THE SITE AT FINISH GRADE. THE LANDSCAPE CONTRACTOR SHALL REVISE GRADES AT A MINIMUM TO ENSURE SMOOTH TRANSITIONS BETWEEN PLANTING BEDS AND LAWN AREAS

2. PLANT MATERIAL: SHALL BE HEALTHY, VIGOROUS AND REPRESENTATIVE OF SPECIES SPECIFIED; ALL PLANTS SHALL BE WELL BRANCHED AND PROPORTIONED AND FREE OF ALL INSECTS AND DISEASES.

3. PLANT GUARANTEE: ALL PLANTS SHALL BE GUARANTEED TO LIVE FOR TWELVE (12) MONTHS. THE GUARANTEE SHALL COMMENCE UPON FINAL ACCEPTANCE OF THE PROJECT IF ANY PLANTS ARE DEAD OR IN AN UNHEALTHY CONDITION BEFORE FINAL ACCEPTANCE, THE LANDSCAPE CONTRACTOR SHALL REPLACE THEM AT HIS EXPENSE. THE REPLACEMENT SHALL NOT BE CONSIDERED A "GUARANTEED" REPLACEMENT.

4. TOPSOIL REQUIREMENTS FOR PLANTING OPERATIONS AND GRADING/MOUNDS SHALL BE NATURAL FRIABLE, FERTILE SOIL CHARACTERISTIC OF PRODUCTIVE SOIL IN THE VICINITY. IT SHALL BE FREE OF CLAY LUMPS, STONES, ROOTS AND OTHER FOREIGN MATTER.

5. MULCH: ALL PLANTING BEDS SHALL BE MULCHED WITH CRUSHED RED BRICK MULCH OR APPROVED EQUAL - 3" DEEP OVER WEED PREV. FABRIC. MULCH ALONG THE PERIMETER OF THE BUILDING SHALL BE 3/4" -1 1/4" WASHED RIVER GRAVEL 3" DEEP OVER WEED PREV. FABRIC.

6. PLANTING PERIOD: EXECUTE ALL LAWNWORK AND PLANTING BETWEEN MARCH 15TH AND MAY 15TH OR BETWEEN SEPTEMBER 15T AND NOVEMBER 15TH, OR AS OTHERWISE DIRECTED BY OWNER.

7. INSTALLATION OF PLANT MATERIAL SHALL BE IN ACCORDANCE WITH THE AMERICAN ASSOCIATION OF NURSERYMEN LANDSCAPE STANDARDS AND WITH THE GENERAL PLANTING SPECIFICATIONS AS SET FORTH BY THE GOVERNING MUNICIPALITY.

8. ALL PLANT MATERIAL SHALL BE PLACED WITHIN A MULCHED PLANTING BED AS INDICATED IN NOTE NO. 5, AND ALL BEDS (EXCLUDING INDIVIDUAL TREE PLANTINGS) SHALL BE "EDGED" W/STEEL EDGING.

9. LAWN AND PLANT BEDS WILL BE IRRIGATED THE IRRIGATION SYSTEM WILL INCLUDE ALL PIPING, HEADS, CONTROLLER, BACKFLOW PRESENTER, WIRING, SLEEVES UNDER HARD SURFACES AND OTHER NORMAL EQUIPMENT TO PROVIDE 100% COVERAGE OF ALL PLANTED AND LAWN AREAS.

10. ALL PLANT MATERIAL SHALL BE TREATED WITH A 'PREEN' APPLICATION

II, 'LAWN' AREAS SHALL BE FINISH-GRADED AND SEEDED AT A RATE OF 4 LBS. PER 1,000 SQ. FT.

12. AREAS LABELED 'LAWN' SHALL RECEIVE A MIXTURE OF THE FOLLOWING TYPES: 40% PALMER RYEGRASS 20% BARON BLUEGRASS 20% PENNLAWN CREEPING RED FESCUE

13. AREA LABELED 'DETENTION SEED MIX' SHALL BE SEEDED WITH PRAIRIE NURSERY (OR APPROVED EQUAL) "DETENTION BASIN MIX" ITEM # 50062 - 1.800,476,9453 (SEE LANDSCAPE PLANT LEGEND)

LANDSCAPE POINTS / BUILDING DATA

CITY OF MADISON REQUIREMENTS

Parking Stalls Provided Total
Texas Roadhouse Parking
Offsite Construction Parking
Loading Area
Canopy Trees Required
Required Landscape Points
146 stalls
115 stalls
75 points
11 trees
712 paints

TEXAS ROADHOUSE LANDSCAPE POINTS

Required Canopy Trees II Trees 35 Pts. = 245 15 Pts. = 195 Canopy Trees 2-2.5" 7 Trees Canopy Trees 1.5"-2" 13 Trees 450 30 Trees 15 Pts. Evergreen Trees 3'+ Ht. 59 Shrubs 2 Pts. Deciduous Shrub 333 III Shrubs Evergreen Shrub

TOTAL LANDSCAPE POINTS Required Landscape Pts. Additional Pts.

231 Units

nits

1331 Pts.

712 Pts. 619 Pts. SAA

SCHREIBER / ANDERSON ASSOCIATES, INC. 717 John Nolen Drive Madison, WI 53713 Ph. 608.255.0800 Px. 608.255.730 www.saa-madison.com

GreenbergFarrow

1755 The Exchange Atlanta, GA 30339 t: 770 303 1033 f: 770 303 2333

Professional Seal

evision Date JDC 2/8/2006

Project Name

TEXAS ROADHOUSE



4841 Annamark Drive MADISON, WISCONSIN

Drawn By: AW
Checked By: CT
File: P-LS
Issued For: UDC
Issue Date: 02/15/2005
Project No. 2141
OPTION
LANDSCAPE

Scale Indicated for 24x36" Sheet Size 0

PLANT LEGEND

Sheet Number

L-1.1





SCHREIBER / ANDERSON ASSOCIATES, INC. 717 John Nolen Drive Madison, WI 53713 Ph 698 255 0800 Px 608.255,7550 www.sae-madison.com

GreenbergFarrow

1755 The Exchange Atlanta, GA 30339 t: 770 303 1033 f: 770 303 2333

Professional Seal

 Revision
 Date

 UDC
 2/8/2006

Project Name

TEXAS ROADHOUSE



4841 Annamark Drive MADISON, WISCONSIN

 Drawn By:
 AW

 Checked By:
 CT

 File:
 P-LS

 Issued For:
 UDC

 Issue Date:
 02/08/2005

 Project No.
 2141

ILLUSTRATIVE

OPTION



Scale Indicated for 24x36" Sheet 9

Sheet Number

L1.2

LANDSCAPE WORKSHEET
Parking Lots, Storage Areas and Loading Areas
(Section 28.04 Madison General Ordinance)

200	VOTATION DO NOT SEL SOLI	Address:
	この方を行うということ	Owner/Contact:
	けるなりなるなどが可	Name of Project:
	ddress: 404 エスマスアフトリ	Project Location/A

For parking lots with greater than 20 stalls, landscape plans must be stamped by a registered landscape architect

	-
	17
	Ē
	=
	긁
	ō
ı	of
	-
	-
	Trees
	es
	Z
	œ
	×
	≐ .
	o o
	á.

The number of trees required for a parking lot is based on the number of parking stalls. Using the Schedule for Required Trees on the reverse side of this worksheet, determine the number of trees required. (Example: One tree is required for 10 parking stalls).

Landscape requirements for storage areas are determined by dividing the total square footage of the storage area by (300) square feet. This converts <u>area</u> to <u>stalls.</u> [Example: 10,000 square feet is equivalent to (33) stalls or (3) trees and (160) points].

					
Number of Points Required (See Schedule on reverse side)————————————————————————————————————	The number of points required for <u>loading areas</u> is (75) points for each loading berth. ————————————————————————————————————	Number of Landscape Points Required The number of points required is also based on the number of parking stalls. Using the Point Schedule for Landscape Elements on the reverse side of this worksheet, determine the number of points required. (Example: 49.5 points are required for 10 stalls). A point fraction of (.5) or less may be disregarded, while a fraction in excess of (.5) must be counted as one point. Thus: 49.5 points would be rounded down to 49.0 points required.	Number of Canopy Shade Trees Required (2" - 2 1/2" Caliper)(See Schedule on reverse side)	Total Square Foolage of the Storage Area Divided by Three Hundred (300) Square Feet	Number of Parking Stalls ———————————————————————————————————
712	מל	(25)	TOTAL		146

Tabulation of Points and Credits Indicate below the quantity and points for all pertinent landscape elements. Also, credit information for boundary screening and any existing elements to be retained.

	Canopy Tree or Small Tree 1 ½" - 2" Caliper (i.e., Crab, Hawthorn)	Evergreen Trees 3' height minimum	Earth Berm (per 10 L.F.) Avg. Height 30" Avg. Height 15"	Decorative Wall or Fence (per 10 L.F.)	Evergreen Shrub	Deciduous Shrub	Canopy Tree: 2" - 2 1/2*	ELEMENT	
	15	15	2 5	Ն	w	2	35	POINT VALUE	
Sub Totals	-	00	1	1		539	_1	QUANTITY	
Sub Totals [30]	105	450	1	}	288	8011	245	POINTS ACHIEVED	
+								QUANTITY	CREDITS
0					******			POINTS	STI
							**		2


*Trees required in Part I above, are not to be included in the point count.

= I30]

Total No. of Points Provided (Equal to or greater than points required)

TOTAL

Approved by: Date:

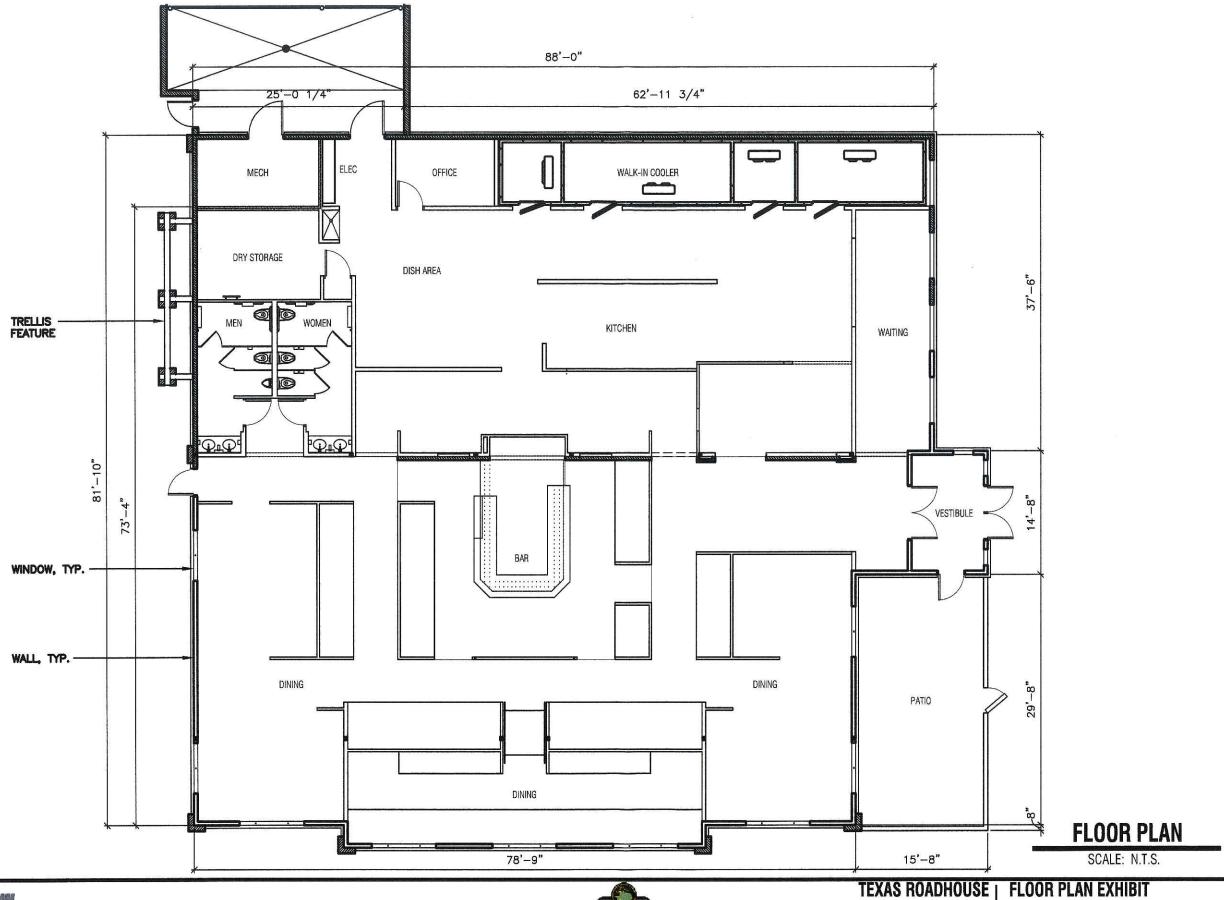


3455 Salt Creek Lane, Suite 100 Arlington Heights, Illinois 60005 t: 847 788 9200 f: 847 788 9536



4841 ANNAMARK DRIVE MADISON, WISCONSIN 20050922 A1.0

CITY REVIEW: 11/09/05 CITY SUBMISSION: 12/21/05 CITY SUBMISSION: 02/08/06

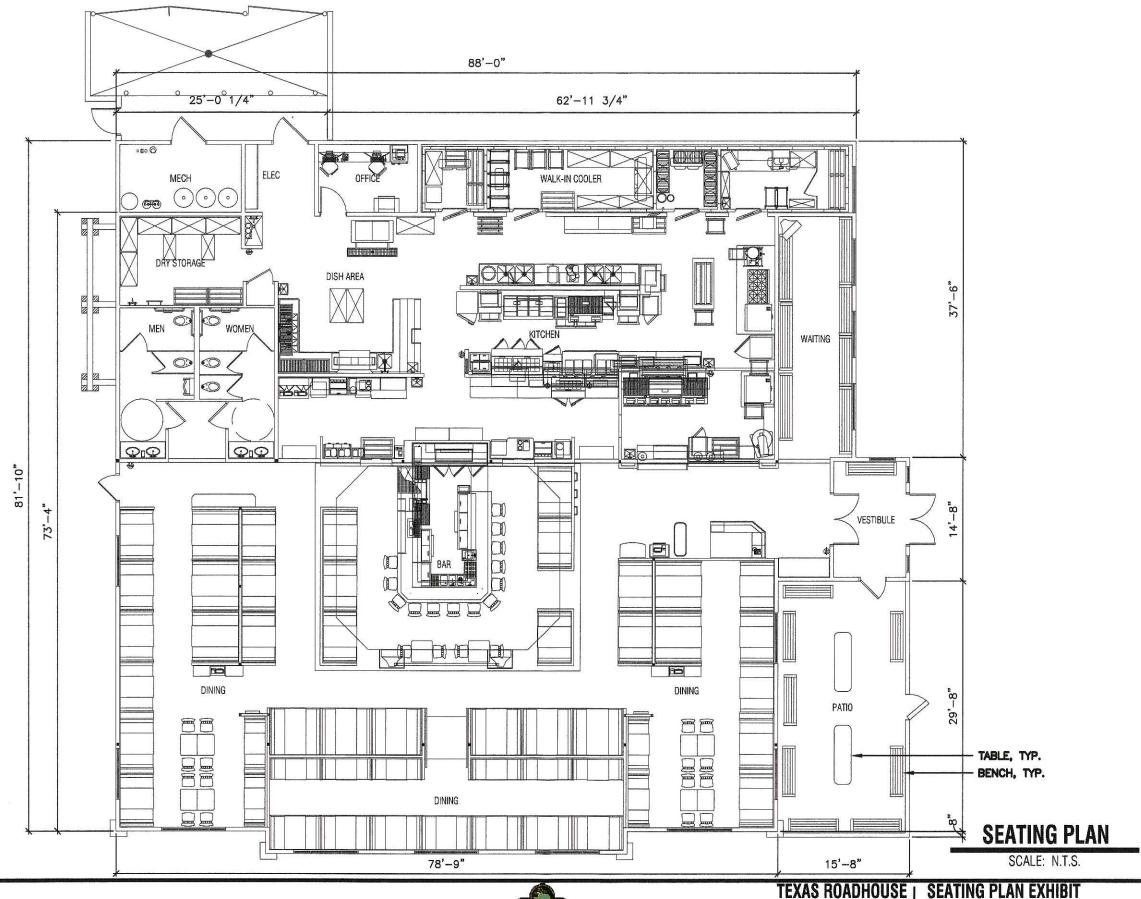



3455 Salt Creek Lane, Suite 100 Arlington Heights, Illinois 60005 t: 847 788 9200 f: 847 788 9536



4841 ANNAMARK DRIVE MADISON, WISCONSIN

20050922

A1.1

CITY REVIEW: 11/09/05 CITY SUBMISSION: 12/21/05 CITY SUBMISSION: 02/08/06



SCALE: N.T.S.



EXTERIOR FINISH SCHEDULE BUILDING ITEMS DESCRIPTION WOOD PRE-STAINED CEDAR & TRIM HENRY POOR LUMBER 3200 REAGAN DRIVE LAFAYETTE, IN 47906 CONTACT: DOUG MILLER PHONE: 800-255-7913 AMTECO #510 STAIN FORMULA AMTECO TWP510 STAIN FORMULA AND TWO COATS OF URETHANE FRONT ENTRANCE WOOD DOORS PORTER PAINTS #617 "EXTERIOR GLOSS" FINISH COLOR - DARK GREEN FORMULA: 2Y16E/2Y13L/8Y10P/1Y24C/2YV NOTE: TWO COATS-BRUSH APPLIED (DO NOT SPRAY) METAL FLASHING PORTER PAINTS #617 "EXTERIOR GLOSS" FINISH COLOR - DARK GREEN AND GUTTERS FORMULA: 2Y16E/2Y13L/8Y10P/1Y24C/2YV WOOD DOOR PORTER PAINTS #610 "EXTERIOR GLOSS" FINISH COLOR TO MATCH PRE-STAINED CEDAR - PRIMER/TWO FINISH COATS #614 BASE 14YJ/2Y3M/1424K/4P/2Y-V STONE WAINSCOT HERITAGE STONE "OTTAWA DRYSTACK" 4" THICK VENEER HERITAGE STONE 3819 OLD WHEELING RD. ZANESVILLE, OH 43701 PHONE: 740-450-4236 CHEROKEE SANFORD BRICK COMPANY BRICK #1 BRICK VENEER "PHOENIX" #143 OVERSIZE SANFORD, NORTH CAROLINA 1-800-277-2700 ILLINOIS BRICK COMPANY BRICK #2 BRICK ACCENTS "ST. LOUIS" MODULAR SIZE 3-1/2" x 2-1/4" x 7-5/8" OR EQUAL COLOR 5 RIBBED V GROOVED METAL ROOF COLOR: GALVALUME DUMPSTER GATES. PAINT #4: BOLLARDS, METAL PORTER PAINTS "EXTERIOR GLOSS" BLACK - PRIMER/TWO FINISH COATS DOORS & FRAMES DOWNSPOUTS PORTER PAINTS "EXTERIOR GLOSS" FINISH COLOR TO MATCH BRICK PAINT #6: WOOD SHUTTERS PORTER PAINTS "EXTERIOR GLOSS" BLACK - PRIMER/TWO FINISH COATS

DISCLAIMER

THE COLORS DEPICTED ON THESE ELEVATIONS ARE FOR GRAPHIC REPRESENTATION PURPOSES ONLY. PLEASE REFER TO MATERIAL BOARD FOR ACTUAL SAMPLE OF COLORS AND TEXTURES

REAR (SOUTH) ELEVATION

SCALE: N.T.S.





20050922



SCALE: N.T.S.




RIGHT (WEST) ELEVATION

SCALE: N.T.S.





ELEVATIONS

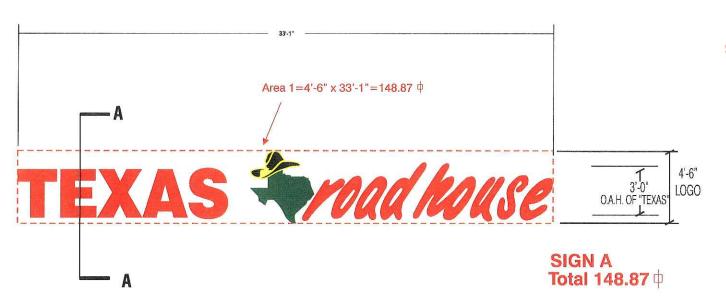

SIGN A [1] SET OF EXPOSED NEON CHANNEL LETTERS READING "TEXAS roadhouse" PAINTED T/M GRIP GARD #108 D5 GLOSS-RED,

WITH DOUBLE-TUBE CLEAR RED NEON IN "TEXAS" AS WELL AS "roadhouse".

REMOTE 30 M.A. TRANSFORMERS LOCATED BEHIND THE FASCIA WALL.

LETTERS TO BE MOUNTED FLUSH ON THE BUILDING FASCIA.

LOGO: {1} EXPOSED NEON CHANNEL LOGO WITH ARLON #2500-76 HOLLY GREEN VINYL BACKGROUND,

WITH A 1.25" EDGE BORDER ON THE "STATE OF TEXAS" WHITE ,PAINT RETURNS WHITE.

"HAT" IS EXPOSED NEON CHANNEL WITH ARLON #2500-22 BLACK VINYL.

"ACCENT, 1.25" EDGE BORDER & INSIDE LINES" ARE #2500-15 YELLOW VINYL.


STOREFRONT ELEVATION

3/16" = 1'-0"

DEDICATED CIRCUITS

SIGN "A" - 2 (TWO) 120V -20 AMP CIRCUITS

ALL BRANCH CIRCUITS SHALL BE DEDICATED TO SIGNS(INCLUDING GROUND AND NEUTRAL) AND SHALL NOT BE SHARED WITH OTHER LOADS

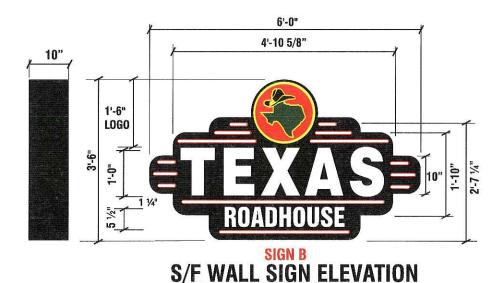

SIGN B Fabricated S/F Aluminum Cabinet Painted Semi-Gloss Black Finish On Face and Filler.


> "Texas Logo" Circle To Be Routed And Backed With White Acrylic Having Vinyl Color Applied To Face Surface. Bkg'd Is Arlon 2500-43 Light Tomato Red W/ 3/4" 2500-15 Yellow Border.

"Hat" Is 2500-22 Black W/ 2500-15 Yellow Outline.

State Is 2500-76 Holly Green W/ 2500-15 Yellow Outline.

"Texas Roadhouse" Copy To Be Routed Out Of Face And Backed W/ 7328 White Acrylic

"Accent Stripes" To Be Routed Out And Backed W/ #7328 White Acrylic W/ 2500-43 Red Vinyl 1/2" Outline On first Surface of Acrylic Face. Internally Illuminated With 800 MA Cool White Fluorescent Lamps. Flush Mount To Wall.

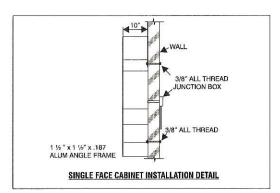

SIDE ELEVATION

1/8"=1'-0"

File Name:

DEDICATED CIRCUITS

SIGN "B" - 1(ONE) 120V-20 AMP CIRCUIT

ALL BRANCH CIRCUITS SHALL BE DEDICATED TO SIGNS(INCLUDING GROUND AND NEUTRAL) AND SHALL NOT BE SHARED WITH OTHER LOADS

NON-STANDARD SIGNAGE: ROUTED COPY W/ ACRYLIC BACKUP



SIGN COMPANY www.FederalHeath.com

160 W. Carmel Drive, Suite 236 Carmel, IN 46032 (317) 581-7790 Fax (317) 581-7783

Other Office Locations:

1/2"=1'-0" Total Enveloped Sq. Footage = 21 S.F.

Oceanside - Las Vegas - Tacoma Kansas City - Willowbrook Euless - Houston - San Antonio Corpus Christi - Milwaukee Tampa - Atlanta - Daytona Beach

Building Quality Signage For American Business

12/13/05- REDUCED FRONT SIGN LOGO TO CONFORM WITH URBAN DESIGN.

1/18/06- REMOVED LED PER URBAN DESIGN COMMENTS CHANGED OVERDOOR AND PYLON TO INTERNALLY ILLUM.

R. Cearlock Project Manager: S. Maeser Drawn By: J. Carpenter




MADISON, WI 53704-7402

23-58583 Job Number: 10/10/05 Date: **1** Of **3** Sheet Number 23-58583R2 Design Number:

is provided as part of a planned project and is not to be exhibited, copied or reproduced without the written permission of Federal Heath Sign Company, LLC or its authorized agent.

SECTION @

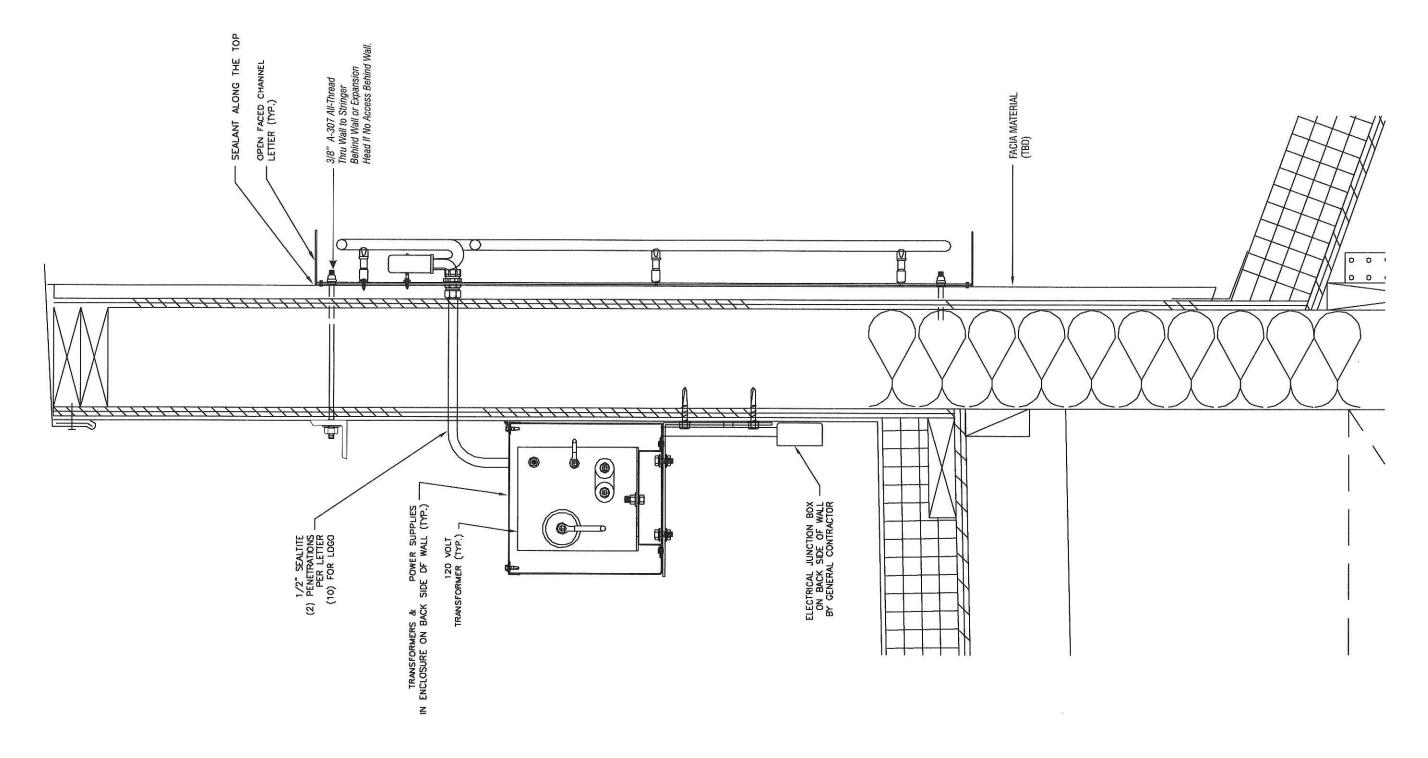



SIGN COMPANY

www.FederalHeath.com

160 W. Carmel Drive, Suite 236 Carmel, IN 46032 (317) 581-7790 Fax (317) 581-7783

Other Office Locations:

Oceanside - Las Vegas - Tacoma Kansas City - Willowbrook Euless - Houston - San Antonio Corpus Christi - Milwaukee Tampa - Atlanta - Daytona Beach

Building Quality Signage For American Business

12/13/05- REDUCED FRONT SIGN LOGO TO CONFORM WITH URBAN DESIGN.

1/18/06- REMOVED LED PER URBAN DESIGN COMMENTS CHANGED OVERDOOR AND PYLON TO INTERNALLY ILLUM. .

Account Rep.	R. Cearlock
Project Manager:	S. Maeser
Drawn By:	J. Carpenter


Project / Location: PROTO 4 RIGHT HAND 4841 ANNAMARK DR.

MADISON, WI 53704-7402

23-58583 Job Number: 10/10/05 **2** Of **3** Sheet Number: 23-58583R2

Design Number:

This original drawing is provided as part of a planned project and is not to be exhibited, copied or reproduced without the written permission of Federal Heath Sign Company, LLC or its authorized agent.

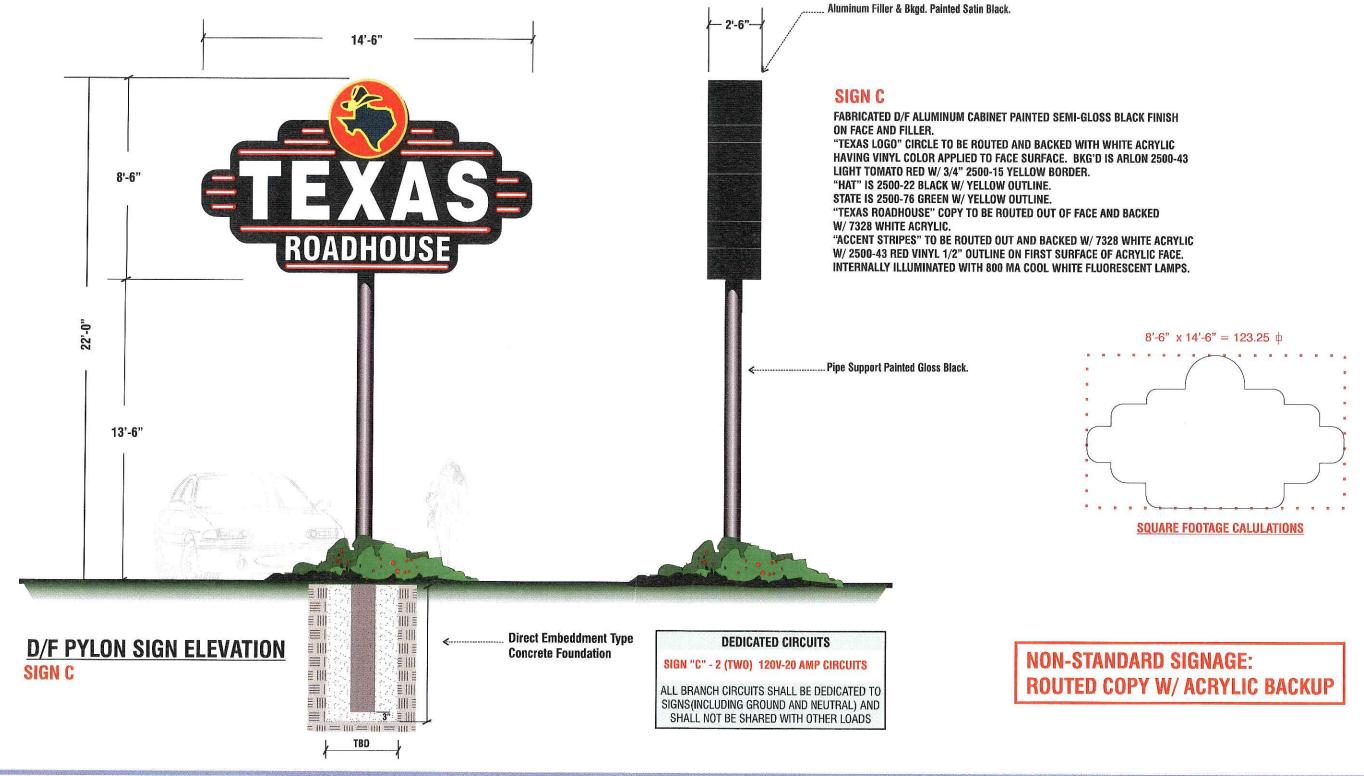



SIGN COMPANY www.FederalHeath.com

160 W. Carmel Drive, Suite 236 Carmel, IN 46032 (317) 581-7790 Fax (317) 581-7783

Other Office Locations:

Oceanside - Las Vegas - Tacoma Kansas City - Willowbrook Euless - Houston - San Antonio Corpus Christi - Milwaukee Tampa - Atlanta - Daytona Beach

Building Quality Signage For American Business

12/13/05- REDUCED FRONT SIGN LOGO TO CONFORM WITH URBAN DESIGN.

1/18/06- REMOVED LED PER URBAN DESIGN COMMENTS CHANGED OVERDOOR AND PYLON TO INTERNALLY ILLUM.

R. Cearlock Account Rep: Project Manager: S. Maeser J. Carpenter Drawn By: File Name:


Project / Location


PROTO 4 RIGHT HAND 4841 ANNAMARK DR. MADISON, WI 53704-7402

23-58583 Job Number: 10/10/05 Date: 3 of 3 Sheet Number 23-58583R2 Design Number:

This original drawing is provided as part of a planned project and is not to be exhibited, copied or reproduced without the written permission of Federal Heath Sign Company, LLC or its authorized agent.

[400 WATT MAX.]

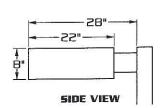

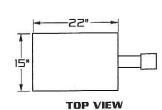

E.P.A.= 1.72




- HOUSING: DNE PIECE HEAVY GAUGI BALLAST COMPARTMENT
- LENS ASS'Y: ONE PIECE HINGED HEAV 9/16" CLEAR TEMPEREI TEMPERATURE SILICONE ASSEMBLY FROM HOUSIN
 - OPTICS: COMPUTER DESIGNED O COMBINES WITH LENS TO FIELD ROTATABLE.
- GASKETING: CLOSED CELL EPDM GAS OPTICAL CHAMBER.
- LAMP HOLDER: MOGUL BASE PORCELAIN
 - LAMP: [BY OTHERS]
 - BALLAST: H.P.F./C.W.A. AUTOTRAM COMPONENTS ARE MOUNT
 - ARM: 3"X5"X6" LONG HEAVY V AND TO POLE WITH STAI
 - FINISH: POLYESTER POWDER COA 140° TEMPERATURE INC CLEANSE AND PRETREA ELECTROSTATICALLY APP AT 400° TEMPERATURE FO




/ERSALUX	
5PECIFICATIONS SE DIE FORMED ALUMINUM CONSTRUCTION WITH SEPARATE	
Y GAUGE DIE FORMED ALUMINUM DOOR FRAME SURROUNDS D GLASS LENS. GLASS IS SEALED TO DOOR WITH HIGH E SEAL. TWO CAPTIVE THUMB SCREWS DISENGAGE LENS NG WITHOUT THE USE OF TOOLS.	
ONE PIECE SEMI SPECULAR HYDROFORMED REFLECTOR D PRODUCE A HIGHLY EFFICIENT, SHARP CUTOFF. OPTICS ARE	
KETING COMPRESSED BETWEEN DOOR AND HOUSING SEALS	
NSFORMER20° STARTING TEMPERATURE. ELECTRICAL TED TO HINGED REMOVABLE TRAY FOR EASY ACCESS. WALL EXTRUDED ALUMINUM. ARM IS SECURED TO HOUSING NLESS STEEL RODS.	
AT-STATE OF THE ART 20 PSI PRESSURE POWER WASH AT CORPORATES FOUR STEP IRON PHOSPHATE PROCESS TO AT THE METAL SURFACE FOR MAXIMUM PAINT ADHESION. PLIED TEXTURED POLYESTER POWDER TOP COAT IS BAKED OR MAXIMUM HARDNESS AND EXTERIOR DURABILITY.	
UL. Listed for wet location	
URAL GEO WEST AVENUE O. PALMDALE DA. 1885 ! GEO 253 2000 FAX NO (881) 233 2011 WWW LISTAING COM	


TYPICAL SQUARE POLE TEMPLATE

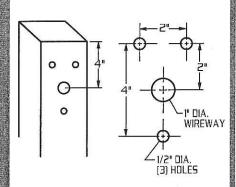


TYPICAL ROUND POLE TEMPLATE

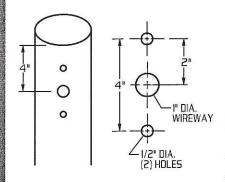


WALL MOUNT

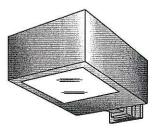

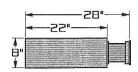


EXTRUDED ALUMINUM ARM AND CAST ALUMINUM WALL BRACKET ASSEMBLY PROVIDED WITH BUILT IN GASKETED WIRE ACCESS FOR FIXTURE/SUPPLY WIRE CONNECTION.

WALL PLATE

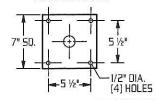

LAMP 5IZE: 100 - 400 WATT

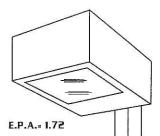

RECTILINEAR HEAVY GAUGE ALUMINUM HOUSING.

FIELD ROTATABLE OPTICS.

FIELD ADJUSTABLE OPTICS.
TYPE II AND III LIGHT
DISTRIBUTION.

HINGEO BALLAST TRAY, WITH QUICK DISCONNECT PLUG FOR EASY ACCESS TO ELECTRICAL COMPONENTS.

TOOLESS LUMINAIRE ACCESS.

ORDERING INFORMATION

MODEL NO.: VR\$	OPTICS	WATTAGE TYPE VOLTAGE	MOUNTING	FINISH	OPTIONS
MODEL NO.:	OPTICS	LAMP	MOUNTING	FINISH	OPTIONS
V R S	TYPE I I(hydrotorm) TYPE III II(hydrotorm) TYPE III III(hydrotorm) TYPE IV (FORWARD THROW) IV(segmented) TYPE V V-S Q(segmented)	WATTAGE TYPE VOLTAGE	ARM MOUNT ARM MOUNT STREET LIGHTING ARM MOUNT ST23	□DARK BRONZE DBM □MEDIUM BRONZE MBM □BLACK BKM □WHITE WTM □SILVER SLM OPTION: □ANODIZED AZ ANODIZED HOUSING MUST HAVE PAINT FINISH COAT EXAMPLE: AZDBM SEE PAGE FOR ADDITIONAL COLORS	☐ CLEAR POLYCARBONATE ☐ DIFFUSER LEX ☐ HOUSE SIDE SHIELD

www.usaltg.com





FEATURES & SPECIFICATIONS

INTENDED USE

For entrances, stairwells, corridors and other pedestrian areas.

CONSTRUCTION

Rear housing is rugged, corrosion-resistant, die-cast aluminum. Front cover is one-piece UV-resistant injection molded polycarbonate, internally painted. Captive external hardware is specially treated for corrosion resistance and includes slotted hex-head and tamperproof fasteners.

Dark Bronze (DDB) corrosion-resistant polyester powder.

OPTICAL SYSTEM

One-piece die-formed reflector is diffused aluminum. Refractor is clear UV stabilized polycarbonate, providing IES cutoff distribution and maximum lateral light output. Front cover is sealed and gasketed to inhibit the entrance of outside contaminants.

ELECTRICAL SYSTEM

Ballast is high reactance, high power factor, copper wound and 100% factory tested. UL listed. Components are heat-sinked directly to the cast housing for maximum heat dissipation (For 50 hertz availability, consult factory.)


Porcelain, horizontally oriented medium-base socket with copper alloy, nickelplated screw shell and center contact. UL listed 660W, 600V and 4kV pulse rated.

Medium-base lamp included with fixture.

INSTALLATION


Mount to any vertical surface or to a 4" round square outlet box. Back ac- Depth: cess through gasketed slot. Top wiring access through 1/2" threaded conduit entry. (Through-wiring requires use of a conduit tee). Photocells are field-installable.

UL listed for wet locations. IP65 listed. Listed and labeled to comply with Canadian and Mexican Standards (see options).

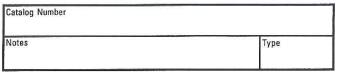

Cutoff Mini Wall-Packs

TWAC

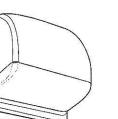

METAL HALIDE 50W, 70W, 100W




Specifications

Height: 10" (25.4cm) Width: 11-1/2" (29.2cm) 8-15/16" (22.7cm) 10 lbs. (4.53kg) Weight:

ORDERING INFORMATION

Choose the boldface catalog nomenclature that best suits your needs and write it on the appropriate line. Order accessories as separate catalog numbers (shipped separately).

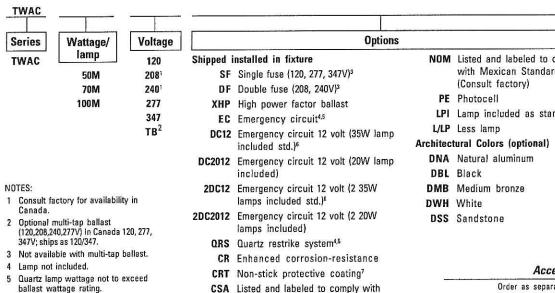

Canadian Standards

Outdoor and **Special Environments**

ballast wattage rating. 6 Not available with QRS, EC or NOM.

7 Black finish on housing only.

Sheet #: TWAC-M_0

Photocell kit (347V)

Wireguard

RK1 PEB1

RK1 PEB2

TWAWG


RK1 PEB1 CSA


RK1 PEB3 CSA


BM-700

	Dark Sky Member
Example: TWAC	50M 120 LPI
ed to comply candards	
onal) n	
Accessories	
separate catalog num Photocell kit (120V Photocell kit (120V Photocell kit (208, 2	only) only)

TWAC Metal Halide Wall-Pack

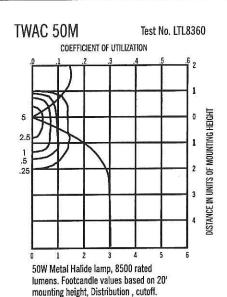

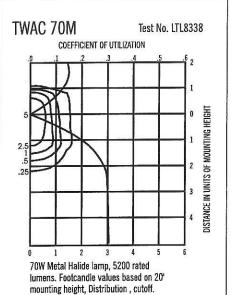

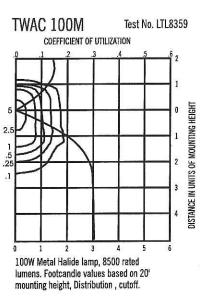

Mounting Height Correction Factor

(Multiply the fc level by the correction factor)
6' 8' 10'
8 ft. = 6.25 - 8 ft. = 6.25
10 ft.= 4.00 10 ft.= 4.00 12 ft.= 2.78 12 ft.= 2.78



Sheet #: TWAC-M_0

©1997 Acuity Lighting Group, Inc., Rev. 10/05


Lithonia Lighting
Acuity Lighting Group, Inc.
Outdoor Lighting
One Lithonia Way, Conyers, GA 30012-3957
Phone: 770-922-9000 Fax: 770-918-1209
In Canada: 160 avenue LaBrosse, Pointe-Claire, P.O. H9R 1A1
www.lithonia.com

Texas Roadhouse EXTERIOR SPECIFICATION

Wall Mounted Lighting

PROJECT:

Texas Roadhouse

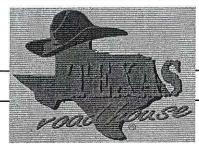

Provided By:



Type F12

3865 Produce Rd

Suite 208

Louisville, KY 40218 Toll Free: 877-707-7378

Phone: 502-961-0096 Fax: 502-961-0357

Web: www.accu-serv.com

Item #: TWAC 100M 120 PE LPI

DESCRIPTION


Classification: Wall Pack

Description: Wall Mounted Area

Light

Dimensions: 10"H x 11.5"W x 8 15/16"D

Lamp Type: 100 Watt MH

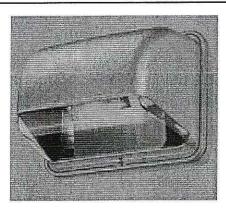

Lamp:



Quantity per Store: 2

Texas Roadhouse

EXTERIOR SPECIFICATION

Exterior Decorative Lighting

PROJECT:

Texas Roadhouse



Provided By:



3865 Produce Rd

Suite 208


Louisville, KY 40218

Toll Free: 877-707-7378 Phone: 502-961-0096

Fax: 502-961-0357

Web: www.accu-serv.com

Type F16

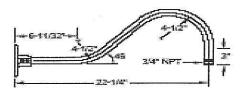

Arm Detail

Item #: KB 686BK

DESCRIPTION

Classification: Exterior Gooseneck

Description: Black Angled Dome Gooseneck

w/ Remote Ballast

Dimensions: A: 10 Inches Dimensions: B: 7 Inches

C: 5 Inches

Lamp Type: 100 W MH





Lamp:



Quantity per Store: 18

Texas Roadhouse EXTERIOR SPECIFICATION

Exterior Decorative Lighting

PROJECT:

Texas Roadhouse



Provided By:




Type F17

3865 Produce Rd Suite 208 Louisville, KY 40218 Toll Free: 877-707-7378

Phone: 502-961-0096 Fax: 502-961-0357

Web: www.accu-serv.com

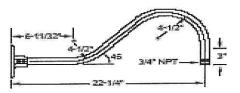

Arm Detail

Item #: KB685 BK

DESCRIPTION

Classification: Exterior Gooseneck

Description: Black Rlm, Arm Mounted

Dimensions: 16" Diameter

CLASSICALM

Lamp Type: 15 Watt Compact Fluorescent

Screw-In

Lamp:



Quantity per Store: 2

ı		
	Bi	

Texas Roadhouse EXTERIOR SPECIFICATION

Exterior Soffit Recessed Lighting

PROJECT:

Texas Roadhouse



Provided By:



Type F18

3865 Produce Rd

Suite 208

Louisville, KY 40218 Toll Free: 877-707-7378

Phone: 502-961-0096 Fax: 502-961-0357

Web: www.accu-serv.com

Item #: LP6H100M120/277 / 6B3

DESCRIPTION

Classification: Recessed Soffit


Description: Recessed Frame w/ Ballast and

Black Baffle Trim

Dimensions: 13"L x 12 1/4"W x 6 7/8" Diameter

of Opening

Lamp Type: 100 W MH

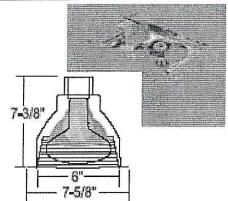

Trim Dimens

Lamp:



Quantity per Store

J. C. S. C.			
3			
e: 21			

3455 Salt Creek Lane Suite 100 Arlington Heights, IL 60005

t: 847 788 9200 f: 847 788 9536

GreenbergFarrow

ATLANTA
NEW YORK
CHICAGO
LOS ANGELES
BOSTON
DALLAS
NEW JERSEY

November 1, 2005

(VIA FED-EX STANDARD)

Santiago Rosas 17th District Alderperson Council Office 210 Martin Luther King, Jr. Blvd., Room 417 Madison, WI 53704-3345 Tel: (608) 266-4071

Re: Proposed Texas Roadhouse Restaurant

Dear Ald. Rosas:

On behalf of my client Texas Roadhouse Inc. (TXRH), I would like to take this opportunity to introduce our proposal for construction of a new 7,135 square foot Texas Roadhouse sit-down restaurant to be located within the southwest quadrant of the East Washington Avenue / Interstate 39 interchange.

For your review, I am forwarding a copy of our preliminary site plan (SP2, dated 09/13/05) and a copy of Texas Roadhouse's prototypical building elevations and sign package. There are a couple of items to note with the site plan:

- Texas Roadhouse intends to lease the property and contractually they have the authorization to install the area labeled as "Offsite Construction Parking" and the drive aisle between the TXRH and Krispy Kreme lots at the time of development of their lot.
- > A 22-foot tall pylon sign is proposed along Annamark Drive.

Also for your reference, I am forwarding a copy of the recorded CSM indicating the Texas Roadhouse lot (Lot 2).

I am available at (847) 788-9200 Ext. 225 to answer any questions you may have concerning this project and am intending to make a formal submission to the City's Planning Department in December for Plan Commission and Urban Design review.

I look forward to working with you and the City of Madison on this project.

Respectfully,

Jennifer M. Mowen, ASLA

01 Formal Letter 07.01.05 J:\ADMIN\2005\20050922\20050922 Letter to Santiago Rosas 10_28_05.doc

3455 Salt Creek Lane Suite 100 Arlington Heights, IL 60005

t: 847 788 9200 f: 847 788 9536

GreenbergFarrow

ATLANTA
NEW YORK
CHICAGO
LOS ANGELES
BOSTON
DALLAS
NEW JERSEY

December 21, 2005

Plan Commission Members City of Madison 210 Martin Luther King, Jr. Blvd. Madison, WI 53704-3345

Re: Proposed Texas Roadhouse Restaurant

Dear Commissioners:

On behalf of my client Texas Roadhouse Inc. (TXRH), I would like to take this opportunity to introduce our proposal for construction of a new 7,135 square foot Texas Roadhouse sit-down restaurant to be located within the southwest quadrant of the East Washington Avenue / Interstate 39 interchange at 4841 Annamark Drive.

The Texas Roadhouse site is part of a larger commercial development entitled the "Zeier Planned Commercial Site." The approved concept plan, dated 10/12/04, has been included with this submission. Texas Roadhouse intends to lease approximately 1.688 acres and contractually they have the authorization to install the approximate 0.404-acre area labeled as "Offsite Construction Parking." This area will provide for a temporary cul-de-sac turnaround until the adjacent properties to the east are developed, at which time the cul-de-sac will be removed and the parking lot will be built out according to the concept plan.

Contractually, Texas Roadhouse is required to install the drive aisle between the TXRH and Krispy Kreme lots at the time of development of their lot. The property line dividing the TXRH and Krispy Kreme lots is located on the centerline of this drive aisle, and as such approximately 0.142 acres of this drive aisle will be located on the Krispy Kreme site. Therefore, TXRH will develop a total of 2.234 acres of land (1.688 acres strictly for their lease lot + 0.404 acres for the "Offsite Construction Parking" area + 0.142 acres for the portion of the drive aisle that is located off of their lease lot.)

The 1.688 acre TXRH lot is noted as Lot 2 on the Recorded "Certified Survey Map Lots 16, 17, And Part of 13, Regional East." A copy of this CSM has been included with this submission. The site is vacant and is relatively flat. A copy of the ALTA survey further denoting existing conditions has also been included with this submission.

115 parking stalls are proposed for the 1.688 acre TXRH lot. This is consistent with the approved concept plan. An additional 31 parking stalls are proposed in the "Offsite Construction Parking" area. A bike pad, sized to accommodate parking for 12 bicycles is proposed near the front door of the restaurant. An outdoor patio is also provided near the front entrance. A trash enclosure sized to accommodate three (3) roll-out trash bins and a loading area are provided adjacent to the service entrances near the southeast corner of the building.

Landscaping, site lighting, and exterior signage are designed to meet code. The City's Planning Department has indicated that Washington Avenue can be used to determine the maximum allowable amount of signage.

Plan Commission Members City of Madison 12/21/2005 Pg. 2 of 2

The occupancy load as determined by the building code is 287 occupants. Seating capacity is 239 seats, including the bar area, and the overall square footage of the building is broken down as follows:

Foyer	481.70 SF
Office	107.49 SF
Chemical Storage	9.50 SF
Mechanical Room	115.93 SF
Rest Rooms	358.53 SF
Coolers	416.67 SF
Waiting	250.93 SF
Bar	184.49 SF
Kitchen	1,965.43 SF
Dinning	3,083.80 SF
Dry Storage	160.53 SF
TOTAL	7,135.00 SF

Square footages are approximate.

In general, Texas Roadhouse's hours of operation are Monday thru Thursday from 4:00 PM to 10:00 PM, Friday from 4:00 PM to 11:00 PM, Saturday from 11:00 AM to 10:00 PM, and Sunday from 11:00 AM to 10:00 PM. Typically, 40 employees are required for the peak shift.

Texas Roadhouse desires to have all approvals and permits in hand with construction under way around the 1st of April 2006 with a Grand Opening scheduled for late August 2006. Per the City's request, a project contact list is also included with this submission.

On behalf of Texas Roadhouse, I look forward to a successful development in the City of Madison and appreciate your consideration of this project.

Respectfully

Jennifer M. Mowen, ASLA

01 Formal Letter 07.01.05 J:\ADMIN\2005\20050922\20050922 Letter of Intent To Plan Commission 12_21_05.doc

MADISON, WI - TEXAS ROADHOUSE CONTACT LIST (SWQ U.S. 151 & I-39) GF #: 20050922.2

TXRH – DIR. OF DEVELOPMENT	TXRH - DEVELOPMENT MANAGER
Michael Keaton Senior Director of Development Texas Roadhouse 6040 Dutchmans Lane, Suite 400 Louisville, KY 40205	Kerri Smith Development Manager Texas Roadhouse 6040 Dutchmans Lane, Suite 400 Louisville, KY 40205
Tel: (502) 515-7250 Mobile: (317) 701-4404 Fax: (240) 250-7122 Email: <u>mikek@texasroadhouse.com</u>	Tel: (502) 515-7301 Mobile: (502) 741-5175 Fax: (859) 422-5006 Email: kerri.smith@texasroadhouse.com
TXRH -REAL ESTATE MANAGER	TXRH -CONSTRUCTION
Michael Keaton Senior Director of Development Texas Roadhouse 6040 Dutchmans Lane, Suite 400 Louisville, KY 40205	David Banet Senior Estimator/Construction Manager Texas Roadhouse 6040 Dutchmans Lane, Suite 400 Louisville, KY 40205
Tel: (502) 515-7250	Tel: (502) 515-7212 Fax: (502) 515-7229
Mobile: (317) 701-4404 Fax: (240) 250-7122	Email:david.banet@texasroadhouse.com
Email: mikek@texasroadhouse.com	
TXRH - ATTORNEY	SITE DEVELOPMENT
Thomas H. Stewart, Jr. Thomas H. Stewart, Jr. & Associates, PLLC 500 N. Akard St., Suite 2840 Dallas, TX 75201 Tel: (214) 740-4290 Fax: (214) 740-4266 Email: tstewart@stewartlegal.com	Jennifer Mowen Site Development Coordinator Greenberg Farrow 3455 Salt Creek Lane, Suite 100 Arlington Heights, IL 60005 Tel: (847) 788-9200 Fax: (847) 788-9537 Email: jmowen@greenbergfarrow.com

LANDLORD	LANDLORD'S ATTORNEY
Raymond & Loraine Zeier Annamark Group Z, LLC 2211 North Stoughton Road Madison, WI 53704	John Frank Lathrop & Clark LLP P.O. Box 1507 Madison, WI 53701-1507
	Tel: (608) 257-7766 Email: <u>ifrank@lathropclark.com</u>
GEOTECH	SIGN CONSULTANT
Troy Giles Giles Engineering Associates, Inc. N8 W22350 Johnson Drive Waukesha, WI 53186 Tel: (262) 544-0118 Fax: (262) 549-5868 Email: tegiles@gilesengr.com	Steve Maeser Sr. Program Manager Federal Heath Sign Company 6040 Dutchmans Lane, Suite 400 Louisville, KY 40205 Tel: (502) 515-7328 Fax: (502) 459-4420 Email: smaeser@federalheath.com
SURVEYOR	CIVIL ENGINEER
Wayne Barsness / Karen Gagnon D'Onofrio, Kottke, & Assoc., Inc. 7530 Westward Way Madison, WI 53717	Dan Angspatt / Alfonso Inchausti Greenberg Farrow 3455 Salt Creek Lane, Suite 100 Arlington Heights, IL 60005
Tel: (608) 833-7530 Fax: (608) 833-1089 Email: wbarsness@donofrio.cc kgagnon@donofrio.cc	Tel: (847) 788-9200 Fax: (847) 788-9536 Email: <u>vangspatt@greenbergfarrow.com</u> <u>ainchausti@greenbergfarrow.com</u>
LANDSCAPE ARCHITECT	SITE LIGHTING CONSULTANT
Christopher Thiel Schreiber/Anderson Associates, Inc. 717 John Nolen Drive Madison, WI 53713	Kevin Loehle AccuServ Lighting & Equipment 3865 Produce Road, Suite 208 Louisville, KY 40218
Tel: (608) 255-0800 Tel Direct: (608) 441-3592 Fax: (608) 255-7750 E-mail: cthiel@saa-madison.com	Tel: (877) 707-7378 (Toll Free) Tel: (502) 961-0096 Fax: (502)961-0357 Email: <u>kloehle@accu-serv.com</u>

ARCHITECT

Julie Wehmeyer Project Manager Greenberg Farrow 3455 Salt Creek Lane, Suite 100 Arlington Heights, IL 60005

Tel: (847) 788-9200 Fax: (847) 788-9536

Email: jwehmeyer@greenbergfarrow.com

RESTAURANT DESIGN

George Lask GLask & Assoc. Inc. 4615 Wolf Creek Parkway Louisville, KY 40241

Tel: (502) 292-2277 Mobile: (502) 802-5754 Fax: (502) 292-2277

Email: g.lask@insightbb.com

MEP

Brad Kalmans RH George and Associates, Inc. 8700 Jameel, Suite 150 Houston, TX 77040

Tel: (713) 690-6300 Fax: (713) 690-9030 Email: <u>bkalmans@rhgeorge.com</u>

STRUCTURAL ENGINEER

Biljana Bulakovska Barry Levin & Associates, Inc. 188 Industrial Drive, Suite 116 Elmhurst, IL 60126

Tel: (630) 530-8181 Fax: (630) 530-8197

Email: bbulakovska@aol.com







