

## **CITY OF MADISON ZONING BOARD OF APPEALS**

## VARIANCE APPLICATION

**\$500 Filing Fee** Type or legibly print using blue or black ink.

Address of Subject Property: 5125 Lake Mendota Dr.	
Name of Owner:  Address of Owner (if different than above):  Same	
Daytime Phone:	Evening Phone:
Name of Applicant (Owner's Representative): Kevin S  Address of Applicant: 1201 S. Stoughton Road, Mad	Sorg lison WI 53716
Daytime Phone: (608)316.3871  Email Address: ksorg@bachmannconstruction.com	Evening Phone: Same
Description of Requested Variance:  The homeowners are requesting a variance to exceed t  building as outlined in the current zoning regulations. T	
unique conditions of the property. The homeowners be	
zoning regulations while preserving neighborhood chara	acter and overall community standards
	See reverse side for more instructions.
Amount Paid: \$500  Receipt: 60097515  Filing Date: 11/19/2025  Received By: Staff  Parcel Number: 070918407086  Zoning District: SR-C1, WP-14  Alder District: 19	## Table 12

## **Standards for Variance**

The Zoning Board of Appeals will only grant a variance if it finds that your proposal meets the following standards. Please explain how your variance request meets these standards.

1. There are conditions unique to the property of the applicant that do not apply generally to other properties in the district.

This property is unique due to its topography—the garage is cut directly into the hillside, a condition not present on any other lot in the neighborhood. As a result, the top of the existing carport sits below the natural grade and is surrounded by retaining walls that are necessary to support the surrounding terrain.

2. The variance is not contrary to the spirit, purpose, and intent of the regulations in the zoning district and is not contrary to the public interest.

While the proposed accessory building exceeds the 15-foot height limit when measured from the lowest adjacent grade (as required by code), the top of the structure remains below 15 feet when measured from the effective grade of the existing home and surrounding context.

3. For an area (setbacks, etc.) variance, compliance with the strict letter of the ordinance would unreasonably prevent use of the property for a permitted purpose or would render compliance with the ordinance unnecessarily burdensome.

This project consists of an alteration to an existing structure. The requested variance is necessary to accommodate the proposed modifications while maintaining compliance with applicable zoning and development standards to the extent feasible.

4. The alleged difficulty or hardship is created by the terms of the ordinance rather than by a person who has a present interest in the property.

While the intent of the ordinance is to preserve community standards, the strict application of its terms creates a hardship in this case. The hardship arises because the ordinance does not account for the unique physical

conditions or features of this or other properties that make alteration, maintenance, or repair of the existing

structure unusually difficult or impractical.

5. The proposed variance shall not create substantial detriment to adjacent property.

The proposed building measures 11'-8" above the effective grade and will not have a negative impact on adjacent properties. The surrounding homes are situated higher up the hill, ensuring that sightlines and views will not be affected by the proposed structure.

6. The proposed variance shall be compatible with the character of the immediate neighborhood.

The siding, roofing, and windows of the proposed structure will match those of the existing home. The roofline is consistent with both the existing residence and adjacent properties. The color palette of the structure has been

selected to complement and blend with the surrounding environment.

### **Application Requirements**

The Zoning Board of Appeals may refer or deny applicants with incomplete applications. Note, the maximum printed size for drawings is 11" x 17." Please provide the following information:

- **Pre-application meeting with staff**. Before you submit this application, meet with the Zoning Χ Administrator. Together, you will discuss your proposed project and submission material. Contact Zoning at least one week prior to the application submission deadline to schedule the meeting. Your application will not be accepted unless a pre-application meeting has been held. Site plan, drawn to scale. We recommend a registered survey, but it is not required. On the plan, Χ show the following: Lot lines. Existing and proposed structures. Include dimensions and setback distances to all property lines. Approximate location of structures on properties next to variance. Major landscape elements, fencing, retaining walls or other relevant site features.  $\square$  Scale (1" = 20' or 1' = 30' preferred). □ North arrow. **Elevations** from all directions showing existing and proposed. Show the existing structure and Χ proposed addition(s). Interior floor plan of existing and proposed structure, if required. Most additions and Χ expansions will require floor plans. Front yard variance requests. Show the front yard setback of all other properties on the same na block face. **Lakefront setback variance requests.** Provide a survey prepared by a registered land surveyor. na The survey must show existing setbacks of buildings on adjacent lots. Variance requests involving slope, grade, or trees. Show: Χ Approximate location and amount of slope. Direction of drainage. □ Location, species and size of trees. Email digital copies of all plans and drawings to: zoning@cityofmadison.com. Χ Pay \$500 filing fee on or before submission deadline. Payment may be made in person by Х appointment at the Zoning counter, by mail to City of Madison Building Inspection, P. O. Box 2984, Madison WI 53701-2984, or placed in the drop box at the Doty Street entrance to the Madison Municipal Building 215 Martin Luther King Jr. Blvd. When mailing or using the drop box, please include a note that payment is for a variance application, state the subject property address and provide your contact information. CHECK HERE. I understand that as part of my variance request, City of Madison staff will need Χ access to my property. Staff will take photographs and do a pre-hearing inspection of the property. I give City Staff permission to enter my property, inspect the property, and take photographs. **CHECK HERE.** I acknowledge that any statements implied as fact require evidence. Х
- X **CHECK HERE.** City of Madison staff has given me a copy of the standards that the Zoning Board of Appeals will use to review variance applications.

Decision  The Board, in accordance with its findings of fact, hereby determines that the requested variance for	The Zoning Board of Appeals: $\square$ Approved	Denied Conditionally Approved
Decision  The Board, in accordance with its findings of fact, hereby determines that the requested variance for		
Date:	findings of fact are stated in the minutes of this public	c hearing.
Dwner's Signature: Phyl Simel Date: 11/19/25(For Office Use Only)  DECISION	(does	s) (does not) meet all the standards for a variance. Further
Dwner's Signature: Phyl Siwell Date: 11/19/25	The Board, in accordance with its findings of fact, her	eby determines that the requested variance for
Dwner's Signature: Phyl SiweM Date: 11/19/25	1	DECISION
	(Fo	or Office Use Only)

The City of Madison zoning ordinance requires applicants to post signs for public hearings of the Board of Zoning Appeals (ZBA) on the properties requesting a variance or appeal.

#### Sign Pickup

- Signs must be picked up at the Building Inspection Zoning Counter, which is open by appointment only. Schedule an appointment at:
   <a href="https://www.cityofmadison.com/dpced/bi/schedule-a-counter-appointment/3423/">https://www.cityofmadison.com/dpced/bi/schedule-a-counter-appointment/3423/</a>. The Zoning Counter is located in the Madison Municipal Building at 215 Martin Luther King, Jr. Blvd., Ste. 017, Madison, WI 53701.
- Signs will include a short description of the request, the address of the property subject to the hearing, applicant name, phone number, and email, and the date and time of the ZBA hearing. You may receive phone calls or emails regarding your request from people who see the signs.

#### Sign Posting


- Signs must be posted at least 21 days prior to the ZBA meeting date.
- Signs must be on the property which is the subject of the public hearing.
- If the property has frontage on more than street, a sign shall be placed facing each street.
- Signs must be posted on private property. Signs may not be in the City right-of-way, public terrace, on a public tree or on a street sign. It is recommended that the signs be placed not more than five feet behind the property line.
- Signs and the information on the signs must face the street so that they are visible to pedestrians and vehicles from the street and the public walkway.
- When there is no front yard to post signs, you may post signs on the outside of the building, in a ground floor window or glass door. Signs should not be displayed more than six feet above the ground or sidewalk. The intent is for signs to be visible to the public.
- Signs shall not be posted in a location that would obstruct the views of any traffic or entrances or exits to the property.
- Signs must be removed no more than seven days after the hearing.

If you have any questions, please call our office at 608-266-4551.

#### VERTICAL GARAGE ADDITION CONSTRUCTION DOCUMENTS



SITE MAP N.T.S.

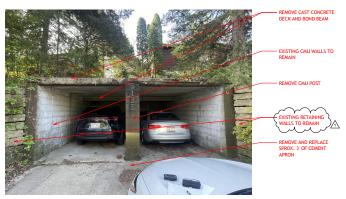

#### PROJECT DIRECTORY CLIENTS: PHILIPP SIMON 5125 LAKE MENDOTA MADISON, WI 53705 INTERIOR DESIGN: BACHMANN DESIGN GROUP 1201 S. STOUGHTON RD. MADISON, WI 53716 GENERAL CONTRACTOR: BACHMANN CONSTRUCTION 1201 S. STOUGHTON RD. MADISON, WI 53716 ADDRESS: 5125 LAKE MENDOTA MADISON, WI 53705 ELECTRICAL: DESIGN-BUILT BY OTHER

SHILL HADEN	
SHEET NUMBER	SHEET NAME
	CSM
A1.0	DEMO PLAN
A2.0	ALTERATION FLOOR PLANS
A2.2	EXTERIOR ELEVATIONS
A3.0	INTERIOR STRUCTURAL ELEVATIONS
A3.1	ROOF FRAMING PLAN
S1	FOUNDATION PLAN, FLOOR FRAMING PLAN, SECTIONS
52	SECTIONS AND DETAILS

AREA OF WORK

- GENERAL NOTES

  IT IS THE RESPONSIBILITY OF THE CONTRACTOR TO PERFORM A SITE VERIFICATION OF EXISTING CONDITIONS AND DIMENSIONS.

  CONTRACTOR TO COMPLY WITH ALL APPLICABLE BUILDING CODES.
  IT IS THE RESPONSIBILITY OF THE CONTRACTOR TO COORDINATE BETWEEN WHAT SHOULD BE REMOVED/MODIFIED WITH THE NEW WORK PLAN.
  COORDINATE WORK SCHEDULE WITH TENANT AND OR BUILDING OWNER.

- ELECTRICAL HOTES

  ELECTRICAL/DATA DRAWINGS, CALCULATIONS AND SUBMITTAL BY DESIGN BUILD CONTRACTOR.

  ELECTRICAN TO PROVIDE, LOCATE AND INSTALL EMERGENCY EGRESS LIGHTING AND EXT SIGNS AS REQUIRED BY CODE, VEREY/ CODERNATE LOCATIONS W/ BACHMANN

SHEET INDEX		
SHEET NUMBER	SHEET NAME	
	CSM	
1.0	DEMO PLAN	
2.0	ALTERATION FLOOR PLANS	
2.2	EXTERIOR ELEVATIONS	
3.0	INTERIOR STRUCTURAL ELEVATIONS	
3.1	ROOF FRAMING PLAN	
	FOUNDATION PLAN, FLOOR FRAMING PLAN, SECTIONS	

SIMON VERTICAL GARAGE ADDITION RESIDENTIAL

**BACHMANN** 

BACHMANN DESIGN GROUP

1201 S. STOUGHTON RD. MADISON, WI 53716 (608) 222-8869 BACHMANNCONSTRUCTION.COM

REVISION SCHEDULE

TITLE AS NOTED SCALE: PHASE ID: ISSUE DATE: 6/23/202

Α0

**EXISTING CONDITIONS** 

N.T.S.

## PLAT OF SURVEY

FOR: SANDRA & PHILIPP SIMON 5125 LAKE MENDOTA DR MADISON, WI 53705

#### **PARCEL DESCRIPTION:**

Being Lot 102 of Indian Hills, located in the NE 1/4 of the SE 1/4 of Section 18, T7N, R9E, City of Madison, Dane County, Wisconsin, to wit:

### **SURVEYOR'S CERTIFICATE:**

I hereby certify that I have surveyed and mapped the parcel of land hereon and that I am in full compliance with the provisions of Chapter AE-7 of the Wisconsin Administrative Code to the best of my knowledge and belief.

Mirle G. Rochon, PLS No. S-2767 Date



40'

80'

#### **LEGEND:**


- O 1" OD. IRON PIPE FOUND


SECTION CORNER FOUND
ALL TIES FOUND & VERIFIED, UNLESS NOTED

REFERENCE POINT SCALE: 1" = 40' RECORDED AS OVERHEAD ELECTRIC EXISTING FENCELINE BUILDING SETBACK Q MENDOTA AVE FOR PRIMARY STRUCTURE IN CITY OF MADISON RESIDENTIAL ZONING NEZ-SEZ (S 67°14' 11.12 30' FRONT GRADE AT STOOP źź YARD SETBACK +15'-4" ABOVE THE CURB BEARINGS ARE
REFERENCED TO THE
SOUTH LINE OF THE SE
1/4 OF SECTION 18,
T7N, R9E, WHICH BEARS
S 88'39'11" W BASED 137.1 137.3 **36** E CSM #805)
INDIAN HILLS 27.01 25:56:50 2 10' SIDE YARD SETBACK 2675 ON THE WISCONSIN COUNTY COORDINATE THOUSAND SURVEY) LOT 102 SYSTEM, DANE COUNTY 0.32 ACRES ± ZONE, NAD83(2011) , SURVEY). \$ 75'44'59" W 92.66' \$ 76' W, 93.2', MABBETT SURVEY) YARD SETBACK @ S-W FENCE 10' SIDE YARD SETBACK SW-E FENCE 0.00,00 1669.38 SE CORNER -S 1/4 CORNER SECTION 18, T7N, R9E SECTION 18, T7N, R9E BRASS CAP FOUND BRASS CAP FOUND S 88'39'11" W 2649.25 1284.89



1364.36

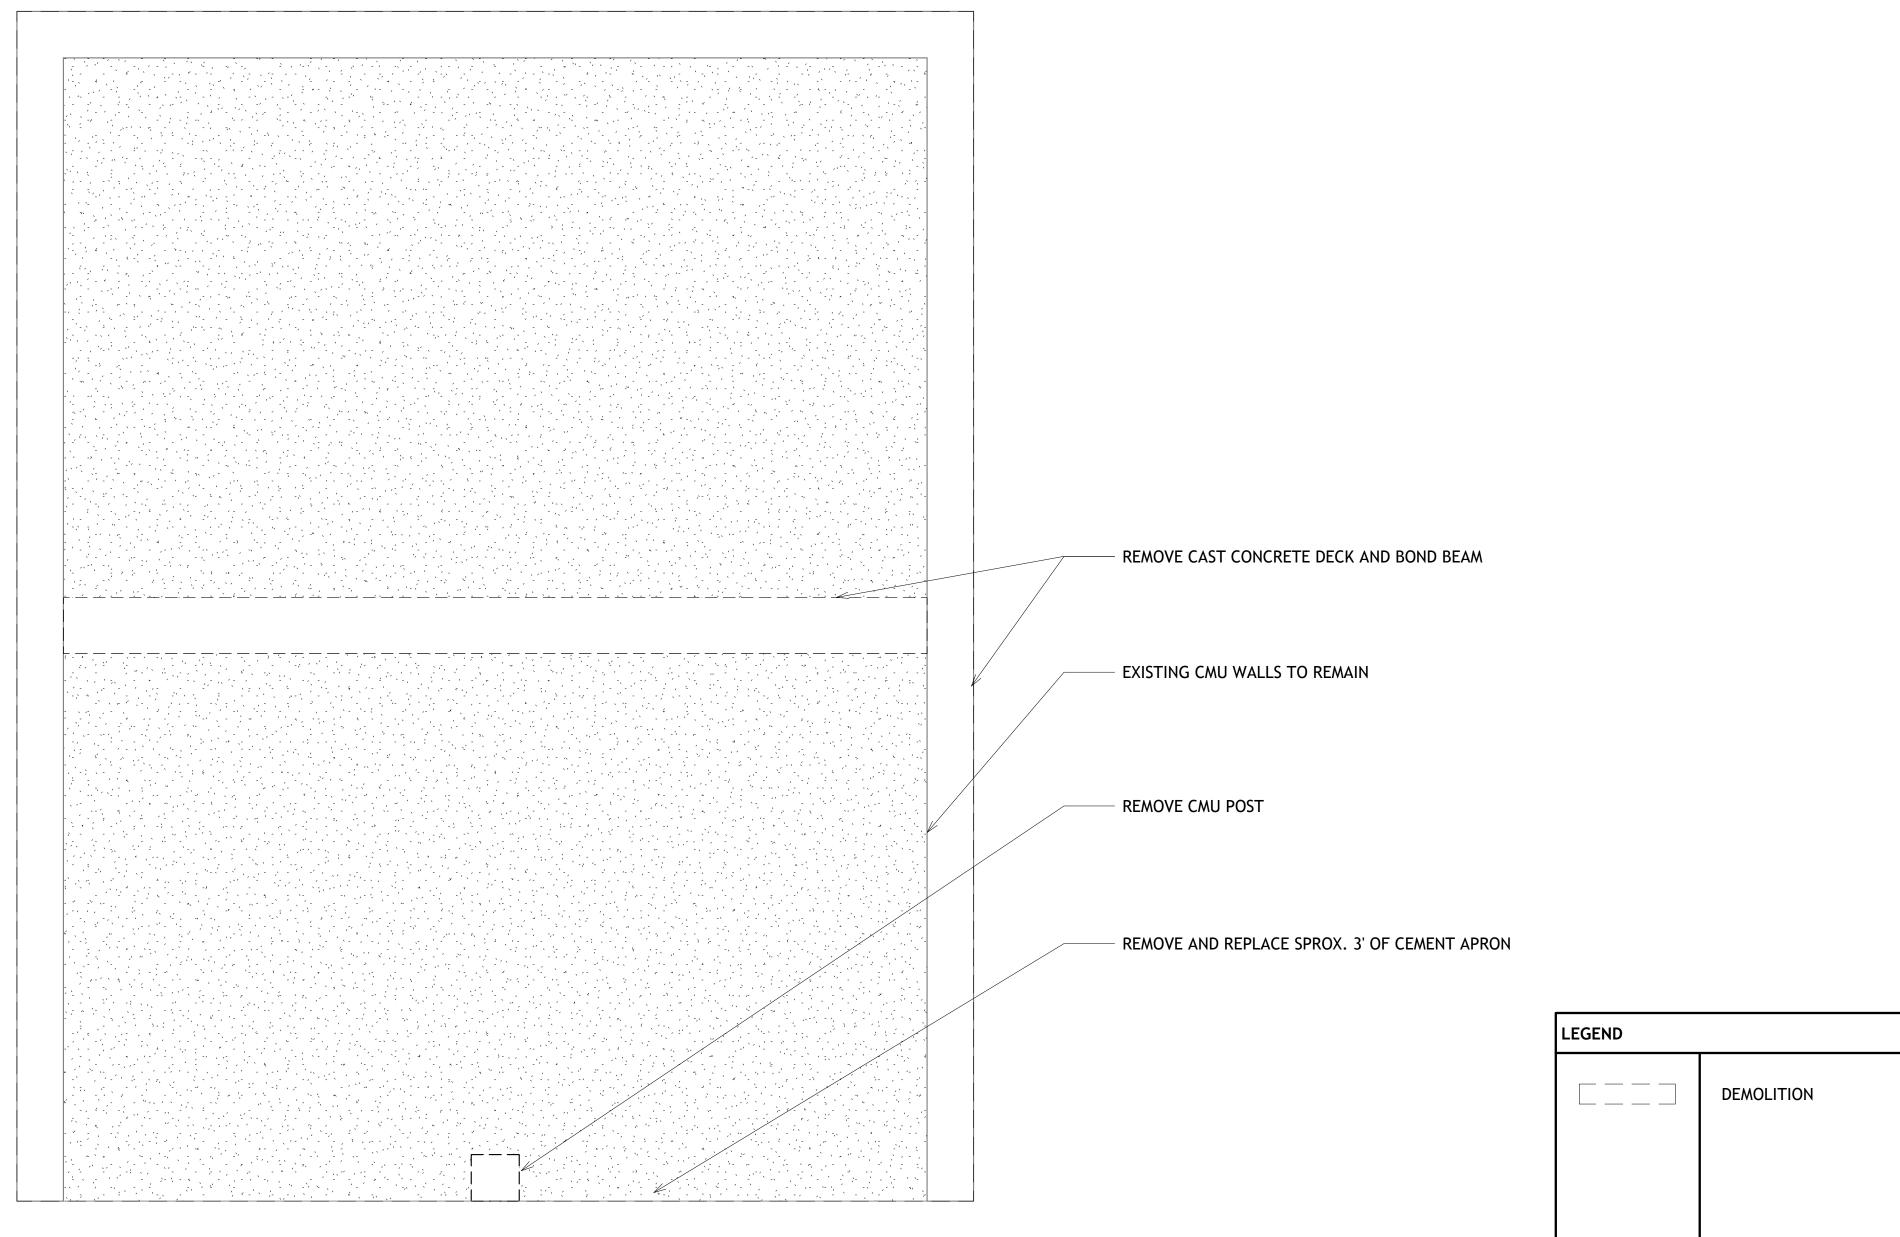

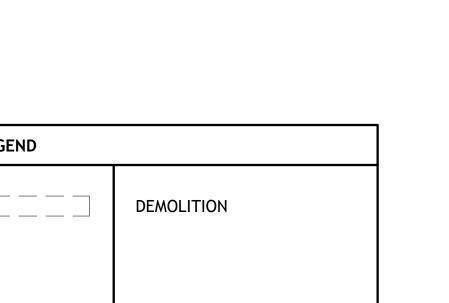

# **GENERAL NOTES**

- IT IS THE RESPONSIBILITY OF THE CONTRACTOR TO PERFORM A SITE VERIFICATION OF EXISTING CONDITIONS AND DIMENSIONS.
- IT IS THE RESPONSIBILITY OF THE CONTRACTOR TO COORDINATE BETWEEN WHAT SHOULD BE REMOVED/MODIFIED WITH THE NEW WORK PLAN.
- PATCH AND REPAIR EXISTING WALLS EFFECTED BY DEMOLITION TO ACCOMMODATE NEW LAYOUT.

## **KEY NOTES**

- REMOVE CEMENT CEILING SLAB AND BEAM
- FOUNDATION AND EXISTING RETAINING WALLS TO REMAIN

1201 S. STOUGHTON RD. MADISON, WI 53716 (608) 222-8869 BACHMANNCONSTRUCTION.COM

CONSULTANTS

SIMON VERTICAL GARAGE ADDITION RESIDENTIAL

5125 Lake Mendota Drive, Madison WI 53705

REVISIONS 0000 0000 0000 0000

> REVISION SCHEDULE DESCRIPTION DATE

> > DEMO PLAN

SCALE: AS NOTED PHASE ID: CONTRACT DOCUMENTS


ISSUE DATE: 6/23/2025

A1.0

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DEMOLITION PLAN

1/2" = 1'-0" (HALF SCALE AT 11X17)



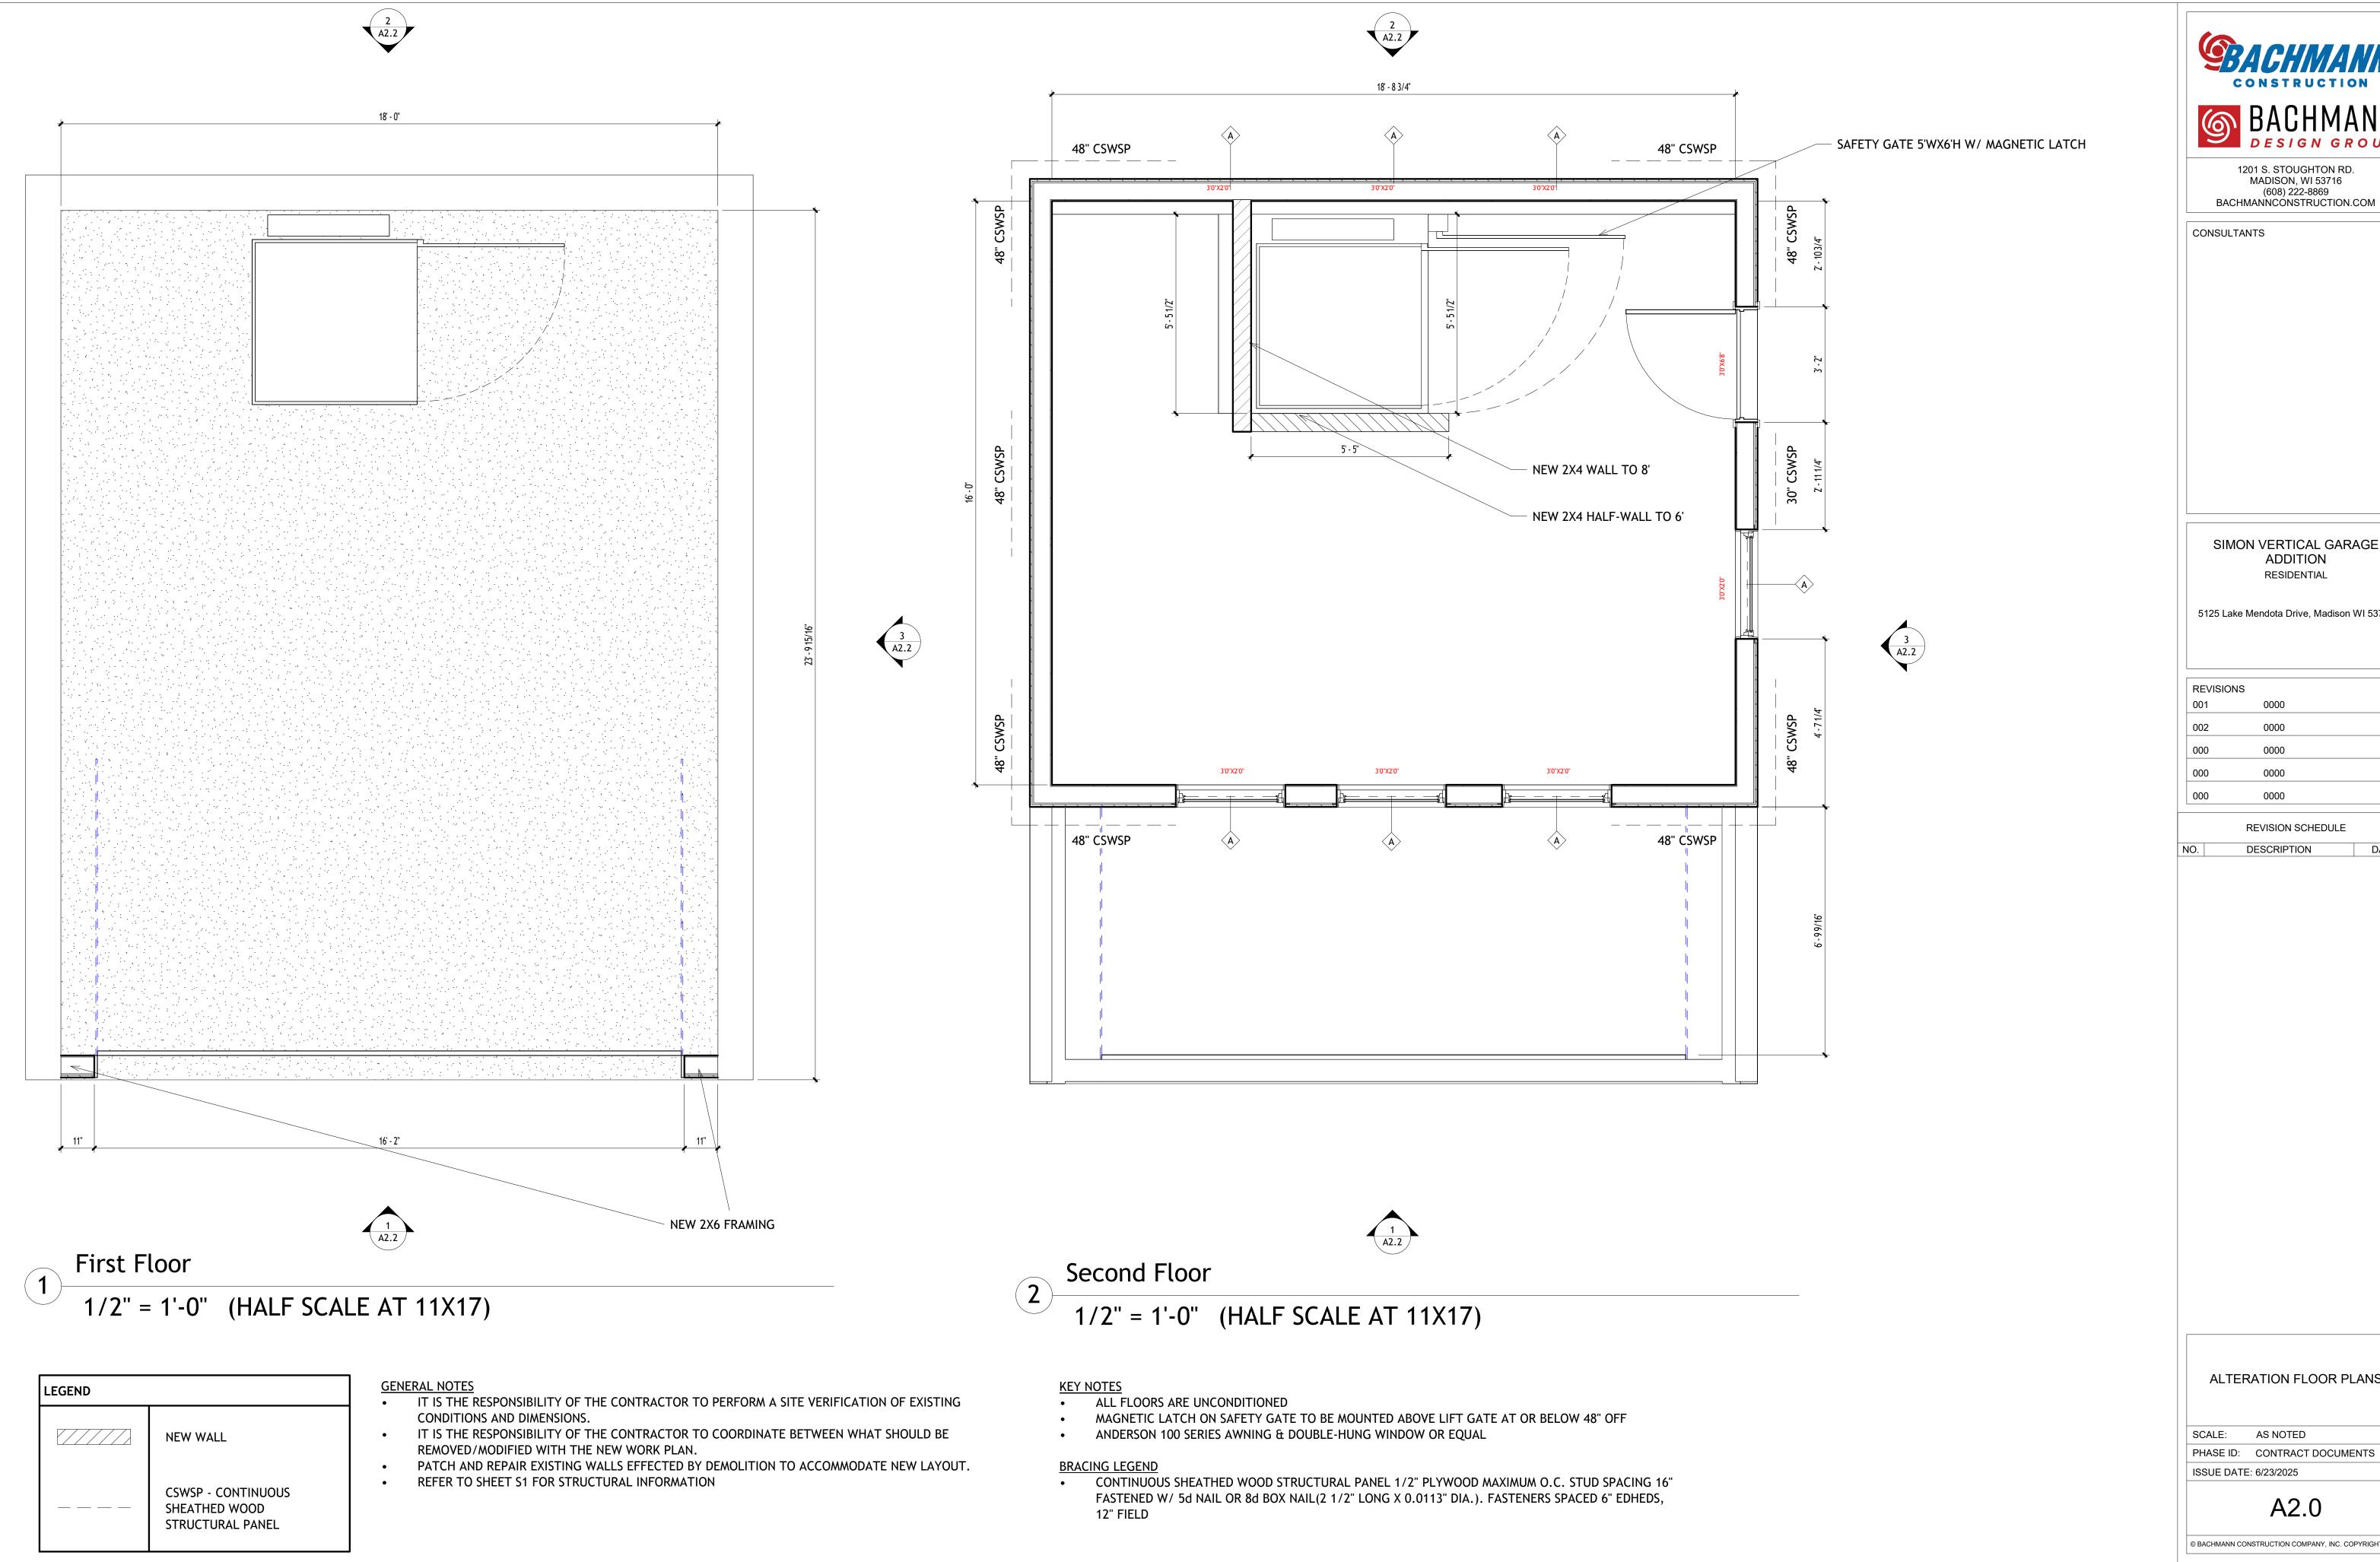

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SIMON VERTICAL GARAGE **ADDITION** RESIDENTIAL

5125 Lake Mendota Drive, Madison WI 53705

REVISIONS 0000 0000 0000

> REVISION SCHEDULE DATE DESCRIPTION


ALTERATION FLOOR PLANS

SCALE: AS NOTED

ISSUE DATE: 6/23/2025

A2.0

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Roof Framing Plan

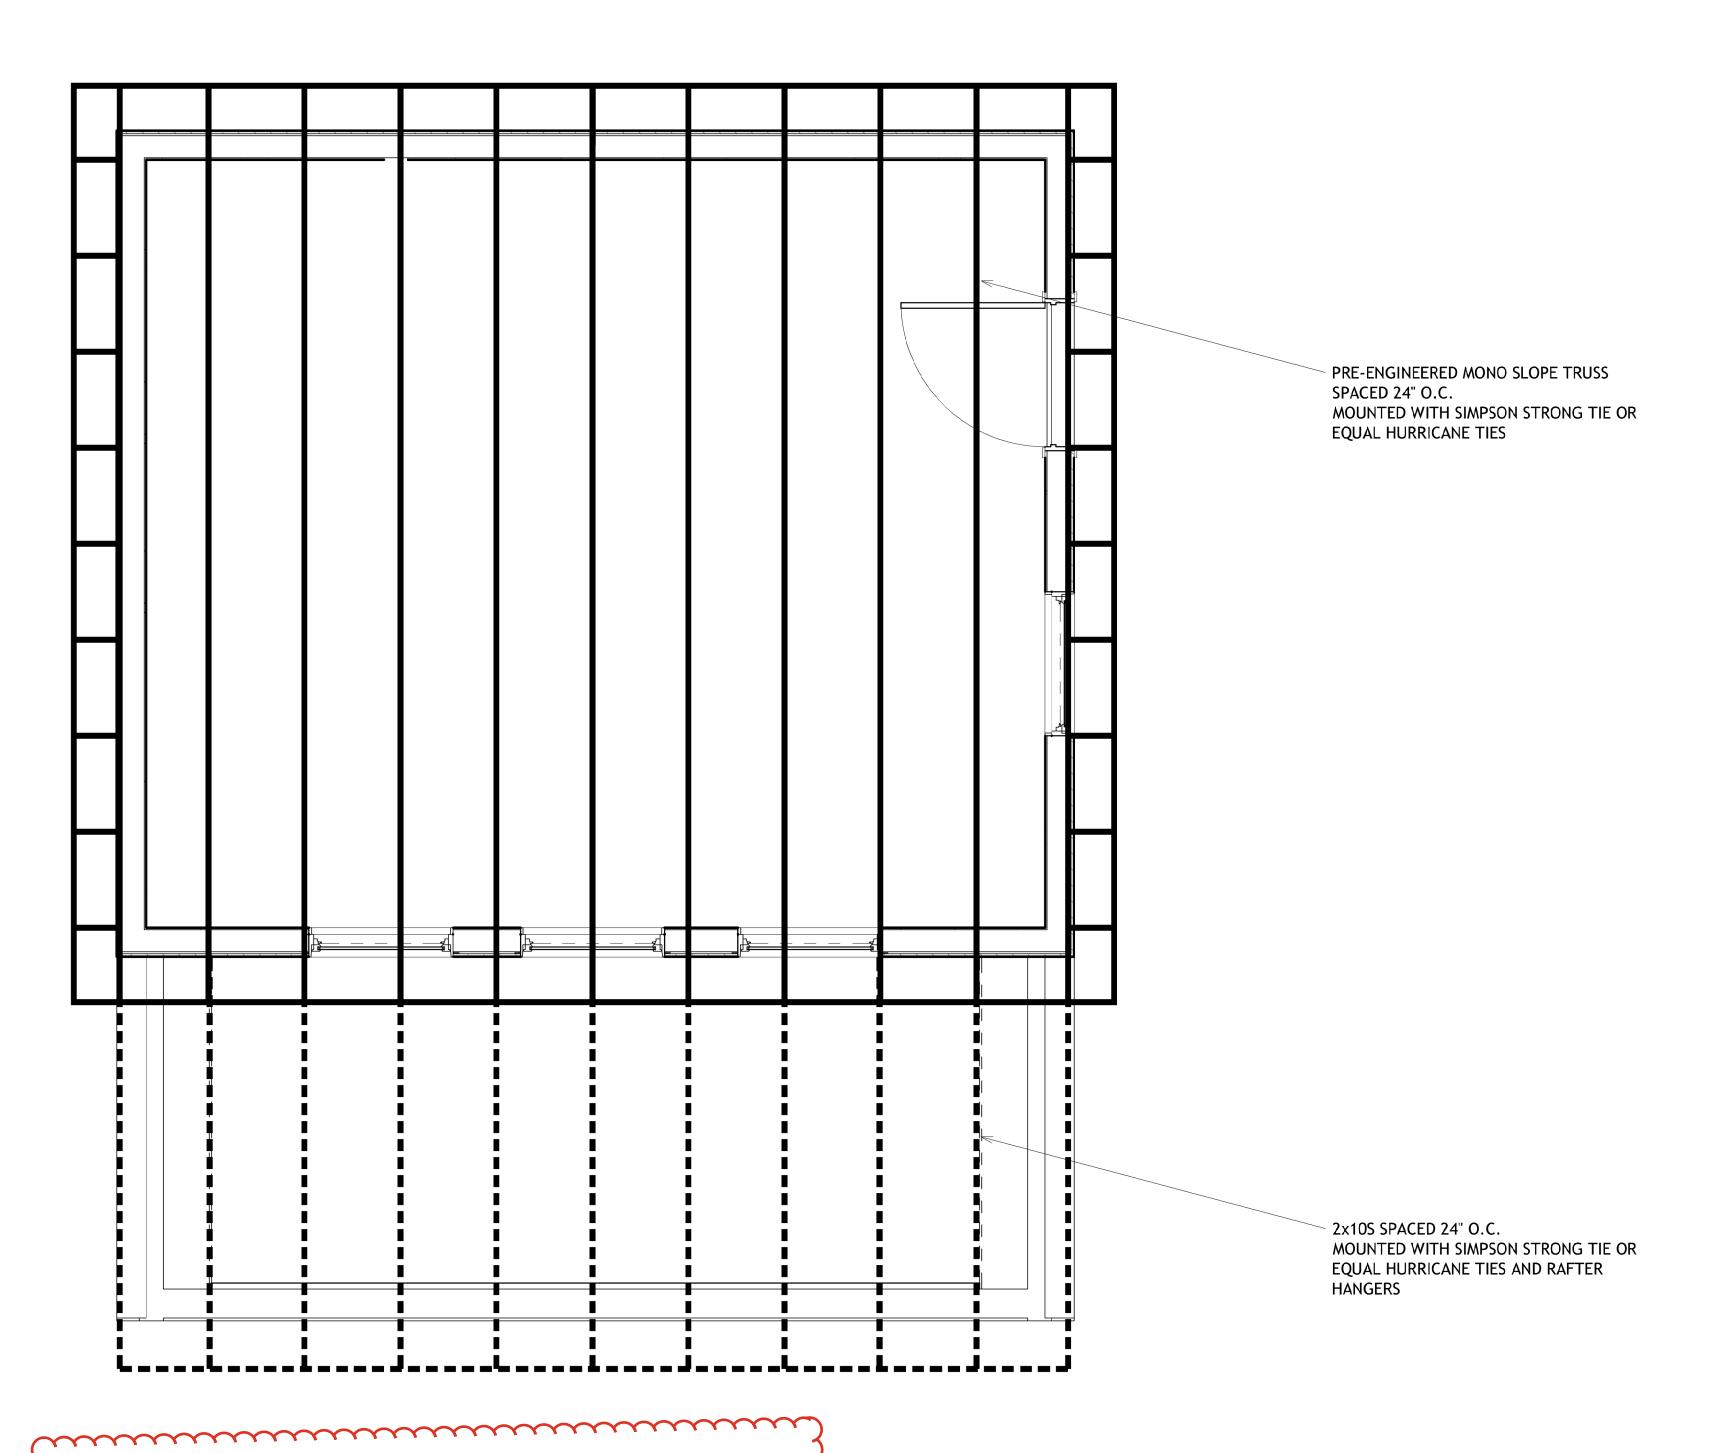1/2" = 1'-0" (HALF SCALE AT 11X17)



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CONSULTANTS

## SIMON VERTICAL GARAGE ADDITION RESIDENTIAL

5125 Lake Mendota Drive, Madison WI 53705

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INTERIOR STRUCTURAL ELEVATIONS

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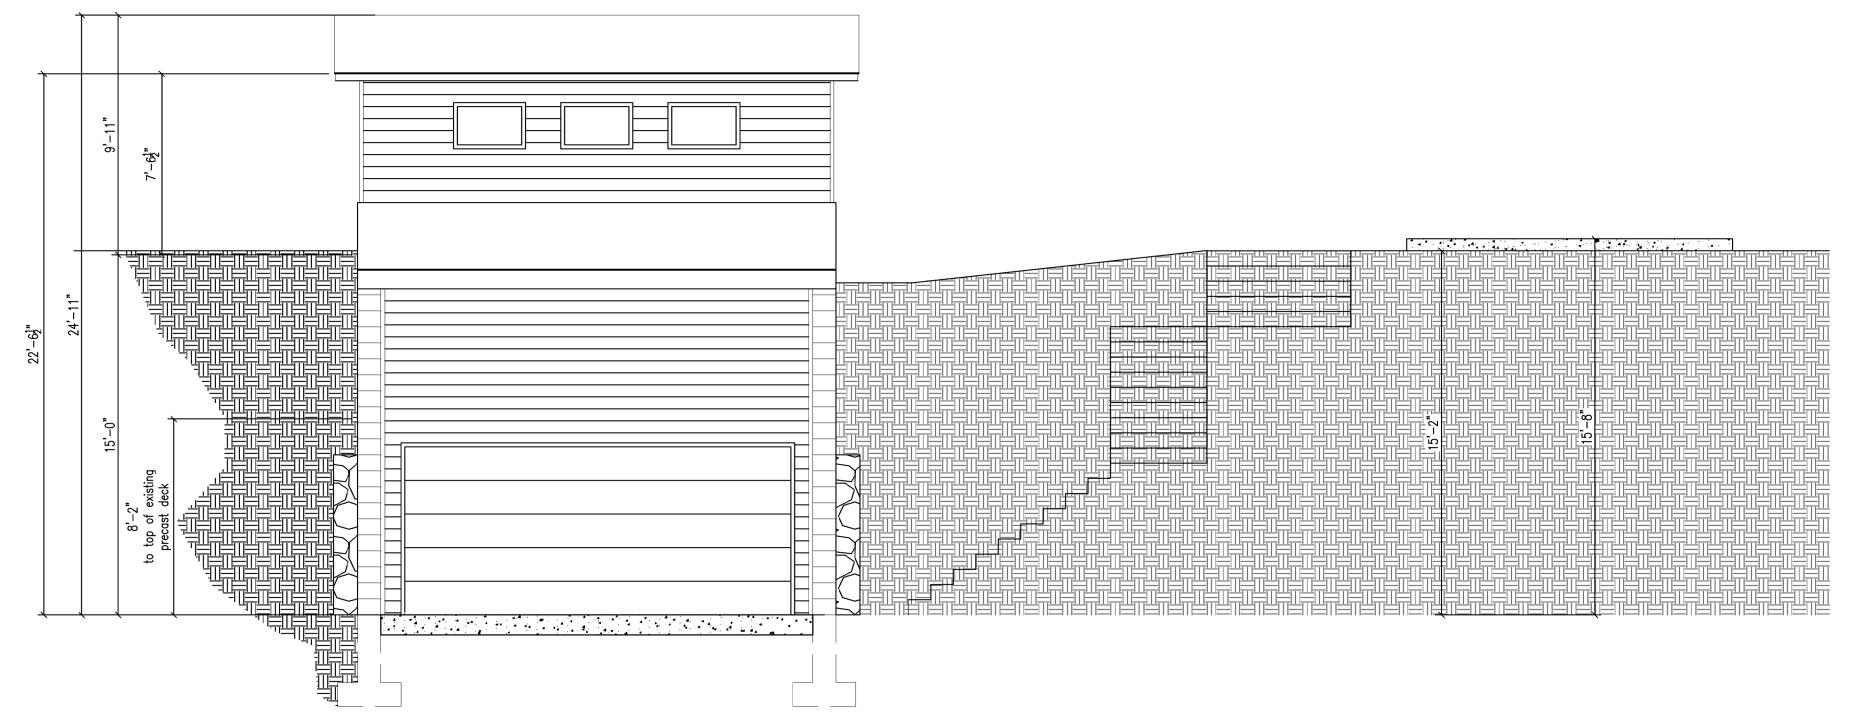
ISSUE DATE: 6/23/2025

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A3.1


Accessory Structure Maximum Height Variance for Detached Garage for Single Family House

Maximum 15'
Proposed 23.7'
Variance 8.7'



EAST WALL STRUCTURAL SECTION

1/4" = 1'-0" (HALF SCALE AT 11X17)

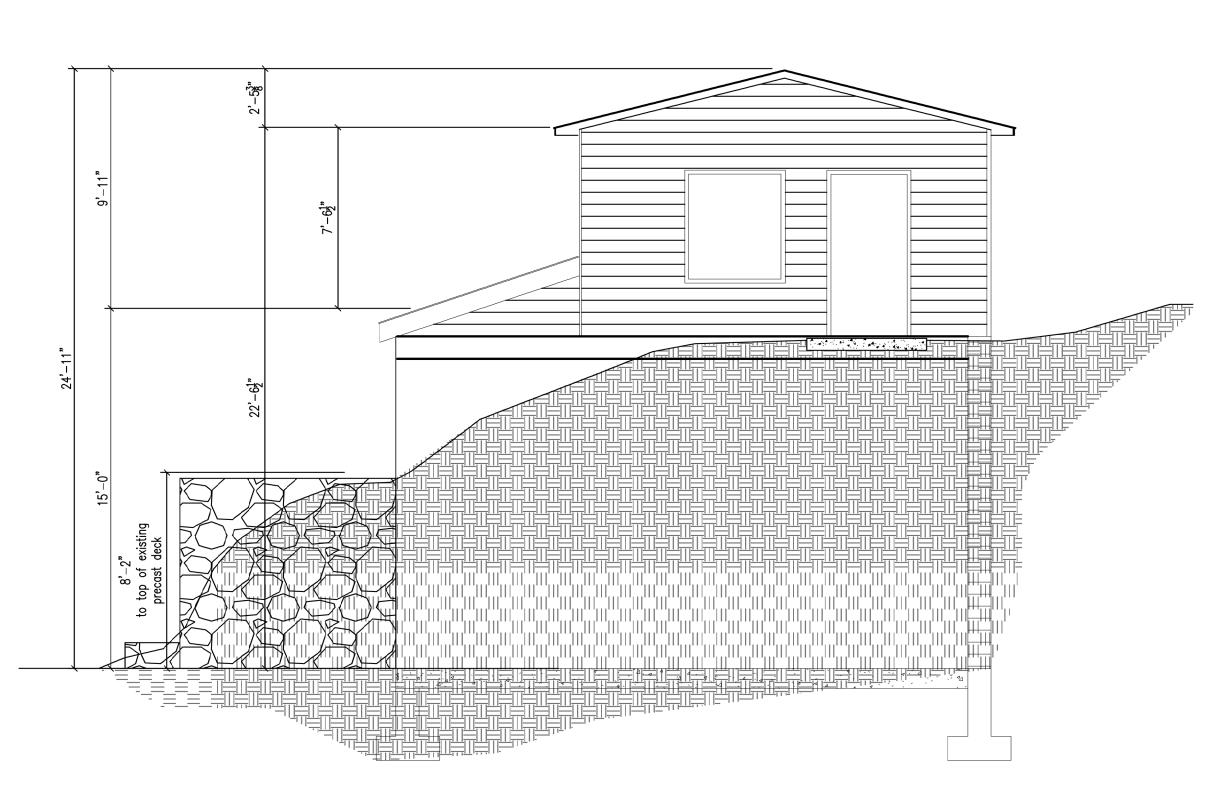

NORTH WALL STRUCTURAL SECTION

1/4" = 1'-0" (HALF SCALE AT 11X17)



1201 S. STOUGHTON RD. MADISON, WI 53716 (608) 222-8869 BACHMANNCONSTRUCTION.COM

CONSULTANTS

SIMON VERTICAL GARAGE ADDITION RESIDENTIAL

5125 Lake Mendota Drive, Madison WI 53705

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REVISION SCHEDULE

NO. DESCRIPTION DATE

INTERIOR STRUCTURAL ELEVATIONS

SCALE: AS NOTED

PHASE ID: CONTRACT DOCUMENTS

ISSUE DATE: 6/23/2025

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#### SAMPLE STRUCTURAL CALCULATIONS


SIMON GARAGE
5125 LAKE MENDOTA DRIVE
MADISON, WI 53705
%KEVIN SORG
BACHMANN CONTRUCTION


#### SHEET INDEX

1.00	TITLE SHEET & SHEET INDEX
2.01-2.14	12" MASONRY WALL -60 PSF/FT (ELEMASONRY)
3.01-3.02	CMU WALL LATERAL SUPPORT
4.00	FLOOR JOIST (WOODWORKS)
5.00	HEADER-1 (WOODWORKS)
6.00	BEAM-1 (WOODWORKS)
7.00	BEAM-2 (WOODWORKS)
8.00	BEAM-3 (WOODWORKS)
ATTENDED OF THE CONTROL OF THE CONTR	


TIMOTHY S. SCHMIT, PE 32451-6
SCHMIT ENGINEERING & SURVEYING LLC
215 GRACE STREET
DODGEVILLE, WI 53533
608-935-2721




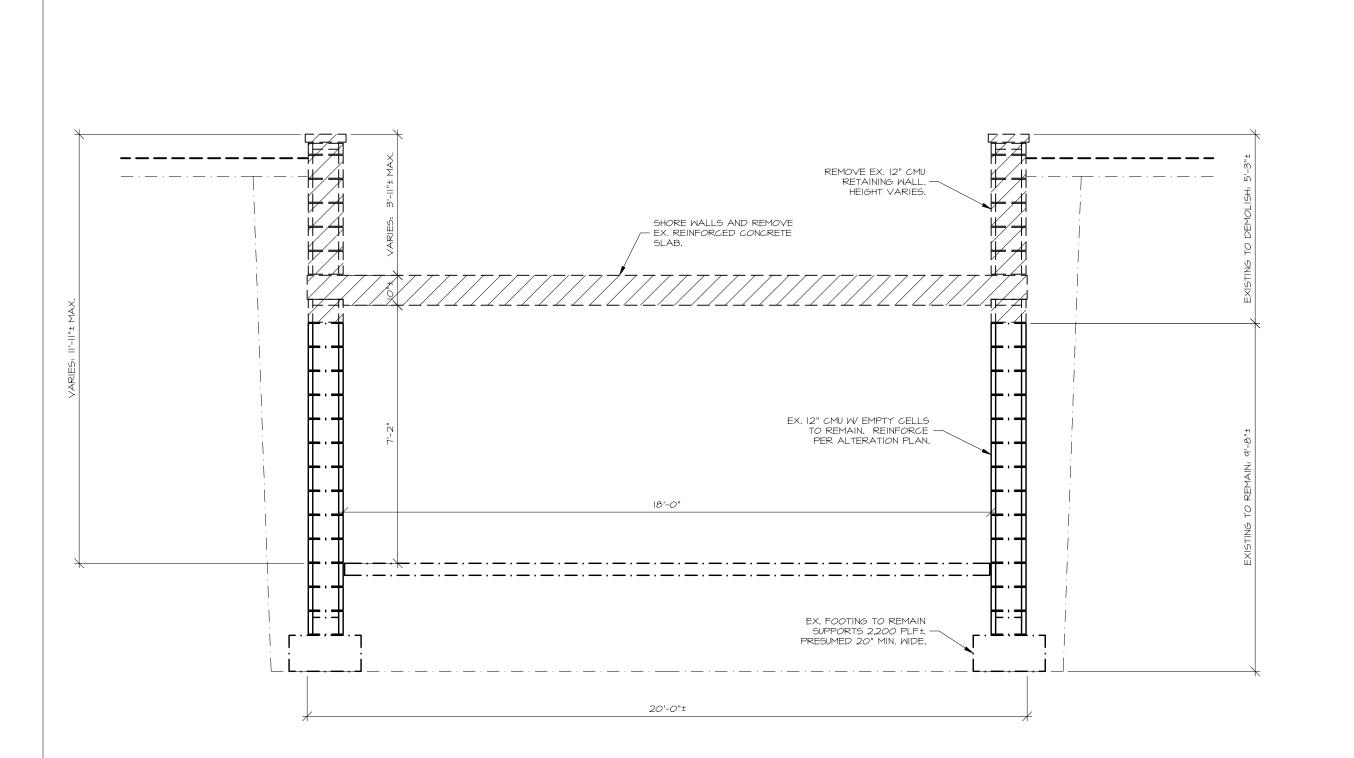

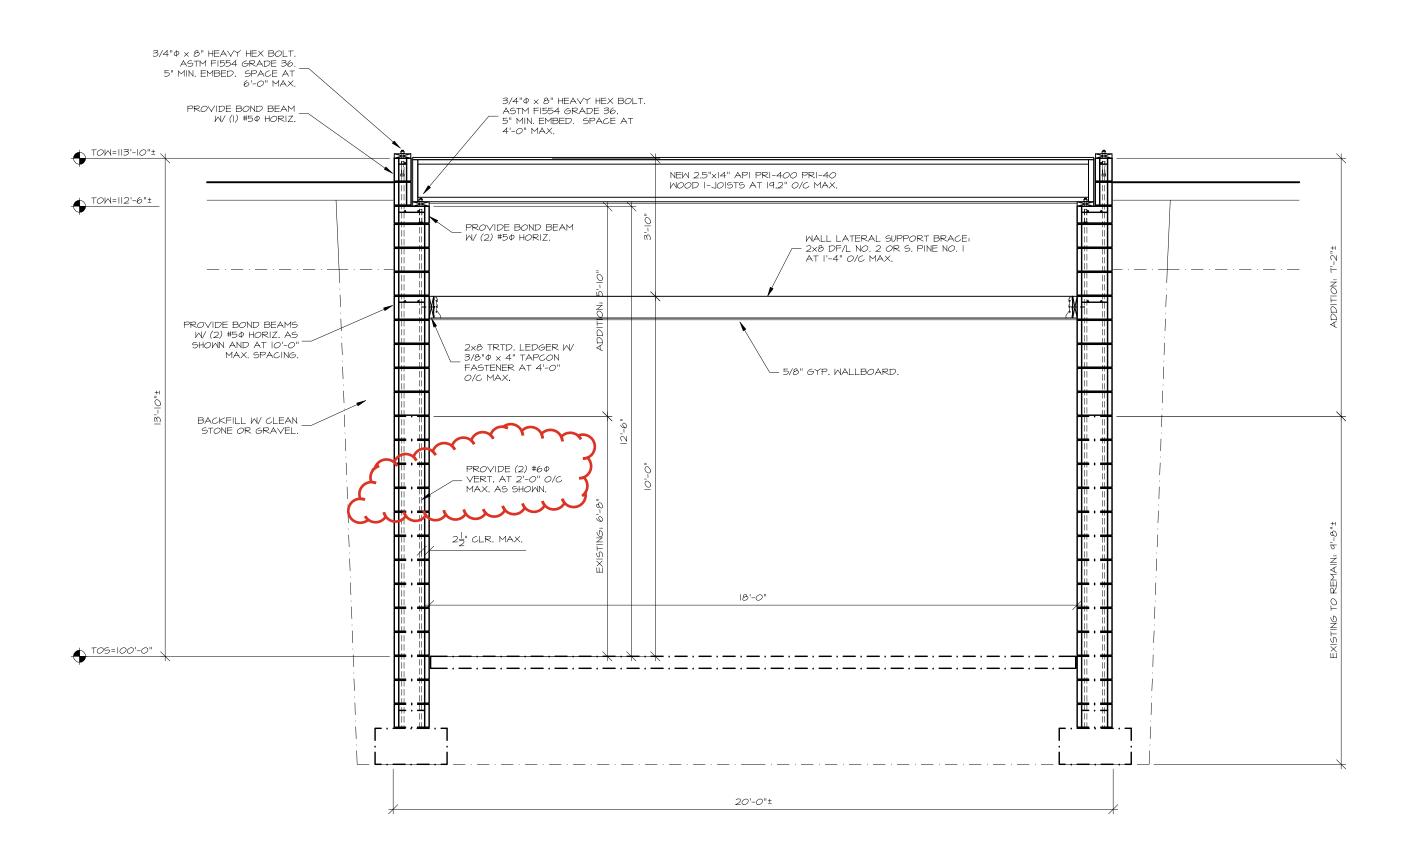


# DEMOLITION SECTION SI SCALE: 3/8"=1'-0"

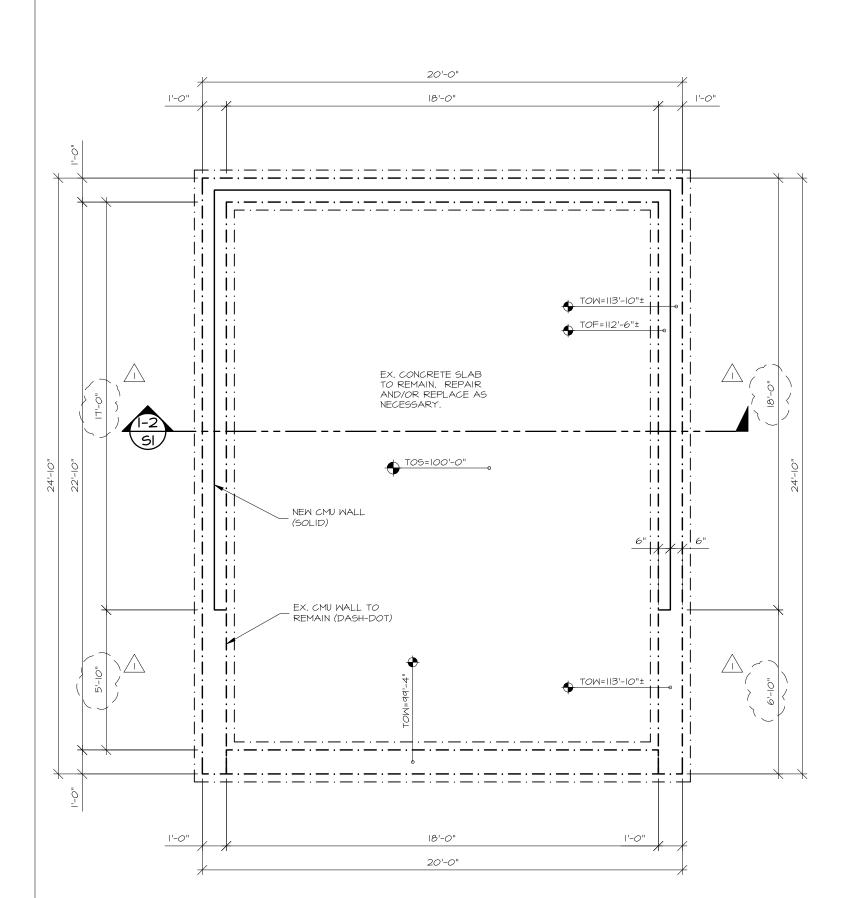

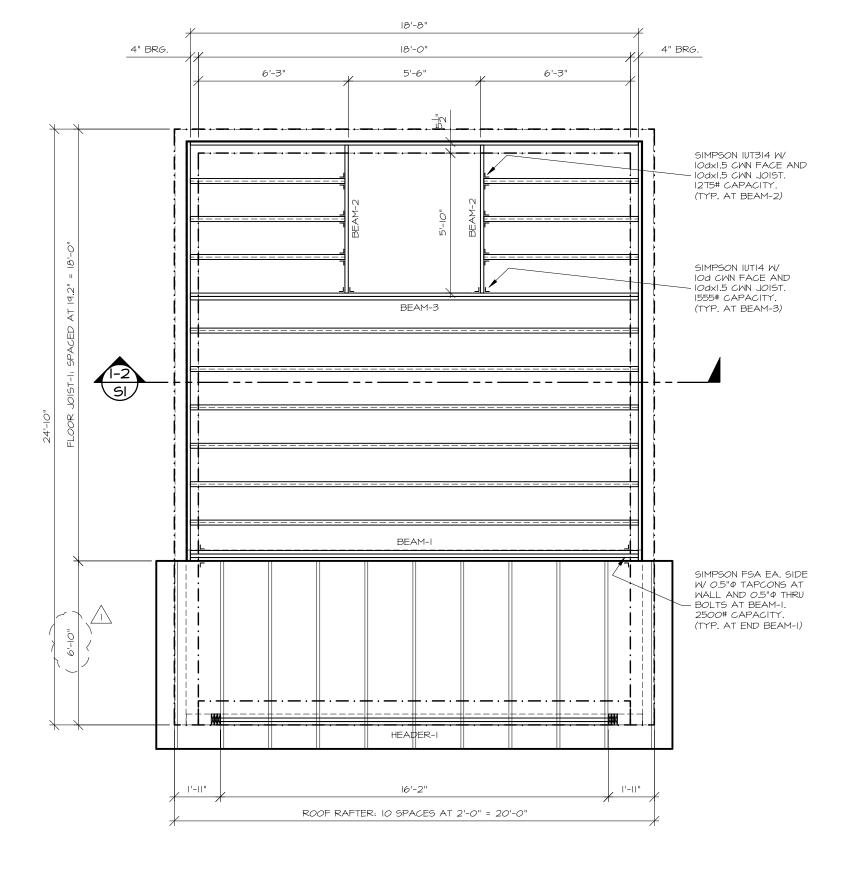



# 2 ALTERATION SECTION SI SCALE: 3/8"=1'-0"

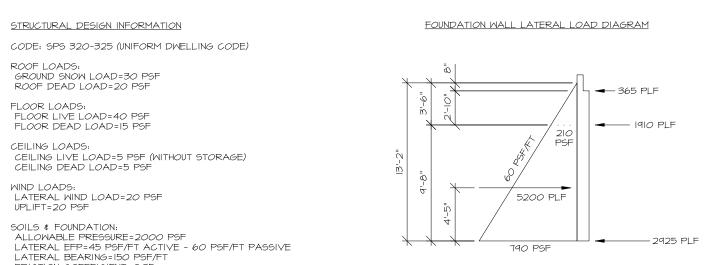

FRICTION COEFFICIENT=0.25

MASONRY SPECIFICATIONS MASONRY DESIGN SHALL COMPLY WITH THE PROVISIONS OF TMS 402/ACI 530/ASCE 5.

CONCRETE MASONRY UNITS SHALL COMPLY WITH ARTICLE 2.3 OF TMS 602/ACI 503.1/ASCE 6. PROVIDE ASTM C90, SOLID UNITS OF NORMAL WEIGHT, TYPICALLY CORED. INSTALL UNITS IN RUNNING BOND PATTERN.

MORTAR FOR USE IN MASONRY CONSTRUCTION SHALL CONFORM TO ARTICLES 2.1 AND 2.6 A OF TMS 602/ACI 530.1/ASCE 6. PROVIDE ASTM C270, TYPE M OR S.

-PORTLAND CEMENT SHALL CONFORM TO ASTM C150, TYPE I OR II. -LIME SHALL CONFORM TO ASTM C207, TYPE S. -MASONRY SAND SHALL CONFORM TO ASTM C144.

GROUT SHALL COMPLY WITH ARTICLE 2.2 OF TMS 602/ACI 530.1/ASCE 6. PROVIDE ASTM C476, FINE OR COARSE TYPE THAT WILL COMPLY WITH ARTICLE 2.2.

-AGGREGATE FOR GROUT SHALL CONFORM TO ASTM C404. -GROUT SOLID ALL REINFORCED CORES.

METAL REINFORCEMENT AND ACCESSORIES SHALL CONFORM TO ARTICLE 2.4 OF TMS 602/ACI 530.1/ASCE 6. PROVIDE ASTM A615 OR ASTM A996, GRADE 60 UNCOATED STEEL REINFORCING BARS.

MASONRY CONSTRUCTION SHALL COMPLY WITH THE REQUIREMENTS OF TMS 602/ACI 530.I/ASCE 6.

FLOOR JOIST SCHEDULE

FLOOR JOIST-I (TYP. FLOOR): 2.5"xI4" WOOD I-JOIST AT 19.2" O/C MAX. API PRI-400 PRI-40.

FLOOR HEADER SCHEDULE

HEADER-I : (2-PLY) I-3/4"  $\times$  I4" LVL I.8E 2,200 Fb W (2) 2x TRIMMER.

FLOOR BEAM SCHEDULE

BEAM-I : (3-PLY) I-3/4" x I4" LVL I.8E 2,200 Fb


BEAM-2 : (I-PLY) I-3/4" x I4" LVL I.8E 2,200 Fb

BEAM-3 : (2-PLY) I-3/4"  $\times$  I4" LVL I.8E 2,200 Fb

FLOOR: WOOD I-JOIST AT I9.2" O/C MAX, W/ 23/32" T&G OSB SHEATHING, STAGGERED. NAILING: IOd CWN P=1.5" MIN. AT 6" O/C EDGE, I2" O/C FIELD.



DATE: NO: 06-23-25 09-29-25

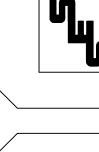

TIMOTHY S. SCHMIT E - 32451MADISON, WIS.

Timothy S. Schmit

REVISED 09/29/25

 $\square$ FOUNDATION FRAMING PLA 5125 LAKE M MADISON, WI

DWG: 25E-065

DATE: 09-29-25 SCALE: NOTED

SHEET #