APPLICATION FOR URBAN DESIGN COMMISSION REVIEW AND APPROVAL

AGENDA ITEM #	
Project #	

DATE SUBMITTED: 3/8/2016 Action Requested Informational Presentation
UDC MEETING DATE: 3/17/2010 Initial Approval and/or Recommendation Final Approval and/or Recommendation
PROJECT ADDRESS: 7102 U.S. HIGHWAY 12 & MADISON, WI 5371 ALDERMANIC DISTRICT: 16
OWNER/DEVELOPER (Partners and/or Principals) PANE COUNTY DEPT OF PUBLIC WORKS HIGHWAY & TRANSPORTATION CONTACT PERSON: JOHN KANNALL, P.E. Address: 125 5. 84 151 501 401 MILWAVKEE, WI 532 4 Phone: 414. 266. 9040 Fax: 414. 259.0037 E-mail address: John Kannall & graef-usa.com TYPE OF PROJECT: (See Section A for:) Planned Unit Development (PUD) General Development Plan (GDP) Specific Implementation Plan (SIP) Planned Community Development (PCD) General Development (PCD) General Development Plan (GDP) Specific Implementation Plan (SIP) Planned Residential Development (PRD) New Construction or Exterior Remodeling in an Urban Design District * (A public hearing is required a
well as a fee) School, Public Building or Space (Fee may be required) New Construction or Addition to or Remodeling of a Retail, Hotel or Motel Building Exceeding 40,000 Sq. Ft. Planned Commercial Site
(See Section B for:) New Construction or Exterior Remodeling in C4 District (Fee required)
(See Section C for:) R.P.S.M. Parking Variance (Fee required)
(See Section D for:) Comprehensive Design Review* (Fee required) Street Graphics Variance* (Fee required)
Other
*Public Hearing Required (Submission Deadline 3 Weeks in Advance of Meeting Date)
Where fees are required (as noted above) they apply with the first submittal for either initial or final approval of

a project.

Letter of Intent

Dane County has operated a municipal solid waste landfill at this site, as a service to its residents and to local municipalities, since 1985, with an expansion to its current footprint occurring in 1994. In recent years, Dane County has received 175,000 – 200,000 tons of solid waste annually. Dane County has a plan of operation on file with the WI DNR, and the site complies with all applicable regulations. Dane County has also worked hard to maintain a very good working relationship with the neighbors of this site, while providing an economical and environmentally responsible waste disposal solution as an element of its comprehensive and integrated solid waste management plan.

As part of its plans for continued landfill operation, Dane County is always looking for ways to divert waste and extend the life of the landfill. One of the best methods for accomplishing this is to divert recyclable materials from the waste stream that is disposed of in the landfill hill. Diverting recyclable materials to recycling markets will extend the life of our landfill, increase recycling rates, and reduce our dependence on raw materials for manufacturing. In an effort to divert more material from the landfill hill, Dane County is proposing the construction of new waste transfer station at the current Dane County landfill site, 7102 U.S. Hwy 12 & 18, Madison WI.

The waste transfer station will be used to separate recyclable materials, especially Construction and Demolition waste, from the waste stream. This separation will take place on the tipping floor slab, which is the main floor space within the waste transfer station and where waste haulers will dump their loads. Wastes will then be loaded onto semi trailers one of two ways. Waste will either be 1) top loaded into open-top semi trailers parked below the tipping floor slab; or 2) pushed into holes at the south end of the tipping floor slab. The holes on the south end of the building lead to compactors below, where the waste will be compacted before being end-loaded onto semi trailers. The semi trailers will then haul the wastes to appropriate final locations. This building is being designed to eventually handle 1800 tons of waste per day. The building would use renewable heat from the electrical generation engines on site to heat the tipping floor slab.

In addition to the waste transfer station, Dane County is also proposing to construct a household hazardous waste drop off site to house the Clean Sweep program year-round. The Clean Sweep program provides a place for residents to safely dispose of hazardous household materials, such as fertilizer, chemicals, mercury, paint, batteries, etc. Currently, Clean Sweep is only open during the summer months, but this new building will allow Clean Sweep to remain open to County residents year-round. The Clean Sweep building would obtain all of its heat from the electrical generation engines on site, a renewable energy source.

As shown on the attached plans, the construction of these facilities includes construction of drive paths and parking areas. A stormwater control plan will be developed for this site, and it will coordinate future runoff with the existing storm waterplan on file with the DNR.

Because the transfer station will be handling waste that would have already been coming to this site, the only anticipated increase in traffic for the transfer station is the relatively small number of semi trailers leaving the facility. The largest traffic increase will be due to residents using the Clean Sweep facility, which will result in an estimated increase of less than 50 vehicle trips per day during its busiest period.

DANE COUNTY WASTE TRANSFER STATION AND HOUSEHOLD HAZARDOUS WASTE FACILITY RODEFELD LANDFILL 7102 US HIGHWAY 12 & 18 MADISON, WISCONSIN

GRaEF

One Honey Creek Corporate Center 125 South 84th Street, Suite 401 Milwaukee, WI 53214-1470 414 / 259 1500 414 / 259 0037 fax

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CONSULTANTS:

SUBMITTALS

URBAN DESIGN COMMISSION REVIEW 03-17-2010 URBAN DESIGN COMMISSION REVIEW 02-08-2010 URBAN DESIGN COMMISSION REVIEW 01-12-2010

DANE COUNTY
WASTE TRANSFER STATION
AND HOUSEHOLD HAZARDOUS
WASTE FACILITY
RODEFELD LANDFILL

IS

PROJECT TITLE:

PROJECT LOCATION

TO THE PROJECT LOCATION

TO

LOCATION MAP

-4

revit worksets/2009-0328_A_L_DaneCntyWasteTransfer/200

DRAWING LIST

T 100 TITLE SHEET

C300 SITE PLAN
C400 GRADING PLAN
A300 BUILDING ELEVATIONS
A301 BUILDING ELEVATIONS
E001 SITE ELECTRICAL PLAN

C200 DEMOLITION AND EROSION CONTROL

E002 SITE PHOTOMETRIC PLAN

SHEET NUMBER:

PROJECT INFORMATION:

03-17-2010

Author

Checker

Approver AS NOTED

SHEET TITLE:

PROJECT NUMBER: 2009-0328.00

DATE:


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CHECKED BY:

TITLE SHEET

APPROVED BY:

T100



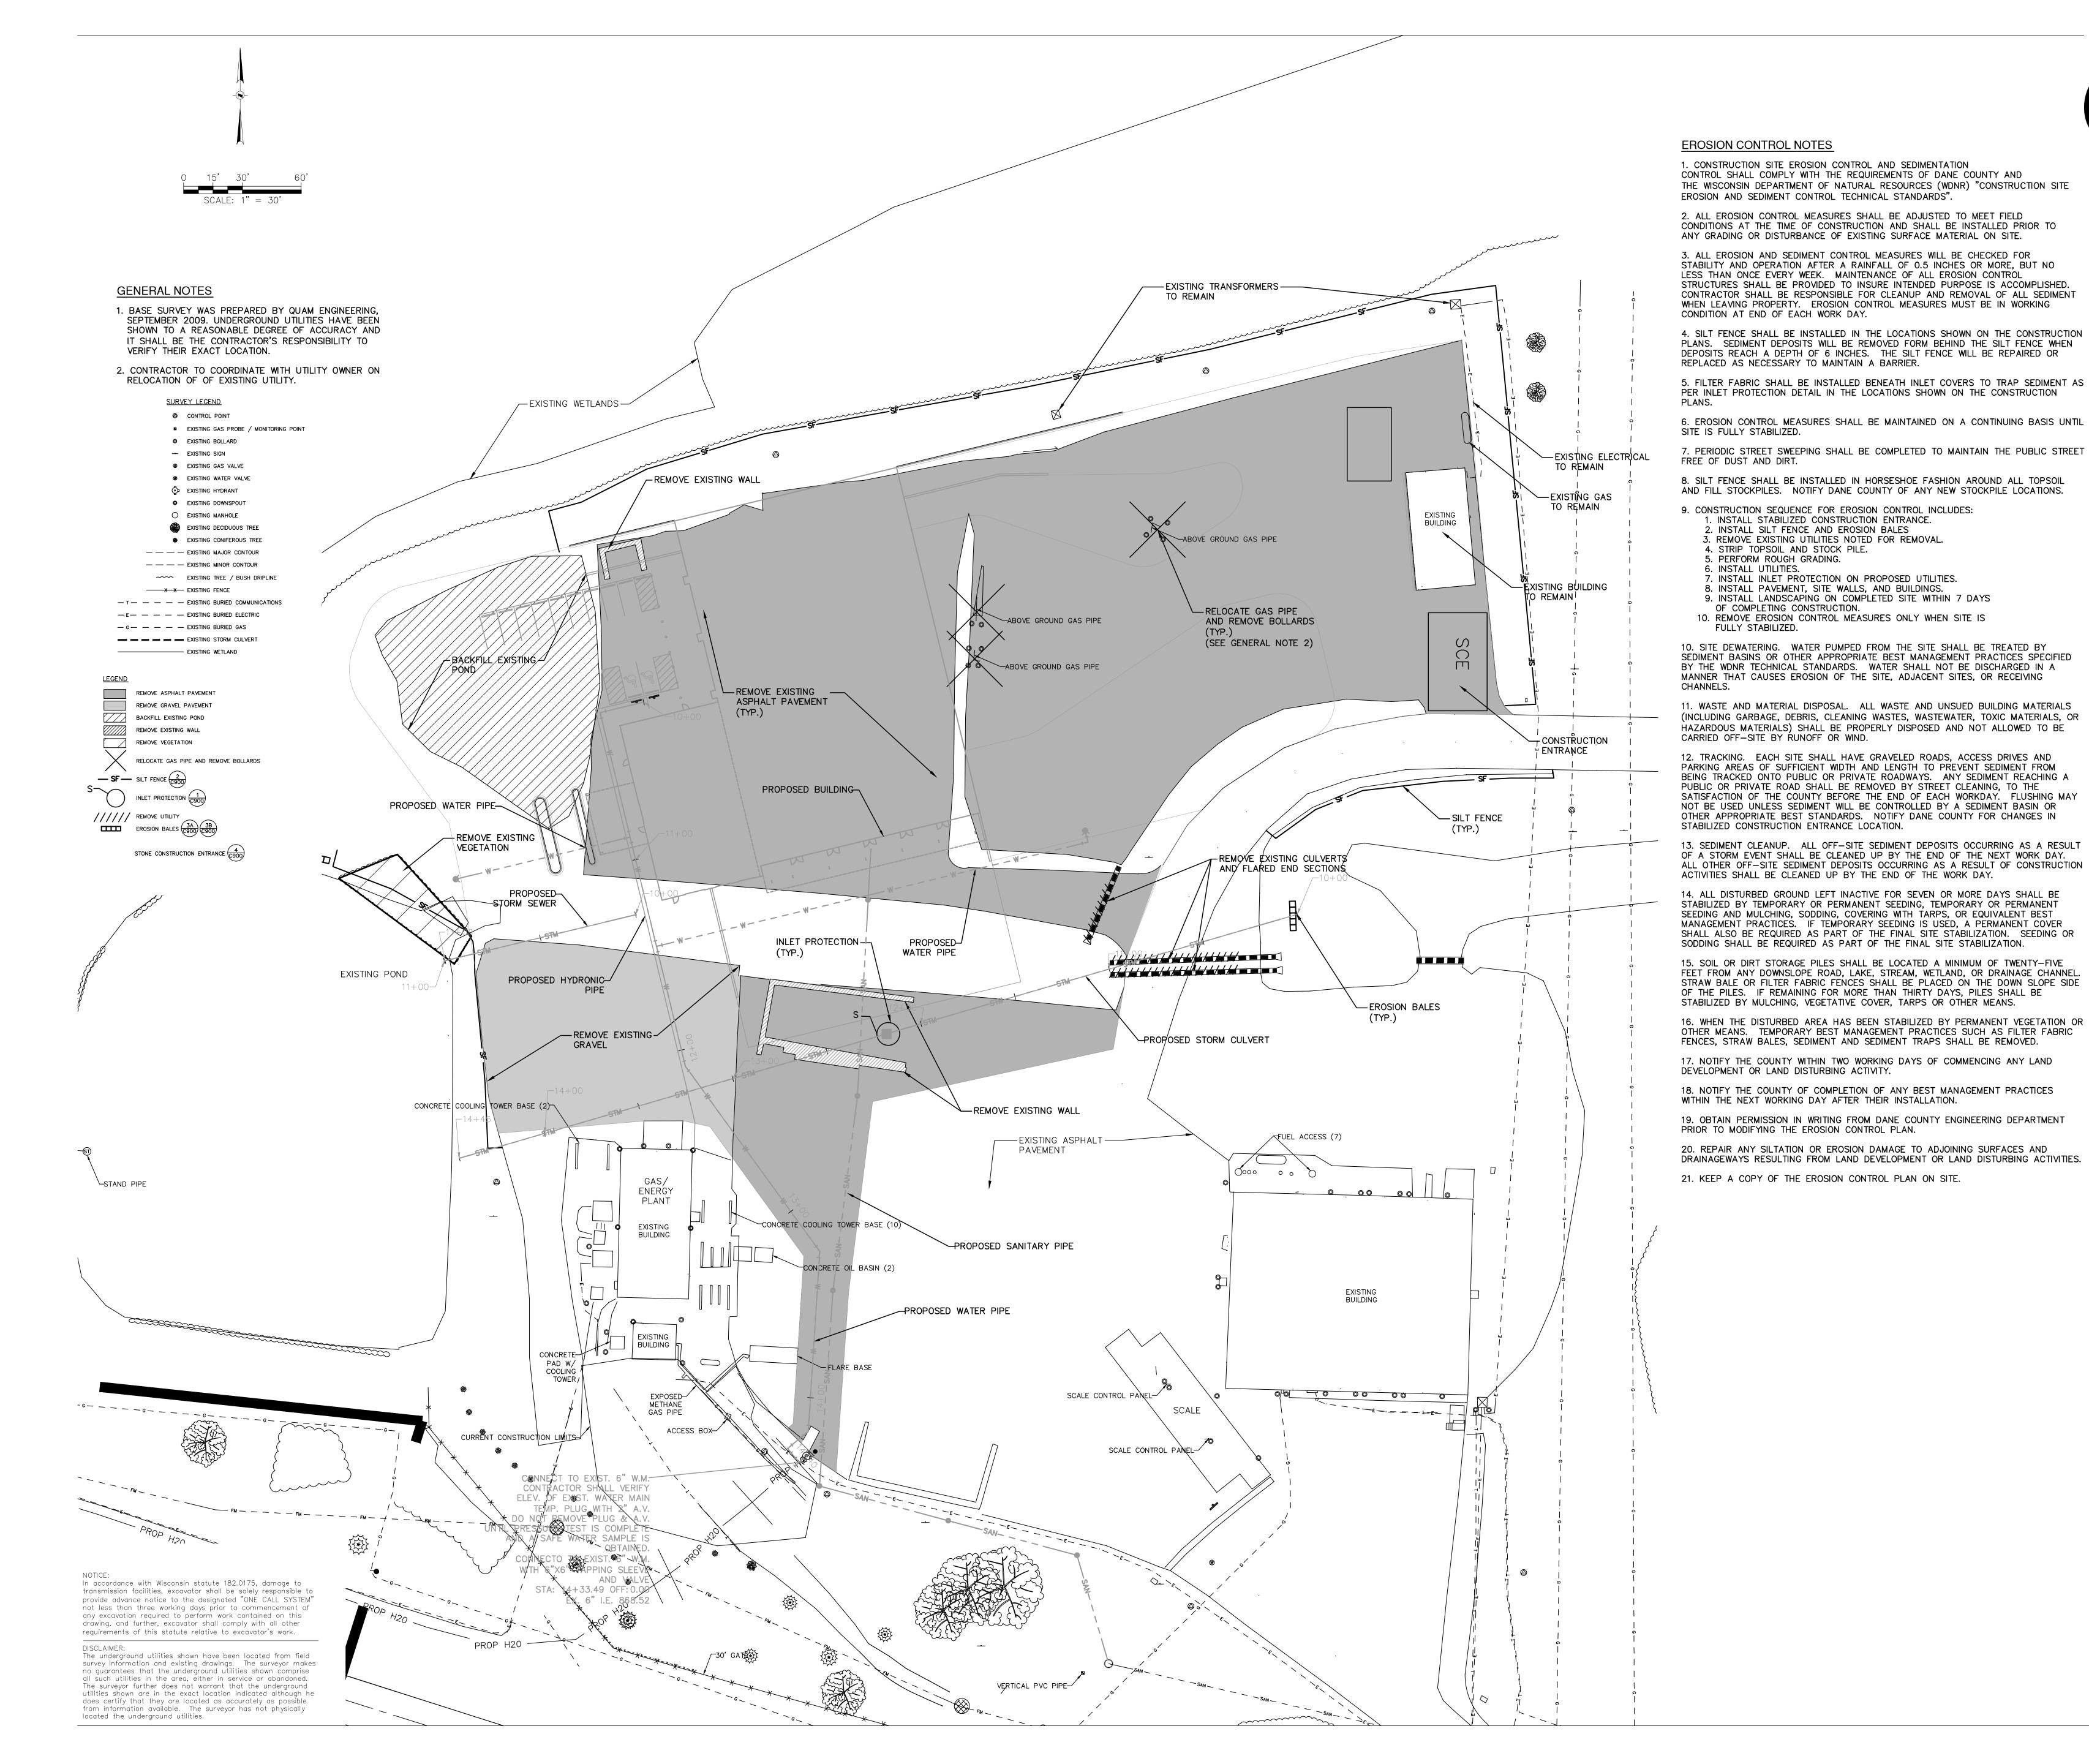

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PROJECT TITLE:

DANE COUNTY WASTE TRANSFER STATION AND HOUSEHOLD HAZARDOUS WASTE FACILITY RODEFELD LANDFILL

NO. DATE REVISIONS BY

ISSUE:

PROJECT INFORMATION:

PROJECT NUMBER: 2009-0328.00

DATE: 01-12-2010

DRAWN BY:

CHECKED BY:

APPROVED BY: SCALE:


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SHEET TITLE:

DEMOLITION AND EROSION CONTROL PLAN





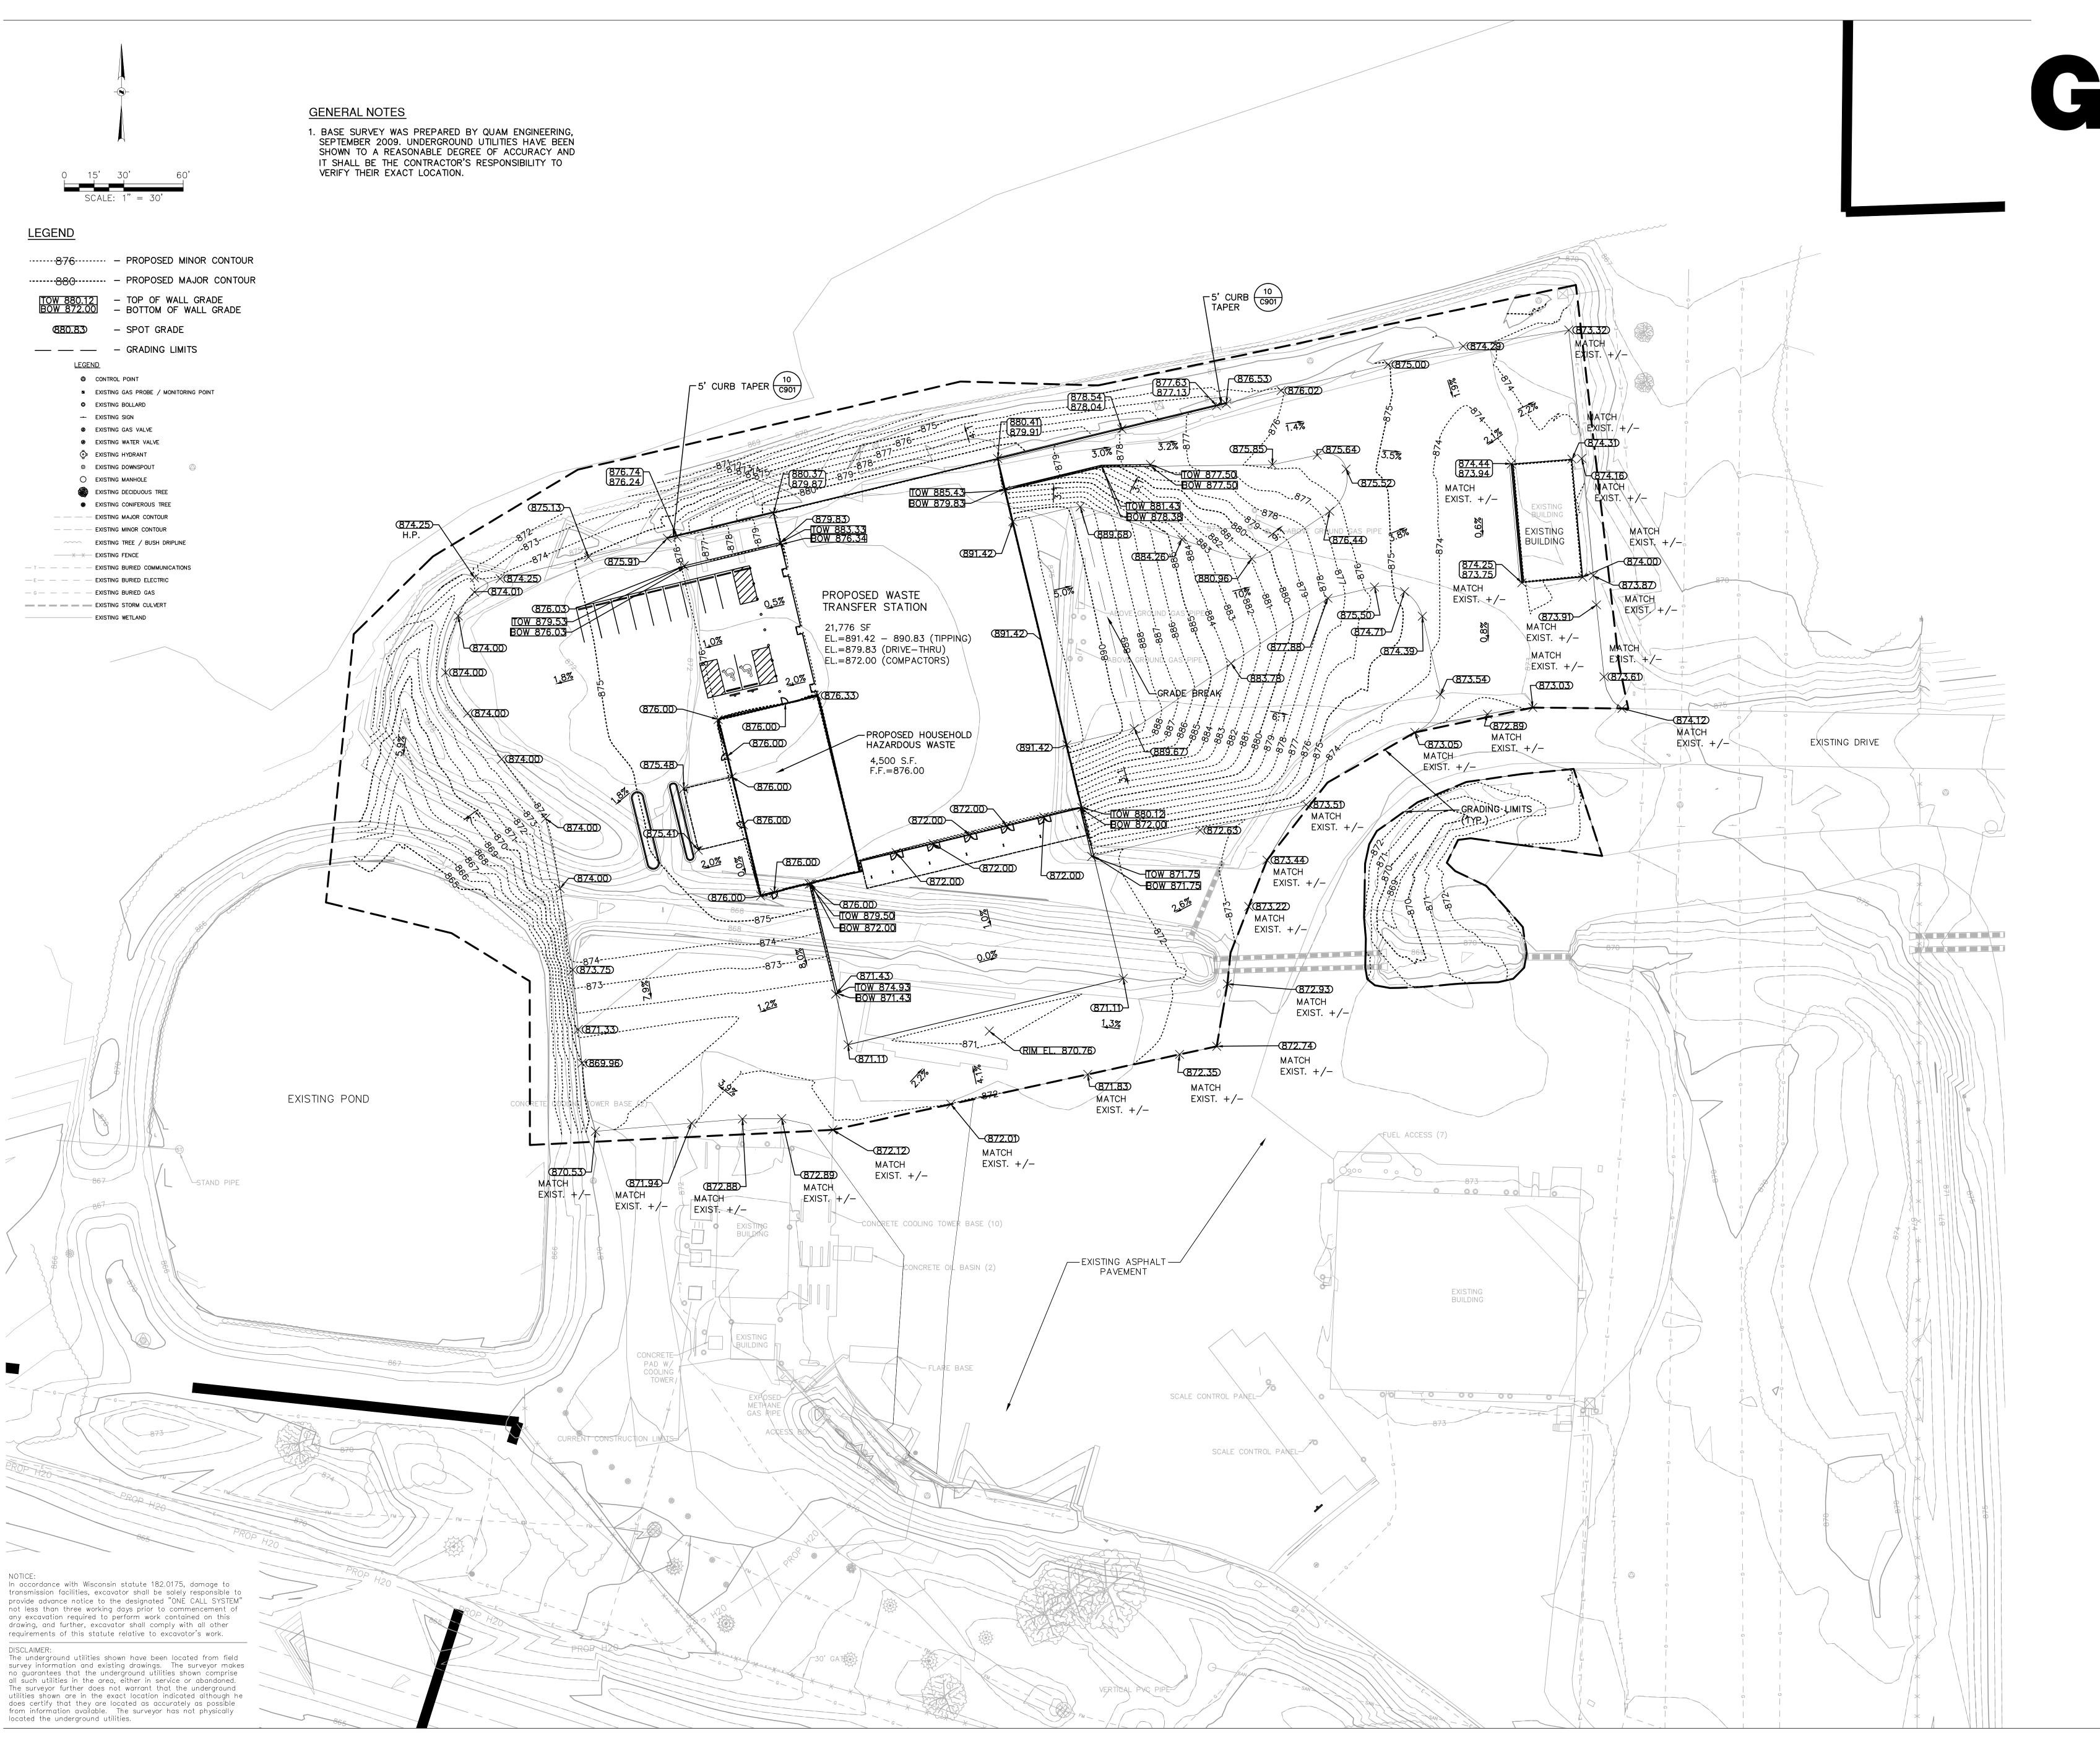

GREF

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DANE COUNTY WASTE TRANSFER STATION AND HOUSEHOLD HAZARDOUS WASTE FACILITY RODEFELD LANDFILL

ISSUE: NO. DATE REVISIONS BY

PROJECT INFORMATION:

PROJECT NUMBER: 2009-0328.00

02-03-2010

CHECKED BY:

SCALE:

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SHEET TITLE:

GRADING PLAN

C400




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ISSUE:



C.9 D D.2

(C)

W-3

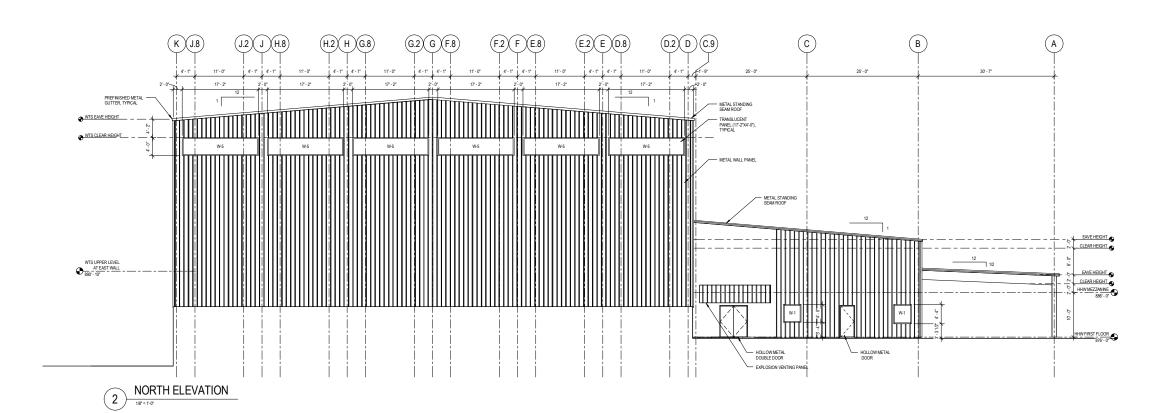(A)

HHW CLEAR HEIGHT _____

HHW MEZZANINE
886' - 0"

HHW FIRST FLOOR

SOUTH ELEVATION

D.8 E E.2

F.8 G G.2

E.8 F F.2

G.8 H H.2

(H.8) J (J.2)

WIS EAVE HEIGHT

WTS LOWER LEVEL

PROJECT INFORMATION:

PROJECT NUMBER: 2009-0328.00 DATE: 03-17-2010

DRAWN BY: JMR
CHECKED BY: SEB/JHK
APPROVED BY: JHK


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SHEET TITLE:
BUILDING ELEVATIONS

SHEET NUMBER:

A300



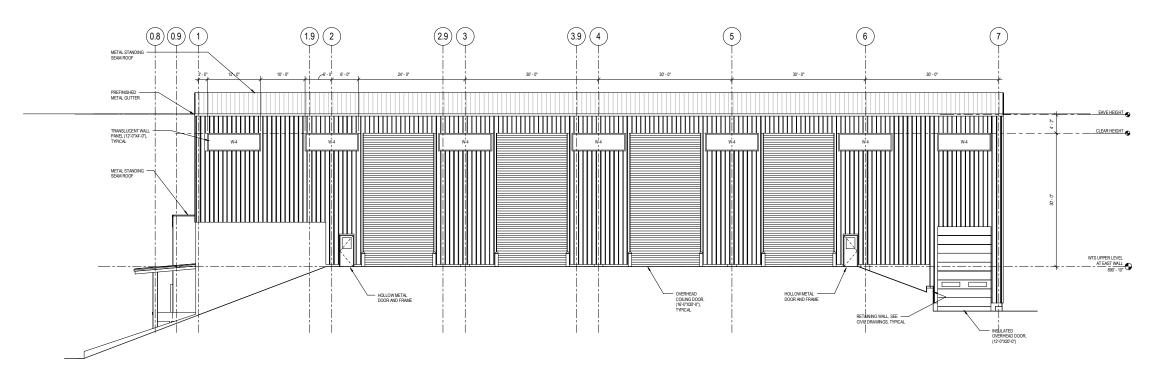

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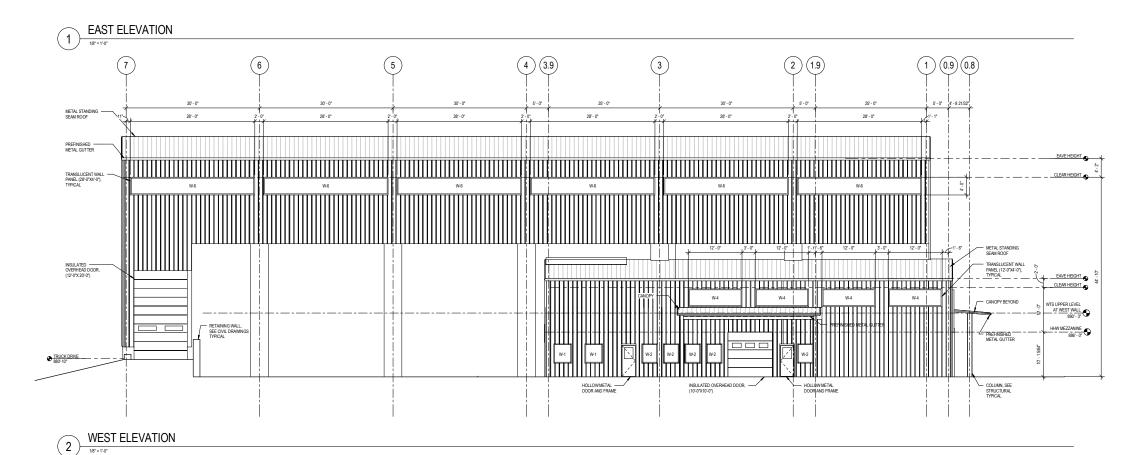
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PROJECT TITLE:

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RODEFELD LANDFILL

ISSUE:



PROJECT INFORMATION:

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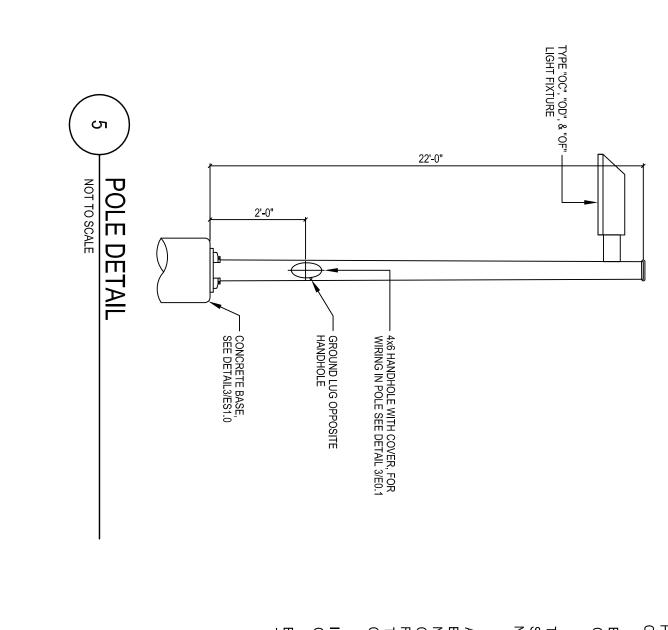
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APPROVED BY: JHK

SCALE: AS NOTED

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BUILDING ELEVATIONS

SHEET NUMBER:






2

POLE WIRING DETAIL

CONNECT TO GROUND
 LUG ON POLE

ANCHOR BOLTS PERPOLE MANUFACTURER

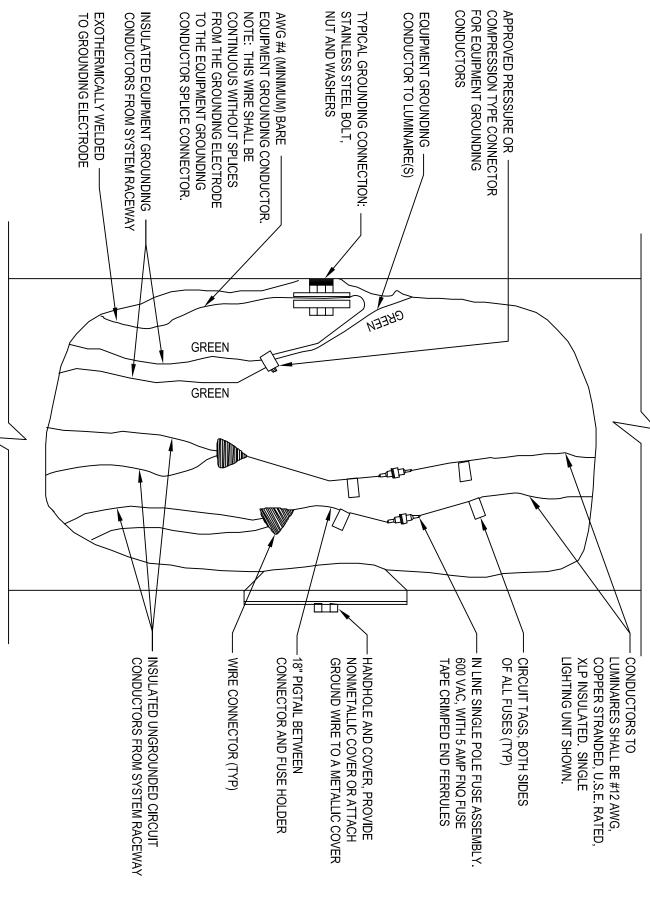

GROUNDING STEM RACEWAY	SPLICES ELECTRODE JUNDING NNECTOR.	CONDUCTOR.			NNECTION:		RE(S)		DING	NECTOR			
	GREEN					MEER	>)		_		_		\
	GREEN												
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JLATED UI	WIRE CONNECTOR (TYP)		18" PIGTAIL BETWEEN CONNECTOR AND FUSE HOLDER	OUND WIR	NMETALLIC	1		TAPE CRIMPED END FERRULES	INE SINGL	OF ALL FUSES (TYP)	CIRCUIT TAGS, BOTH SIDES	HING ON	LUMINAIRES SHALL BE #12 AWG, COPPER STRANDED, U.S.E. RATE XLP INSULATED. SINGLE
NGROUND S FROM SY	CTOR (TYP		ETWEEN	E IO A ME	COVERC			D END FER	E POLE FL	5 (TYP)	S, BOTH SI	SHOWN.	NALL BE #1 NDED, U.S.I
INSULATED UNGROUNDED CIRCUIT CONDUCTORS FROM SYSTEM RACEWAY			HOLDER	GROUND WIRE TO A METALLIC COVER	NONMETALLIC COVER, PROVIDE ORDINATION OF A COVER OR ATTACH			RULES	IN LINE SINGLE POLE FUSE ASSEMBLY.		DES		LUMINAIRES SHALL BE #12 AWG, COPPER STRANDED, U.S.E. RATED, XLP INSULATED. SINGLE
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	EC SHALL PROVIDE 22'-0", 4-INCH SQUARE STEE EC SHALL PROVIDE CONCRETE BASES. SEE DE'	IGHTING FIXTURE SCHEDULE NO		320W PSMH	320W PSMH	320W PSMH	320W PSMH	F54T5HO	TYPE	1TA		ABBREVIATIONS:	NOTE: SEE SPECIFICATIONS REFERENCED BY THE COLUN ACCEPTABLE MANUFACTURI
	ICH SQUA E BASES.	HEDU		PARI	PARI	PARI	EXT	EXTE				ATIONS:	E SPECIFIC ED BY THI
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			NOTE: SEE SP REFERENCED ACCEPTABLE N	NOTE: SEE SPECIFICATIONS SECTIONS FOR ADDITIONAL INFORMATION REGARDING LIGHTING FIXTURE AND INSTALLATION REQUIREMENTS. PROVIDE OPTIONS AND ACCESSORIES REFERENCED BY THE COLUMN TITLED "OPTIONS/ACCESSORIES". MANUFACTURERS LISTED AS ACCEPTABLE SHALL MEET ALL REQUIREMENTS AND FEATURES INDICATED. ACCEPTABLE MANUFACTURERS MUST MEET THE PHOTOMETRIC PERFORMANCE OF THE LISTED UNIT.	ON REGARDING LIGHTING FIXTURE A NUFACTURERS LISTED AS ACCEPTAE FORMANCE OF THE LISTED UNIT.	ND INSTALLATION REQUIREMI 3LE SHALL MEET ALL REQUIRE	ENTS. PROVIDE	E OPTIONS AND) ACCESSORII CATED.	S			
			ABBREVIATIONS:)NS: DW = DRY WALL ES = EXPOSED STRUCTURE LG = LAY-IN GRID	P = PENDANT R PL = PLASTER S PO = POLE W	= RECESS = SURFACE - WALL MOUNTED	V = VARIES						
	7		LAMP DATA	ַחַרְיִּרְיִנְיִינְיִינְיִינְיִינְיִינְיִינְיִינ	LIGHTING FIXTURE	TIXTURE	10		CEILING	FIXTURE			755 NOT
BLY.	טבט	#	TYPE	CEOCAITICA	MANUFACTURER	CATALOF SERIES	۷٥۲	MICON	TYPE	DEPTH	OF HONS/ ACCESSORIES	ACCET LABLE MANOFAC LORERO	SEE NOTE
	OA	_	F54T5HO	EXTERIOR WALL FLUORESCENT FIXTURE	LUMINAIRE LIGHTING	AEL48-CL-BKH-EMB	277	W	1		-	LITHONIA, DAYBRITE, LSI	×
	ОВ	1	320W PSMH	EXTERIOR FLOOD	COOPER	AMF-F-76-BK	277	W	•	•	-	LITHONIA, DAYBRITE, LSI	×
	00	1	320W PSMH	PARKING LOT - 22FT POLE - TYPE III	COOPER	CLM-3F-FG-BK	277	PO	•	•	22FT POLE COOPER 'SSS' SERIES	LITHONIA, DAYBRITE, LSI	×
	OD	_	320W PSMH	PARKING LOT - 22FT POLE - TYPE IV WITH SHIELD	COOPER	CLM-4F-FG-BK	277	PO	•		22FT POLE COOPER 'SSS' SERIES	LITHONIA, DAYBRITE, LSI	×
Ţ	유	_	320W PSMH	PARKING LOT - 22FT POLE - TYPE IV	COOPER	CLM-4F-FG-BK-HS	277	PO			22FT POLE COOPER 'SSS' SERIES	LITHONIA, DAYBRITE, LSI	×
	1. LIGH	TING EC SHAL	LIGHTING FIXTURE SCHEDULE NOTES: 1. EC SHALL PROVIDE 22'-0", 4-INCH SQUARE STEEL POLE. 2. EC SHALL PROVIDE CONCRETE BASES. SEE DETAIL 3/E100.	EDULE NOTES: SQUARE STEEL POLE. ASES. SEE DETAIL 3/E100.									

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SITE LIGHTING FIXTURE SCHEDULE

0B-15r4 POLE #9
OD-21r7 (e)

30" MINIMUM

FIXTURE TYPE "OC", "OD", & "OF" POLE BASE DETAIL

		SITE ELECTRICAL PLAN 1"=40'-0" 0 20' 40'
5 EC TO PROVIDE ELE HAZARDOUS MATER SEE SPECIAL OUTLE REQUIREMENTS. EC REQUIREMENTS WIT 6 ROUTE CONDUITS T ELECTRICAL ROOM. 7 EC TO PROVIDE (3) 1 1" CONDUIT.	SHEET NOTES: 1 MADISON GAS AND TRANSFORMER. EC PAD. 2 EC TO PROVIDE 160 TRANSOCKET WITH BELOW FINISH GRAI UTILITY TRANSFORM COORDINATE ALL RELECTRIC UTILITY. 4 EC TO COORDINATE ALL RELECTRIC UTILITY.	

) EC TO PROVIDE 1600A,480V, 3-PHASE, 4-TRANSOCKET WITH METER SOCKET.

MADISON GAS AND ELECTRIC COMPANY UTILITY TRANSFORMER. EC TO PROVIDE CONCRETE PAD.

EC TO PROVIDE (4) 4" CONDUIT STUBS 36"
BELOW FINISH GRADE TO TRANSOCKET AND
UTILITY TRANSFORMER FROM BUILDING. EC TO
COORDINATE ALL REQUIREMENTS WITH
ELECTRIC UTILITY.

CONDUIT SIZE AND QUAN AS INDICATED ON PLAN

6"

1'-0"

CONDUIT TRENCH DETAIL

AND FILL BED ——OR CONDUITS

30" MIN

DANE COUNTY
WASTE TRANSFER STATION
AND HOUSEHOLD HAZARDOUS
WASTE FACILITY
RODEFELD LANDFILL PROJECT TITLE: (o)

DATE: PROJECT NUMBER: 2009-0328.00 PROJECT INFORMATION: 01-12-2010

SCALE: DRAWN BY: CHECKED BY: APPROVED BY: AS NOTED 폿 AAS TKA

SITE ELECTRICAL PLAN, LIGHTING FIXTURE SCHEDULE, AND DETAILS

SHEET TITLE:

EC TO PROVIDE (2) #8 AWG, AND (1) #10 GRD IN 1" CONDUIT.

EC TO PROVIDE (2) #10 AWG, 1" CONDUIT.

AND (1) #10 GRD IN

EC TO PROVIDE (3) #10 AWG, AND (1) #10 GRD IN 1" CONDUIT.

ROUTE CONDUITS TO UNDE ELECTRICAL ROOM.

SITE L	SITE LIGHTING CALCULATION SUMMARY	CULATIC	NUS N	MARY			
LABEL	CALC TYPE	SLINN	AVG	MAX	MIN	AVG/MIN	NIW/XYW
SITE LIGHTING	ILLUMINANCE	FC	0.98	3.8	0.1	9.80	38.00

0.0 0.0 0.0 0.1 0.1 0.0 0.0 0.0 0.0 0.0 0.0 0.0 0.0 0.1 0.1 0.0 0.1 0.0 0.1 0.1 0.2 0.0 0.3 0.4 0.0 0.5 0.6 0.0 0.0 1.0 1.1 1
0.0 0.1 1.0 1.1 1
0.0 1.5 1.8 1.8 1.2 2.6 0.1 0.2 0.3 0.4 0.9 1.9 1.5 0.9 0.7 0.7 0.1 0.1 0.2 0.3 0.3 0.3 0.3 0.3 0.3 3.2 2.0 1.4 1.4 1.0 0.7 0.7 0.1 0.1 0.1 0.1 0.6 1.2 1.4 1.4 0.7 0.7 0.2 0.3 0.3 0.1 0.1 0.0 0.00 0.1 0.1 0.0 0.0 0.0

DANE COUNTY
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PROJECT TITLE:





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0.00

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CONSULTANTS:

SCALE: DATE: SITE PHOTOMETRIC PLAN DRAWN BY: PROJECT NUMBER: 2009-0328.00 CHECKED BY: APPROVED BY: 돗 AAS TKA 01-12-2010 AS NOTED SHEET TITLE:

PROJECT INFORMATION: