LANDMARKS OMMI ON AP LICATION

Complete all sections of this application, making sure to note the requirements on the accompanying checklist (reverse).

If you need an interpreter, translator, materials in alternate formats or other accommodations to access these forms, please call (608) 266-4635

City of Madison Planning Division 215 Martin Luther King Jr Blvd, Ste 017 PO Box 2985 Madison, WI 53701-2985 (608) 266-4635



1. LOCATION				
Project Address: 826 Will	iamson Street		Alde	r District:6
2. PROJE T				
Project Title/Description:	Struck & Irwin Site Redevelo	opment		
This is an application for: (ch	neck all that apply)		Legis	tor #•
☑ New Construction/Alte or Designated Landmar	ration/Addition in a Local Histik (specify):	toric District	Legis	.αι π.
☐ Mansion Hill	▼ Third Lake Ridge	☐ First Settlement		DATE STAMP
☐ University Heights	☐ Marquette Bungalows	☐ Landmark	D	GUGUWISM
□ Land Division/Combina or to Designated Landn□ Mansion Hill□ University Heights□ Demolition	tion in a Local Historic District nark Site (specify): □ Third Lake Ridge □ Marquette Bungalows	t □ First Settlement □ Landmark	DPCED USE ONLY	1/13/23 10:44 am
☐ Development adjacent	to a Designated Landmark			
☐ Variance from the Histo	oric Preservation Ordinance (hapter 41)		
	Rescission or Historic District storic Preservation Planner for sp			
☐ Informational Presenta	tion			
☐ Other (specify):				
3. <u>APPLI ANT</u>				
Applicant's Name: Kevin E	Burow	Company: Knot	he & Bruce Ard	chitects
Address: 7601 University	Ave, Ste 201	Middleto	on, WI 53562	
Telephone: 608-836-3690		Email: kburow@kr	city nothebruce.con	State Zip
Property Owner (if not applied	cant): Mark Herrling			
Address: 421 Bryce Cany		Mac	lison, WI 5370	
Property Owner's Signature	Street: Mark Herrling		City Date:I/	State Zip 16/2022

NOTICE REGARDING LOBBYING ORDINANCE: If you are seeking approval of a development that has over 40,000 square feet of non-residential space, or a residential development of over 10 dwelling units, or if you are seeking assistance from the City with a value of \$10,000 (including grants, loans, TIF or similar assistance), then you likely are subject to Madison's lobbying ordinance (Sec. 2.40, MGO). You are required to register and report your lobbying. Please consult the City Clerk's Office for more information. Failure to comply with the lobbying ordinance may result in fines.

4. <u>APPLI ATION SUBMI SION REQUIREMENT</u> (see checklist on reverse)

All applications must be filed by 12:00pm on the submission date with the Preservation Planner. Applications submitted after the submission date *or* incomplete applications will be postponed to the next scheduled filing time. Submission deadlines can be viewed here: https://www.cityofmadison.com/dpced/planning/documents/LC Meeting Schedule Dates.pdf

January 26, 2023



Heather Bailey, Ph.D.
Preservation Planner
Department of Planning & Community & Economic Development
Madison Municipal Building, Suite 017
215 Martin Luther King Jr. Boulevard
Madison, Wisconsin 53703

Re: Letter of Intent 826 Williamson Street – Letter of Intent KBA Project #2241

Heather Bailey,

The following is submitted together with the plans and application for the Landmarks Commission's review and consideration:

This proposed development involves the redevelopment of 826 Williamson Street, which is located within the Third Lake Ridge historic district, by removing an existing one-story commercial building and surface parking lot and constructing a new three to four-story mixed use building. There will be a total of approximately 45 apartment units (subject to final unit size mix) and approximately 3,500 sq.ft. of commercial space. There will also be 50 underground parking stalls for residential use.

In designing the building at 826 Williamson Street (the old Struck & Irwin Site) we have incorporated a number of details to make it compatible with the historic nature of the Third Lake Historic District.

Frontage:

The overall frontage of the building is approximately 135' long, with an adjacent open area of approximately 50' that serves as parking for the commercial portion of the project as well as access for Fire Department equipment. While the building frontage is 135' overall, it is broken down into 3 principal sections to present smaller scale facades. The "commercial" portion of the building is 52' wide and is further delineated into smaller sections of 26' with the use of pilasters, separated storefronts and other brick details. Each of the 26' wide sections contain 3 bays of windows above a single entrance storefront. The storefront at the corner of the building facing the parking lot is designed as a corner entrance similar to typical corner storefronts along Williamson Street such as at 1146, 1150, 1201 and 1255 Williamson Street. The remaining storefronts are recessed centered storefronts similar to the building across the street at 831 Williamson Street as well as number of other storefronts further east on Williamson. The commercial section of the building is a lighter brick color, with cast stone trim and metal panels within the window bays.

The center part of the building is 12' wide and serves as a visual break between the commercial storefront area and the more private residences on the east portion of the building. This 12' section (the "Hypen") functions as the primary entrance to the residences in the building is 8' further back from the front edge of the commercial section and 4' back from the residential section. This small area uses a gray brick to differentiate it from the other two parts while still using historically appropriate materials commonly found in the district, particularly on Williamson Street.

The eastern portion of the building is approximately 70' wide overall. A central pilaster helps to reduce the visual scale into two separate 35' sections that appear to share a common wall. Each of the 35' sections is further delineated into 3 smaller window bays. To reinforce the more residential character we have taken inspiration from the oriels on the building at 1201 Williamson Street (Weary Traveler) as well as similar bay windows on 1234, 1236 and 1354 Williamson St. Like the other two sections of the façade on Williamson Street this portion is also done in masonry with brick detailing at the corners, windows and parapet.

Within the 200' range there are 2 other existing buildings with frontages of at least 50' – specifically the brick building located at 853 Williamson Street (which does not have details to reduce the overall length other than the first floor storefronts) and 841-843 Williamson Street which is a duplex home. That is designed to appear as two houses above the first floor.

Height:

The overall height of the building is 3 stories at Williamson Street, stepping up to 4 stories 30' back from the property line in accordance with the Williamson Street Build II recommendation (page 32). Several buildings to the west of the 800 block rise to 4 stories (the Olds Building and 744 Williamson) while at least two other buildings to the east on Williamson Street are 3 story brick structures (1019 and 1216 Williamson). Looking more broadly there are a number of 3 story apartment houses in the neighborhood in brick, wood and plaster located on the side streets (1036 Williamson Street, 1022, 1027, 1134, 1140 Jenifer St and 1036 and 1040 Spaight Street) as well as an historic 3 story brick apartment building located at 600 S. Brearly (which also has recessed bay windows framed in wood).

Parts (Windows, doors, entrances):

Windows in the building are double hung style windows with equal top and bottom sashes, consistent with nearly all the windows in the Third Lake Historic District. The size of the windows is typically 3' wide by 6' tall – also typical of numerous buildings in the neighborhood. The windows on the 4th floor of the commercial section are slightly shorter at 5' tall – to differentiate the attic floor from the middle section of the building (similar to the fenestration on the Olds building on the 700 block).

Windows in the commercial section are ganged into groups of 2, as well as in the "hyphen" section (in the same manner as parts of 301 S. Blount, 744 Williamson St, and 1201 Williamson among others. The residential half has windows ganged into groups of 3 similar to the Blount Street façade of 301 S. Blount Street. The oriel windows in the residential section are similar to windows located at 1201 Williamson Street (Weary Traveler) as well as 1354, 1234 and 1236 Williamson Street.

In the center bays of each residential section (under the oriels) are walk-up stoops in the style of numerous residential properties along Williamson Street (and of course on the side streets in the district as well).

The underground parking for this project is accessed from the adjacent property at 302 S. Paterson St (which is not a part of the historic district). The garage doors that access the parking under both this building as well as the Paterson Street building are located at the end of a sloping driveway aprox. 12' below grade. Neither garage door faces the street, but is oriented perpendicular to the street. Nevertheless we have included a spec sheet for the doors.

Building Systems:

No rooftop systems will be visible from the street at any point. There are no solar panels currently planned for the rooftop and if added, will be setback far enough from the edge to not be visible either.

All vents in the masonry will be painted to match and be flush with the masonry.

Exterior lighting on the building will be minimal, with recessed downlights located in the entry canopy to the main entrance and period appropriate fixtures adjacent to the doors of the walk up stoops (req"d by code). No fixtures have been selected at this point but we are of course happy to review final selections with Landmarks staff to receive approval of any fixtures.

Lighting at the commercial storefronts will be from gooseneck style lights consistent with the fixtures located at (811, 1020, 1201, 1370 Williamson Street).

The structure to be removed was constructed outside of the period of significance for the Third Lake Ridge historic district (1850-1929) and has no historic significance to this area. It is also out of character and is not a landmark structure, nor is it of an uncommon or unusual design or method of construction, and as such should meet the demolition criteria.

As part of this project the underlying land (3 lots facing Williamson Street) that the existing and the proposed building will sit on needs to be combined into one lot. This land combination has already been reviewed and approved by the Landmarks Commission and a certificate of appropriateness was approved on 6/6/2022.

We appreciate the feedback we received at the January 11 Landmarks Commission meeting and your email sent on 1/13/2023 have taken those comments into consideration when preparting this submittal. On the "commercial" portion of the building we widened the window bays to make them slightly less vertical. This is reflected on the elevations and renderings on both the Williamson St facade as well as the side facade.

We hope that you will find this an appropriate building that will fit in well in the Third Lake Ridge historic district. I look forward to discussing these with you at the upcoming Landmarks Commission meeting.


Thank you for your time reviewing our proposal.

Sincerely,

Kevin Burow, AIA, NCARB, LEED AP

Managing Member

Keni Bum

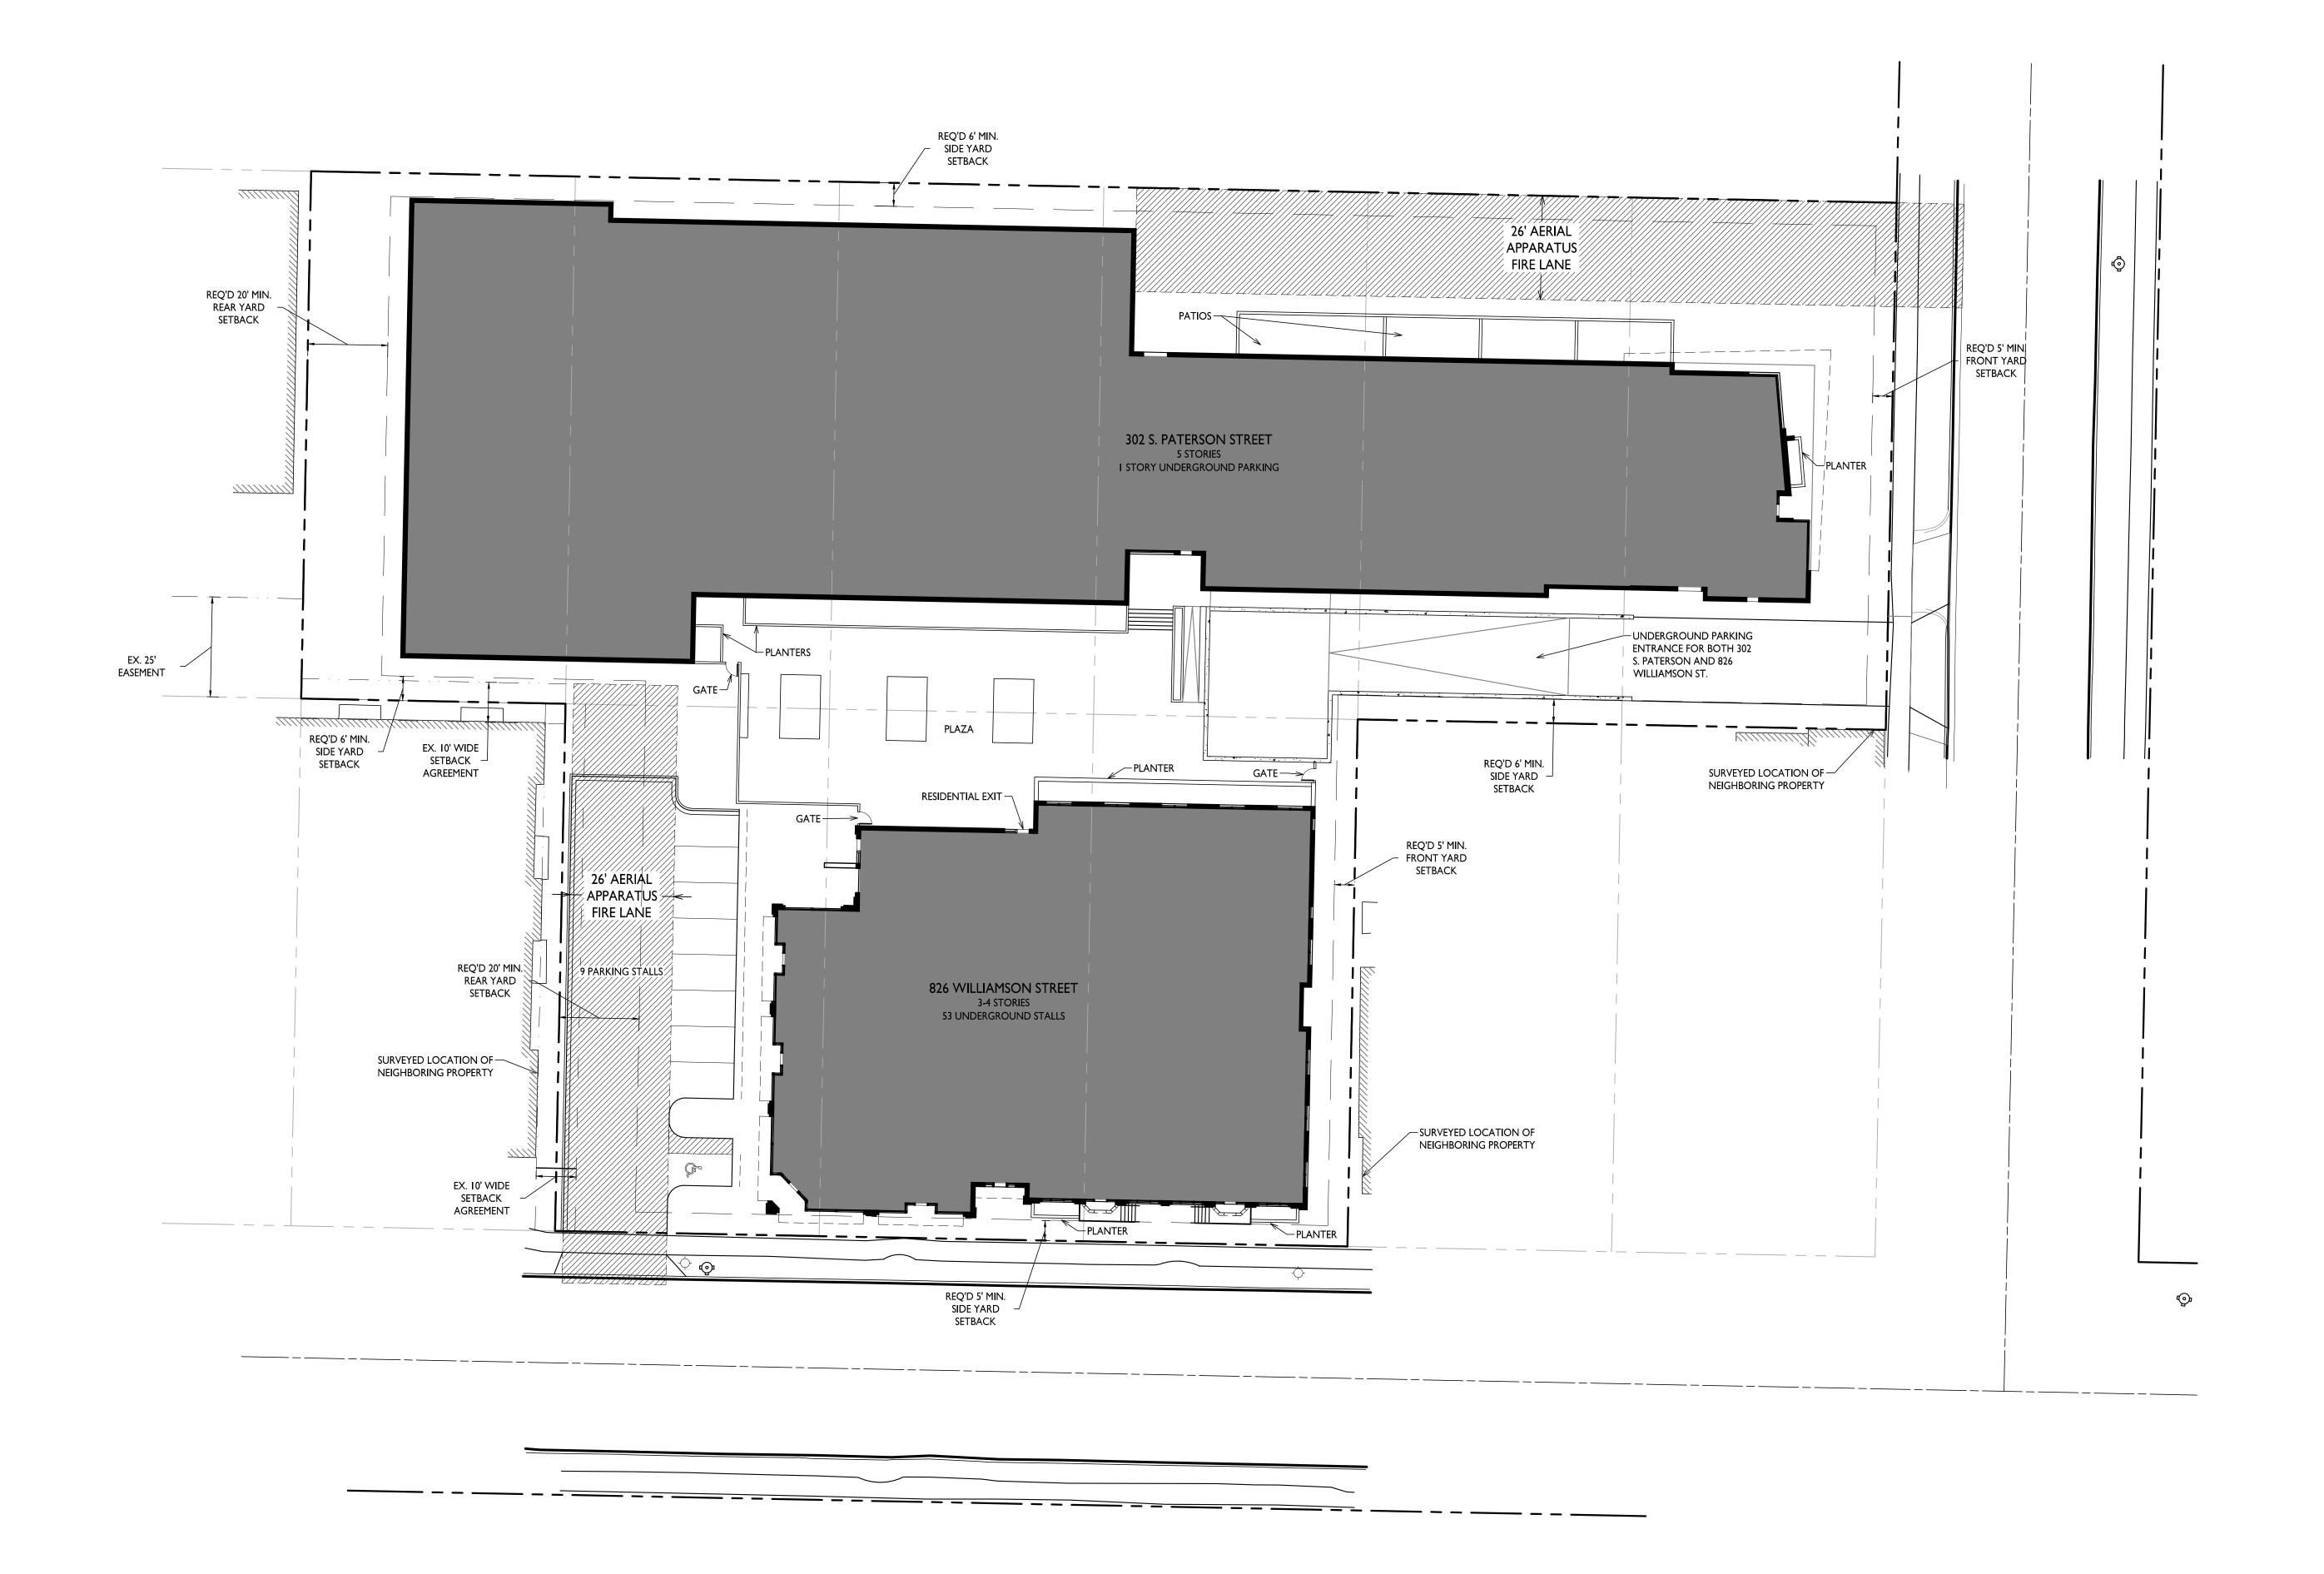



Issued for Landmarks Submittal - January 13, 2023

PROJECT TITLE Threshold Development
Struck and Irwin Site

826 Williamson Street & 302 S. Paterson Street SHEET TITLE Site Plan


SHEET NUMBER



© Knothe & Bruce Architects, LLC

PROJECT NO.

SITE PLAN

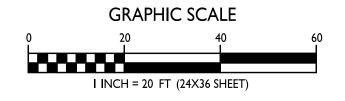



x201 1/8" = 1'-0"



1/8" = 1 '- 0"

EXTERIOR MATERIAL SCHEDULE BUILDING ELEMENT MANUFACTURER COLOR COMPOSITE LAP SIDING 6" JAMES HARDIE IRON GRAY JAMES HARDIE 2 COMPOSITE TRIM ARCTIC WHITE PEARL GRAY 3 COMPOSITE PANEL - SMOOTH JAMES HARDIE SILVER 4 METAL PANEL CMG 5 COMPOSITE PANEL JAMES HARDIE GREEN INTERSTATE BRICK CHIPPEWA 6.1 BRICK VENEER 6.2 BRICK VENEER INTERSTATE BRICK OCHRE BUFF 6.3 BRICK VENEER PLATINUM INTERSTATE BRICK 7.1 BRICK VENEER - SOLDIER 7.2 BRICK VENEER - ROWLOCK 7.3 BRICK VENEER - ANGLED 8 CAST STONE ROCKCAST CREME BUFF 10 COMPOSITE WINDOWS ANDERSEN BLACK 11 ALUMINIUM STOREFRONT BLACK BLACK SUPERIOR 12 RAILINGS & HANDRAILS 13 FABRIC AWNING



Threshold
Development
Struck & Irwin
Site

826 Williamson St.

Madison, WI


SHEET TITLE

EXTERIOR ELEVATIONS

SHEET NUMBER

X201
PROJECT NUMBER 2241

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ISSUED
January 26th, 2023

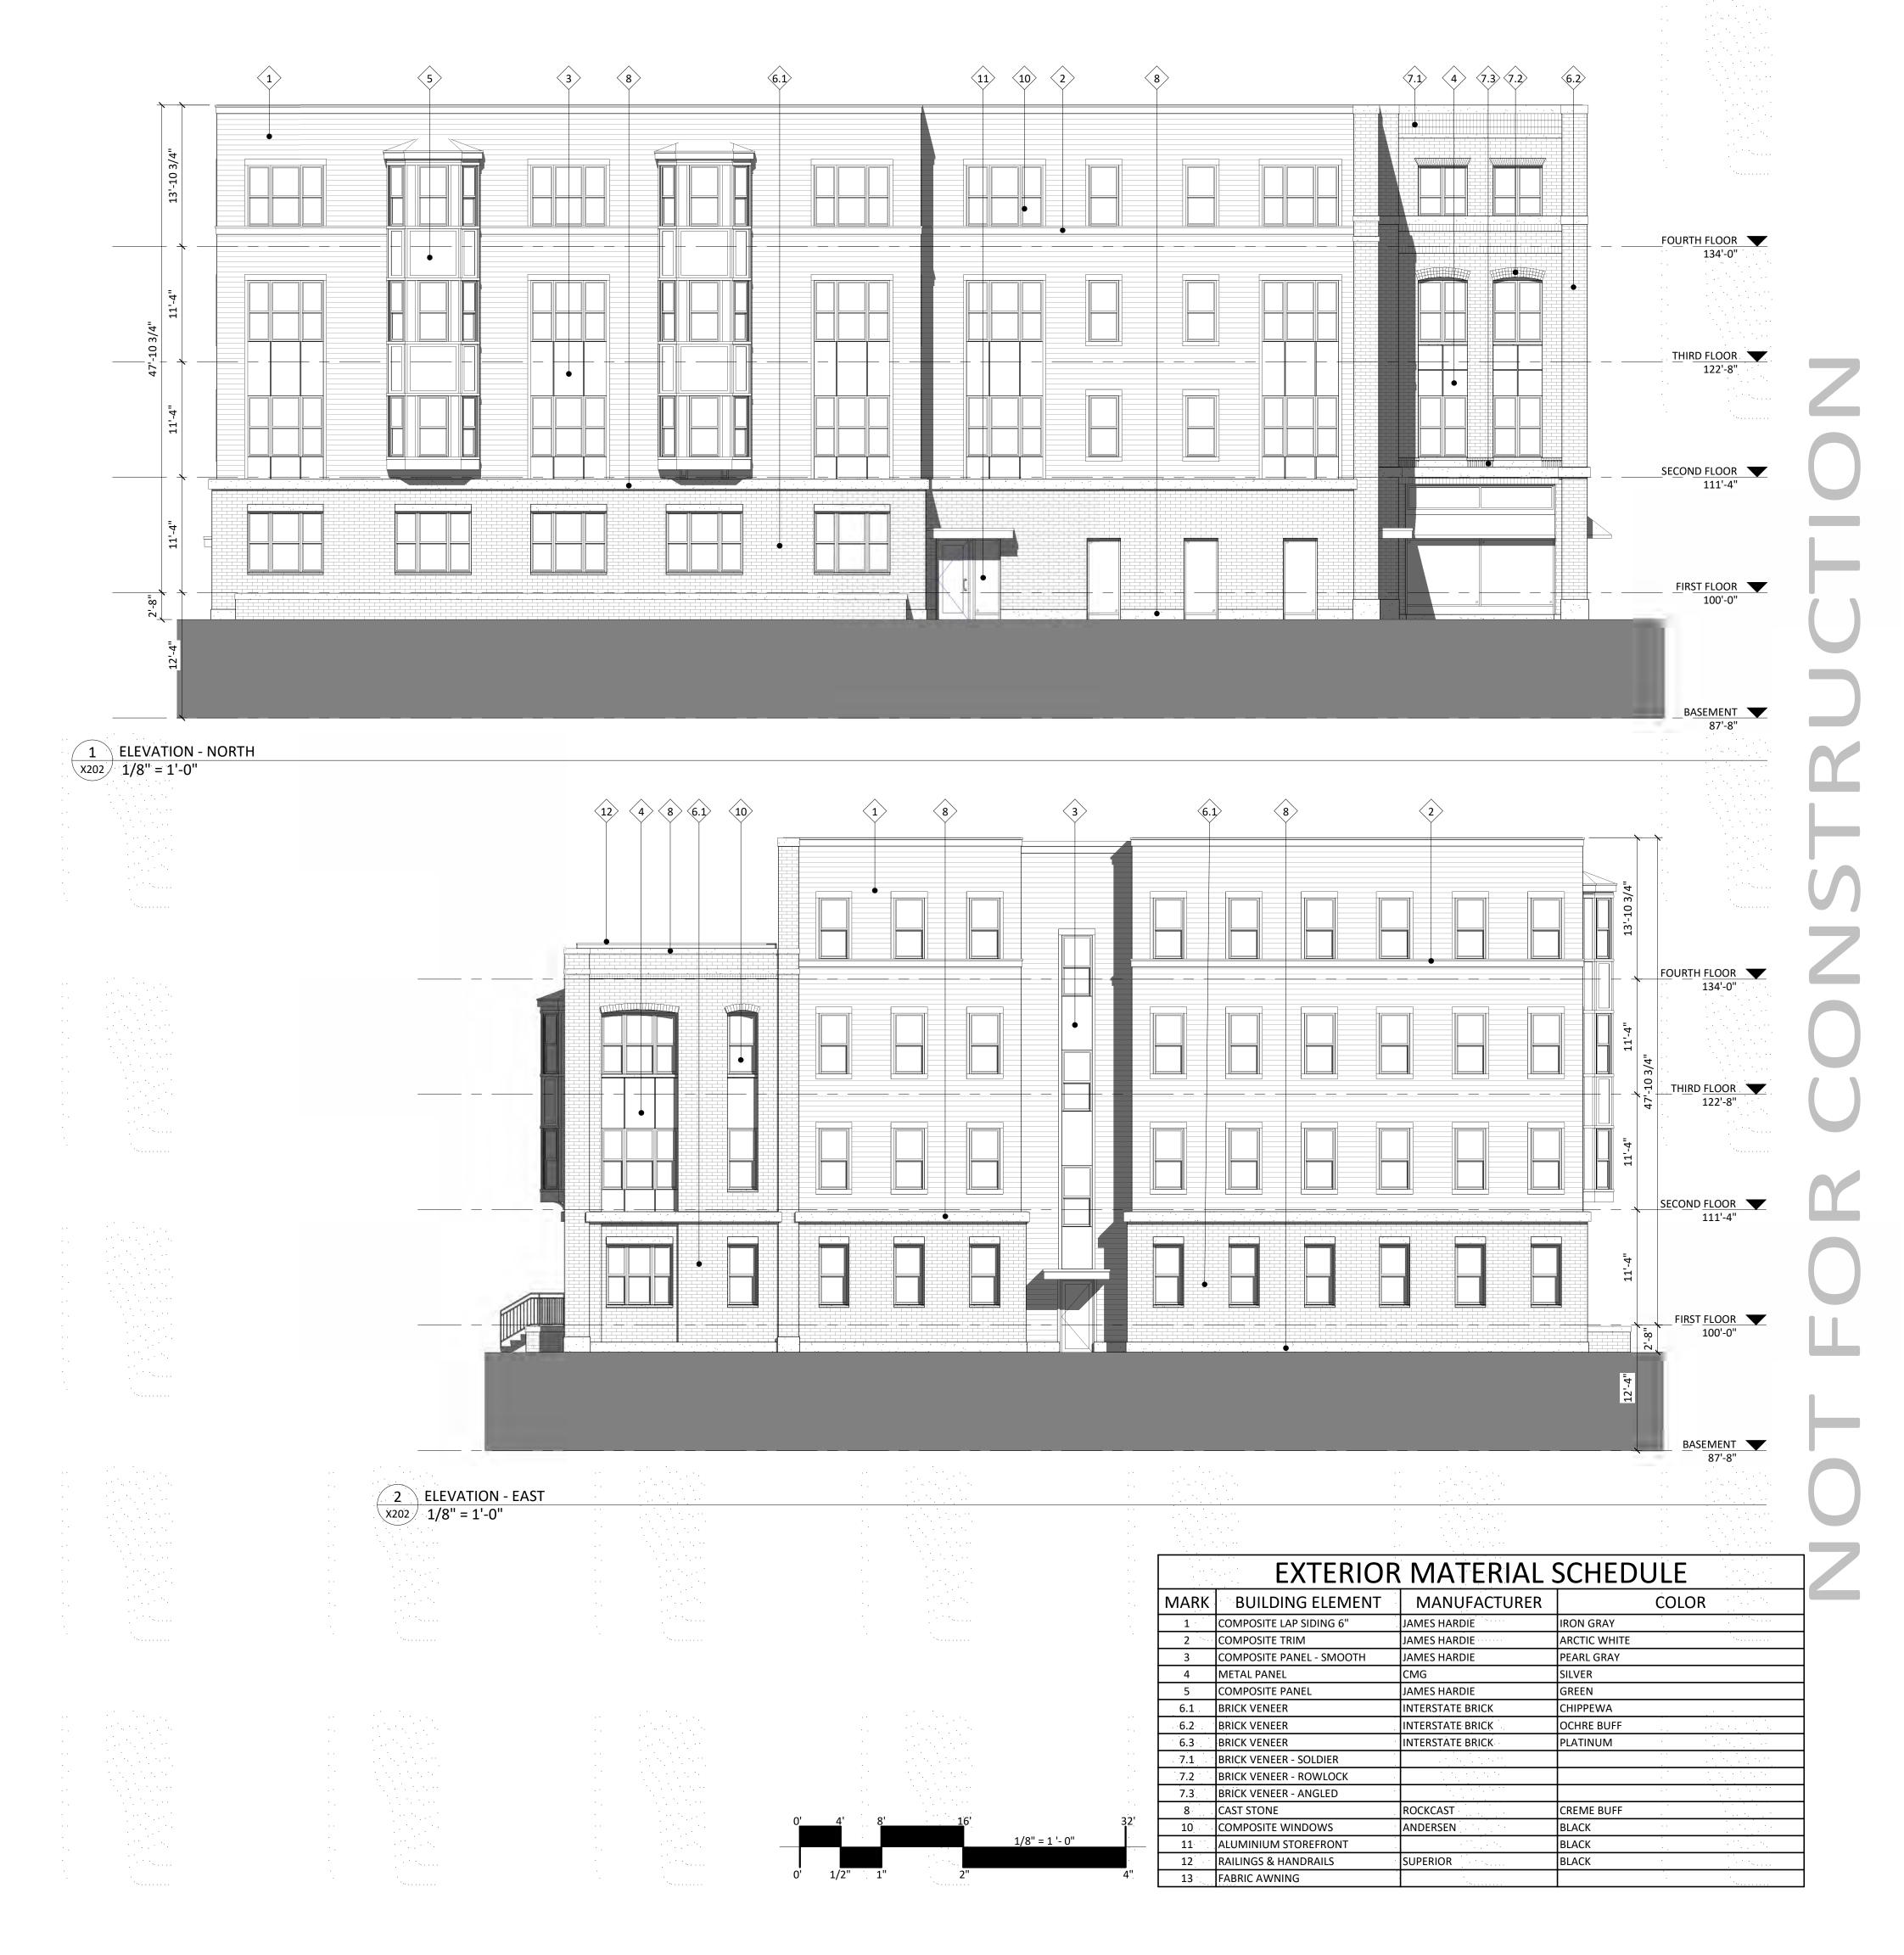Threshold
Development
Struck & Irwin
Site

826 Williamson St.

Madison, WI

SHEET TITLE

EXTERIOR ELEVATIONS


SHEET NUMBER

X202

PROJECT NUMBER 2241

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2 COLORED ELEVATION - WEST 1/8" = 1'-0"

MARK	BUILDING ELEMENT	MANUFACTURER		COLOR
1	COMPOSITE LAP SIDING 6"	JAMES HARDIE	IRON GRAY	
2	COMPOSITE TRIM	JAMES HARDIE	ARCTIC WHITE	· · · · · · · · · · · · · · · · · · ·
3	COMPOSITE PANEL - SMOOTH	JAMES HARDIE	PEARL GRAY	
4	METAL PANEL	CMG	SILVER	
5	COMPOSITE PANEL	JAMES HARDIE	GREEN	
6.1	BRICK VENEER	INTERSTATE BRICK	CHIPPEWA	
6.2	BRICK VENEER	INTERSTATE BRICK	OCHRE BUFF	
6.3	BRICK VENEER	INTERSTATE BRICK	PLATINUM	
7.1	BRICK VENEER - SOLDIER			
7.2	BRICK VENEER - ROWLOCK			
7.3	BRICK VENEER - ANGLED			
8	CAST STONE	ROCKCAST	CREME BUFF	
10	COMPOSITE WINDOWS	ANDERSEN	BLACK	
11	ALUMINIUM STOREFRONT		BLACK	
12	RAILINGS & HANDRAILS	SUPERIOR	BLACK	
13	FABRIC AWNING	· · · · · · · · · · · · · · · · · · ·		

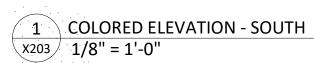EXTERIOR MATERIAL SCHEDULE



ISSUED
January 26th, 2023

Threshold
Development
Struck & Irwin
Site

826 Williamson St.

Madison, WI

SHEET TITLE

EXTERIOR ELEVATIONS COLORED

SHEET NUMBER

X203

© Knothe & Bruce Architects, LLC

4" 13 FABRIC AWNING PROJECT NUMBER 2241





2 COLORED ELEVATION - EAST X204 1/8" = 1'-0"

	EXTERIOR	MATERIAL	SCHED	JLE	
MARK	BUILDING ELEMENT	MANUFACTURER		COLOR	
1	COMPOSITE LAP SIDING 6"	JAMES HARDIE	IRON GRAY		
2	COMPOSITE TRIM	JAMES HARDIE	ARCTIC WHITE	,	
3	COMPOSITE PANEL - SMOOTH	JAMES HARDIE	PEARL GRAY		
4	METAL PANEL	CMG	SILVER		
5	COMPOSITE PANEL	JAMES HARDIE	GREEN		
6.1	BRICK VENEER	INTERSTATE BRICK	CHIPPEWA		
6.2	BRICK VENEER	INTERSTATE BRICK	OCHRE BUFF		
6.3	BRICK VENEER	INTERSTATE BRICK	PLATINUM		
7.1	BRICK VENEER - SOLDIER				
7.2	BRICK VENEER - ROWLOCK				
7.3	BRICK VENEER - ANGLED			. *	
8	CAST STONE	ROCKCAST	CREME BUFF		
10	COMPOSITE WINDOWS	ANDERSEN	BLACK		
11	ALUMINIUM STOREFRONT		BLACK	• .	
12	RAILINGS & HANDRAILS	SUPERIOR	BLACK		
13	FABRIC AWNING				



ISSUED January 26th, 2023

Threshold
Development
Struck & Irwin
Site

826 Williamson St.

Madison, WI

SHEET TITLE

EXTERIOR


EXTERIOR ELEVATIONS COLORED

SHEET NUMBER


X204

2273

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JAMES HARDIE ARCTIC WHITE

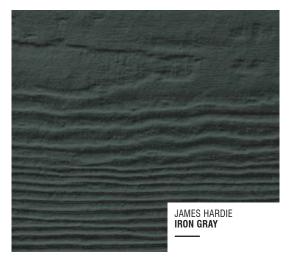


knothe • bruce

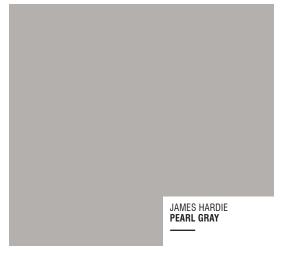COMPOSITE LAP SIDING 6"

COMPOSITE TRIM

COMPOSITE PANEL - SMOOTH

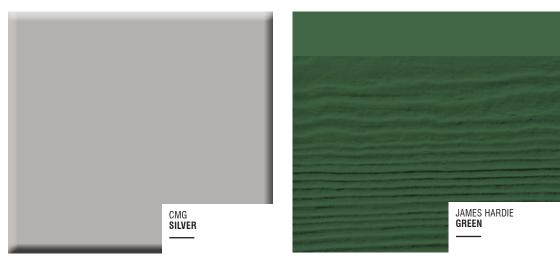




RAILINGS & WINDOWS


ROCKCAST
CREME BUFF| SMOOTH


METAL PANEL

COMPOSITE PANEL & TRIM

CAST STONE SILLS & BANDS

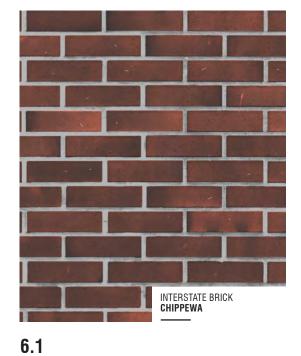

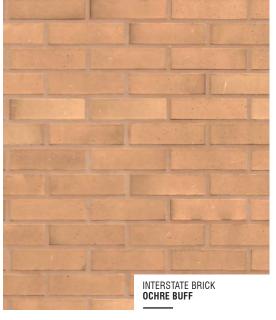

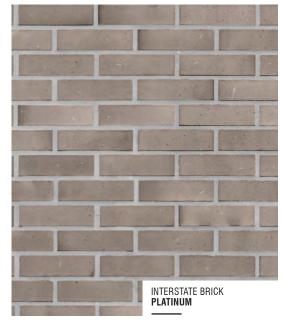

	EXTERIOR	MATERIAL	SCHEDULE	
MARK	BUILDING ELEMENT	MANUFACTURER	COLO	OR .
1	COMPOSITE LAP SIDING 6"	JAMES HARDIE	IRON GRAY	, * * * * * * * * * * * * * * * * * * *
2	COMPOSITE TRIM	JAMES HARDIE	ARCTIC WHITE	
3	COMPOSITE PANEL - SMOOTH	JAMES HARDIE	PEARL GRAY	
4	METAL PANEL	CMG	SILVER	
5	COMPOSITE PANEL	JAMES HARDIE	GREEN	
6.1	BRICK VENEER	INTERSTATE BRICK	CHIPPEWA	
6.2	BRICK VENEER	INTERSTATE BRICK	OCHRE BUFF	
6.3	BRICK VENEER	INTERSTATE BRICK	PLATINUM	
7.1	BRICK VENEER - SOLDIER			
7.2	BRICK VENEER - ROWLOCK	1.5,15,5		
7.3	BRICK VENEER - ANGLED			
8	CAST STONE	ROCKCAST	CREME BUFF	
10	COMPOSITE WINDOWS	ANDERSEN	BLACK	
11	ALUMINIUM STOREFRONT	4 May 2 May	BLACK	477, 144
12	RAILINGS & HANDRAILS	SUPERIOR	BLACK	i de la compania del compania del compania de la compania del la compania de la compania del la compania
13	FABRIC AWNING	1		

MATERIAL Board

Site


826 Williamson St. Madison, WI January 26, 2023 KBA PROJECT #2241

Threshold Development Struck & Irwin


6.2 6.3

BRICK



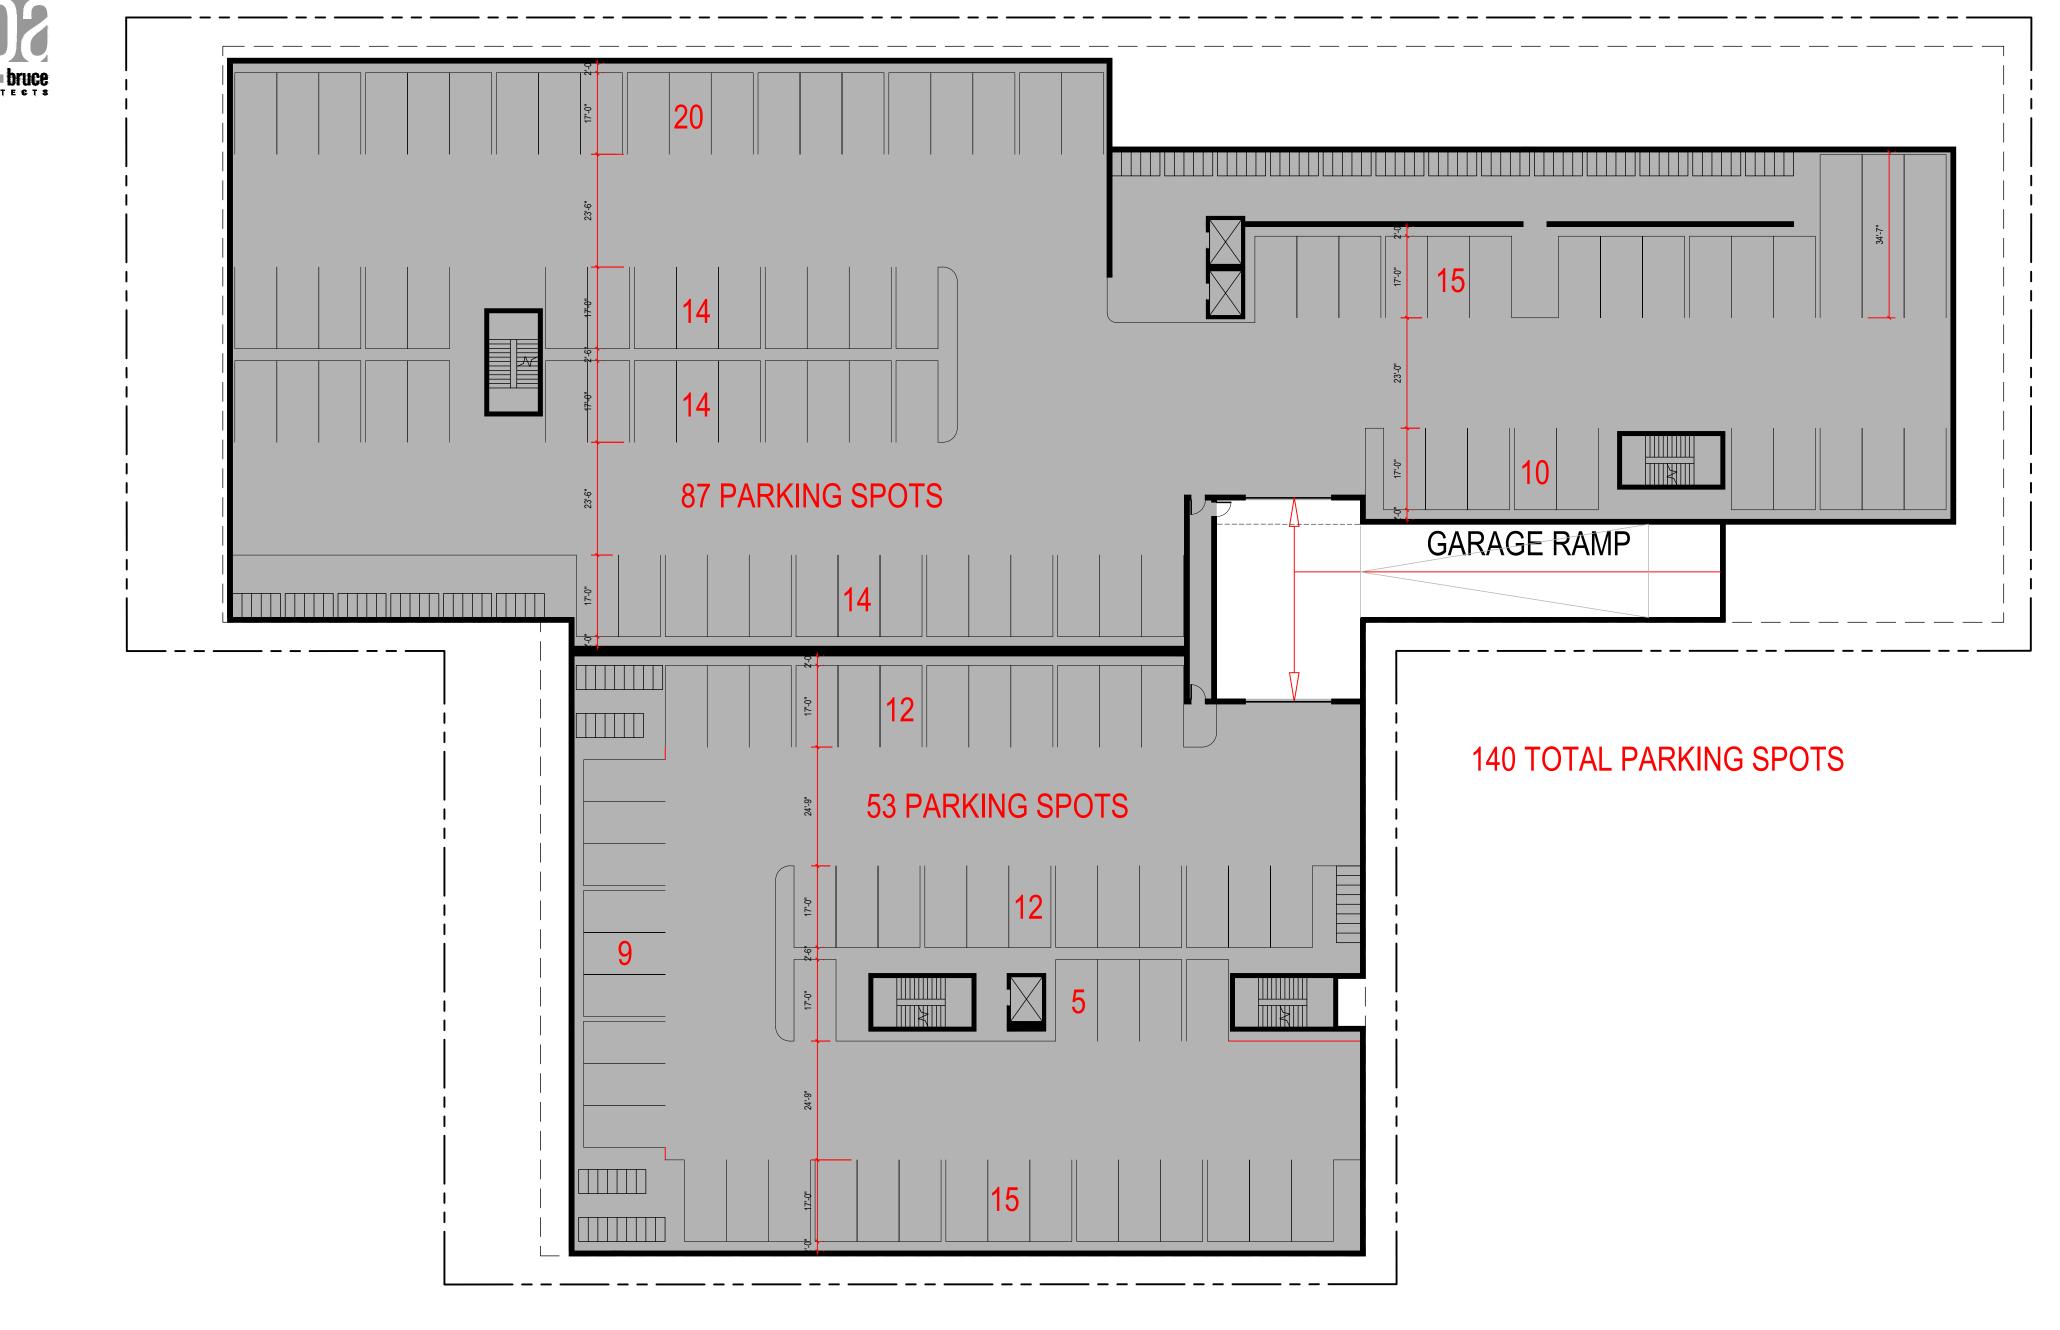



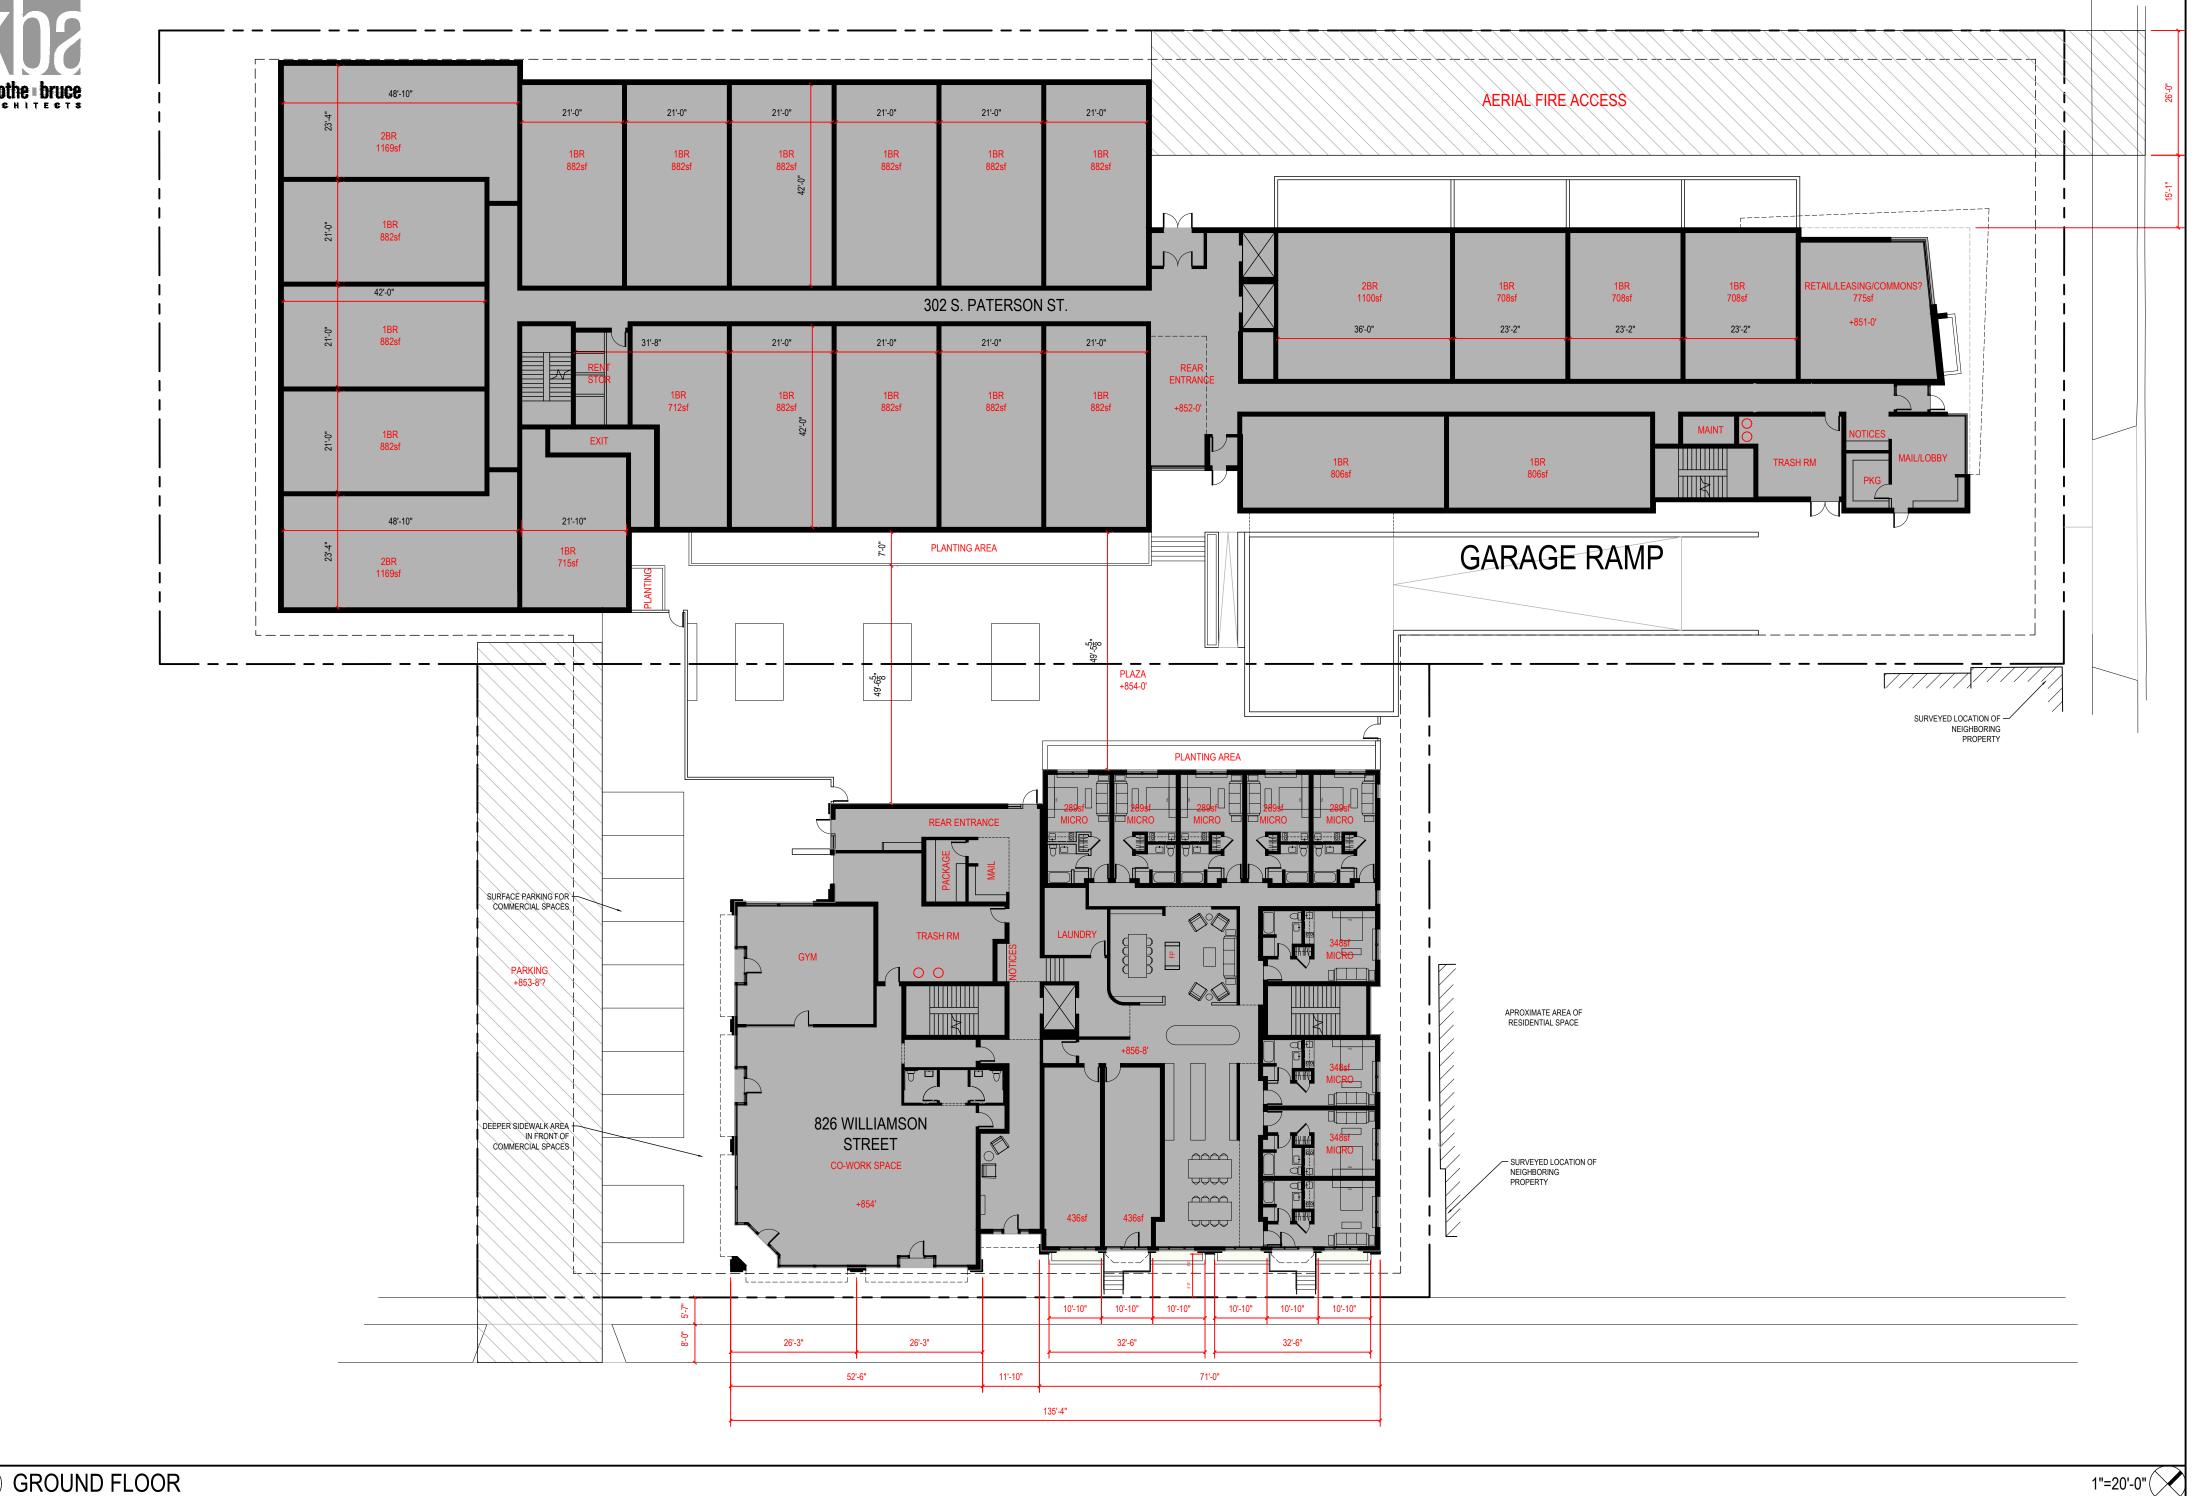






1) FLOORS 2-3

1"=20'-0"



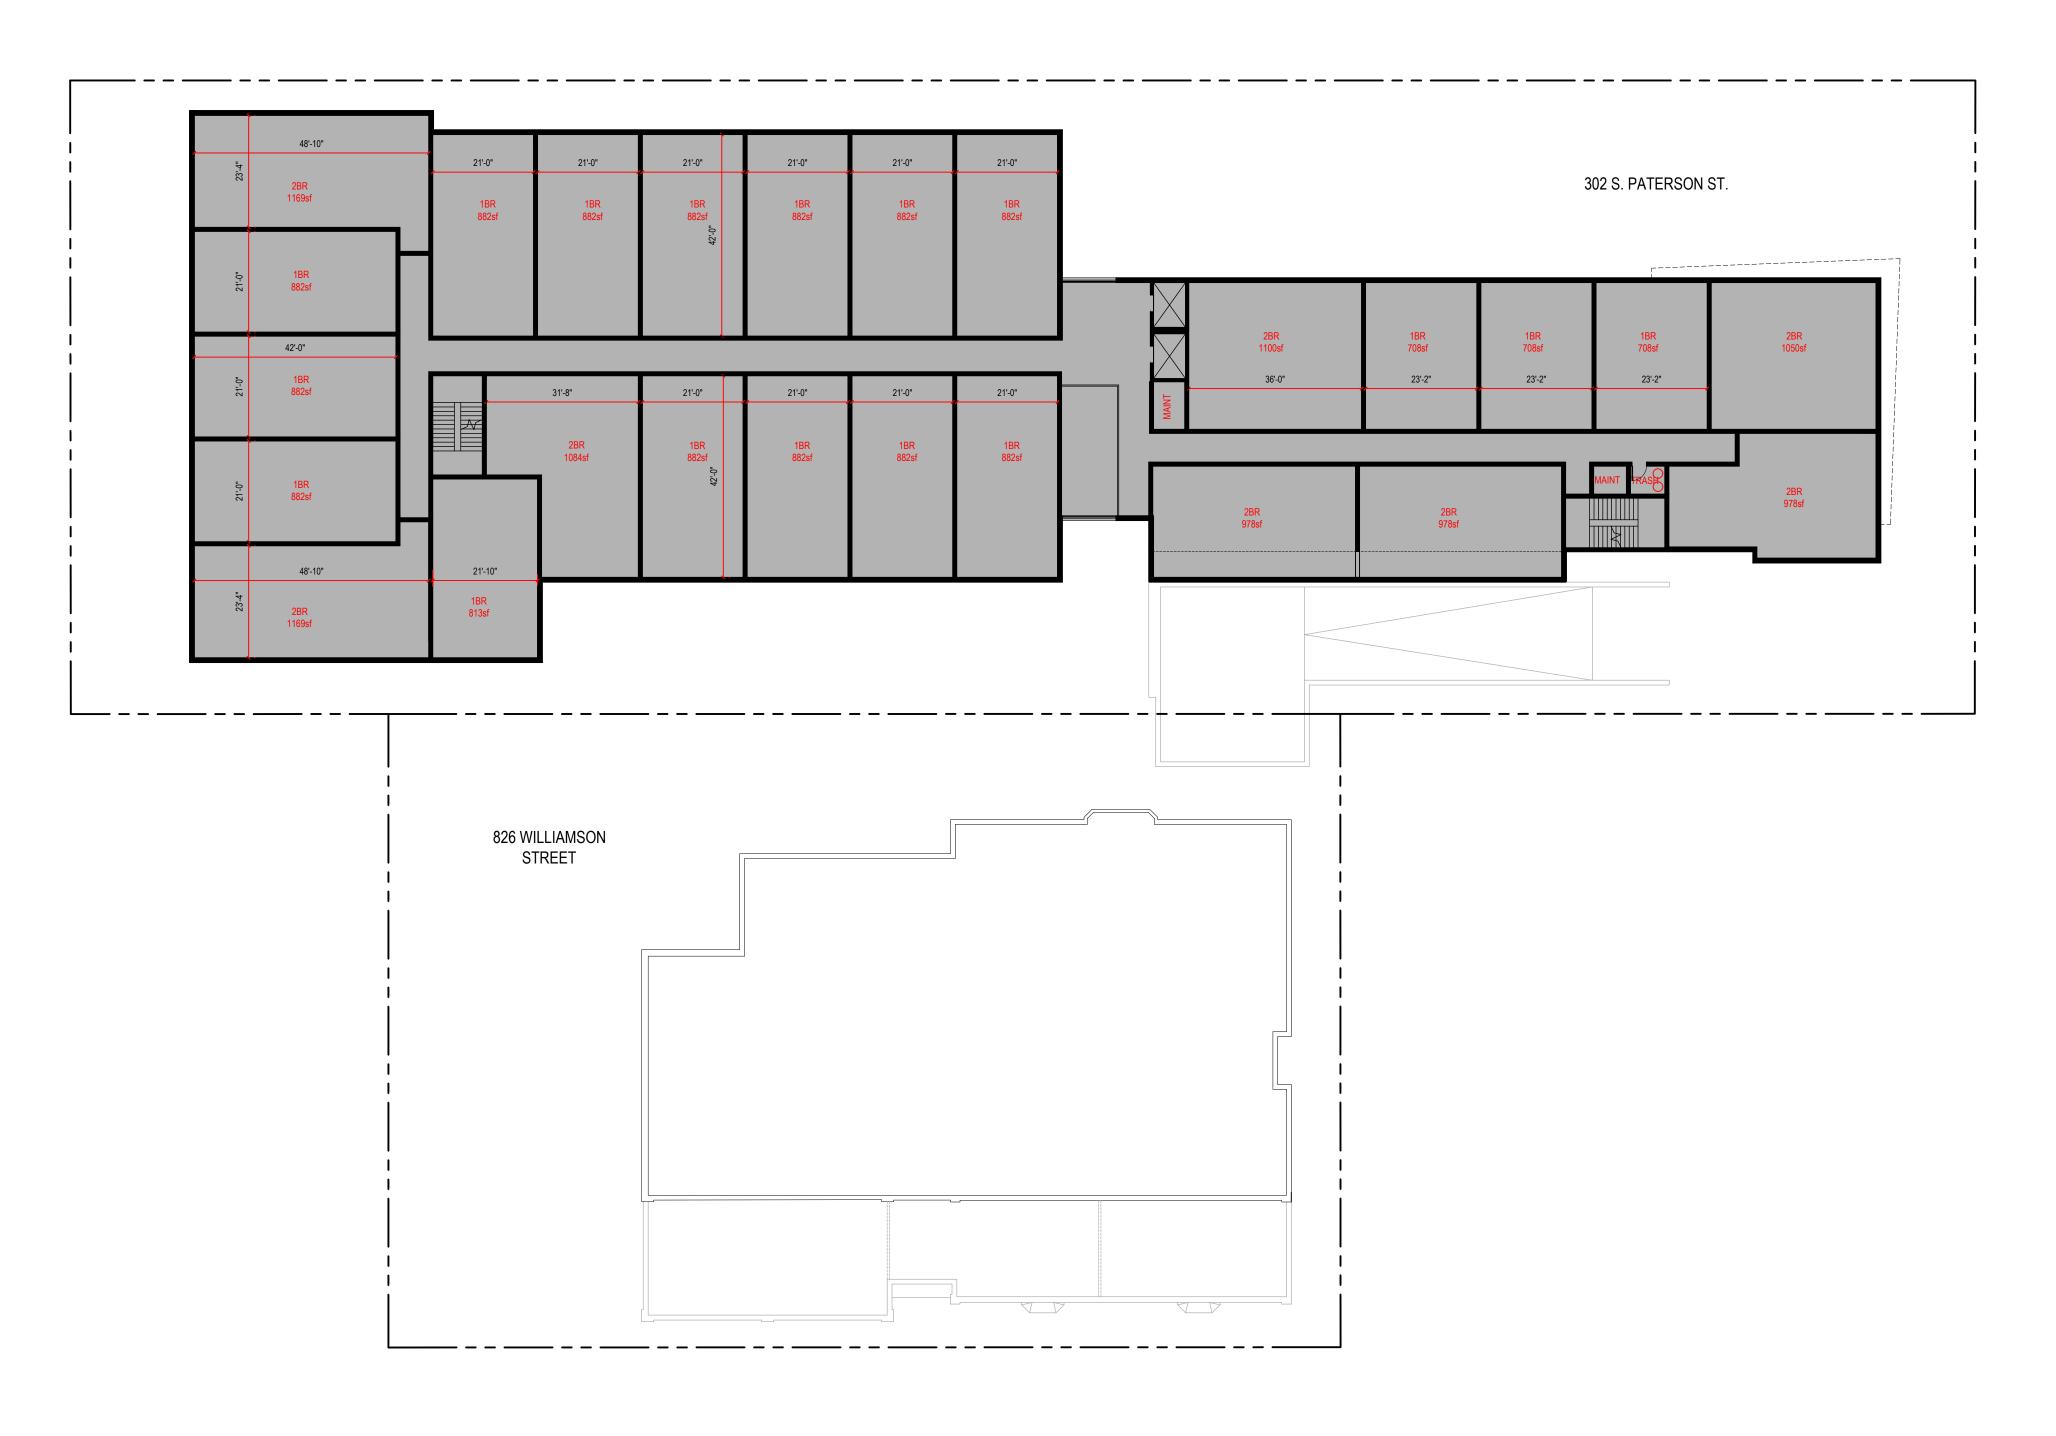



826 Williamson St. Madison, WI RENDER IMAGE 01





826 Williamson St. Madison, WI RENDER IMAGE 02





826 Williamson St. Madison, WI
RENDER IMAGE 03

X903



826 Williamson St. Madison, WI RENDER IMAGE 04 X904



826 Williamson St. Madison, WI RENDER IMAGE 05



826 Williamson St. Madison, WI RENDER IMAGE 06 X906



Customer Information —

Name: Address:

Phone 1: Phone 2:

Fax:



Quote

Page 1 of 1

Date: 11/3/2021

0	Ni	
Conore	Number:	

		T	
1	1		
	3	82" (R.O	82-7/8* (O.M. Exterior
		9	9 X

Contact:	
Joh Name:	

38-1/4" (R.O.)	6-5/8*
Exterior	-

U.D. = 37-1/2" x 81-5/8"; R.O. = 38-1/4" x 82"

O.M. of Exterior Trim = 40" x 82-7/8"

Image is viewed from Exterior!

Lead Time: Stock (Call to verify)

Specifications ———

Item Description	Qty
3' 0" x 6' 8" S4810-LE Smooth-Star Shaker-Style Fiberglass Door w/Low E Glass - Left Hand Inswing	1
2-3/4" Backset - Double Bore (2-1/8" Dia. Bore w/Standard 5-1/2" Spacing) w/Deadbolt Deadbolt 1 (Schlage) 1-1/8" x 2-3/4" x 3/16" depth Strike Prep	1
Set of Ball Bearing - Black Nickel Hinges	1
Primed DuraFrame Wood Frame - 6-5/8" Jamb w/Brickmould Exterior Trim (Applied) w/(1)Oil Rubbed Bronze Adjustable Security Strike Plate (for Lockset only)	1

Version #: 3.40

Version Date: 11/1/2021



CHOOSE YOUR OPTIONS

INSULATION	3-Inch ThermoGuard™	2-1	nch ThermoGuard™
Foam/Insulate	Polyurethane		Polyurethane
R-Value	26.0		18.0
U-Factor (Btu/hr/ft2/F)	0.114		0.136
Thickness	3 inches		2 inches
Maximum Width	40 ft. 2 ln.		32 ft. 2 in.
Exterior Steel	27 gauge 20 gauge upgrade, white only		27 gauge
Interior Steel	27 gauge		27 gauge
Warranty* Excludes Springs	10 years		10 years

^{*}For full warranty details contact your Midland dealer



The same of the sa

WINDOWS







TRACK MOUNTING



Reverse Angle Mounted Track Continuous leg-in angle to attach to steel jambs



Angle Mounted Track

Continuous leg-out angle used on larger doors to attach to wood jambs

KNOTHE - VERIFY COLOR AT EACH LEVEL

COLORS











Tera-Bronze Green



Coffee





*ColorSelect™ uses Sherwin Williams Polane® Solar Reflective Polyurethane Enamel, providing a durable, heat-repelling coating.

GLASS















*Tempered only. All other glass is available in both tempered and untempered.


Doubl Dark

TRACK CONFIGURATIONS





Inclined Track
To follow pitchof
roof

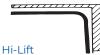

To put horizontal track as close to ceiling as possible

Vertical Lift
Full vertical
rise where
headroom is
available





MODEL 2" THERMOGUARD™

ARCHITECTURAL SPECIFICATIONS



2-INCH THERMOGUARD HIGHLIGHTS

DOOR TYPE: POLYURETHANE INSULATED

PANEL THICKNESS: 2.0 INCH

R-VALUE: R18

INSTALLED U-FACTOR: 0.14 BTU/HR-FT²-°F

U-Factor is tested per ANSI-DASMA 105. Installed U-Factor and calculated U-Value are NOT equivalent.

S	SECTION INFORMATION				
STEEL	STANDARDS	SPECIFICATIONS			
Thickness	ASTM A653	27 Ga.			
Embossing		Pebble Texture			
Hot Dipped Galvanized Coating	ASTM A924				
THERMAL BREAKS	TYPE	LOCATION			
Top/Bottom Extrusions	s PVC	Top/Bottom Of Sections			
Alcryn	Thermoplastic Elastomer	Bottom Of Sections			
End Stile Seals (Commercial Only)	Polypropylene	Face Side End Of Stiles			
STILES	MATERIAL	SPECIFICATIONS			
End Stiles	HDG Steel	16. Ga.			
Center Stiles	HDG Steel	20. Ga.			
FINISH	TYPE	SPECIFICATIONS			
Prime Coat	Urethane Primer	0.2 mil			
Top Coat	Baked On polyester	0.8 mil			

PERFORMANCE DATA				
FEATURE	STANDARDS	SPECIFICATIONS		
Wind Guard Package *OPTIONAL **Not available in for unusual requirements.		IBC 2015 Exposure B Building Category II		
Installed U-Factor U-Factor is tested per ANSI- and calculated U-Value are	DASMA 105. Installed U-Factor	0.14 BTU/HR-FT ² -°F		
R-Value	ASTM C236	R18		
AIR INFILTRATION	STANDARDS	COMPLIANCE		
15 mph	ANSI/DASMA 105 ASTM E283	0.05 cfm/ft ²		
25 mph	ANSI/DASMA 105 ASTM E283	0.13 cfm/ft ²		


OPERATION		
OPERATOR	TYPE	
Pull Rope	Standard Equipment	
Chain Hoist or Electric Operators	Optional	

As manufactured by Midland Garage Door Mfg. Co. Related structure work, opening preparation, field painting, electrical work falls to the responsibility of other trades. Garage doors should be installed in compliance with Midland Garage Door Mfg.Co. instructions by authorized Midland Garage Door installation professionals.

HARDWARE & COUNTERBALANCE		
HARDWARE	FEATURES	SPECIFICATIONS
Hinges	ASTM A123	G60
Rollers	Floating, Bearing	Nylon Steel
SPRING COUNTERBALANCE	STANDARDS	COMPLIANCE
Helical Wound Coil Springs	ASTM A229	10,000 Cycle Standard 25,000 Cycle Available 50,000 Cycle Available 100,000 Cycle Available
Lift Cables		Galvanized Aircraft Type
Cross Header Shaft	ANSI/DASMA 102	Designed For Appropriate SF


TRACKS, LOCK & WEATHERSTRIP		
TRACK	STANDARDS	SPECIFICATIONS
2 Inch Track	ASTM A1008/A1010	Bracket/Angle Mount
3 Inch Track	ASTM A1008/A1010	Angle Mount
LOCK	TYPE	SPECIFICATIONS
Slide Lock	Interior Mounted	
Keyed Lock	Optional	
Mini Warehouse	Optional	
WEATHERSTRIP	MOUNTING	LOCATION
U-Shape Astragal	Aluminum Retainer	Bottom Of Door

	DOOR OPTIONS
FINISH OPTIONS	
Standard Colors	White, Almond, Sandtone, Tera-Bronze, Green, Coffee, Black, Gray, Light Oak, And Dark Oak
ColorSelect	Select Custom Color
Powder Coat	Select Custom Color
ADD-ONS	
· Thermal Glazing	· Bottom Sensing Edge
· High Cycle Springs	· Flexible PVC Dual Flap Header Seal
· Jamb Weatherstrip	• Full Vision Aluminum Sections (White Standard
• Electric Operators	With Optional Anodized, Powder Coat, Or ColorSelect Custom Colors)
· Chain Hoist	,

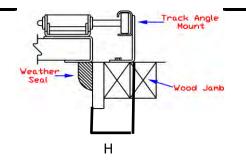



Requirements:

1 EA. @ 16'2" WIDTH X 7'0" HEIGHT. DOOR MODEL 2TG. 2 DOOR SECTION THICKNESS. EXTERIOR SHEET STEEL 27GA. INTERIOR SHEET STEEL 27GA. DOORS TO BE 5 PANELS WIDE AND 4 SECTIONS HIGH. WINDOW LIGHTS IF REQUIRED, WILL BE AND WILL BE GLAZED WITH LOCATED IN SECTION # AND IN PANEL(S). DOORS WILL ALSO BE FURNISHED WITH

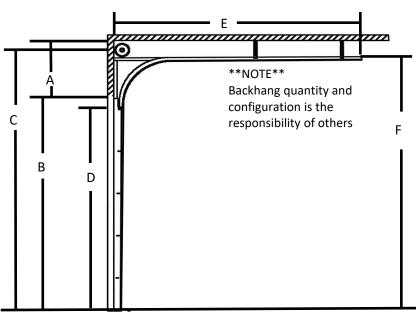

	Dimensions	
Α	Headroom (min)	15"
В	Opening Height	7' 0"
С	Floor Center Line of Spring Shaft	8' 0"
D	Vertical Track Height	6' 4"
Е	Backdepth	8' 8"
F	Horizontal Track Height	7' 9"
G	Roof Pitch	N/A
Н	Track Sideroom (min)	5-1/2"
I	High Lift Dimension	N/A
J	Operator Backroom	N/A

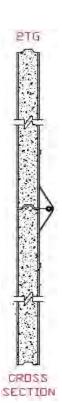

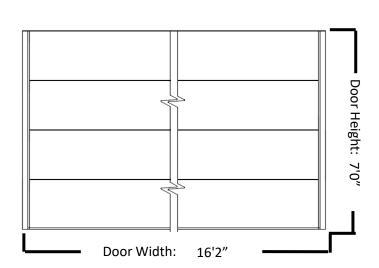

Drawing: NTS

MIDLAND
GARAGE DOOR MFG CO


SUPPLIER: GARAGE DOOR EXPRESS LLC


ADDRESS: 33133 US HWY 14

LONE ROCK, WI 53556

PHONE:

DATE: 8/17/2021 JOB: Falcon LOCATION: DRAWN BY:Adam CONTRACTOR: ORDER NO: 441747-1

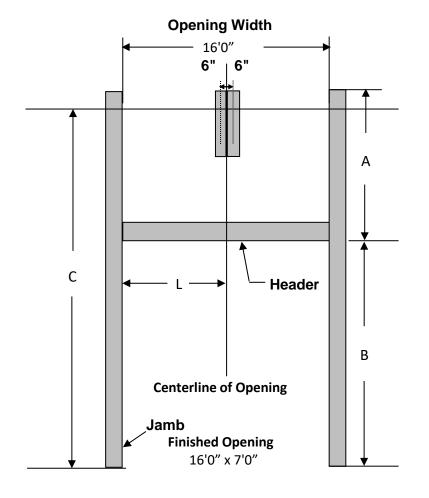

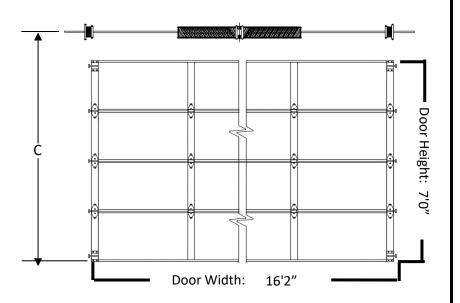

	Dimensions		
	Α	Headroom (min)	15"
	В	Opening Height	7' 0"
	С	Floor Center Line of Spring Shaft	8' 0"
	D	Vertical Track Height	6' 4"
	Е	Backdepth	8' 8"
	K	Pad Spacing	90"
	L	Centerline of Opening	8' 0"
Drawing: N	TS		

MIDI AND
GARAGE DOOR MFG CO

JOB: Falcon

LOCATION:

CONTRACTOR:

SUPPLIER: GARAGE DOOR EXPRESS LLC

ADDRESS: 33133 US HWY 14

LONE ROCK, WI 53556

PHONE:

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DRAWN BY:Adam

ORDER NO: 441747-1