DATE SUBMITTED: 10-16-13 UDC MEETING DATE: 10-23-13 PROJECT ADDRESS: 7401 Mineral Point Road, Madison, WI 53719 ALDERMANIC DISTRICT: District 9 OWNER/DEVELOPER (Partners and/or Principals) ARCHITECT/DESIGNER/OR AGENT: CBL & Associates Properties, Inc. JSD Professional Services, Inc. 2030 Hamilton Place Boulevard, Suite 500 161 Horizon Drive Suite 101 Chattanooga, TN 37421 Verona, WI 53593 CONTACT PERSON: Trey Conway Address: 2030 Hamilton Place Boulevard, Suite 500 Chattanooga, TN 37421 423.553.8730 Phone: 423.90.8602 Justin Frahm Fax: Verona, WI 53593 TYPE OF PROJECT: 608.848.5060 ext. 226 (See Section A for:) 608.848.2255 Planned Unit Development (PUD) justin.frahm@jsdinc.com General Development Plan (GDP)

Specific Implementation Plan (SIP)

General Development Plan (GDP) Specific Implementation Plan (SIP)

School, Public Building or Space (Fee may be required)

Planned Community Development (PCD)

Planned Residential Development (PRD)

R.P.S.M. Parking Variance (Fee required)

Comprehensive Design Review* (Fee required) Street Graphics Variance* (Fee required)

well as a fee)

Planned Commercial Site

Sq. Ft.

(See Section B for:)

(See Section C for:)

(See Section D for:)

Χ

APPLICATION FOR

URBAN DESIGN COMMISSION

REVIEW AND APPROVAL

Project # Legistar #	
Action Requested Informational Presentation Initial Approval and/or Recommendation Final Approval and/or Recommendation	

AGENDA ITEM #

PLEASE PRINT!

____ Other _____*
Public Hearing Required (Submission Deadline 3 Weeks in Advance of Meeting Date)

New Construction or Exterior Remodeling in C4 District (Fee required)

Where fees are required (as noted above) they apply with the first submittal for either initial or final approval of a project.

New Construction or Exterior Remodeling in an Urban Design District * (A public hearing is required as

New Construction or Addition to or Remodeling of a Retail, Hotel or Motel Building Exceeding 40,000

10/16/2013 **LETTER OF INTENT**

To: City of Madison Urban Design Commission/Plan Commission

Re: West Towne Shopko Development Developer: CBL & Associates Properties, Inc.

Dear Commission Members:

Included in this submittal is information pertaining to a new development project by CBL & Associates within the West Towne Mall development, generally located at the corner of the Shopko property, the mall ring road and Mineral Point Road. The project replaces one vacant out-parcel, with new restaurant construction which will add both temporary construction and full-time restaurant service employment opportunities to the local job market. One existing parcels is currently being combined into three separate parcels through the City's subdivision process.

Existing Conditions

The current site contains a 77,666 SF vacant asphalt paved parking lot containing 241 parking spaces and associated infrastructure. A perimeter 5' wide concrete sidewalks extends around the site adjacent to the mall ring road. There is one existing curb cut to the Steinhafel's Mattress paved area.

Project Details

The development project includes the following:

- Demolition of existing selective paving, and infrastructure (excluding underground public utilities and easements).
- New construction of 11,710 SF of two single-story restaurant buildings with maximum height of 25' above finished grade elevation.
- 168 new automobile parking stalls and 7 accessible spaces for a total of 175 parking stalls; facilities for parking of 16 bicycles distributed in 2 separate locations within site.
- Vehicular access will be provided at 4 locations: southeast property corner from ring road (no change/existing); northern property (existing location/internal modification); and two on the western property (new location/ single curb cut versus two existing curb cuts)
- Pedestrian features to include expanded perimeter sidewalks at 7'-0" wide; new sidewalk/crosswalk connection from north side of new building to Mineral Point Road; offsite sidewalk/crosswalk connection from existing sidewalk from the mall ring road to development's building sidewalk; and sidewalk passage/node between new buildings.
- Landscaping per attached Landscape Plans
- Site Lighting to include relamping/reuse of existing area light poles; building mounted sconce lighting and ornamental light poles for building sidewalk lighting; and a combination of ornamental light poles between new buildings.
- Signage: A signage package will be submitted as tenants are secured and proposed signage will be consistent with Chapter 31 and other City Ordinances.

- Two outdoor seating areas containing 44 seats and 64 seats respectively in locations shown on plans. *Use and hours of operation to be determined.
- Zoning: CC Commercial Center District
- Hours of Operation: Retail operation 10:00am to 10:00pm Monday through Sunday
- Construction Schedule (*):

Demolition of existing structure
 Site Preparation
 Building Construction
 Tenant Fixturing
 Grand Opening
 February-March, 2014
 March- June, 2014
 June- October, 2014
 October- November, 2014
 November-December, 2014

(*) Pending Construction Contract with General Contractor

Parties Involved

Developer CBL & Associates Properties, Inc.

Contact: Trey Conway 423.553.8730

Trey _Conway@cblproperties.com

Property Owner Spirit SPE Portfolio 2006-1, LLC

Contact: Jennifer McGinnity 920.429.4780

Jennifer.McGinnity@shopko.com

Civil Engineer: JSD Professional Services, Inc.

Contact: Justin Frahm 608.848.5060

Justin.Frahm@jsdinc.com

Landscape Architect: JSD Professional Services, Inc.

Contact: Justin Frahm 608.848.5060

Justin.Frahm@jsdinc.com

Surveyor: JSD Professional Services, Inc.

Contact: Justin Frahm 608.848.5060

Justin.Frahm@isdinc.com

General Contractor: To Be Determined

Summary

The development of this site will accomplish the removal of existing vacant and deteriorating properties within West Towne Mall and the creation of a vibrant and distinctive restaurant center that enhances pedestrian movement and reconnects the existing site with the remainder of the mall. We look forward to working with the City to make the West Towne development project a successful addition to the City of Madison's retail experiences.

Respectfully submitted by,

Trey Conway

CBL & Associates Properties, Inc.



LAND USE APPLICATION

CITY OF MADISON

215 Martin Luther King Jr. Blvd; Room LL-100

FOR OFFICE	USE ONLY:
mt. Paki Rece	lipt No.
ate Received	
ecelved By	
arcel No.	···
ldermanic District	
oning District	
pedal Requirements	
eview Required By:	
Urban Design Commission	Plan Commission
Common Council	Other:
Form Effective: Febr	

PO Box 2985; Madison, Wisconsin 53701-2985 Phone: 608.266.4635 Facsimile: 608.267.8739	Date Received
All Land Use Applications should be filed with the Zoning Administrator at the above address.	Parcel No
The following information is required for all applications for Plan Commission review except subdivisions or land divisions, which should be filed using the <u>Subdivision Application</u> .	Zoning District Special Requirements Review Required By:
This form may also be completed online at: www.cityofmadison.com/developmentcenter/landdevelopment	Urban Design Commission Plan Commission Common Council Other: Form Effective: February 21, 2013
. Project Address: 7401 Mineral Point Road, Madison, WI 53	3717
Project Title (if any):	
	THE STATE OF THE S
2. This is an application for (Check all that apply to your Land	Use Application):
Zoning Map Amendment from	to
	Major Amendment to Approved PD-SIP Zoning
	•
Review of Alteration to Planned Development (By Plan Con	•
▼ Conditional Use, or Major Alteration to an Approved Condit	tional Use
Demolition Permit	
Other Requests:	
Analisant Agant & Dananthi Chimas Information	
3. Applicant, Agent & Property Owner Information: Compa	ny: CBL & Associates Properties, inc.
DODG Hamilton Diago Divid Ov. COO	Chattanooga, TN Zip: 37421
400 EE2 0720 400 0002	Email: trey_conway@cbiproperties.com
The state of the s	
	nny: JSD Professional Services, Inc. Verona, Wi 715. 53593
	Superior Standard Control of the Con
Telephone: (608) 848-5080 Fax: (608) 848-2255	Email: justin.franm@jsdinc.com
Property Owner (If not applicant): Spirit SPE Portfolio 2006-1, LLC	
Street Address: 7401 Mineral Point Road City/State:	Madison, WI Zip: 53717
T. Danie sk Informackien.	
4. Project Information:	
المنتري المستند في المنتبين والمنتزل المنتزل ا	Tun (2) proposed from atomsline resistance
Provide a brief description of the project and all proposed uses of the buildings	e site: Two (2) proposed free standing restauran

Development Schedule: Commencement Completion

5.	Required Submittal	Information
All	Land Use applications a	re required to

o include the following:


- Project Plans including:*
 - Site Plans (fully dimensioned plans depicting project details including all lot lines and property setbacks to buildings; demollshed/proposed/altered buildings; parking stalls, driveways, sidewalks, location of existing/proposed signage; HVAC/Utility location and screening details; useable open space; and other physical improvements on a property)
 - Grading and Utility Plans (existing and proposed)
 - Landscape Plan (Including planting schedule depicting species name and planting size)
 - Building Ejevation Drawings (fully dimensioned drawings for all building sides, labeling primary exterior materials)
 - Floor Plans (fully dimensioned plans including interior wall and room location)


Provide collated project plan sets as follows:


- Seven (7) copies of a full-sized plan set drawn to a scale of 1 inch = 20 feet (folded or rolled and stapled)
- Twenty Five (25) copies of the plan set reduced to fit onto 11 X 17-inch paper (folded and stapled)
- One (1) copy of the plan set reduced to fit onto 8 ½ X 11-inch paper
- * For projects requiring review by the Urban Design Commission, provide Fourteen (14) additional 11x17 copies of the plan

	set. In addition to the above information, <u>all plan sets should also include: 1</u>) Colored elevation drawings with shadow lines and a list of exterior building materials/colors; 2) Existing/proposed lighting with photometric plan & fixture cutsheet; and 3) Contextual site plan information including photographs and layout of adjacent buildings and structures. The applicant shall <u>bring</u> samples of exterior building materials and color scheme to the Urban Design Commission meeting.
V	Letter of intent: Provide one (1) Copy per Plan Set describing this application in detail including, but not limited to:
	 Project Team Existing Conditions Project Schedule Proposed Uses (and ft² of each) Hours of Operation Building Square Footage Number of Dweiling Units Estimated Project Cost Number of Construction & Full-Time Equivalent Jobs Created Public Subsidy Requested
V	Filing Fee: Refer to the Land Use Application Instructions & Fee Schedule. Make checks payable to: City Treasurer.
V	Electronic Submittal: All applicants are required to submit copies of all items submitted in hard copy with their application as Adobe Acrobat PDF files on a non-returnable CD to be included with their application materials, or by e-mail to pcapplications@cityofmadison.com.
Z	Additional information may be required, depending on application. Refer to the <u>Supplemental Submittal Requirements.</u>
6.	Applicant Declarations
Ø	Pre-application Notification: The Zoning Code requires that the applicant notify the district alder and any nearby neighborhood and business associations in writing no later than 30 days prior to Filling this request. List the alderperson, neighborhood association(s), and business association(s) AND the dates you sent the notices: Alderman Paul Skidmere, District 9, 9/16/13
	→ If a waiver has been granted to this requirement, please attach any correspondence to this effect to this form.
Ø	Pre-application Meeting with Staff: <u>Prior</u> to preparation of this application, the applicant is required to discuss the proposed development and review process with Zoning and Planning Division staff; note staff persons and date.
	Planning Staff: DAT meeting Date: 9/19/13 Zoning Staff: DAT meeting Date: 9/19/13
The	e applicant attests that this form is accurately completed and all required materials are submitted:
Nar	me of Applicant Trey Conway Relationship to Property: Developer
Λιн	thorsing Stonature of Property Owner 115/13

Walk Wenholmer

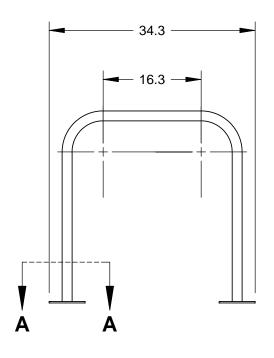

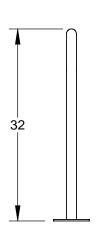

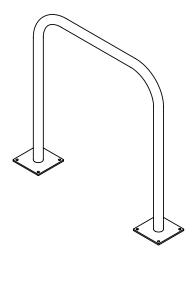

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2X 6" X 6" X .25" SQUARE FLANGE MOUNTING PLATE WITH 4 ϕ 5/8" MOUNTING HOLES

NOTE:

- 1. DO NOT SCALE DRAWING.
- 2. INTALLATION TO BE COMPLETED IN ACCORDANCE WITH MANUFACTURER'S SPECIFICATIONS.




SARIS CYCLING GROUP

5253 VERONA RD., MADISON WI. 53711 1-800-783-7257 / 1-608-274-1702 WWW.SARISPARKING.COM

THE INFORMATION CONTAINED IN THIS DRAWING IS THE SOLE PROPERTY OF SARIS CYCLING GROUP ANY REPRODUCTION IN PART OR WHOLE WITHOUT THE WRITTEN PERMISSION OF SARIS CYCLING GROUP IS PROHIBITED.


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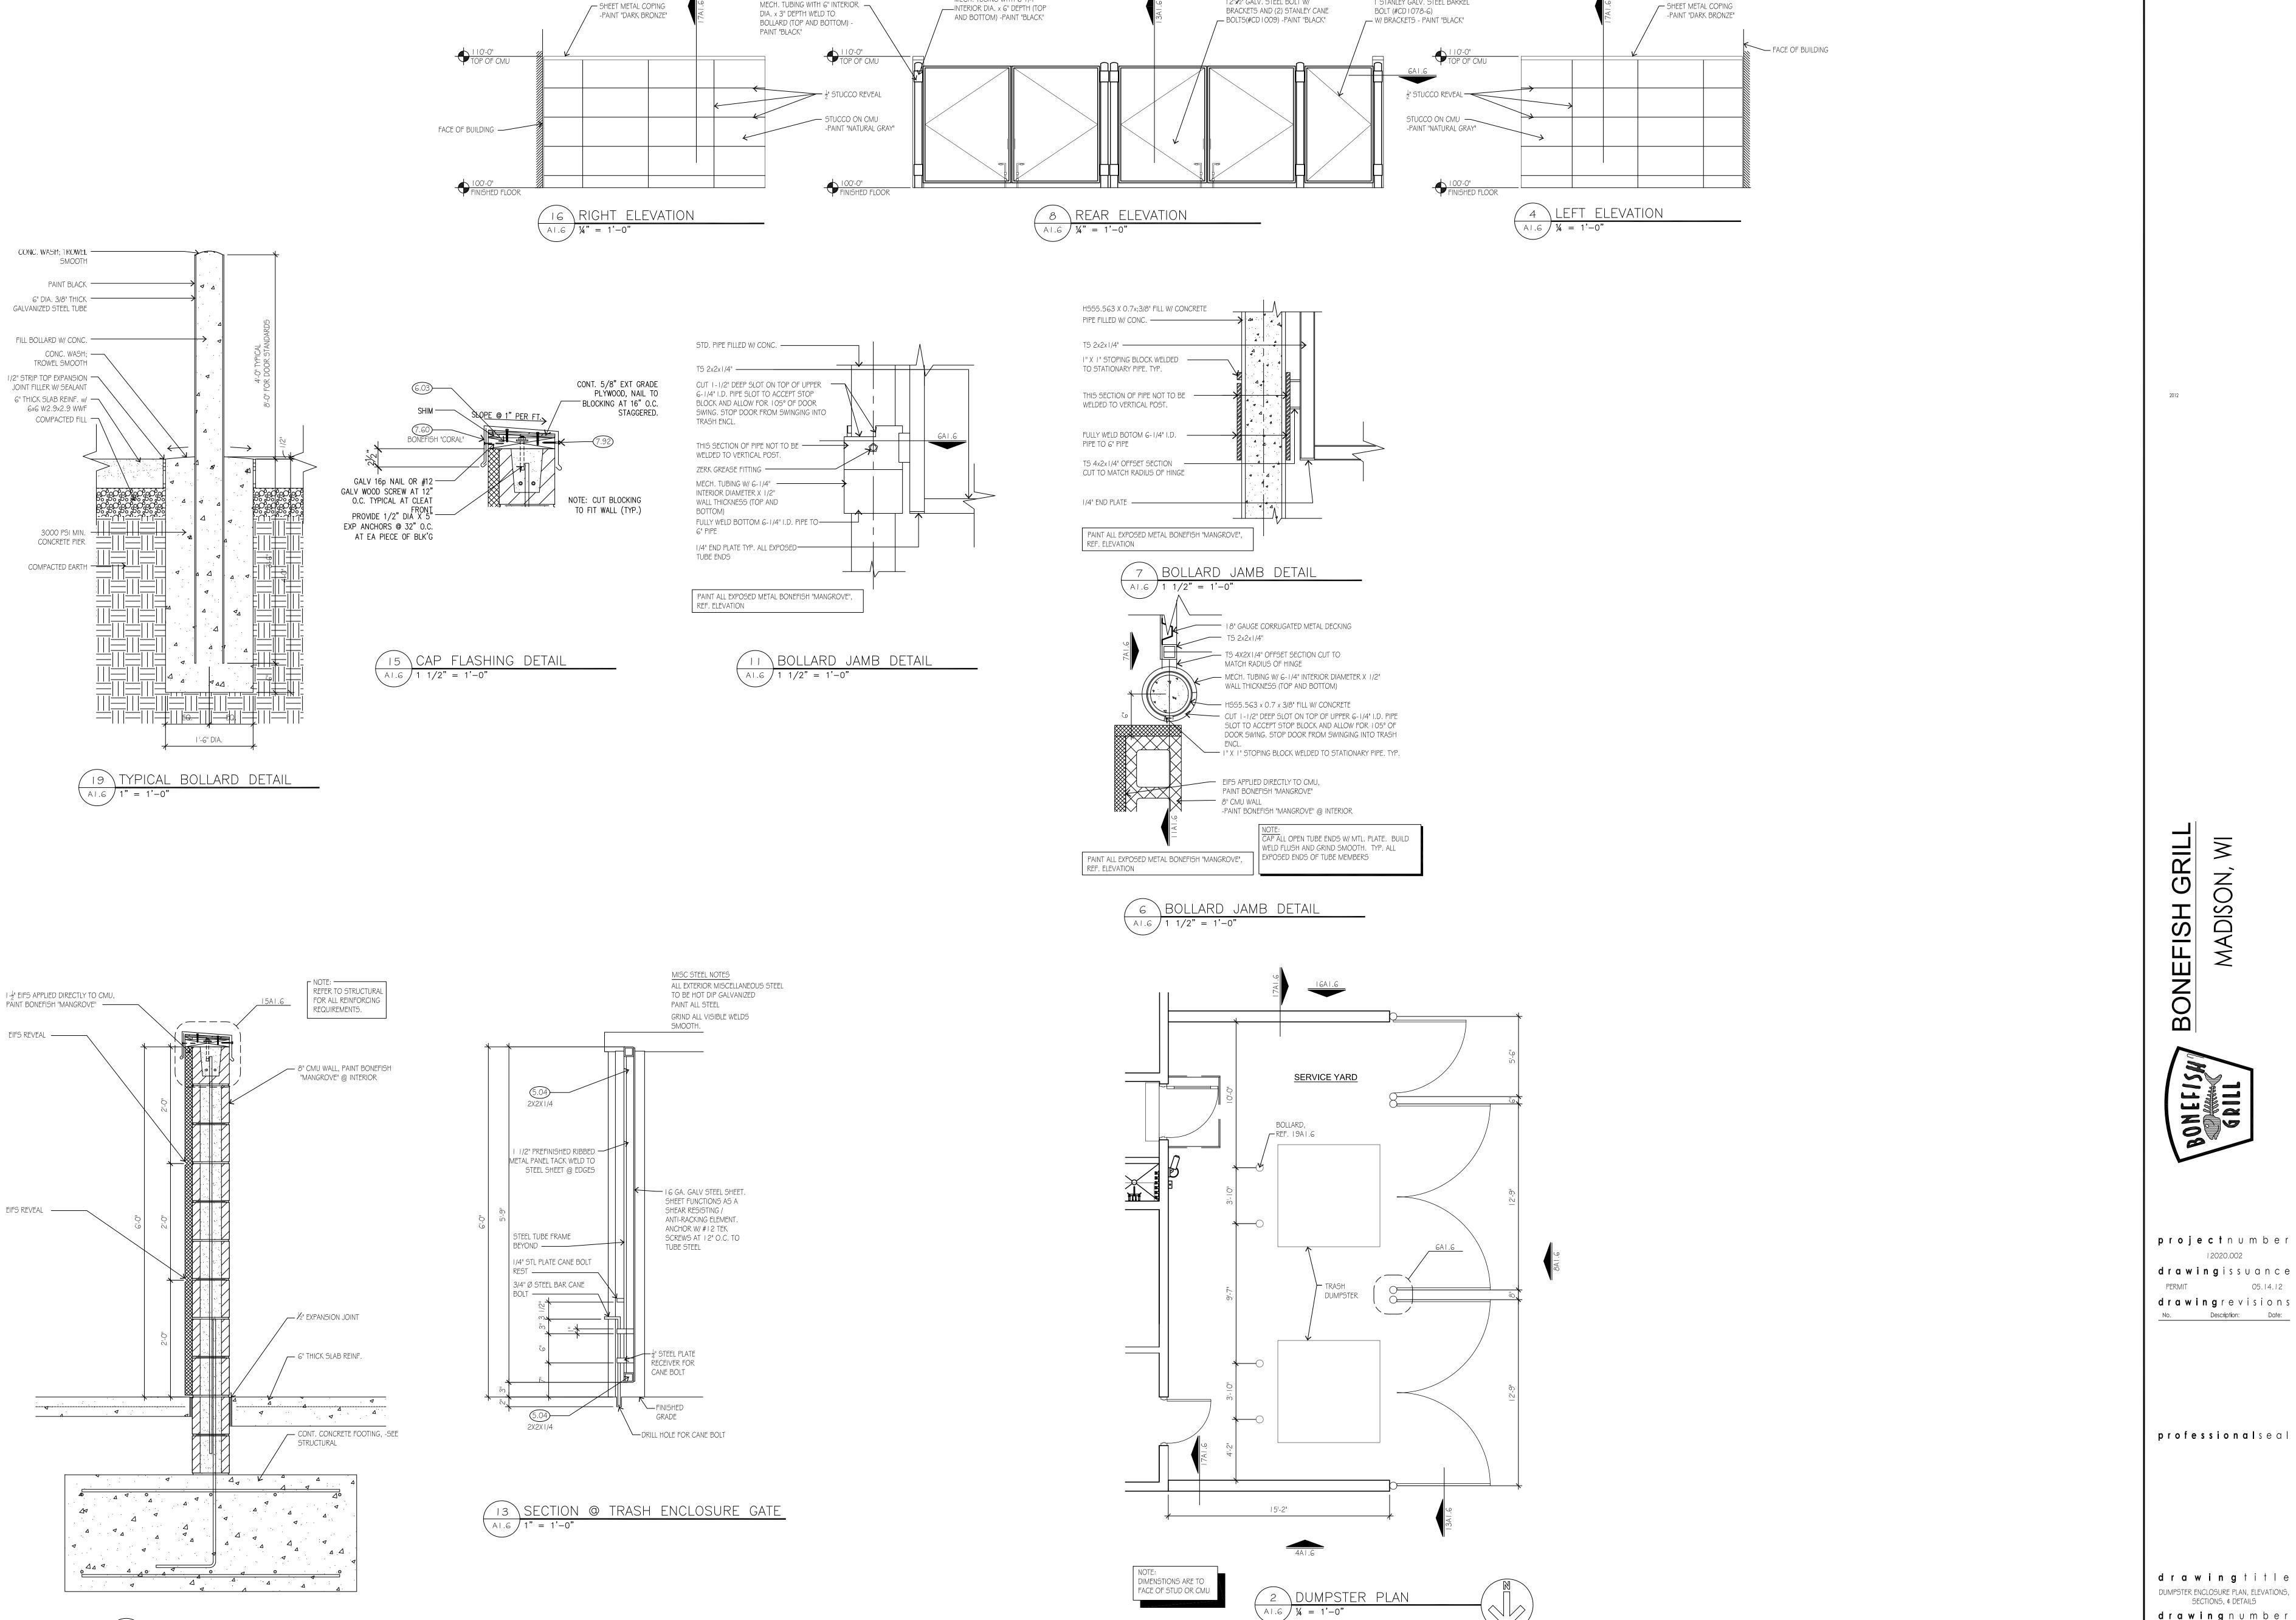


Design Consultant: Innovation and Design in 115 Pine Ave. Suite 250 Long Beach, CA 90802

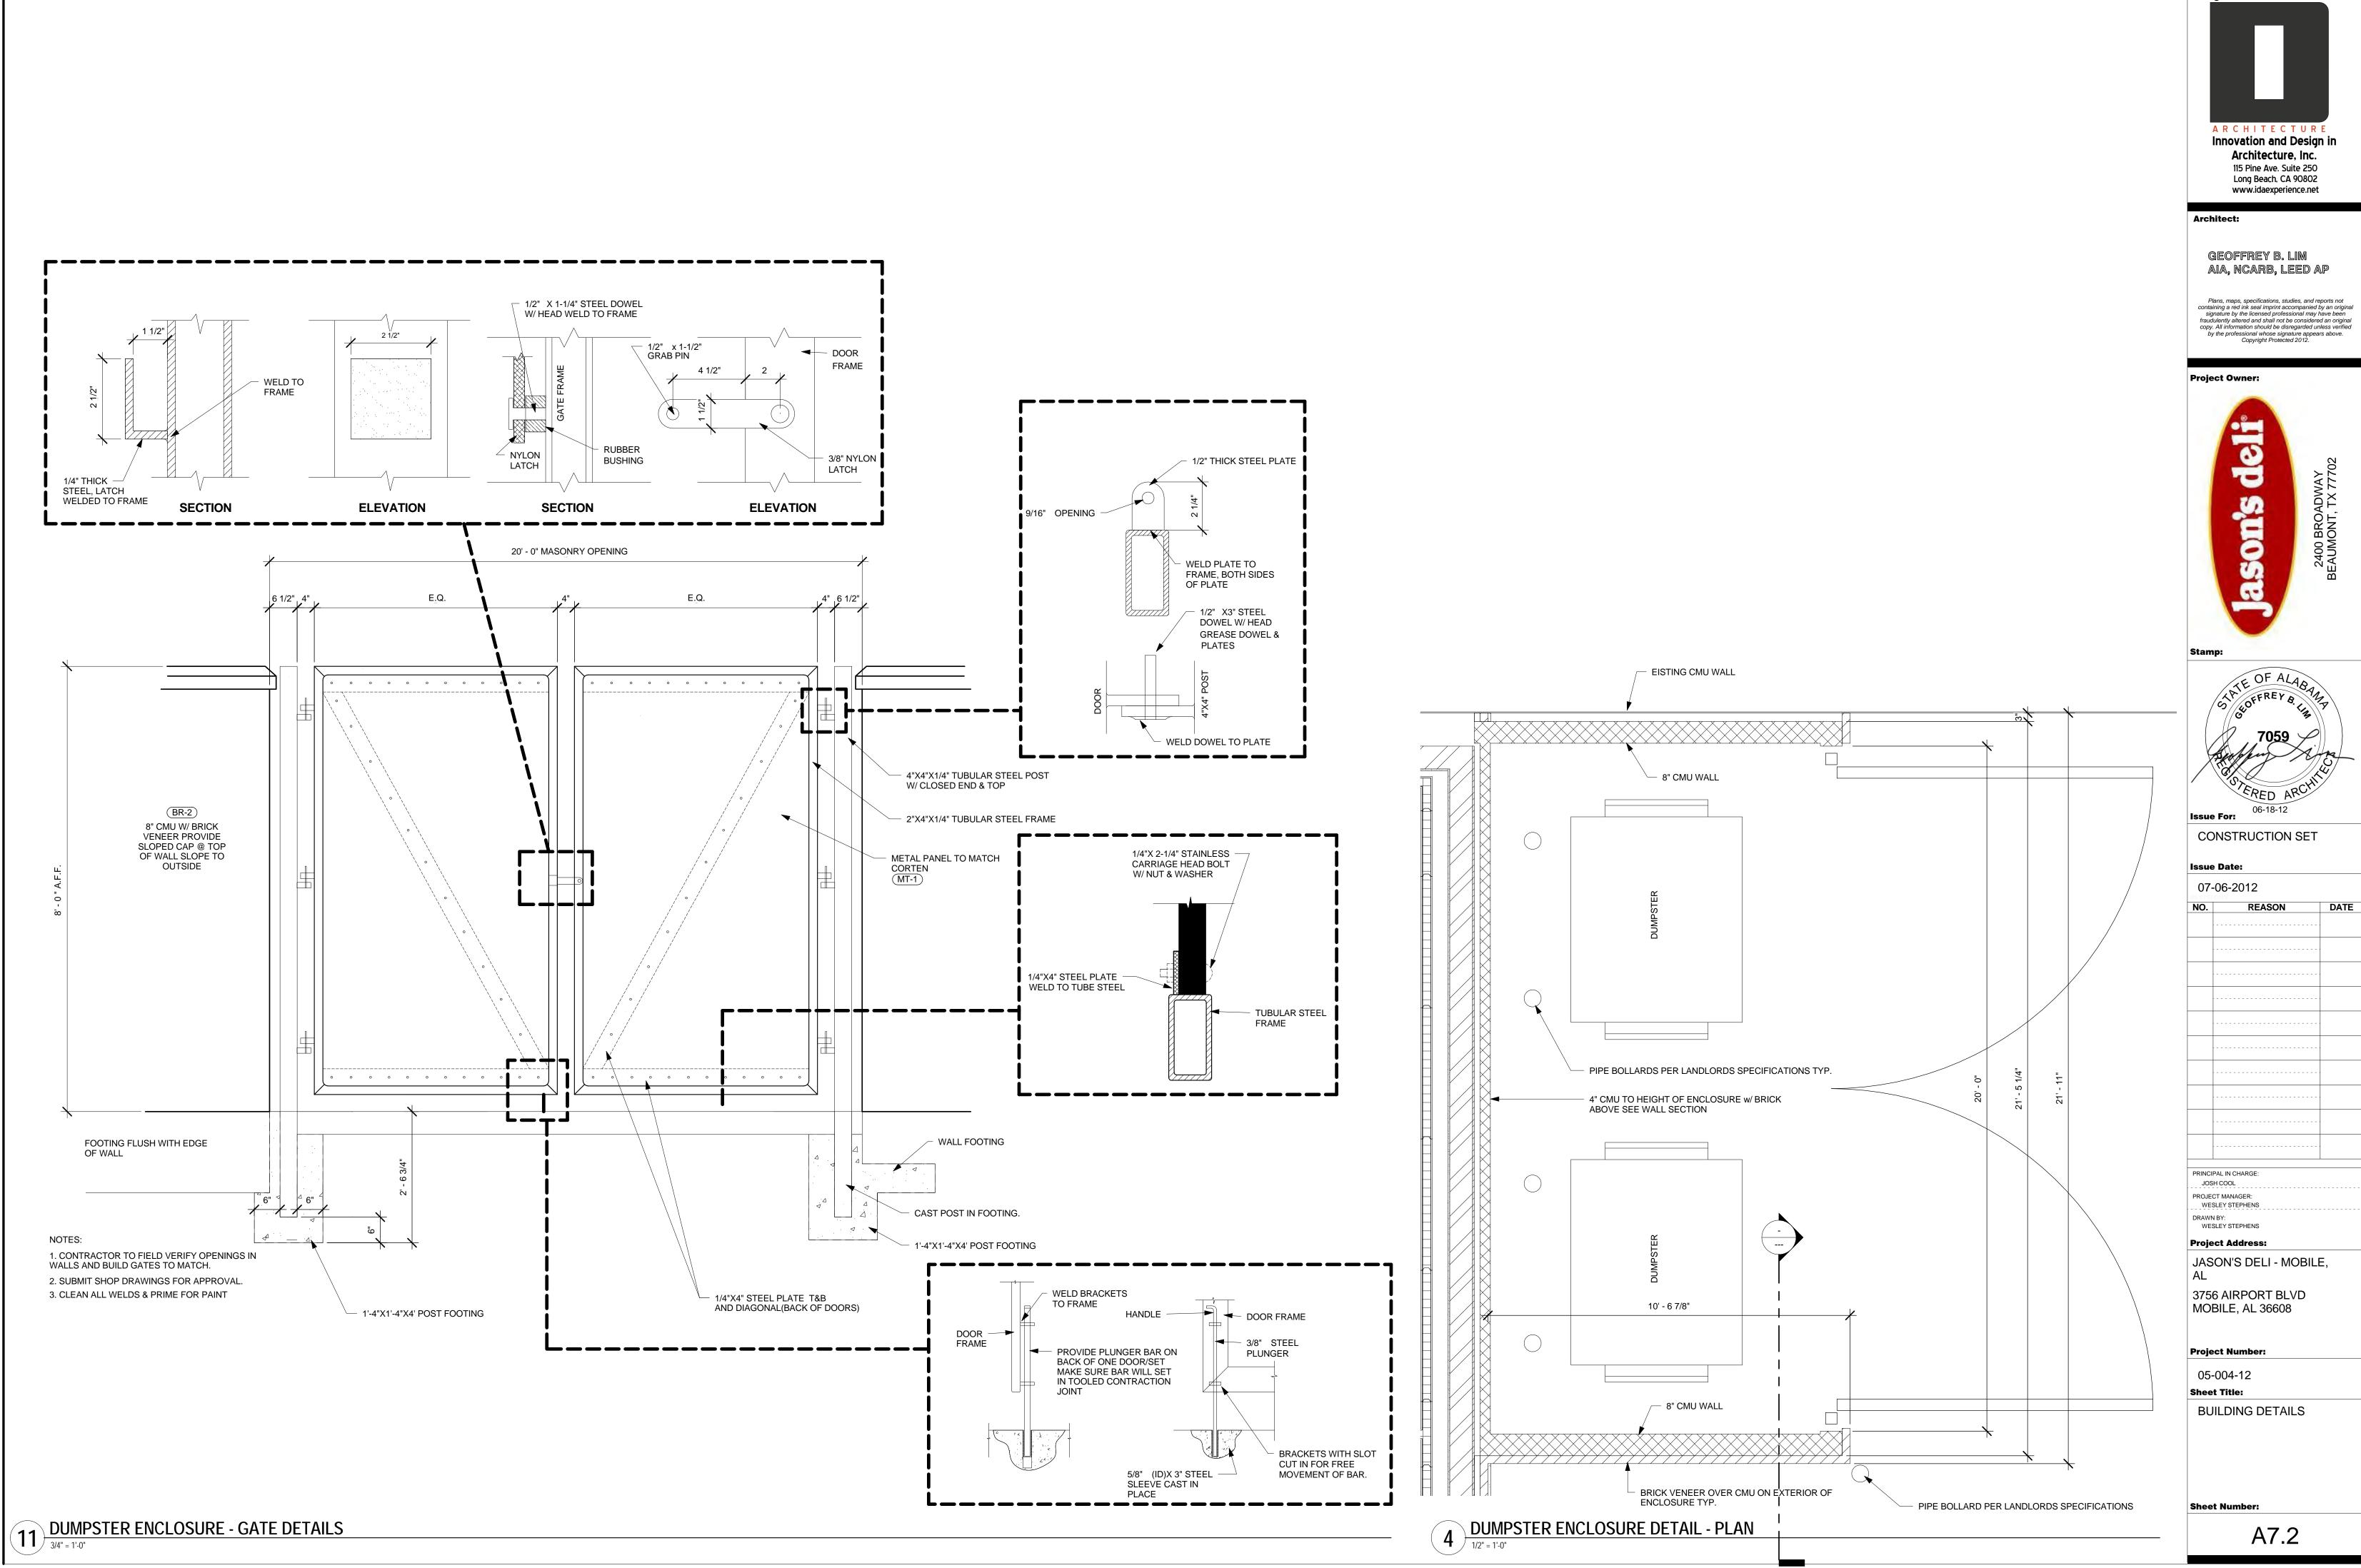



1 O.	KLASON	DAIL
	PAL IN CHARGE:	

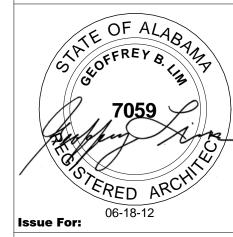

17 SECTION @ DUMPSTER WALL

MECH. TUBING WITH 6 1/4"

GATE HARDWARE:

I 2" 1/2" GALV. STEEL BOLT W/

MAN DOOR HARDWARE:

I STANLEY GALV. STEEL BARREL

PLAN NORTH

BONEFISH GRILL ADISON,

BONEFISM GRILL

projectnumber 12020.002 **drawing**issuance

drawing title DUMPSTER ENCLOSURE PLAN, ELEVATIONS, SECTIONS, & DETAILS **drawing**number

Jason's deli

Sign A

Sign: 12" Jason's Deli w/ 11" ToGo letters

Sign Type: Channel Letters on a shoebox pan/
Aluminum Frame and Reverse Lit Letters

Illumination: Internally Illuminated LED

Square Footage: 21.29

To Grade: Top of sign to grade = 13'-3"

Bottom of sign to grade = 10'-2 1/2"

Sign B

Sign: 16" Jason's Deli

Sign Type: Channel Letters on a shoebox pan/
Aluminum Frame


Illumination: Internally Illuminated LED

Square Footage: 25.08

To Grade: Top of sign to grade = 16'-9 1/2"
Bottom of sign to grade = 14'-1 1/4"

Sign C

Sign: Jason's Deli
Sign Type: New Pole Sign
Illumination: Internally Illuminated Fluorescent lamps
Square Footage: 192.66

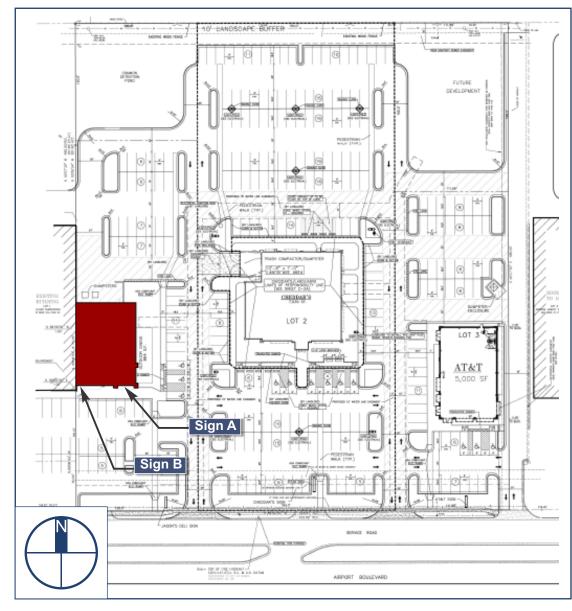



Client:	Jasons Deli	05/03/2012	Original Rendering	ВС	This re
Site #:	JD-A16234	<u> </u>			Sign, In Anchor reques
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Sign A		Sign B	
Sign:	12" Jason's Deli w/ 11" ToGo letters	Sign	16" Jason's Deli
Sign Type:	Channel Letters on a shoebox pan/ Aluminum Frame and Reverse Lit Letters	Sign Type	Channel Letters on a shoebox pan/ Aluminum Frame
Illumination:	Internally Illuminated LED	Illumination	Internally Illuminated LED
Square Footage:	21.29	Square Footage	25.08
To Grade:	Top of sign to grade = 13'-3" Bottom of sign to grade = 10'-2 1/2"	To Grade	Top of sign to grade = 16'-9 1/2" Bottom of sign to grade = 14'-1 1/4"



Front Elevation (South)

Scale: 3/32" = 1'-0"

Allowable Square Footage this Elevation:

350

Actual Square Footage this Elevation:


46.73



Client:	Jasons Deli	05/03/2012	Original Rendering	BC	This re
Site #:	JD-A16234	<u> </u>			Sign, Ancho
Address:	3756 Airport Road	NO			reque
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Side Elevation (East)

Scale: 3/32" = 1'-0"

Allowable Square Footage this Elevation:

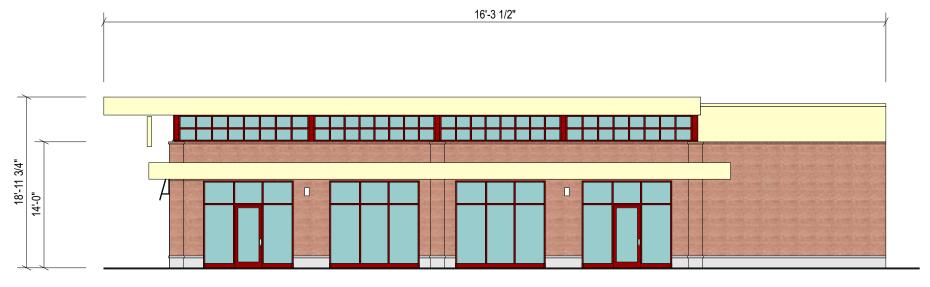350

Actual Square Footage this Elevation:

0.00



Jasons Deli	05/03/2012	Original Rendering	BC	This
JD-A16234	<u> </u>			Sign
3756 Airport Road	<u> </u>			requ
Mobile AL 36608	\$			distr
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Sign A 12" Jason's Deli w/ 11" ToGo letters Sign Type: Channel Letters on a shoebox pan/ Aluminum Frame and Reverse Lit Letters Illumination: Internally Illuminated LED Square Footage: Top of sign to grade = 13'-3" To Grade: Bottom of sign to grade = 10'-2 1/2"

Electrical Detail:

White LEDs (GE MiniMax)

(X) 60w Transformer @ 0.85 Amps Each Total Amps: X.XX

(1) 20 amp 120V Circuit Req.

General Notes:

This sign is to be installed in accordance with the requirements of Article 600 of the National Electrical Code.

- 1) Grounded and bonded per NEC 600.7/NEC 250
- 2) Existing branch circuit in compliance with NEC 600.5, not to exceed 20 amps
- 3) Sign is to be UL listed per NEC 600.3
- 4) UL disconnect switch per NEC 600.6- required per sign component before leaving manufacturer* *For multiple signs, a disconnect is permitted but not required for each section

Specifications: ToGo


- 1. Existing Facade: Brick
- 2. 0.065" Aluminum letter returns painted to match black
- 3. 0.125" x 1" Trim cap to match black
- 4. 3/16" Clear lexan backs (interior of sign can painted ultra white for maximum illumination)
- 5. White LEDs
- 6. 3/16" White Acrylic
- 7. Waterproof disconnect switch per NEC 600-6
- 8. Primary electrical feed
- 9. Transformers
- 10. 2" Sleeve spacers w/ mounting hardware to suit
- 11. 0.75" x 0.0625" Aluminum angle pop-riveted to backs attached to returns via #8 Pan-head screws

7'-0" 4'-10 1/4" 3'-1 7/8" Jason's deli 1/2" 1/2" background

Sign Layout Detail

Scale: 3/4" = 1'-0"

Note: Registration Mark to be white vinyl applied to face of

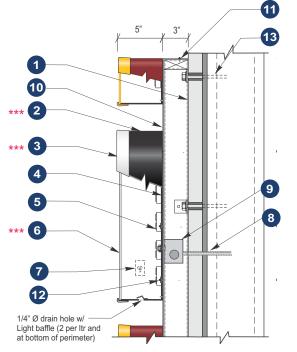

Section @ LED Channel Letter/ Shoebox Front-Lit (Self Contained)

5 6 1/4" Drain holes at bottom of letter cans (2) per letter

Section @ LED Channel Letter Reverse-lit / Front-lit (Remote)



05/03/2012 Original Rendering Client: Jasons Deli Site #: JD-A16234 Address: 3756 Airport Road Mobile AL 36608 Mobile

Specifications: Jason's deli

4. 3mm Signabond Lite composite backs

7. Waterproof disconnect switch per NEC 600-6

10. 0.080" Aluminum shoe-box ptm PMS# 1805 Red

12. #12 x 1" TEC screws with 11/4" fender washers

(all jumps contained within shoe-box)

for the Perimeter Channel Trim

2. 0.040" Aluminum letter returns painted to match black (channel letters) and ptm PMS#1805 red (Perimeter Channel Trim)

3. 0.125" x 1" trim cap to match white (channel letters) and yellow

(interior of sign can painted ultra white for maximum illumination)

6. 3/16" White Acrylic (Channel Letters) and 3/16" #2037 Yellow acrylic

11. #12 TEC screws fastening shoe-box to 3" x 1" Aluminum Square Tube

Mounting Frame. (2" x 2" x 1/4" Aluminum mount tabs welded to frame)

1. Existing Facade: TBD

8. Primary electrical feed

13. Mounting hardware to suit

9. Transformers

(Perimeter Channel Trim)

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Sign B	
Sign:	16" Jason's Deli
Sign Type:	Channel Letters on a shoebox pan/ Aluminum Frame
Illumination:	Internally Illuminated LED
Square Footage:	25.08
To Grade:	Top of sign to grade = 16'-9 1/2" Bottom of sign to grade = 14'-1 1/4"



Sign Layout Detail

Scale: 1/2" = 1'-0"

Note: Registration Mark to be white vinyl applied to face of background

Note: Attachment detail for this sign will be determined prior to permitting and production

Electrical Detail:

White LEDs (GE MiniMax)

- (X) 60w Transformer @ 0.85 Amps Each Total Amps: X.XX
- (1) 20 amp 120V Circuit Req.


General Notes:

This sign is to be installed in accordance with the requirements of Article 600 of the National Electrical Code.

- 1) Grounded and bonded per NEC 600.7/NEC 250
- 2) Existing branch circuit in compliance with NEC 600.5, not to exceed 20 amps
- 3) Sign is to be UL listed per NEC 600.3
- 4) UL disconnect switch per NEC 600.6- required per sign component before leaving manufacturer* *For multiple signs, a disconnect is permitted but not required for each section

Specifications: Channel Letters

- 1. Existing Facade: TBD
- 0.040" Aluminum letter returns painted to match black (channel letters) and ptm PMS#1805 red (Perimeter Channel Trim)
- 3. 0.125" x 1" trim cap to match white (channel letters) and yellow (Perimeter Channel Trim)
- 4. 3mm Signabond Lite composite backs (interior of sign can painted ultra white for maximum illumination)
- 5. White LEDs
- 3/16" White Acrylic (Channel Letters) and 3/16" #2037 Yellow acrylic for the Perimeter Channel Trim
- 7. Waterproof disconnect switch per NEC 600-6
- 8. Primary electrical feed
- 9. Transformers
- 10. 0.080" Aluminum shoe-box ptm PMS# 1805 Red (all jumps contained within shoe-box)
- 11. #12 TEC screws fastening shoe-box to 3" x 1" Aluminum Square Tube Mounting Frame. (2" x 2" x 1/4" Aluminum mount tabs welded to frame)
- 12. #12 x 1" TEC screws with 11/4" fender washers
- 13. Mounting hardware to suit

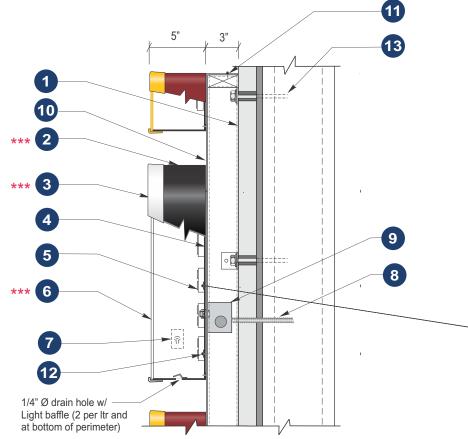


Section @ LED Channel Letter/ Shoebox Front-Lit (Self Contained) Scale: N.T.S.



Client:	Jasons Deli	05/03/2012	Original Rendering	ВС	This re
Site #:	JD-A16234	볼			Sign, I Ancho
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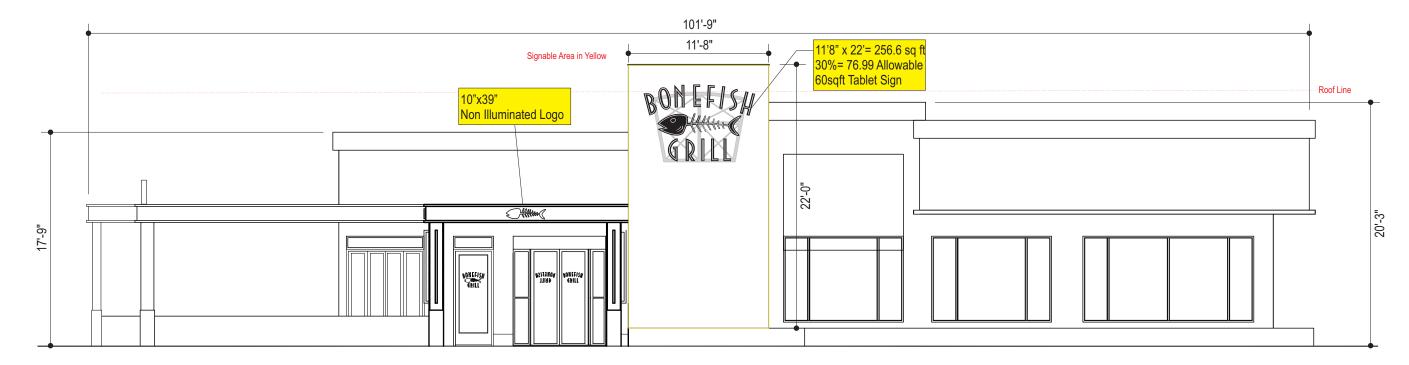




Client:	Jasons Deli	05/03/2012	Original Rendering	ВС	This rende
Site #:	JD-A16234	<u> </u>			Sign, Inc. Anchor Si
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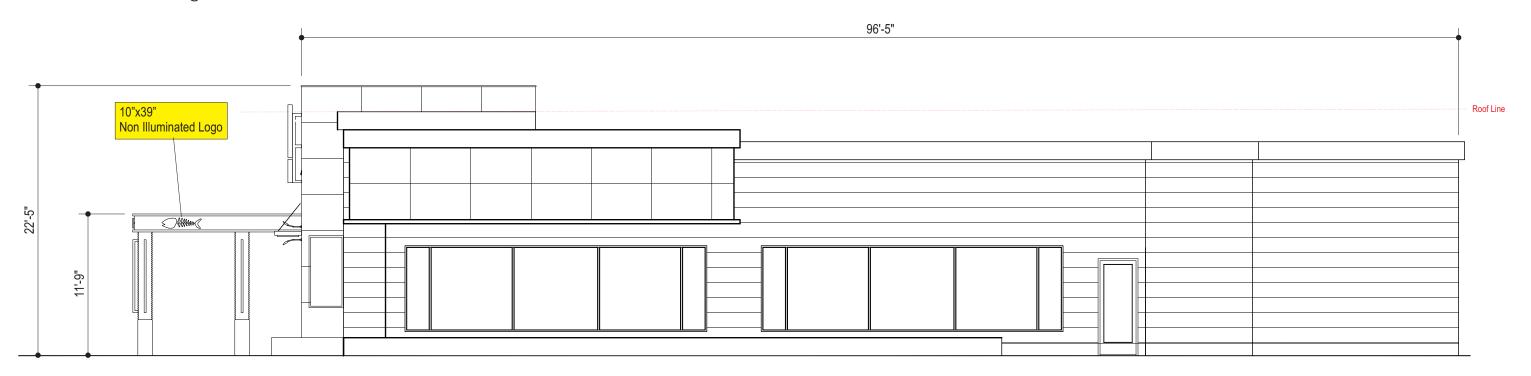
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South/Front Elevation

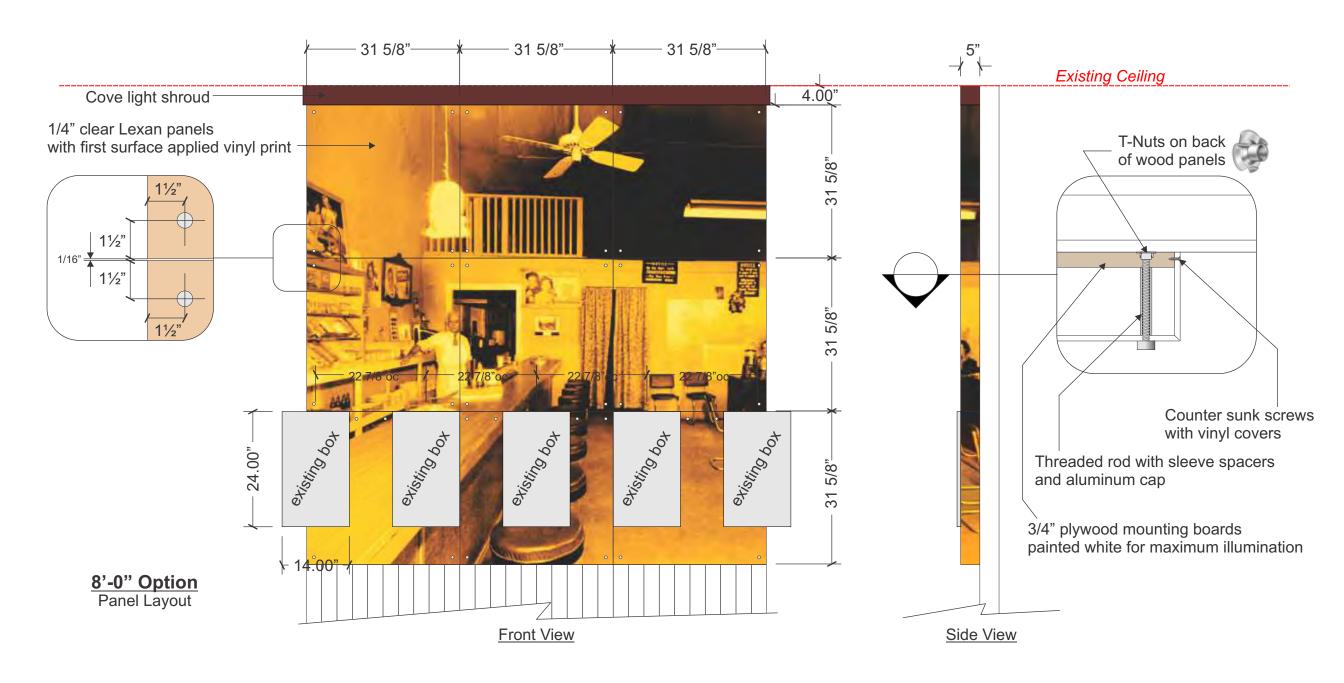Scale: 1/8" = 1' @ 11X17



East/Right Side Elevation

Scale: 1/8" = 1' @ 11X17

CLIENT:	Bonefish Gril]	
LOCATION:	Madison, WI		
DATE:	10.14.13		STORE #
DRAWING #	BON-Madiso	n-E1	
DRAWN BY:	СВ	APPROVED BY:	SHEET SIZE 11 x 17

THIS DESIGN IS SUBMITTED AS PART OF OUR PROPOSAL AND IS TO REMAIN OUR PROPERTY EXCLUSIVELY UNTIL ACCEPTED AND APPROVED BY PURCHASE.

IS SUBMITTED JUR PROPOSAL REMAIN OUR EXCLUSIVELY EXCLUSIVELY	1	REVISED PER CITY COMMENTS	10/15/13	DD
PURCHASE.	REV#	DESCRIPTION	DATE	BY



THIS SIGN IS INTENDED TO BE INSTALLED IN ACCORDANCE WITH THE REQUIREMENTS OF ARTICLE 600 OF THE NATIONAL LECTRICAL CODE AND / OR OTHER APPLICABLE LOCAL CODES. THIS INCLUDES PROPER GROUNDING AND BONDING OF THE SIGN.

CUSTOMER APPROVAL:

SIGNATURE


DATE: _____ APPROVAL RECEIVED BY UNITED

IMPORTANT:

PERMANENT ACCESS TO THE BACK SIDE OF THE WALL IS REQUIRED FOR INSTALLATION AND WIRING OF THE SIGN. IF IT IS NOT AVAILABLE IT MUST BE PROVIDED BY THE CUSTOMER BEFORE INSTALLATION.




206 Tower Drive Oldsmar, Florida 34677 unitedsignsystems.com

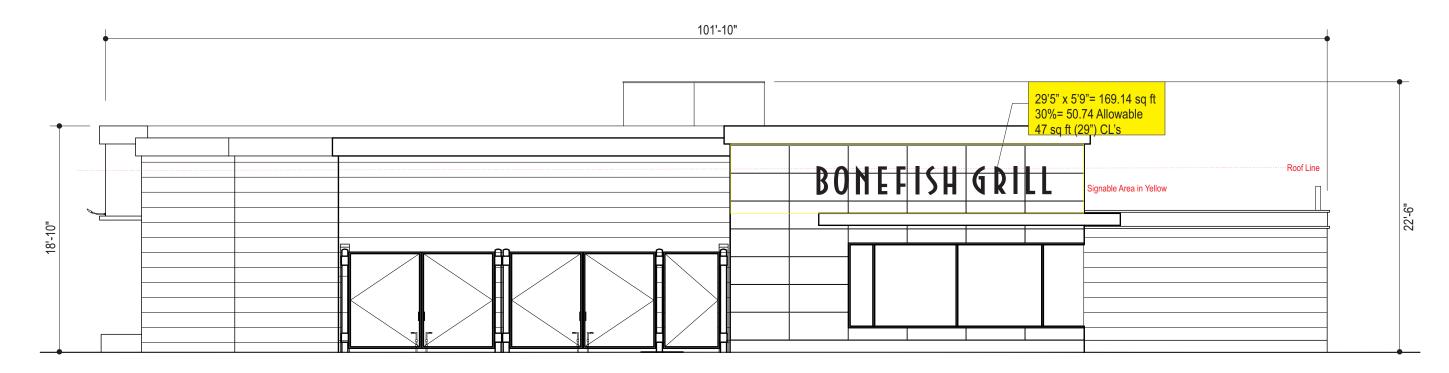

North/Rear Elevation

Scale: 1/8" = 1' @ 11X17

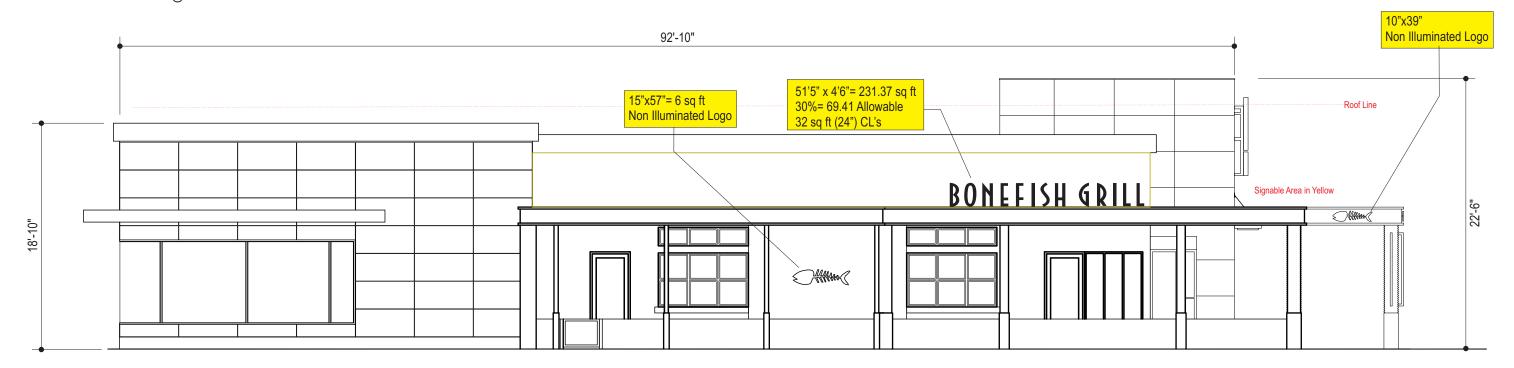

West/Left Side Elevation

Scale: 1/8" = 1' @ 11X17

CLIENT:	Bonefish Grill		
LOCATION:	Madison, WI		
DATE:	10.14.13		STORE #
DRAWING #	BON-Madiso	n-E2	
DRAWN BY:	СВ	APPROVED BY:	SHEET SIZE 11 x 17

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CHASE.	REV#	DESCRIPTION	DATE	BY	



THIS SIGN IS INTENDED TO BE INSTALLED IN ACCORDANCE WITH THE REQUIREMENTS OF ARTICLE 600 OF THE NATIONAL CODE AND / OR OTHER APPLICABLE LOCAL CODES. THIS INCLUDES PROPER GROUNDING AND BONDING OF THE SIGN.

CUSTOMER APPROVAL:

IMPORTANT:


IF IT IS **NOT** AVAILABLE IT MUST BE **PROVIDED**


BY THE CUSTOMER BEFORE INSTALLATION.

DATE: _ APPROVAL RECEIVED BY UNITED

PERMANENT ACCESS TO THE BACK SIDE OF THE WALL IS REQUIRED FOR INSTALLATION AND WIRING OF THE SIGN.

United Sign Systems 206 Tower Drive Oldsmar, Florida 34677 unitedsignsystems.com

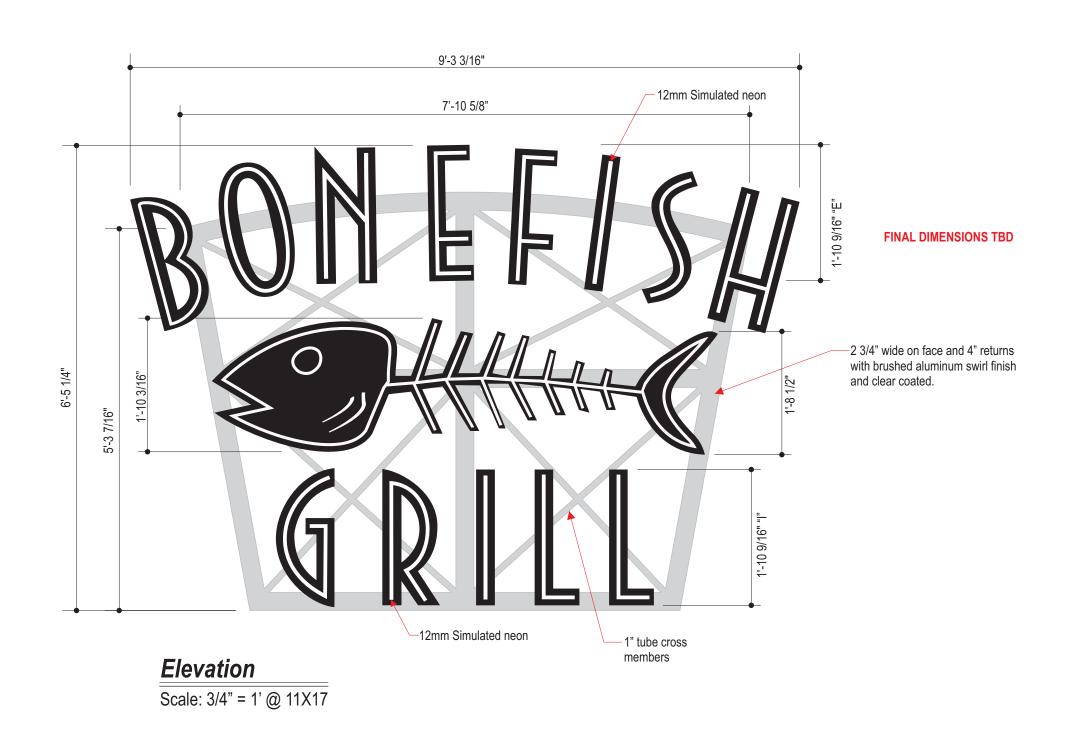

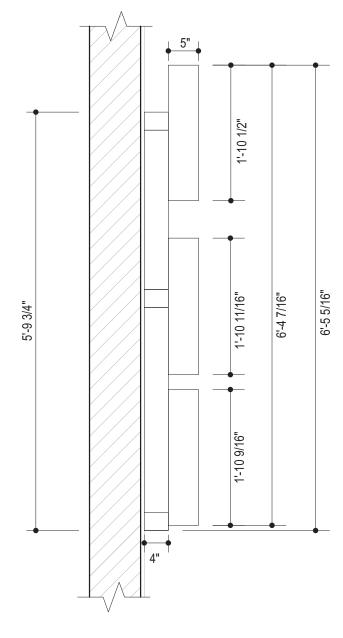

Section Through Centerline

Scale: 3/4" = 1' @ 11X17

CLIENT:	Bonefish Gril		
LOCATION:	Madison, WI		
DATE:	10.14.13		STORE #
DRAWING #	BON-Madiso	n-Tablet60	
DRAWN BY:	СВ	APPROVED BY:	SHEET SIZE 11 x 17

REV# DESCRIPTION DATE BY	THIS DESIGN IS SUBMITTED AS PART OF OUR PROPOSAL AND IS TO REMAIN OUR PROPERTY EXCLUSIVELY UNTIL ACCEPTED AND APPROVED BY PURCHASE.					
	74 TROVES BTT GROWNEE.	REV#	DESCRIPTION	DATE	BY	L



THIS SIGN IS INTENDED TO BE INSTALLED IN ACCORDANCE WITH THE REQUIREMENTS OF ARTICLE 600 OF THE NATIONAL LECTRICAL CODE AND / OR OTHER APPLICABLE LOCAL CODES. THIS INCLUDES PROPER GROUNDING AND BONDING OF THE SIGN.

CUSTOMER APPROVAL:

PERMANENT ACCESS TO THE BAG THE WALL IS REQUIRED FOR INST AND WIRING OF THE SIGN. IF IT IS **NOT** AVAILABLE IT MUST B DATE: APPROVAL RECEIVED BY UNITED


IMPORTANT:	United
PERMANENT ACCESS TO THE BACK SIDE OF THE WALL IS REQUIRED FOR INSTALLATION	Sign
AND WIRING OF THE SIGN. IF IT IS NOT AVAILABLE IT MUST BE PROVIDED	Systems
BY THE CUSTOMER BEFORE INSTALLATION.	Dysteins .

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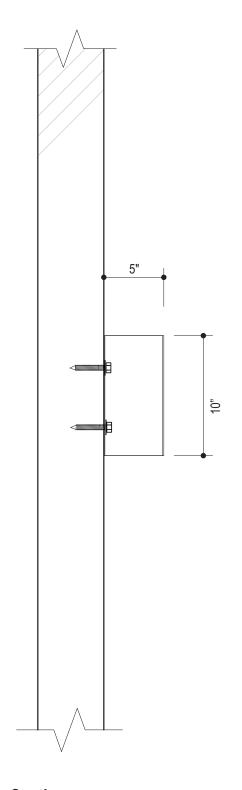
Elevation

Scale: 1 1/2" = 1' @ 11X17



Mounting

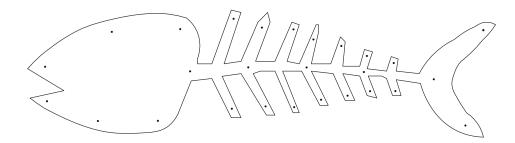Scale:1 1/2" = 1' @ 11X17



Section Scale: 1 1/2" = 1' @ 11X17

Painted Aluminum 5

BON- 2.7 SQFT LOGO 10" X 39" = 2.7 SQFT

Section "A-A" Scale: 3" = 1' @ 11X17

CLIENT:	Bonefish Grill	, and the second
LOCATION:	Madison, WI	
DATE:	10/15/13	STORE #
DRAWING #	BON-2.7SQFT-LOGO	
DRAWN BY:	DD	SHEET SIZE

THIS DESIGN IS SUBMITAS PART OF OUR PROPO AND IS TO REMAIN PROPERTY EXCLUSIV UNTIL ACCEPTED APPROVED BY PURCHAS

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ASE.	REV#	DESCRIPTION	DATE	BY	



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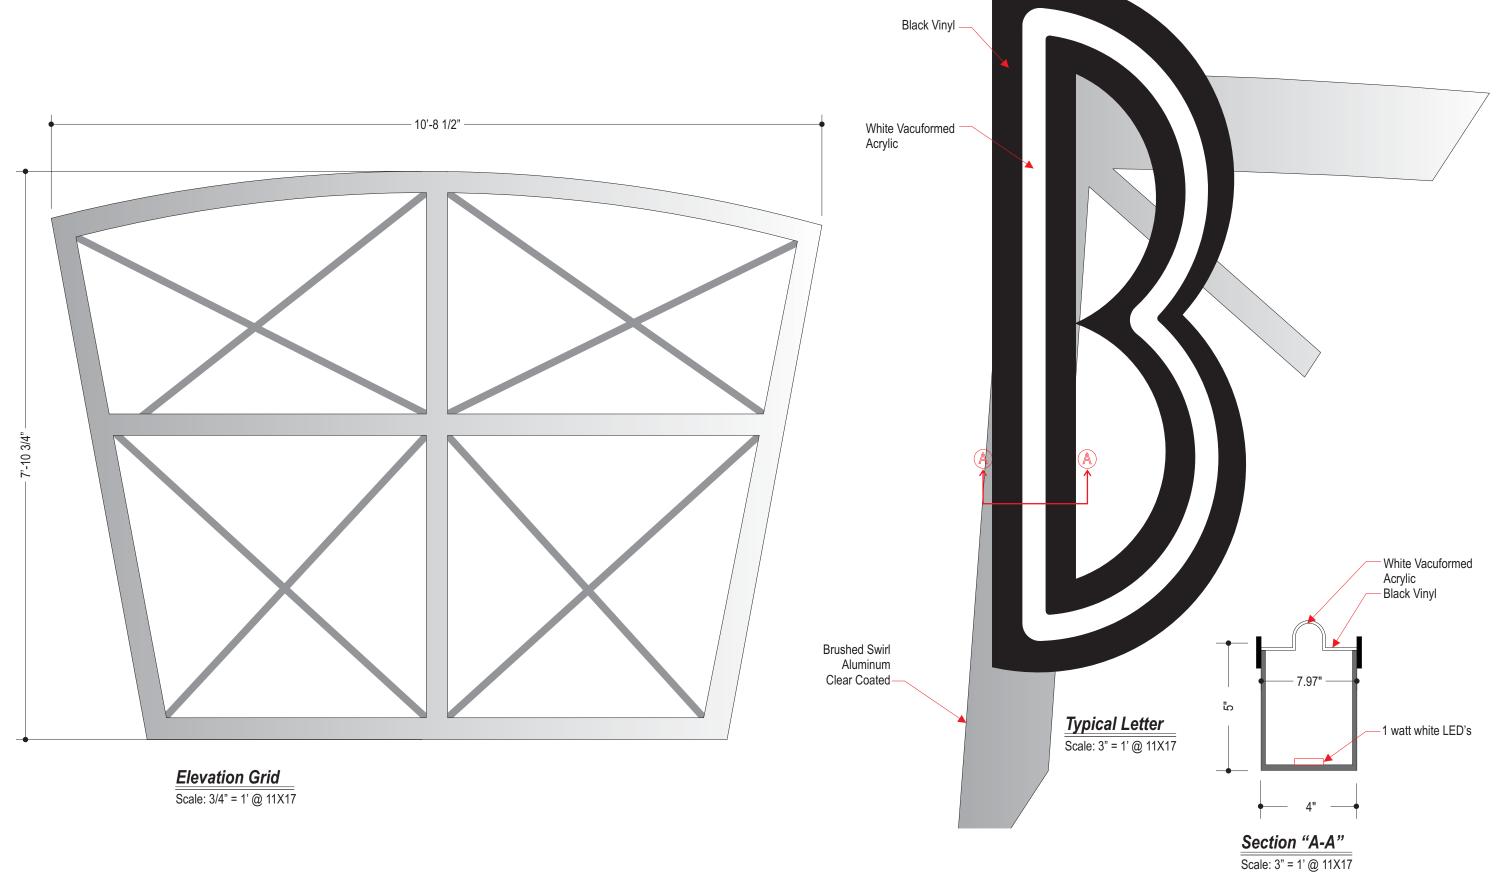
CUSTOMER APPROVAL:

IMPORTANT:

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IF IT IS NOT AVAILABLE IT MUST BE PROVIDED BY THE CUSTOMER BEFORE INSTALLATION. SIGNATURE DATE: APPROVAL RECEIVED BY UNITED



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CLIENT: Bonefish Grill LOCATION: Various DATE: 6-04-13 DRAWING # BFG-Tablet-NEW 2 SHEET SIZE DRAWN BY: AGG

THIS DESIGN IS SUBMITTED AS PART OF OUR PROPOSAL AND IS TO REMAIN OUR PROPERTY EXCLUSIVELY INTIL ACCEPTED AND APPROVED BY PURCHASE.					
	#1	Added 75sqft Tablet	11/12/10	JJM	
	REV#	DESCRIPTION	DATE	BY	
					7



THIS SIGN IS INTENDED TO BE INSTALLED IN ACCORDANCE WITH THE REQUIREMENTS OF ARTICLE 600 OF THE NATIONAL ELECTRICAL C O D E AN D / O R O T HE R APPLICABLE LOCAL CODES. THIS INCLUDES PROPER GROUNDING AND BONDING OF THE SIGN.

CUSTOMER APPROVAL:

SIGNATURE


DATE: APPROVAL RECEIVED BY UNITED

IMPORTANT:

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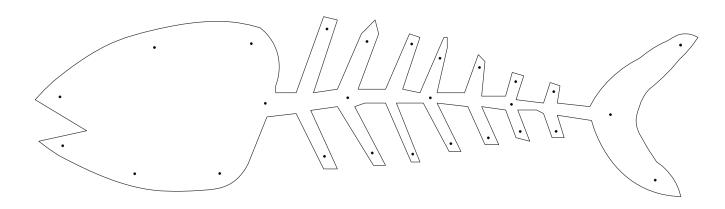


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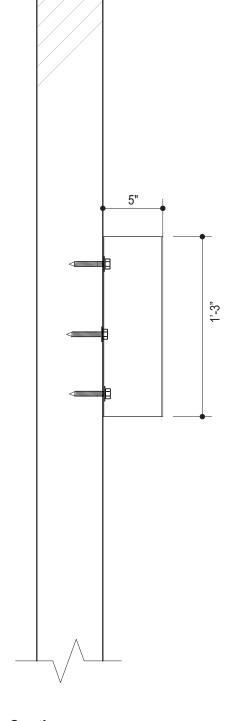
Elevation

Scale: 1 1/2" = 1' @ 11X17

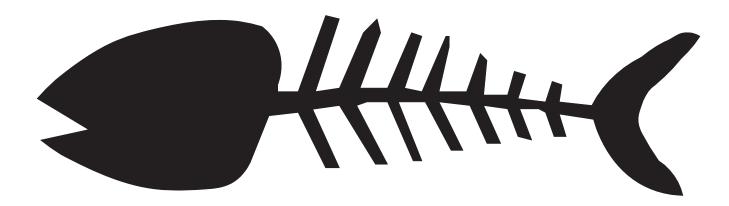


Mounting

Scale: 1 1/2" = 1' @ 11X17



Section

Scale: 1 1/2" = 1' @ 11X17

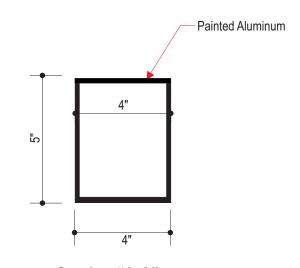

Section "A-A" Scale: 3" = 1' @ 11X17

CLIENT:	Bonefish Grill	
LOCATION:	Madison, WI	
DATE:	10/15/13	STORE #
DRAWING #	BON-6SQFT-LOGO	
DRAWN BY:	DD	SHEET SIZE

THIS DESIGN IS SUBMITTED AS PART OF OUR PROPOSAL
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PROPERTY EXCLUSIVELY UNTIL ACCEPTED AND
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CUSTOMER APPROVAL:

DATE:


IMPORTANT:

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IF IT IS NOT AVAILABLE IT MUST BE PROVIDED BY THE CUSTOMER BEFORE INSTALLATION. SIGNATURE APPROVAL RECEIVED BY UNITED



206 Tower Drive Oldsmar, Florida 34677 unitedsignsystems.com

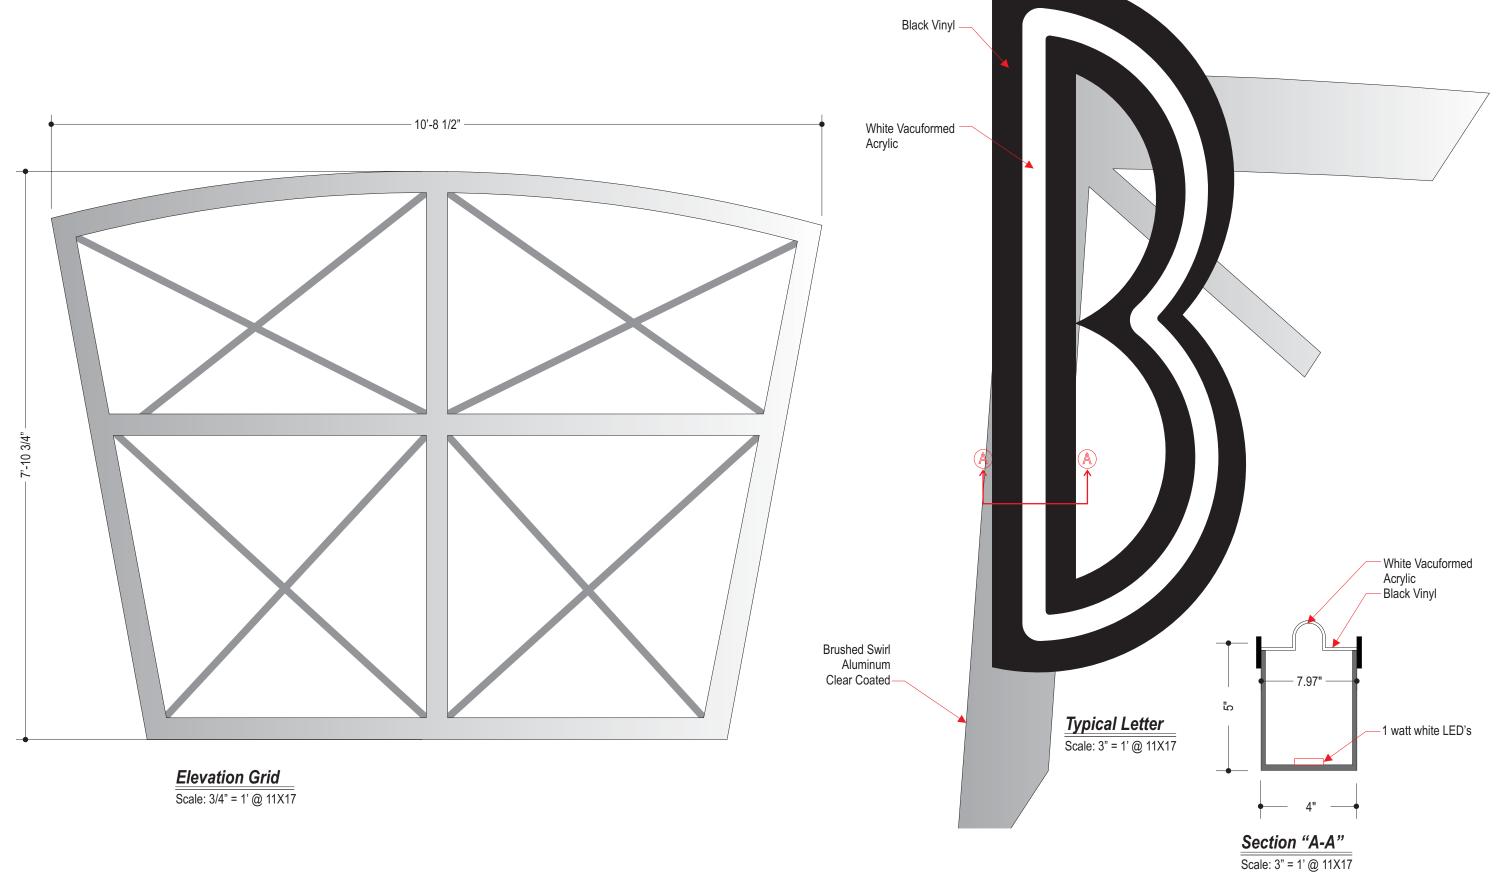

CLIENT: Bonefish Grill LOCATION: Various DATE: 6-04-13 DRAWING # BFG-Tablet-NEW 2 SHEET SIZE DRAWN BY: AGG

HIS DESIGN IS SUBMITTED					
AS PART OF OUR PROPOSAL					
AND IS TO REMAIN OUR					
PROPERTY EXCLUSIVELY					
JNTIL ACCEPTED AND APPROVED BY PURCHASE.	#1	Added 75sqft Tablet	11/12/10	JJM	
REFROVED BY FORCHASE.	REV#	DESCRIPTION	DATE	BY	
					7



THIS SIGN IS INTENDED TO BE INSTALLED IN ACCORDANCE WITH THE REQUIREMENTS OF ARTICLE 600 OF THE NATIONAL ELECTRICAL C O D E AN D / O R O T HE R APPLICABLE LOCAL CODES. THIS INCLUDES PROPER GROUNDING AND BONDING OF THE SIGN.

CUSTOMER APPROVAL:

SIGNATURE


DATE: APPROVAL RECEIVED BY UNITED

IMPORTANT:

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BONEFISH GRILL

NIGHT PERSPECTIVE

GENERAL SPECIFICATION:

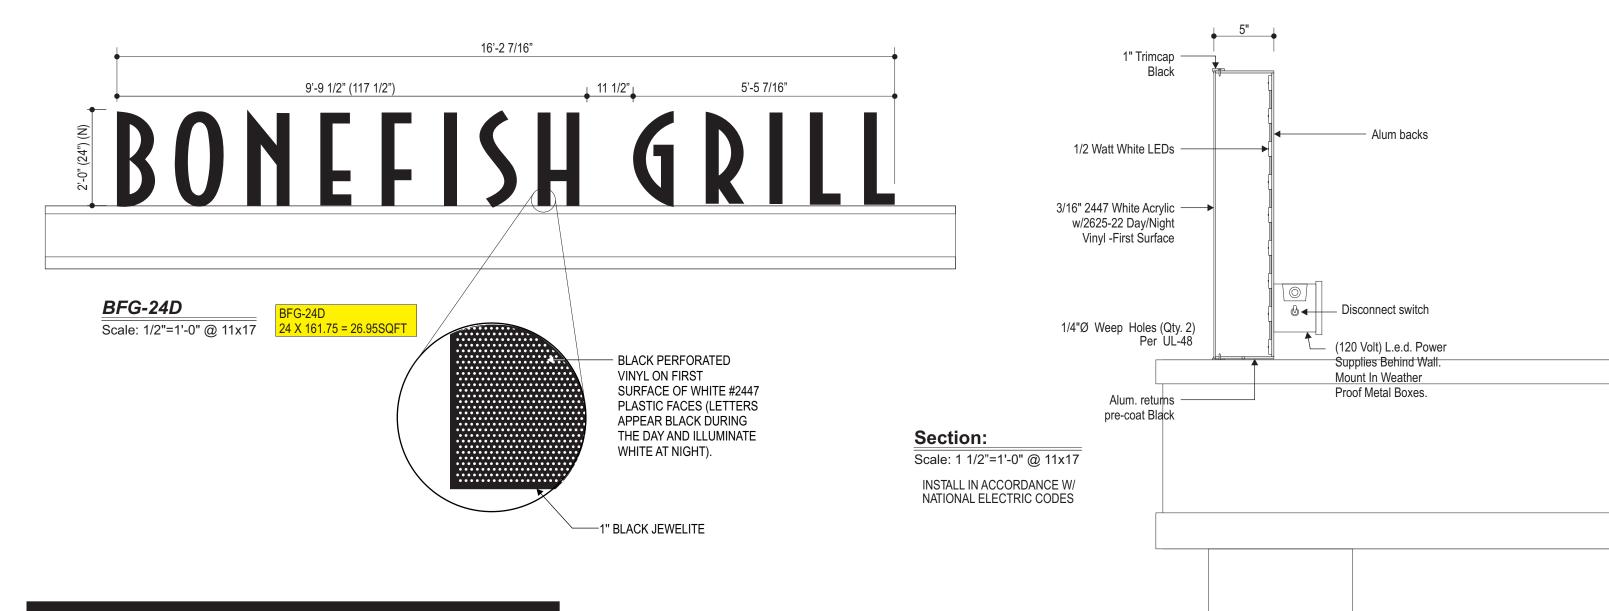-5" DEEP ALUMINUM CHANNEL LETTERS, PRE-COAT BLACK RETURNS. -2447 WHITE ACRYLIC FACE WITH FIRST SURFACE #2625-222 DUAL-COLOR FILM (BLACK

DAY / WHITE NIGHT). RETAIN WITH 1" BLACK TRIMCAP. -ILLUMINATE WITH 1/2 WATT WHITE VENTEX LED'S. REMOTE POWER SUPPLIES AS

REQUIRED.

-MOUNT FLUSH TO FASCIA.

CLIENT:	Bonefish Grill	
LOCATION:	Madison, WI	
DATE:	10.14.13	STORE #
DRAWING #	BON-Madison-24CL	
DRAWN BY:	СВ	SHEET SIZE 11 x 17

THIS DE AS PART AND IS PROPER UNTIL **APPROV**

ESIGN IS SUBMITTED					
T OF OUR PROPOSAL					
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ACCEPTED AND /EDBYPURCHASE.	1	REVISED FROM CITY COMMENTS	10/15/13	DD	
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CUSTOMER APPROVAL:

SIGNATURE

THE WALL IS REQUIRED FOR INSTALLATION DATE: AND WIRING OF THE SIGN. IF IT IS NOT AVAILABLE IT MUST BE PROVIDED BY THE CUSTOMER BEFORE INSTALLATION. APPROVAL RECEIVED BY UNITED


IMPORTANT:


PERMANENT ACCESS TO THE BACK SIDE OF

United Sign **Systems**

206 Tower Drive Oldsmar, Florida 34677

888-704-1516 A Division of United Advantage

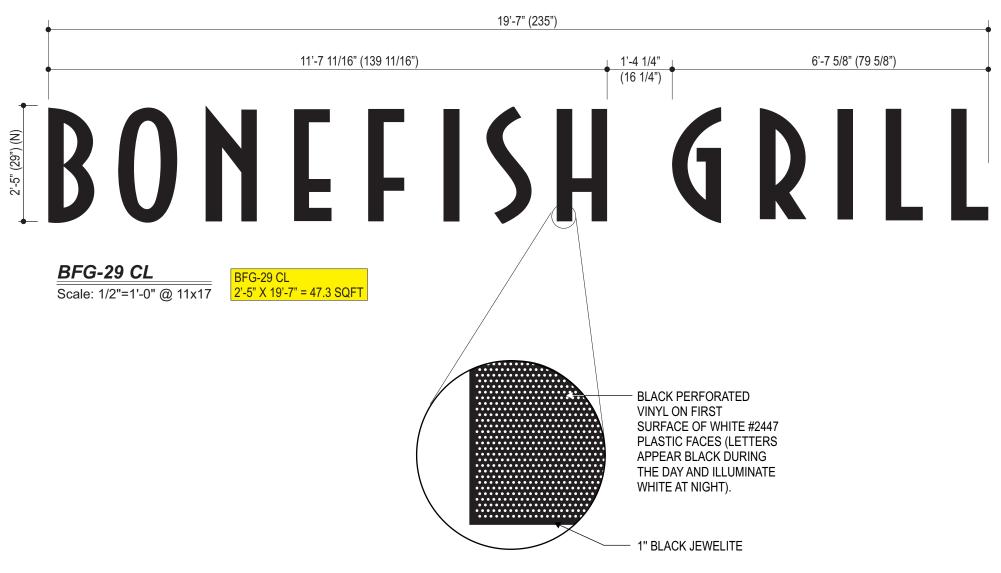

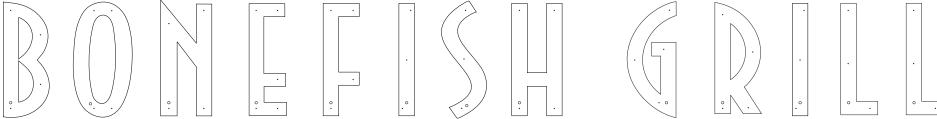

Mounting Detail

Scale: 1/2"=1'-0" @ 11x17

Bonefish Grill

Madison, WI

BON-24D-LED

10.14.13

CB

CLIENT:

DATE:

LOCATION:

DRAWING #

DRAWN BY:

THIS DESIGN IS SUBMITTED AS PART OF OUR PROPOSAL AND IS TO REMAIN OUR PROPERTY EXCLUSIVELY UNTIL ACCEPTED AND APPROVED BY PURCHASE. DESCRIPTION DATE BY



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CUS

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BONEFISH GRILL

NIGHT PERSPECTIVE

CUSTOMER APPROVAL:	IMPORTANT:	United
SIGNATURE DATE:	PERMANENT ACCESS TO THE BACK SIDE OF THE WALL IS REQUIRED FOR INSTALLATION AND WIRING OF THE SIGN.	Sign
APPROVAL RECEIVED BY UNITED	IF IT IS NOT AVAILABLE IT MUST BE PROVIDED BY THE CUSTOMER BEFORE INSTALLATION.	Syster Syster

SHEET SIZE

1" Trimcap Black

1/2 Watt White LEDs

3/16" 2447 White Acrylic w/2625-22 Day/Night Vinyl -First Surface

1/4"Ø Weep Holes (Qty. 2)

Per UL-48

SECTION:

-5" DEEP ALUMINUM CHANNEL LETTERS, PRE-COAT BLACK RETURNS.

DAY / WHITE NIGHT). RETAIN WITH 1" BLACK TRIMCAP.

Scale: N/A=1'-0" @ 11x17

INSTALL IN ACCORDANCE W/

NATIONAL ELECTRIC CODES

-2447 WHITE ACRYLIC FACE WITH FIRST SURFACE #2625-222 DUAL-COLOR FILM (BLACK

-ILLUMINATE WITH ½ WATT WHITE VENTEX LED'S. REMOTE POWER SUPPLIES AS

Alum, returns pre-coat Black

GENERAL SPECIFICATION:

-MOUNT FLUSH TO FASCIA.

REQUIRED.


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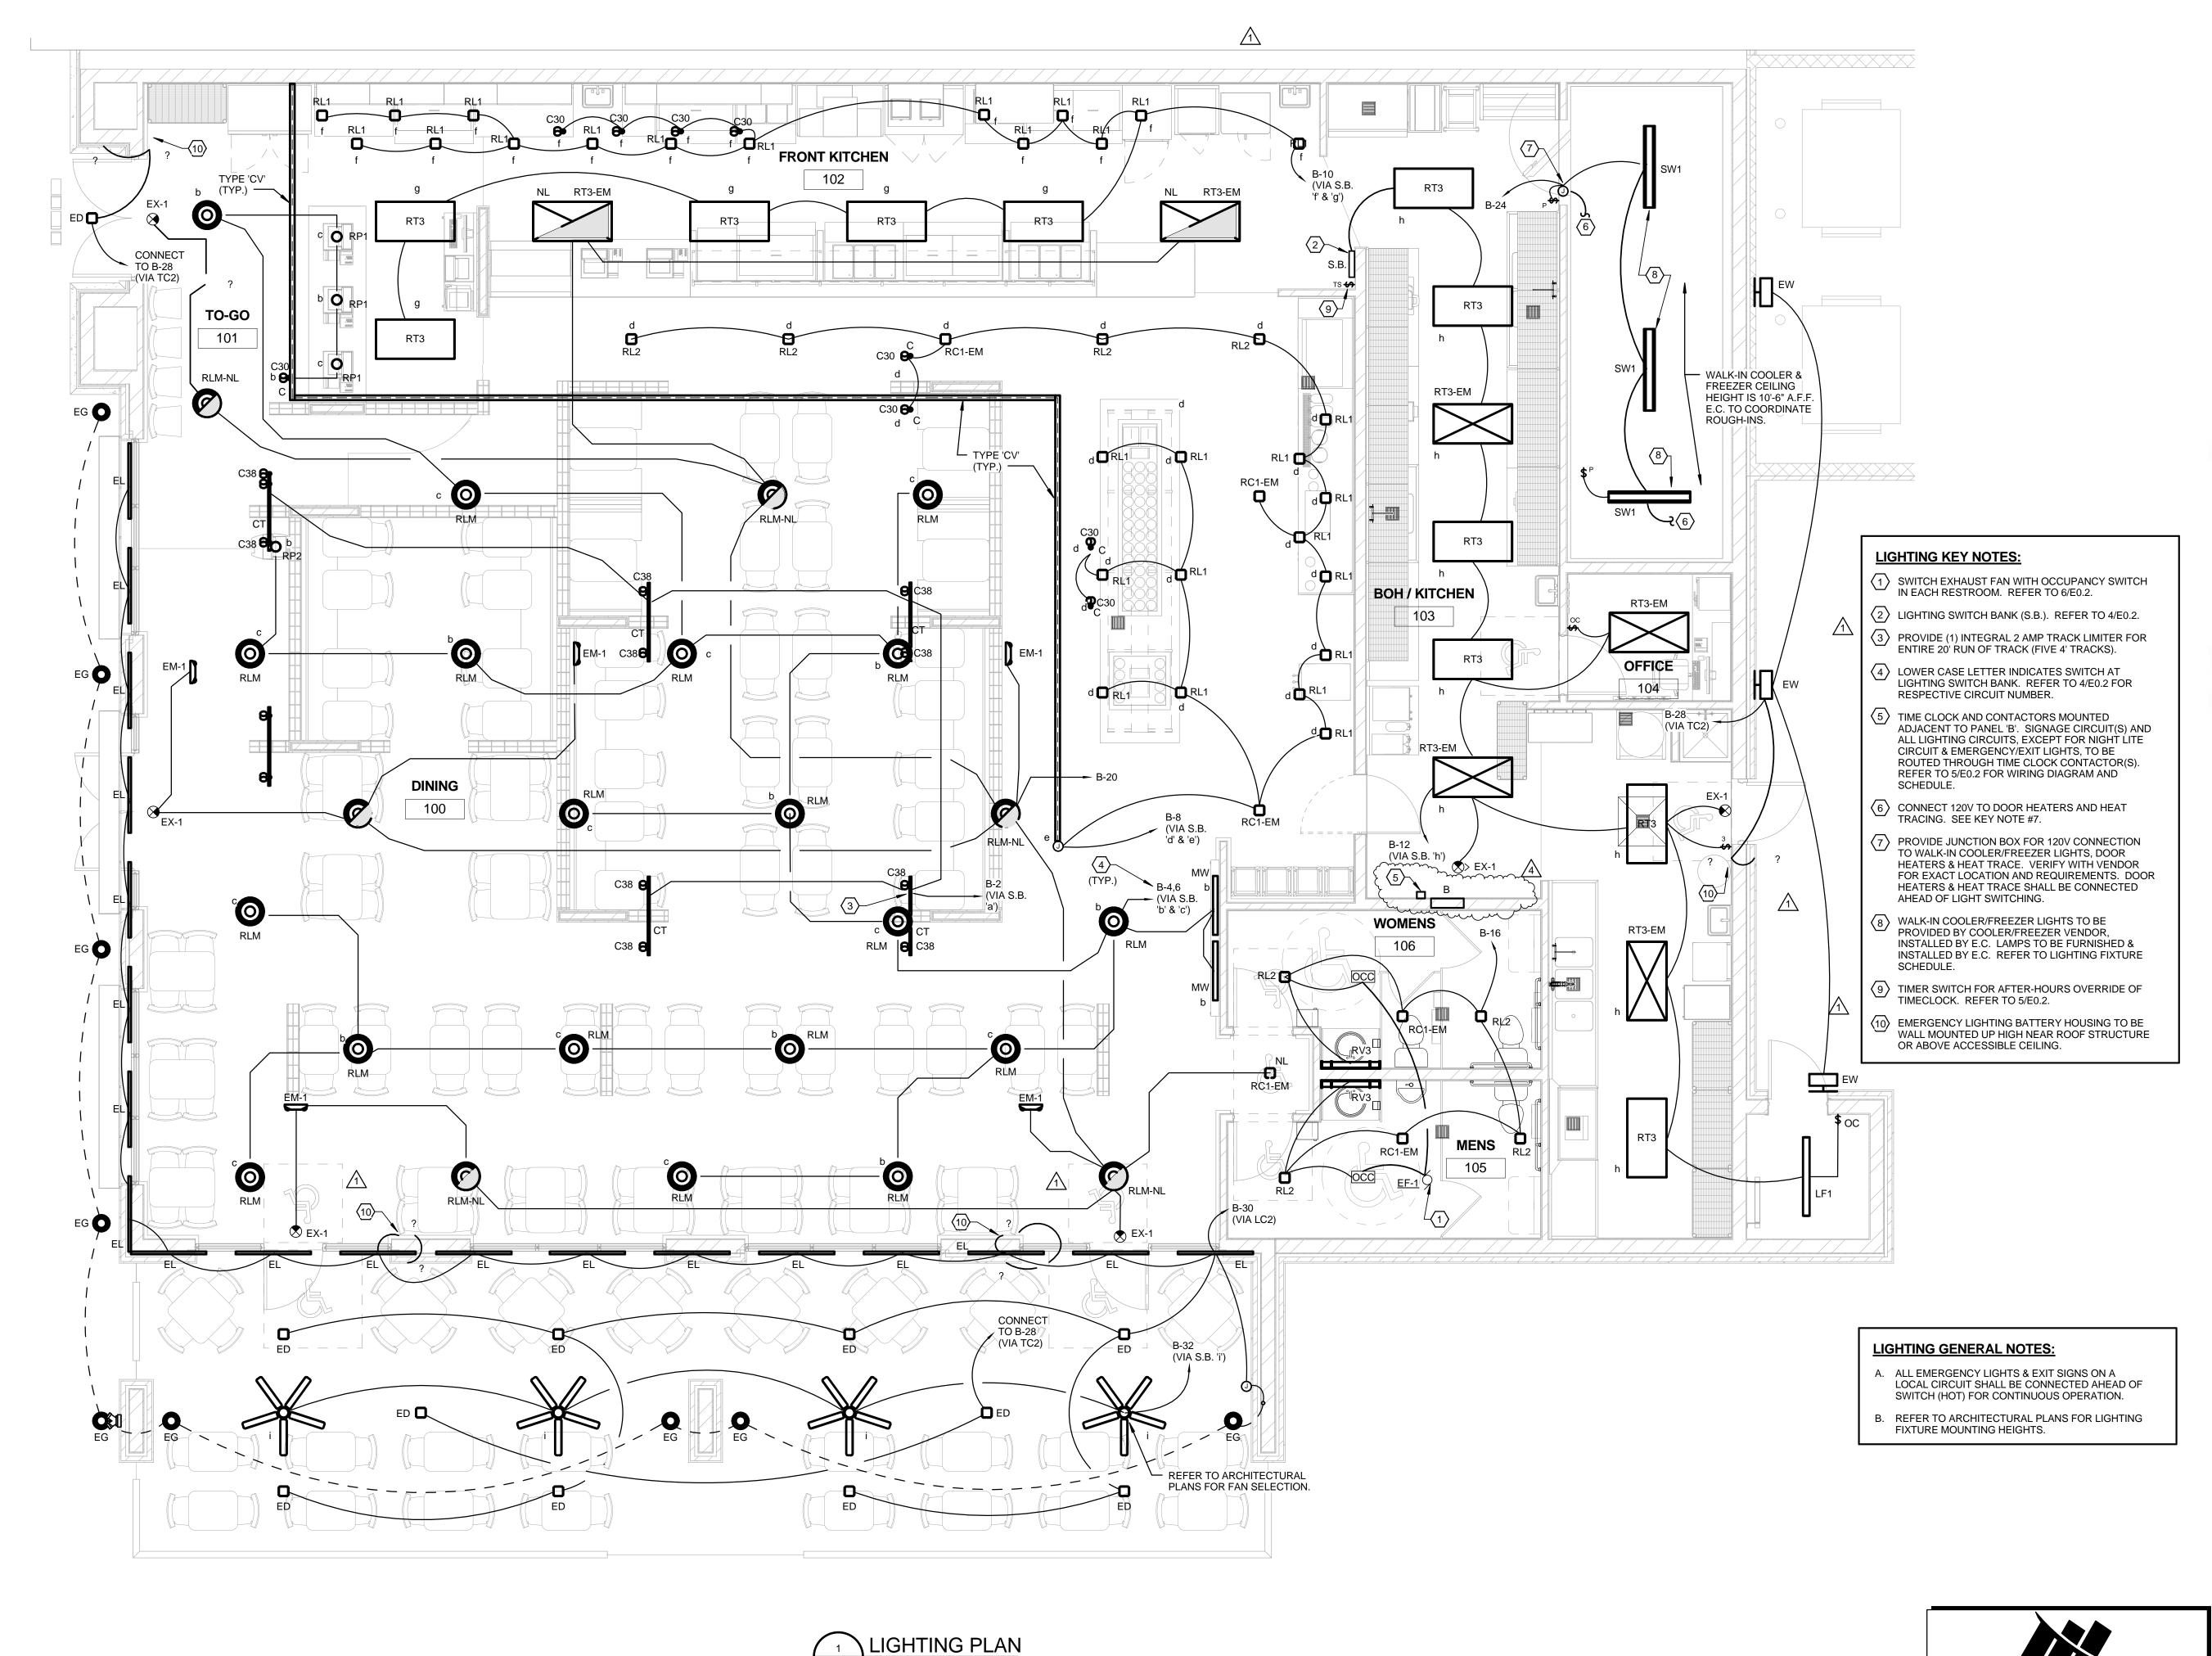
Mounting hardware per wall construction

Alum backs

Disconnect switch

(120 Volt) L.e.d. Power Supplies Behind Wall. Mount In Weather Proof Metal Boxes.



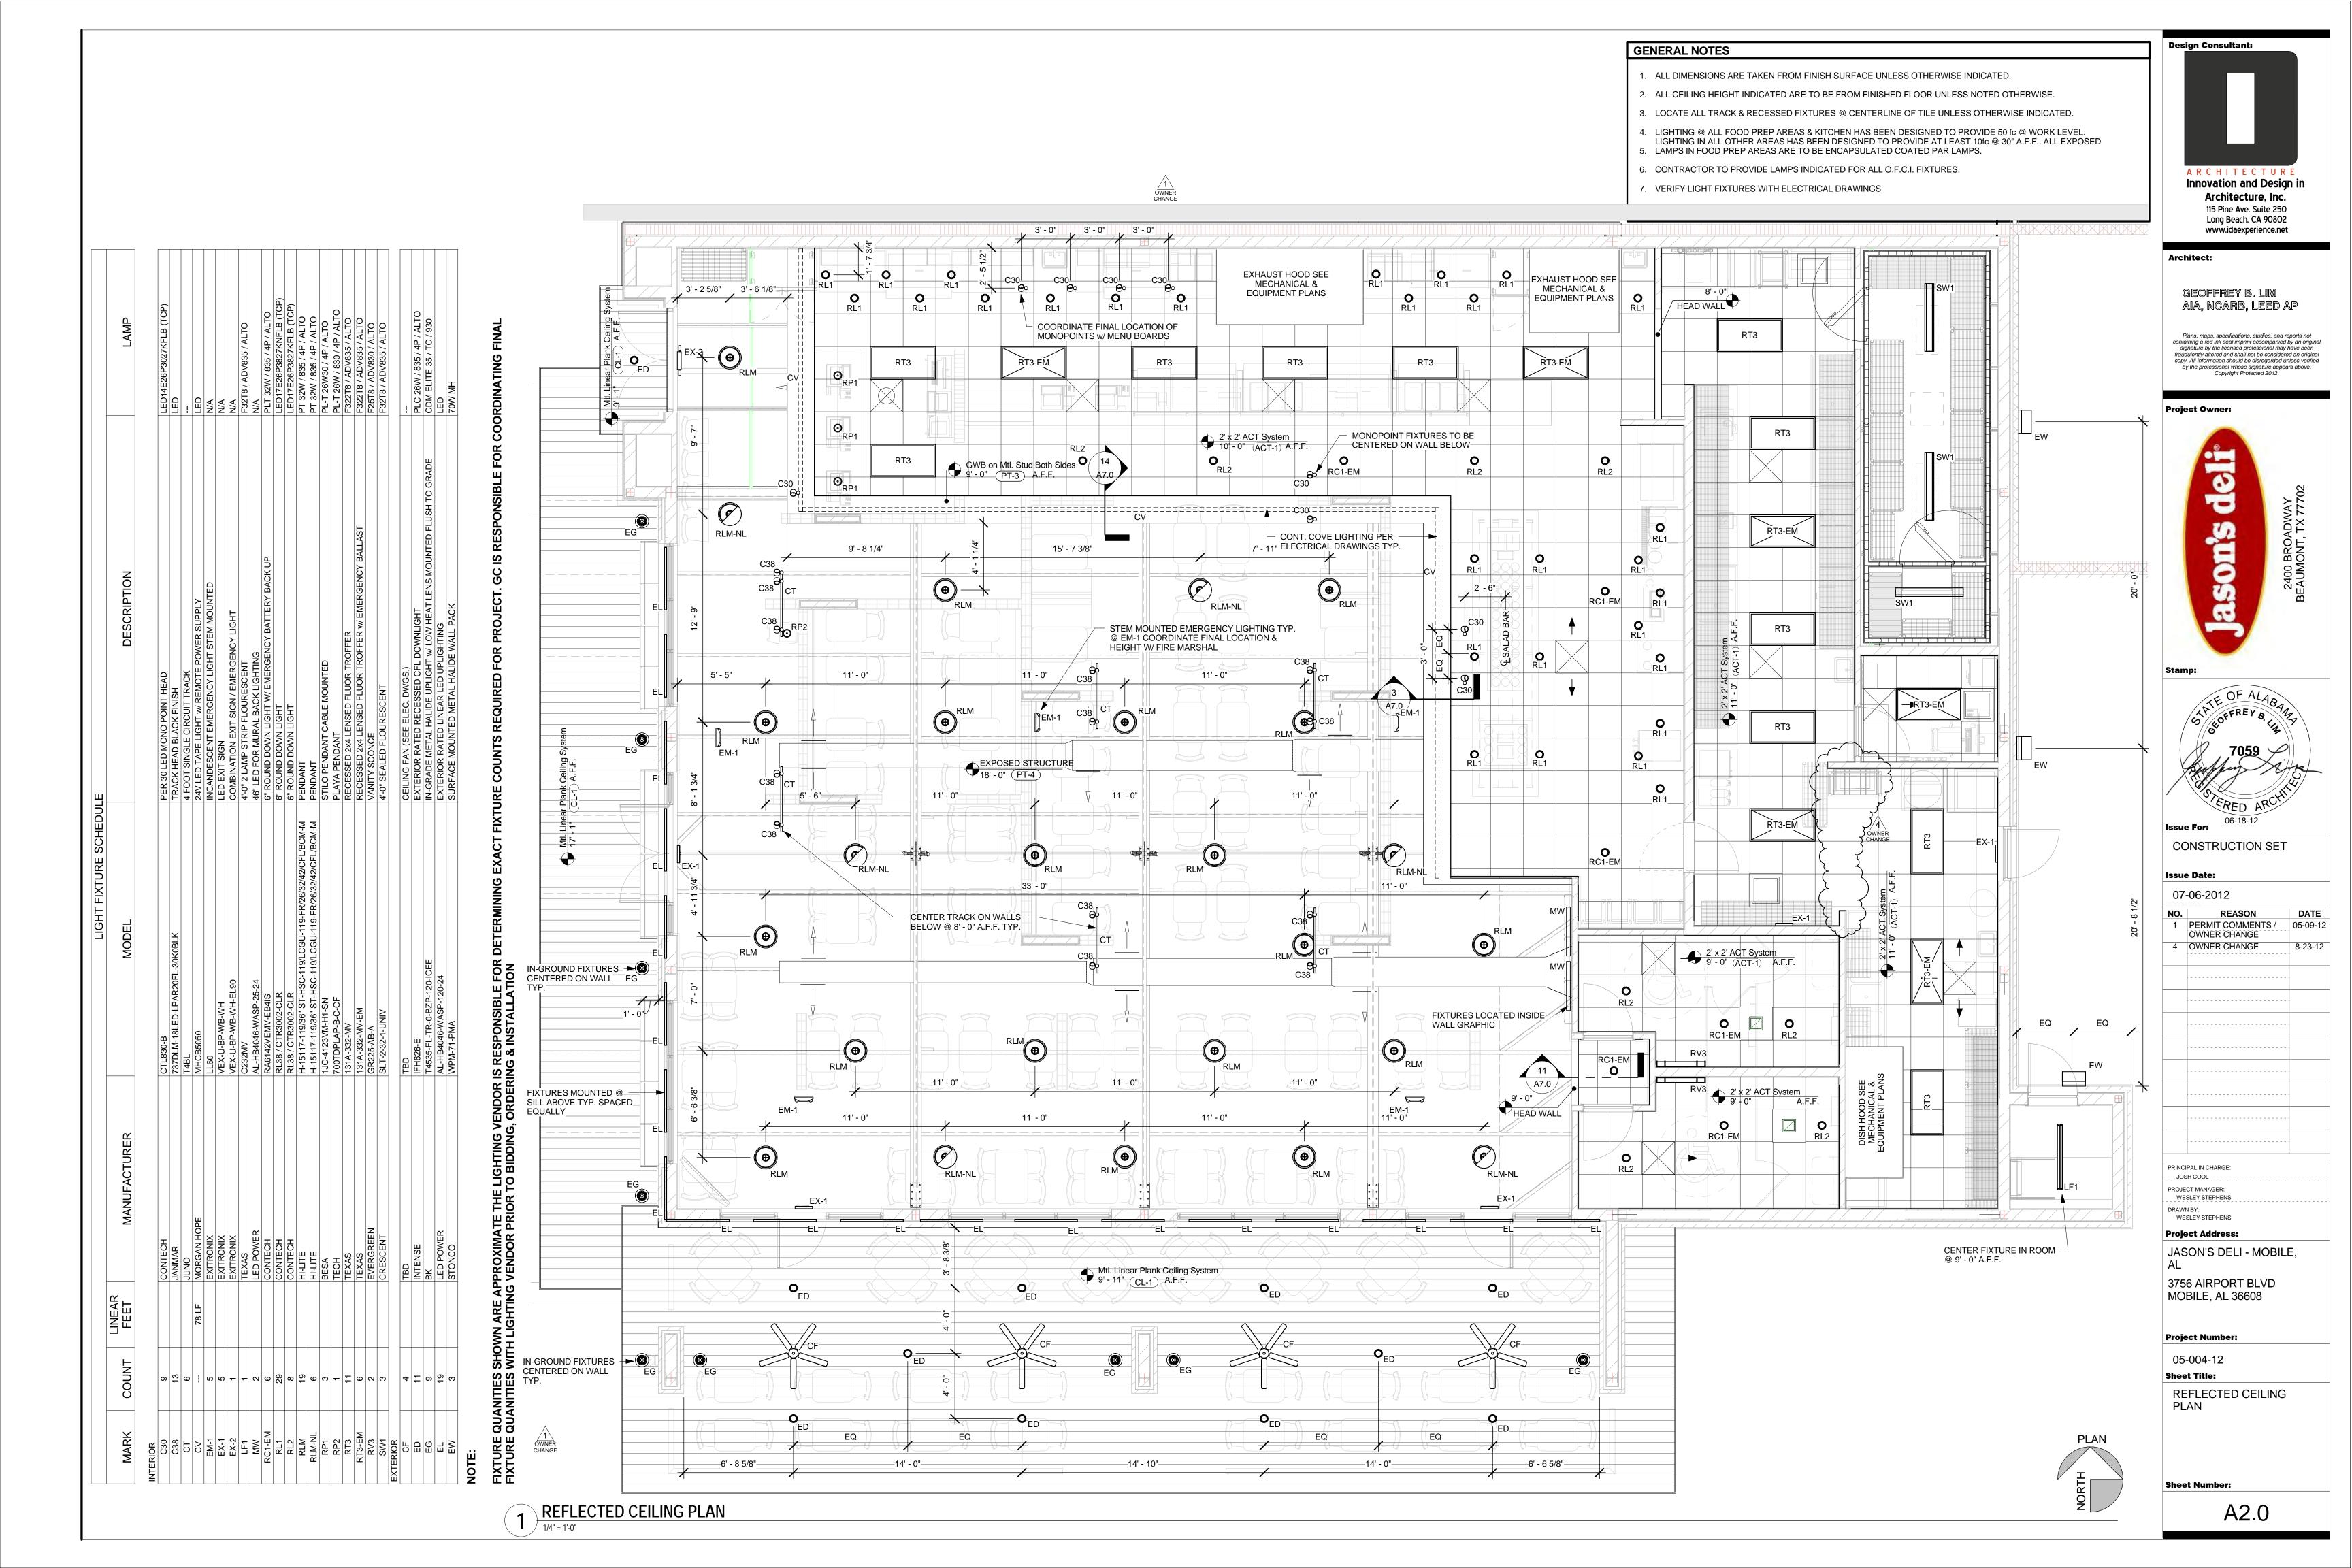

Design Consultant:

ARCHITECTURE
Innovation and Design in

Architecture, Inc.
115 Pine Ave
Suite 250
Long Beach, CA 90802
www.id-ainc.net

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Project Owner



tamp:



Issue For:

CONSTRUCTION SET

Issue Date:

07-06-2012

REVISI		
NO.	REASON	DATE
1	CODE COMMENTS / OWNER CHANGES	05/09/
4	OWNER CHANGE	08/28/

PRINCIPAL IN CHARGE:
Approver
PROJECT MANAGER:
Checker

Project Address:

DRAWN BY: Author

JASON'S DELI - MOBILE, AL

3756 AIRPORT BLVD MOBILE, AL 36608

Project Number:

05-004-12 Sheet Title:

LIGHTING PLAN

Sheet Number:

MCVEIGH & MANGUM ENGINEERING INC

9133 R.G. Skinner Parkway Jacksonville, Florida 32256 EB 6330 Ph: (904) 483-5200 Fax: (904) 636-6700

email: mail@McVeighMangum.com
Eng. of Record: Thomas C. Nielsen License No.:23967

E1.0

ELECTRICAL SYMBOL LEGEND WIRING SYSTEM: CONTINUOUS LINE INDICATES WIRING SYSTEM CONCEALED IN WALL OR CEILING. DASHED LINES INDICATES WIRING SYSTEM RUN BELOW SLAB/GRADE. WIRING SYSTEM: CONTINUOUS LINE INDICATES WIRING SYSTEM TO BE RUN EXPOSED. DASHED LINES INDICATES WIRING SYSTEM RUN BELOW SLAB/GRADE. BRANCH CIRCUIT HOMERUN TO PANEL. NUMBER OF ARROWHEADS INDICATE NUMBER OF CIRCUITS. THREE CIRCUITS OF ALTERNATING PHASES MAY BE COMBINED IN ONE CONDUIT, HOWEVER THEY SHALL EITHER BE EQUIPPED WITH DEDICATED NEUTRALS, COMMON TRIP CIRCUIT BREAKERS, OR HANDLE-TIES ON THEIR CEILING MOUNTED JUNCTION BOX 0 Ю WALL MOUNTED JUNCTION BOX SINGLE POLE SWITCH, 20A, 120/277 VOLT, +48" A.F.F. TO CENTER. "3" INDICATES 3-WAY SWITCH "4" INDICATES 4-WAY SWITCH "OC" INDICATES WALL SWITCH OCCUPANCY SENSOR WITH MANUAL OVERRIDE "P" INDICATES PILOT LIGHT SWITCH "TS" INDICATED TIMER SWITCH CEILING MOUTED INFRARED/ULTRASONIC (DUAL TECHNOLOGY) 360° MOTION SENSOR EQUAL TO WATTSTOPPER DT-300. PROVIDE ALL NECESSARY COMPONENTS TO INSURE PROPER OPERATION (POWER PACKS, SLAVE PACKS, ETC.). DUPLEX RECEPTACLE, 15 AMP, 120 VOLT, +18" A.F.F. TO CENTER. FOR SINGLE RECEPTACLE ON A CIRCUIT, USE A 20A RECEPTACLE "GFI" INDICATES GROUND FAULT PROTECTION "AFI" INDICATES ARC FAULT PROTECTION

"WP" INDICATES WEATHERPROOF "EX" INDICATES EXISTING TO BE REUSED "IG" INDICATES ISOLATED GROUND SHADING INDICATES DEVICE TO BE MOUNTED 6" ABOVE COUNTER TOP BACKSPLASH TO CENTER U.O.N. ALL 15 AND 20 AMP, 125 VOLT RECEPTACLES IN THE KITCHEN AND FOOD PREPARATION AREAS SHALL BE GFCI DOUBLE DUPLEX (QUAD) RECEPTACLE HEAVY DUTY DISCONNECT SWITCH

MOTOR PROVIDED AND INSTALLED BY MECH. CONTRACTOR, WIRED BY ELEC. CONTRACTOR

PANELBOARD, SURFACE OR RECESS MOUNTED. SEE SCHEDULE FOR DETAILS.

2' X 4' FLUORESCENT LIGHTING FIXTURE. SEE FIXTURE SCHEDULE FOR DETAILS. DIAGONAL SHADING INDICATES NIGHT LITE (NL) FIXTURE

SURFACE MOUNTED "ROPE" LIGHTING

NUMERAL INDICATE HORSEPOWER

--

D

PENDANT SHADE FIXTURE. SEE FIXTURE SCHEDULE FOR DETAILS.

RECESSED DOWNLIGHT FIXTURE. SEE FIXTURE SCHEDULE FOR DETAILS. DIAGONAL SHADING INDICATES NIGHT LITE (NL) FIXTURE

MINI PENDANT FIXTURE. SEE FIXTURE SCHEDULE FOR DETAILS.

WALL MOUNTED LIGHT FIXTURE. SEE FIXTURE SCHEDULE FOR DETAILS.

L.E.D. EXIT LIGHT, SHADING INDICATES ILLUMINATED FACE, ARROWS INDICATE CHEVRONS. SEE FIXTURE SCHEDULE FOR DETAILS.

CEILING MOUNTED EMERGENCY EGRESS LIGHT. SEE FIXTURE SCHEDULE FOR DETAILS.

TELEPHONE OUTLET, SAME HEIGHT AS ADJACENT RECEPTACLE, WITH 3/4" CONDUIT STUBBED OUT ABOVE ACCESSIBLE CEILING. "W" INDICATES 60" AFF MOUNTING.

COMPUTER OUTLET, SAME HEIGHT AS ADJACENT RECEPTACLE, WITH 3/4" CONDUIT

STUBBED OUT ABOVE ACCESSIBLE CEILING. "W" INDICATES 60" AFF MOUNTING.

COMBINATION TEL/DATA OUTLET, SAME HEIGHT AS ADJACENT RECEPTACLE, WITH 1" CONDUIT STUBBED OUT ABOVE ACCESSIBLE CEILING.

DOOR BELL FLUSH MOUNTED AT 72" A.F.F.

120V STAND ALONE DUCT SMOKE DETECTOR

CEILING MOUNTED SMOKE DETECTOR

FIRE ALARM PULL STATION

CEILING MOUNTED SMOKE DETECTOR

ELECTRICAL ABBREVIATIONS

A	AMPERE	HT	HEIGHT
A.F.F.	ABOVE FINISHED FLOOR	J.B.	JUNCTION BOX
A.F.G.	ABOVE FINISHED GRADE	KVA	KILOVOLT-AMPERE
AWG	AMERICAN WIRE GAGE	M.C.	MECHANICAL CONTRACTOR
С	CONDUIT	NEC	NATIONAL ELECTRICAL CODE
CB, CKT BKR	CIRCUIT BREAKER	N/L	NIGHT LIGHT
CLG	CEILING	PNL	PANEL
E.C.	ELECTRICAL CONTRACTOR	PVC	POLY-VINYL-CHLORIDE (SCHEDULE 40, U.O.N
ES	ENERGY SAVING	U.O.N.	UNLESS OTHERWISE NOTED.
EMT	ELECTRICAL METALLIC TUBING	V	VOLT
FACP	FIRE ALARM CONTROL PANEL	VA	VOLT-AMPERE
GFI	GROUND FAULT CIRCUIT INTERRUPTER	W	WATT
HOA	HAND-OFF-AUTOMATIC	WP	WEATHERPROOF
HP	HORSEPOWER		

SAFETY SWITCH TYPE SCHEDULE NAME AMPS POLES NEMA NAME AMPS POLES NEMA NAME AMPS POLES NEMA S13 | 100 | 3 S8 200 2 S14 | 100 | 3 S15 | 200 | 3 S4 | 60 | 2 | S16 | 200 | 3 S10 | 30 | 3 | S17 | 30 | 1 S5 | 100 | 2 | S11 | 60 | 3 S12 | 60 | 3 | S18 | 30 | 1

*** NOT ALL SAFETY SWITCHES SCHEDULED MAY APPEAR IN PLANS ***

GENERAL ELECTRICAL NOTES

- ALL ELECTRICAL WORK SHALL BE IN ACCORDANCE WITH THE APPLICABLE EDITION OF THE NATIONAL ELECTRICAL CODE AND ALL LOCAL AND STATE CODES.
- ALL MATERIAL SHALL BE NEW AND SHALL CONFORM TO THE STANDARDS OF THE UNDERWRITER'S LABORATORIES, INC., AND THE NATIONAL MANUFACTURERS ASSOCIATION.
- ALL ELECTRICAL PERMITS AND INSPECTION FEES SHALL BE OBTAINED AND PAID FOR BY THE ELECTRICAL
- DRAWINGS ARE DIAGRAMMATIC ONLY AND INDICATE ONLY THE GENERAL ARRANGEMENT. SEE ARCHITECTURAL DRAWINGS FOR EXACT DIMENSIONS.
- ELECTRICAL CONTRACTOR SHALL GUARANTEE ALL WORK AND MATERIALS FOR ONE YEAR EFFECTIVE THE DAY THE PROJECT IS ACCEPTED BY THE OWNER.
- ELECTRICAL CONTRACTOR SHALL MAKE ALL ELECTRICAL POWER CONNECTIONS TO HVAC, PLUMBING, AND OTHER EQUIPMENT AS REQUIRED.
- A COMPLETE GROUNDING SYSTEM SHALL BE PROVIDED AND INSTALLED IN ACCORDANCE WITH ARTICLE 250
- ALL CUTTING AND PATCHING OF WALLS AND FLOORS FOR ELECTRICAL EQUIPMENT SHALL BE THE RESPONSIBILITY OF THE ELECTRICAL CONTRACTOR.
- ALL WIRING SHALL BE INSTALLED IN GALVANIZED RIGID CONDUIT, INTERMEDIATE METAL CONDUIT, OR EMT EMT SHALL NOT BE USED IN OR UNDER CONCRETE SLABS, OR IN MASONRY WALLS. USE SCHEDULE 40 PVC OUTDOORS WHERE NOT SUBJECT TO PHYSICAL DAMAGE OR BELOW FLOOR SLAB.
- BRANCH CIRCUITS RATED 30 AMPS OR LESS MAY UTILIZE TYPE MC FLEXIBLE METAL CABLE. SUPPORT WITHIN 12" OF ALL CONNECTIONS AND NOT MORE THAN 4'-6" ON CENTER.
- ALL RACEWAYS (EXCEPT THOSE BELOW SLAB OR GRADE) SHALL BE INSTALLED PARALLEL OR PERPENDICULAR TO BUILDING LINES.
- CONDUCTORS SHALL BE COPPER RATED AT NOT LESS THAN 600 VOLTS. MINIMUM SIZE SHALL BE #12 AWG UNLESS OTHERWISE NOTED ON THE DRAWINGS. ALL WIRE #8 AWG AND LARGER SHALL BE STRANDED. ALL CONDUCTORS #10 AND SMALLER SHALL BE SOLID, UNLESS OTHERWISE NOTED.
- FEEDERS RATED GREATER THAN 150 AMPERES MAY UTILIZE 75°C COMPACT ALUMINUM CONDUCTORS OF EQUIVALENT AMPACITY. TYPE XHHW OR XHHW-2 INSULATION. EQUIVALENT TO ALCAN SERIES 8000 CONDUCTORS. CONTRACTOR TO VERIFY CONDUIT SIZES REQUIRED FOR ALUMINUM FEEDERS.
- BRANCH CIRCUIT CONDUCTORS SHALL BE TYPE THHN OR THWN AS REQ'D.
- 12. PROVIDE A PULLWIRE IN ALL EMPTY CONDUITS.

OF THE NEC, AND AS SHOWN ON THE DRAWINGS.

- 13. PROVIDE A TYPED DIRECTORY IN ALL PANELBOARDS CLEARLY DESCRIBING THE LOCATION OF AND TYPE OF LOAD BEING SERVED FOR ALL CIRCUITS.
- PROVIDE ENGRAVED PHENOLIC NAMEPLATES FOR ALL PANELBOARDS AND DISCONNECT SWITCHES, BLACK LETTERS ON WHITE BACKGROUND.
- FUSES 0 600 AMPS SHALL BE UL CLASS "RK-1" LOW PEAK DUAL ELEMENT TIME DELAY WITH 200,000 AMPERE INTERRUPTING RATING AS MANUFACTURED BY BUSS, UNLESS NOTED OTHERWISE.
- VERIFY ALL REQUIREMENTS AND COORDINATE EXACT LOCATION OF INCOMING ELECTRICAL SERVICE WITH OWNER AND LOCAL POWER COMPANY PRIOR TO PROJECT START-UP. NOTIFY ENGINEER OF ANY CHANGES AS MAY BE REQUIRED.
- PROVIDE 1-1/2" CONDUIT FROM TELEPHONE EQUIPMENT ROOM TO CONNECTION POINT AS DIRECTED BY LOCAL TELEPHONE COMPANY.
- 18. ALL TERMINALS, SPLICING CONNECTORS, LUGS, ETC. SHALL BE IDENTIFIED FOR USE WITH THE MATERIAL (CU/AL) OF THE CONDUCTOR AND SHALL BE PROPERLY INSTALLED.
- THE ELECTRICAL CONTRACTOR SHALL BE RESPONSIBLE FOR PROTECTING ALL ELECTRICAL EQUIPMENT FROM FOREIGN MATERIAL DURING CONSTRUCTION (PAINT, SPACKLE, ETC.).
- PENETRATIONS OF REQUIRED SMOKE PARTITIONS SHALL BE SEALED USING METHODS APPROVED UNDER THE STATE BUILDING CODE. COORDINATION WITH THE GENERAL CONTRACTOR SHALL BE MAINTAINED TO INSURE
- WHERE PENETRATIONS ARE MADE THROUGH A REQUIRED FIRE-RESISTIVE WALL, FLOOR, OR PARTITION FOR THE PURPOSE OF RUNNING RACEWAY CARRYING ELECTRICAL, TELEPHONE, TELEVISION, OR LOCAL COMMUNICATION AND/OR SIGNALING CIRCUITS. THE OPENING AROUND THE RACEWAY SHALL BE FIRE STOPPED PER THE STATE BUILDING CODE. COORDINATION WITH THE GENERAL CONTRACTOR SHALL BE

MAINTAINED TO INSURE THAT THIS FIRE STOPPING IS ACCOMPLISHED. USE APPROVED ASSEMBLIES SUCH

- AS THE FOLLOWING: UP TO 1" PENETRATIONS OF 1, 2, 3 & 4 HOUR GYPSUM WALLS - U.L.#WL1001
- UP TO 4" PENETRATIONS OF 1 & 2 HOUR GYPSUM WALLS U.L.#WL1001
- UP TO 4" PENETRATIONS OF 1 & 2 HOUR CONC. OR BLOCK WALLS & FLOORS U.L.#CAJ1009 UP TO 4" PENETRATIONS OF 3 & 4 HOUR CONC. OR BLOCK WALLS & FLOORS - U.L.#CBJ1020
- IN REQUIRED FIRE RATED WALLS AND PARTITIONS, OPENINGS FOR INSTALLATION OF BOXES THAT ARE GREATER THAN 16 SQUARE INCHES SHALL BE PROTECTED AS REQ'D BY U.L. COORDINATE CLOSELY WITH THE GENERAL CONTRACTOR TO INSURE THAT THE INTEGRITY OF THE U.L. RATING IS MAINTAINED.
- UNLESS SPECIFICALLY NOTED AS DEDICATED, HOMERUNS MAY BE COMBINED AS MULTI-WIRE BRANCH CIRCUITS, UNLESS OTHERWISE INDICATED, HOMERUN RACEWAYS SHALL NOT SERVE MORE THAN 3 CIRCUITS. A MAXIMUM OF THREE 20A BRANCH CIRCUITS MAY BE COMBINED IN A COMMON HOMERUN SHARING A COMMON NEUTRAL (PROVIDE CIRCUIT BREAKER HANDLE TIES.) AT CONTRACTOR'S OPTION, SEPARATE NEUTRALS MAY BE PROVIDED FOR MULTI-WIRE BRANCH CIRCUITS FOR A MAXIMUM TOTAL OF SIX CURRENT CARRYING CONDUCTORS IN THE RACEWAY (NO HANDLE TIES REQUIRED.) UNLESS OTHERWISE NOTED, ALL BRANCH CIRCUITS LARGER THAN 20A SHALL BE SEPARATELY HOMERUN TO THE PANEL.
- ALL RACEWAYS SHALL BE CONCEALED UNLESS OTHERWISE NOTED AND THAT THE ELECTRICAL CONTRACTOR SHALL BE RESPONSIBLE FOR ALL COSTS ASSOCIATED WITH CONCEALING RACEWAYS AFTER (INITIAL) BLOCK CONSTRUCTION.

HVAC CONDITIONING UNIT ELECTRICAL CONNECTION SCHEDULE

DESIGNATION	RTU-1	RTU-2	RTU-3
TONNAGE	10	10	10 3
VOLTAGE/PHASE	208V/3PH	208V/3PH	208V/3PH
MIN. CIRCUIT AMPACITY (MCA)	47.2	47.2	47.2
MAX FUSE SIZE (AMPS)	(60	60	, 60
SERVING PANEL-CIRCUIT	MDP-1,3,5	MDP-2,4,6	MDP-7,9,11
NOTES:	•	•	

NON-FUSED DISCONNECT SWITCHES ARE FACTORY PROVIDED.

LIGHTING FIXTURE SCHEDULE MARK | MANUFACTURER CATALOG NUMBER DESCRIPTION MONOPOINT CANOPY, BLACK FINISH CON-TECH LA-18-B N/A N/A SURFACE LED14E26P30-14W PAR30 LED TRACK HEAD, BLACK FINISH, C30 CON-TECH CTL830-B - LF20-CL CANOPY 27KFL [TCP] NOTE 1 MONOPOINT MTD, TEMPERED GLASS LENS LED17E26P38-17W PAR38 LED TRACK HEAD, BLACK FINISH, C38 CON-TECH TRACK CTL838/2-B NOTE 14 27KNFLB [TCP] TRACK MOUNTED TRACK: LT-4-B 4' SINGLE CIRCUIT TRACK, POWER SUPPLY, CON-TECH POWER FEED: LA-8-B N/A 120 N/A SUSPENDED CONNECTOR, BLACK FINISH SEE NOTES 1 & 2 CONNECTOR: LA-2-B LED TAPE LIGHT, 24V CV MORGAN HOPE 1.6W/FT COVE MHCB5050 LED RECESSED | 1-LAMP, 6" CFL DOWNLIGHT, HORIZONTAL HOUSING: IFH626-F TRIM: IC610C PLC 26W/835/ INTENSE ELEC 30 FLAT BAR HANGERS: IC200 4P/ALTO LAMP, DAMP LABEL IN-GROUND 1-LAMP, IN-GRADE UPLIGHT, INTEGRAL CDM ELITE **BK LIGHTING** HP2-T4535-FL-TR-0-BZP-120-ICEE BALLAST, METAL HALIDE, SEE NOTE 15 35/TC/930 LINEAR UPLIGHTING LED, 2800K, 120 DEGREE LED POWER AL-HB4046-WASP-120-24 LED 32 SURFACE BEAM SPREAD, WET LABEL, SEE NOTES 2 & 16 1-LAMP, SURFACE MOUNTED METAL HALIDE HPF 85 STONCO WPM-71-PMA-8 70W MH WALL WALL PACK, OPEN FACE -32T8/ADV835/ 2-LAMP, 4' STRIP LIGHT CRESCENT ELEC 58 SCF232BK2Y ALTO FIXTURE: AL-HB4046-WASP-25-24 46" LED WALL WASHER, 2800K, 25 DEG BEAM COVE LED POWER BRACKET: AL-HB40 LED POWER SUPPLY: PS-LEDINTA-0024V-41FO RECESSED | 6" CFL DOWNLIGHT, SEMI-DIFFUSED WITH HOUSING: RA6142VEMC-EB4IS 32W/835/4P/ CON-TECH ELEC 35 TRIM: CTR6322V-CLR ALTO 90 MINUTE BATTERY BACK-UP HOUSING: RL38 LED17E26P38-6" DOWNLIGHT, PAR38 LED LAMP, NARROW CON-TECH TRIM: CTR3002-CLR 27KNFL [TCP] NOTE 14 FLOOD, FIXTURE TO BE LENSED RECESSED 6" DOWNLIGHT, PAR38 LED LAMP HOUSING: RL38 LED17E26P38-RL2 CON-TECH TRIM: CTR3002-CLR 27KFL [TCP] NOTE 1 H-15117-119/36"ST-HSC-119/LCGU-119-PENDANT SHADE CFL, STEMS TO BE RIGID RLM HI-LITE 32W/835/4P/ PENDANT ELEC 35 FR/26/32/42/CFL/BCM-M ALTO PENDANT/ MINI PENDANT CFL 26W 4-PIN BESA 1JC-412318-H1-SN ELEC CFL CABLE PL-T26W/830/ PENDANT/ MINI PENDANT CFL RP2 TECH ELEC 700TDPLAP-B-S-CF 4P/ALTO CABLE RECESSED | 3-LAMP, 2x4 LENSED TROFFER -32T8/ADV835/ RT3 TEXAS 131A-332-MV ELEC ALTO F32T8/ADV835/ SAME AS TYPE RT3 EXCEPT WITH 90 MINUTE RT3-EM TEXAS 131A-332-MV-EM14 ELEC **RECESSED** 88 ALTO BATTERY BACK-UP 2-LAMP, 3' VANITY SCONCE RV3 **EVERGREEN** GR225-AB-A ELEC SURFACE 25W T8 F32T8/ADV835/ 2-LAMP, INDUSTRIAL FLUORESCENT, VAPOR ELEC SURFACE CRESCENT SLT2321UNIV 58 ALTO TIGHT, SEE NOTE 3 **EMERGENCY LIGHT WITH 90 MINUTE BATTERY** EM-1 EXTRONIX LL60 WALL 5.4W 20 HOUSING: LED-90 BL (NOTE 17) REMOTE EMERGENCY DUAL HEAD UNIT WITH

CATALOG NUMBERS AND MANUFACTURERS ARE TO INDICATE TYPE AND QUALITY OF FIXTURE DESIRED. SUBMIT CUTSHEETS OF ALTERNATE MANUFACTURERS FOR ARCHITECT AND OWNER APPROVAL PRIOR TO PURCHASE OF ANY FIXTURES. ALL FLUORESCENT LAMPS SHALL BE ENERGY SAVING TYPE. ALL INCANDESCENT LAMPS SHALL BE 130V RATED.

LED

LED

LIGHTING FIXTURE SCHEDULE NOTES:

EXTRONIX

EXTRONIX


EM-2

EX-1

- REFER TO LIGHTING PLAN FOR QUANTITY OF TRACK TO DETERMINE TYPES AND QUANTITY OF LIVE END FEEDS & CONNECTORS REQUIRED. E.C. TO DETERMINE TYPES AND QUANTITIES OF LIVE END FEEDS, CONNECTORS, POWER SUPPLIES, MOUNTING HARDWARE, ETC. FOR SYSTEM TO FUNCTION PROPERLY.
- COORDINATE MOUNTING OF FIXTURE INSIDE EQUIPMENT BY OWNER.
- PROVIDE 60W LED DRIVER FOR COVE RUNS UP TO 26 FEET. PROVIDE 90W LED DRIVER FOR COVE RUNS UP TO 38 FEET. FIELD VERIFY OVERALL LENGTH REQUIRED IN FIELD PRIOR TO ORDERING. PROVIDE ALL COMPONENTS NECESSARY FOR COMPLETE AND WORKING OPERATION.
- PROVIDE LENGTH(S) OF FIXTURES AS REQUIRED FOR CONTINUOUS MOUNTING. UTILIZE MAXIMUM FIXTURE LENGTH ALLOWABLE IN LINEAR RUNS TO MINIMIZE QUANTITY OF FIXTURES
- AND BALLASTS. PROVIDE ALL COMPONENTS NECESSARY FOR COMPLETE AND WORKING OPERATION. MOUNT BOTTOM OF RLM FIXTURE AT 10'-0" A.F.F.. COORDINATE MOUNTING AS REQUIRED WITH EXISTING STRUCTURAL CONDITIONS AND
- PROPOSED HVAC LAYOUTS. VERIFY EXACT PENDANT LENGTHS IN FIELD WITH ELECTRICAL CONTRACTOR PRIOR TO ORDERING SO THAT DESIRED HEIGHT IS ATTAINED. MOUNT FIXTURE AT HEIGHT AS INDICATED ON ARCHITECTURAL DRAWINGS, OR AS INDICATED IN FIELD BY ARCHITECT. RP1 FIXTURES SHALL BE CENTERED ON BOOTH TABLES. COORDINATE MOUNTING OF FIXTURE INSIDE EQUIPMENT BY OWNER.
- PROVIDE SINGLE OR DOUBLE FACE UNITS, WITH ARROW(S) AS INDICATED ON PLANS. COORDINATE WALL OR CEILING MOUNTING WITH LOCATION(S) INDICATED ON DRAWINGS AND
- AS REQUIRED BY FIELD CONDITIONS, WALL MOUNT SHALL BE ABOVE DOOR AT 7'-6" A.F.F. DOWN RODS FOR FIXTURES RLM TO BE RIGID CONDUIT SUPPLIED BY GENERAL CONTRACTOR AND PAINTED TO MATCH CEILING FINISH.
- COORDINATE EXACT COLOR OF FIXTURE WITH JASON'S DELI REPRESENTATIVE.
- PROVIDE '14 WATTS MAX' LABEL.
- PROVIDE '17 WATTS MAX' LABEL.
- IN-GRADE LIGHT FIXTURE TO BE MOUNTED FLUSH TO GRADE. PROVIDE (1) 100W POWER SUPPLY FOR EACH (2) FIXTURES.
- 17. ORDER 'LED-90 BL' LESS HEADS. UNIT IS TO OPERATE REMOTED HEADS AS SHOWN ON 1/E-1.0.

REMOTE HEADS: 2HLED

VEX-U-BP-WB-WH

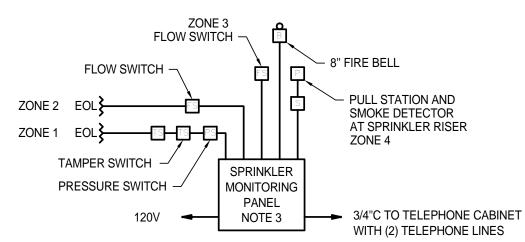

(MONITORING) SPRINKLER ALARM RISER DIAGRAM E0.0 NOT TO SCALE

SPRINKLER ALARM SYSTEM NOTES:

- ALARM DEVICES ARE TO BE INSTALLED IN ACCORDANCE WITH NFPA 72 AND ADA.
- ACTUATION OF ANY PULL STATION, FLOW SWITCH OR SMOKE DETECTOR SHALL ACTIVATE ALARM.
- MONITORING SYSTEM SHALL BE A COMPACT MULTIFACETED STAND-ALONE COMMUNICATOR WITH FOUR SUPERVISED MONITORING CHANNELS AND TWO MODULAR PHONE CONNECTIONS (RJ31X OR RJ38X JACKS) WHICH SHALL BE CONSTANTLY SUPERVISED FOR PROPER VOLTAGE AND CURRENT. (14.5"H X 12.5"W X 2.875" DEEP) (NOTIFIER #411UDAC) OR EQUAL PROVIDE 60 HR. BATTERY STAND-BY.
 - ALL FIRE ALARM SWITCHES, MODULES, AND WIRING SHALL BE PROVIDED BY THE FIRE ALARM SUB-CONTRACTOR. FIRE ALARM SYSTEM SUB-CONTRACTOR SHALL BE RESPONSIBLE TO SUBMIT DETAILED SYSTEM DRAWINGS, CUTSHEETS, WIRING DIAGRAMS, ETC. AS REQUIRED FOR FINAL PERMITTING. ALL COMPONENTS NECESSARY FOR CERTIFICATE OF OCCUPANCY SHALL BE INCLUDED IN THE BID.
 - SEE PLANS FOR MINIMUM NUMBER OF DEVICES.
- ALL TAMPER AND FLOW SWITCH CONNECTION LOCATIONS TO BE FIELD VERIFIED WITH SPRINKLER SUB-CONTRACTOR AS REQ'D.
- COORDINATE DUAL LINE TELEPHONE CONNECTION FOR UL LISTED CENTRAL STATION MONITORING.



90-MIN. BATTERY BACK-UP - SEE NOTE 17

UNIVERSAL | LED EXIT SIGN

Design Consultant: ARCHITECTURE Innovation and Design in Architecture, Inc. 115 Pine Ave Suite 250 Long Beach, CA 90802 www.id-ainc.net

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Project Owner:



Issue For:

CONSTRUCTION SET

Issue Date:

07-06-2012 1 CODE COMMENTS

OWNER CHANGES

3 CODE COMMENTS OWNER CHANGES

PROJECT MANAGER:

Project Address:

DRAWN BY:

JASON'S DELI - MOBILE

3756 AIRPORT BLVD MOBILE, AL 36608

Project Number:

05-004-12

LEGEND, NOTES AND LIGHTING FIXTURE SCHEDULE

E0.0



MILLENIUM FINITE™

PEACE OF MIND











PROJECT INFORMATION

Job Name

Fixture Type

Catalog Number Approved by

FN SERIES – LOW PROFILE

PRODUCT FEATURES:

- » Surface wall mount; 9" & 15"
- » Full cutoff Type II, III, IV or IVN optic patterns
- » Dark-Sky friendly
- » Designlights Consortium listed (DLC)
- » Peace of Mind Guarantee®



SPECIFICATIONS

HOUSING: High-impact resistant, UV-stabilized injection molded polycarbonate. Marine-grade die-cast aluminum ballast/driver housing.

DOOR: High-impact resistant, UV-stabilized injection molded polycarbonate with detachable hinge. Secured to housing with four (4) captive, recessed Torx® (or optional Phillips head) stainless steel screws. Lens sealed with closed-cell silicone gasket and secured to door frame with heavy gauge stainless steel brackets.

GASKETING: Closed cell, silicone "O" ring gasket seals joint between polycarbonate housing and die-cast aluminum ballast housing and joint between polycarbonate housing and polycarbonate lens frame assembly. Thick gauge, die-cut, closed cell neoprene with self-adhesive gasket seals joint between housing and mounting surface or accessory surface conduit adapter.

ELECTRICAL: Flourescent electronic 120/277/347 and dual voltage ballasts high power factor (<10% THD), HID ballasts high power factor. Metal halide lamps utilize pulse start technology. Shock absorbing, medium base lamp sockets provided for HID lamps. See Lamp Type for electronic halide ballast option LED: Replaceable high-brightness ANSI 4000K (65 CRI min.), 5000K (65 CRI min.), and 5700K (70 CRI min.) white LED array. See Options for higher CRI lamp availability.120-277VAC High Power Factor Electronic Dimming Constant Current driver. Luminaire is certified to UL Standards by either Underwriters Laboratory or Intertek Testing Laboratory for wet location.

INSTALLATION: Fixture is factory pre-wired and includes gasketed, 16-gauge stainless steel quick mounting plate. Once four-point mounted to wall (required for Peace of Mind Guarantee®) or accessory surface conduit adapter, allows guick mounting with hook-and-lock mechanism. Quick mounting plate bolts to wall (fasteners by other), fixture attaches to mounting plate with two (2) captive Torx® (or optional Phillips head) screws, which are concealed but accessible from bottom.

SURFACE CONDUIT ADAPTER (ACCESSORY): Marine-grade die-cast aluminum construction includes die-cut gaskets and two 3/4" threaded connection ports. Once four-point mounted to wall (required for Peace of Mind Guarantee®) allows same quick mounting (hook-and-lock) capability as described in the Installation section above.

WARRANTY: One (1) year warranty against defects in materials and workmanship. Five (5) year warranty on LED lamps and driver for defects resulting in a fixture lumen depreciation of 30% or greater.


LISTINGS: Luminaire is certified to UL Standards by either Underwriters Laboratory or Intertek Testing Laboratory for wet location. UL certified IP64 per IEC 60598. IESNA-designated full cut-off. IDA-Approved[™] Dark-Sky Friendly Fixture. Product listed on Designlights Consortium QPL. Photometry tested to the IESNA LM-79-08 standard by an ILAC/ISO17025 accredited laboratory.


FN15L CROSS SECTION **FN9L CROSS SECTION** 8.86" - 9.15 " **←** 9.31"





SURFACE ADAPTER (1) 3/4" (2) 3/4" NPS-2 sides NPS (Not Plugged) (Plugged) 6.25" ŏ < 7.00" 10.65

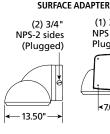

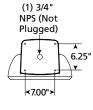

ORDERING INFORMATION

Model Optic System Lens Type	Finish	Oltage Options Accessories
Indel N9L 9" Full Cutoff Low Profile N15L 15" Full Cutoff Low Profile Ipptic System Type II Type III (LED only) Type IV (LED only) (Available with one lamp only on the 15") N Type IV Narrow (LED only)	Lamp Type (Qty/Ballast/Volt/Starting Temp) 9" 26L40K 26 Watt 4000K LED 26L50K 26 Watt 5000K LED 26L57K 26 Watt 5700K LED 18Q 18 Watt Quad (2/RS/120/277,347/0°F) 26P 26 Watt PLT (1,2/RS/120/277,347/0°F) 32P 32 Watt PLT (1/RS/120/277,347/0°F) 15" 26L40K 26 Watt 4000K LED	Lamp Quantity (See Lamp Type) 1 One Lamp 2 Two Lamps Voltage 120 120 Volts 277 277 Volts 347* 347 Volts DV 120-277 Volts (fluorescent or LED only) Options
ens Type .187" Clear Polycarbonate (n/a with two lamps or HID) .250" Clear Tempered Glass (STD w/HID) inish B Dark Bronze MB Matte Black MW Matte White CC Custom Color (Consult factory)	26L50K 26 Watt 5000K LED 26L57K 26 Watt 5700K LED 50L40K 50 Watt 5000K LED 50L50K 50 Watt 5000K LED 50L57K 50 Watt 5700K LED 80L50K 80 Watt 5700K LED 80L50K 80 Watt 5700K LED 80L50K 80 Watt 5700K LED 80L57K 80 Watt 5700K LED 26Q 26 Watt Quad (1,2/RS/120,277,347/0°F) 32P 32 Watt PLT (1,2/RS/120,277,347/0°F) 42P 42 Watt PLT (1,2/RS/120,277,347/-20°F) 50M 50 Watt MH (1/HPF/120,277,347/-20°F) 70M 70 Watt MH (1/HPF/120,277,347/-20°F) 70ME 70 Watt MH (1/EP/120,277,347)-20°F)	LÉL Integral Emergency Battery Backup (Available with FN15L, 26 Watt LED only) Two Circuit Wiring (2 Lamp Quantity only) (n/a in LED) Single Fuse & Holder PH Phillips Head Fasteners QRC Hot/Cold Quartz Restrike (15" only) (HID only) QS2 Two Quartz sockets (max. 50W ea.) (15" only) (HID only) Accessories 50QL 50 Watt DC Bayonet Base Quartz Lamp (15" only) 9500 Torx® Screwdriver SA Die-Cast Surface Adapter * n/a with LED Option





705

70 Watt HPS (1/HPF/120,277,347/-40°F)



Four-Inch Architectural LED Downlight

Product Description

The LR4™ architectural LED downlight delivers up to 540 lumens of exceptional 90+ CRI light while achieving over 51 lumens per watt. This breakthrough performance is achieved by combining the high efficacy and high-quality light of Cree TrueWhite® Technology. The LR4 is available in moderate or deep recess, warm or neutral color temperatures, and has a variety of trim options. It must be used with the Cree $\rm H4$ housing, making the LR4 perfect for use in commercial new construction applications.

Performance Summary

Utilizes Cree TrueWhite® Technology

Active Color Management

Delivered Light Output: LR4E-15: 540 lumens, LR4E-30: 515 lumens

Input Power: LR4E-15: 10.5 watts, LR4E-30: 11.1 watts

CRI: 90

CCT: 2700K, 3500K Warranty: 10 years†

Lifetime: Designed to last 50,000 hours

Dimming: Dimmable to 20%* Shield Angles: 15° or 30°

Ordering Information

Example: LR4E-15 + H4 + LT4-15A OR LR4E-30 + H4 + LT4-30A

Fully assembled luminaire is composed of three components that must be ordered separately: LR4: Light engine H4: Recessed architectural housing LT4: Snap-in architectural trim

LR4E-15

2700K, 15° Shield (Moderate Recess)

LR4E-15C

3500K, 15° Shield (Moderate Recess)

LR4E-30

2700K, 30° Shield (Deep Recess)

LR4E-30C

3500K, 30° Shield (Deep Recess)

Recessed housing with GU24 socket

LT4-15A/LT4-30A

Diffuse anodized finish trim

LT4-15AW/LT4-30AW

Wheat diffuse anodized finish trim

LT4-15AP/LT4-30AP

Pewter diffuse anodized finish trim

LT4-15AB/LT4-30AB

Black anodized finish trim

LT4-15WH/LT4-30WH

Smooth white trim

LT4-15BB/LT4-30BB

Flat black finish trim and reflector


NOTE: Light engine and trim reflector depth must match for appropriate fit.

- * Reference www.cree.com/lighting for recommended dimmers.
- † See www.cree.com/lighting for warranty terms.





LR4E-30

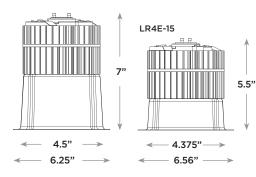


The LR4 downlight ships as three components: a housing, light engine, and trim. Each component must be ordered separately.









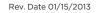



Product Specifications

CREE TRUEWHITE® TECHNOLOGY

A revolutionary way to generate high-quality white light, Cree TrueWhite® Technology mixes the light from the highest performing red and unsaturated yellow LEDs. This patented approach delivers an exclusive combination of 90+ CRI, beautiful light characteristics, and lifelong color consistency, all while maintaining high luminous efficacy—a true no compromise solution.

CONSTRUCTION & MATERIALS

- Durable cold-rolled steel housing protects LEDs, driver and power supply. Adjustable flip clips resist heat while providing retention for flush ceiling fit.
- Thermal management system uses extruded aluminum heat sink to conduct heat away from LEDs and transfer it to the plenum space for optimal performance. LED junction temperatures stay below specified maximum even when installed in attic insulation with ambient temperatures exceeding 60 C.
- Suitable for insulated and non-insulated ceilings.
- Snap-in trim (sold separately) integrates reflector and flange to redirect light while creating a comfortable visual transition from the lens to the ceiling plane.

OPTICAL SYSTEM

- Unique combination of reflective and refractive optical components achieves a uniform, comfortable appearance while eliminating pixelation and color fringing. This ensures smooth light patterns are projected with no hot spots and minimal striations.
- Components work together to optimize distribution, balancing the delivery of high illuminance levels on horizontal surfaces with an ideal amount of light on walls and vertical surfaces. This increases the perception of spaciousness.
- Diffusing lens shields direct view of LEDs while lower reflector balances brightness of lens with the ceiling to create a low-glare high angle appearance. When installed with 30° trim, deep set diffusing lens provides more precise optical control with greater visual cut-off.

ELECTRICAL SYSTEM

- Integral, high-efficiency driver and power supply.
- Power Factor > 0.9 nominal
- Input Voltage: 120V, 60Hz
- Dimming: Dimmable to 20% with most incandescent dimmers. Reference www.cree.com/lighting for recommended dimmers.

REGULATORY & VOLUNTARY QUALIFICATIONS

- · ENERGY STAR® qualified.
- cULus Listed
- Exceeds California Title-24 high efficacy luminaire requirements.
- IC air-tight rated, tested in accordance with ASTM E283.
- Suitable for damp locations.

Application Reference


		Ope				
Spacing	Shield	Lumens	Wattage	LPW	w/ft²	Average FC
4 4	15° (LR4E-15)	540	10.5	51	0.60	33
4 x 4	30° (LR4E-30)	515	11.1	46	0.66	32
6 x 6	15° (LR4E-15)	540	10.5	51	0.28	15
6 X 6	30° (LR4E-30)	515	11.1	46	0.31	15
00	15° (LR4E-15)	540	10.5	51	0.15	8
8 x 8	30° (LR4E-30)	515	11.1	46	0.17	8
10 × 10	15° (LR4E-15)	540	10.5	51	0.10	5
10 x 10	30° (LR4E-30)	515	11.1	46	0.11	5

10' Ceiling, 80/50/20 Reflectances, 2.5 workplane. LLF: 1.0 Initial. Open Space: 50' x 40' x 10'

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Photometry

LR4E-15 LT4-15A BASED ON ITL TEST #: 59866

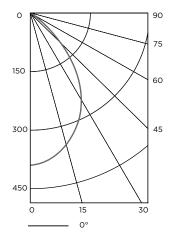

Intensity (Candlepower) Summary


Angle	Mean CP
O°	378
5°	373
15°	340
25°	278
35°	200
45°	114
55°	52
65°	19
75°	1
85°	0
90°	0

Zonal Lumen Summary

Zone	Lumens	% Lamp	% Fix
0-30	259	47.9%	47.9%
0-40	383	70.9%	70.9%
0-60	518	96%	96%
0-90	540	100%	100%

Reference www.cree.com/lighting for detailed photometric data

LR4E-30 LT4-30A BASED ON ITL TEST #: 59865

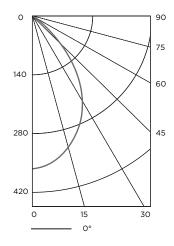

Intensity (Candlepower) Summary

Angle	Mean CP	
0°	362	
5°	357	
15°	325	
25°	266	
35°	191	
45°	109	
55°	50	
65°	18	
75°	1	
85°	0	
90°	0	


Zonal Lumen Summary

Zone	Lumens	% Lamp	% Fix
0-30	275	53.5%	53.5%
0-40	314	76.9%	76.9%
0-60	509	98.8%	98.8%
0-90	515	100%	100%

Reference www.cree.com/lighting for detailed photometric data.



Canada: www.cree.com/canada T (800) 473-1234 F (800) 890-7507

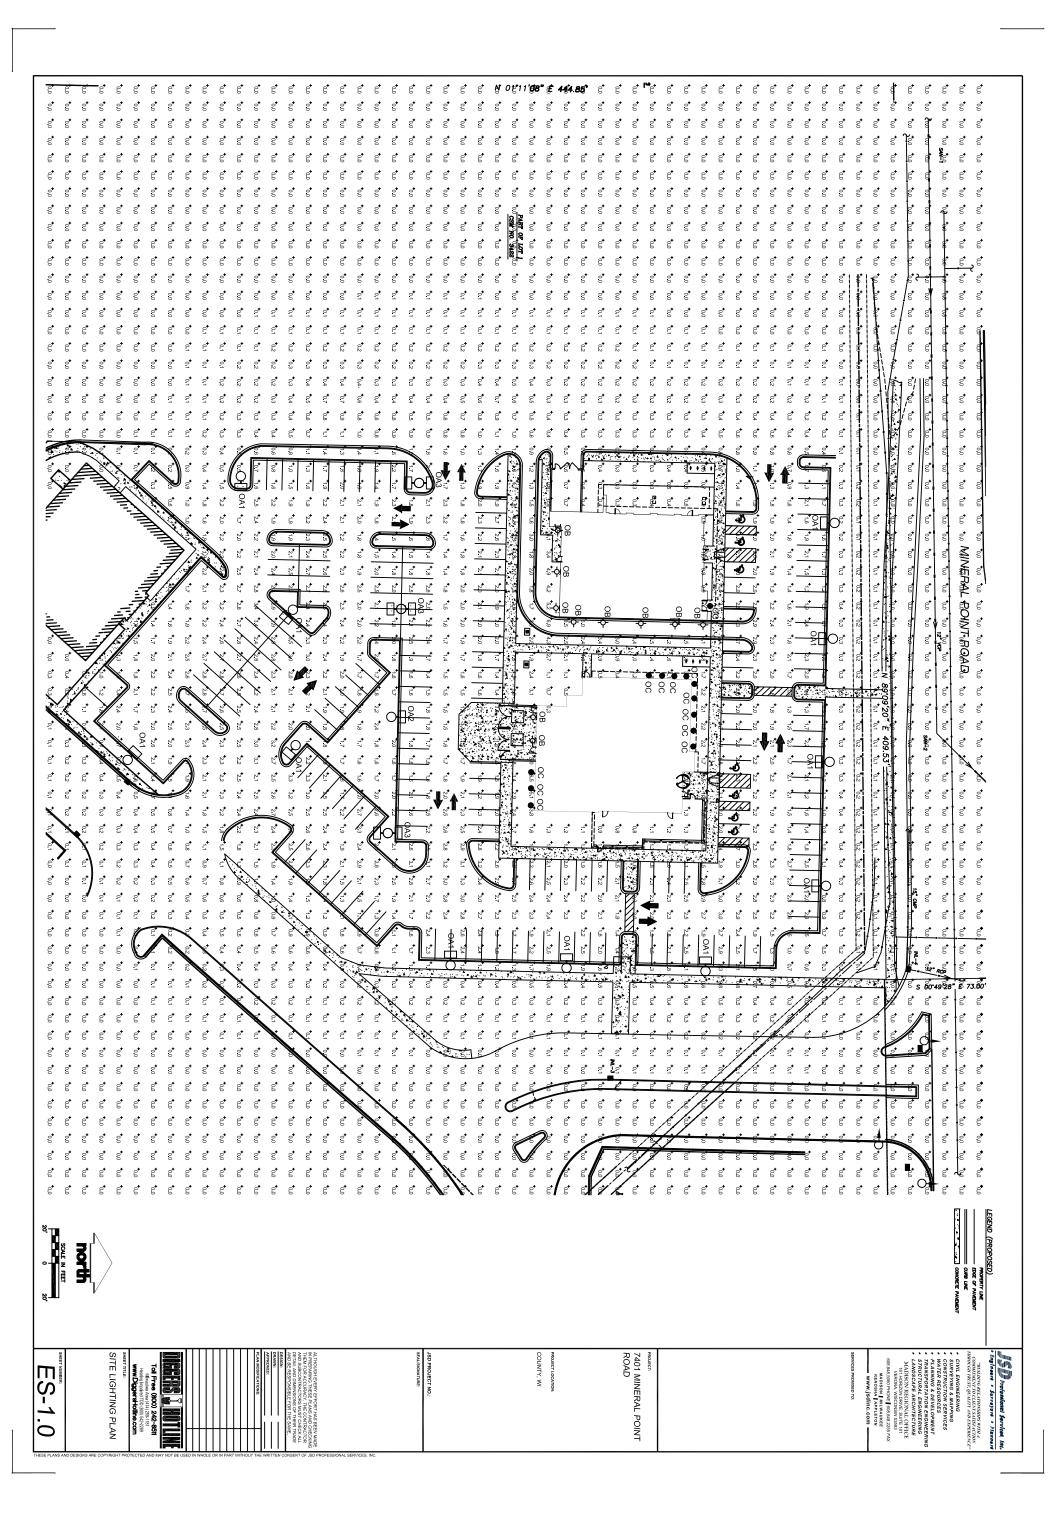

0A1 0A2 푎 SINGLE HEAD PARKING LOT POLE
SINGLE HEAD PARKING LOT POLE
DOUBLE HEAD PARKING LOT POLE CUTOFF WALLPACK FIXTURE MANUFACTURER KENALL OREE LR4E-15-H4-LT-15AW/LT4-30W IFH626-E-IC610C FN15L-4-7-XX-50L40K-DV-SA LIGHTING FIXTURE SCHEDULE POLE POLE MOUNTING CEILING WALL CEILING TYPE ₹ OPEN GLASS GLASS GLASS LENS MVOLT 1 MVOLT 1

MVOLT 1 120 1 120 1 5 NO. WATT 50W 10.5 26W 320W 320W 320W 5 PSMH PSMH Ж 용률 LAMP DATA MANUFACTURER × ନ ₹ ¥ MVR320/VBU/PA MVR320/VBU/PA MVR320/VBU/PA NA F26DBXT4/SPX41 CATALOG NO. 35 FOOT SQUARE STEEL POLE ON 3 FOOT BASE 35 FOOT SQUARE STEEL POLE ON 3 FOOT BASE 35 FOOT SQUARE STEEL POLE ON 3 FOOT BASE

COUNTY, WI

7401 MINERAL POINT ROAD

SITE LIGHTING SCHEDULES

ES-2.0

Tol Free (800) 242-8511

Minute Anni 141 (251-181)

Minute Anni 141 (251-18

CVIL EMOINEERING
CUNVETING & MAPPING
CUNVETING & MAPPING
CUNVETING & FOREICO PRICE
PLANUING & FOREICO PRICE
PLANUING & FOREICO PRICE
TRANSPORTATION ENGINEERING
STRUCTURAL ENGINEERING
LANDSCAPE ARCHITECTURE
MADISON PRICIONAL OFFICE
METORICAL PROCESSOR
008.442.000 POWER GUITE
VERDAM, MICCOLEN ESSIE
008.442.000 POWER GUITE
METORICAL PROCESSOR
MADISON J MUTANATE
KENDING J PANETON
WWW. J SHITCH COM
WWW. J SHIT "BUILDING RELATIONSHIPS WITH A COMMITMENT TO CLIENT SATISFACTION THROUGH TRUST, QUALITY AND EXPERIENCE

Figures + Surveyors + Pleasant

DESCRIPTION

The McGraw-EdisonTalon is the most versatile, functionally designed, universally adaptable outdoor luminaire available. The Talon brings outstanding performance to walkways, parking lots, roadways, loading docks, building areas, and any security lighting application. U.L. listed and CSA certified for wet locations. IP65 Rated.

E McGRAW-EDISON®



Catalog #	Туре
	OA1, OA2
Project	OA1, OA2 & OA3
Comments	Date
Prepared by	

SPECIFICATION FEATURES

Construction

One-piece heavy-wall, die-cast aluminum construction with integral reveal channels along top surface of housing. Internal cast-in wall separates optical and electrical chambers allowing components to operate cooler. One-piece die-cast aluminum door frame with integral cast-in gasket channel seals optical chamber to an IP65 rating. Stainless steel latches and hinges allow for toolless opening and removal of door frame.

Electrical

Electrical componentry mounted on a swing-down galvanized steel power tray with integral handle. Electrical disconnects allow tray to be completely removed from the housing providing ample hand and tool room for attachment of fixture during installation.

Optical

REFLECTOR: Choice of 14 high efficiency optical systems utilizing horizontal and vertical lamp orientations. Optional high efficiency segmented optical systems constructed of premium 95% reflective anodized aluminum sheet. Optical segments are rigidly mounted inside a thick guage aluminum housing for superior protection. All segment faces are clean of rivet heads, tabs or other means of attachment which may cause streaking in the light distribution. Standard with mogulbase socket. All optical modules feature quick disconnect wiring plugs and are field rotatable in 90° increments.

Mounting

Extruded 10 1/2" aluminum arm includes internal bolt guides allowing for easy positioning of fixture during installation to pole or wall surface. Standard single carton packaging of housing, square pole arm and round pole adapter for contractor friendly arrival of product on site.

Finish

Housing and arm finished in a 5 stage premium TGIC polyester powder coat paint, 2.5 mil nominal thickness for superior protection against fade and wear. Standard colors include black, bronze, grey, white, dark platinum, and graphite metallic. RAL and custom color matches available. Consult the McGraw-Edison Architectural Colors brochure for the complete selection.




TLL TALON LARGE

250 - 1000W Pulse Start Metal Halide High Pressure Sodium Metal Halide

ARCHITECTURAL


DIMENSIONS

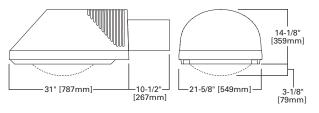


WATTAGE TABLE

Lamp Type	Wattage
Pulse Start Metal Halide (MP)	250, 320, 350, 400, 450, 750, 875, 1000W
High Pressure Sodium (HPS)	250, 400, 750, 1000W
Metal Halide (MH)	250, 400, 1000W

ARM DRILLING

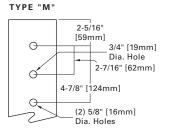

WALL DRILLING

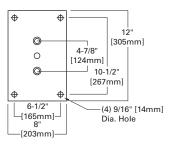



NOTE: In all flat glass configurations only.

ENERGY DATA

CWA Ballast Input Watts

250W HPS HPF (295 Watts)
250W MP HPF (283 Watts) ®
320W MP HPF (361 Watts) ®
350W MP HPF (397 Watts) ®
400W HPS HPF (457 Watts)
400W MP HPF (452 Watts) ®
450W MP HPF (508 Watts) ®
750W HPS HPF (840 Watts)
750W MP HPF (820 Watts)
1000W HPS HPF (1100 Watts)
1000W MP HPF (1070 Watts)

EPA

Effective Projected Area: (Sq. Ft.) 3.28 with 10.5" ARM

SHIPPING DATA Approximate Net Weight: 400W 91 lbs. (41.36 kgs.) 1000W 98 lbs. (44.54 kgs.)





Wall Mount

Arm Mount Single E.P.A.

TLL

3.28

Arm Mount 2 @ 180° E.P.A. TLL 6.14 Arm Mount 2 @ 90° E.P.A. TLL 6.16 Arm Mount 3 @ 120° E.P.A. TLL 7.13 Arm Mount 3 @ 90° E.P.A.


E.P./ 5 TLL


Arm Mount 4 @ 90° E.P.A.








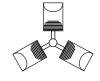


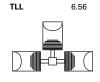

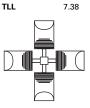

PHOTOMETRICS [Complete IES files available at www.cooperlighting.com]

Flat Glass w/House-side Shield

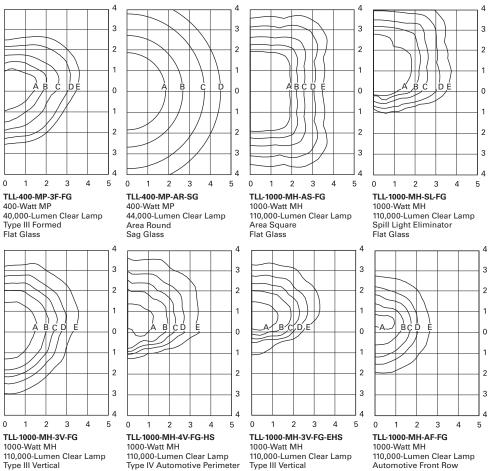

Flat Glass-External

House-side Shield

Footcandle Table

Select mounting height and read across for footcandle values of each isofootcandle line. Distance in units of mounting height.

Mounting			Values fo	r	
Height	Isot	ootcand	le Lines		
	Α	В	С	D	E
400W [3F]/	1000W	[AS/SL]			
25'	2.88	1.44	0.72	0.29	0.14
30'	2.00	1.00	0.50	0.20	0.10
35'	1.46	0.73	0.37	0.15	0.07
400W [AR]					
25'	1.44	0.72	0.29	0.14	
30'	1.00	0.50	0.20	0.10	
35'	0.73	0.37	0.15	0.07	

Footcandle Table

Select mounting height and read across for footcandle values of each isofootcandle line. Distance in units of mounting height.


Mounting Height		candle \	/alues fo e Lines	r	
	Α	В	С	D	E
1000W [3V	/4V-HS/	3V-EHS]	I		
25'	7.20	2.88	1.44	0.72	0.29
30'	5.00	2.00	1.00	0.50	0.20
35'	3.65	1.46	0.73	0.37	0.15
1000W [AF	-	10.00	2.00	1.00	0.20
25'	30.00	10.00	3.00	1.00	0.20
27'	25.50	8.50	2.55	0.85	0.17
30'	20.70	6.90	2.07	0.69	0.14



Flat Glass

Flat Glass

ORDERING INFORMATION

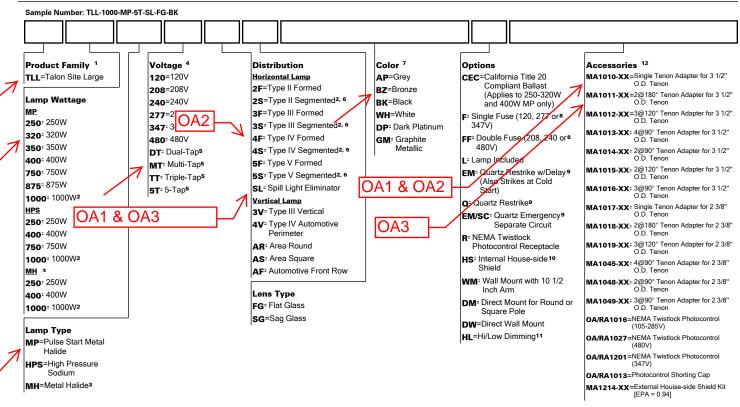

Notes: 1 10 1/2" arm and round pole adapter included with fixture. 2 Requires reduced envelope lamp. 3 250 and 400W are available for non-US markets only. 4 Products also available in non-US voltages and 50Hz for international markets. Consult factory for availability and ordering information. 5 Dual-Tap ballast is 120/277V wired 277V. Triple-Tap ballast is 277/247/480V wired 347V. 5-Tap ballast is 120/208/240/277/480V wired 480V. 6 Maximum wattage on segmented optical distributions is 400W. 7 Custom and RAL color matching available upon request. Consult Cooper Lighting Representative for further information. 8 Must specify voltage. 9 Quartz options not available with SL and AF optics. 10 House-side shield not available on 55, 5F, AS, AR, and SL optics. 11 Requires vertical lamp orientation. Provides 24V low voltage leads used in dimming control. 12 Order separately, replace XX with color designation.

MILLENIUM FINITE™











PROJECT INFORMATION

Job Name

OB

Fixture Type Catalog Number

Approved by

FN SERIES – LOW PROFILE

PRODUCT FEATURES:

- » Surface wall mount; 9" & 15"
- » Full cutoff Type II, III, IV or IVN optic patterns
- » Dark-Sky friendly
- » Designlights Consortium listed (DLC)
- » Peace of Mind Guarantee®



SPECIFICATIONS

HOUSING: High-impact resistant, UV-stabilized injection molded polycarbonate. Marine-grade die-cast aluminum ballast/driver housing.

DOOR: High-impact resistant, UV-stabilized injection molded polycarbonate with detachable hinge. Secured to housing with four (4) captive, recessed Torx® (or optional Phillips head) stainless steel screws. Lens sealed with closed-cell silicone gasket and secured to door frame with heavy gauge stainless steel brackets.

GASKETING: Closed cell, silicone "O"ring gasket seals joint between polycarbonate housing and die-cast aluminum ballast housing and joint between polycarbonate housing and polycarbonate lens frame assembly. Thick gauge, die-cut, closed cell neoprene with self-adhesive gasket seals joint between housing and mounting surface or accessory surface conduit adapter.


ELECTRICAL: Flourescent electronic 120/277/347 and dual voltage ballasts high power factor (<10% THD), HID ballasts high power factor. Metal halide lamps utilize pulse start technology. Shock absorbing, medium base lamp sockets provided for HID lamps. See Lamp Type for electronic halide ballast option LED: Replaceable high-brightness ANSI 4000K (65 CRI min.), 5000K (65 CRI min.), and 5700K (70 CRI min.) white LED array. See Options for higher CRI lamp availability.120-277VAC High Power Factor Electronic Dimming Constant Current driver. Luminaire is certified to UL Standards by either Underwriters Laboratory or Intertek Testing Laboratory for wet location.


INSTALLATION: Fixture is factory pre-wired and includes gasketed, 16-gauge stainless steel quick mounting plate. Once four-point mounted to wall (required for Peace of Mind Guarantee®) or accessory surface conduit adapter, allows quick mounting with hook-and-lock mechanism. Quick mounting plate bolts to wall (fasteners by other), fixture attaches to mounting plate with two (2) captive Torx® (or optional Phillips head) screws, which are concealed but accessible from bottom.

SURFACE CONDUIT ADAPTER (ACCESSORY): Marine-grade die-cast aluminum construction includes die-cut gaskets and two 3/4" threaded connection ports. Once four-point mounted to wall (required for Peace of Mind Guarantee®) allows same quick mounting (hook-and-lock) capability as described in the Installation section above.

WARRANTY: One (1) year warranty against defects in materials and workmanship. Five (5) year warranty on LED lamps and driver for defects resulting in a fixture lumen depreciation of 30% or greater.


LISTINGS: Luminaire is certified to UL Standards by either Underwriters Laboratory or Intertek Testing Laboratory for wet location. UL certified IP64 per IEC 60598. IESNA-designated full cut-off. IDA-Approved[™] Dark-Sky Friendly Fixture. Product listed on Designlights Consortium QPL. Photometry tested to the IESNA LM-79-08 standard by an ILAC/ISO17025 accredited laboratory.

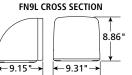


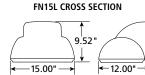






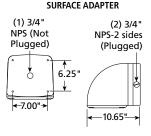

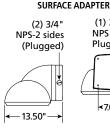

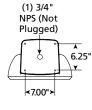

ORDERING INFORMATION

	Model	Optic System	Lens Type	Finish	Lamp Type	Lamp Qty	Voltage		Options	Accessories
	 Model			Lamp Typ	e (Qty/Ballast/Volt/Sta	orting Tomp)		James James	Quantity (See Lamp Type)	
		utoff Low Profile		9"	e (Qty/ballast/voit/sta	irtilig lellip)			One Lamp	
_	FN15L 15" Full	Cutoff Low Profile			26 Watt 4000K LED			2	Two Lamps	
7	Optic System				26 Watt 5000K LED 26 Watt 5700K LED			Voltag	Ie.	
	2 Type II				18 Watt Quad (2/RS/120)	/277 347/0°F)		120	120 Volts	
	3 Type III (LEI			26P	26 Watt PLT (1,2/RS/120/			277	277 Volts	
7	4 Type IV (LEI) only) vith one lamp only on	the 15")	32P	32 Watt PLT (1/RS/120/2	77,347/0°F)		347* DV	347 Volts 120-277 Volts (fluorescent	or LED only)
٠.		row (LED only)	rule 13 /	15"			1	•		of LLD offig)
	Lens Type				26 Watt 4000K LED		/'	Option LEL	ns Integral Emergency Battery	, Packup
		Polycarbonate			26 Watt 5000K LED 26 Watt 5700K LED			LEL	(Available with FN15L, 26	
1	(n/a with to	wo lamps or HID)			50 Watt 4000K LED			2C	Two Circuit Wiring (2 Lamp	Quantity only) (n/a in LED)
	A .250" Clear	Tempered Glass (STE) w/HID)		50 Watt 5000K LED			FS	Single Fuse & Holder	
	Finish				50 Watt 5700K LED 80 Watt 4000K LED			PH QRC	Phillips Head Fasteners Hot/Cold Quartz Restrike (15" only) (HID only)
	DB Dark Bronz	-			80 Watt 5000K LED			QS2		50W ea.) (15" only) (HID only)
	MB Matte Black MW Matte White				80 Watt 5700K LED			Access	corios	
		or (Consult factory)			26 Watt Quad (1,2/RS/12)		50 Watt DC Bayonet Base Qu	uartz Lamp (15" only)
		7,			32 Watt PLT (1,2/RS/120, 42 Watt PLT (1,2/RS/120,			9500	Torx® Screwdriver	77
					50 Watt MH (1/HPF/120,		-1	SA	Die-Cast Surface Adapter	
				50S	50 Watt HPS (1/HPF/120),277,347/-40°F	i) //	* n/a v	with LED Option	
					70 Watt MH (1/HPF/120,				•	
				70ME	70 Watt MH (1/EB/120,2	///-ZU'F)				





70S

70 Watt HPS (1/HPF/120,277,347/-40°F)

When you see this image, you will know the Kenall product shown or described is manufactured in the USA with components purchased from US suppliers, and



Product Description

The LR4™ architectural LED downlight delivers up to 540 lumens of exceptional 90+ CRI light while achieving over 51 lumens per watt. This breakthrough performance is achieved by combining the high efficacy and high-quality light of Cree TrueWhite® Technology. The LR4 is available in moderate or deep recess, warm or neutral color temperatures, and has a variety of trim options. It must be used with the Cree $\rm H4$ housing, making the LR4 perfect for use in commercial new construction applications.

Performance Summary

Utilizes Cree TrueWhite® Technology

Active Color Management

Delivered Light Output: LR4E-15: 540 lumens, LR4E-30: 515 lumens

Input Power: LR4E-15: 10.5 watts, LR4E-30: 11.1 watts

CRI: 90

CCT: 2700K, 3500K Warranty: 10 years[†]

Lifetime: Designed to last 50,000 hours

Dimming: Dimmable to 20%* Shield Angles: 15° or 30°

Ordering Information

Example: LR4E-15 + H4 + LT4-15A OR LR4E-30 + H4 + LT4-30A

Fully assembled luminaire is composed of three components that must be ordered separately: LR4: Light engine H4: Recessed architectural housing LT4: Snap-in architectural trim

LR4E-15

2700K, 15° Shield (Moderate Recess)

LR4E-15C

3500K, 15° Shield (Moderate Recess)

LR4E-30

2700K, 30° Shield (Deep Recess)

LR4E-30C

3500K, 30° Shield (Deep Recess)

Recessed housing with GU24 socket

LT4-15A/LT4-30A

Diffuse anodized finish trim

LT4-15AW/LT4-30AW

Wheat diffuse anodized finish trim

LT4-15AP/LT4-30AP

Pewter diffuse anodized finish trim

LT4-15AB/LT4-30AB

Black anodized finish trim

LT4-15WH/LT4-30WH

Smooth white trim

LT4-15BB/LT4-30BB

Flat black finish trim and reflector


NOTE: Light engine and trim reflector depth must match for appropriate fit.

- * Reference www.cree.com/lighting for recommended dimmers.
- † See www.cree.com/lighting for warranty terms.





LR4E-30

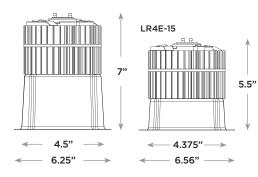

The LR4 downlight ships as three components: a housing, light engine, and trim. Each component must be ordered separately.











Product Specifications

CREE TRUEWHITE® TECHNOLOGY

A revolutionary way to generate high-quality white light, Cree TrueWhite® Technology mixes the light from the highest performing red and unsaturated yellow LEDs. This patented approach delivers an exclusive combination of 90+ CRI, beautiful light characteristics, and lifelong color consistency, all while maintaining high luminous efficacy—a true no compromise solution.

CONSTRUCTION & MATERIALS

- Durable cold-rolled steel housing protects LEDs, driver and power supply. Adjustable flip clips resist heat while providing retention for flush ceiling fit.
- Thermal management system uses extruded aluminum heat sink to conduct heat away from LEDs and transfer it to the plenum space for optimal performance. LED junction temperatures stay below specified maximum even when installed in attic insulation with ambient temperatures exceeding 60 C.
- · Suitable for insulated and non-insulated ceilings.
- Snap-in trim (sold separately) integrates reflector and flange to redirect light while creating a comfortable visual transition from the lens to the ceiling plane.

OPTICAL SYSTEM

- Unique combination of reflective and refractive optical components achieves a uniform, comfortable appearance while eliminating pixelation and color fringing. This ensures smooth light patterns are projected with no hot spots and minimal striations.
- Components work together to optimize distribution, balancing the delivery of high illuminance levels on horizontal surfaces with an ideal amount of light on walls and vertical surfaces. This increases the perception of spaciousness.
- Diffusing lens shields direct view of LEDs while lower reflector balances brightness of lens with the ceiling to create a low-glare high angle appearance. When installed with 30° trim, deep set diffusing lens provides more precise optical control with greater visual cut-off.

ELECTRICAL SYSTEM

- Integral, high-efficiency driver and power supply.
- Power Factor > 0.9 nominal
- Input Voltage: 120V, 60Hz
- **Dimming**: Dimmable to 20% with most incandescent dimmers. Reference www.cree.com/lighting for recommended dimmers.

REGULATORY & VOLUNTARY QUALIFICATIONS

- ENERGY STAR® qualified.
- cULus Listed
- Exceeds California Title-24 high efficacy luminaire requirements.
- IC air-tight rated, tested in accordance with ASTM E283.
- · Suitable for damp locations.

Application Reference


Open Space						
Spacing	Shield	Lumens	Wattage	LPW	w/ft²	Average FC
4 x 4	15° (LR4E-15)	540	10.5	51	0.60	33
4 X 4	30° (LR4E-30)	515	11.1	46	0.66	32
C + C	15° (LR4E-15)	540	10.5	51	0.28	15
6 x 6	30° (LR4E-30)	515	11.1	46	0.31	15
00	15° (LR4E-15)	540	10.5	51	0.15	8
8 x 8	30° (LR4E-30)	515	11.1	46	0.17	8
10 × 10	15° (LR4E-15)	540	10.5	51	0.10	5
10 x 10	30° (LR4E-30)	515	11.1	46	0.11	5

10' Ceiling, 80/50/20 Reflectances, 2.5 workplane. LLF: 1.0 Initial. Open Space: $50' \times 40' \times 10'$

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Photometry

LR4E-15 LT4-15A BASED ON ITL TEST #: 59866

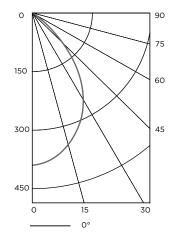

Intensity (Candlepower) Summary


Angle	Mean CP
O°	378
5°	373
15°	340
25°	278
35°	200
45°	114
55°	52
65°	19
75°	1
85°	0
90°	0

Zonal Lumen Summary

Zone	Lumens	% Lamp	% Fix
0-30	259	47.9%	47.9%
0-40	383	70.9%	70.9%
0-60	518	96%	96%
0-90	540	100%	100%

Reference www.cree.com/lighting for detailed photometric data.

LR4E-30 LT4-30A BASED ON ITL TEST #: 59865

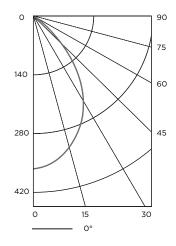

Intensity (Candlepower) Summary

Angle	Mean CP
O°	362
5°	357
15°	325
25°	266
35°	191
45°	109
55°	50
65°	18
75°	1
85°	0
90°	0

Zonal Lumen Summary


Zone	Lumens	% Lamp	% Fix
0-30	275	53.5%	53.5%
0-40	314	76.9%	76.9%
0-60	509	98.8%	98.8%
0-90	515	100%	100%

Reference www.cree.com/lighting for detailed photometric data.




IFH6 / IC610

6" Horizontal Compact Fluorescent / Open Reflector

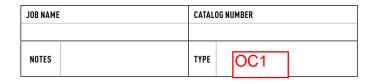



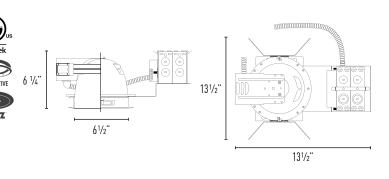

Order Matrix | Example: IFH6226-ADV-I100

A	В	C	D
A	Series	С	Ballast
IFH6	6" Horizontal Compact	E	Electronic 120/277V
7	Fluorescent	E-347	Electronic 347V
'		-ADV	Advance Mark 10 120V
В	Lamp	-ADV-27	Advance Mark 10 277V
		-ADV7	Advance Mark 7 120/277V ¹
13	(1) 13W DTT ¹	-LUT	Lutron EcoSystem® 120/277V
18	(1) 18W DTT	-LUT-1	Lutron Hi-lume 1% 120V ²
26	(1) 26W DTT/TRT	-LUT-1-27	Lutron Hi-lume 1% 277V ²
32	(1) 32W TRT		
42	(1) 42W TRT	D	Options
213	(2) 13W DTT ¹	1100	C Charal Day Harray
218	(2) 18W DTT (2) 26W DTT	-1100 -1200	C-Channel Bar Hanger
226	(Z) ZOW DII	-1200 -1400	Flat Bar Hanger Wood Joist Bar Hanger
		-EM	Emergency 650 lm Max
		-EM-13	Emergency 1300 lm Max
		-EM2	Emergency 650 lm Max w/
		LITZ	Integral Reflector Test Switc
Notes:		-EM2-13	Emergency 1300 lm Max w/
	ing only available with Mark 7.	LI12 10	Integral Reflector Test Switc
	ume 1% available in (1) 26W		I micograc moreoctor root owite

6" Open Reflector

High quality low iridescent reflector.

OD: 7 1/4"

 IC610C
 Clear Reflector / White Phenolic Ring

 IC610C-SF
 Clear Reflector / Self Flanged

 IC610C-SFW
 Clear Reflector / Self Flanged White

 IC610SD
 Semi Diffused Reflector / White Phenolic Ring

 IC610SD-SF
 Semi Diffused Reflector / Self Flanged

 IC610W
 White Reflector / White Phenolic Ring

Designer Trim Option (for non-self flanged reflectors):

Reflector standard with white phenolic trim ring. Optional metal trim rings include: Specify MW (metal white), B (black), SN (satin nickel), MO (mocha). Not available with self flanged reflector.

Notes

4 - Self flanged reflectors are compatible with Infuz ™ accessories only.

DESCRIPTION

Cut-out: 6 1/2"

Horizontal compact fluorescent downlight provides superior performance. Designed for use in medium to high ceiling heights. Applications include retail, commercial and hospitality.

SOCKET

Universal G24 4-Pin

REFLECTOR OPTICS

Specification grade reflector with 1.2mm thickness. White phenloic trim ring standard with optional designer trims or self flanged.

MOUNTING FRAME

Frame is constructed from heavy duty galvanized steel. Universal mounting brackets included. Compatible with C-channel, flat bar, wood joist bar hanger and EMT. Bar hangers must be ordered separately. C-channel are recommended for T-bar ceilings.

BALLAST

Electronic multi-voltage technology enables operation at any input voltage from 120 to 277 volts, 50/60Hz. Dimming options include Advance Mark 7, Mark 10, Lutron Eco System or Lutron Hi-lume® 1%.

EMERGENCY

- UL and cUL Listed
- Long-Life High-Temperature Recyclable
- Ni-Cad Battery
- Painted Steel Case
- 90-Minute Emergency Operation
- Includes Test Switch/Charge Indicator
- Dual Voltage 120/277V, 60Hz
- 5-Year Manufacturers Warranty

ACCESSORIES

Compatible with decorative drop and Infuz $^{\mathtt{M}}$ accessories. See page 2 for decorative drop and Infuz $^{\mathtt{M}}$ accessories.

LISTING

ETL listed for thru-branch wiring and damp locations. For Non-IC recessed installation. ETL listed to US and Canadian standards.



6" Decorative Recessed Accessories

JOB NAME		CATALO	CATALOG NUMBER	
NOTES		ТҮРЕ		



Decorative glass and acrylic accessories are compatible with select reflectors. Customize and create your environment with the options below.

ORDERING INFORMATION:

Add accessory part number to the end of the reflector part number. (Example: IC610C-SF-D1R)

Note: Infuz decorative accessories are compatible with self flanged reflectors only.

ORDERING INFO	DESCRIPTION	OD	ID	THICKNESS
-D1R	6" Red Acrylic Ring 1 ³/₀"	7 3/4"	5 ½"	1/8"
-D2R	6" Red Acrylic Ring 23%"	7 3/4"	3 1/2"	1/8"
-D1B	6" Blue Acrylic Ring 1 %"	7 3/4"	5 1/2"	1/8"
-D2B	6" Blue Acrylic Ring 2 3/8"	7 3/4"	3 1/2"	1/8"
-D1G	6" Green Acrylic Ring 1 ³/₀"	7 3/4"	5 1/2"	1/8"
-D2G	6" Green Acrylic Ring 2 3/₀"	7 3/4"	3 1/2"	1/8"
-D5	6" Tempered Glass Decorative Drop	7 3/4"	NA	5/32"
-D6	6" Tempered Glass Decorative Drop	7 3/4"	NA	5/32"
-D7	6" Tempered Glass Decorative Drop	7 3/4"	NA	5/32"
-D8	6" Tempered Glass Ring 1 3%"	7 3/4"	5 1/2"	5/32"
-D9	6" Sandblasted Tempered Glass Ring 2 3/6"	7 3/4"	3 1/2"	5/32"



Infuz decorative accessories may be used with select reflectors. Accessory kits are factory installed. Custom material available by special order. Minimum order and lead times may apply. Consult factory.

How to Order:

- 1. Enter your specified reflector under section "A".
- 2. Specify the Infuz adder on the reflector part number. (Example: IC610C-SF-IZDM-5-MO)

Note: Infuz decorative accessories are compatible with self flanged reflectors only.



Flush Mount Recessed



Drop Mount Recessed

Order Matrix | Example: IC610C-SF-IFZFM-W-1

A	B	С	D
A	Reflector	0	Material
	Specify Compatible Reflector	-1 -2 -3	
В	Series	-4 5	Linea Vert
-IFZFM	Infuz Flush Mount	6	
С	Inner Reflector		
-W -HZ	White Haze		

Order Matrix Example: IC610C-SF-IFZDM-1-SN	

Α	В	С	D
A	Reflector	C	Material
	Specify Compatible Reflector	-1 -2 -3	Red Crush Blue Crush Tiger Thatch
В	Series	-4 -5	Linea Vert Bronze Weave
-IFZDM	Drop Mount	-6	Fossil Leaf
		D	Drop Hardware
		-SN -M0	Satin Nickel Mocha



Type: Red Crush Item Code: 1



Type: Blue Crush Item Code: 2



Type: Tiger Thatch Item Code: 3



Type: Linea Vert Item Code: 4



Type: Bronze Weave Item Code: 5



Type: Fossil Leaf Item Code: 6
















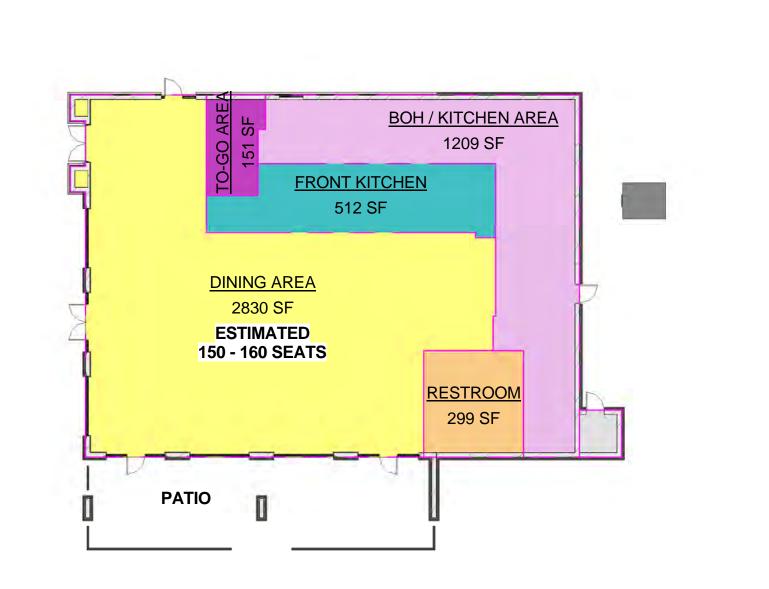

BOH / KITCHEN AREA

DINING AREA

FRONT KITCHEN

RESTROOM

OCCUPANCY CALCULATIONS AS DEFINED BY CODE: FIXED SEATING (1 PERSON FOR EACH 24" OF BOOTH LENGTH) AS DEFINED BY CODE: INTERIOR OCCUPANCY CALCULATED BY AREA OCCUPANT TOTALS **BOOTH TYPE** 4' - 0" BOOTH AREA OCCUPANTS: = 188 23'-11" BANQUET FIXED SEAT OCCUPANTS: = 44 20'-7" BANQUET EXTERIOR SEATING OCCUPANTS: = 64 15'-6" BANQUET 14'-5" BANQUET TOTAL OCCUPANT LOAD INTERIOR: = 232 12'-6" BANQUET TOTAL OCCUPANT LOAD EXTERIOR: TOTAL FIXED SEAT OCCUPANTS = 44

TOTAL OCCUPANT LOAD: = 296

			1 1		
OCCUPANCY	WATER CLOSETS URINALS LAVATO		ORIES		
296 OCCUPANTS	MALE	FEMALE		MALE	FEMALE
50% MALE / 50% FEMALE	1 PER 75	1 PER 75	N/A	1 PER 200	1 PER 200
148 MALE / 148 FEMALE			•		•
FIXTURES REQUIRED	2	2		1	1
FIXTURES PROVIDED	1	2	1	1	1

EXIT REQUIREMENTS

		IMUM OF EXITS	TRAVEL DIS	STANCE	ARRANGEMENT MEANS OF EGRESS		
FLOOR, ROOM OR SPACE DESIGNATION	REQUIRED	SHOWN ON PLANS	ALLOWABLE TRAVEL DISTANCE	DEAD END LIMIT	REQUIRED DISTANCE BETWEEN EXIT DOORS	ACTUAL DISTANCE SHOWN ON PLANS	
OCCUPIED SPACE	2	4	250'	20'	> or = 34' - 0"	54' - 0"	

		IMUM R OF EXITS	TRAVEL DIS	STANCE	ARRANGEMEN EGRES	
FLOOR, ROOM OR SPACE DESIGNATION	REQUIRED	SHOWN ON PLANS	ALLOWABLE TRAVEL DISTANCE	DEAD END LIMIT	REQUIRED DISTANCE BETWEEN EXIT DOORS	ACTUAL DISTANCE SHOWN ON PLANS
OCCUPIED SPACE	2	4	250'	20'	> or = 34' - 0"	54' - 0"


PRE-DESIGN AREA PLAN $\binom{1}{1/16''} = 1'-0''$

Area Schedule (Rentable Space)							
Name	Area	Percentage					
DINING AREA	2830 SF	57%					
BOH / KITCHEN AREA	1209 SF	24%					
FRONT KITCHEN	512 SF	10%					
RESTROOM	299 SF	6%					
TO-GO AREA	151 SF	3%					
Grand total	5000 SF	100%					

GROSS BUILDING AREA: 5,000 SF

PATIO:	900 SF
TOTAL:	5,900 SF

TOTAL PARKING SPACES: 77

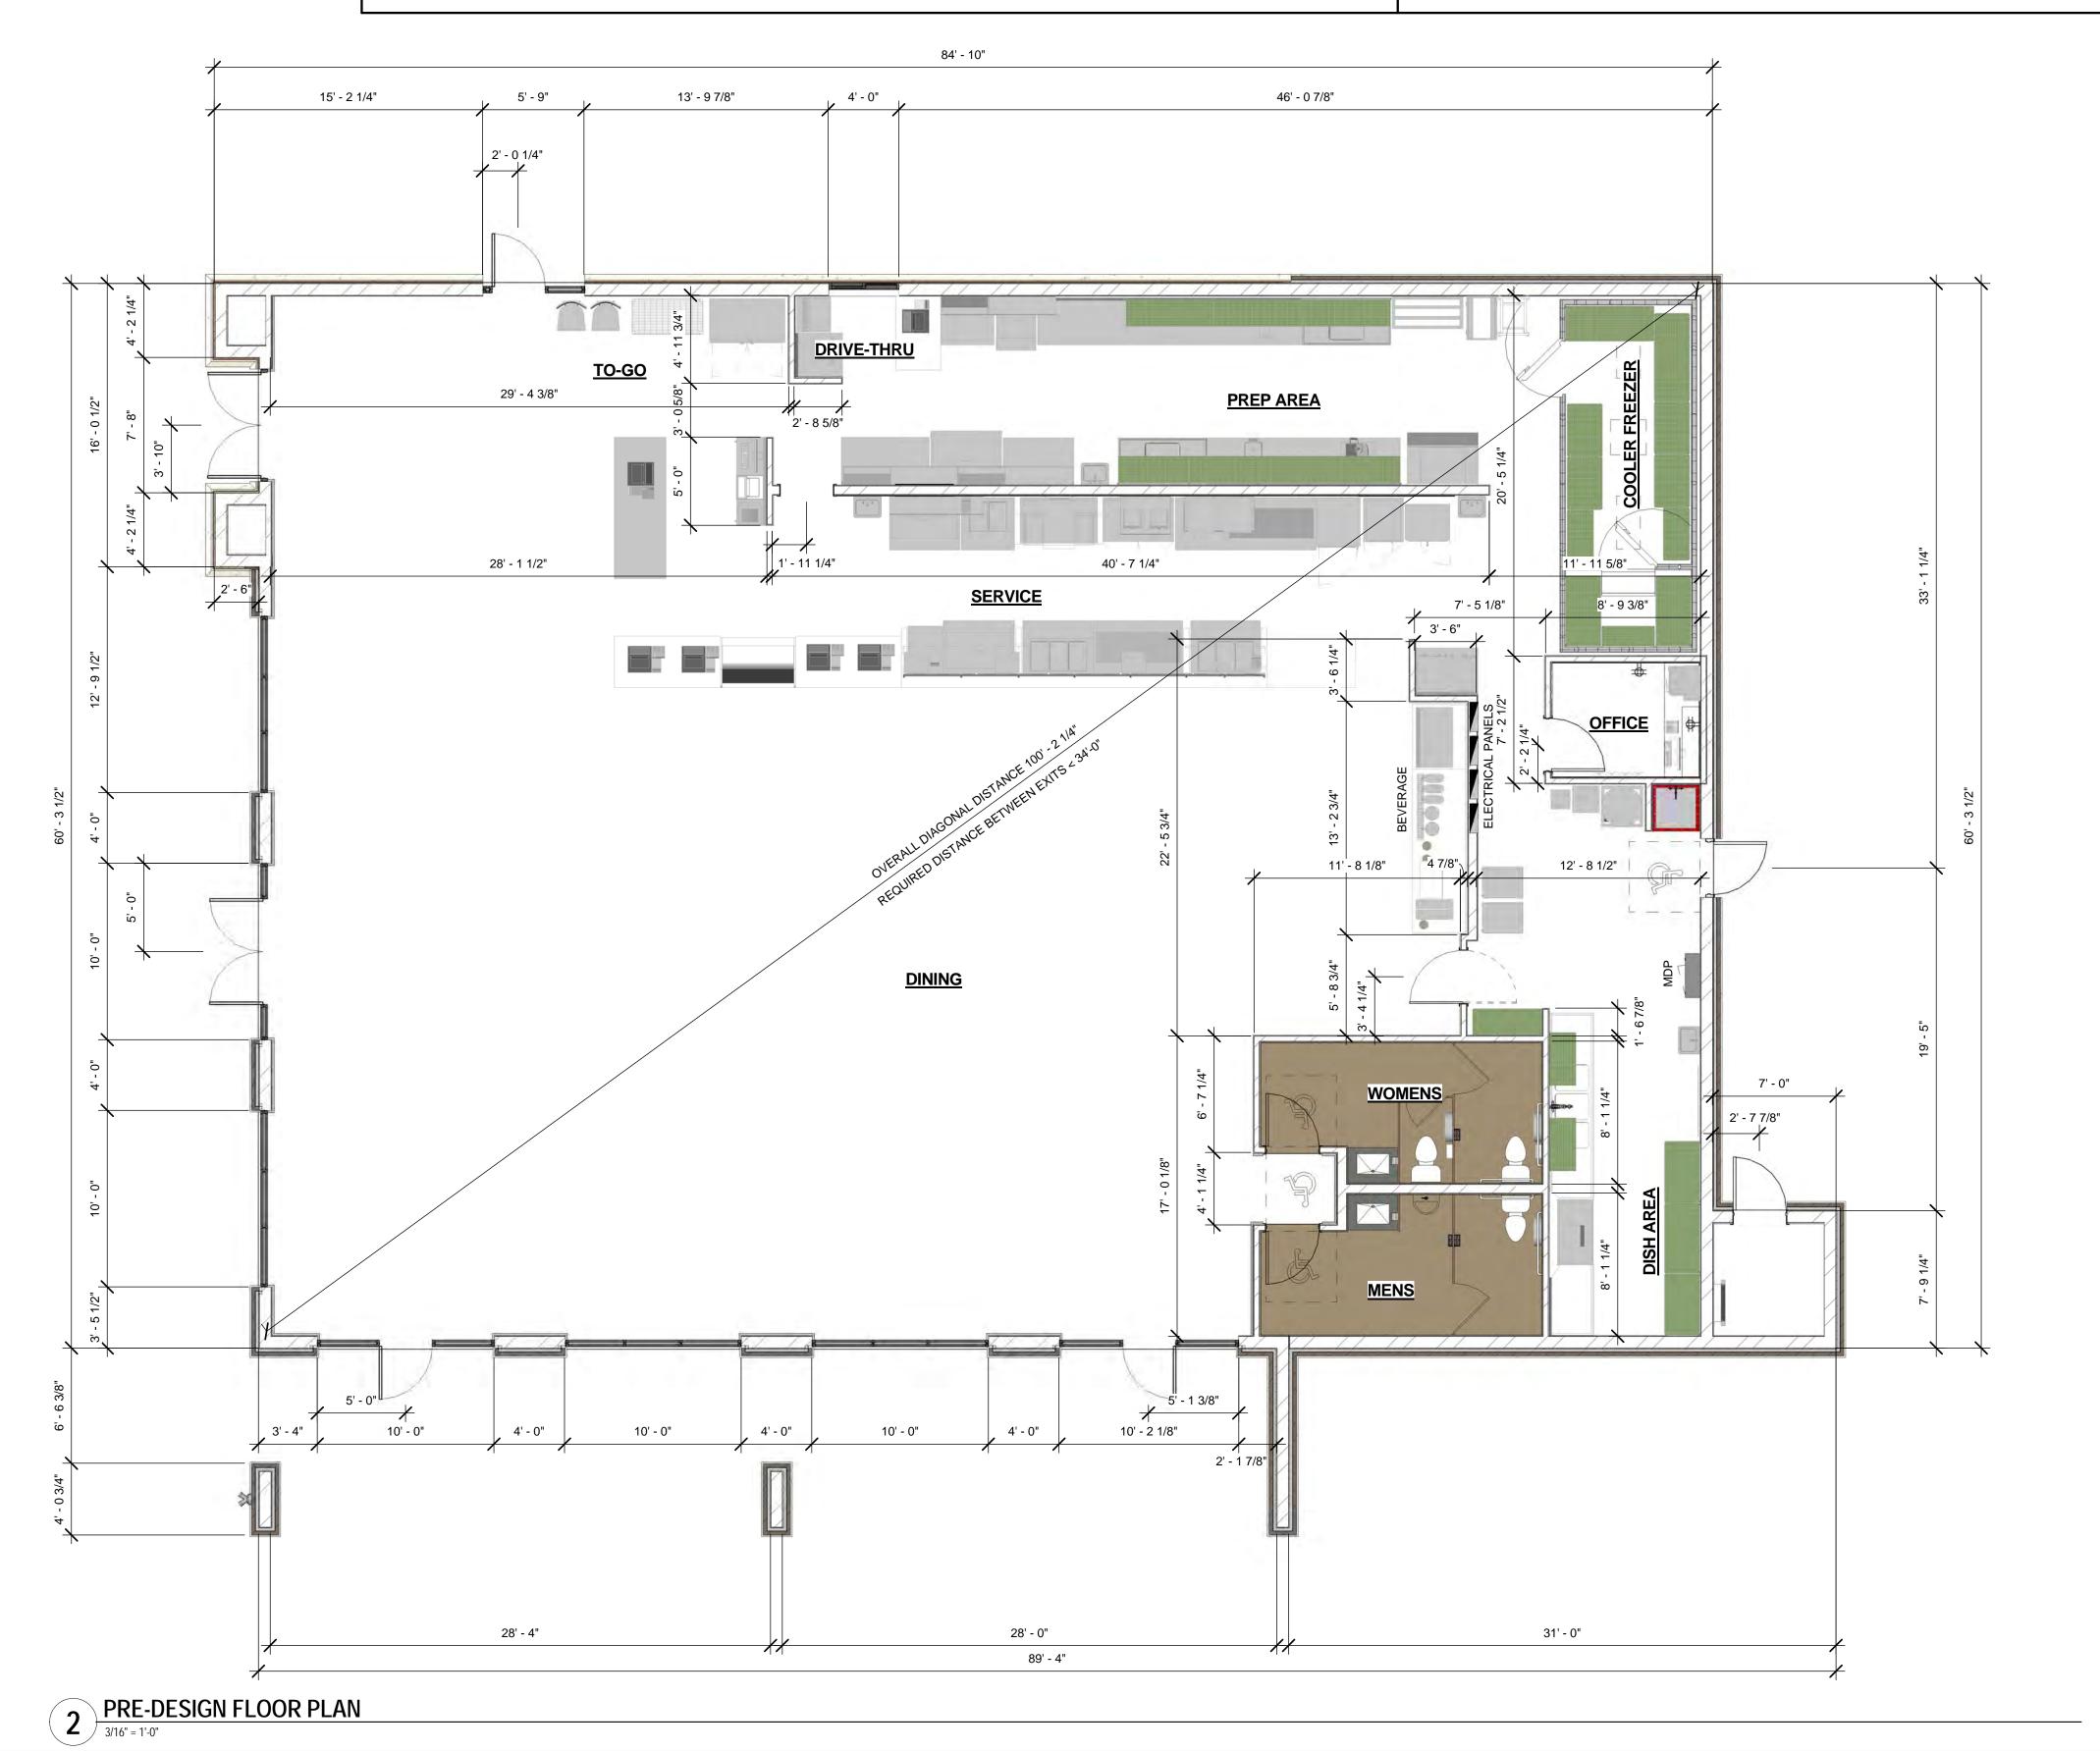

AS DEFINED BY JURSIDICTION:
EXTERIOR SEATING OCCUPANCY CALCULATED PER SEAT

TOTAL EXTERIOR SEATING OCCUPANTS = 64

TOTAL SEATS

OCCUPANTS

PER SEAT = 64



Innovation and Design in Architecture, Inc. 218 The Promenade North Long Beach, CA 90802 www.idaexperience.net

Architect:

Geoffrey B. Lim aia, ncarb, leed ap

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Issue For:

PRE-DESIGN

10-15-13

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REASON

DATE


PROJECT MANAGER: WESLEY STEPHENS

JASON'S DELI - MADISON,

05-018-13 Sheet Title:

PRE-DESIGN DEVLOPMENT PLAN

PF1-1

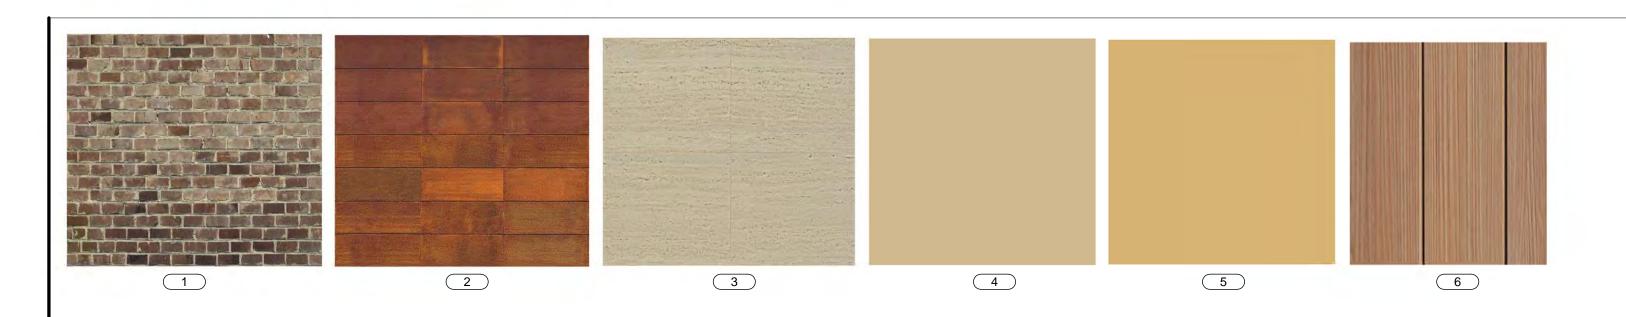

EXTERIOR PERSPECTIVE 1

FINISH SCHEDULE - EXTERIOR										
	PRODUCT DATA									
CODE	TYPE / STYLE / COLOR	MANUFACTURER / REP.								
1	CYPRESS FOREST TUMBLED - QUEEN SIZE 27/8 x 7 5/8 x 2 3/4	STATESVILLE BRICK / 704-872-4123								
2	RUSTED CORTEN PANEL SYSTEM	WESTERN STATES DECKING / PAUL RUBIO 949-929-1020								
3	CAST CONC. FINAL TBD									
4	EIFS - COLOR: ALMOND 10407 (73)	PAREX								
5	POWDER COAT - 049/15190 - RAL 1001	TIGER DRYLAC POWDER COATINGS								
6	ENGINEERED WOOD PLANKING									



Architect: Geoffrey B. Lim AIA, NCARB, LEED AP

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PRE-DESIGN

Issue Date: 10-03-13

Issue For:

NO.	REASON	DA

PRINCIPAL IN CHARGE: Approver PROJECT MANAGER: DRAWN BY:

Author Project Address:

JASON'S DELI - MADISON,

Project Number:


05-018-13 **Sheet Title:**

SCHEMATIC ELEVATIONS

PF1-3





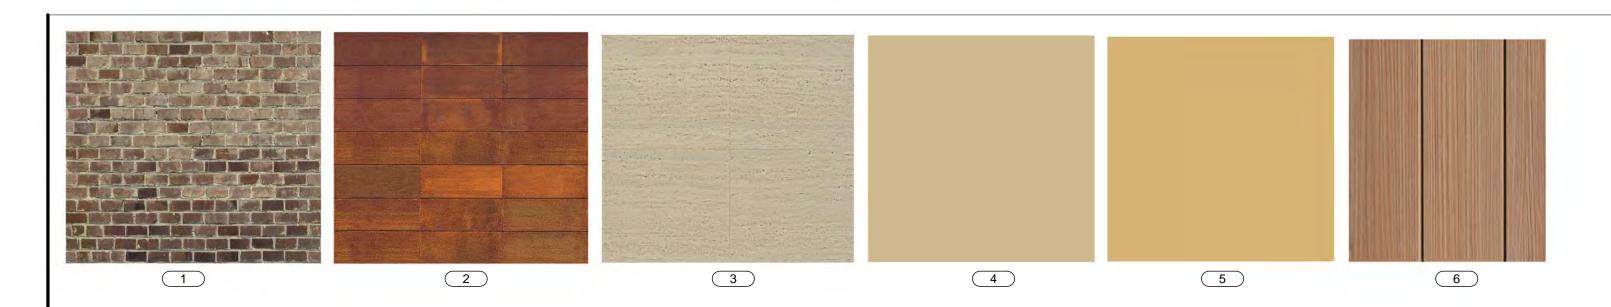

	PRODUCT DATA									
CODE	TYPE / STYLE / COLOR	MANUFACTURER / REP.								
1	CYPRESS FOREST TUMBLED - QUEEN SIZE 27/8 x 7 5/8 x 2 3/4	STATESVILLE BRICK / 704-872-4123								
2	RUSTED CORTEN PANEL SYSTEM	WESTERN STATES DECKING / PAUL RUBIO 949-929-1020								
3	CAST CONC. FINAL TBD									
4	EIFS - COLOR: ALMOND 10407 (73)	PAREX								
5	POWDER COAT - 049/15190 - RAL 1001	TIGER DRYLAC POWDER COATINGS								
6	ENGINEERED WOOD PLANKING									







Architect:

AIA, NCARB, LEED AP

Plans, maps, specifications, studies, and reports no

GEOFFREY B. LIM

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om's delif

amp:

Issue For:

PRE-DESIGN

10-03-13

NO. REASON DATE

PRINCIPAL IN CHARGE:
Approver
PROJECT MANAGER:
Checker
DRAWN BY:

roject Address:

JASON'S DELI - MADISON, WI

Project Number:


05-018-13
Sheet Title:

SCHEMATIC ELEVATIONS

Sheet Number:

PF1-4

1 EXTERIOR PERSPECTIVE 3

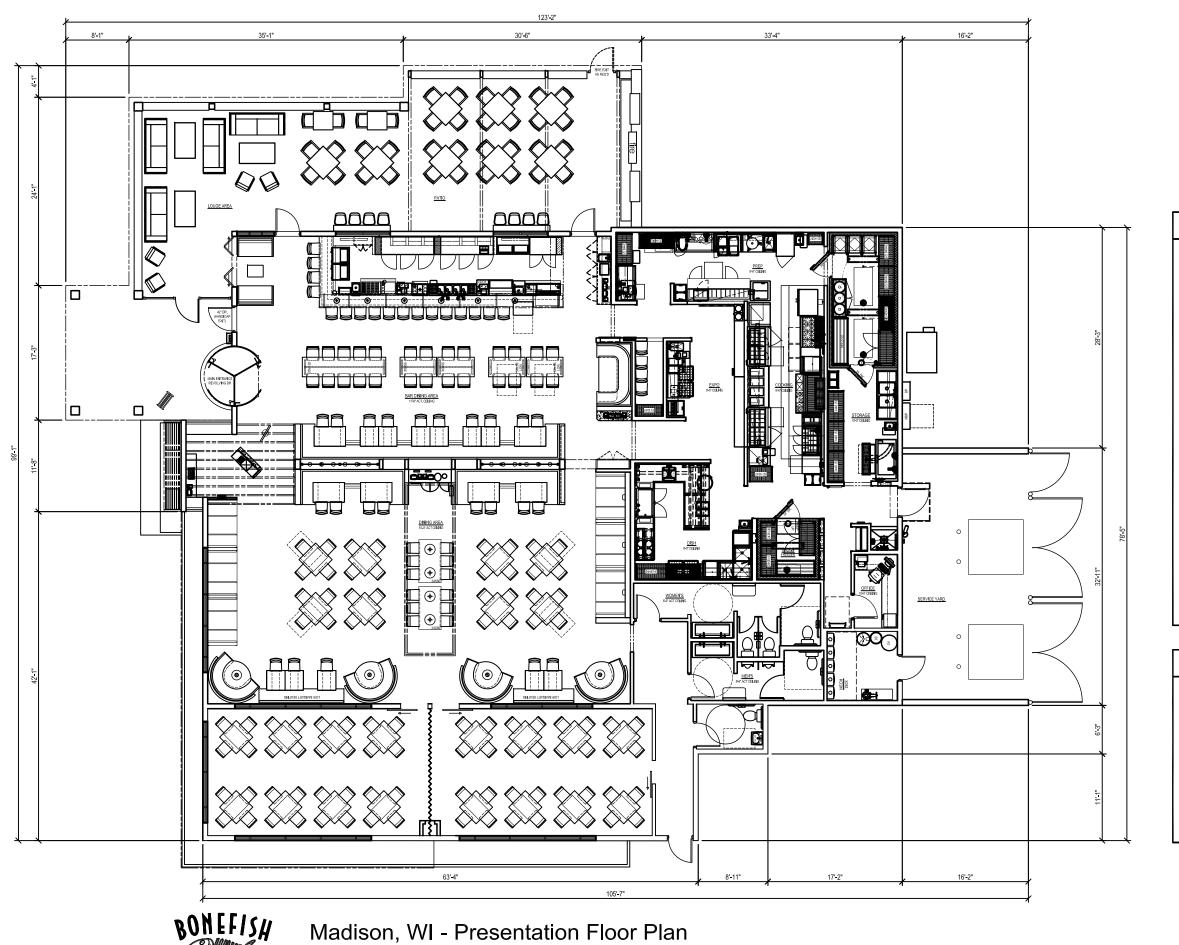

RESTAURANT SEATING INFORMATION				
BAR	TABLE	SEATS		
BAR STOOLS	N/A	17		
2 TOP TABLES	6	12		
4 TOP TABLES	4	16		
5 TOP TABLES	2	10		
7 TOP TABLES	1	7		
8 TOP TABLES	1	8		
	14	70		
DINING	TABLE	SEATS		
2 TOP TABLES	5	10		
4 TOP TABLES	14	56		
5 TOP TABLES	8	40		
6 TOP TABLES	2	12		
	29	118		
PRIVATE DINING	TABLE	SEATS		
4 TOP TABLES	14	56		
PATIO	TABLE	SEATS		
STOOLS	N/A	8		
2 TOP TABLES	2	4		
4 TOP TABLES	8	32		
	10	44		
TOTALS	TABLE	SEATS		
INTERIOR	57	244		
EXTERIOR / PATIO	10	44		
	67	288		

RESTAURANT AREA INFO	ORMATION
BUILDING SQUARE FOOTAGE WAITING BAR DINING PRIVATE DINING BOH	SIZE 344 1,245 1,660 1,078 2,180
TOTAL ADDITIONAL SQUARE FOOTAGE PATIO LOUNGE / PORCH	6,506 <u>SIZE</u> 843 460

BONEFISH GRILL

2013 Greenfield PDR Prototype (expanded) w/ Patio

11 13











Madison, WI - Presentation Elevations
In-line Greenfield PDR w/ Patio

10.11.13 0 2 4 8 16

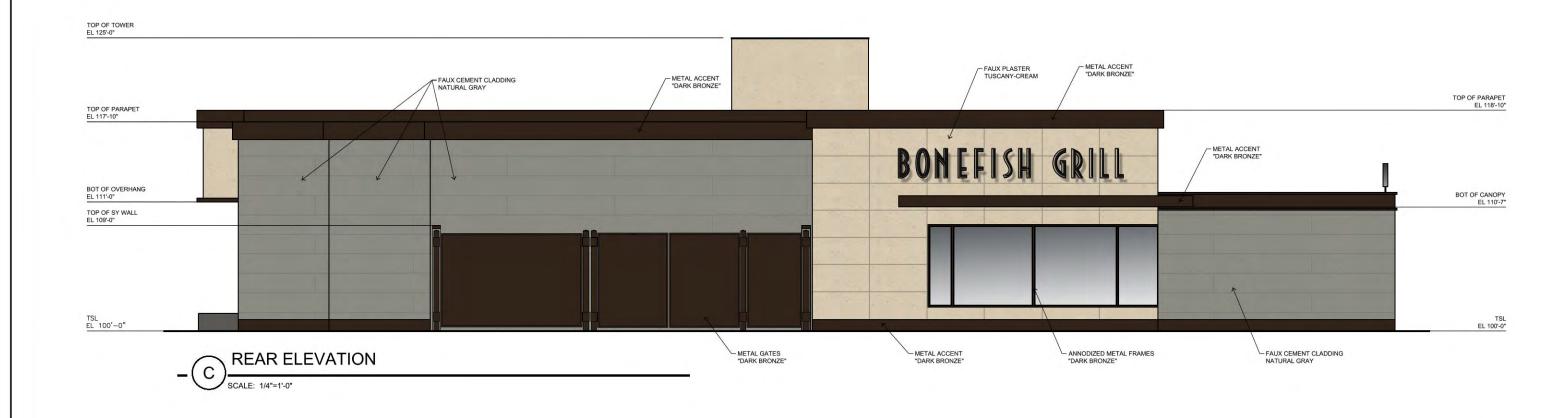

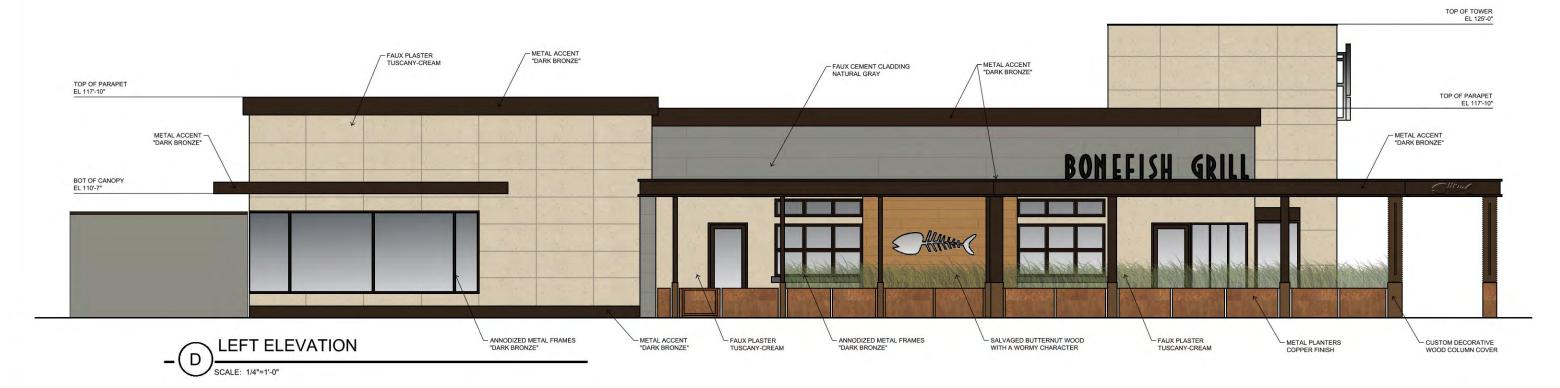




Madison, WI - Presentation Elevations
In-line Greenfield PDR w/ Patio


10.11.13



AMERICAN FIBER CEMENT CORPORATION FAUX CEMENT CLADDING EXTERIOR WALLS NATURA TC --COLOR: NATURAL GRAY (#N250)

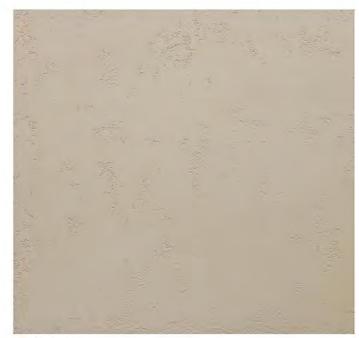

TEXSTON
STUCCO FINISH
EXTERIOR WALLS
TUSCANY COLOR CODE: VPC-4643D-091613

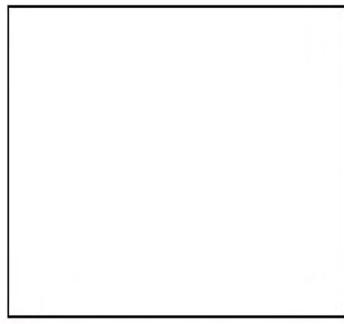

TBD
FLOORING & LOW PLANT BEDS
SPEC UNDETERMINED
COLOR TO BE DARK CHARCOAL



CWC
BUTTERNUT WOOD PLANKING
EXTERIOR FEATURE WALL



PORCELONOSA USA IRONKER/COBRE TILE ABOVE FIRE PIT




PRISMATIC POWDERS
POWDER COATING
BLACK BRONZE II




TBD
CUSTOM EXTERIOR PLANTERS

BONEFISHGRILL


'Greenfield' Exterior Finishes

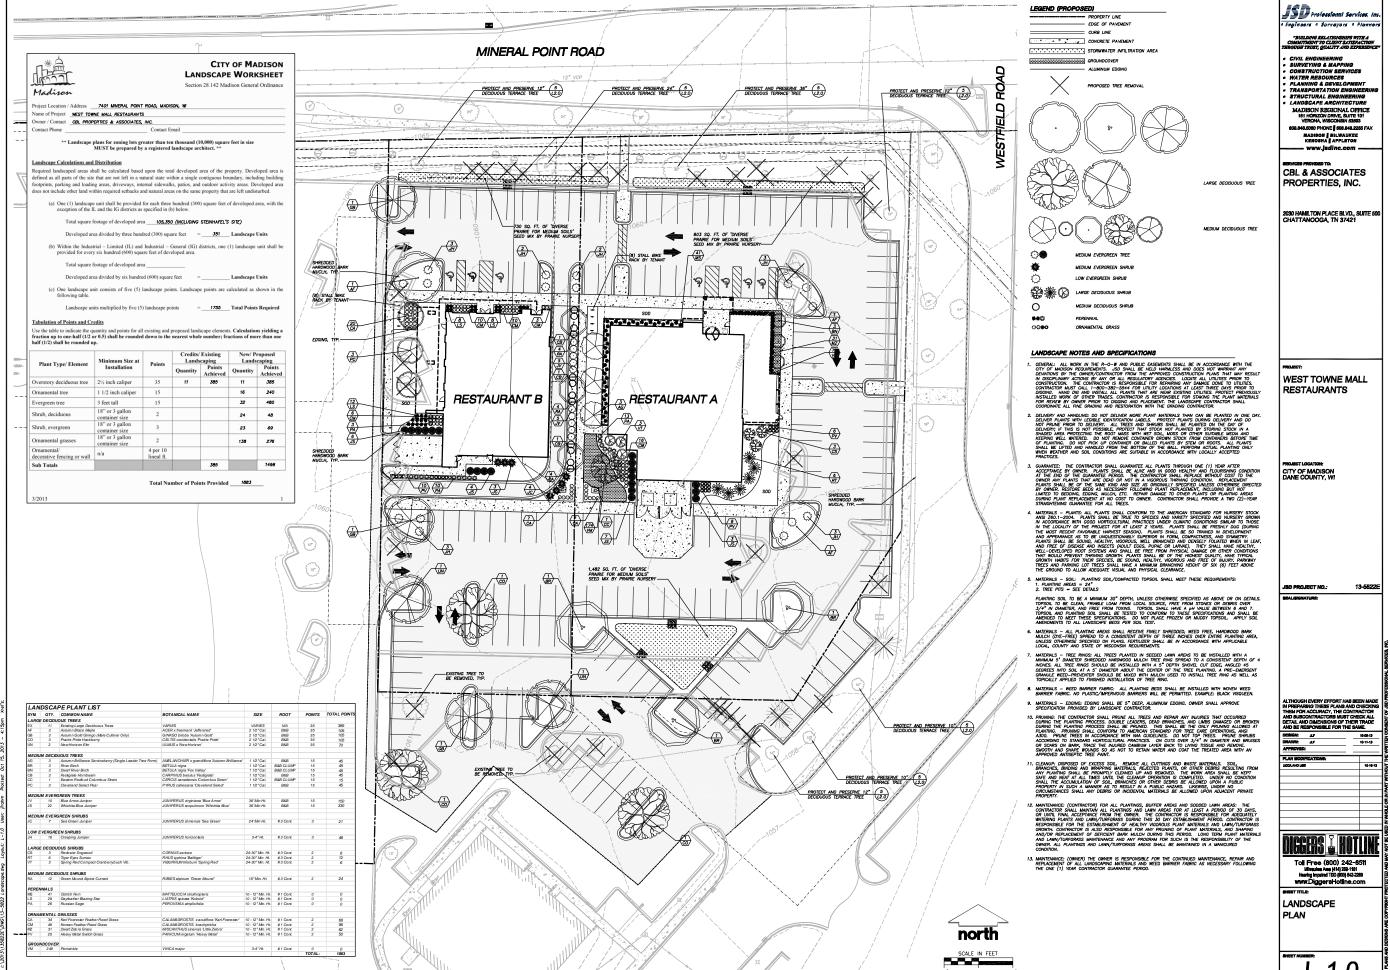



L-1.0

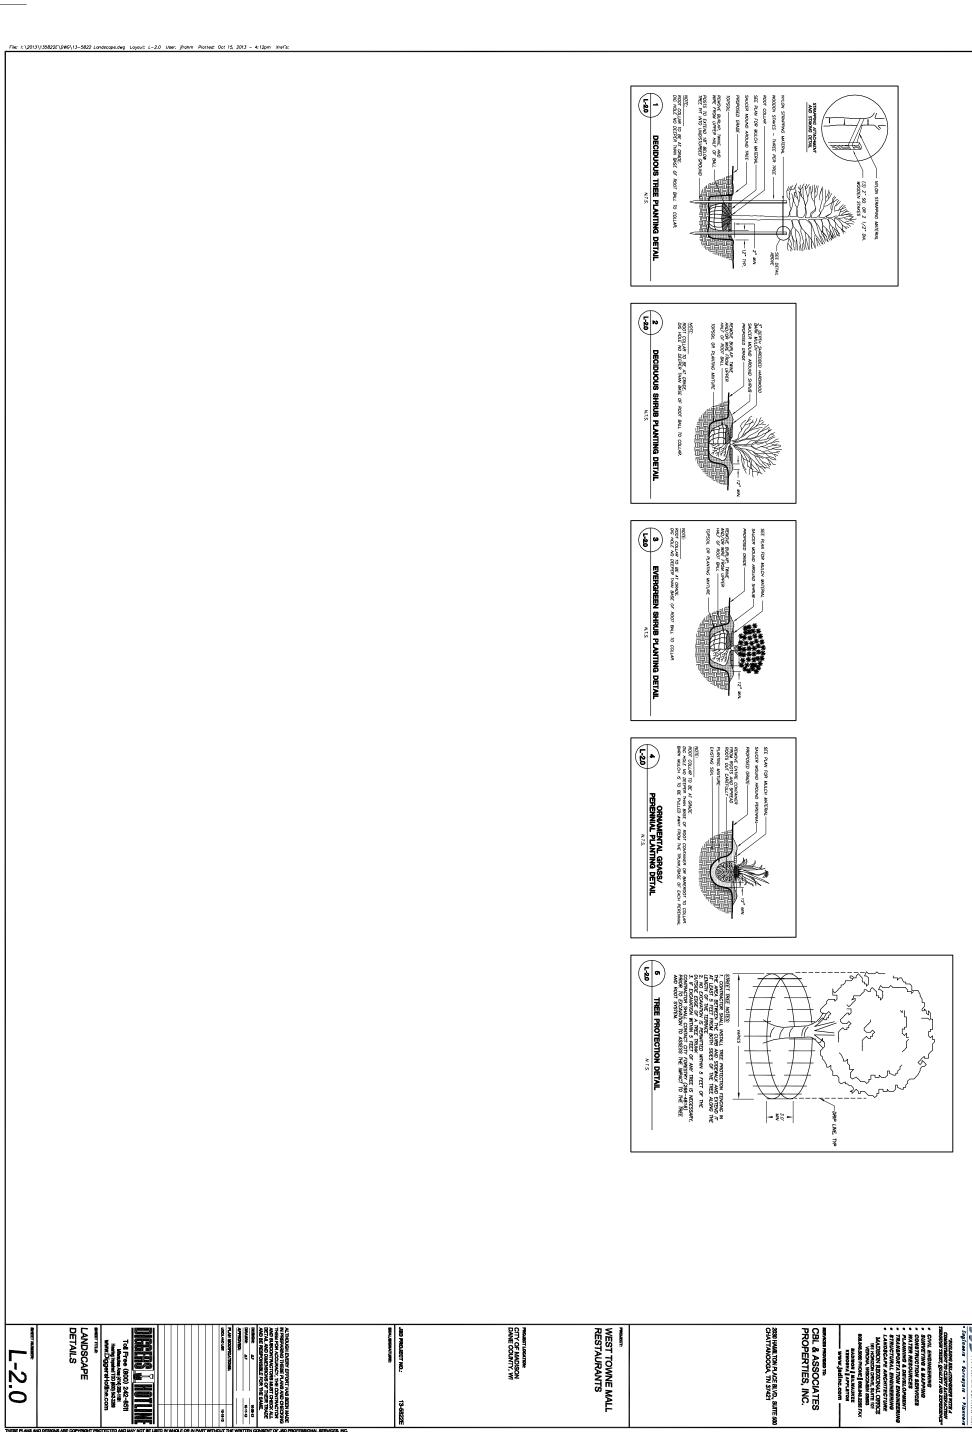


Ingliseers - Surveyors - Planners "BULDING RELATIONSHIPS WITH A CHAITMENT TO CLIEVT SATERACTION ODGH TRUST, QUALITT AND ECPERUSY.E'

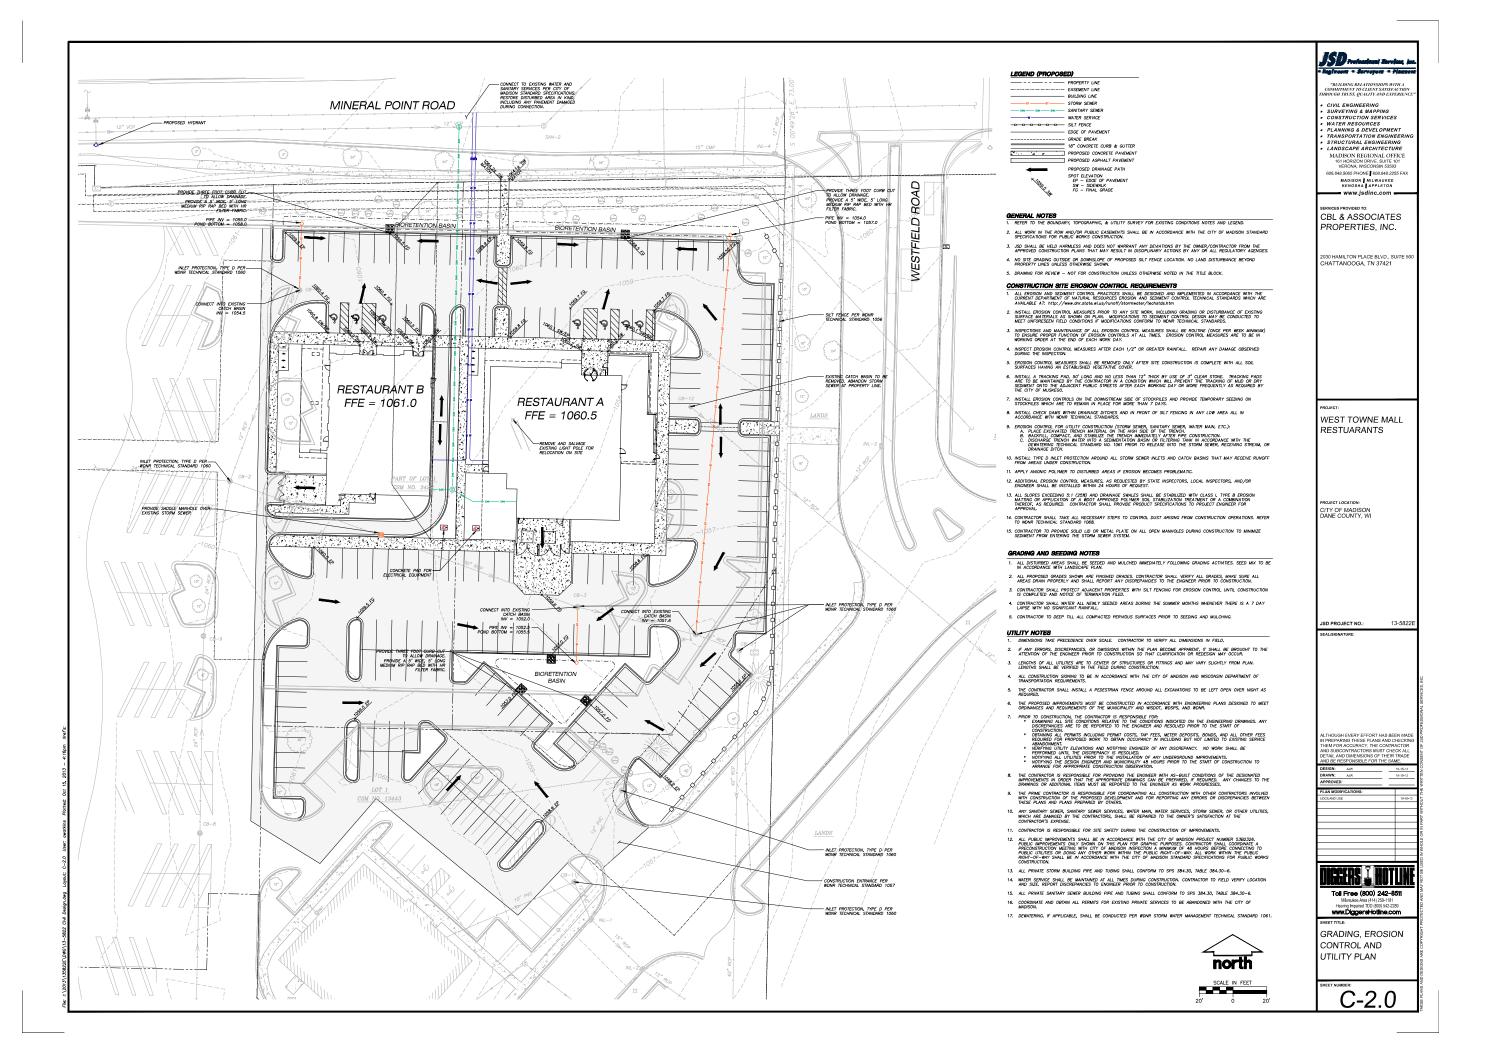

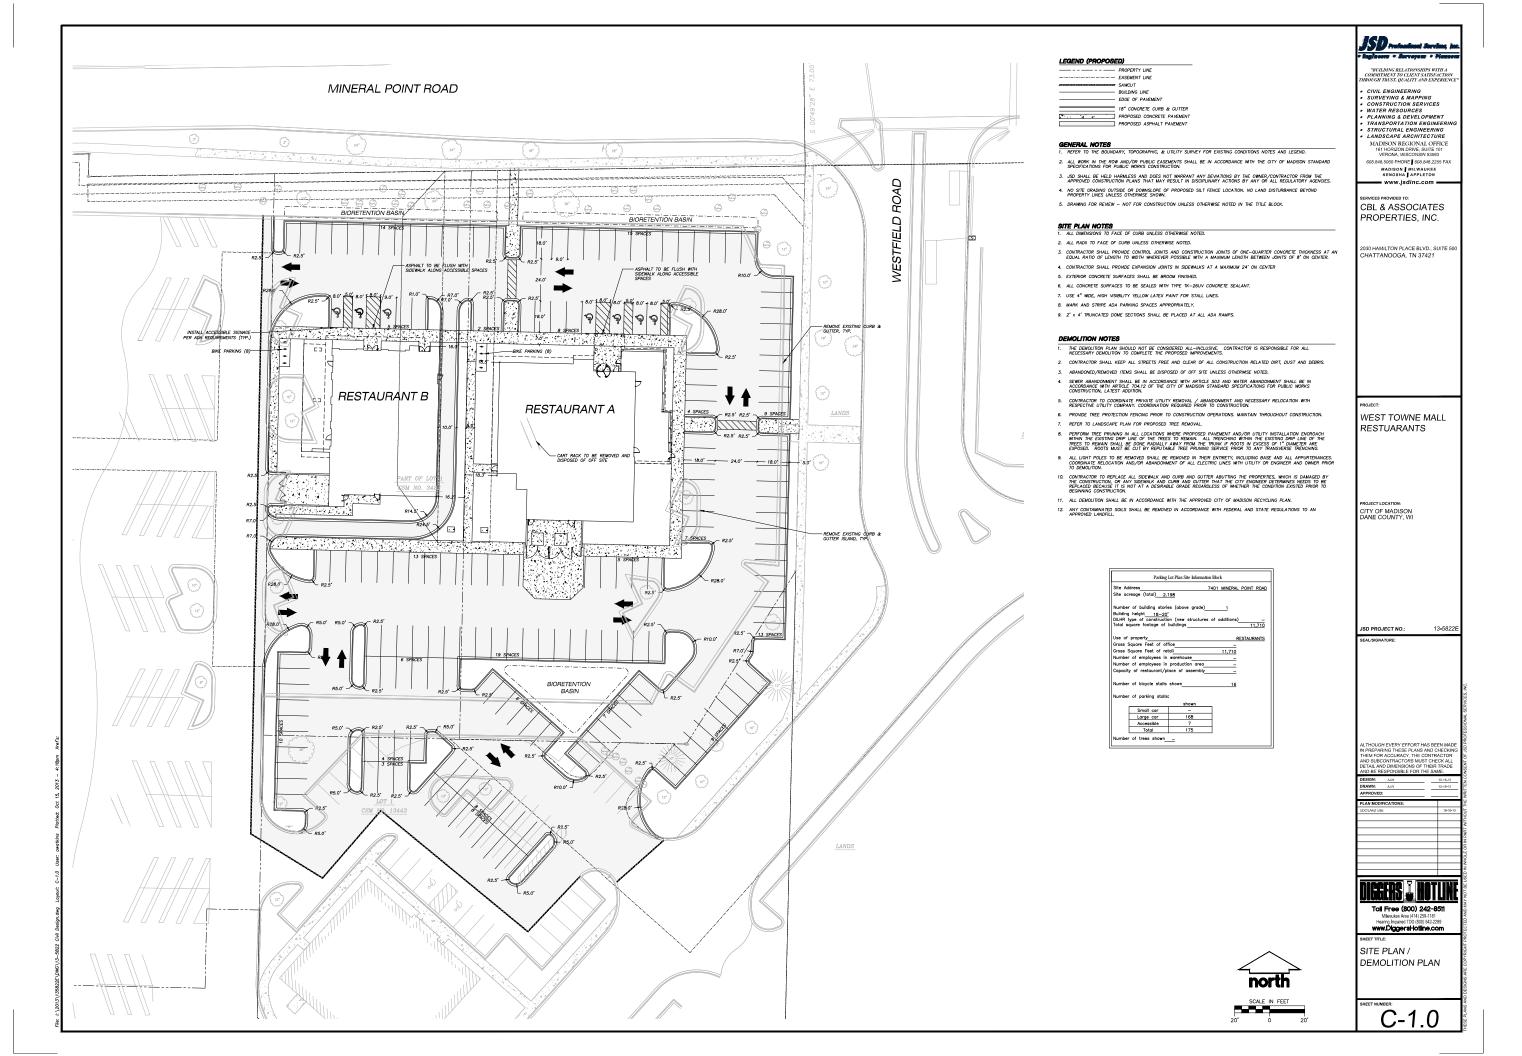

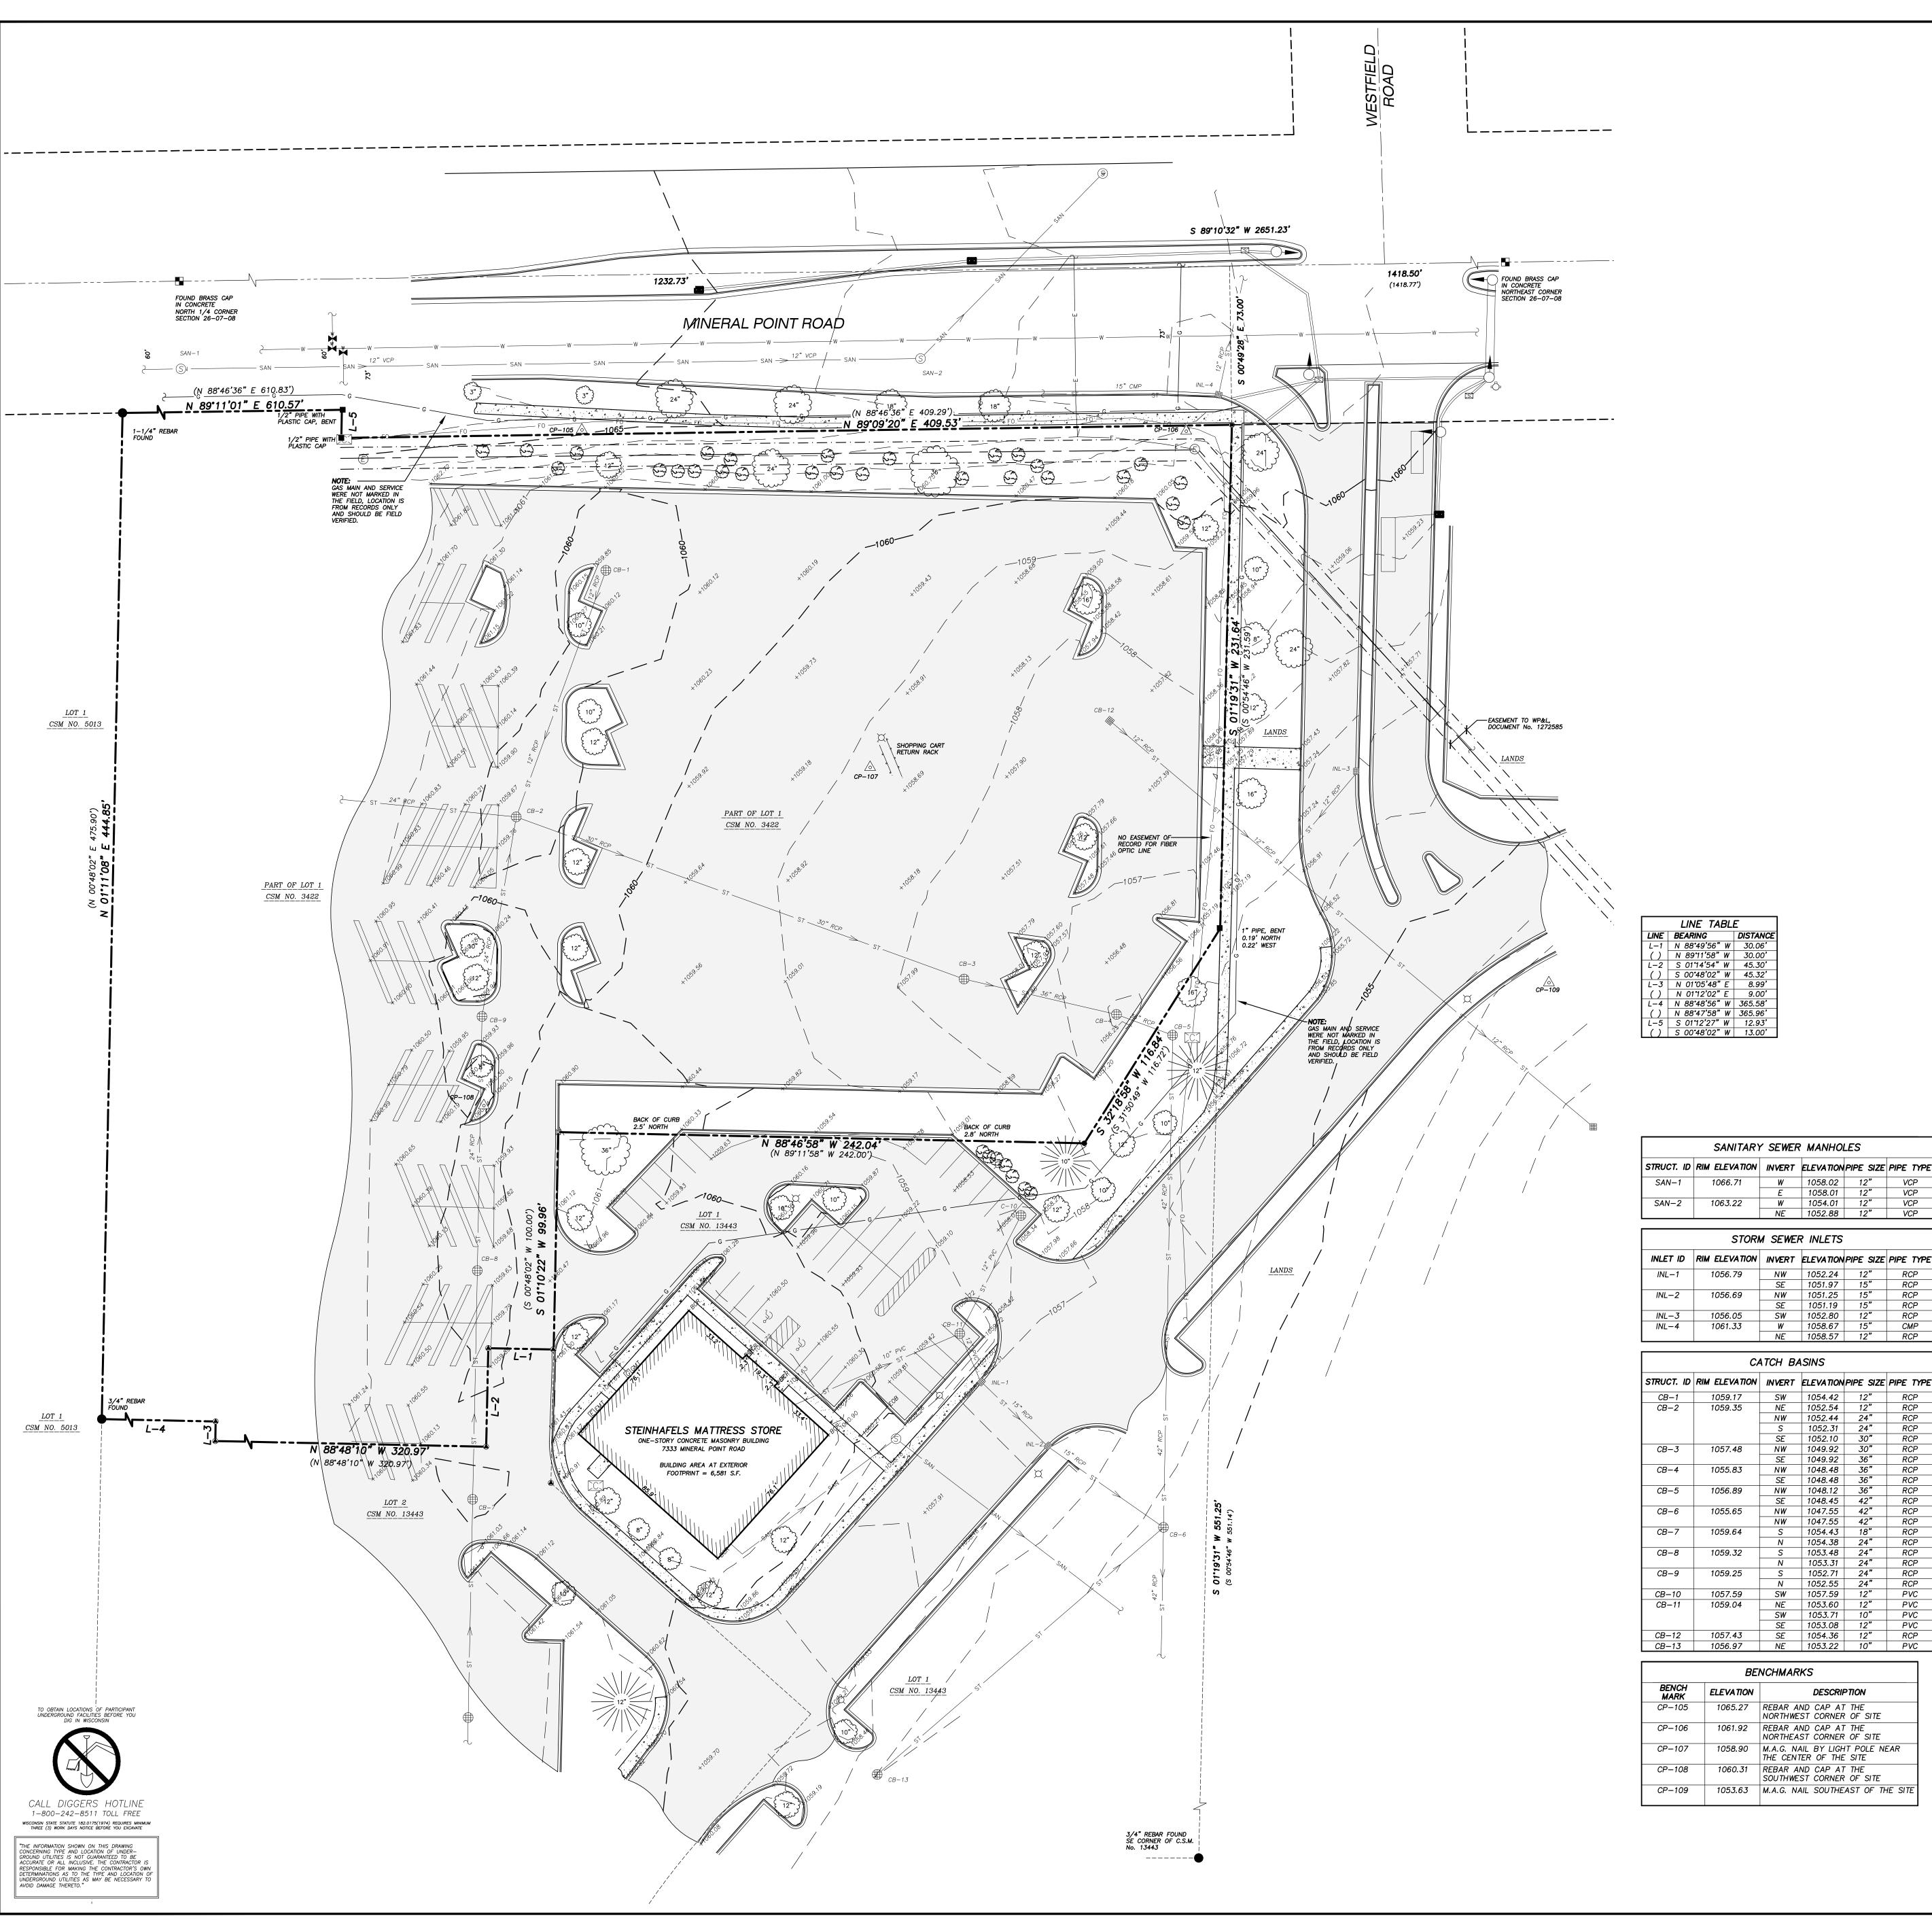

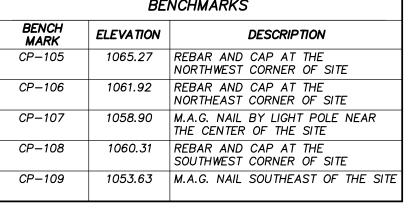

BENCHMARKS								
BENCH MARK	ELEVATION	DESCRIPTION						
P-105	1065.27	REBAR AND CAP AT THE NORTHWEST CORNER OF SITE						
CP-106	1061.92	REBAR AND CAP AT THE NORTHEAST CORNER OF SITE						
P-107	1058.90	M.A.G. NAIL BY LIGHT POLE NEAR THE CENTER OF THE SITE						
P-108	1060.31	REBAR AND CAP AT THE SOUTHWEST CORNER OF SITE						
P-109	1053.63	M.A.G. NAIL SOUTHEAST OF THE SITE						

BENCHMARKS									
CH PK	ELEVATION	DESCRIPTION							
05	1065.27	REBAR AND CAP AT THE NORTHWEST CORNER OF SITE							
06	1061.92	REBAR AND CAP AT THE NORTHEAST CORNER OF SITE							
07	1058 90	MAC NAIL BY LIGHT POLE NEAR							

1058.67

BENCHMARKS		
H K	ELEVATION	DESCRIPTION
)5	1065.27	REBAR AND CAP AT THE NORTHWEST CORNER OF SITE
06	1061.92	REBAR AND CAP AT THE NORTHEAST CORNER OF SITE
) <i>7</i>	1058.90	M.A.G. NAIL BY LIGHT POLE NEAR THE CENTER OF THE SITE
18	1060.31	REBAR AND CAP AT THE SOUTHWEST CORNER OF SITE

CBL & ASSOCIATES PROPERTIES, INCORPARATED 2030 HAMILTON PLACE BOULEVARD, SUITE 500

CHATTANOOGA, TN 37421

SCALE 1" = 30'PREPARED FOR:

SURVEYED: PB/JK F.B. NO/PG: 225/72 SHEET NO: <u>1 OF 2</u>

PROJECT NO: 13-5822 FILE NO: <u>E-172</u>

SURVEYOR'S CERTIFICATE I, JOHN KREBS, WISCONSIN REGISTERED LAND SURVEYOR NO. S-1878, HEREBY CERTIFY THAT THIS EXISTING CONDITIONS SURVEY AND MAP IS CORRECT TO THE BEST OF MY KNOWLEDGE AND BELIEF IN ACCORDANCE WITH THE INFORMATION PROVIDED. JOHN KREBS, S-1878 REGISTERED LAND SURVEYOR

PART OF LOT 1 OF DANE COUNTY CERTIFIED SURVEY MAP No. 3422, RECORDED IN VOLUME 13, ON PAGES 250-253, AS DOCUMENT No. 1657742, LOCATED IN PART OF THE NORTHWEST QUARTER OF THE NORTHEAST QUARTER OF SECTION 26, TOWNSHIP 07 NORTH, RANGE 08 EAST, CITY OF MADISON, DANE COUNTY, WISCONSIN.

LEGAL DESCRIPTION

9. THIS PARCEL IS SUBJECT TO ALL EASEMENTS AND AGREEMENTS, BOTH RECORDED AND UNRECORDED. 10. SITE LIGHTING CONNECTION WERE NOT MARKED IN THE FIELD.

UNDERGROUND UTILITIES, CONTACT DIGGERS HOTLINE, AT 1.800.242.8511. 8. THE ACCURACY OF THE BENCHMARKS SHOWN ON THIS MAP SHALL BE VERIFIED BEFORE BEING UTILIZED. JSD PROFESSIONAL SERVICES, INC. DOES NOT WARRANT THE ACCURACY OF THESE BENCHMARKS.

SURFICIAL FEATURES AND APPURTENANCES, LOCATING DIGGERS HOTLINE FIELD MARKINGS AND BY REFERENCE TO UTILITY RECORDS AND MAPS. DIGGER'S HOTLINE TICKET NO. 20133511087. 7. BEFORE EXCAVATION, APPROPRIATE UTILITY COMPANIES SHOULD BE CONTACTED. FOR EXACT LOCATION OF

6. SUBSURFACE UTILITIES AND FEATURES SHOWN ON THIS MAP HAVE BEEN APPROXIMATED BY LOCATING

4. CONTOUR INTERVAL IS ONE FOOT. 5. SPOT ELEVATIONS SHOWN ALONG CURB AND GUTTER REFERENCE THE TOP BACK OF CURB.

BRASS CAP IN CONCRETE MONUMENT MARKING THE NORTHEAST CORNER OF SECTION 26, TO7N, RO8E, ELEVATION = 1040.01

COUNTY, THE NORTH LINE OF THE NORTHEAST QUARTER, BEARS S 89"10'32" W. 3. ELEVATIONS ARE BASED ON THE NORTH AMERICAN VERTICAL DATUM OF 1988 (NAVD88). BENCHMARK IS A

2. BEARINGS FOR THIS SURVEY AND MAP ARE BASED ON THE WISCONSIN COUNTY COORDINATE SYSTEM, DANE

1. FIELD WORK PERFORMED BY JSD PROFESSIONAL SERVICES, INC. THE WEEK OF SEPTEMBER 2, 2013.

—1061— INTERMEDIATE CONTOUR $_{\sqrt{0}}$ SPOT ELEVATION BITUMINOUS PAVEMENT CONCRETE PAVEMENT \sim DISCONTINUED MAPPED PIPE LINE () RECORDED INFORMATION

----G--- NATURAL GAS --- E --- UNDERGROUND ELECTRIC ——FO — FIBER OPTIC <u>///////</u> BUILDING —1060— INDEX CONTOUR

----- EDGE OF PAVEMENT CONCRETE CURB & GUTTER --- ST --- STORM SEWER

GUARD OR SAFETY RAIL

---- CENTERLINE ---- PLATTED LOT LINE —·—·— EASEMENT LINE --- -- LANDSCAPE LIMITS

HANDICAP PARKING --- PARCEL BOUNDARY — - - - — SECTION LINE — — — RIGHT-OF-WAY LINE

DECIDUOUS TREE CONIFEROUS TREE BUSH

SIGNAL CONTROLLER BOX CABLE PEDESTAL

→ TRAFFIC SIGNAL

LIGHT POLE

GAS REGULATOR/METER ELECTRIC MANHOLE

ROUND CASTED INLET SQUARE CASTED INLET CURB INLET

WATER OR GAS VALVE STORM MANHOLE

SANITARY MANHOLE riangle HYDRANT

DRILL HOLE FOUND △ CONTROL POINT

PK/MAG NAIL FOUND ■ IRON PIPE FOUND (SIZE NOTED) ● 3/4" REBAR FOUND

■ GOVERNMENT CORNER



Ingree/Egress Looking West from Site



Existing Parking Area Looking West From S. Westfield Road Entry




Existing Building and Parking Area Looking Southwest from Site



Ingress/Egress Looking Northeast from adjacent West Towne Mall Site



Adjacent Property to Northwest

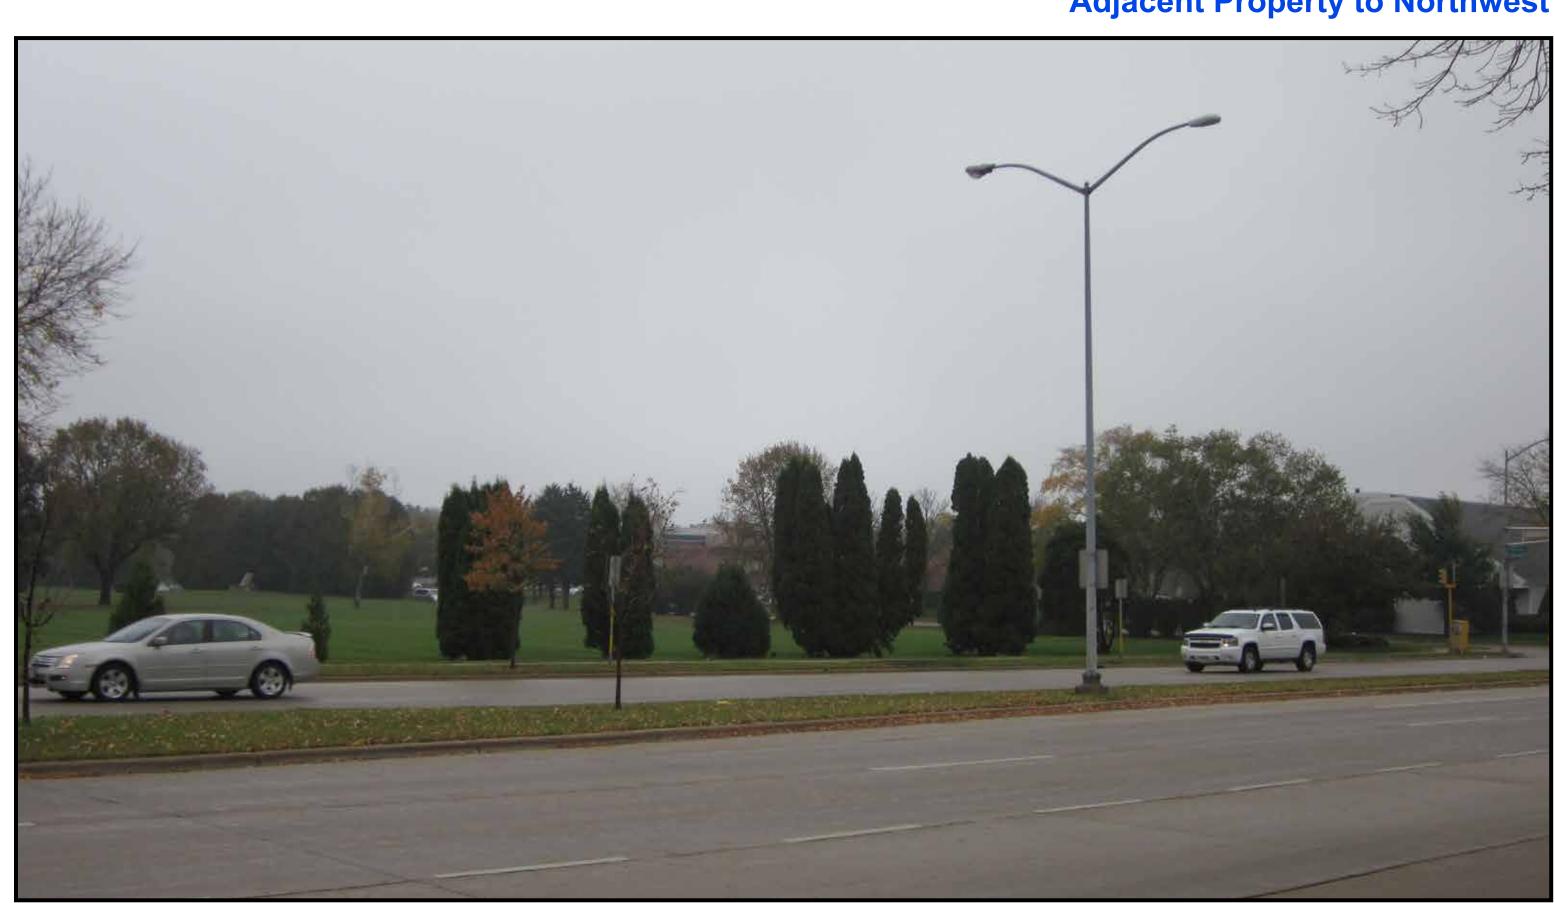

Adjacent Property to North



Adjacent Property to Southwest



S. Westfield Road Intersection







Adjacent Property to Southeast



Adjacent Property to South




Adjacent Property to South



Shopko Property Access Drive West of Site





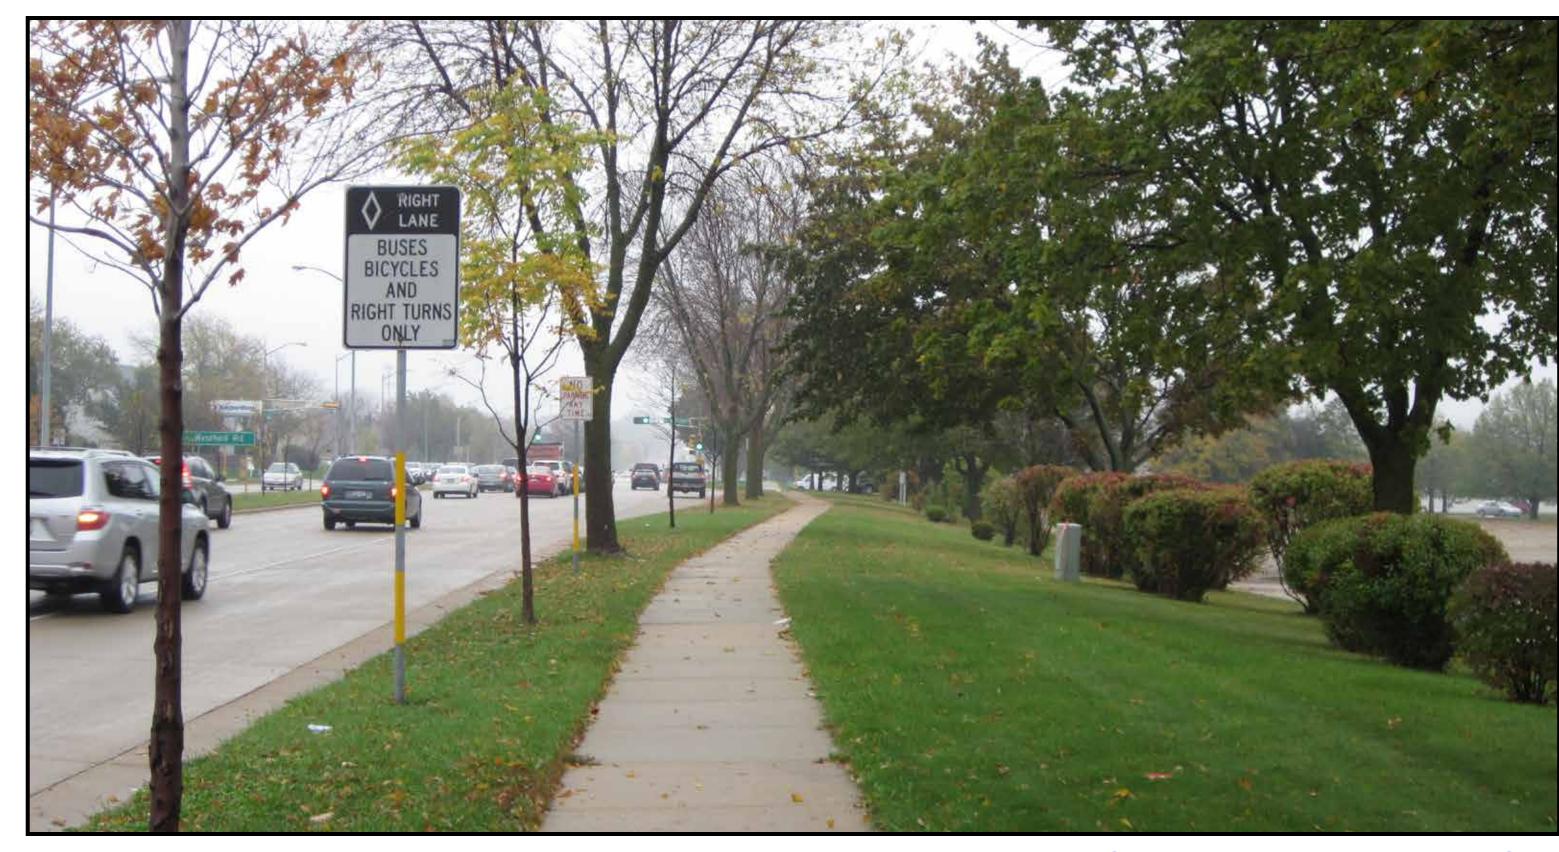

Mineral Point Road Sidewalk Looking East to Site



Parking Area Looking East to Site



Looking Northeast from Site



Looking Southeast from Site







S. Westfield Road Entrance to West Towne Mall Development from Mineral Point



Looking Northwest from Site



Sidewalk Connection to S. Westfield Road Entrance to West Towne Mall Development



Looking East from Site









