

# **City of Madison Fire Department**

314 W Dayton Street, Madison, WI 53703-2506

Phone: 608-266-4420 • Fax: 608-267-1100 • E-mail: fire@cityofmadison.com


| Project Address: 5201 Old Middleton Rd. |  |                            |  |  |
|---|--|----------------------------|--|--|
| Contact Name & Phone #:                 |  | Duane Johnson 608-836-3690 |  |  |

### FIRE APPARATUS ACCESS AND FIRE HYDRANT WORKSHEET

| 1. Is the building completely protected by an NFPA 13 or 13R automatic fire sprinkler system?  If non-sprinklered, fire lanes extend to within 150-feet of all portions of the exterior wall?  If sprinklered, fire lanes are within 250-feet of all portions of the exterior wall?   | X Yes Yes Yes   | No No No           | N/A N/A N/A   |
|---|---|--------------------|---|
| 2. Is the fire lane constructed of concrete or asphalt, designed to support a minimum load of 85,000 lbs?  a) Is the fire lane a minimum unobstructed width of at least 20-feet?  b) Is the fire lane unobstructed with a vertical clearance of at least 13½-feet?  c) Is the minimum inside turning radius of the fire lane at least 28-feet?  d) Is the grade of the fire lane not more than a slope of 8%?  e) Is the fire lane posted as fire lane? (Provide detail of signage.)  f) Is a roll-able curb used as part of the fire lane? (Provide detail of curb.)  g) Is part of a sidewalk used as part of the required fire lane? (Must support +85,000 lbs.)                                     | X Yes | No                 | <ul> <li>N/A</li> <li>N/A</li> <li>N/A</li> <li>N/A</li> <li>N/A</li> <li>N/A</li> <li>N/A</li> <li>N/A</li> <li>N/A</li> </ul> |
| 3. Is the fire lane obstructed by security gates or barricades? If yes:  a) Is the gate a minimum of 20-feet clear opening? b) Is an approved means of emergency operations installed, key vault, padlock or key switch?  | ☐ Yes<br>☐ Yes<br>☐ Yes   | No<br>  No<br>  No | N/A N/A N/A   |
| 4. Is the Fire lane dead-ended with a length greater than 150-feet?  If yes, does the area for turning around fire apparatus comply with IFC D103?  | Yes Yes   | X No<br>No         | N/A<br>N/A  |
| 5. Is any portion of the building to be used for high-piled storage in accordance with IFC Chapter 3206.6 If yes, see IFC 3206.6 for further requirements.  | Yes   | X No               | □ N/A   |
| 6. Is any part of the building greater than 30-feet above the grade plane?  | X Yes   | ☐ No               | □ N/A   |
| If yes, answer the following questions:  a) Is the aerial apparatus fire lane parallel to one entire side of the building and covering at least   | X Yes   | □No                | □ N/A   |
| <ul> <li>25% of the perimeter?</li> <li>b) Is the near edge of the aerial apparatus fire lane between 15' and 30' from the building?</li> <li>c) Are there any overhead power or utility lines located across the aerial apparatus fire lane?</li> <li>d) Are there any tree canopies expected to grow across the aerial fire lane? (Based on mature canopy width of tree species)</li> <li>e) Does the aerial apparatus fire lane have a minimum unobstructed width of 26-feet?</li> <li>f) Is the space between the aerial lane and the building free of trees exceeding 20' in heights?</li> <li>7. Are all portions of the required fire lanes within 500-feet of at least (2) hydrants?</li> </ul> | X Yes     ☐ Yes     ☐ Yes     X Yes     X Yes     X Yes     X Yes             | No No No No        | N/A   |

Attach an additional sheet if further explanation is required for any answers.

This worksheet is based on MGO 34.503 and IFC 2015 Edition Chapter 5 and Appendix D; please see the codes for further information.

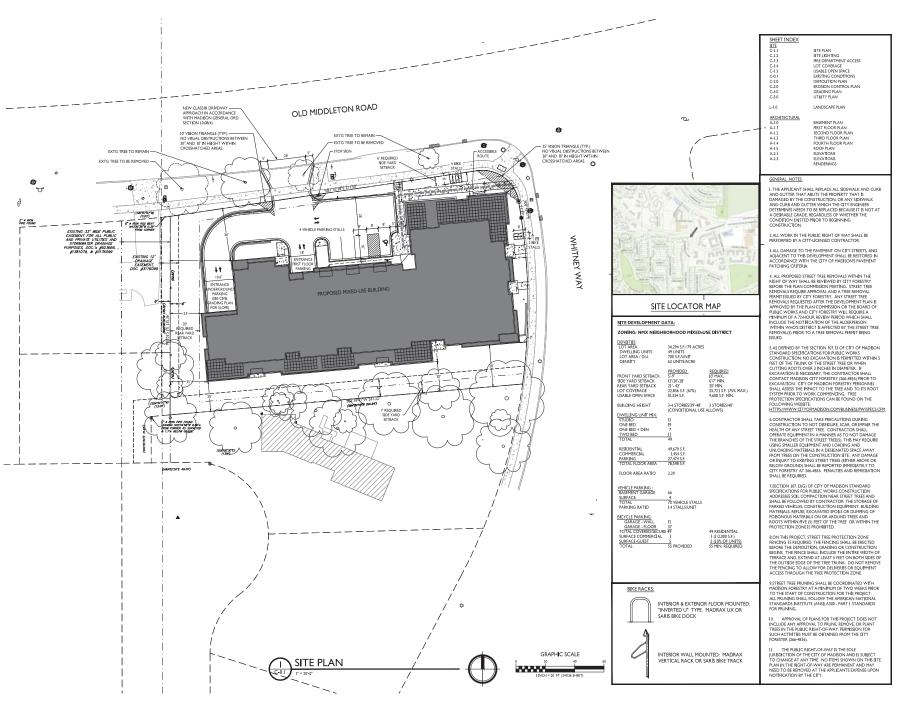



UED

ISSUED Issued for UDC Info - August 19, 2020

PROJECT TITLE
Old Middleton Rd.
Development
5201 Old Middleton Rd.

SHEET TITLE
Site Plan

SHEET NUMBER

C-1.1


ROJECT NO. 2012
Knothe & Bruce Architects, LLC



# OLD MIDDLETON ROAD

| STATISTICS                             |        |        |        |        |             |             |
|--|--------|--------|--------|--------|-------------|-------------|
| DESCRIPTION                            | SYMBOL | AVG.   | MAX.   | MIN.   | MAX. / MIN. | AVG. / MIN. |
| Parking Area Lighting                  | +      | 0.7 fc | 1.8 fc | 0.2 fc | 9.0:1       | 3.5:1       |
| Upper Parking Garage Entrance Lighting | +      | 1.5 fc | 5.9 fc | 0.4 fc | 14.8:1      | 3.8:1       |
| Lower Parking Garage Entrance Lighting | +      | 1.3 fc | 5.6 fc | 0.1 fc | 56.0:1      | 13.0:1      |

| NAIR  | E S        | CHEDULE              |   |   |   |  |
|-------|------------|----------------------|---|---|---|--|
| LABEL | QTY        | r. Manuf.            | CATALOG   | DESCRIPTION   | FILE  | MOUNTING   |
| Α     | I          | LITHONIA<br>LIGHTING | DSX0 LED PI 30K<br>T4M MVOLT HS                                 | DSX0 LED PI 30K T4M<br>MVOLT WITH HOUSE<br>SIDE SHIELD  | DSX0_LED_PI_30K_T4M<br>_MVOLT_HS.les  | 18'-0" POLE<br>ON 2'-0" TALL<br>CONC. BASE   |
| В     | 3          | LITHONIA<br>LIGHTING | LIL LED 30K MVOLT   | LIL WALLPACK<br>(STANDARD)  | LIL_LED_30K_MVOLT.ies   | 8'-0" ABOVE<br>GRADE ON<br>BUILDING  |
|       |            |                      | EXAMPLE LIGHT   | ISOLUX CON  | ITOUR = 0.25 FC<br>ITOUR = 0.5 FC<br>ITOUR = 1.0 FC   |  |
|       |            |                      |   |   |   |  |
|       | LABEL<br>A | LABEL QT             | LABEL QTY. MANUF.  A I LITHONIA LIGHTING  B 3 LITHONIA LIGHTING | A I LITHONIA DSX0 LED PI 30K T4M MVOLT HS  B 3 LITHONIA LIGHTING UL LED 30K MVOLT LIGHTING  EXAMPLE LIGHT | LABEL QTY. MANUF. CATALOG DESCRIPTION  A I LITHONIA DESCRIPTION DESCRIPTION  B 3 LITHONIA LILED JOK MYOLT HS SIDE SHELD  EXAMPLE LIGHT FIXTURE DISTRI | LABEL QTY. MANUF. CATALOG DESCRIPTION FILE  A I LITHONIA DSX0 LED P1 30K DSX0 LED P1 30K DSX0 LED P1 30K TAM DSX0 LED P1 30K DSX0 LED P1 30K TAM D |

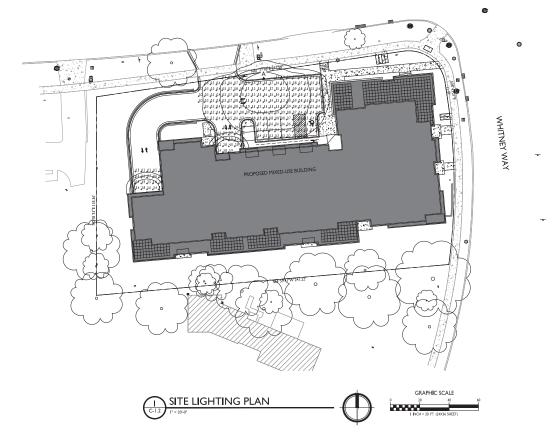


ISSUED Issued for Land Use Submittal - Sept. 2, 2020

PROJECT TITLE
Old Middleton Rd.
Development
5201 Old Middleton Rd.

SHEET TITLE
Site Lighting Plan

SHEET NUMBER

PROJECT NO. 2012

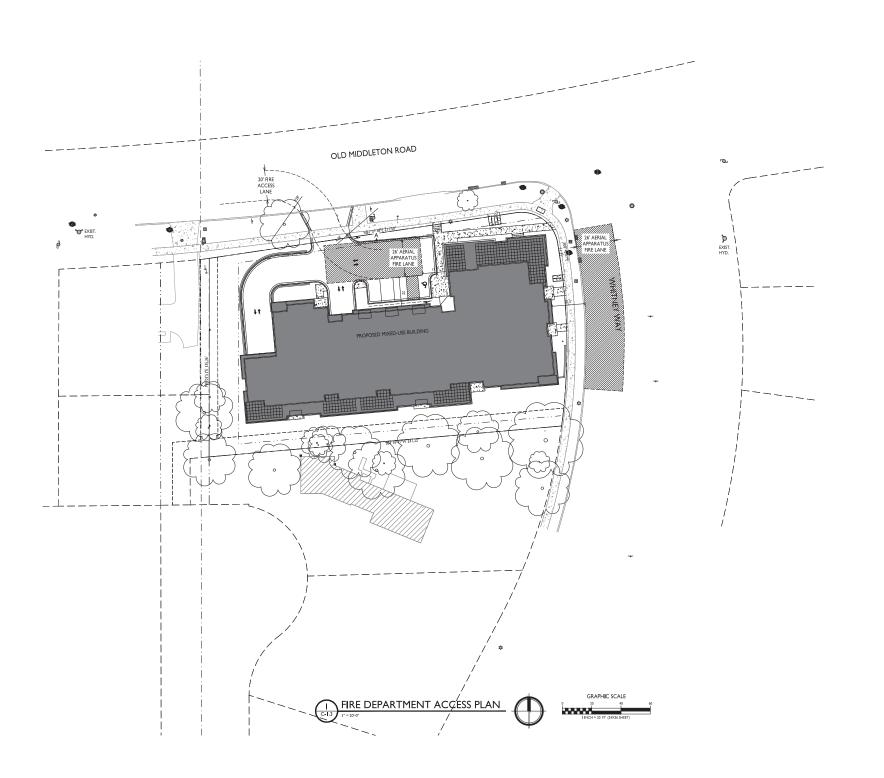



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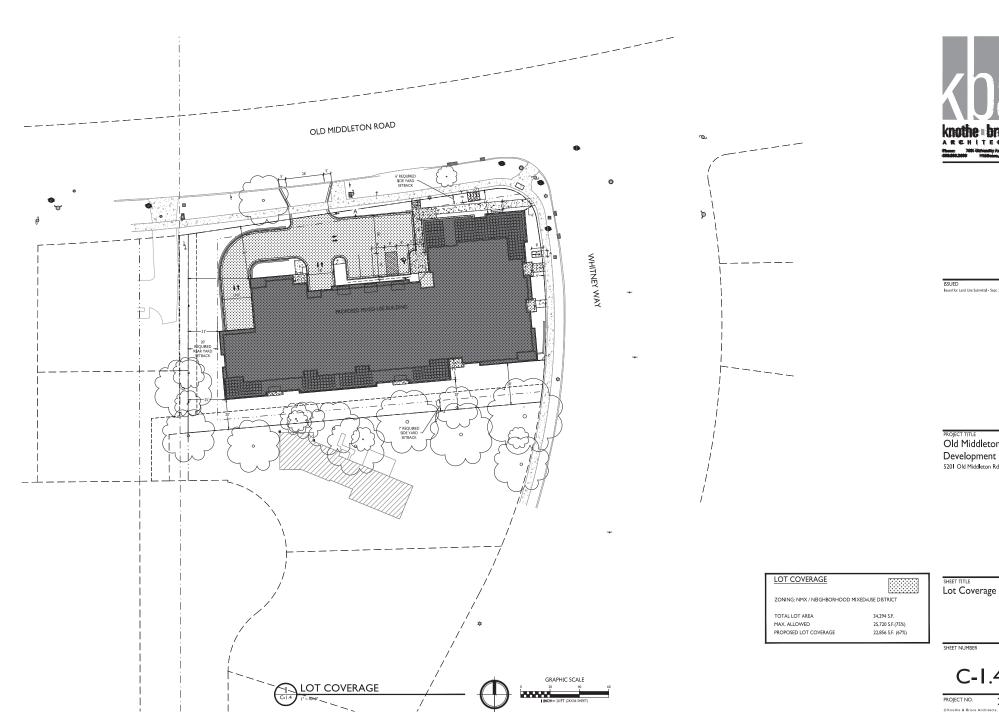
PROJECT TITLE
Old Middleton Rd.
Development
5201 Old Middleton Rd.

SHEET TITLE
Fire Department
Access Plan

SHEET NUMBER

C-1.3

PROJECT NO. 2012






ISSUED Issued for Land Use Submittal - Sept. 2, 2020

PROJECT TITLE
Old Middleton Rd. Development 5201 Old Middleton Rd.

SHEET NUMBER

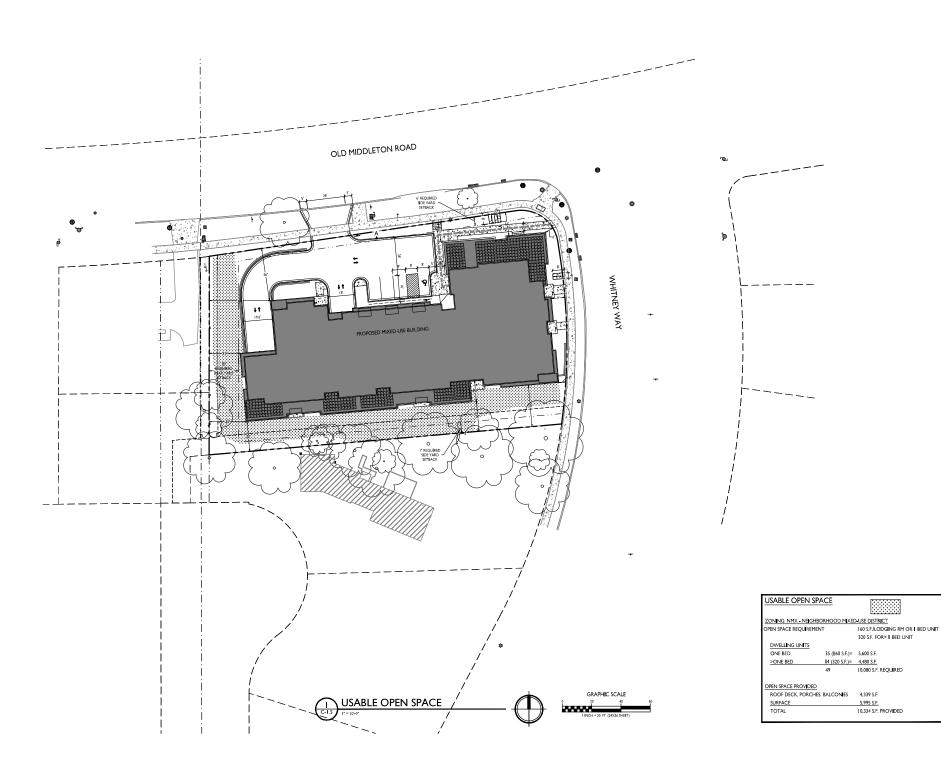




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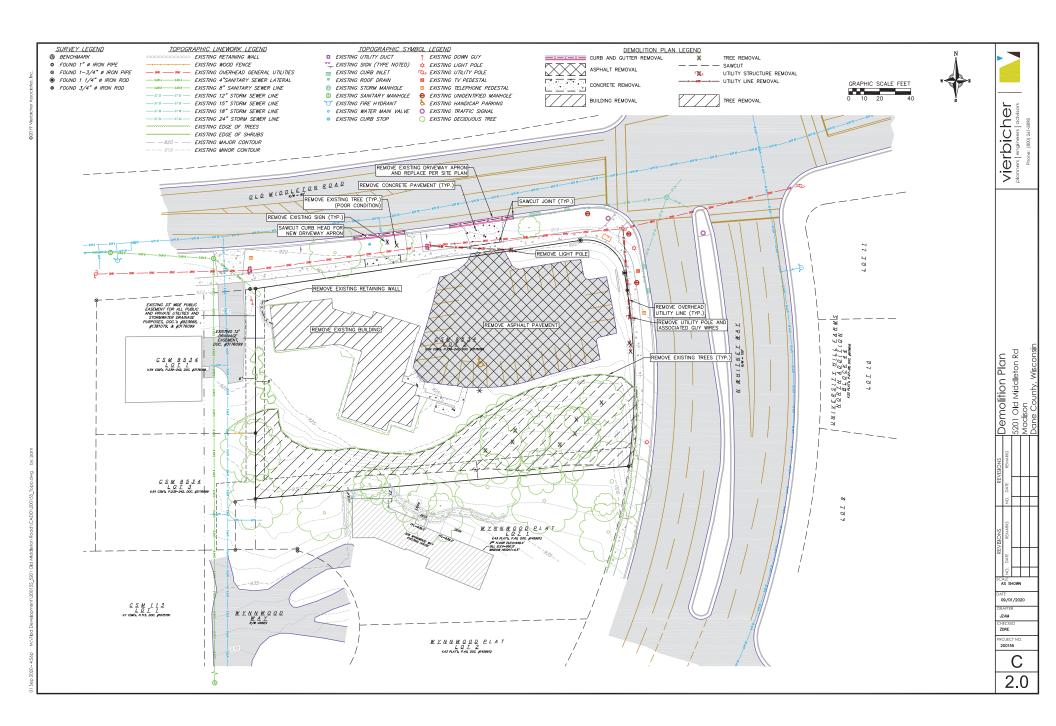
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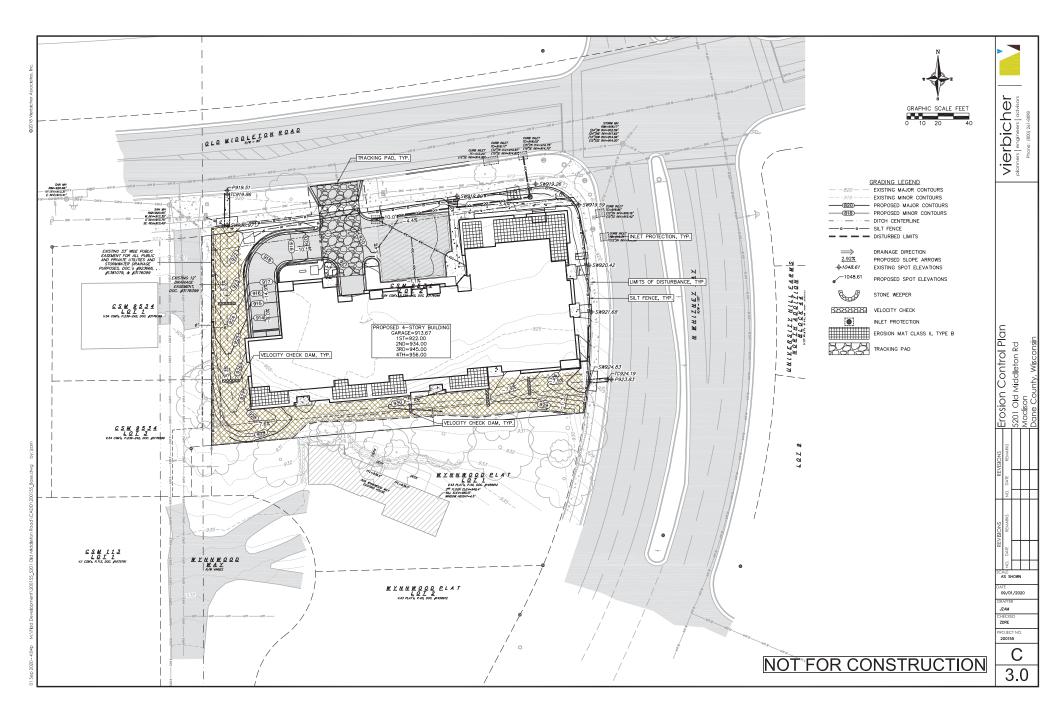
SHEET TITLE Usable Open Space


5,995 S.F. 10,334 S.F. PROV**I**DED


SHEET NUMBER





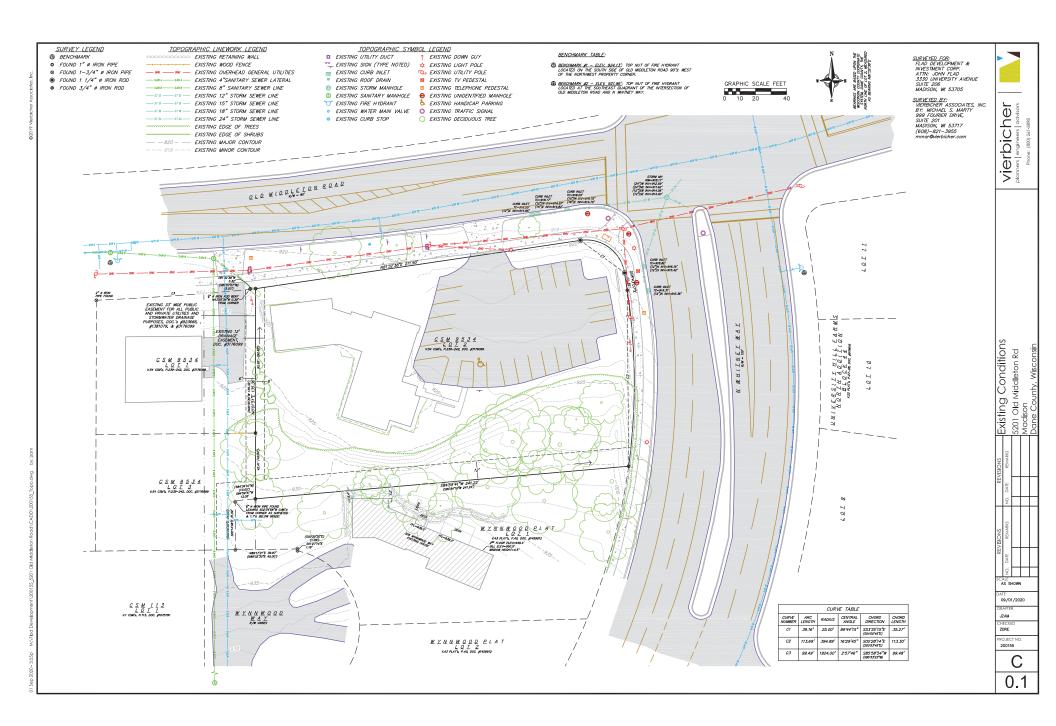

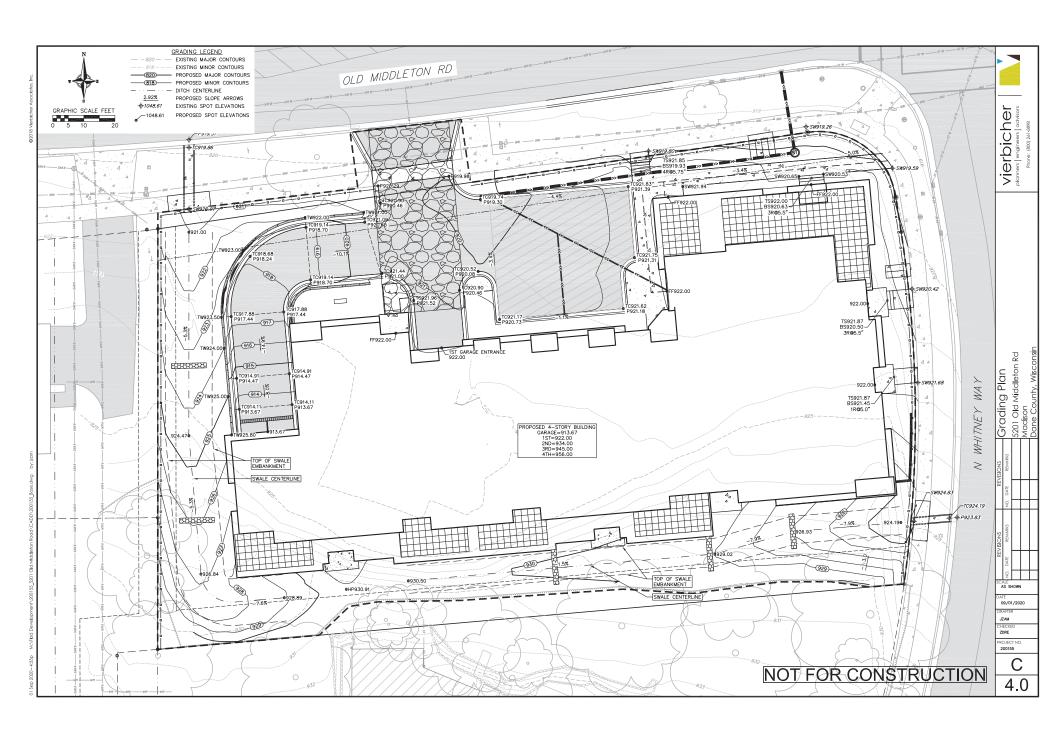

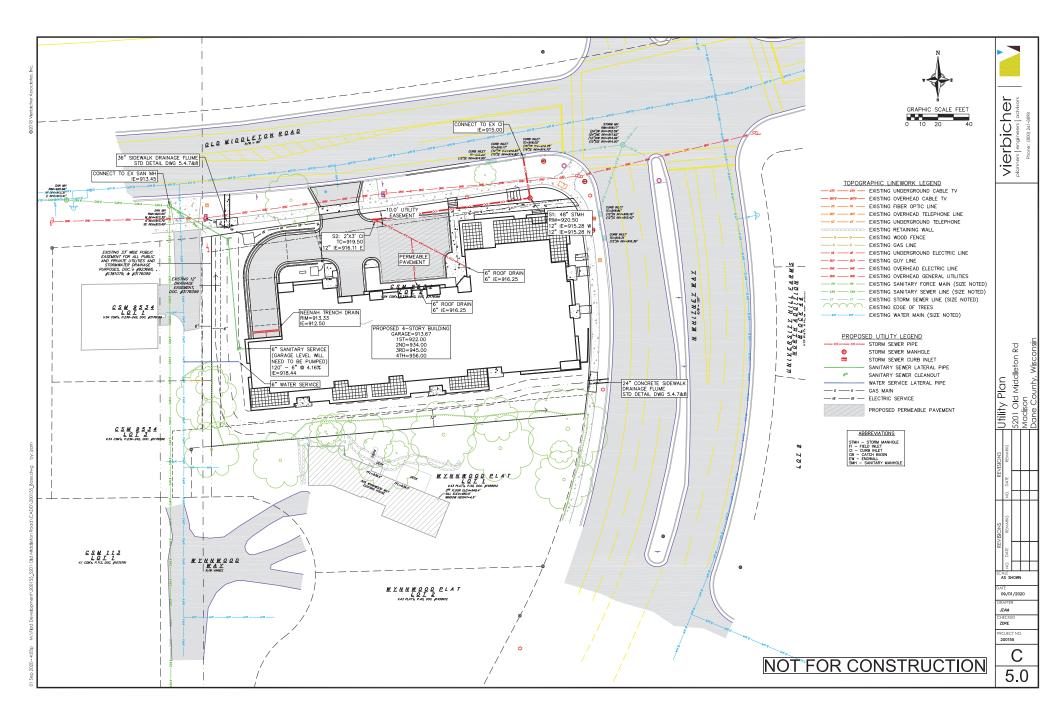

# EROSION CONTROL MEASURES

- 1. EROSION CONTROL SHALL BE IN ACCORDANCE WITH THE CITY OF MADISON EROSION CONTROL ORDINANCE AND CHAPTER NR 216 OF THE WISCONSIN ADMINISTRATIVE CODE.
- 2. CONSTRUCT AND MAINTAIN ALL EROSION AND SEDIMENT CONTROL MEASURES IN ACCORDANCE WITH WISCONSIN DNR TECHNICAL STANDARDS (http://dnr.wi.gov/runoff/stormwater/techstds.htm) AND WISCONSIN CONSTRUCTION SITE BEST MANAGEMENT PRACTICE HANDBOOK.
- 3. INSTALL SEDIMENT CONTROL PRACTICES (TRACKING PAD, PERIMETER SILT FENCE, SEDIMENT BASINS, ETC.) PRIOR TO INITIATING OTHER LAND DISTURBING CONSTRUCTION ACTIVITIES.
- 4. THE CONTRACTOR IS REQUIRED TO MAKE EROSION CONTROL INSPECTIONS AT THE END OF EACH WEEK AND WHEN 0.5 INCHES OF RAIN FALLS WITHIN 24 HOURS, INSPECTION FROM THE PROPER SHALL BE PREPARED AND FILED AS REQUIRED BY THE DNR AND/OR CITY. ALL MAINTENANCE WILL FOLLOW AN INSPECTION WITHIN 24 HOURS.
- 5. EROSION CONTROL IS THE RESPONSIBILITY OF THE CONTRACTOR UNTIL ACCEPTANCE OF THIS PROJECT. EROSION CONTROL MEASURES AS SHOWN SHALL EROSION CONTINCT, IN PRECAUTIONS THAT WILL BE ALLOWED. ADDITIONAL EROSION CONTINCT MEASURES AS SHOWN SHALL BE STATE OR LOCAL INSPECTORS, OR THE DEVELOPER'S ENGINEER, SHALL BE INSTALLED WITHIN 24 HOURS.
- A 3" CLEAR STONE TRACKING PAD SHALL BE INSTALLED AT THE END OF ROAD CONSTRUCTION LIMITS TO PREVENT SEDIMENT FROM BEING TRACKED ONTO THE ADJACENT PANCY DIBLIC ROADWAY. SEDIMENT TRACKING FAD SHALL CONFORM TO MEMOR TECHNICAL STANDARD 1057. SEDIMENT REACHING THE PUBLIC ROAD SHALL BE REMOVED BY STREET CLEANING (NOT HYDRAULIC FLUSHING) BEFORE THE END OF EACH WORK DAY.
- 7. CHANNEUZED RUNOFF: FROM ADJACENT AREAS PASSING THROUGH THE SITE SHALL BE DIVERTED AROUND DISTURBED AREAS.
- 8. STABILIZED DISTURBED OROLNO: ANY SOIL OR DIRT PILES WHICH WILL REMAIN IN EXISTENCE FOR MORE THAN PERCONSECUTIVE DAYS, WHETHER TO BE WORKED DURING THAT PERCO OR NOT, SHALL NOT BE LOCATED WITHIN 25-FEET OF ANY ROADWAY, PERKING LOT, PAUD AREA, OR DRANNAGE STRUCTURE OR CHANNEL (UNLESS INTENDED TO BE LUES OR PART OF THE REGISION CONTROL MEASURES). TEMPORAPY STABILIZATION AND CONTROL MEASURES (SEEDING, MULCHING, TARPING, EROSION MATTING, BARRIER FENCING, ETC.) ARE REQUIRED FOR THE PROTECTION OF DISTURBED AREAS AND SOIL PILES, WHICH WILL RELIAM UN-WORKED FOR A PERIOD OF MORE THAN 14-CONSECUTIVE CALENDAR DAYS. THESE MEASURES SHALL REMAIN IN PLUNINL SITE HAS STABILIZED.
- 9. SITE DE-WATERING. WATER PUMPED FROM THE SITE SHALL BE TREATED BY TEMPORARY SEDIMENTATION BASINS OR OTHER APPROPRIATE CONTROL MEASURES. SEDIMENTATION BASINS SHALL HAVE A DEPTH OF AT LEAST 3 FEET, BE SURROUNDED BY SNOWENCE OR EQUIVALENT BARRER AND HAVE SUFFICIENT SURFACE AREA OF DIPROVIDE A SURFACE SETLING RATE OF NO MORE THAN 750 GALLONS PER SOURCE FOOT PER DAY AT THE HIGHEST DEWATERING PUMPING RATE. WATER MAY NOT BE DISCHARGED IN A MANNER THAT CAUSES EROSION OF THE SITE, A INCHEDIORNO SITE, OR THE BED OR BANKS OF THE RECEIVING WATER. POLYMERS MAY BE USED AS DIRECTED BY DAY TECHNICAL STANDARD 1061 (DE-WATERING).
- 10. WASHED STONE WEEPERS OR TEMPORARY EARTH BERMS SHALL BE BUILT PER PLAN BY CONTRACTOR TO TRAP SEDIMENT OR SLOW THE VELOCITY OF STORM WATER.
- 11. SEE DETAIL SHEETS FOR RIP-RAP SIZING, IN NO CASE WILL RIP-RAP BE SMALLER THAN 3" TO 6".
- 12. INLET FILTERS ARE TO BE PLACED IN STORMWATER INLET STRUCTURES AS SOON AS THEY ARE INSTALLED. ALL PROJECT AREA STORM INLETS NEED WISCONSIN D.O.T. TYPE D INLET PROTECTION. THE FILTERS SHALL BE MAINTAINED UNTIL THE CITY HAS ACCEPTED THE BINDER COURSE OF ASPHALT.
- 13. USE DETENTION BASINS AS SEDIMENT BASINS DURING CONSTRUCTION (DO NOT USE INFILTRATION AREAS). AT THE END OF CONSTRUCTION, REMOVE
- 14. RESTORATION (SEED, FERTILIZE AND MULCH) SHALL BE PER SPECIFICATIONS ON THIS SHEET (NOTE: ADD SEEDING RATE STANDARD OF DETAIL BLOCK TO PLAN) UNLESS SPECIAL RESTORATION IS CALLED FOR ON THE LANDSCAPE PLAN OR THE DETENTION BASIN DETAIL SHEET.
- 15. TERRACES SHALL BE RESTORED WITH 6" TOPSOIL, PERMANENT SEED, FERTILIZER AND MULCH. LOTS SHALL BE RESTORED WITH 6" TOPSOIL, TEMPORARY SEED, FERTILIZER AND MULCH.
- 16. AFTER DETENTION BASIN GRADING IS COMPLETE. THE BOTTOM OF DRY BASINS SHALL RECEIVE 6" TOPSOIL AND SHALL BE CHISEL-PLOWED TO A MINIMUM DEPTH OF 12" PRIOR TO RESTORATION.
- 17. SEED, FERTILIZER AND MULCH SHALL BE APPLIED WITHIN 7 DAYS AFTER FINAL GRADE HAS BEEN ESTABLISHED, IF DISTURBED AREAS WILL NOT BE RESTORED IMMEDIATELY AFTER ROUGH GRADING, TEMPORARY SEED SHALL BE PLACED
- 18. FOR THE FIRST SIX WEEKS AFTER RESTORATION (E.G. SEED & MULCH, EROSION MAT, SOD) OF A DISTURBED AREA, INCLUDE SUMMER WATERING PROVISIONS OF ALL NEWLY SEEDED AND MULCHED AREAS WHENEVER 7 DAYS ELAPSE WITHOUT A RAIN EVENT.
- 19. EROSION MAT (CLASS I, TYPE A URBAN PER WISCONSIN D.O.T. P.A.L.) SHALL BE INSTALLED ON ALL SLOPES 3:1 OR GREATER BUT LESS THAN 1:1.
- 20. EROSION MAT (CLASS I, TYPE B URBAN PER WISCONSIN D.O.T. P.A.L.) SHALL BE INSTALLED ON THE BOTTOM (INVERT) OF ROADSIDE DITCHES/SWALES AS SHOWN ON THIS PLAN, 1 ROLL WIDTH.
- 21. SOIL STABILIZERS SHALL BE APPLED TO DISTURBED AREAS WITH SLOPES BETWEEN 10% AND 3-1 (DO NOT USE IN CHANNELS). SOIL STABILIZERS SHALL BE TIPE B, PER WISCONSIN D.O.T. P.ALL (PRODUCT ACCEPTABILITY LIST), OR EQUAL. APPLY AT RATES AND METHODS SECORED PER MANUFACTURER/THIS SHEET. SOIL STABILIZERS SHALL BE RE-APPLED WHENEVER VEHICLES OR OTHER EQUIPMENT TRACK ON THE AREA.
- 22. SILT FENCE OR EROSION MAT SHALL BE INSTALLED ALONG THE CONTOURS AT 100 FOOT INTERVALS DOWN THE SLOPE ON THE DISTURBED SLOPES STEEPER THAN 5% AND MORE THAN 100 FEET LONG THAT SHEET FLOW TO THE ROADWAY UNLESS SOIL STABILIZERS ARE USED.
- 23. SILT FENCE TO BE USED ACROSS AREAS OF THE LOT THAT SLOPE TOWARDS A PUBLIC STREET OR WATERWAY. SEE DETAILS.
- 24. SEDIMENT SHALL BE CLEANED FROM CURB AND GUTTER AFTER EACH RAINFALL AND PRIOR TO PROJECT ACCEPTANCE.
- 25. ACCUMULATED CONSTRUCTION SEDIMENT SHALL BE REMOVED FROM ALL PERMANENT BASINS TO THE ELEVATION SHOWN ON THE GRADING PLAN FOLLOWING THE STABILIZATION OF DRAINAGE AREAS.
- 26. ALL CONSTRUCTION ENTRANCES SHALL HAVE TEMPORARY ROAD CLOSED SIGNS THAT WILL BE IN PLACE WHEN THE ENTRANCE IS NOT IN USE AND AT THE END OF EACH DAY.
- 27. ANY PROPOSED CHANGES TO THE EROSION CONTROL PLAN MUST BE SUBMITTED AND APPROVED BY DANE COUNTY LAND CONSERVATION OR PERMITTING MUNICIPALITY.
- 28. THE CITY, OWNER AND/OR ENGINEER MAY REQUIRE ADDITIONAL EROSION CONTROL MEASURES AT ANY TIME DURING CONSTRUCTION.

#### CONSTRUCTION SEQUENCE:

- INSTALL SILT FENCE AND TRACKING PAD
- 2. STRIP TOPSOIL-DETENTION BASINS
- 3. ROUGH GRADE DETENTION BASINS
- 4. SEED DETENTION BASINS
- 5. STRIP TOPSOIL-STREETS & LOTS
- 6. ROUGH GRADE STREETS & LOTS
- SEED LOT AREAS AND INSTALL DRIVE-OVER VELOCITY CHECKS
- 8. CONSTRUCT UNDERGROUND UTILITIES
- 9. INSTALL INLET PROTECTION
- 10. CONSTRUCT ROADS (STONE BASE, CURB & GUTTER, AND SIDEWALK). REMOVE DRIVE—OVER VELOCITY CHECKS WHEN BASE COURSE IS PLACED
- 12. REMOVE TRACKING PAD, SILT FENCE AND DIVERSION BERM MEASURES AFTER DISTURBED AREAS ARE RESTORED

#### SEEDING RATES

- USE ANNUAL OATS AT 3.0 LB./1,000 S.F. FOR SPRING AND SUMMER PLANTINGS.
- 2. USE WINTER WHEAT OR RYE AT 3.0 LB./1,000 SF FOR FALL PLANTINGS STARTED

AFTER SEPTEMBER 15.


PERMANENT: 1. USE WISCONSIN D.O.T. SEED MIX #40 AT 2 LB./1,000 S.F.


#### FERTILIZING RATES:

TEMPORARY AND PERMANENT: USE WISCONSIN D.O.T. TYPE A OR B AT 7 LB./1,000 S.F.

#### TEMPORARY AND PERMANENT:

USE & TO 1-½" STRAW OR HAY MULCH, CRIMPED PER SECTION 607.3.2.3, OR OTHER RATE AND METHOD PER SECTION 627, WISCONSIN D.O.T. STANDARD SPECIFICATIONS FOR HIGHWAY AND STRUCTURE CONSTRUCTION

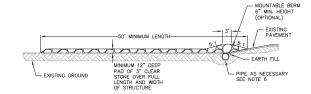

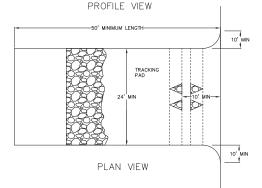


FOLLOW WISCONSIN DNR TECHNICAL STANDARD 1057 FOR FURTHER DETAILS AND INSTALLATION

WIDTH - 24' MINIMUM, SHOULD BE FLARED AT THE EXISTING ROAD TO PROVIDE A TURNING RADIUS.

ON SITES WITH A HIGH GROUND WATER TABLE OR WHERE SATURATED CONDITIONS EXIST, GEOTEXTILE FABRIC SHALL BE PLACED OVER EXISTING GROUND PRIOR TO PLACING STONE. FABRIC SHALL BE WISDOT TYPE—HR GEOTEXTILE FABRIC.

- 5. STONE CRUSHED 3" CLEAR STONE SHALL BE PLACED AT LEAST 12" DEEP OVER THE ENTIRE LENGTH AND WIDTH OF ENTRANCE.
- 6. SURFACE WATER ALL SURFACE WATER FLOWING TO OR DIVERTED TOWARDS CONSTRUCTION ENTRANCES SHALL BE PIPED THROUGH THE RETNEADE. ANAINATION POSTITUE DRAINAGE, PIPE INSTALLED THROUGH THE STABILIZED CONSTRUCTION ENTRANCE SHALL BE PROTECTED WITH A MOUNTABLE BERN WITH 5:1 SLOPES AND MINIMUM OF 6" STONE OVER THE PIPE, PIPE SHALL BE SIZED ACCORDING TO THE DRAINAGE REQUIREMENTS, WHEN THE ENTRANCE IS COLOTED AT A HIGH SPOT AND OR PAINAGE REQUIREMENTS. TO CONVEY A PIPE SHALL NOT BE NECESSARY. THE MINIMUM PIPE DIAMETER SHALL BE 6". CONTRACTOR SHALL BE RESPONSIBLE FOR THE MAINTENANCE OF SAID PIPE.
- LOCATION A STABILIZED CONSTRUCTION ENTRANCE SHALL BE LOCATED WHERE CONSTRUCTION TRAFFIC ENTERS AND/OR LEAVES
  THE CONSTRUCTION SITE. VEHICLES LEAVING THE SITE MUST TRAVEL OVER THE ENTIRE LENGTH OF THE TRACKING PAD.

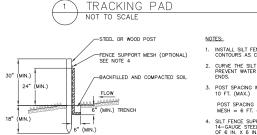

- INSTALL SILT FENCE TO FOLLOW THE GROUND CONTOURS AS CLOSELY AS POSSIBLE.
- CURVE THE SILT FENCE UP THE SLOPE TO PREVENT WATER FROM RUNNING AROUND THE
- 3. POST SPACING WITH FENCE SUPPORT MESH =
  - POST SPACING WITHOUT FENCE SUPPORT MESH = 6 FT. (MAX.)
- 4. SILT FENCE SUPPORT MESH CONSISTS OF 14—CAUGE STEEL WRE WITH A MESH SPACING OF 6 IN. X 6 IN. OR PREFABRICATED POLYMERIC MESH OF EQUIVALENT STRENGTH



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Detail

Rd Middleton <u>p</u>0 5201 C Madisc

> AS SHOWN 09/01/2020

6.0

BAG TO BE CONSTRUCTED USING GEOTEXTILE FABRIC, WISDOT TYPE FF.

FRONT, BACK AND BOTTOM PANEL TO BE MADE FROM SINGLE PIECE OF FABRIC (NO SEAMS).

- FLAP POCKET TO BE FITTED WITH REBAR OR STEEL ROD FOR REMOVAL. IF USED WITH CURB BOX, FLAP POCKETS TO BE FITTED WITH WOOD 2" x 4". EXTENDED 10" BEYOND GRATE WIDTH AND SECURED TO GRATE WITH THE WOOD SHALL NOT BLOCK THE ENTIRE HEIGHT OF THE CURB BOX OPENING.

TRIM EXCESS FABRIC IN THE FLOW LINE TO WITHIN 3" OF THE GRATE.

- 4" x 6" OVAL HOLE CUT INTO ALL FOUR SIDE PANELS. HOLES TO BE POSITIONED MIN. 8" BELOW INLET GRATE AND MIN. 12" ABOVE BOTTOM PANEL.

BOTTOM DIMENSION = 12"


INSTALLED BAD SHALL HAVE A MIN. SIDE CLEARANCE OF 3" FROM THE INLET WALLS MEASURED AT THE HOLES. IF NECESSARY, CONTRACTOR SHALL CINCH THE BAG (MAX. 4" FROM BAG BOTTOM) TO ACHIEVE CLEARANCE.


INLET PROTECTION DEVICES SHALL BE MAINTAINED OR REPLACED AT THE DIRECTION OF THE ENGINEER.

WHEN REMOVING OR MAINTAINING INLET PROTECTION, ANY TRAPPED MATERIAL THAT FALLS INTO THE INLET SHALL BE IMMEDIATELY REMOVED BY THE CONTRACTOR.


IF INLET DEPTH FROM TOP OF GRATE TO BOTTOM OF INLET IS LESS THAN 30", CONTRACTOR SHALL SUBSTITUTE WISDOT TYPE C INLET PROTECTION.



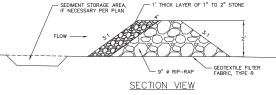

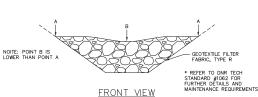



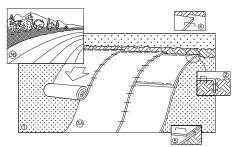

NOTE: REFER TO GENERAL STAPLE PATTERN GUIDE FOR CORRECT STAPLE PATTERN RECOMMENDATIONS FOR SLOPE INSTALLATIONS.

- RECOMMENDATIONS FOR SLOPE INSTALLATIONS.

  1. PREPARE SOIL BEFORE INSTALLATIONS.

  1. PREPARE SOIL BEFORE INSTALLATIONS BLANKETS, INCLUDING APPLICATION OF FERTILIZER AND SEED.

  1. PROPERTY OF THE STALLED WITH PAPER SIDE DOWN.

  1. PROPERTY OF THE STALLED WITH PAPER SIDE DOWN.

  2. BEGIN AT THE TOP OF THE SLOPE BY AND COMPACT THE BLANKET IN 6" DEEP BY 6" WIDE TRENCH. BACKFILL AND COMPACT THE TRENCH AFTER STAPLING.


  3. ROLL THE BLANKETS ACT, DOWN, OR 48. PORTOXITALLY ARORSS THE SLOPE.

  4. THE EDGES OF PARALLEL BLANKETS WIST BE STAPLED WITH APPROXIMATELY 2" OVERLAP.


  5. WIEN BLANKETS MUST BE SPLICED DOWN THE SLOPE, ELACE BLANKETS END OVER BUD OVER BUD GENERAL STAPLING WITH APPROXIMATELY 4" OVERLAP. STAPLE

  6. ALL BLANKETS MUST BE SECURELY FASTENED TO THE SLOPE BY PLACING STAPLES/STAKES IN APPROPRIATE LOCATIONS AS RECOMMENDED BY THE MANUFACTURER.



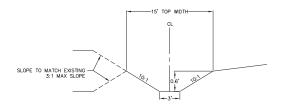


WEST DITCH CROSS SECTION NOT TO SCALE

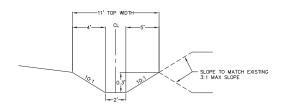

SOUTH DITCH CROSS SECTION

#### NOTES:

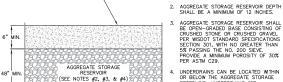

SOIL SUBGRADE

PERVIOUS CONCRETE OR POROUS ASPHALT

POROUS CONCRETE PAVEMENT-

AGGREGATE STORAGE RESERVOIR SHALL BE OPEN-GRADED BASE CONSISTING OF GRUSHED STONE OR GRUSHED GRAVEL PER WISDOT STANDARD SPECIFICATIONS SECTION 301 WITH NO GREATER THAN 5% PASSING THE NO. 200 SIEVE. PROVIDE A MINIMUM POROSITY OF 30% PER ASTM C29.

PAVEMENT SURFACE PERCENT VOIDS SHALL BE LESS THAN 25%.

 UNDERDRAINS CAN BE LOCATED WITHIN OR BELOW THE AGGREGATE STORAGE RESERVOIR. UNDERDRAINS (OR EQUIVALENT) ARE TO BE INSTALLED.

PERMEARIE PAVEMENT SHALL RE PERMEABLE PAVEMENT SHALL BE DESIGNED PER WDNR CONSERVATION PRACTICE STANDARDS (1008) AND WISCONSIN ASPHALT PAVEMENT ASSOCIATION STANDARDS.

BOTTOM OF GRANULAR FILL TO BE LOCATED AT SUITABLE NATIVE SOIL LAYER (IDENTIFED AS INFLITATIVE, GRANULAR MATERIAL). FINAL DEPTH OF DEVICE TO BE DETERMINED VISUALLY BY DESIGN ENGINEER IN THE FIELD WHEN THE AREA IS EXCAVATED. ELEV = 915.00±





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Construction Details 5201 Old Middleton Rd Madison Dane County, Wisconsi

AS SHOWN 09/01/2020 JZAM

C 6.1

#### Plant Material List

| Broadleaf De  | ciduous   |                               |                                |               |
|---------------|-----------|-------------------------------|--------------------------------|---------------|
| Quantity      | Code Name | Common Name                   | Scientific Name                | Planting Size |
| 2             | ARM       | Armstrong Maple               | Acer X Freemanii 'armstrong'   | 2 I/2" B&B    |
| 2             | RJCC      | Red Jewel Crabapple (clp)     | Malus 'jewelcole' (clp)        | 6' B&B        |
| 2             | GPO       | Green Pi <b>ll</b> ar Pin Oak | Quercus Palustris 'pringreen'  | 2 I/2" B&B    |
| Conifer Every | green     |                               |                                |               |
| Quantity      | Code Name | Common Name                   | Scientific Name                | Planting Size |
| 17            | MMP       | Mops Mugo Pine                | Pinus Mugo 'mops'              | #3 CONT.      |
| 5             | EWP       | Eastern White Pine            | Pinus Strobus                  | 7' B&B        |
| 3             | TY        | Taunton Yew                   | Taxus X Media 'tauntonii'      | 18" B&B       |
| 11            | HA        | Holmstrup Arborvitae          | Thuja Occidentalis 'holmstrup' | 5' B&B        |

| Peren | nial       |                      |  |                  |
|-------|------------|----------------------|--|------------------|
| Qua   | ntity Code | Name Common Name     | Scientific Name                                | Planting         |
| 13    | KFG        | Karl Foerster's Feat | ther Reed Grass Calamagrostis Acutiflora 'karl | Foerster' #I COI |
| 3     | PH         | Patriot Hosta        | Hosta 'patriot'                                | #I COI           |
| 17    | PMG        | Purple Maiden Grass  | s Miscanthus Sinensis Var Purpu                | rescens #I COI   |
| 15    | GBES       | Goldsturm Black-Ey   | ved Susan Rudbeckia Ful Var Sullivan 'gol      | ldsturm' #I CO   |

Canadian Hemlock

Prairie Dropseed

CNH

PRD

67

|              |           | Plant Material List–Street Tr | rees Required                  |               |
|--------------|-----------|-------------------------------|--------------------------------|---------------|
| Broadleaf De | ciduous   |                               |                                |               |
| Quantity     | Code Name | Common Name                   | Scientific Name                | Planting Size |
| 1            | GGCT      | Golden Glory Corn Cherry (tf) | Cornus Mas 'golden Glory' (tf) | 2" B&B        |
| 2            | RJC       | Red Jewel Crabapple           | Malus 'jewelcole'              | 2" B&B        |
|              |           |                               |                                |               |

#### GENERAL NOTES

A) Areas Jabeled "Processed Wood Mulch" to receive hardwood wood mulch, spread to a 3" depth over pre-emergent herbicide.

B) Individual trees (and shrub groupings) found along perimeter of property as well as those found within lawn areas to receive hardwood wood mulch rings (and wood mulch beds), spread to a minimum 3" depth (3' wide beds for shrub groupings).

C) "Vinyl Edging" to be Valley View Black Diamond Vinyl Edging or equivalent.

Tsuga Canadensis

Sporobolus Heterolepis

7' B&B

D) Areas labeled "washed stone" to receive I-I/2" washed stone spread to a 3" depth over fabric weed barrier.

E) "Seed" areas shall be finish-graded and seeded at a rate of 4 lbs. per 1,000 sq. ft.


F) Seed shall consist of the following mixture: 10% Palmer IV Perennial Ryegrass 20% Dragon Kentucky Bluegrass 20% Diva Kentucky Bluegrass 20% Foxy II Creeping Red Fescue 15% Vall II Perennial Ryegrass 15% Ginney Kentucky Bluegrass

G) Areas labeled "Seed/Mat" shall be seeded with the above-noted premium lawn seed mixture and overlaid with DS75 straw erosion control netting that is then pegged into the soil with metal staples.

H) Plant beds adjacent to building foundation to be mulched with  $1-1/2^{\circ}$  diameter washed stone mulch spread to a 3° depth over fabric weed barrier.

I) Existing street trees shall be protected. Contractor shall install tree protection fencing in the area between the curb and sidewalk and extend it at least 5 feet from both sides of the real long the length of the terrace. No excandion is permitted within 5 feet of any tree in necessary, contractor shall contact CIp forestary (1908)244-818 prior to excavation to session size in lengate to the tree and root system. Tree pruning shall be coordinated with City Forestary. The protection specifications and benof all section (21) at Giv of Midston Shander's specifications for Paddio 21 of Contractors of the Contractor o

Contractor shall contact City Forestry (608)266-4816 at least one week prior to installing street trees to schedule inspecting the nursery stock and reviewing landscaping specifications with the landscaper.

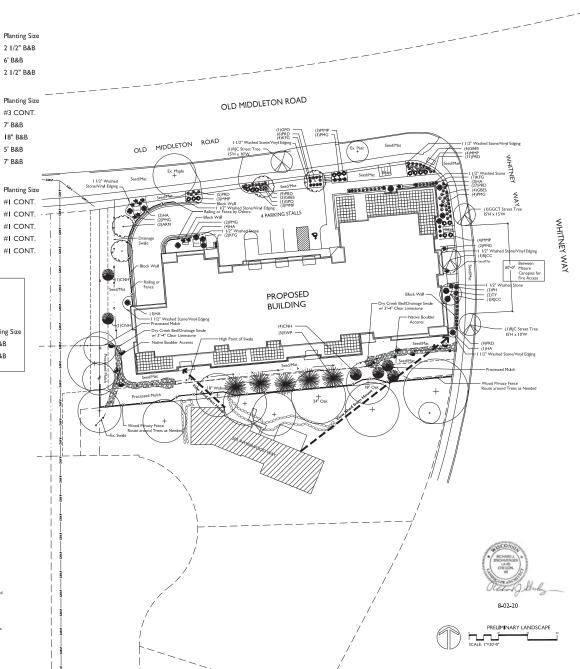

2830 PARMENTER STREET P.O. BOX 620330 MIDDLETON, WI 53562-033 TEL (608) 836-7041 FAX (608) 831-6266

MIDDLETON ROAD

OLD MIDDLETON ROLL WISCONSIN 5

5201 SZ01 OLD MADISON, V

Checked By: SS Drawn By: 9/02/20 RS Revised: Pavisad Revised:

Revised: Revised: Revised: Revised: Revised: Revised:

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# MADISON LANDSCAPE WORKSHEET

| Zoning District: is NMX  Total square footage of developed area  Total square footage of first 5 acres of developed area ÷ 300 square feet =  Total square footage of 0 additional acres of developed area ÷ 100 square feet | 19 Landscape Units |
|--|--------------------|
| NUMBER OF LANDSCAPE POINT REQUIRED  19 Landscape Units x 5 landscape points for first 5 acres  0 Landscpe Units x 1 landscape point for additional 0 acres  TOTAL LANDSCAPE POINTS REQURED                                   | 0 points           |

|  |                    | NI     | EW                 | EXIS | TING               |                    |
|--|--------------------|--------|--------------------|------|--------------------|--------------------|
| PLANT TYPE or ELEMENT  | Point<br>Value     | Qty.   | Points<br>Achieved | Qty. | Points<br>Achieved |                    |
| Overstory Deciduous Tree : 2-1/2" (dbh)                            | 35                 | 4      | 140                | 3    | 105                |                    |
| Tall Evergreen Tree : 5-6 feet tall                                | 35                 | П      | 385                |      |                    |                    |
| Ornamental Tree : I-I/2" Caliper (dbh)                             | 15                 | 2      | 30                 |      |                    |                    |
| Upright Evergreen Shrub : 3-4 feet tall                            | 10                 | П      | 99                 |      |                    |                    |
| Shrub, deciduous : 3 gallon / 12"-24"                              | 3                  | 0      | 0                  |      |                    |                    |
| Shrub, evergreen : 3 gallon / 12"-24"                              | 4                  | 20     | 80                 |      |                    |                    |
| Ornamental grass/perennial: Igallon / 8"-18"                       | 2                  | 115    | 230                |      |                    |                    |
| Ornamental / Decorative fencing or wall                            | 4 per<br>10 l.f.   | 375    | 150                |      |                    |                    |
| Existing significant specimen tree                                 | I4 per<br>Cal. In. |        |                    |      |                    | TOTAL              |
| Landscape furniture for public seating and /or transit connections |                    |        |                    |      |                    | POINTS<br>PROVIDED |
|  | Sub                | Totals | 1114               | +    | 105                | = 1,219            |

# **Street Frontage Landscape Required**

## **Street Frontage Landscape Supplied**

Proposed Canopy Trees = 13.5 Proposed Shrubs = 31



# LANDSCAPE ARCHITECTS LANDSCAPE CONTRACTORS

2830 PARMENTER STREET P.O. BOX 620330 MIDDLETON, WI 53562-0330

TEL (608) 836-7041 FAX (608) 831-6266

# 5201 OLD MIDDLETON ROAD 5201 OLD MIDDLETON ROAD MADISON, WISCONSIN 53705


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Revised:

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HORTHLAD-OLD MIDDLETONNLAD-OLD MIDDLETON 20C5.DWG Created; 8/3 1/2020, Saved; 9/1/2020, Printed; 9/1/2020



Knothe # bruce
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KEY PLAN

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PROJECT TITLE

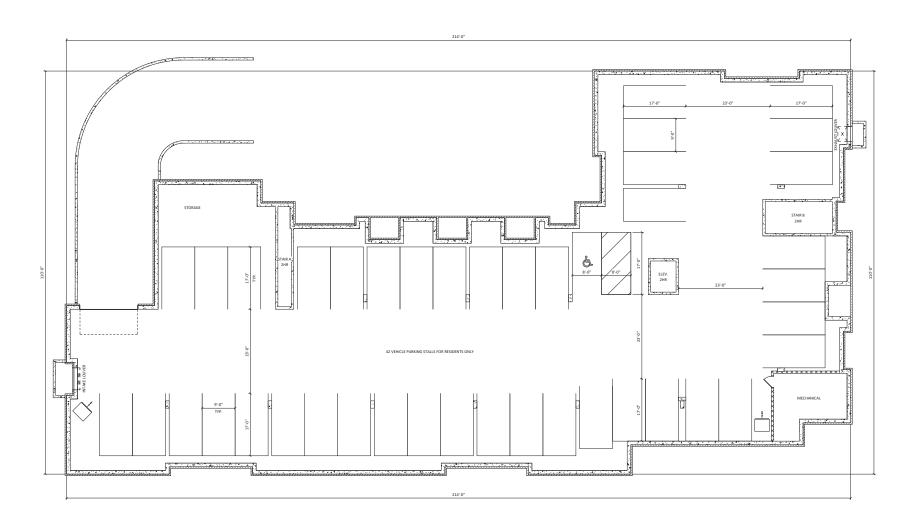
5201 OLD MIDDLETON RD MADISON, WI

SHEET TITLE
BASEMENT
FLOOR PLAN

SHEET NUMBER

PROJECT NUMBER 2012

BASEMENT FLOOR PLAN

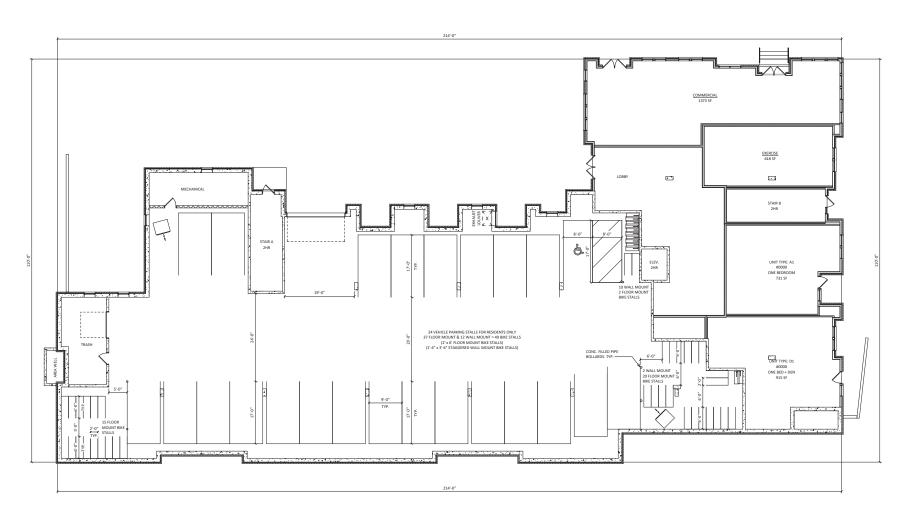

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MA

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PROJECT TITLE

5201 OLD MIDDLETON RD MADISON, WI SHEET TITLE FIRST FLOOR

SHEET NUMBER

PLAN

PROJECT NUMBER 2012
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TIRST FLOOR PLAN



SECOND FLOOR PLAN
(A12) 1/8" = 1-0"

Knothe = bruce
ARCHITECTS
Interference are
1048 ERREST for 5-bits 201 - Markets, NI 33541
KEY PLAN

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PROJECT TITLE

5201 OLD
MIDDLETON RD
MADISON, WI
SHEET THITLE
SECOND FLOOR
PLAN

SHEET NUMBER

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PLAN

SHEET NUMBER

5201 OLD MIDDLETON RD MADISON, WI SHEET TITLE THIRD FLOOR

Inethebrara.com 608.008.2083 2601 University Res. + Suite 201 + Middleton, W1 53583

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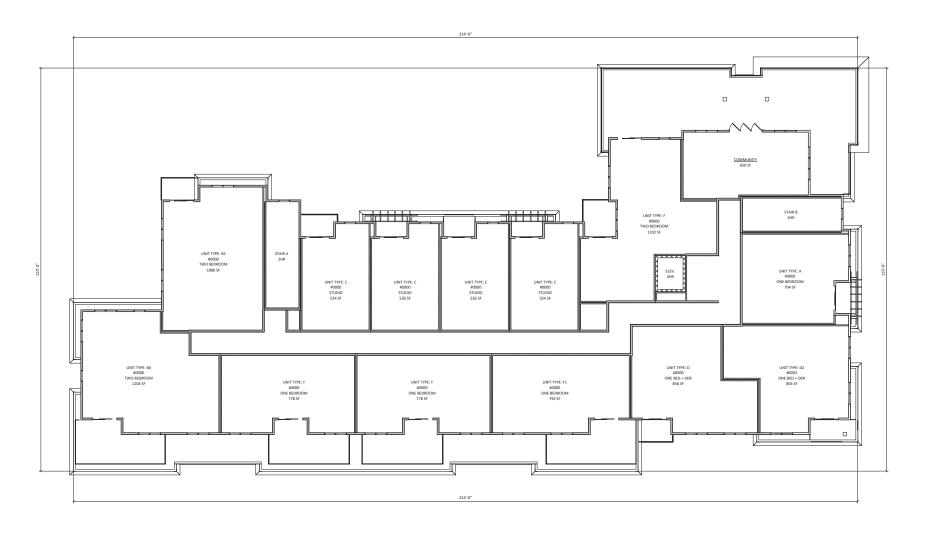
KEY PLAN

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PROJECT TITLE

PROJECT NUMBER 2012

THIRD FLOOR PLAN



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Hill Blanching Bar + Rail 2014 + Markin, 18 12551
KEY PLAN
KEY PLAN

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PROJECT TITLE

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FOURTH FLOOR PLAN


SHEET NUMBER

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PROJECT NUMBER 2012

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1) FOURTH FLOOR PLAN



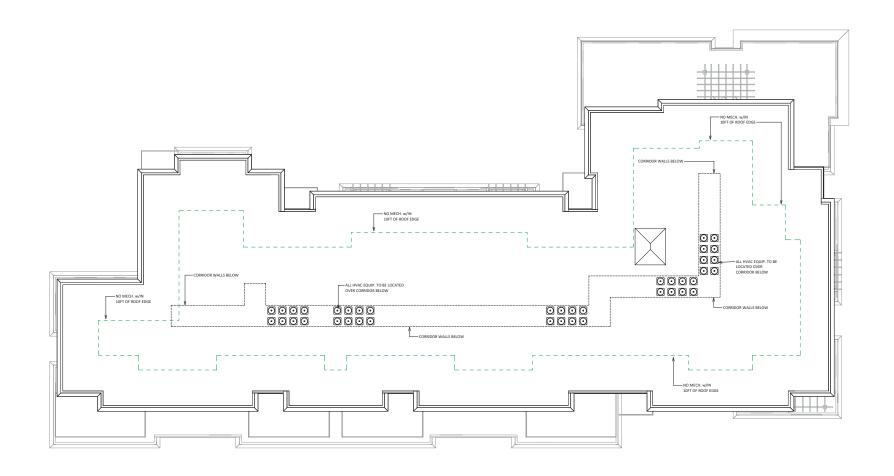

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PROJECT TITLE

5201 OLD MIDDLETON RD MADISON, WI

SHEET TITLE ROOF PLAN

SHEET NUMBER

PROJECT NUMBER 2012

1 ROOF PLAN





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NORTH ELEVATION

1/8" = 1'-0"



SHEET NUMBER

PROJECT NUMBER 2012

SOUTH ELEVATION







WEST ELEVATION



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PROJECT TITLE

5201 OLD MIDDLETON RD MADISON, WI SHEET TITLE

EXTERIOR ELEVATIONS

SHEET NUMBER

PROJECT NUMBER 2012



Anothebrace.com 608.838.3800 2501 Deversity Ave. + Suite 201 + Middleton, W1 53562

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NORTH ELEVATION - COLOR



PROJECT TITLE

5201 OLD MIDDLETON RD MADISON, WI SHEET TITLE **EXTERIOR ELEVATIONS -**

SHEET NUMBER

PROJECT NUMBER 2012

2 SOUTH ELEVATION - COLOR





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PROJECT TITLE

5201 OLD MIDDLETON RD MADISON, WI

SHEET TITLE
EXTERIOR
ELEVATIONS COLORED

SHEET NUMBER

PROJECT NUMBER 2012



5201 OLD MIDDLETON RD, MADISON WI RENDERED PERSPECTIVE SEPTEMBER 02, 2020









