

City of Madison

Proposed Conditional Use

Location 2115 Allen Boulevard

Project Name MMSD - Pump Station 15

Applicant

Erik Rehr-Madison Metropolitan Sewage Dist./ Doug Hursh-Potter Lawson Inc.


Existing Use

Marshall Park and MMSD Pump Station


Proposed Use

Additions and renovations to an existing Madison Metropolitan Sewerage District pump station and construction of new restrooms at Marshall Park

Public Hearing Date Plan Commission 22 February 2016

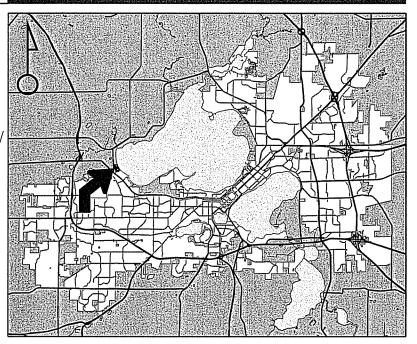


For Questions Contact: Tim Parks at: 261-9632 or tparks@cityofmadison.com or City Planning at 266-4635

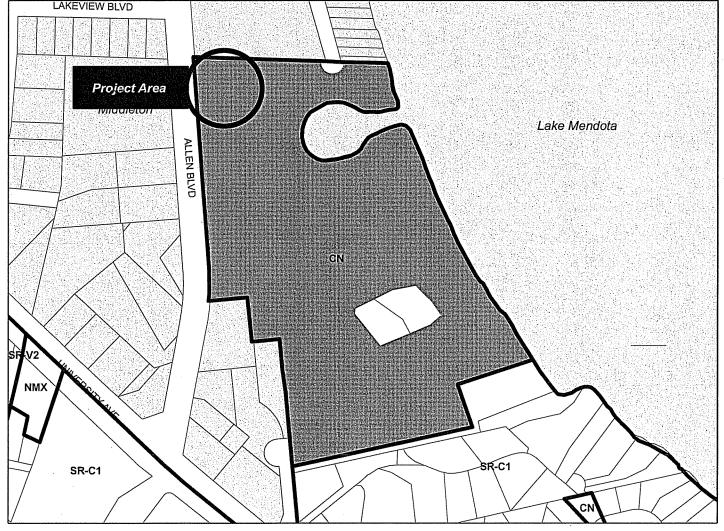

Scale: 1" = 400'


City of Madison, Planning Division: RPJ: Date: 15 February 2016

City of Madison

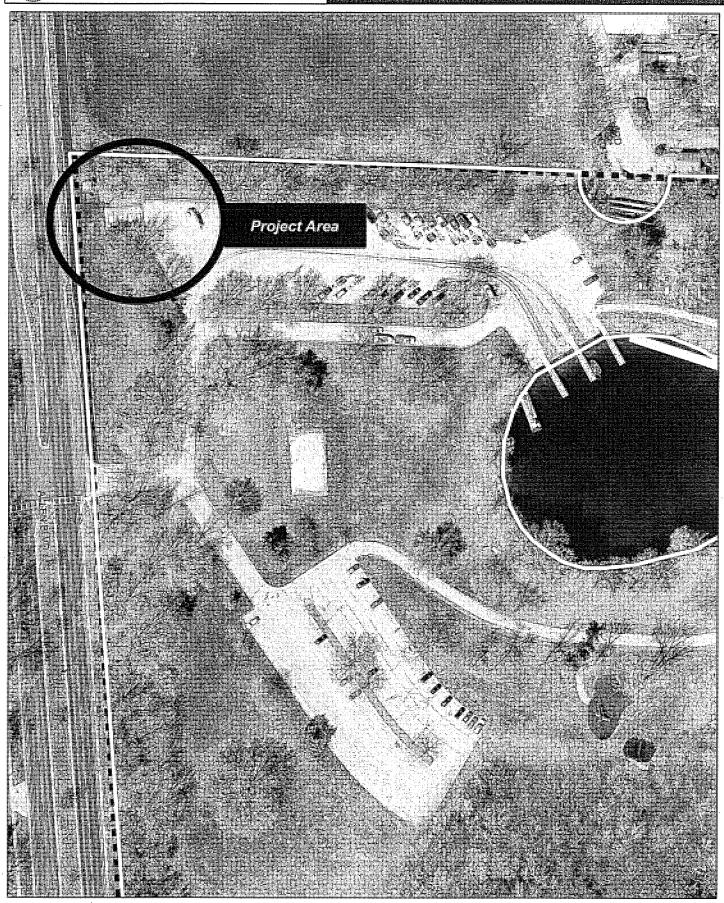

Date of Aerial Photography: Spring 2013

City of Madison

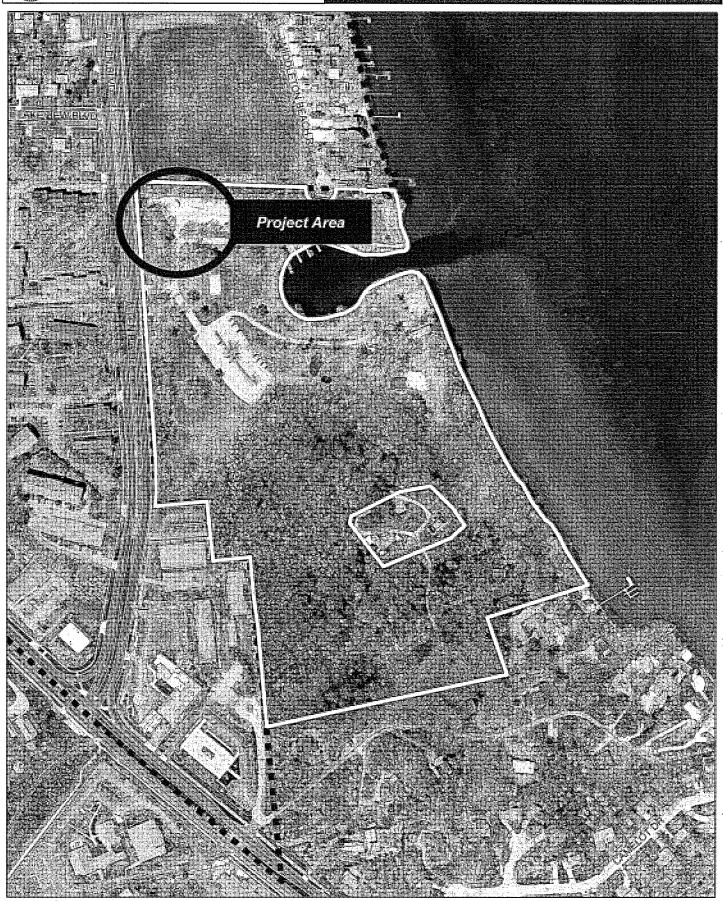

Date of Aerial Photography: Spring 2013



AND USE APPLICATION

CITY OF MADISON

- All Land Use Applications should be filed with the Zoning Administrator at the above address.
- The following information is required for all applications for P Commission review except subdivisions or land divisions, which should be filed using the Subdivision Application.
- This form may also be completed online at: www.cityofmadison.com/developmentcenter/land

Development Schedule: Commencement

Madison m	
215 Martin Luther King Jr. Blvd; Room LL-100	Amt. Paid Receipt No.
PO Box 2985; Madison, Wisconsin 53701-2985	Amt. Paid Receipt No Date Received 12/15 165
Phone: 608.266.4635 Facsimile: 608.267.8739	Received By The
 All Land Use Applications should be filed with the Zoning Administrator at the above address. 	Parcel No. 0709-073-0099-4 Aldermanic District 19/mark Clean
The following information is required for all applications for P	Vlan Zoning District
Commission review except subdivisions or land divisions, which should be filed using the <u>Subdivision Application</u> .	$\Gamma = \Gamma = \Gamma = \Gamma = \Gamma$
This form may also be completed online at:	☐ Urban Design Commission ☐ Plan Commission
www.cityofmadison.com/developmentcenter/landdevelopme	
	Form Effective: February 21, 2013
1. Project Address: 2115 Allen Boulevard, Madison WI 5	3705
Project Title (if any): Madison Metropolitan Sewerage Dis	trict - Pump Station 15
2. This is an application for (Check all that apply to your I	Land Use Application):
Zoning Map Amendment from	to
☐ Major Amendment to Approved PD-GDP Zoning	☐ Major Amendment to Approved PD-SIP Zoning
Review of Alteration to Planned Development (By Plan	n Commission)
	•
Conditional Use, or Major Alteration to an Approved C	onditional Use
☐ Demolition Permit	
Other Requests: Conditional use within CN - Conservancy Zon	ing - Public Building
3. Applicant, Agent & Property Owner Information:	
Applicant Name: Erik Rehr	Company: Madison Metropolitan Sewerage District
Street Address: 1610 Moorland Road City/Stat	te: Madison, WI Zip: 53713
Telephone: (608) 272-1201 Fax: ()	Email: erikr@madsewer.org
Project Contact Person: Doug Hursh	Company: Potter Lawson Inc.
Street Address: 749 University Row, Suite 300 City/Stat	14 - P 14 / F070F
Telephone: (608) 274-2741 Fax: ()	Email: dough@potterlawson.com
Property Owner (if not applicant):	
Street Address: City/Stat	te:Zip:
4. Project Information:	
Provide a brief description of the project and all proposed uses	
Above grade addition to house equipment for existing sewer pump station. A	lso, new public restrooms for the park.

Completion

5. Required Submittal Information

All Land Use applications are required to include the following:

- ✓ Project Plans including:*
 - Site Plans (<u>fully dimensioned</u> plans depicting project details including all lot lines and property setbacks to buildings; demolished/proposed/altered buildings; parking stalls, driveways, sidewalks, location of existing/proposed signage; HVAC/Utility location and screening details; useable open space; and other physical improvements on a property)
 - Grading and Utility Plans (existing and proposed)
 - Landscape Plan (including planting schedule depicting species name and planting size)
 - Building Elevation Drawings (fully dimensioned drawings for all building sides, labeling primary exterior materials)
 - Floor Plans (fully dimensioned plans including interior wall and room location)

Provide collated project plan sets as follows:

- Seven (7) copies of a full-sized plan set drawn to a scale of 1 inch = 20 feet (folded or rolled and stapled)
- Twenty Five (25) copies of the plan set reduced to fit onto 11 X 17-inch paper (folded and stapled)
- One (1) copy of the plan set reduced to fit onto 8 ½ X 11-inch paper
- * For projects requiring review by the **Urban Design Commission**, provide **Fourteen (14) additional 11x17 copies** of the plan set. In addition to the above information, <u>all</u> plan sets should also include: 1) Colored elevation drawings with shadow lines and a list of exterior building materials/colors; 2) Existing/proposed lighting with photometric plan & fixture cutsheet; and 3) Contextual site plan information including photographs and layout of adjacent buildings and structures. The applicant shall <u>bring</u> samples of exterior building materials and color scheme to the Urban Design Commission meeting.

V	Letter of Intent: Provide one (1) Copy	per Plan Set describing this application	in detail including, but not limited to:
	 Project Team Existing Conditions Project Schedule Proposed Uses (and ft² of each) Hours of Operation 	 Building Square Footage Number of Dwelling Units Auto and Bike Parking Stalls Lot Coverage & Usable Open Space Calculations 	 Value of Land Estimated Project Cost Number of Construction & Full-Time Equivalent Jobs Created Public Subsidy Requested
	Filing Fee: Refer to the Land Use Applic	ation Instructions & Fee Schedule. Mak	e checks payable to: City Treasurer.
· •			omitted in hard copy with their application as eir application materials, or by e-mail to
	Additional Information may be require	ed, depending on application. Refer to	the <u>Supplemental Submittal Requirements.</u>
6.	Applicant Declarations	•	
V	neighborhood and business associated alderperson, neighborhood association	ions <u>in writing</u> no later than <u>30 dav</u>	
	→ If a waiver has been granted to the	s requirement, please attach any corr	espondence to this effect to this form.
	Pre-application Meeting with Staff: I proposed development and review proposed		n, the applicant is required to discuss the on staff; note staff persons and date.

Planning Staff: Tim Parks / Al Martin Date: March 20, 2015 Zoning Staff: Matt Tucker

Authorizing Signature of Property Owner

Date /2-/6-15







Letter of Intent-City of Madison Planning Commission

Pumping Station 15 2115 Allen Boulevard

Madison Metropolitan Sewerage District December 18, 2015

Project Team

The project design team includes Baxter & Woodman (Lead), Potter Lawson, Inc. (Architect), Ken Saiki Design (Landscape Architecture), Sustainable Engineer Group (Solar Panel Design), Karen Kabbes (ISI Envision Coordinator), CGC, Inc. (Geotechnical) and MMSD District staff. Key personnel for each team are shown in Table 1.

TABLE 1
Project Design Team

Firm	Person	Role
Baxter & Woodman, Inc. (Lead)	Jim Kleinschmidt	Overall Project Manager
	Amanda Heller	Project Engineer
	Adam Stec	Structural Engineer
	Lee Rita Rigos	Controls
	Elizabeth Quimby	Electrical Engineer
Potter Lawson, Inc (Architect)	Doug Hursh	Project Manager
	Andy Laufenberg	Project Architect
Ken Saiki Design(Landscape Architect)	Nik Swartz	Landscape Architect
Karen Kabbes Engineering (ISI Envision Coordinator	Karen Kabbes	ISI Envision
CGC, Inc (Geotechnical)	Bill Wuellner	Geotechnical Engineering
Sustainable Engineering Group	Jon Evans	Solar Panel Design
	Andy DeRocher	Solar Panel Design

Firm	Person	Role
Madison Metropolitan Sewerage	Erik Rehr	Project Manager
District		
	Michael Mucha	Chief Engineer
	Bruce Borelli	Director of Engineering
	Claudia Haack	Director of Sustainable Asset Management
	Dave Lundey	Electrical Construction Supervisor
	John Bembinster	Electrical Engineer

Existing Conditions and Project Description

The pumping station is located within an easement in the northwest corner of Marshall Park on the far west site boundary between Madison and Middleton. The current station is mostly underground and extends about 24" above the grade. There is also a large external transformer and switch gear on the site for the station.

The original pumping station was built in 1974 and serves Madison, Middleton, and the town of Westport. The station operates on a continuous basis every day of the year. The proposed project will create a pumping station superstructure to house electrical and HVAC equipment. A building addition will also be constructed to the north of the existing pumping station. The new structure will house new electrical and mechanical equipment needed to upgrade and renovate the existing pump station. Restrooms are also included in the project. The restrooms will be owned and maintained by the City of Madison Parks Department but funding for the project will be provided by the Madison Metropolitan Sewerage District. There will also be an aquatic invasive species control center to allow boaters to remove materials from their boats prior to leaving Marshall Park.

The design process has followed the Institute for Sustainable Infrastructure (ISI) Envision guidelines and has taken into consideration community needs. A bike repair station will be located near the Allen Boulevard bike as an amenity for bikers; also a new sidewalk connection from the bike path will provide an accessible route to the bike station, pump station building, and Marshall Park. The restrooms and Aquatic Invasive Species Control Center were added after public comments requesting both project elements.

A public meeting was held on July 14, 2015 in Marshall Park. Alders for both Madison and Middleton were present in addition to about 20 members of the public. Presentations were made by the Design Team and were followed by questions from the public in attendance. The most overwhelming request was to provide better access to restrooms in Marshall Park and to provide an aquatic invasive species control center. After negotiations between the City of Madison Parks and Madison Metropolitan Sewerage District, the District agreed to finance and facilitate the construction of the restrooms. Upon completion of the restrooms and the aquatic invasive species control center, the District will deed these over to the City of Madison who will be responsible for the ongoing maintenance of these facilities. The restrooms will be open from 7 AM to 10 PM from about April 15th to November 15th.

As part of the MMSD's mission to protect water (groundwater and surface water), a green roof, bio swale/dry steam bed, bioretention basin, and permeable pavers are used to manage storm water runoff on-site. Runoff from the restrooms and the Aquatic Invasive Species Control Center will drain to a bioretention basin where the runoff can be temporarily staged and allowed to infiltrate back into the soil. The built storm water management control features are designed to enhance the site while showcasing the District's commitment to water quality.

Some minor grading will occur on the west and north sides of the pump station building to enhance and integrate the bio swale/dry stream bed with existing site drainage patterns. Invasive species within the MMSD easement will be eradicated during the site clearing and re-grading process and restored with a low-maintenance turf. Proposed plantings consist of native and native cultivar trees, shrubs and perennials that will provide multi-seasonal interest. The proposed species have been carefully selected to ensure a low-maintenance landscape that will require minimal supplemental water or fertilizer which is consistent with ISI Envision Guidelines and MMSD's mission of protecting water resources.

Indigenous and locally sourced decorative stone in the form of accent boulders, cobbles, and mulch will be concentrated around roof scuppers while directing runoff to the storm water management feature to dissipate concentrated roof runoff volumes and provide filtration, cooling, and temporary staging of runoff while directing runoff to the storm water management features. Decorative stone material will also be integrated throughout the site to create a holistic landscape composition.

The sloped roof allows for translucent clerestory panels that allow daylight into the both the pumping station and the restrooms. Windows will be provided along the south side of the building to allow people to see the inner workings of the facility.

The building will include photovoltaic panels to generate about 8kW of power at full sun. This will provide about 30 percent of the required kW to operate one of the pumps in PS 15. The sloped roof on both the Pumping Station and restrooms allow for translucent clerestory panels that allow daylight into the facility. Windows will be provided along the south side of the building to allow people to see the inner workings of the facility. There will be a station status display for visitors to view. An informational kiosk will also be provided for educational purposes. If approved by the County, we will also likely have a bike trail map located near the bike station.

The site development was designed to minimize the elimination of critically needed boat trailer parking in Marshall Park. Design features were included to maintain the existing boat trailer parking stalls and minimize the exposure of the pumping station to boat trailer parking. Equipment for the station will be removed from the building using the double door entrance on the east side of the building along with the concrete pad extension.

The building materials will be durable and cleanable. The walls are constructed of burnished concrete blocks in a range of warm neutral colors to create a subtle range similar to natural stone. Cement board and composite wood siding will be used for the clerestory and roof fascia.

The project is expected to create 27,000 hours of work for both contractors and consulting engineers. There will be no additional full time equivalent jobs created by this project.

Figures 1 and 2 show the existing location of PS 15 in relation to Marshall Park.

FIGURE 1

MMSD PS 15-Allen Boulevard towards Marshall Park



FIGURE 2

Relationship of MMSD PS 15 to Marshall Park



-Project Schedule

Table 2 shows the proposed bidding and construction schedule for PS 15.

TABLE 2

<u>Bidding and Construction Schedule-PS 15</u>

Urban Design Commission Information Meeting	August 12, 2015
City of Madison Planning Commission Submittal	December 21, 2015
Submittal to Madison Parks	December 21, 2015
Madison Parks Commission Meeting	January 13, 2016
Urban Design Commission Meeting	February 10, 2016
Madison Plan Commission Meeting	February 22, 2016
City Council Approval-Conditional Use Permit	March 1, 2016
Advertise Project for Bids	March 1, 2016
Open Bids	March 31, 2016
Project Award-Contractor	April 14, 2016
Construction Begins	May 2016
Project Erosion Controls Completed	May 31, 2016
Building Addition Foundation	August 31, 2016
Meter Vault and Force Main Connection Manhole	August 31, 2016
Site Work and Paving (Binder Course Only)-Start Date	September 6, 2016
Bathroom Construction	October 31, 2016
Site Work and Paving (Binder Course Only)	October 31, 2016
Pumping Station Building Completion	December 2016
Final Paving	May 31,2017
Project Completion	September 30, 2017
	1

Building Sizes, Lot Coverage, Estimated Project Cost and Bike Stalls

The Pumping Station will be 1,650 square feet while the restrooms will be 380 square feet. The easement for PS 15 is 21,000 square feet. A portion of the construction will take place outside of the easement in both Marshall Park as well as in the City of Middleton storm sewer easement. The estimated project cost including the restrooms is \$3,800,000. The bike station will be provided with 4 stalls for bike parking.

RUBIX - model: WS-W2504, WS-W2505

LED Wall Mount

WAC LIGHTING

Responsible Lighting®

 Fixture Type:
Catalog Number:
Project:
Location:

PRODUCT DESCRIPTION

Available in single- and twin-light configurations, this die cast aluminum LED wall luminaire is wet location listed for a broad range of exterior lighting applications. Designed with a square profile, this version of Rubix mounts upwards or downwards.

FEATURES

- · Energy Star® rated
- · CEC Title 24 Compliant
- Mounts up or down
- · IP65 Rated, ETL & cETL Wet Location Listed
- · Die-Cast Aluminum Construction
- Universal Voltage Input (120V 277V)
- Dimming: ELV (120V) or 0-10V

SPECIFICATIONS

Construction: Aluminum with etched glass.

Power: Integral driver in luminaire. 120V - 277V input.

Light Source: High output LED

Mounting: Mounts directly to Junction box Dimming: 0-10V Dimming: 100%-10%

ELV Dimming: 100%-15% (120V only)

Finish: Brushed Aluminum (AL), Black (BK), Bronze (BZ), Graphite (GH), White (WT)


Color Temp: 3000K

CRI: 90

Rated Life: 70,000 hours

Standards: Energy Star® rated, IP65 Rated, ETL & cETL Wet Location Listed,

CEC Title 24 Compliant, Dark Sky Friendly.

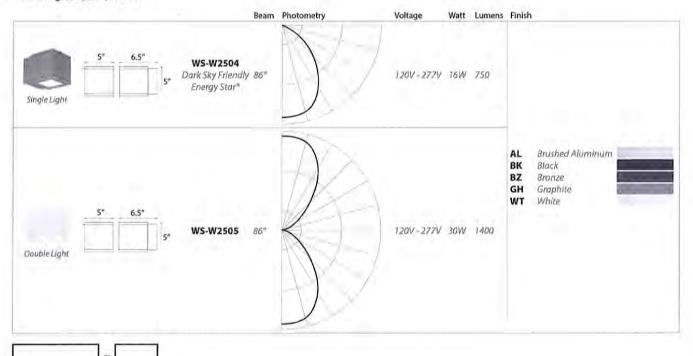


Example: WS-W2504-GH

waclighting.com Phone (800) 526.2588 Fax (800) 526.2585 Headquarters/Eastern Distribution Center 44 Harbor Park Drive Port Washington, NY 11050 Central Distribution Center 1600 Distribution Ct Lithia Springs, GA 30122 Western Distribution Center 1750 Archibald Avenue Ontario, CA 91760

MADISON METROPOLITAN SEWERAGE DISTRICT MADISON, WISCONSIN

PUMPING STATION 15 REHABILITATION CITY OF MADISON PLANNING COMMISION SUBMITTAL

Madison Metropolitan Sewerage District

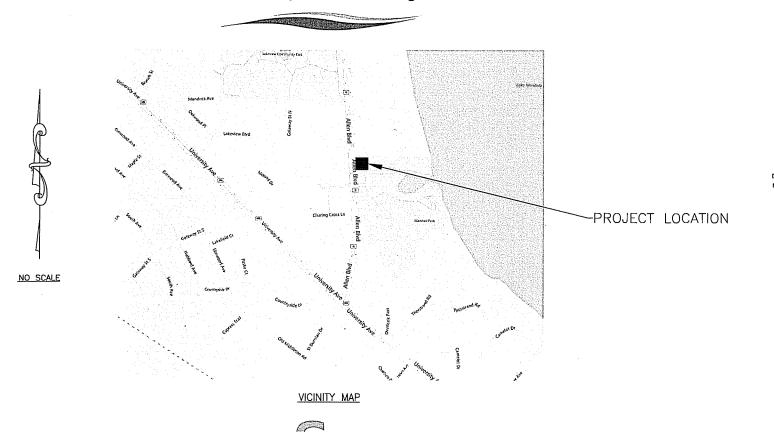

KISTING LITHLITIES

WHERE THE DRAWINGS INCLUDE INFORMATION PERTAINING TO THE LOCATION OF UNDERGROUND UTILITY FACILITIES, SUCH INFORMATION REPRESENTS ONLY THE OPINION OF THE ENGINEER AS TO THE LOCATION OF SUCH UTILITIES. THE INFORMATION IS INCLUDED ONLY FOR THE CONVENIENCE OF THE CONTRACTOR. THE UTILITY LOCATIONS WERE DETERMINED FROM THE BEST AVAILABLE RECORDS. THE ENGINEER AND OWNER ASSUME NO RESPONSIBILITY WHATEVER WITH RESPECT TO THE SUFFICIENCY OR ACCURACY OF THE INFORMATION SHOWN ON THE DRAWINGS REGARDING THE LOCATION OF UNDERGROUND UTILITY FACILITIES OR THE MANNER IN WHICH THEY ARE TO BE REMOVED OR ADJUSTED. IT SHALL BE THE CONTRACTOR'S RESPONSIBILITY TO DETERMINE THE ACTUAL LOCATION OF ALL SUCH FACILITIES. THE CONTRACTOR SHALL DETAIN FORM THE RESPECTIVE UTILITY COMPANIES DETAILED INFORMATION REGARDING THE LOCATION OF THE UTILITY FACILITIES AND THE WORKING SCHEDULES OF THE UTILITY FACILITIES.




TO OBTAIN LOCATION OF PARTICIPANT'S UNDERGROUND FACILITIES BEFORE YOU DIG IN WISCONSIN

CALL DIGGERS HOTLINE 1-800-242-8511

WIS, STATUTE 182.0175 (1974)
REQUIRES MIN, OF 3 WORK DAYS
NOTICE BEFORE YOU EXCAVATE.



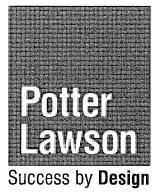

Consulting Engineers

WWW.BAXTERWOODMAN.COM

BAXTER & WOODMAN, INC. STATE OF WISCONSIN — PROFESSIONAL DESIGN FIRM LICENSE NO. — 484-011 — EXPIRES 1/31/2016

NOT FOR BIDDING

PROJECT NO.: 140963

List of Drawing


Demolition Site Plan (Existing Condition Site Plan & Erosion Control


L-01

Landscape Plan

Electrical Site Plan (Photo

LAND USE SUBMITTAL

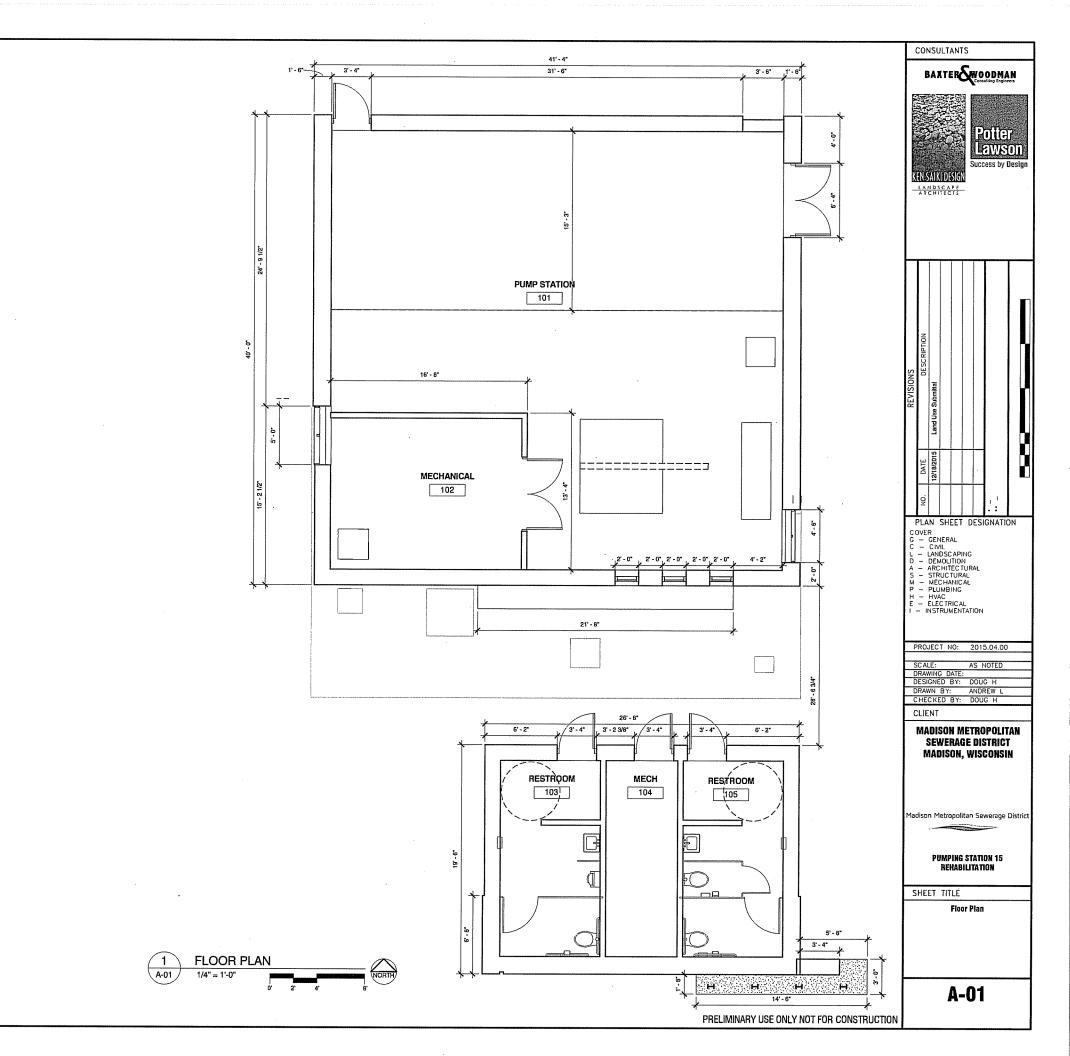

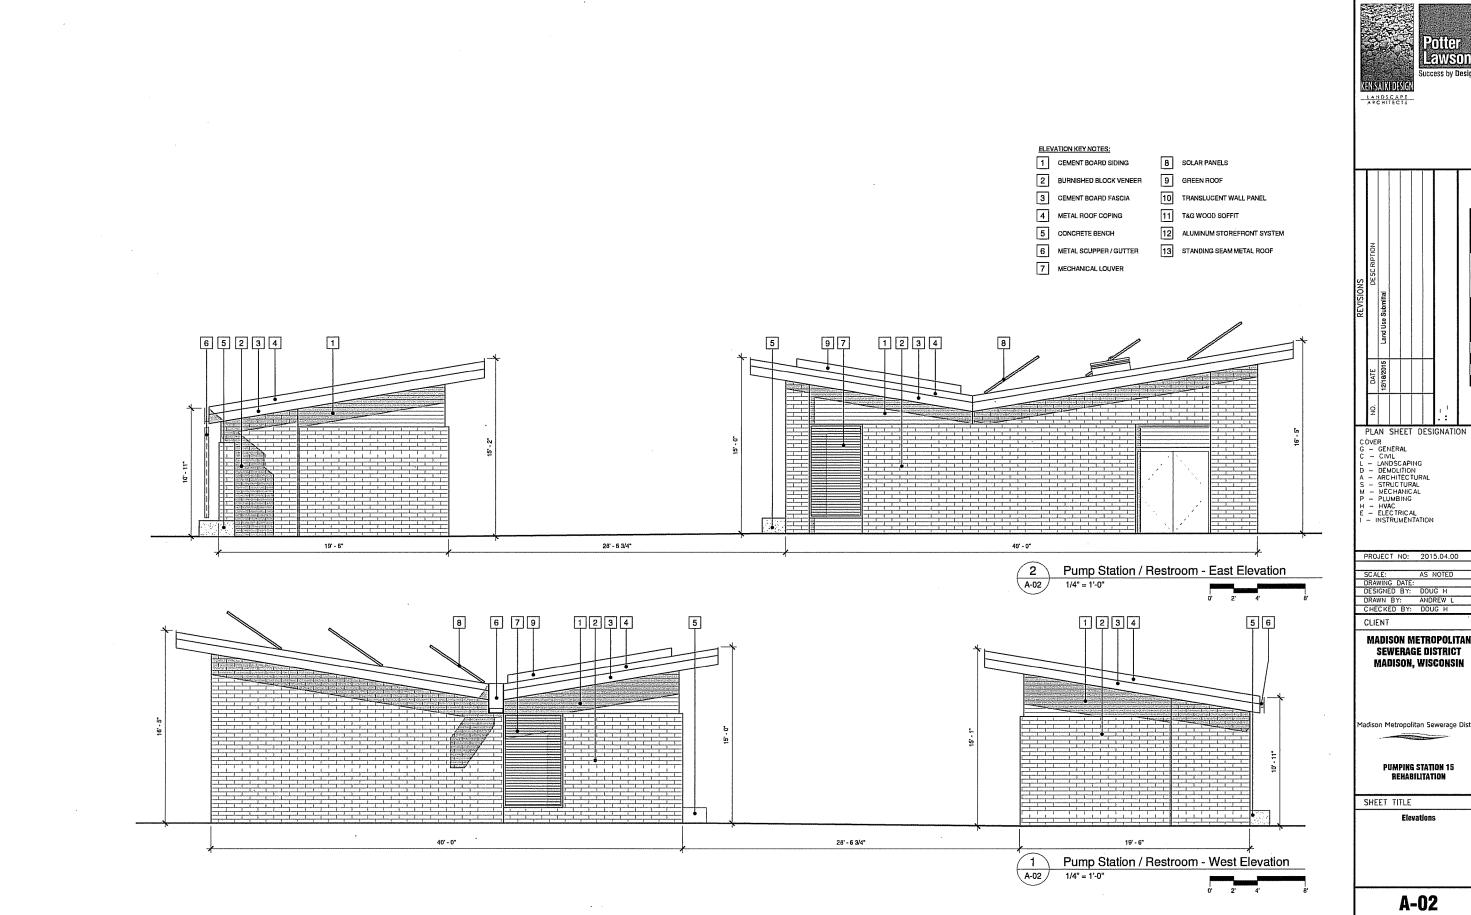

BAXTER WOODMAN



ARCHITECTS

DRAWING DATE:
DESIGNED BY: DOUG H
DRAWN BY: ANDREW L
CHECKED BY: DOUG H

CLIENT

MADISON METROPOLITAN SEWERAGE DISTRICT MADISON, WISCONSIN


PUMPING STATION 15 REHABILITATION

SHEET TITLE

Elevations

A-02

PRELIMINARY USE ONLY NOT FOR CONSTRUCTION

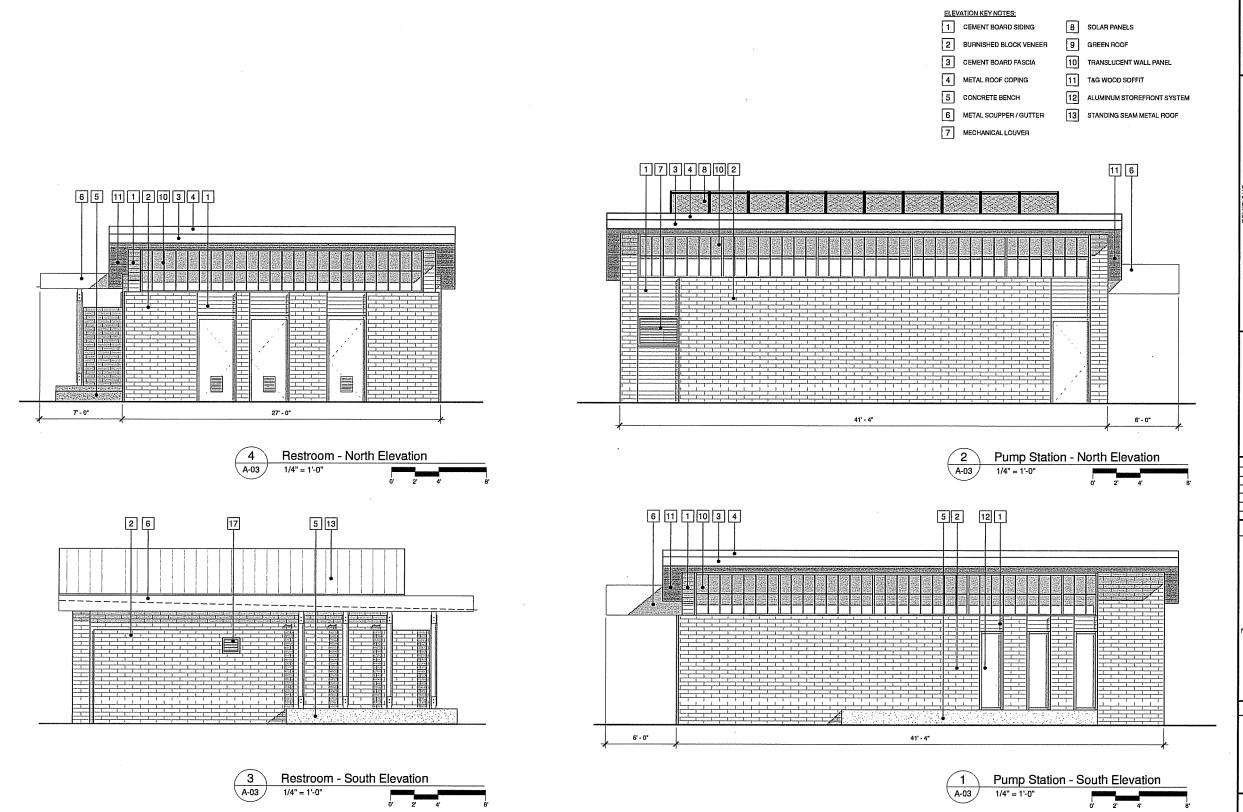

PRELIMINARY USE ONLY NOT FOR CONSTRUCTION

CONSULTANTS BAXTER WOODMAN Lawson Success by Design LANDSCAPE ARCHITECTS

PLAN SHEET DESIGNATION

PLAN SHEET DES
COVER
G - GENERAL
C - CIVIL
L LANDSCAPING
O - DEMOLITION
A - ARCHITECTURAL
S - STRUCTURAL
I - MECHANICAL
P - PLUMBING
I - HVAC
- ELECTRICAL
INSTRUMENTATION

SCALE: AS NOTED
DRAWING DATE:
DESIGNED BY: DOUG H DRAWN BY: ANDREW L
CHECKED BY: DOUG H

CLIENT

MADISON METROPOLITAN SEWERAGE DISTRICT MADISON, WISCONSIN


PUMPING STATION 15 REHABILITATION

SHEET TITLE


A-03




South-East Perspective

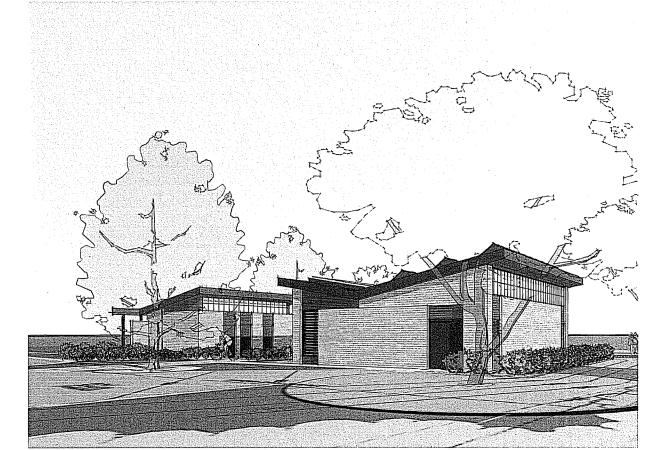

North-East Perspective

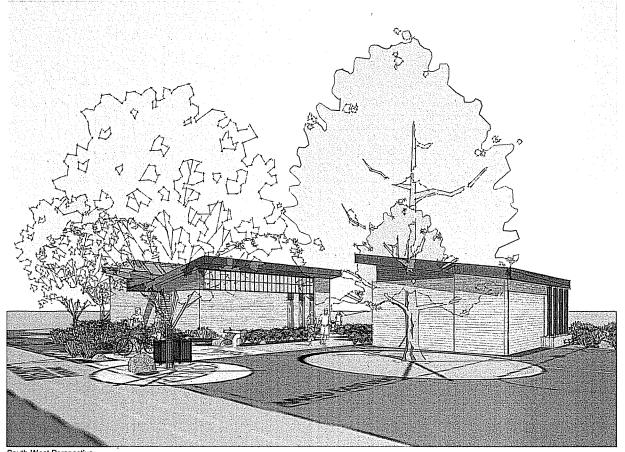

South-West Perspective

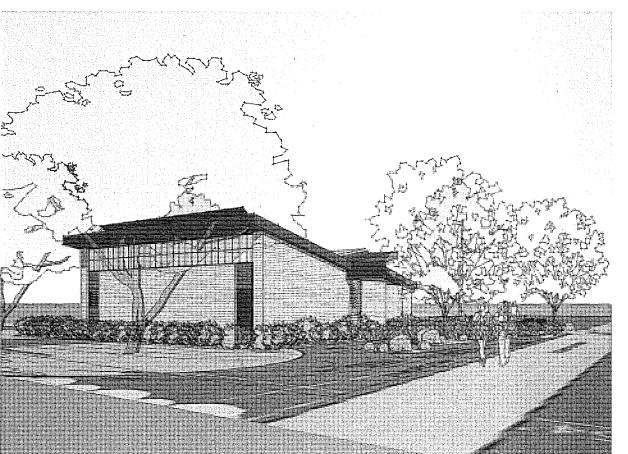

BAXTER WOODMAN





FROULCT NO.	2013.04.00
SCALE:	AS NOTED
DRAWING DATE:	
DESIGNED BY:	DOUG H
DRAWN BY:	ANDREW L
CHECKED BY:	DOUG H

CLIENT


MADISON METROPOLITAN SEWERAGE DISTRICT MADISON, WISCONSIN

PUMPING STATION 15 REHABILITATION


SHEET TITLE


Perspectives

A-04

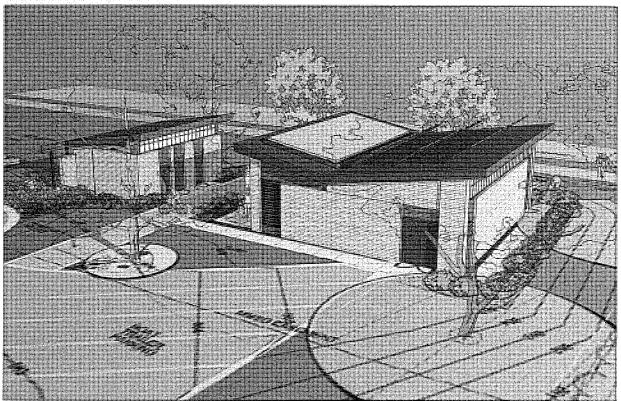



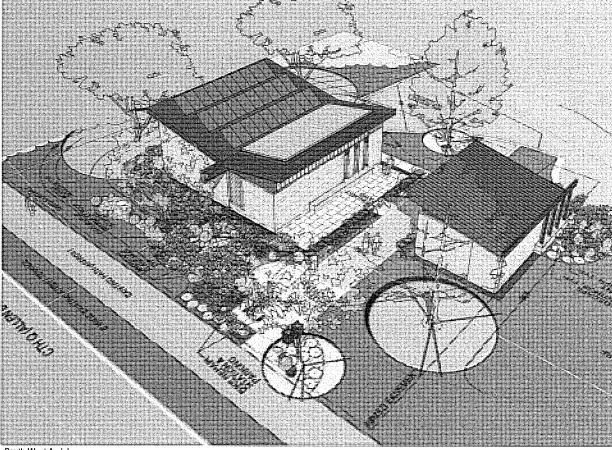


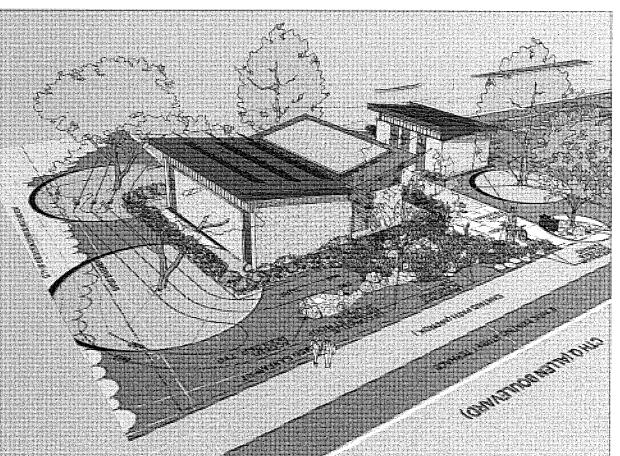

North-West Aerial

BAXTER WOODMAN



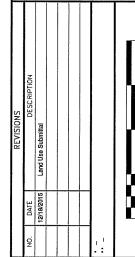

PLAN SHEET DESIGNATION COVER G - GENERAL C - CIVIL L - LANDSCAPING D - DEMDLINON A - ARCHITECTURAL S - STRUCTURAL M - MECHANICAL P - PLUMBING H - HVAC E - ELECTRICAL I - INSTRUMENTATION


CLIENT

MADISON METROPOLITAN SEWERAGE DISTRICT MADISON, WISCONSIN

PUMPING STATION 15 REHABILITATION

SHEET TITLE

A-05

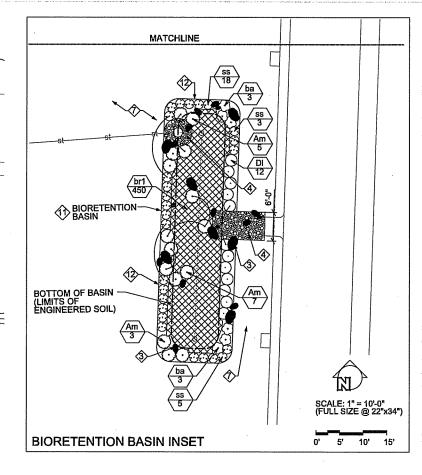

LEGEND

- MAINTENANCE EDGE, SEE
- SHREDDED HARDWOOD BARK MULCH
- 3 ACCENT BOULDER, SEE DETAIL
- DECORATIVE COBBLES, SEE DETAIL 5/L-2
- SHREDDED HARDWOOD BARK MULCH RING AT BASE OF TREE, SEE DETAIL 1/L-2
- SEEDED NO-MOW FESCUE LAWN WITH EROSION CONTROL MAT

- SEEDED BLUEGRASS LAWN
- STEEL EDGING
- ♦ BENCH, SEE DETAIL 3/L-2
- EXTENSIVE GREEN ROOF -SEDUM TILE & PERENNIALS PER PLANT SCHEDULE
- JUTE MESH OVER SHREDDED HARDWOOD BARK MULCH (ENTIRE BIORETENTION BASIN)
- (2) SHOVEL-CUT EDGING

PLANT SCHEDULE

-PERMEABLE PAVERS. DO NOT TEMPORARILY STORE, STAGE OR DUMP LANDSCAPE MATERIALS IN THIS AREA. IF CLOGGING OF PAVEMENT SYSTEM OCCURS CONTRACTOR WILL BE RESPONSIBLE FOR REPAIRS AT NO ADDITIONAL COST TO OWNER.

Plant	List					
Key	Botanical Name	Common Name	Quantity	Size	Root Condition	Comments
	Deciduous Trees	President Control of the Control of		CANALISE NO CONTRACTOR OF CONT		
CU	Carpinus caroliniana	American Hombeam	1	2" Cal.	B&B	Space Per Plans
QB	Quercus bicolor	Swamp White Oak	2	2" Cal.	B&B	Space Per Plans
(1774)	Ornamental Trees		ata a taga	retail a sortine process.		
AG	Amelanchier x grandiflora 'Robinhili'	Robinhill Serviceberry	3	6' Ht.	8&8	Multi-Stem Tree; Space Per Plans
	Deciduous Shrubs		Company of the compan			
Am	Aronia melanocarpa 'Morton'	Iroquois Beauty Chokeberry	18	24" Ht.	Cont	Space 3'-0" o.c.
DI	Diervilla lonicera 'Copper'	Copper Dwarf Bush Honeysuckle	75	24" Sprd.	Cont	Space 2'-6" o.c.
ΝT	llex verticillata 'Red Sprite'	Red Sprite Winterberry	11	24" Ht.	Cont	Space 2'-6" o.c.
M	llex verticillata 'Jim Dandy'	Jim Dandy Winterberry	1	24" Ht.	Cont	Space Per Plans
	Perennials/Grasses/Groundcovers		AND VICTORIA			
al	Allium tanguticum 'Summer Beauty'	Summer Beauty Allium	17	#1	Cont.	Space 12" o.c.
ac	Allium cemuum	Nodding Onion	120	2" sq. x 3.5" deep min.	Plug	Space 12" o.c. mix randomly into green roof
ba	Baptisla 'solar flare' Prairieblues	Solar Flare False Indigo	34	#1	Cont	Space 30" o.c.
55	Schizachyrium scoparium 'MinnblueA'	Blue Heaven Little Bluestem	63	#1	Cont	Space 24" o.c.
rf	Rudbeckia fulgida 'Early Bird Gold'	Early Bird Gold Cone flower	18	#1	Cont	Sapce 18" o.c.
ls	Liatris spicata 'Kobold'	Kobold Spiked Gayfeather	5	#1	Cont	Sapce 18" o.c.
pγ	Panicum virgatum 'Shenandoah'	Shenandoah Switchgrass	40	#1	Cont	Space 30" o.c.
7.00	Bloretention Area Mlx	V/2004578-250-250-250-250-250-250-250-250-250-250	4692696		7.50 (4.00)	TECHT PERSONS ESTE AND ESTE A
br1	Asclepias tuberosa	Butterfly Weed	50	2" sq. x 5" deep min.	. Plug	
	Aquilegia canadensis	Columbine	30	2" sq. x 5" deep min.	Plug	
	Carex bicknellii	Copper Shouldered Oval Sedge	170	2" sq. x 5" deep min.	Plug	
	Carex bebbii	Bebb's Oval Sedge	60	2" sq. x 5" deep min.	Plug	Mix evenly & Space 12" o.c.
	Carex sprengelli	Long Beaked Sedge	55	2" sq. x 5" deep min.	Plug	• •
	Carex vulpinoidea	Brown Fox Sedge	55	2" sq. x 5" deep min.	Plug	
	Rudbeckia speciosa sullivantii	Showy Black-Eved Susan	30	2" sq. x 5" deep min.	Plua	

1xL 5' 10' 15'

PLANTING.

FLANTING.

6. SPACE SHRUBS AND PERENNIALS PER PLANT SCHEDULE.

7. ALL WRAPPINGS, WIRE BASKETS, BURLAP, TWINE AND OTHER MISCELLANEOUS MATERIAL SHALL BE REMOVED FROM ENTIRE ROOT BALL PRIOR TO INSTALLATION.

8. ALL LAWN AREAS ADJACENT TO THE PROJECT SITE THAT ARE DISTURBED BY CONSTRUCTION ACTIVITIES INCLUDING, BUT NOT LIMITED TO, UTILITY TRENCHING, ACCESS, OR MATERIALS STORAGE SHALL BE REPAIRED WITH SEED MIXES AS NOTED ON THE PLANS AND PER SECTION 32 92 00, TURF AND GRASSES.

9. REPAIR TO ORIGINAL CONDITION ALL EXISTING VEGETATION NOTED TO REMAIN INCLUDING PLANTS, MULCH AND EDGING THAT HAVE BEEN DISTURBED BY CONSTRUCTION ACTIVITIES.

10. ALL PLANTING BEDS TO RECEIVE SHREDDED HARDWOOD BARK MULCH UNLESS OTHERWISE NOTED.

11. HOLD CENTER OF PERENNIAL PLANTINGS A MINIMUM OF 18"AND CENTER OF SHRUB PLANTINGS A MINIMUM OF 24" FROM BACK OF CURB/EDGE OF PAVEMENT.

CONSULTANTS

BAXTER SWOODHAN



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ARCHITECTS

DATE 718/2015

PLAN SHEET DESIGNATION

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- PLAN SHEET DES
 COVER
 G = GENERAL
 C = CIVIL
 L = LANDSCAPING
 D = DEMILITION
 9 = ARCHITECTURAL
 7 = STRUCTURAL
 1 = HECHANICAL
 PLUMBING
 HVAC
 ELECTRICAL
 INSTRUMENTATION
- PROJECT NO 140963

SCALE: AS NOTED
DRAVING DATE: 12/18/2015
DESIGNED BY: NMS
DRAWN BY: NMS
CHECKED BY: NMS DRAVN BY: CHECKED BY: CLIENT

> **MADISON METROPOLITAN** SEWERAGE DISTRICT MADISON, WISCONSIN

Madison Metropolitan Sewerage District

PUMPING STATION 15 REHABILITATION

SHEET TITLE

LANOSCAPE PLAN

L-01

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LINGTON\MAMSD\14D963-PS 15\CADD\DRAW 1: ---- By: 4211er & Woodman, Inc. ght @ ----- By Baxter & Woodman, Inc. of Wisconsin — Professional Design Firm e No. — 484-011 — Expires 1-31-16

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LANDS CAPE

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MADISON METROPOLITAN SEWERAGE DISTRICT MADISON, WISCONSIN

PUMPING STATION 15 REHABILITATION

SHEET TITLE

SITE RENDERING

L-02

SCALE: 1" = 20' CITY OF MIDDLETON STORM SEWER EASEMENT DEMOLISH EXIST DEMOLISH EXIST ELECTRICAL EQUIP. AFTER STARTUP OF NEW ELECTRICAL EQUIPMENT, SEE SH. C-6 REMOVE ELECTRICAL SERVICE
AND PROVIDE TEMPDRARY
SERVICE, SEE SH. C-6 — EXISTING MMSD A BOULEVARD) 24" FM SAWCUT GURB & GUTTER (FULL DEPTH) Pumping Station Na. 15 CTH Q (ALLEN 20'-45'20' 12" SAWCUT PAVEMENT (FÚLL DEPTH) A REMOVE PAVEMENT AND CURB & GUTTER - Tree and Stump Removal Within Easement (Typ.) @18" 15" 周 A 55' 12" 25' REMOVE PIPE FOR
INSTALLATION OF
VENTURI METER VAULT
AND FORCE MAIN
BYPASS MANHOLE
SEE SH. C-4 A 35 A 35' -REMOVE CURB & GUTTER @J23' Bit. EXISTING FLOW DIVERSION MANHOLE, SEE DETAIL SH. C.43 -SAWCUT CURB & GUTTER (FULL DEPTH)

BENCHMARK

PUMPING STATION 15 BENCHMARK: ON NORTHWEST CORNER OF PUMPING STATION 15 FOR MMSD AT MARSHALL PARK ON ALLEN BOULEVARD — EL. 865.25'.

NOTES:


- 1. REFER TO CONSTRUCTION SEQUENCE IN SECTION 01 31 14 FOR SPECIFIC DEMOLITION REQUIREMENTS.
- STRIP TOPSOIL AND STOCKPILE IN ACCORDANCE WITH SECTION 31 16 00 FOR AREAS TO BE IMPROVED (NDT SHOWN). FOLLOW SCHEDULE INCLUDED IN SECTION 01 14 15 PUMPING STATION OPERATION DURING CONSTRUCTION.

CONSULTANTS

BAXTER WOODMAN



Success by Desig LANDSCAPE ARCHITECTS

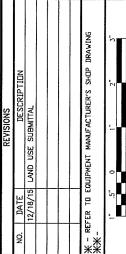

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PROJECT NO: 140963

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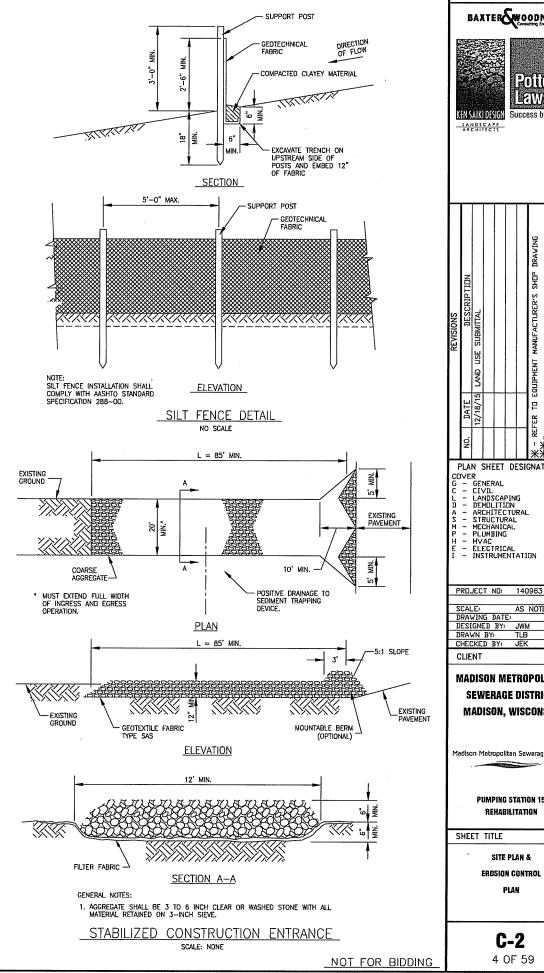
PUMPING STATION 15 REHABILITATION

SHEET TITLE

DEMOLITION SITE PLAN


C-1 3 OF 59

- SOIL DISTURBANCE SHALL BE CONDUCTED IN SUCH A MANNER AS TO MINIMIZE EROSION. SOIL STABILIZATION MEASURES SHALL CONSIDER THE TIME OF YEAR, SITE CONDITIONS AND THE USE OF TEMPORARY OR PERMANENT MEASURES.
- SOIL EROSION AND SEDIMENT CONTROL FEATURES SHALL BE CONSTRUCTED PRIOR TO THE COMMENCEMENT OF UPLAND DISTURBANCE.
- TEMPDRARY SOIL STABILIZATION SHALL BE APPLIED TO DISTURBED AREAS WITHIN 15 CALENDAR DAYS OF THE END OF ACTIVE HYDROLOGIC DISTURBANCE. PERMANENT STABILIZATION SHALL BE DONE WITHIN 15 DAYS AFTER COMPLETION OF FINAL GRADING OF THE SOIL.
- 4. ALL STORM SEWER FACILITIES THAT ARE OR WILL BE FUNCTIONING DURING CONSTRUCTION SHALL BE PROTECTED, FILTERED, OR OTHERWISE TREATED TO REMOVE SEDIMENT.
- 5. ALL TEMPORARY EROSION AND SEDIMENT CONTROL MEASURES SHALL BE REMOVED WITHIN 30 DAYS AFTER FINAL SITE STABILIZATION IS ACHIEVED OR AFTER THE TEMPORARY MEASURES ARE NO LONGER NEEDED. TRAPPED SEDIMENT AND OTHER DISTURBED SOIL AREAS SHALL BE PERMANENTLY
- ALL TEMPORARY AND PERMANENT EROSION CONTROL MEASURES MUST BE MAINTAINED AND REPAIRED AS NEEDED. THE GENERAL CONTRACTOR WILL BE RESPONSIBLE FOR INSPECTION AND



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ladison Metropolitan Sewerage Distri

PUMPING STATION 15 REHABILITATION

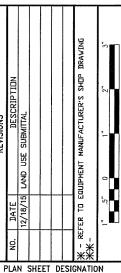SHEET TITLE

SITE PLAN & **EROSION CONTROL** PLAN

C-2 4 OF 59

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BENCHMARK

PUMPING STATION 15 BENCHMARK:
ON NORTHWEST CORNER OF PUMPING STATION 15 FOR MMSD AT MARSHALL PARK
ON ALLEN BOULEVARD — EL. 865.25'.



CONSULTANTS



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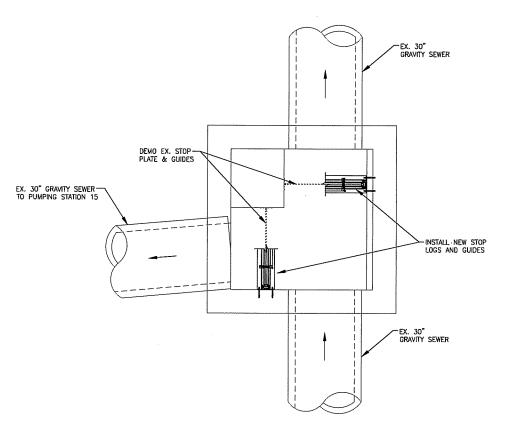
SHEET TITLE

MECHANICAL SITE PLAN

C-3 5 OF 59


PUMPING STATION 15 FFE=865.80 PROPOSED GAS SERVICE BY MG&E, COMTRACTOR RESPONSIBLE FOR GAS SERVICE COORDINATIONS IN ACCORDANCE WITH SECTION 33 51 11 4" PVC DRAIN -1" TYPE "K" COPPER WATER SERVICE (TYP) VENTURI METER VAULT -SEE SH. C-4 FORCE MAIN BYPASS MANHOLE — SEE SH. C-4 EX. CATCH BASIN-BIO-RETENTION BASIN-OVERFLOW STRUCTURE SEE DETAIL SH. CORE HDLE IN EX. CATCH BASIN, INSTALL NEW STORM SEWER AND GROUT ANNULAR SPACE 6 CORRUGATED HDPE STORM SEWER @ 1.00% Bil. LEXISTING FLOW DIVERSION MANHOLE, SEE DETAIL THIS SH. Д A

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INSTALLATION OF NEW STOP LOGS AND GUIDES MUST BE DONE UNDER ACTIVE FLOW CONDITIONS, PREFERABLY DURING PERIODS OF LOW FLOW. CONTRACTOR IS RESPONSIBLE FOR FLOW DIVERSION WITHIN THE STRUCTURE AS NEEDED TO COMPLETE THE WORK

EXISTING FLOW DIVERSION MANHOLE



SITE LIGHTING CALCULATIONS

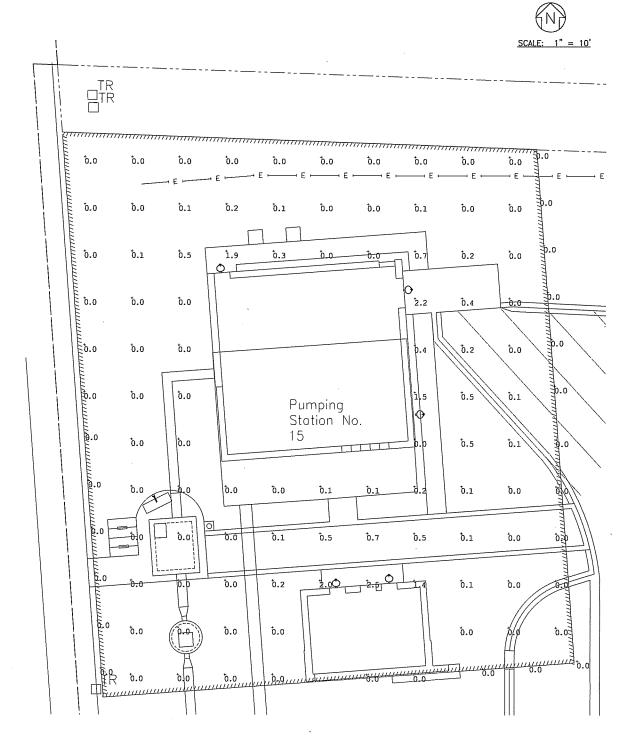NDTE:

1. COORDINATE INSTALLATION OF NEW ELECTRICAL SERVICE WITH MG&E.

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PLAN SHEET DESIGNATION

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PUMPING STATION 15 REHABILITATION

SHEET TITLE

ELECTRICAL SITE PLAN AND SITE LIGHTING CALCULATIONS

> **C-6** 8 OF 59

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<u>SWITCHGEAR</u> B M-4 <u>SCC</u> -ELECTRICAL EQUIPMENT SEE SH. E-2 FOR DETAILS /--¾" FREEZE--PROOF HOSE BIB HVAC OPENING-SEE SH. H-2 FOR DETAILS VFD PUMP_15A <u>VFD</u> <u>VFD</u> <u>PUMP 15B</u> <u>PUMP 15C</u> * FREEZE-PROOF-HOSE BIB -- ALUM. RAILING ALUM. RAILING D M-5 D M-5 —HVAC UNIT SEE SH. H—2 FOR DETAILS REMOVABLE RAILING— (TYP. FOR 2) ←EX. STAIRS MONORAIL -1" NAT. GAS PIPING TO BY CONTRACTOR FLOOR DRAIN SEE SH. A-1 FOR BUILDING DETAILS (TYP) -HVAC OPENING SEE SH. H-2 FOR DETAILS FUTURE ODOR CONTROL SYSTEM NAT. GAS SERVICE -AND METER BY MG&E ~4" VENT PIPE AIR COMPRESSOR SEAL OPENING W/ REINFORCED-DIAMOND PLATE COVER, 4" BEYOND -- DECORATIVE WINDOW SEE SH. A-1 FOR DETAILS (TYP) -Bubbler System L2'-0" X 2'-0" ALUM. FLDOR ACCESS DOOR -4'-0" X 4'-0" ALUM. DOUBLE LEAF FLOOR ACCESS DODR -2'-6" X 2'-6" ALUM. FLOOR ACCESS DOOR -2'-0" X 2'-0" ALUM. FLOOR ACCESS DOOR C M-5 B M-4 **UPPER PLAN** SCALE: 1'-0"

CONSULTANTS BAXTER WOODMAN



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PROJECT NO: 140963

DESIGNED BY: JWM

DRAWN BY: TLB CLIENT

> MADISON METROPOLITAN SEWERAGE DISTRICT MADISDN, WISCONSIN

PUMPING STATION 15

PUMPING STATION 15 REHABILITATION

SHEET TITLE

UPPER PLAN - MECHANICAL

M-3 38 OF 59

ALL FLODR ACCESS DOORS TO BE FLUSH WITH NEW CONCRETE FLOOR TOPPING.

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C - CAR

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PUMPING STATION 15 REHABILITATION

SHEET TITLE

G-01

NORTH