


ZONING ZONING LOT 4 & PARTIAL LOT 5 SITE LOT A & PARTIAL LOT 5 SITE FLOOR AREA RATIO ALLOWED ALL

54,561 S.F.


TOTAL BUILDING

S I T E P L A N

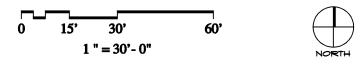


M A D I S O N P A I N M A N A G E M E N T



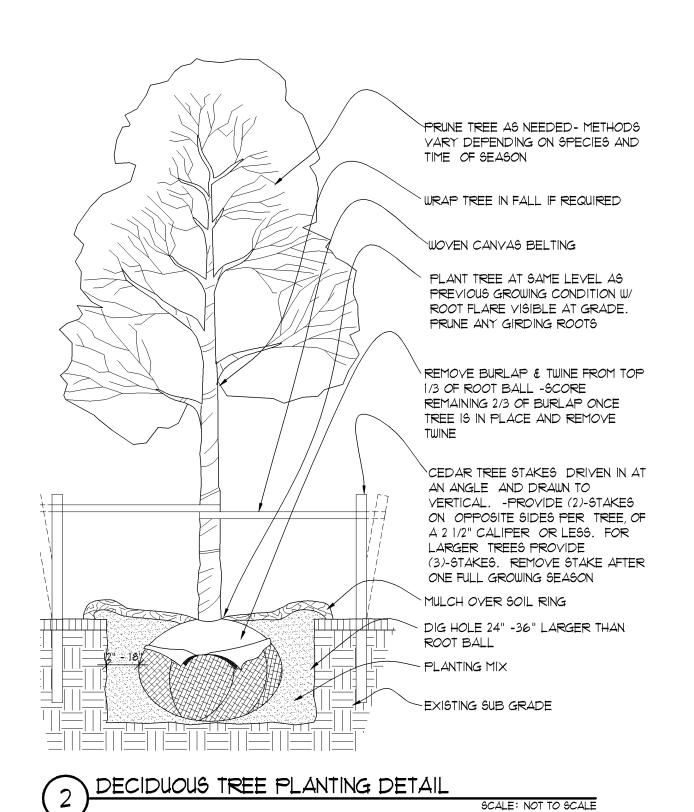

-DO NOT BURY ANY LOWER BRANCHES -PLANT TREE AT SAME LEVEL AS PREVIOUS GROWING CONDITION W/ ROOT FLARE VISIBLE AT GRADE. PRUNE ANY GIRDING ROOTS WOVEN CANVAS BELTING CEDAR TREE STAKES DRIVEN IN AT AN ANGLE AND DRAWN TO VERTICAL. -PROVIDE (2)-STAKES ON OPPOSITE SIDES PER TREE, OF A 2 1/2" CALIPER OR LESS. FOR LARGER TREES PROVIDE (3)-STAKES. REMOVE STAKE AFTER ONE FULL GROWING SEASON - REMOVE BURLAP & TWINE FROM TOP 1/3 OF ROOT BALL -SCORE REMAINING 2/3 OF BURLAP ONCE TREE IS IN PLACE AND REMOVE MULCH OVER SOIL RING > DIG HOLE 24" -36" LARGER THAN ROOT BALL PLANTING MIX - EXISTING SUB GRADE

CONIFEROUS TREE PLANTING DETAIL

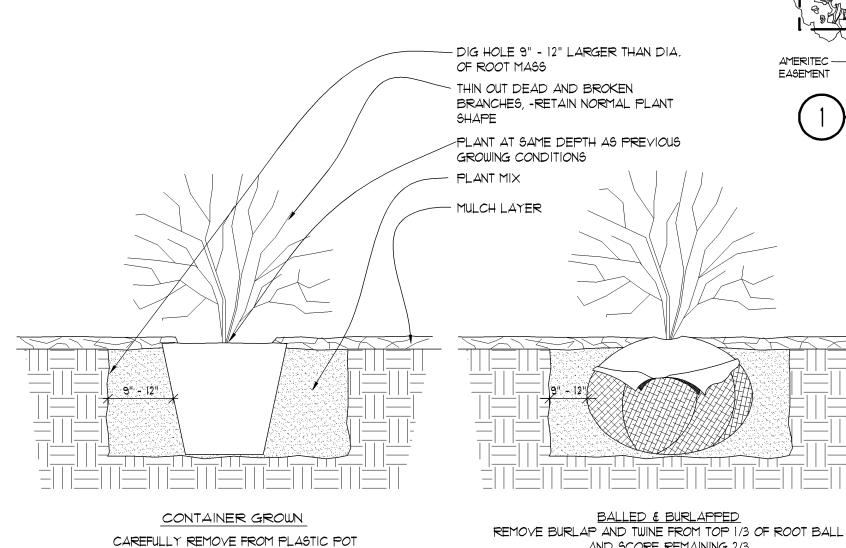



SCALE: |" = 30'-0' PREVIOUS LEVEL - PLANTING MIX FINISHED GRADE-MULCH LEVEL BALLED & BURLAPPED CONTAINER GROWN REMOVE BURLAP AND TWINE FROM TOP 1/3 OF ROOT BALL CAREFULLY REMOVE FROM PLASTIC POT AND SCORE ROOTS

CONIFEROUS SHRUB PLANTING DETAIL

AND SCORE REMAINING 2/3

Plant Material Table

Quantity	Code Name	Symbol	Scientific Name	Common Name	Planting Size	Points	Total Points	Con
6	GibiPS	0	Ginko biloba 'Princeton Sentry'	Princeton Sentry Maidenhair Tree	2 1/2"-Cal	35	210	1
5	AcruF	₩	Acer rubrum 'Franksred' Red Sunset Maple		3"-Cal	35	140	
12	Glts	0	Gleditsia triacanthos 'Sunburst'	Sunburst Honey Locust	2 1/2"-Cal	35	70	
6	Cabf	0	Carpinus betulis 'Fastigiata'	Pyramidal EuropeanHornbeam	3"-Cal	35	70	
Conifer Ever	green Tree					•		
Quantity	Code Name	Symbol	Scientific Name	Common Name	Planting Size	Points	Total Points	Con
8	PideB	0	Picea densata 'Bailey'	Black Hills Spruce	5' - 6'	120	75	
4	ThocP	*	Thuja occidentalis 'Pyramidalis'	Pyramidal Arborvitae	5' - 6'	15	60	
7	PifIV	**	Pinus flexis 'Vanderwolf's Pyramid'	Vanderwolf's Pyramid Limber Pine	5' - 6'	15	105	
6	JucoS	*	Juniperus scopulorum 'skyrocket'	Skyrocket upright juniper	5' - 6'	15	90	
Conifer Ever	green Shrub					•		
Quantity	Code Name	Symbol	Scientific Name	Common Name	Planting Size	Points	Total Points	Con
37	JuchSG	E LANGE	Juniperus chinensis 'Sea Green'	Sea Green Juniper	18" - 24"	3	69	
20	JupfGC	O	Juniperus x pfizeriana 'MonSan'	Gold Coast Juniper	18" - 24"	3	60	
12	JucoM	100	Juniperus communis 'Mondap'	Alpine Carpet Juniper	18"	3	36	
Perennial Gr	ass	, ,,,,,,,,,,,,,,,,,,,,,,,,,,,,,,,,,,,,,				1		
Quantity	Code Name	Symbol	Scientific Name	Common Name	Planting Size	Points	Total Points	Con
52	CaacK	*	Calamagrostis acutiflora "Karl Forester'	Karl Forester Feather Reed Grass	1-Gal	0	0	
69	PaviS	žw.	Panicum virgatum 'Shenandoah'	Shenandoah Switch Grass	1-Gal	0	0	
Perennial						•		
Quantity	Code Name	Symbol	Scientific Name	Common Name	Planting Size	Points	Total Points	Con
56	HeCB	*	Hemerocallis x 'Cranberry Baby'	Cranberry Baby Daylilly	1-Gal	0	0	
Shrub							1	.1
Quantity	Code Name	Symbol	Scientific Name	Common Name	Planting Size	Points	Total Points	Com
45	SpbuG		Spirea x bumalda "Goldmound"	Goldmound Spirea	15" - 18"	2	90	
12	PhviDS	4	Philadelphus x virginalis 'Dwarf Snowflake'	Dwarf Snowflake Mock Orange	18"	2	24	
17	PofrA	0	Potentilla fruticosa 'Abbotswood'	Abbotswood Potentilla	15" - 18"	2	34	
22	PhopM	0	Physocarpus opulifolius 'Monlo'	Diabolo Ninebark	2' - 3'	2	20	
35	ChjaTS	**	Chaenomeles Japonica 'Texas Scarlet'	Texas Scarlet Flowering Quince	18" - 24"	2	10	1
	•	•						
TOTAL LANDS	SCAPE POINTS 650 po	ints required (LES	SS 10 TREES REQUIRED PER PARKING STALL CO	OUNT AND SCREENING ALONG HWY 12/2	L4)		1163 TOTAL	POINT
Moist Meado	w Seed Mix							

GENERAL PLANTING NOTES

ALL PLANTS SHOWN AT MATURE SIZE.

NOTE: PER MEETING WITH THE CITY OF KENOSHA FORESTER, DIRK NELSON ON DECEMBER 12, 2006, A MINIMUM OF (30) - 2" CALIPER QUALITY TREES ARE TO BE PROVIDED ON THE GENESIS CLINIC LANDSCAPE

- 1. AT LEAST SEVENTY-TWO HOURS PRIOR TO ANY EXCAVATION, CONTRACTOR SHALL VERIFY UTILITY LOCATIONS AS GIVEN BY THE ELECTRIC, GAS, TELEPHONE, WATER, SEWER, AND CABLE TELEVISION COMPANIES, UTILITIES OR ENTITIES. REVIEW WITH OWNER'S REPRESENTATIVE SITE MECHANICAL, SITE ELECTRICAL AND LIGHTING, SITE GRADING AND DRAINAGE, SITE IRRIGATION AND ALL OTHER DRAWINGS PERTAINING TO UNDERGROUND UTILITY LOCATIONS. RECORD SET OF INFORMATION THE SAME AS IN POSSESSION OF OWNER'S REPRESENTATIVE. ALSO REVIEW OWNER'S "MARK SETS" OF ALL OF THESE DRAWINGS IN POSSESSION OF THE CONTRACTOR OR OWNER. MARK ALL SUCH UTILITIES ON THE SITE PRIOR TO COMMENCING. COORDINATE WITH OWNER BEFORE AND DURING CONSTRUCTION. REPAIR ANY DAMAGE TO ANY SYSTEM THAT IS CAUSED BY LANDSCAPE CONTRACTOR AT NO COST TO OWNER
- 2. ALL PLANTINGS SHALL COMPLY WITH STANDARDS AS DESCRIBED IN AMERICAN STANDARD OF NURSERY STOCK ANSI Z60.0 1986.
- 3. DEVIATIONS FROM THESE PLANS SHALL BE NOTED ON THE RECORD DRAWING BY THE CONTRACTOR AND ONLY WITH PRIOR APPROVAL OF THE LANDSCAPE ARCHITECT AND OWNER'S REPRESENTATIVE.
- 4. ALL PLANTS MUST BE BID AND SELECTED PER THE SIZES AND SPECIES SPECIFIED ON THE PLANS.
- 5. PROTECT PUBLIC FROM CONSTRUCTION WITH BARRIERS AND BARRICADES.
- 6. ALL AREAS THAT WERE DISTURBED DURING CONSTRUCTION AND AREAS NOT COVERED WITH PAVEMENT, BUILDING, PLANTING BEDS, OR TREE PITS ARE TO BE TOPSOILED 6" DEEP (MIN.) AND SHALL BE SODDED/SEEDED WITH SPECIFIED LAWN GRASS.
- 7. CONTRACTOR IS RESPONSIBLE FOR FURNISHING ALL MATERIALS, TOOLS, EQUIPMENT, LABOR, AND PLANTS NECESSARY FOR PROPER PLANTING AND INSTALLATION OF ALL LANDSCAPE MATERIAL.
- 8. QUANTITIES ON PLANT MATERIALS LIST ARE FOR CONVENIENCE ONLY. CONTRACTOR IS RESPONSIBLE FOR ALL PLANTS SHOWN ON LANDSCAPE PLANS AND COVERAGE OF ALL AREAS DELINEATED. WHERE DISCREPANCIES OCCUR BETWEEN PLANT LIST AND LANDSCAPE PLANS, THE PLANS ARE TO SUPERSEDE THE PLANT LIST IN ALL CASES.
- 9. ALL DISEASED, NOXIOUS OR INAPPROPRIATE MATERIALS SHALL BE REMOVED FROM THE PROPOSED SITE PRIOR TO THE START OF CONSTRUCTION AND DURING THE MAINTENANCE PERIOD.
- 10. GENERAL CONTRACTOR SHALL LEAVE THE SITE FREE OF CONSTRUCTION DESBRIS.
- 11. FINISH GRADES FOR SHRUB AND GROUND COVER AREAS SHALL BE HELD 1' BELOW TOP OF ADJACENT PAVEMENTS AND CURBS, UNLESS NOTED OTHERWISE ON THE PLANS.
- 12. ALL LAWN AND PLANTING AREAS SHALL SLOPE TO DRAIN A MINIMUM OF 2% UNLESS NOTED OTHERWISE AND REVIEWED WITH OWNER'S REPRESENTATIVE FOR FINAL APPROVAL.
- 13. ALL PERENNIAL, ANNUAL AND GROUND COVER AREAS TO RECEIVE A BLEND OF ORGANIC SOIL AMENDMENTS PRIOR TO PLANTING. ROTO-TILL THE FOLLOWING MATERIALS INTO EXISTING TOPSOIL TO A DEPTH OF APPROXIMATELY 8". A DEPTH OF 12" IN TREE PITS. PROPORTIONS AND QUANTITIES MAY REQUIRE ADJUSTMENT DEPENDING ON THE CONDITION OF EXISTING SOIL.
 - PER EVERY 100 SQUARE FEET ADD: -ONE - 2 CUBIC FOOT BALE OF PEAT MOSS, -2 POUNDS OF 5 -10 -5 GARDEN FERTILIZER,
 - -1/4 CUBIC YARD OF COMPOSTED MANURE, PLANT STARTER OR OTHER COMPOSTED, ORGANIC MATERIAL,
- 14. ALL SHRUBS TO BE POCKET PLANTED WITH A 50/50 MIX OF PLANT STARTER AND EXISTING SOIL. INSTALL TOPSOIL INTO ALL BEDS AS NEEDED TO ACHIEVE PROPER GRADE. REMOVE ALL EXCESSIVE GRAVEL,
- CLAY AND STONES. REFER TO DETAIL 4/A0.3 AND 5/A0.3. 15. PLANT ALL TREES SLIGHTLY HIGHER THAN FINISHED GRADE AT ROOT FLARE. BACK FILL HOLE WITH 2/3 EXISTING TOPSOIL AND 1/3 PEAT MOSS. AVOID ANY AIR POCKETS. DISCARD ANY GRAVEL CLAY OR STONES. REFER TO DETAILS 2/A0.3 AND 3/A0.3.
- 16. ALL TREES TO BE INSTALLED, STAKED AND GUYED ACCORDING TO DETAILS. REFER TO DETAILS 2/A0.3 AND 3/A0.3.
- 17. PROVIDE A 4'-0" DIAMETER MULCH RING ALL LAWN TREES.
- 18. ALL PLANTINGS TO BE WATERED AT THE TIME OF PLANTING, THROUGHOUT CONSTRUCTION AND UPON COMPLETION OF PROJECT AS REQUIRED.
- 19. WHERE SPECIFIED, ALL PLANT BEDS, PITS AND TREE RINGS ARE TO RECEIVE A MINIMUM OF 2'-3" DRESSING OF SHREDDED HARDWOOD BARK MULCH (OR BROWN ENVIRO-MULCH TAKE CARE WITH INSTALLATION NOT TO DAMAGE OR COVER PLANTS.
-). LAWN INSTALLATION: CONTRACTOR TO FURNISH AND PREPARE TOPSOIL (3" MIN) AND SEED BED (REMOVE ALL STONES 1" OR LARGER), APPLY STARTER FERTILIZER AND SEED UNIFORMLY. PROVIDE A MULCH COVERING SUITABLE TO GERMINATE AND ESTABLISH TURF. EROSION CONTROL MESH SHOULD BE USED IN SWALES AND STEEP GRADES WHERE APPLICABLE. METHODS OF INSTALLATION MAY VARY AT THE DISCRETION OF CONTRACTOR. IT IS HIS/HER RESPONSIBILITY TO ESTABLISH AND GUARANTEE A SMOOTH, UNIFORM, QUALITY TURF. IF STRAW MULCH IS USED AS A COVERING, A TACKIFIER MAY BE NECESSARY TO AVOID WIND DAMAGE.

RECOMMENDED SEED MIX SUPREME GRASS SEED MIX 17% RUGBY KENTUCKY BLUE GRASS 16% MERIT KENTUCKY BLUE GRASS 17% CREST KENTUCKY BLUE GRASS

12% KEN BLUE KENTUCKY BLUE GRASS 25% PENNLAWN RED FESCUE 15% CUTTER PERENNIAL RYE GRASS



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MADISON MANAGEMENT MADISON WI

REVISION:	٨	
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PROJECT NO.

27036

DATE:

SHEET NAME: LANDSCAPE PLAN, GENERAL NOTES,

AND PLANTING DETAILS SHEET NO:

NDECIDUOUS TREE PLANTING DETAIL

AND SCORE ROOTS I" DEEP WITH A SHARP


AND SCORE REMAINING 2/3

SCALE: NOT TO SCALE


I" DEEP WITH A SHARP KNIFE

SCALE: NOT TO SCALE

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B A S E M E N T P L A N

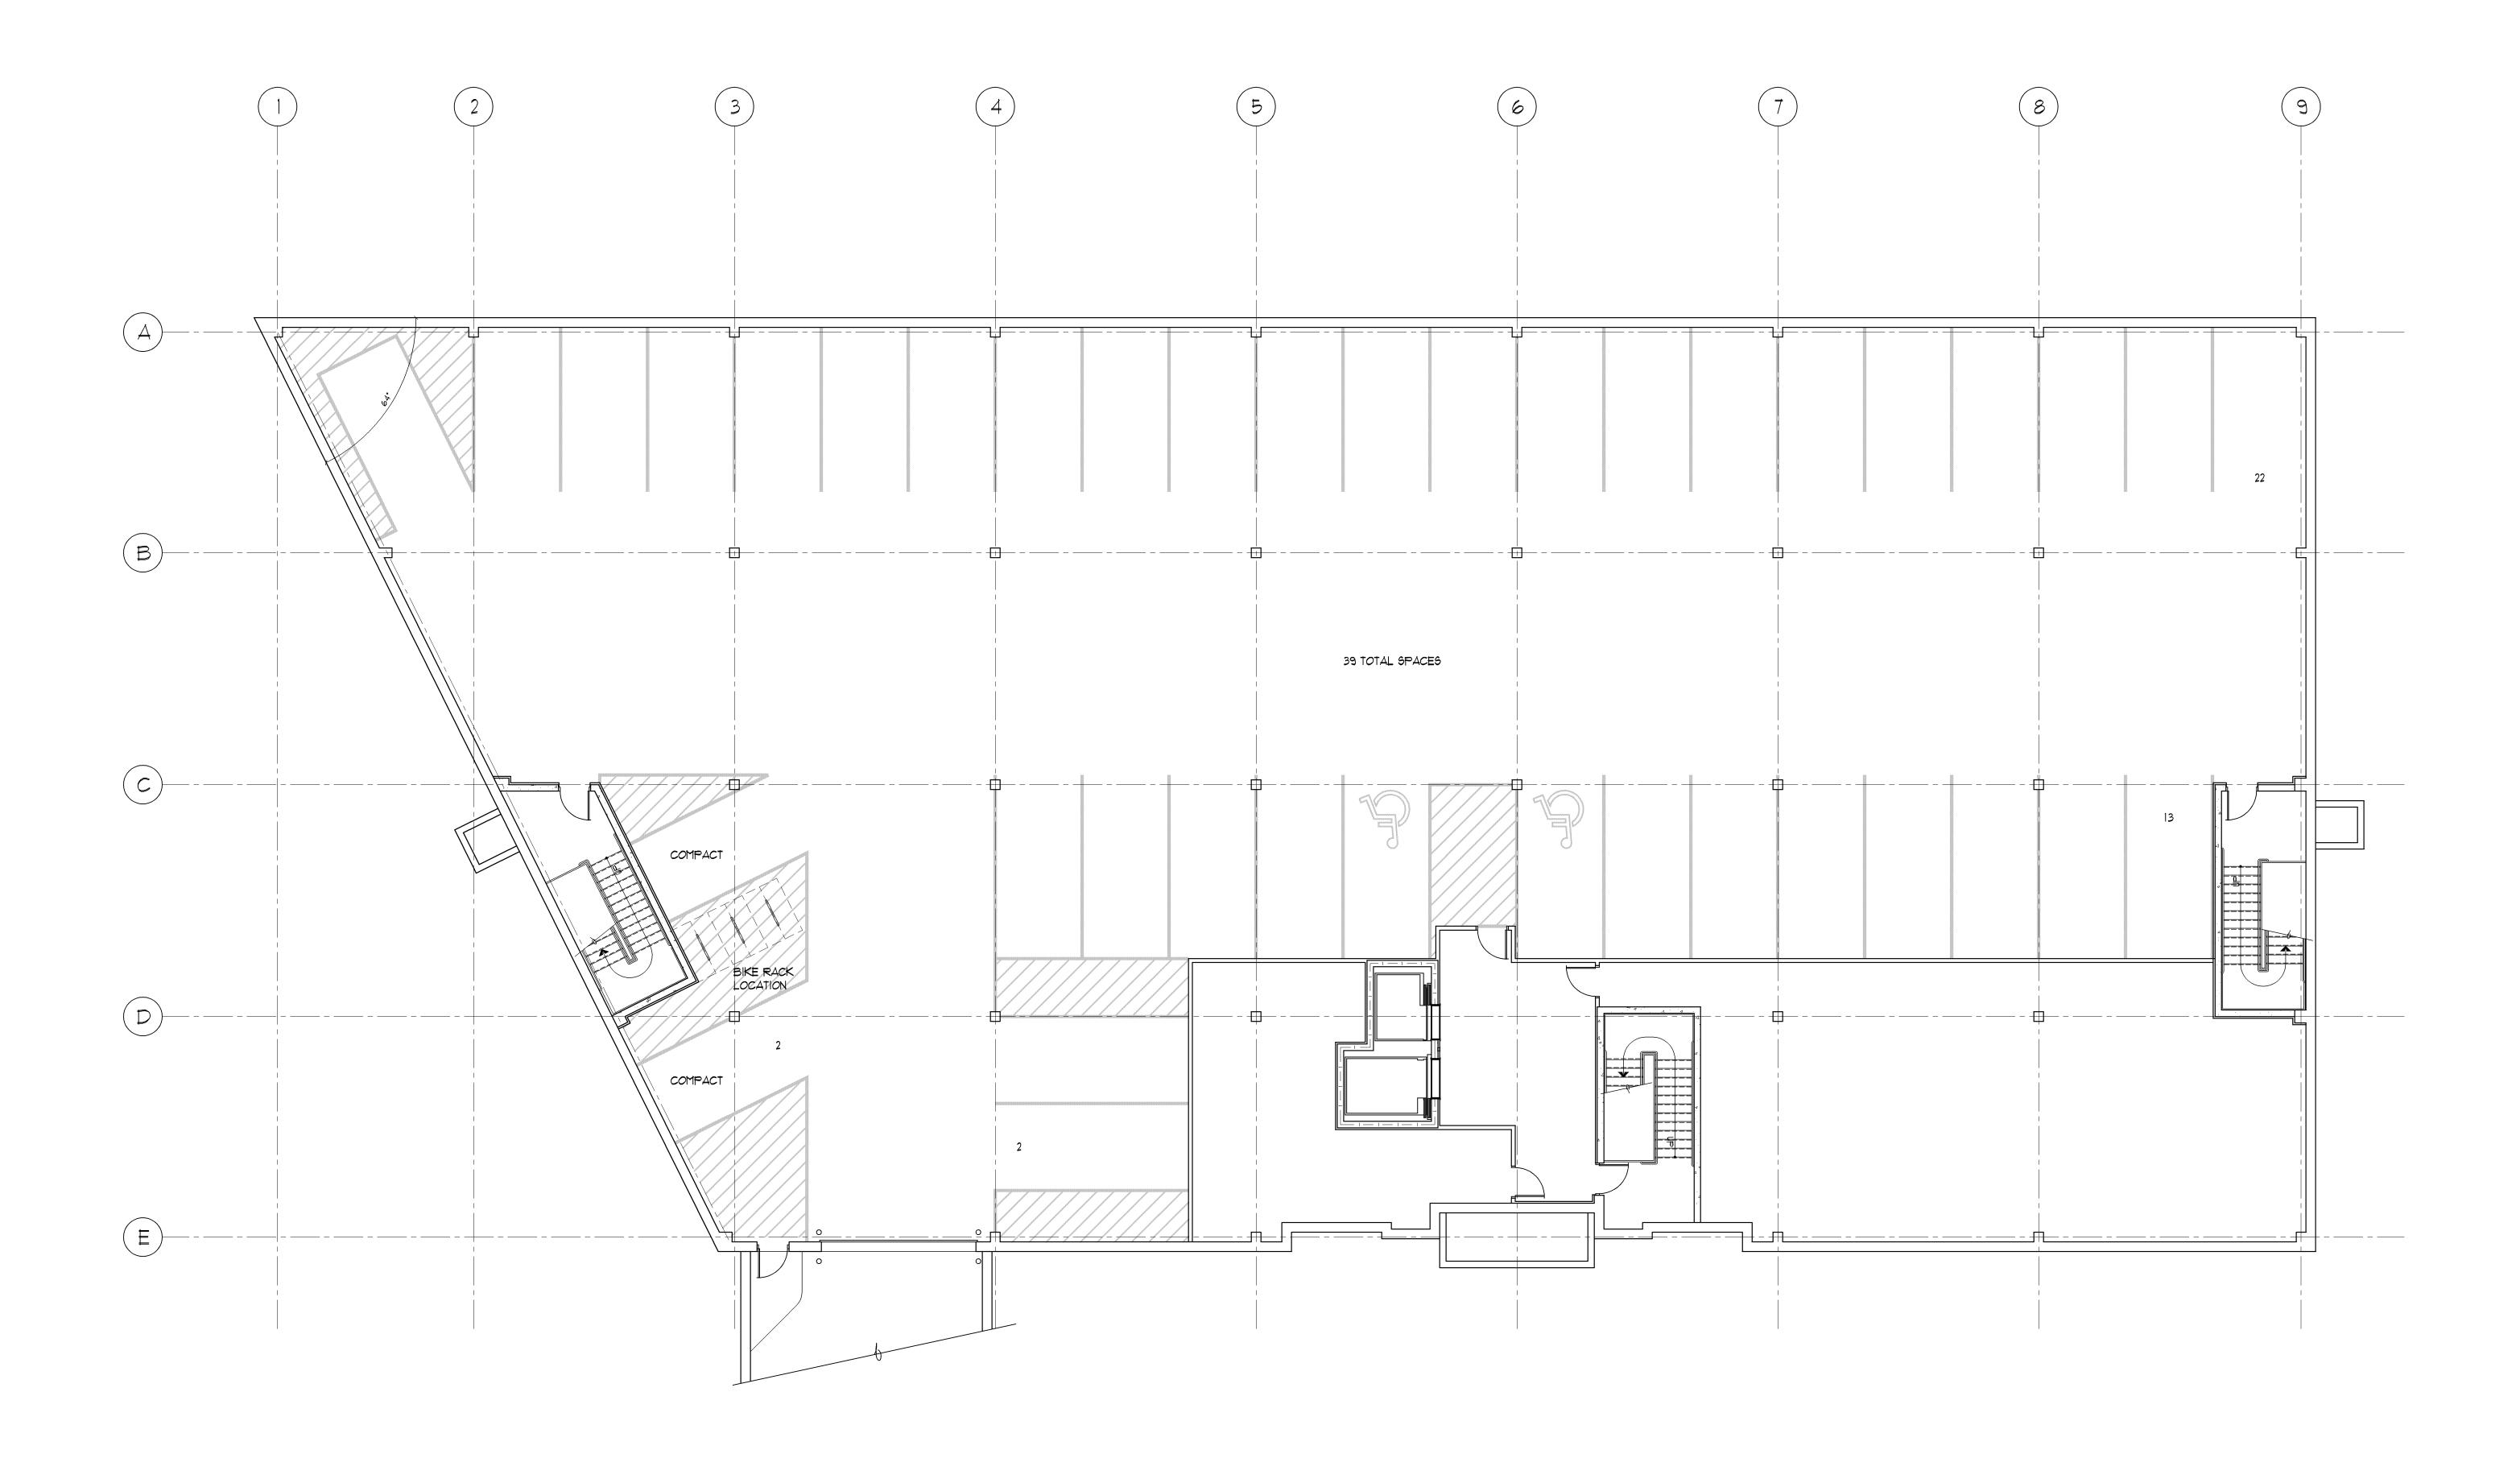

M A D I S O N P A I N M A N A G E M E N T

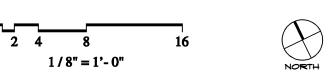