

# The Kronenberg 423-427 W. Mifflin St., Madison, WI 4 STORY, 40 UNIT APARTMENT BUILDING; 1 LEVEL UNDERGROUND PARKING



# SHEET INDEX

PROJECT NUMBER 2253 LUA SUBMITTAL - 2024.09.23

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#### EROSION CONTROL NOTES/SPECIFICATIONS:

- 1. EROSION CONTROL DEVICES AND/OR STRUCTURES SHALL BE INSTALLED PRIOR TO CLEARING AND GRUBBING OPERATIONS. THESE SHALL BE PROPERLY MAINTAINED FOR MAXIMUM EFFECTIVENESS UNTIL VEGETATION IS RE-ESTABLISHED.
- 2. EROSION CONTROL IS THE RESPONSIBILITY OF THE CONTRACTOR UNTIL ACCEPTANCE OF THIS PROJECT. EROSION CONTROL MEASURES AS SHOWN SHALL BE THE MINIMUM PRECAUTIONS THAT WILL BE ALLOWED. THE CONTRACTOR SHALL BE RESPONSIBLE FOR RECOGNIZING AND CORRECTING ALL EROSION CONTROL PROBLEMS THAT ARE THE RESULT OF CONSTRUCTION ACTIVITIES. ADDITIONAL EROSION CONTROL MEASURES, AS REQUESTED IN WRITING BY THE STATE OR LOCAL INSPECTORS, OR THE DEVELOPER'S ENGINEER, SHALL BE INSTALLED WITHIN 24 HOURS.
- 3. ALL EROSION CONTROL MEASURES AND STRUCTURES SERVING THE SITE MUST BE INSPECTED AT LEAST WEEKLY OR WITHIN 24 HOURS OF THE TIME 0.5 INCHES OF RAIN IS PRODUCED. ALL MAINTENANCE WILL FOLLOW AN INSPECTION WITHIN 24 HOURS. INSPECTION SCHEDULE AND RECORD KEEPING SHALL COMPLY WITH NR 216.46(9), WIS. ADM. CODE.
- 4. CONSTRUCTION ENTRANCES PROVIDE A STONE TRACKING PAD AT EACH POINT OF ACCESS. INSTALL ACCORDING TO WDNR STANDARD 1057. REFER TO WDNR'S STORMWATER WEB PAGE OF TECHNICAL STANDARDS AT: HTTP://DNR.WI.GOV/TOPIC/STORMWATER/STANDARDS/CONST\_STANDARDS.HTML. THE TRACKING PAD MUST BE MAINTAINED IN A CONDITION THAT PREVENTS THE TRACKING OF MATERIAL ONTO THE PUBLIC STREET.
- 5. SOIL STOCKPILES A ROW OF SILT FENCE PLACED DOWNSLOPE AND AT LEAST 10 FEET AWAY FROM THE STOCKPILE SHALL PROTECT ALL STOCKPILES. SOIL STOCKPILES THAT ARE INACTIVE FOR MORE THAN 14 CONSECUTIVE DAYS SHALL BE STABILIZED WITH SEED & MULCH, EROSION MAT, POLYMER, OR COVERED WITH TARPS OR SIMILAR MATERIAL. NO STOCKPILE SHALL BE PLACED WITHIN 20 FEET OF A DRAINAGE WAY.
- 6. DEWATERING WATER PUMPED FROM THE SITE SHALL BE TREATED BY USING A TEMPORARY SEDIMENTATION BASIN, PORTABLE DEWATERING BASIN, GEOTEXTILE BAG, OR AN EQUIVALENT DEVICE. SHOW ON THE PLAN THE ANTICIPATED LOCATIONS OF DEWATERING ACTIVITY, AND PROVIDE AN ENGINEERING DETAIL OF THE DEWATERING SYSTEM. DEVISES SHALL COMPLY WITH WDNR TECHNICAL STANDARD 1061 FOUND AT: HTTP://DNR.WI.GOV/TOPIC/STORMWATER/STANDARDS/CONST\_STANDARDS.HTML THIS WATER SHALL BE DISCHARGED IN A MANNER THAT DOES NOT INDUCE EROSION OF THE SITE OR ADJACENT PROPERTY.

TYPE I BAG SIZE (SQ-FT) PUMP SIZE (MAX GPM)

- 7. STORM SEWER INLETS PROVIDE WOOT TYPE D "CATCHALL" INLET PROTECTION OR EQUIVALENT. REFER TO WOOT PRODUCT ACCEPTABILITY LIST AT: HTTP://WWW.DOT.WISCONSIN.GOV/BUSINESS/ENGRSERV/PAL.HTM. INLET PROTECTION SHALL BE INSTALLED PRIOR TO THE STORM SEWER SYSTEM RECEIVING SITE RUNOFF. OTHER THAN FOR PERFORMING MAINTENANCE, THESE DEVICES SHALL NOT BE REMOVED UNTIL PLAT-LEVEL STABILIZATION IS COMPLETE.
- 8. BUILDING AND WASTE MATERIALS SHALL BE PREVENTED FROM RUNNING-OFF THE SITE AND ENTERING WATERS OF THE STATE IN CONFORMANCE WITH NR151.12(6M).
- 9. NO SOLID MATERIAL SHALL BE DISCHARGED OR DEPOSITED INTO WATERS OF THE STATE IN VIOLATION OF CH. 30 OR 31 OF THE WISCONSIN STATE STATUTES OR 33 USC 1344 PERMITS.
- 10. EROSION CONTROL DEVICES SHALL ADHERE TO THE TECHNICAL STANDARDS FOUND AT: HTTP://DNR.WI.GOV/RUNOFF/STORMWATER/TECHSTDS.HTM AND COMPLY WITH ALL CITY OF MADISON ORDINANCES.
- 11. ALL DEBRIS TRACKED ONTO PUBLIC STREETS SHALL BE BE SWEPT OR SCRAPED CLEAN BY THE END OF EACH WORKDAY.
- 12. ALL BUILDING AND WASTE MATERIAL SHALL BE HANDLED PROPERLY TO PREVENT RUNOFF OF THESE MATERIALS OFF OF THE
- 13. ALL DISTURBED AREAS SHALL BE SEEDED IMMEDIATELY AFTER GRADING ACTIVITIES HAVE BEEN COMPLETED.
- 14. ALL DISTURBED AREAS, EXCEPT PAVED AREAS, SHALL RECEIVE A MINIMUM OF FOUR (4) INCHES OF TOPSOIL, FERTILIZER, SEED, AND MULCH. SEED MIXTURES SHALL BE SELECTED APPROPRIATE TO THE INTENDED FUNCTION. A QUALIFIED LANDSCAPING CONTRACTOR, LANDSCAPE ARCHITECT OR NURSERY CAN BE CONSULTED FOR RECOMMENDATIONS. SEEDING RATES SHALL BE BASED ON POUNDS OR OUNCES OF PURE LIVE SEED PER ACRE AND SHALL BE PROVIDED BY THE SEED SUPPLIER. FERTILIZER CAN BE APPLIED TO HELP PROMOTE GROWTH, BUT A SOIL TEST IS RECOMMENDED TO DETERMINE THE TYPE AND AMOUNT OF FERTILIZER TO BE APPLIED. ALL SEEDING AND RESTORATION SHALL BE IN CONFORMANCE TO WDNR TECHNICAL STANDARD 1059 FOUND AT HTTP://DNR.WI.GOV/TOPIC/STORMWATER/STANDARDS/CONST\_STANDARDS.HTML. SEEDING AND SODDING MAY ONLY BE USED FROM MAY 1ST TO SEPTEMBER 15TH OF ANY YEAR. TEMPORARY SEED SHALL BE USED AFTER SEPTEMBER 15. IF TEMPORARY SEEDING IS USED, A PERMANENT COVER SHALL ALSO BE REQUIRED AS PART OF THE FINAL SITE STABILIZATION.
- 15. FOR THE FIRST SIX (6) WEEKS AFTER THE INITIAL STABILIZATION OF A DISTURBED AREA, WATERING SHALL BE PERFORMED WHENEVER MORE THAN SEVEN (7) DAYS OF DRY WEATHER ELAPSE.

### EMERGENCY CONTACT

MADISON DEVELOPMENT CORPORATION HARRY IRWIN 550 WEST WASHINGTON, AVE.

608-571-3375 harry@mdcorp.org

#### SCHEDULE: TBD

SILT FENCE AND CONSTRUCTION ENTRANCE INSTALLED AND BEGIN DISTURBANCE OF SITE.

PLACE PRIVATE DRIVEWAY BASE AND BEGIN BUILDING CONSTRUCTION.

PLACE TEMPORARY SEED AND MULCH ON ALL DISTURBED AREAS

DRIVEWAY PAVEMENT INSTALLED APPLY FINAL SEED AND MULCH

SITE STABILIZED. COMPLETE CONSTRUCTION OF BIORETENTION BASIN.

PROJECT COMPLETE

#### GENERAL NOTES:

- 1. IT IS THE CONTRACTOR'S RESPONSIBILITY TO VERIFY THE LOCATION OF UNDERGROUND UTILITIES. UTILITIES WERE LOCATED BY OBSERVED EVIDENCE, MARKINGS PROVIDED BY DIGGER'S HOTLINE, AND RECORD DRAWINGS FROM THE CITY OF MADISON.
- 2. CONTRACTOR SHALL VERIFY THE SIZE, TYPE, SLOPE, AND INVERTS OF ALL EXISTING STORM AND SANITARY LATERALS CALLED OUT TO BE CONNECTED TO. CONTRACTOR SHALL SUBMIT THE INFORMATION ON THE PIPES TO THE CITY INSPECTOR AND PROJECT CIVIL ENGINEER.
- 3. ANY SIDEWALK, CURB, OR OTHER PUBLIC PROPERTY DAMAGED AS PART OF THE CONSTRUCTION OF THE UTILITIES AND BUILDING SHALL BE REPLACED IN-KIND PER THE CITY OF MADISON STANDARD SPECIFICATIONS.
- 4. THE RIGHT-OF-WAY IS THE SOLE JURISDICTION OF THE CITY OF MADISON AND IS SUBJECT TO CHANGE AT ANY TIME PER THE RECOMMENDATION/PLAN OF THE CITY.
- 5. CONTRACTOR SHALL INSTALL TREE PROTECTION FENCING IN THE AREA BETWEEN THE CURB AND SIDEWALK AND EXTEND IT AT LEAST 5 FEET FROM BOTH SIDES OF THE TREE ALONG THE LENGTH OF THE TERRACE. NO EXCAVATION IS PERMITTED WITHIN 5 FEET OF THE OUTSIDE EDGE OF A TREE TRUNK. IF EXCAVATION WITHIN 5 FEET OF ANY TREE IS NECESSARY, CONTRACTOR SHALL CONTACT CITY FORESTRY (266-4816) PRIOR TO EXCAVATION TO ASSESS THE IMPACT TO THE TREE AND ROOT SYSTEM. TREE PRUNING SHALL BE COORDINATED WITH CITY FORESTRY PRIOR TO THE START OF CONSTRUCTION. TREE PROTECTION SPECIFICATIONS CAN BE FOUND IN SECTION 107.13 OF CITY OF MADISON STANDARD SPECIFICATIONS FOR PUBLIC WORKS CONSTRUCTION http://www.cityofmadison.com/business/pw/documents/stdspecs/2018/part1.pdf. ANY TREE REMOVALS THAT ARE REQUIRED FOR CONSTRUCTION AFTER THE DEVELOPMENT PLAN IS APPROVED WILL REQUIRE AT LEAST A 72 HOUR WAIT PERIOD BEFORE A TREE REMOVAL PERMIT CAN BE ISSUED BY FORESTRY, TO NOTIFY THE ALDER OF THE CHANGE IN THE TREE PLAN.

- 1. PAVEMENT DESIGN SHALL BE PER THE RECOMMENDATION OF THE SOILS CONSULTANT.
- 2. TRAFFIC CONTROL SIGNAGE SHALL BE IN ACCORDANCE WITH FEDERAL, STATE, COUNTY, CITY, AND LOCAL CODE, WHICHEVER HAS JURISDICTION.
- 3. NEW APRONS SHALL BE CONSTRUCTED AND PLACED IN CONFORMANCE WITH THE CITY OF MADISON STANDARD DETAIL 3.02 FOR COMMERCIAL OPENINGS.


#### <u>GRADING PLAN NOTES:</u>

1. ALL GRADES ARE FINISH ELEVATION UNLESS NOTED OTHERWISE.

- 1. ALL WORK WITHIN THE CITY RIGHT OF WAY AND EASEMENTS SHALL BE COMPLIANT WITH THE CITY OF MADISON STANDARD SPECIFICATIONS CURRENT AT THE TIME OF CONSTRUCTION.
- 2. UTILITY INSTALLATION SHALL BE COORDINATED WITH ENGINEER AT LEAST 4 WEEKS PRIOR TO INSTALLATION TO ENSURE BUILDING INSPECTION APPROVAL IS OBTAINED.


#### <u>DEMOLITION NOTES:</u>

- 1. THE CONTRACTOR IS RESPONSIBLE FOR THE DEMOLITION, REMOVAL, AND DISPOSING IN A LOCATION APPROVED BY ALL GOVERNING AUTHORITIES, OF ALL STRUCTURES, PADS, WALLS, FLUMES, FOUNDATIONS, PARKING DRIVES, DRAINAGE, STRUCTURES, UTILITIES, ETC., SUCH THAT THE IMPROVEMENTS SHOWN ON THE REMAINING PLANS CAN BE CONSTRUCTED. ALL FACILITIES TO BE REMOVED SHALL BE UNDERCUT TO SUITABLE MATERIAL AND BROUGHT TO GRADE WITH SUITABLE COMPACTED FILL MATERIAL PER THE SPECIFICATIONS.
- 2. THE CONTRACTOR IS RESPONSIBLE FOR OBTAINING ALL PERMITS REQUIRED FOR DEMOLITION AND DISPOSAL.
- 3. THE CONTRACTOR SHALL COORDINATE WITH THE RESPECTIVE UTILITY COMPANIES PRIOR TO THE REMOVAL AND/OR RELOCATION OF UTILITIES. THE CONTRACTOR SHALL COORDINATE WITH THE UTILITY COMPANY CONCERNING PORTIONS OF WORK WHICH MAY BE PERFORMED BY THE UTILITY COMPANY FORCING ANY FEES WHICH ARE TO BE PAID TO THE UTILITY COMPANY FOR THEIR SERVICES. THE DEVELOPER IS RESPONSIBLE FOR PAYING ALL FEES AND CHARGES.
- 4. THE LOCATIONS OF ALL EXISTING UTILITIES SHOWN ON THIS PLAN HAVE BEEN DETERMINED FROM THE BEST INFORMATION AVAILABLE AND ARE GIVEN FOR THE CONVENIENCE OF THE CONTRACTOR. THE ENGINEER ASSUMES NO RESPONSIBILITY FOR THEIR ACCURACY. PRIOR TO THE START OF ANY DEMOLITION ACTIVITY, THE CONTRACTOR SHALL NOTIFY THE UTILITY COMPANIES FOR ONSITE LOCATIONS OF EXISTING UTILITIES. NOTIFY THE ENGINEER OF ANY DISCREPANCIES.
- 5. ALL EXISTING SEWERS, PIPING, AND UTILITIES SHOWN ARE NOT TO BE INTERPRETED AS THE EXACT LOCATION, OR AS THE ONLY OBSTACLES THAT MAY OCCUR ON THE SITE. VERIFY EXISTING CONDITIONS AND PROCEED WITH CAUTION AROUND ANY ANTICIPATED FEATURES. GIVE NOTICE TO ALL UTILITY COMPANIES REGARDING DESTRUCTION AND REMOVAL OF ALL SERVICE LINES BEFORE PROCEEDING WITH THE WORK. UTILITIES DETERMINED TO BE ABANDONED AND LEFT IN PLACE SHALL BE
- 6. ELECTRICAL, TELEPHONE, CABLE, WATER, FIBER OPTIC CABLE, AND/OR GAS LINES NEEDING TO BE REMOVED OR RELOCATED SHALL BE COORDINATED WITH THE AFFECTED UTILITY COMPANY. ADEQUATE TIME SHALL BE PROVIDED FOR RELOCATION AND CLOSE COORDINATION WITH THE UTILITY COMPANY IS NECESSARY TO PROVIDE A SMOOTH TRANSITION IN UTILITY SERVICE.
- 7. CONTRACTOR SHALL PROTECT THE PUBLIC AT ALL TIMES WITH FENCING, BARRICADES, ENCLOSURES, COVERED WALKWAYS, ETC. CONTRACTOR SHALL SUBMIT THEIR STREET OCCUPANCY PLAN TO TRAFFIC ENGINEERING FOR APPROVAL.
- 8. PRIOR TO DEMOLITION OCCURRING, ALL APPLICABLE EROSION CONTROL DEVICES ARE TO BE INSTALLED.
- 9. THE CONTRACTOR MAY LIMIT SAWCUT AND PAVEMENT REMOVAL TO ONLY THOSE AREAS WHERE IT IS REQUIRED AS SHOWN ON THESE CONSTRUCTION PLANS, BUT IF ANY DAMAGE IS INCURRED ON ANY OF THE SURROUNDING PAVEMENT, ETC. THE CONTRACTOR SHALL BE RESPONSIBLE FOR ITS REMOVAL AND REPAIR IN KIND.
- 10. DAMAGE TO ALL EXISTING CONDITIONS TO REMAIN WILL BE REPLACED AT THE CONTRACTOR'S EXPENSE.
- 11. CONTINUOUS ACCESS SHALL BE MAINTAINED FOR THE SURROUNDING PROPERTIES AT ALL TIMES DURING DEMOLITION OF THE EXISTING FACILITIES.

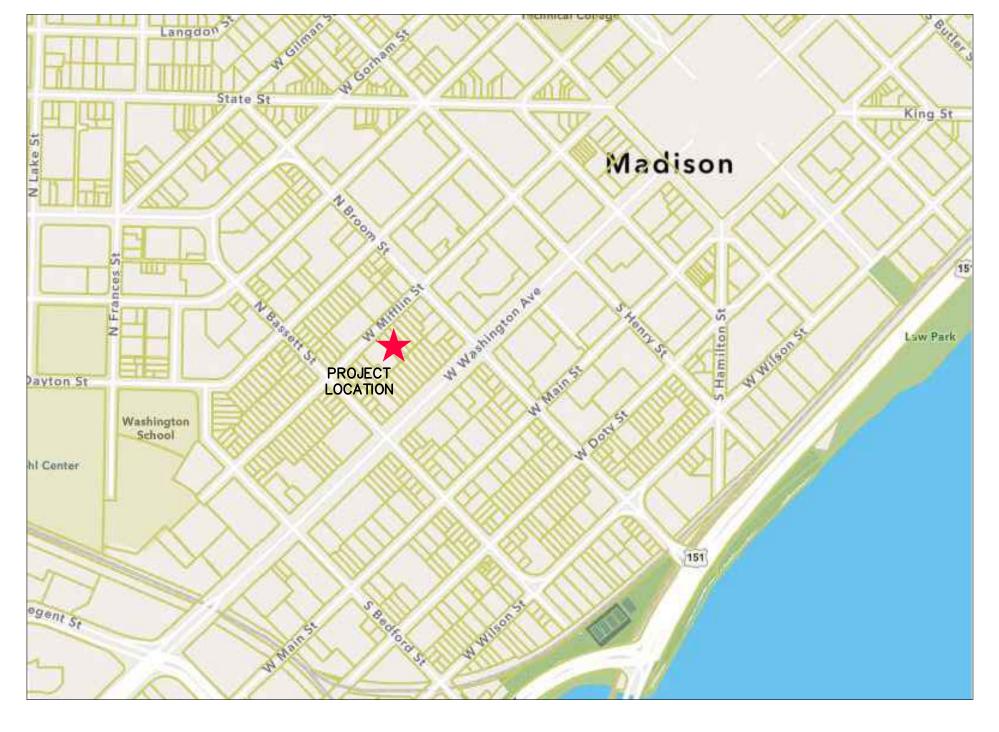




LOCATION MAP

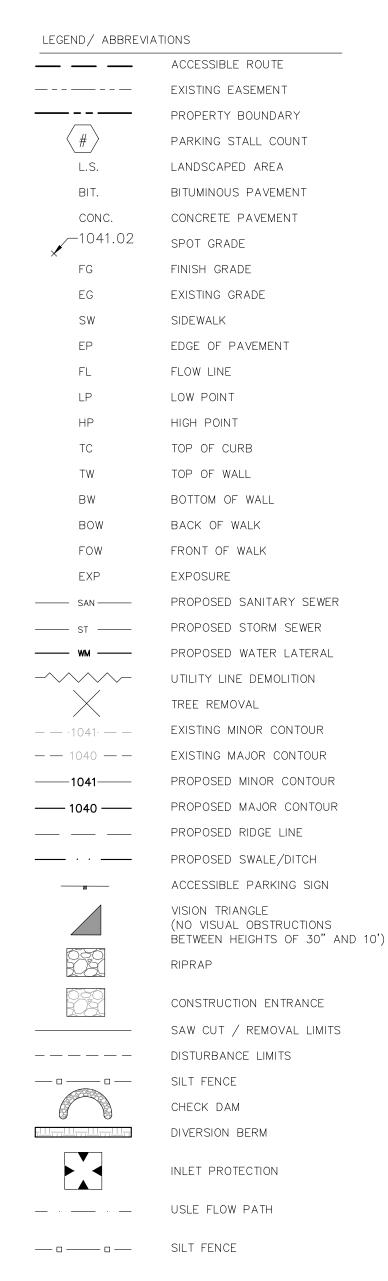

SHEET

NUMBER

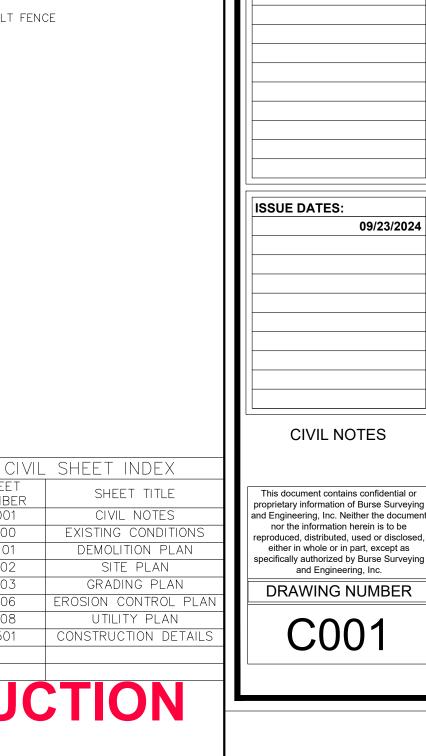

Bur<u>se</u>

Surveying and Engineering, In

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Phone: 608-250-9263

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PROJECT #: BSE1842

**REVISION DATES:** 


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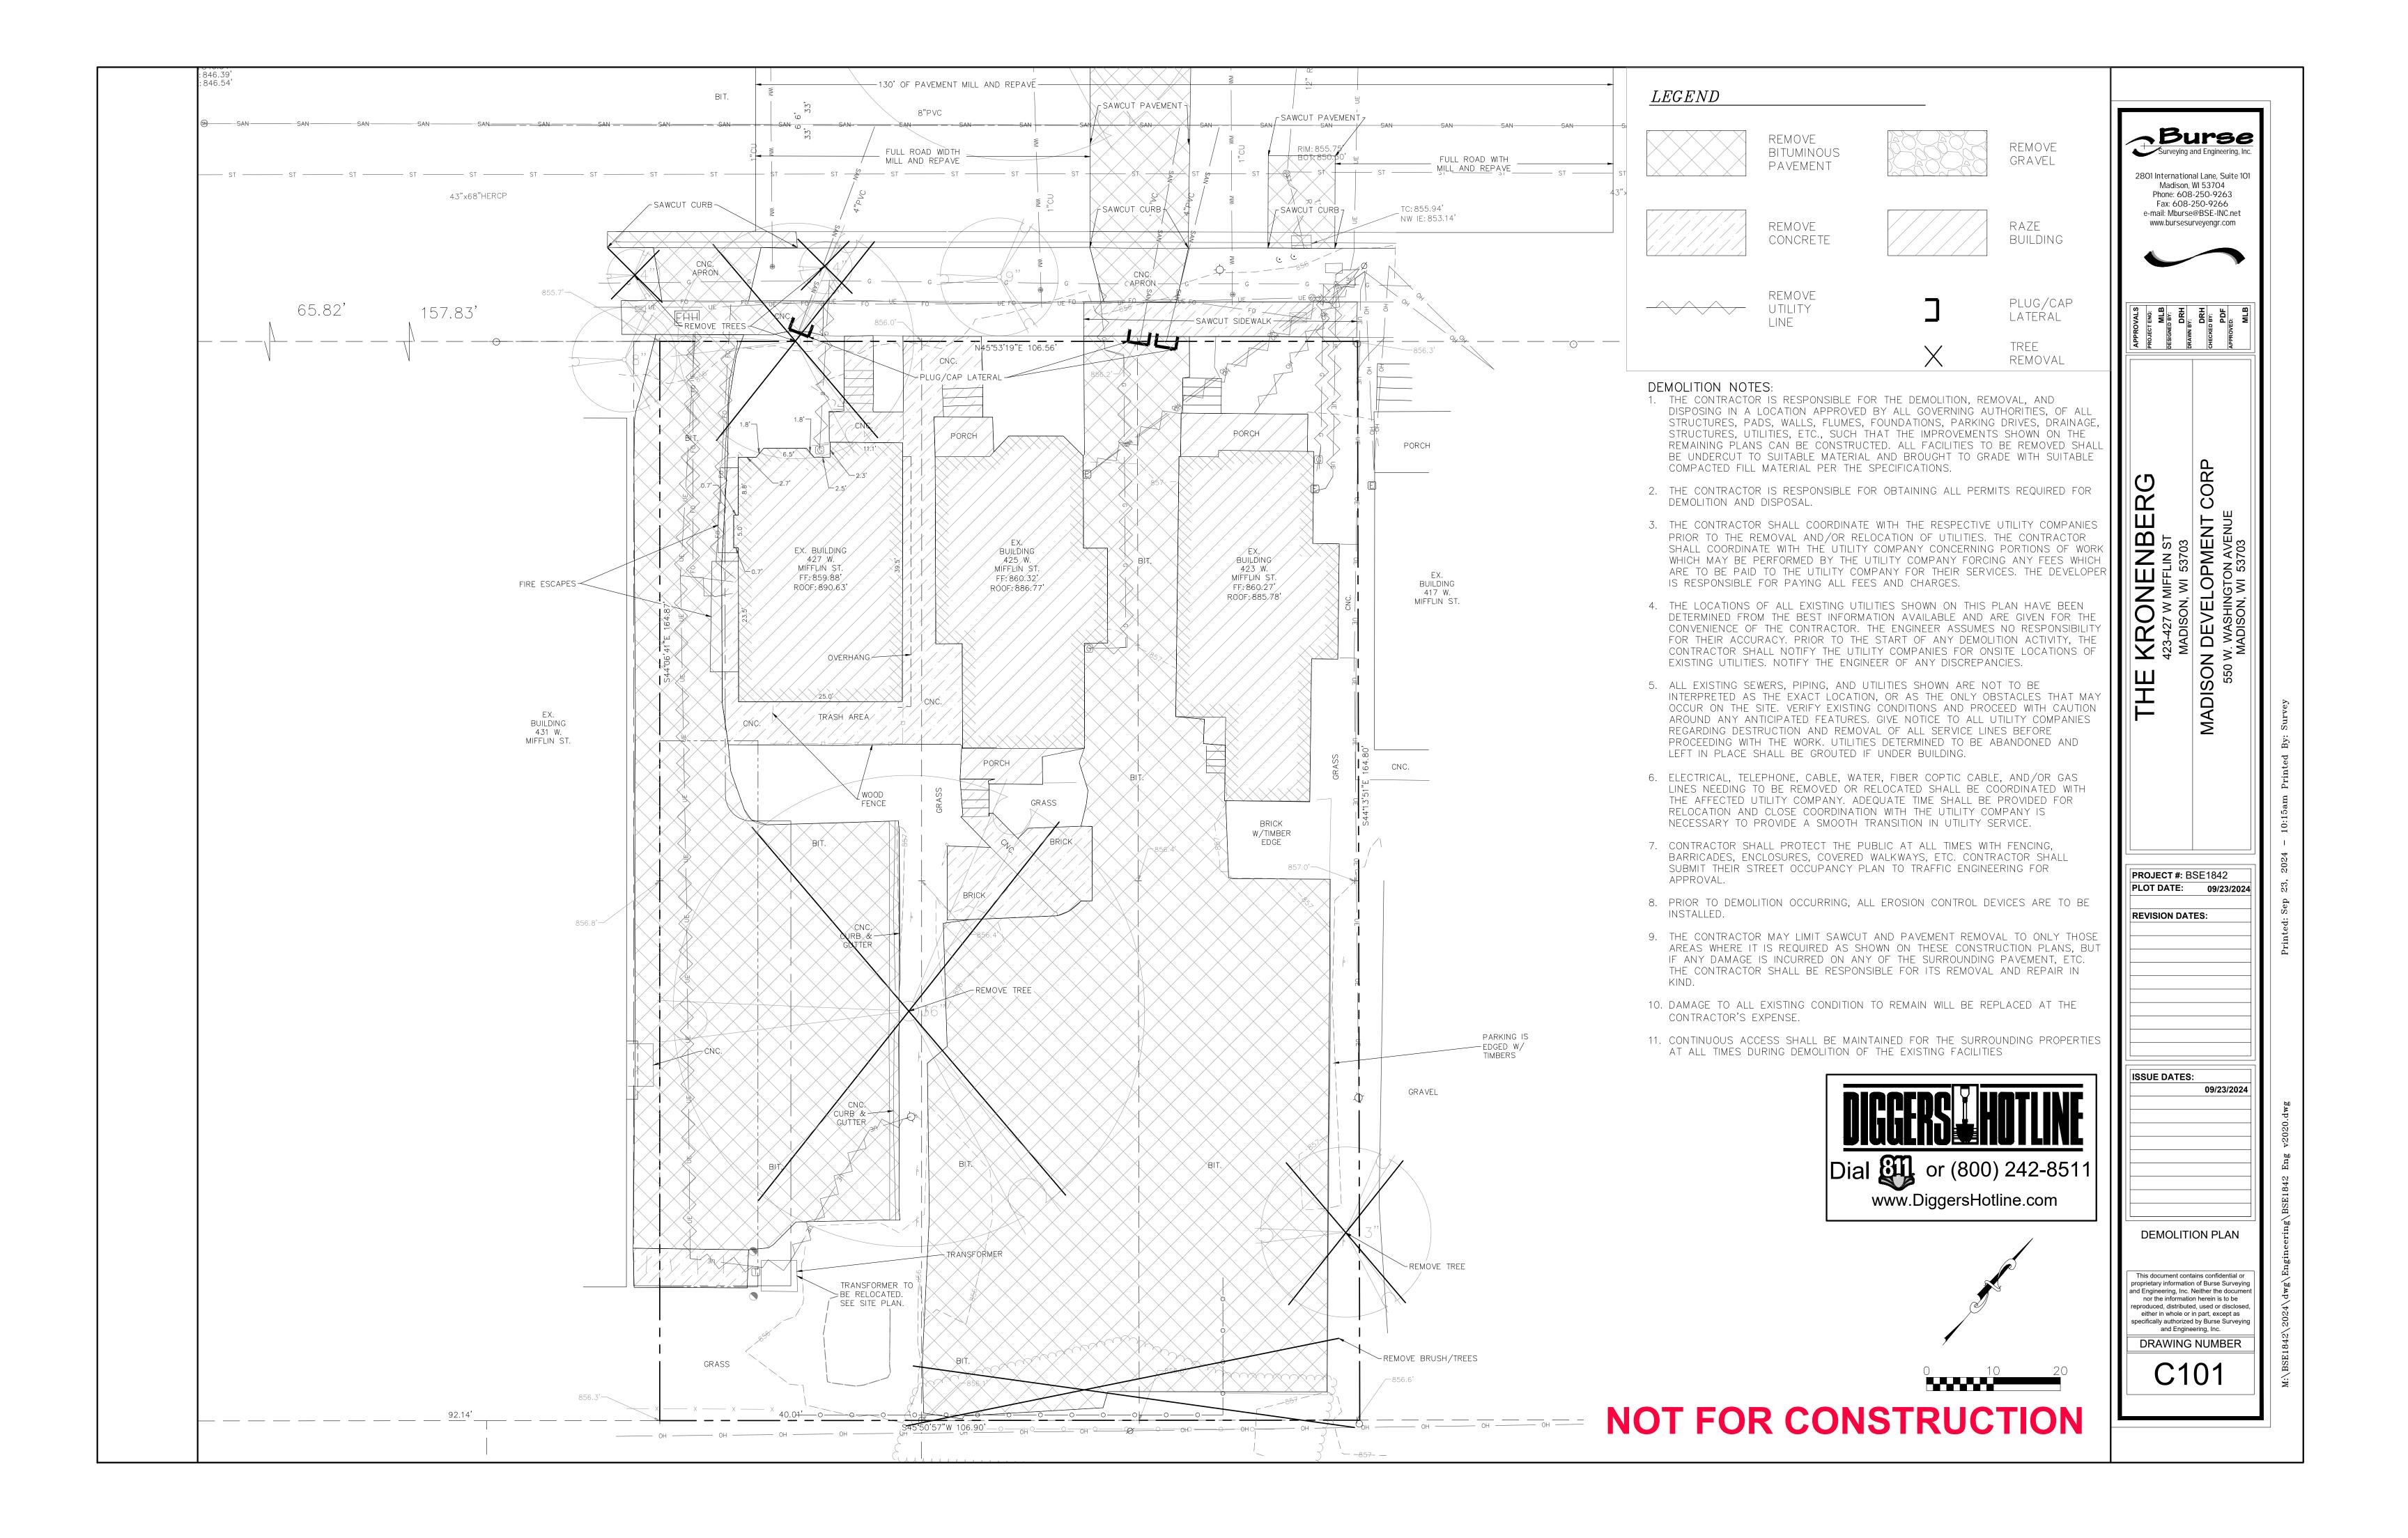
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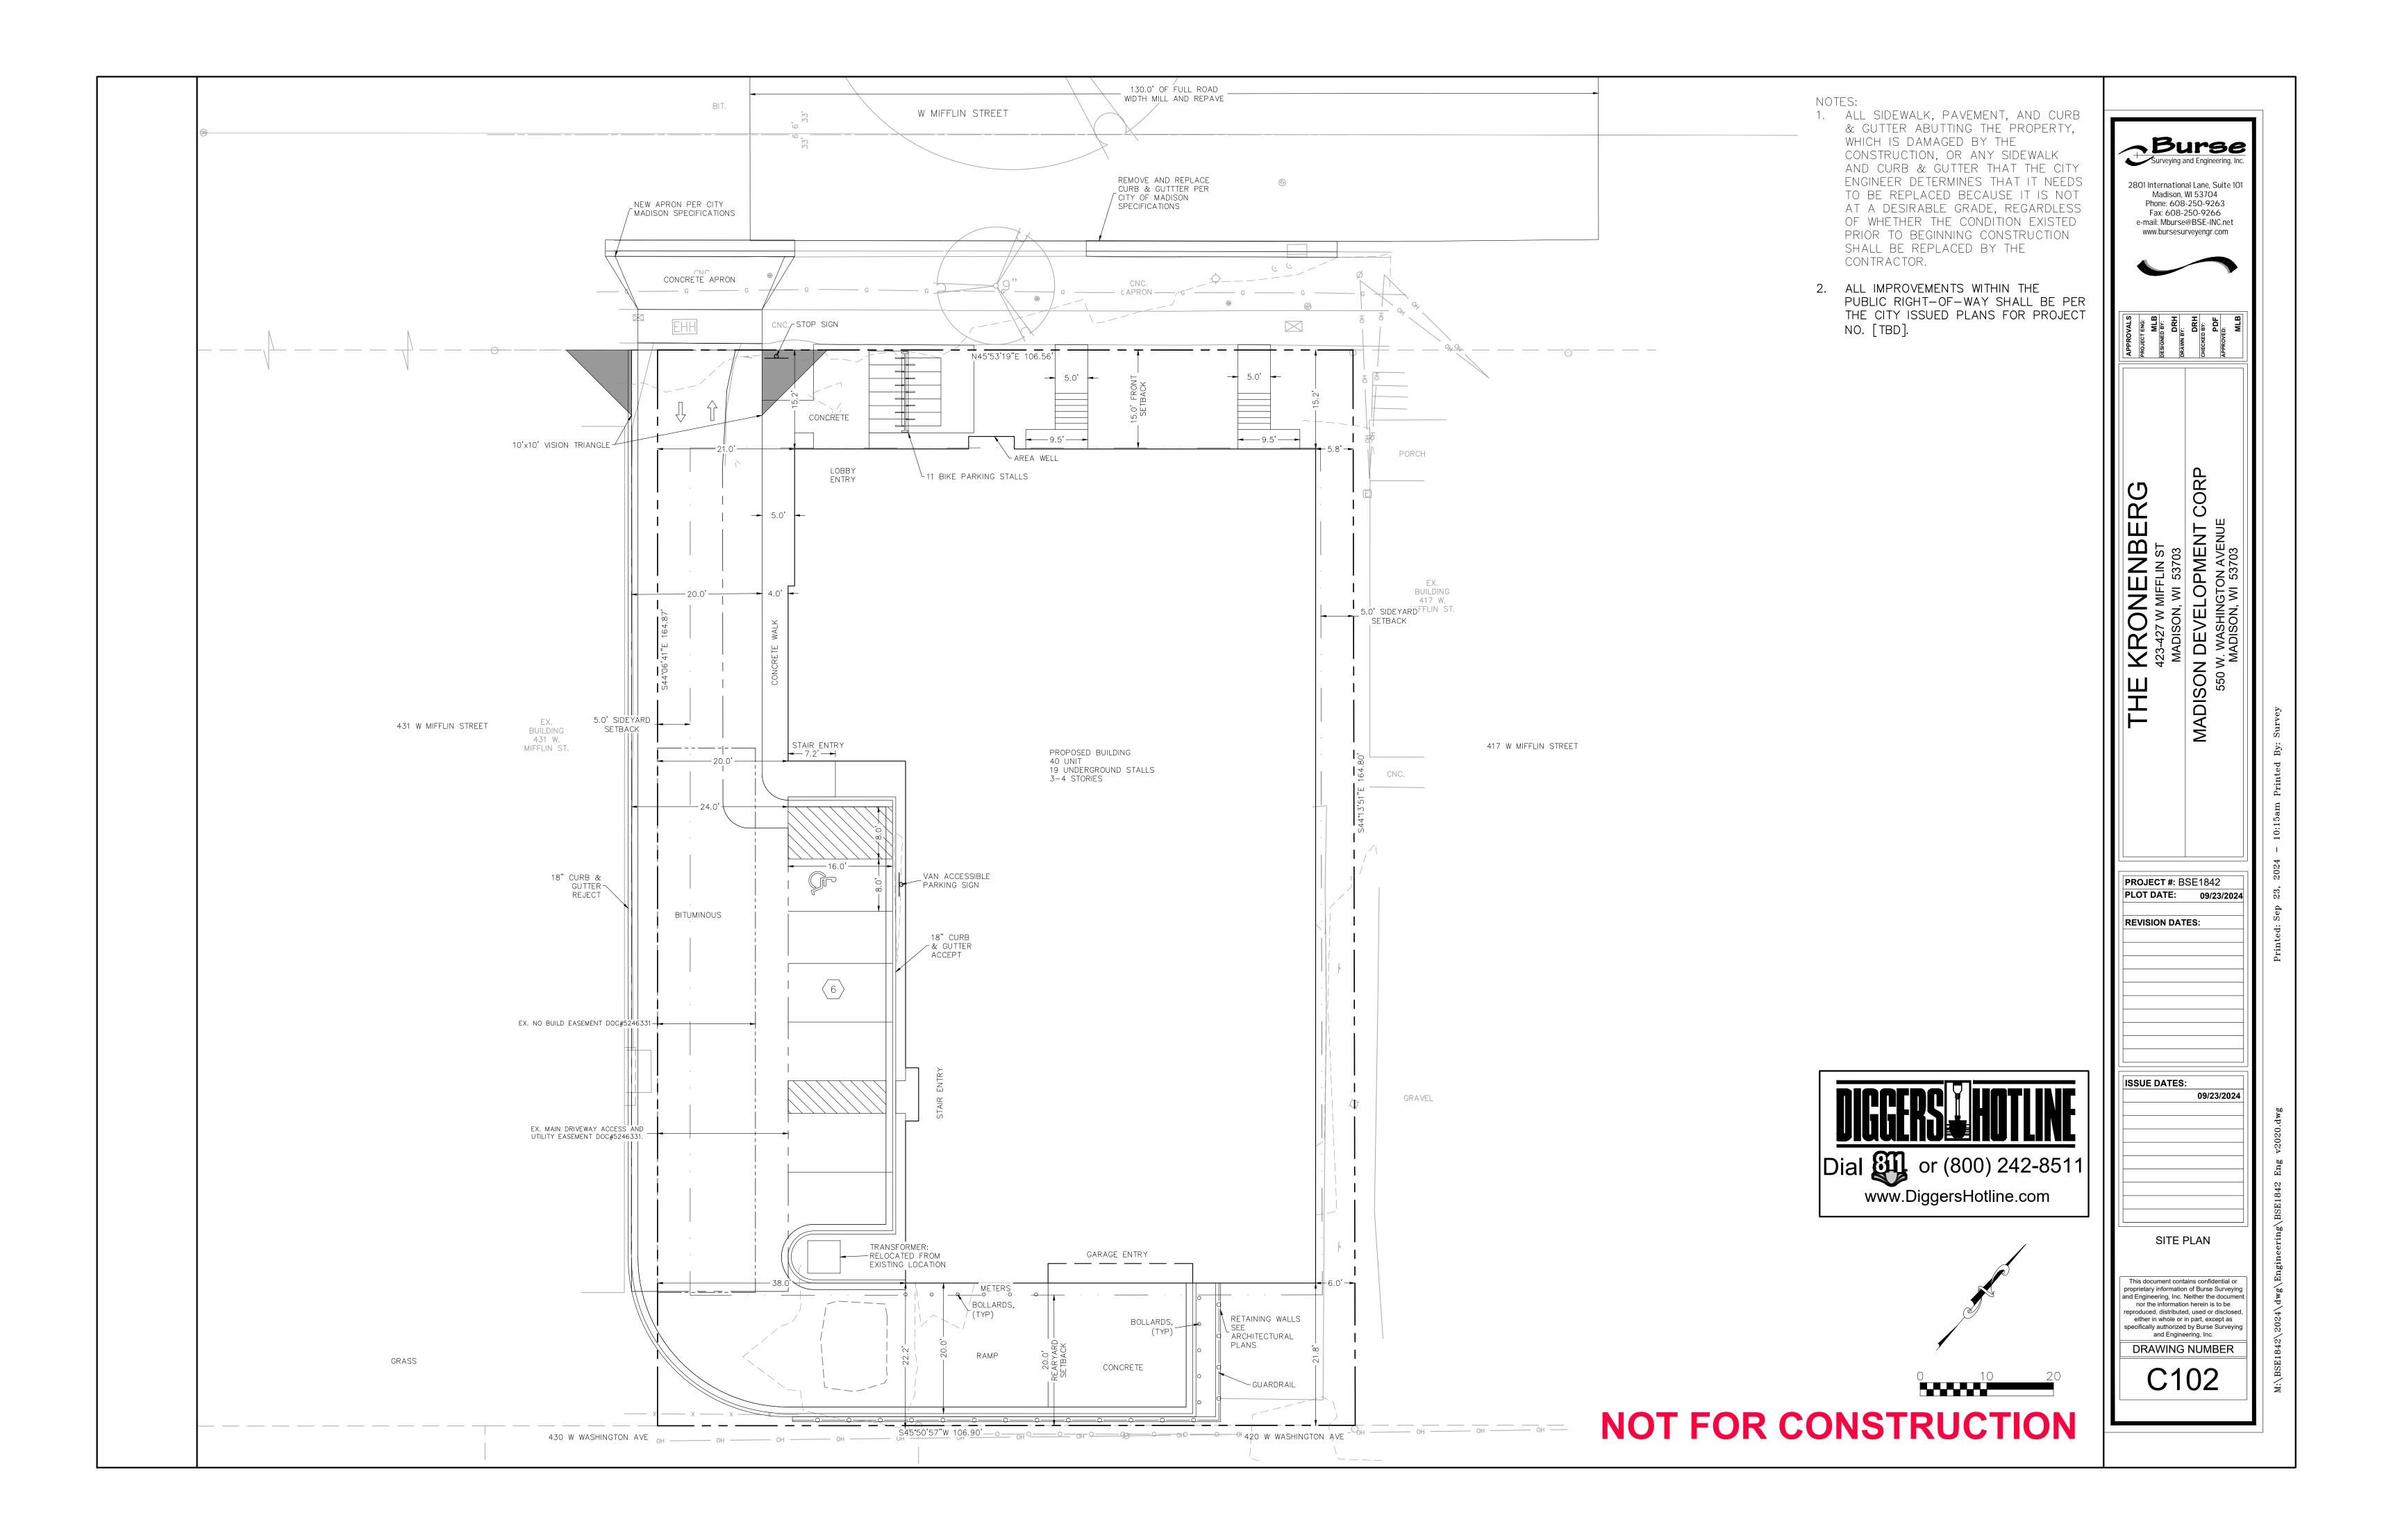
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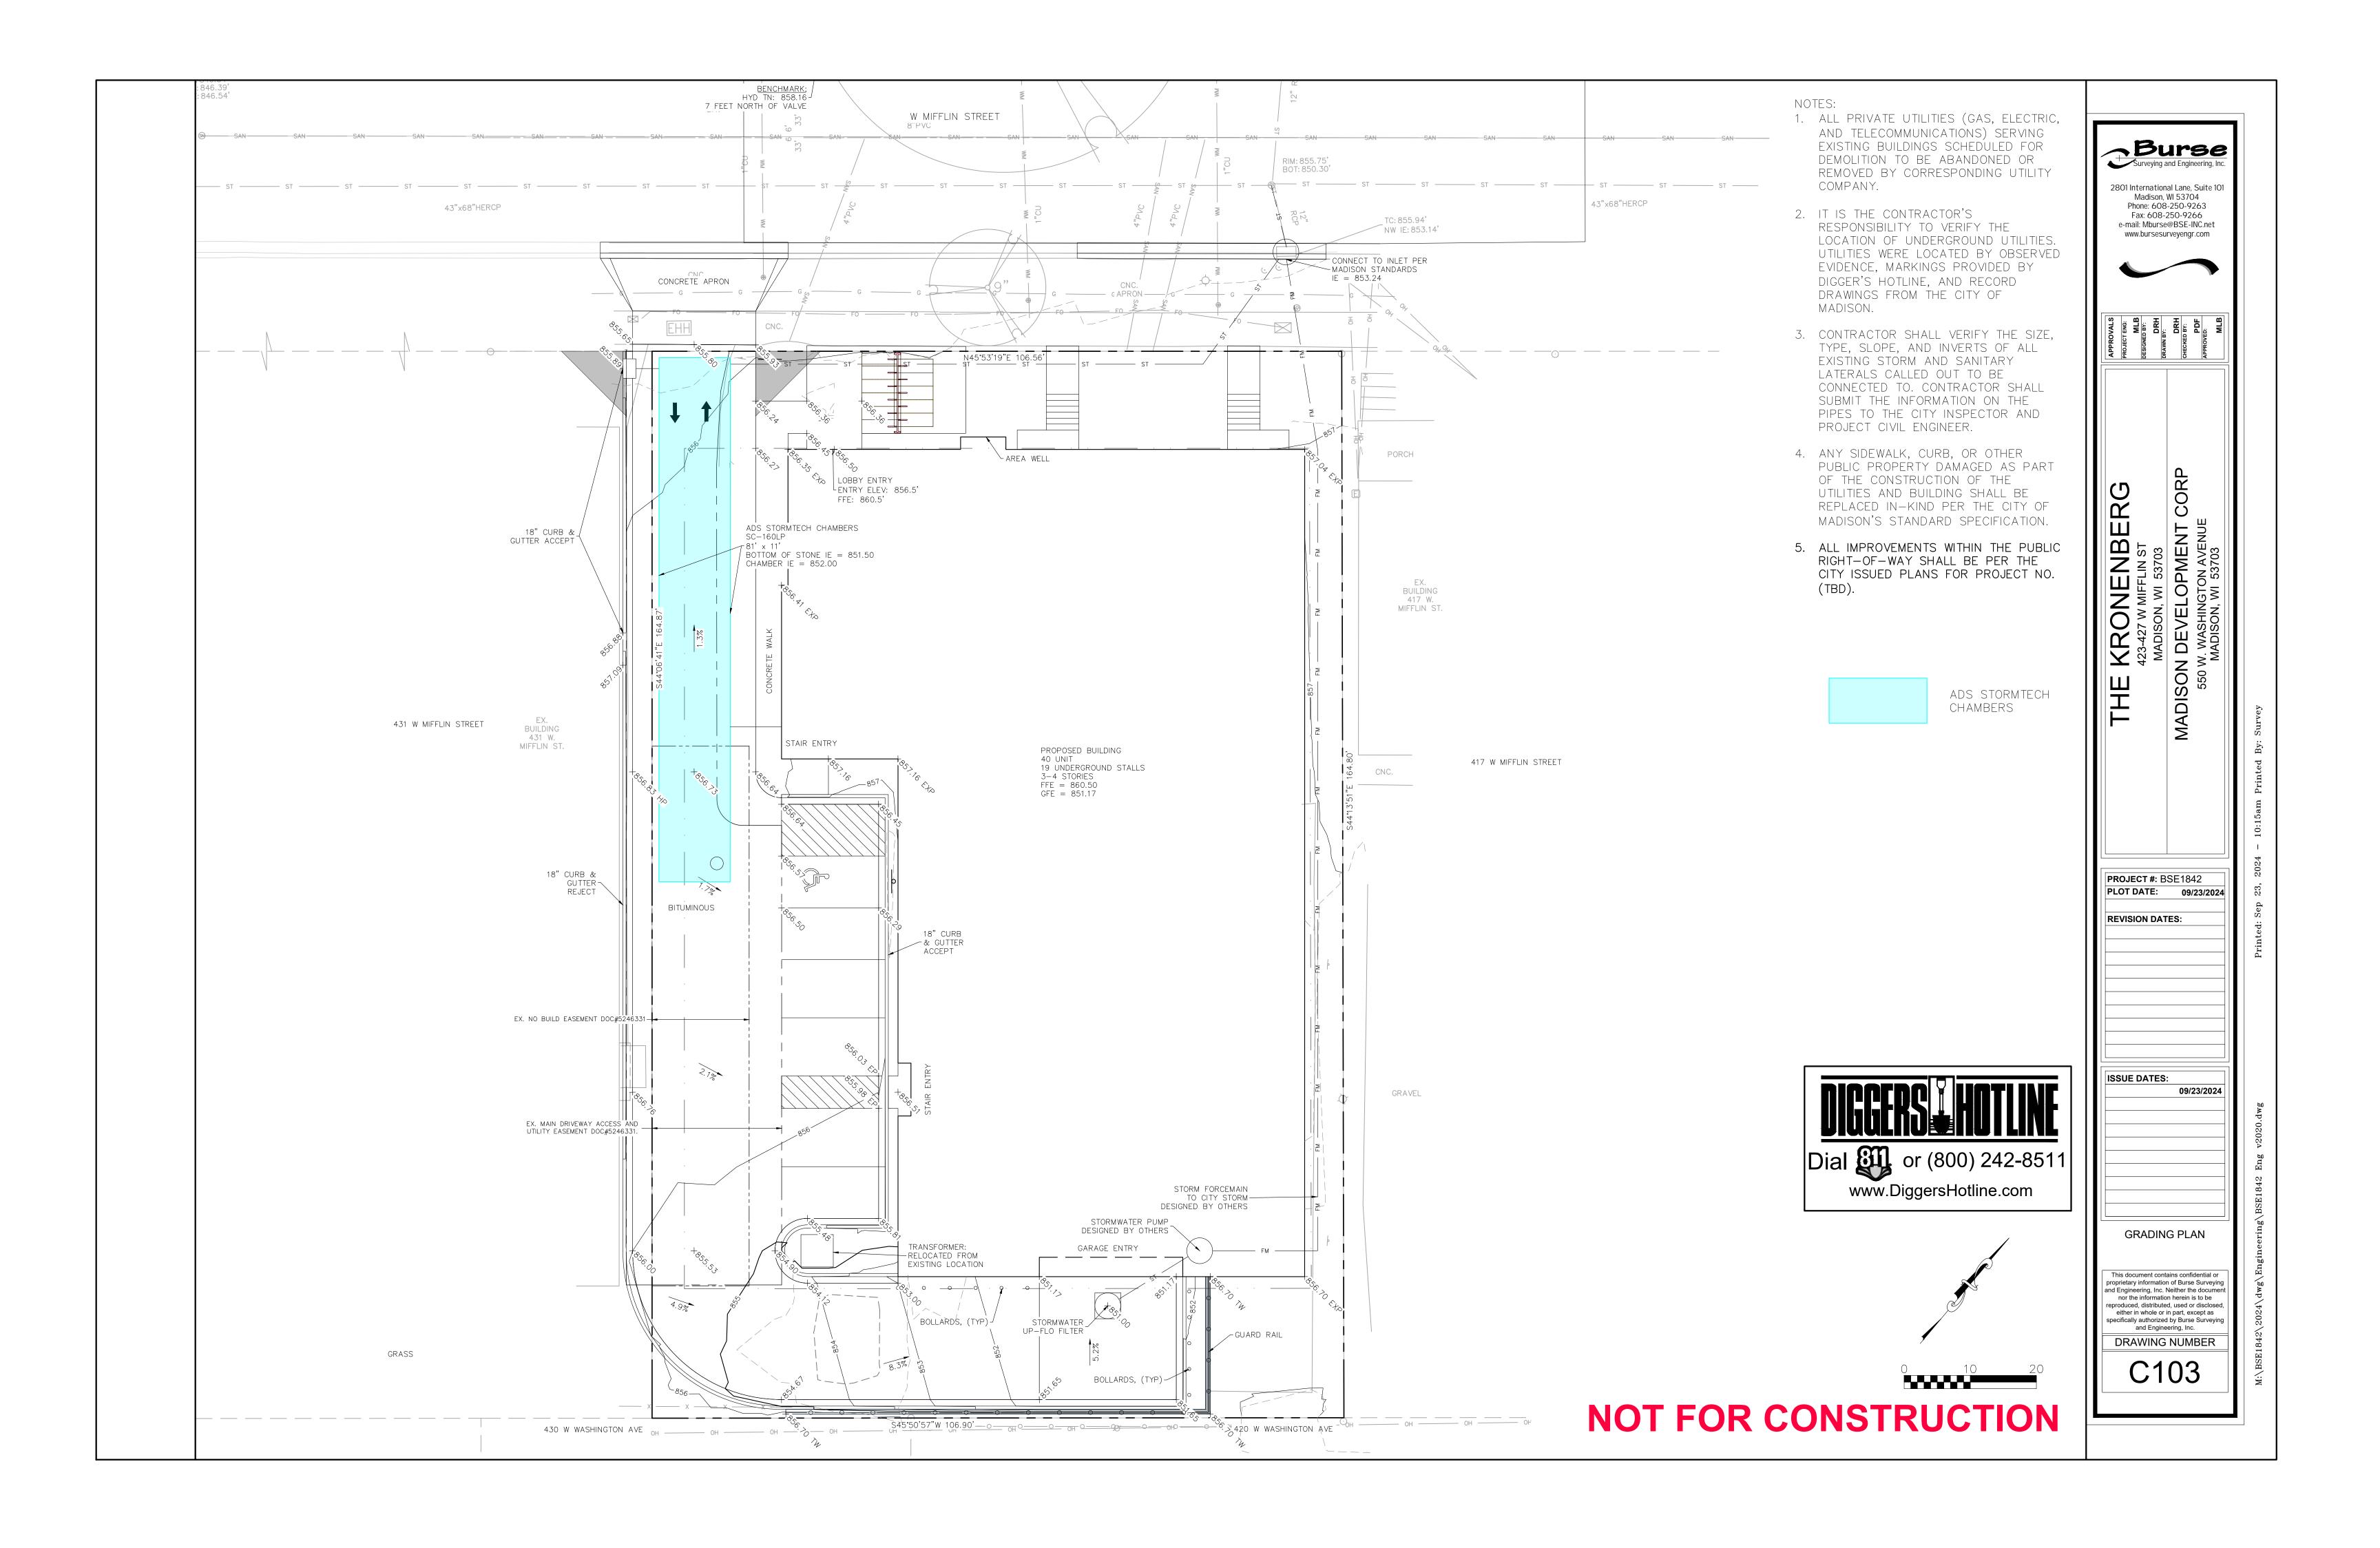
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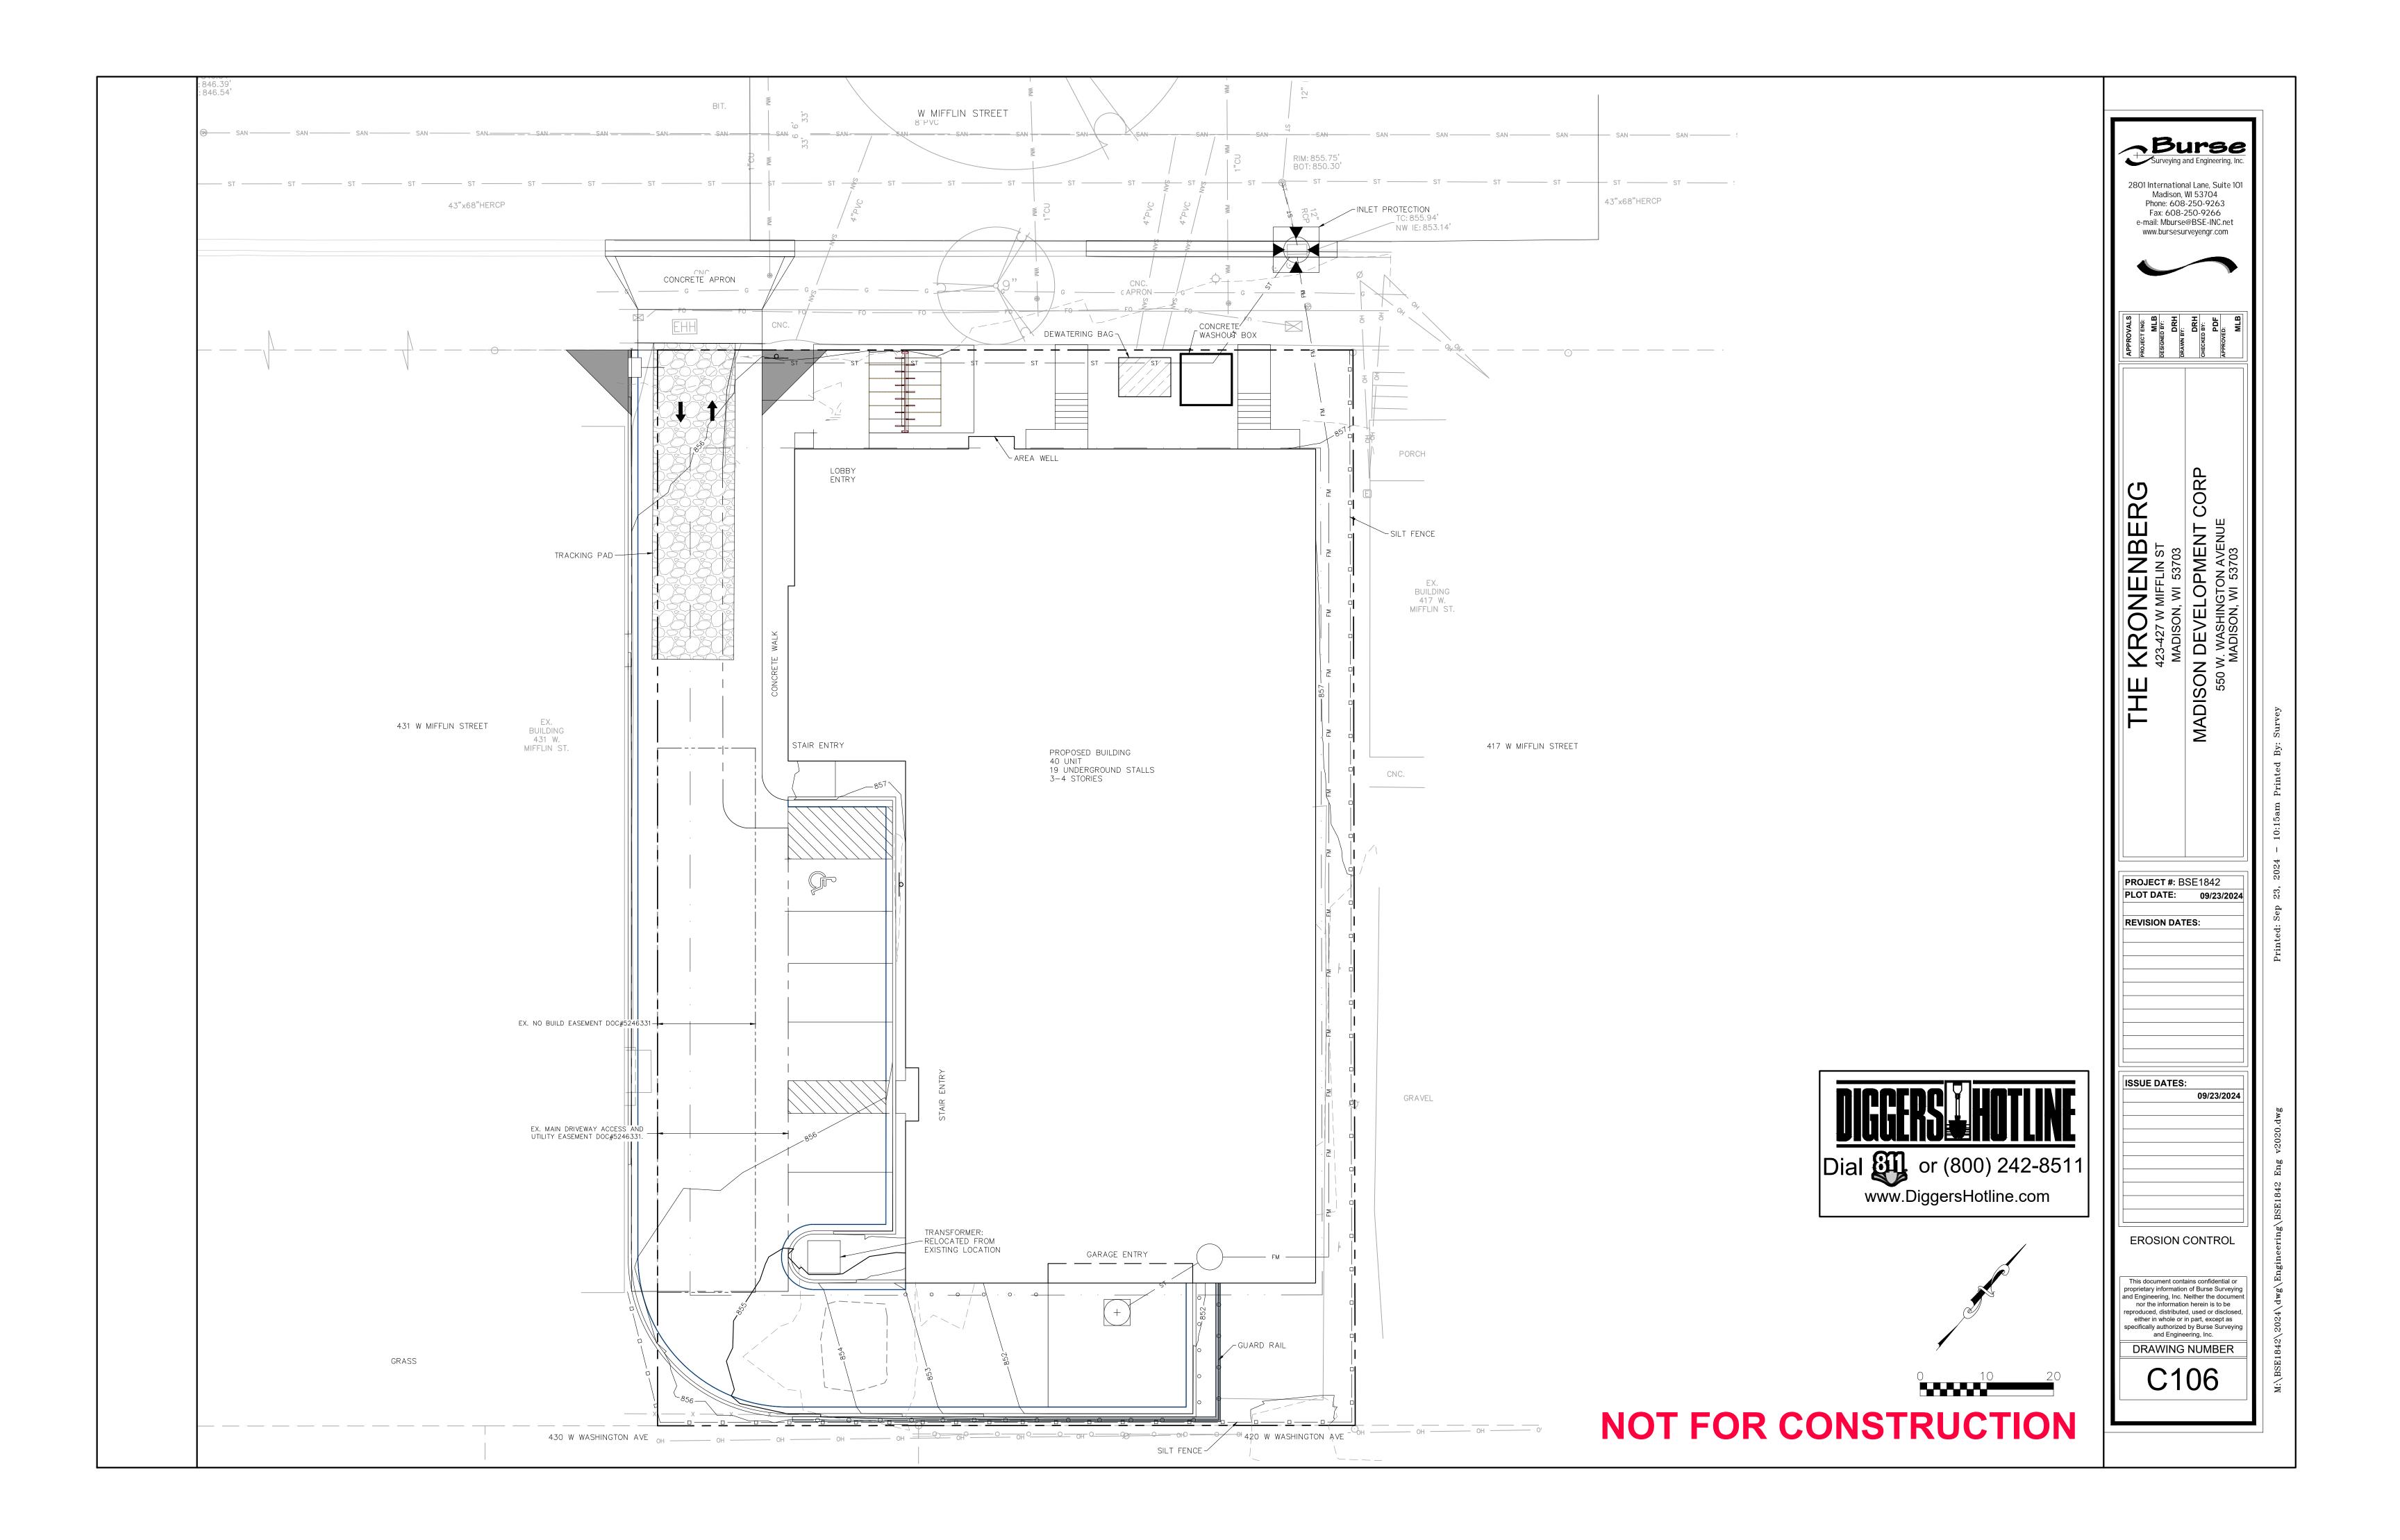
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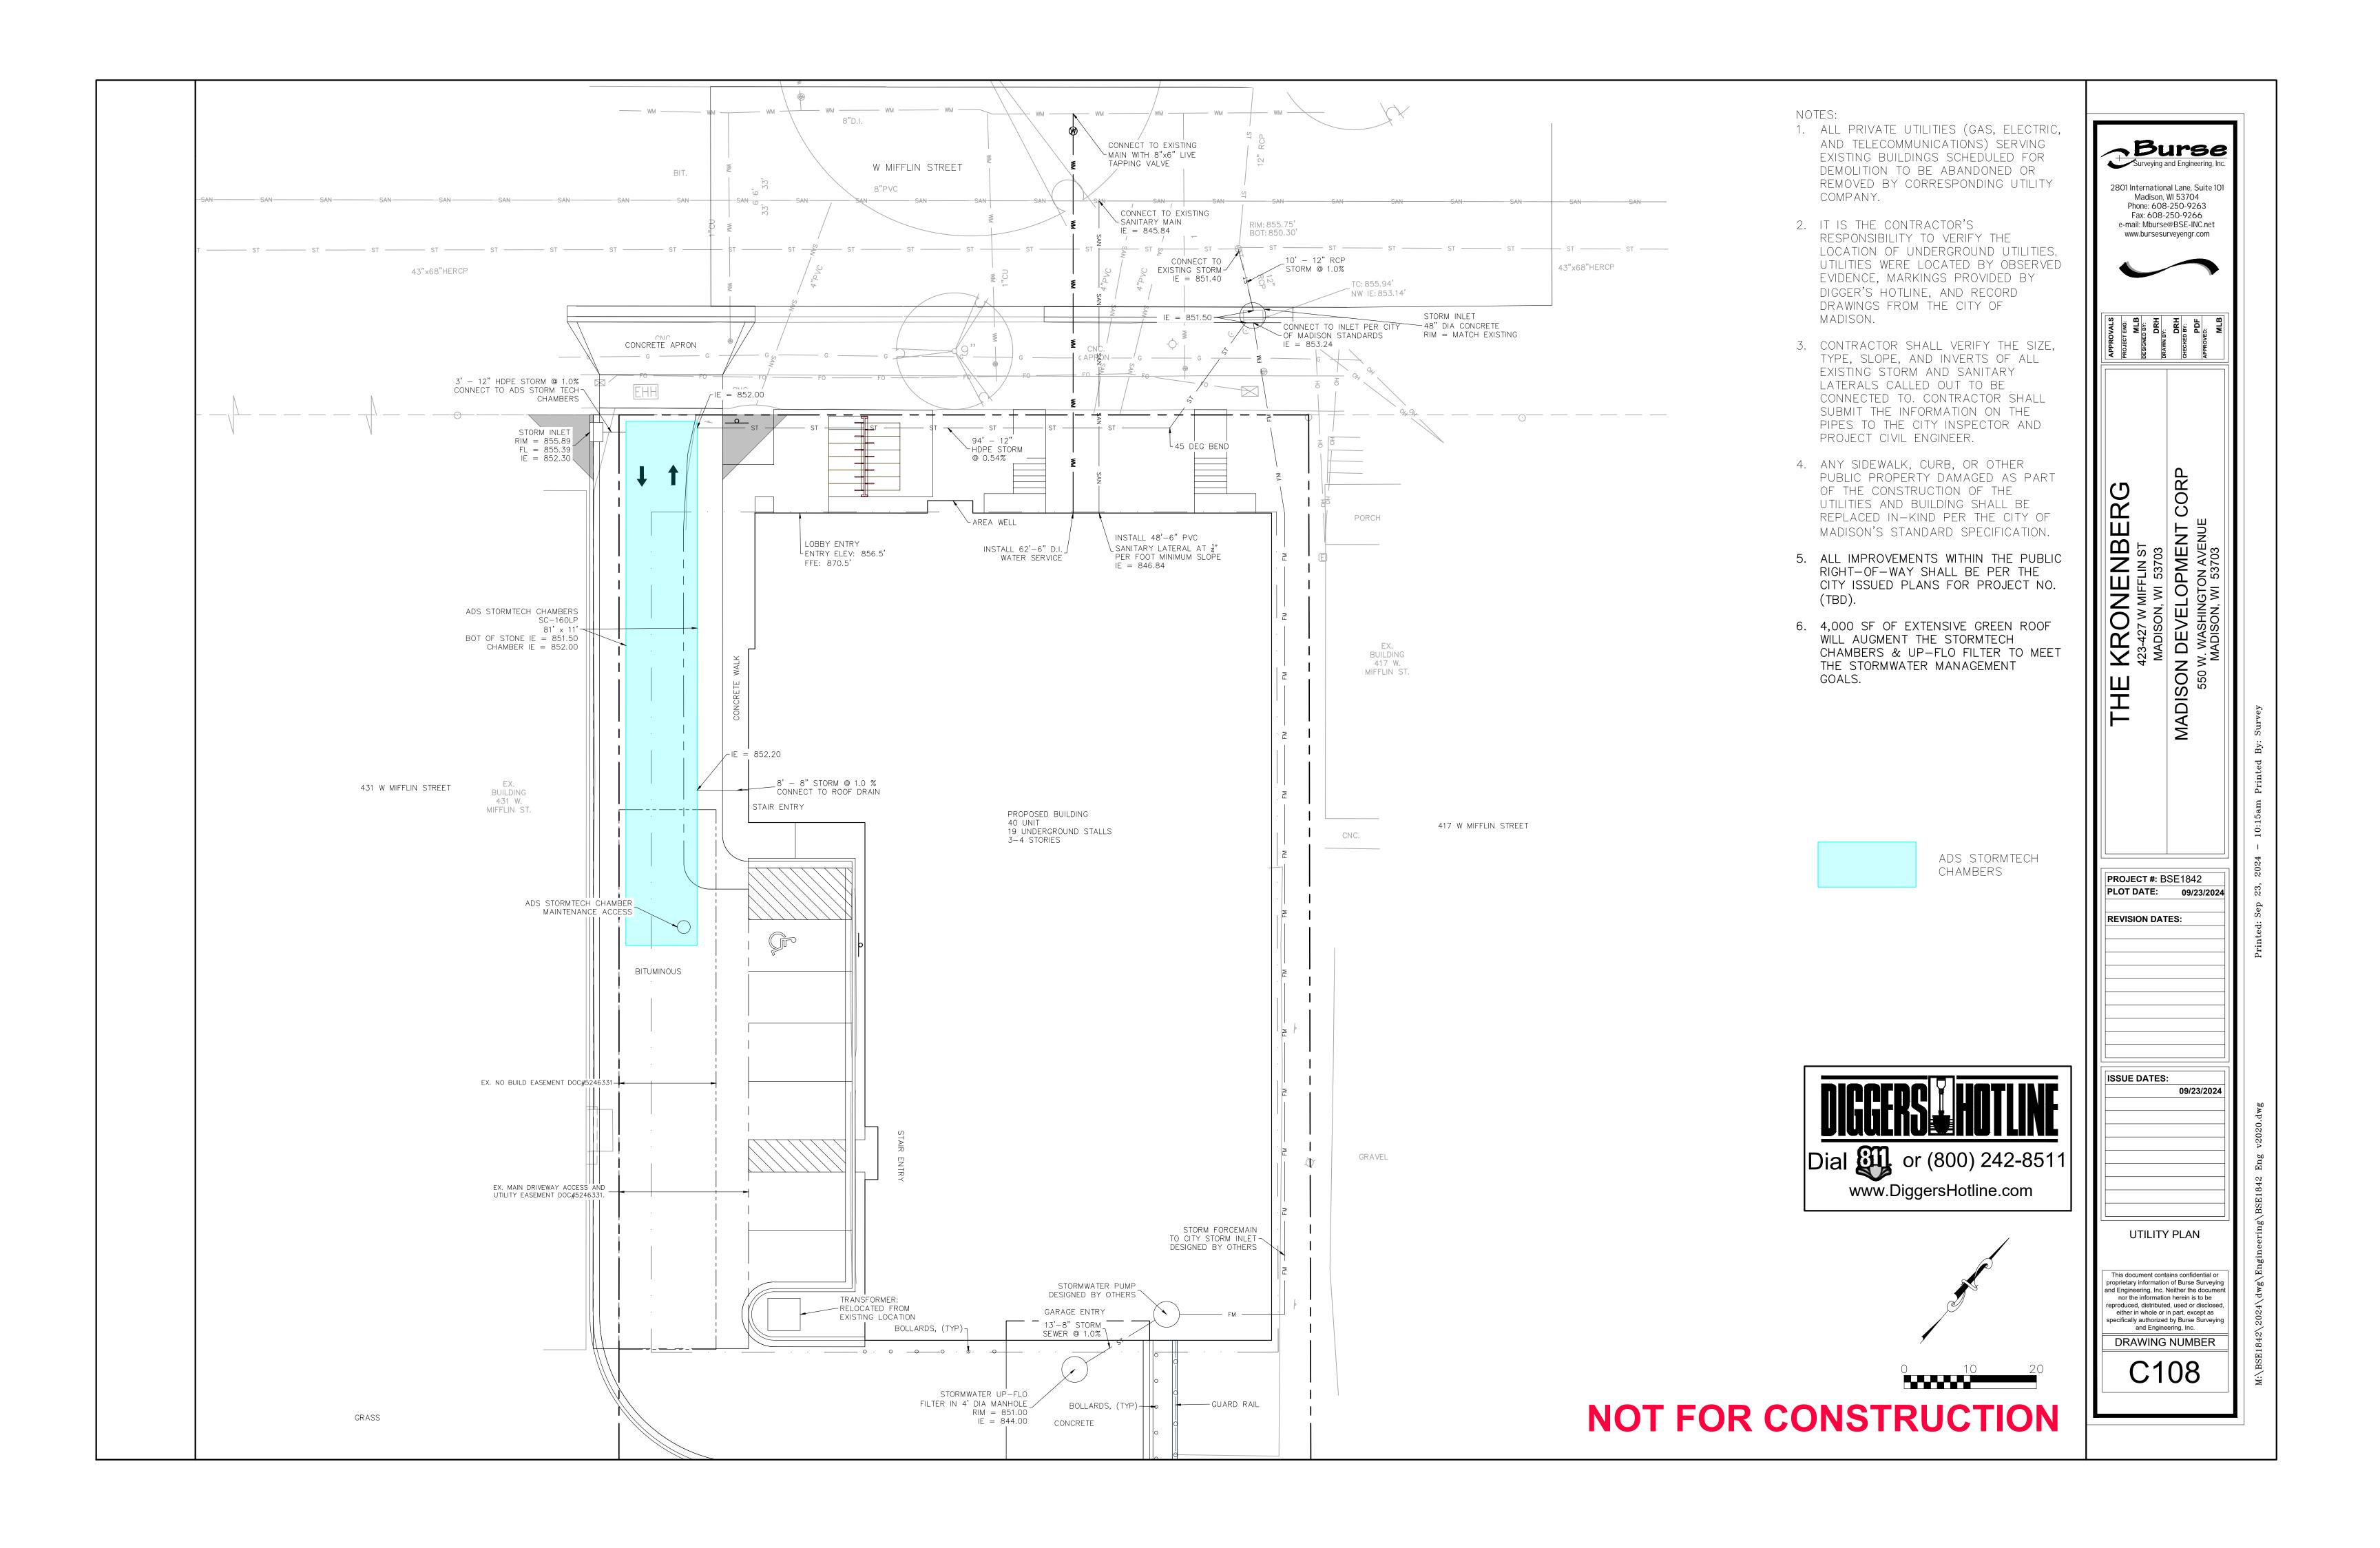












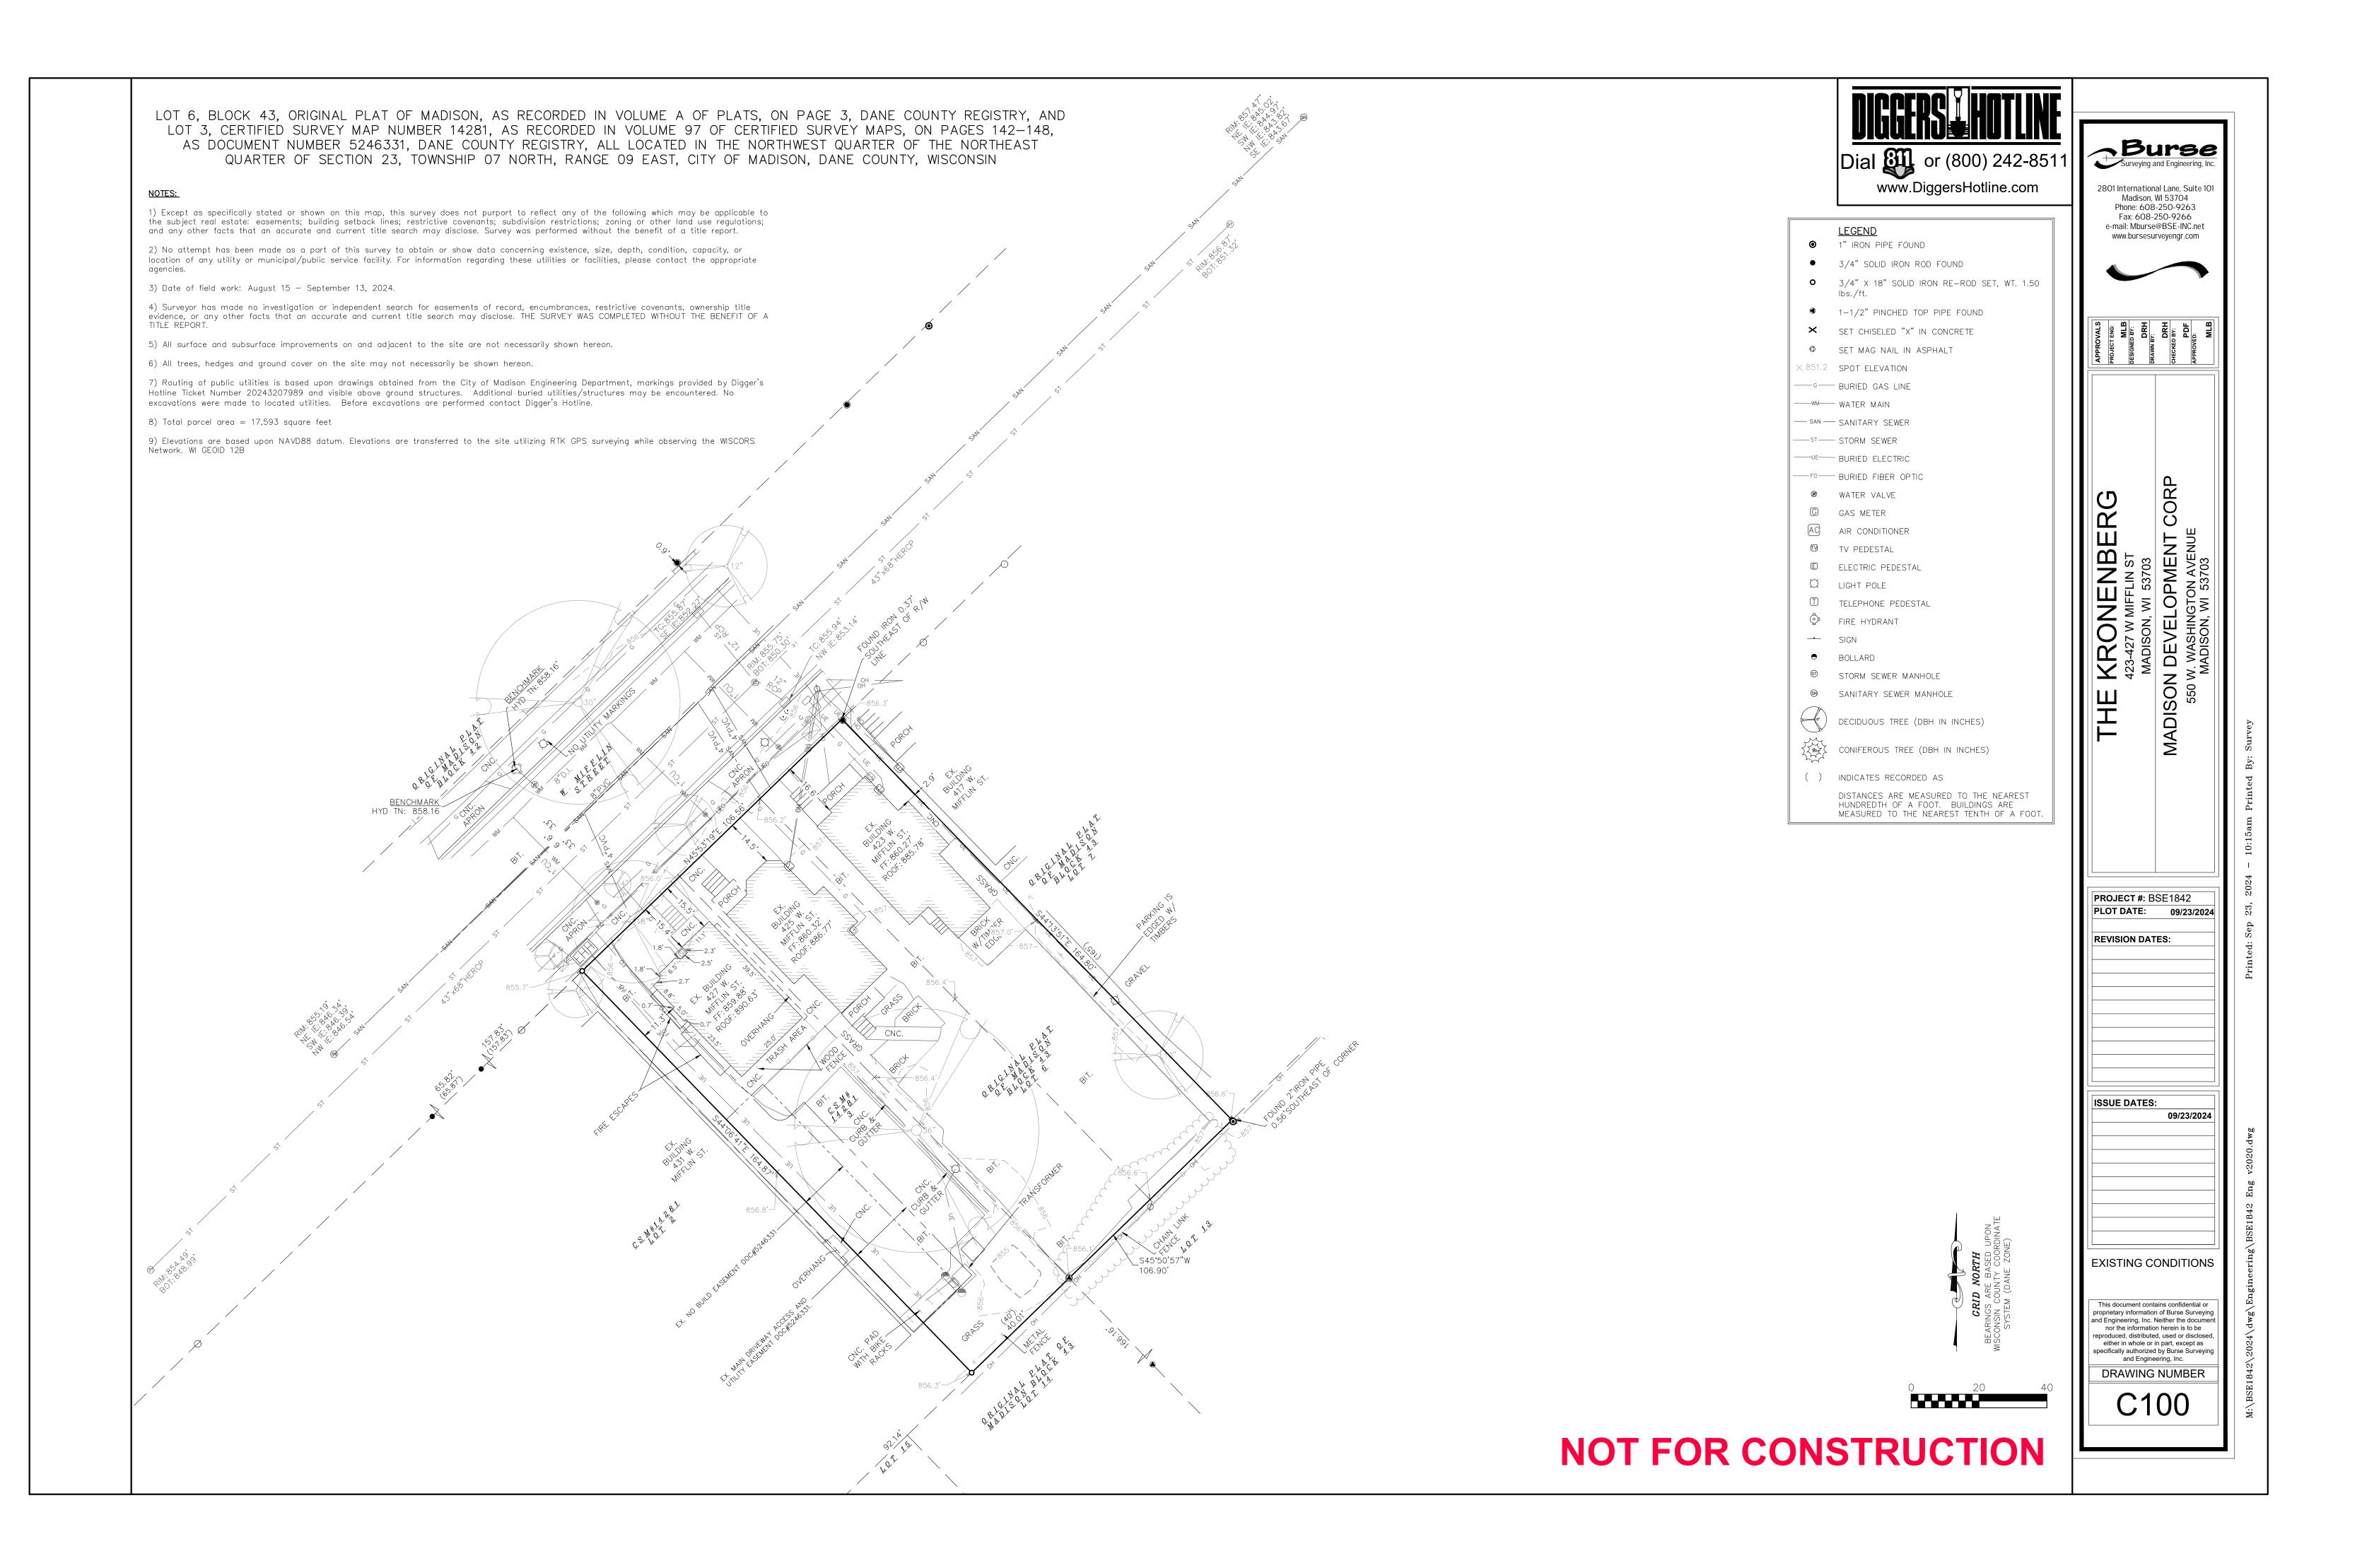

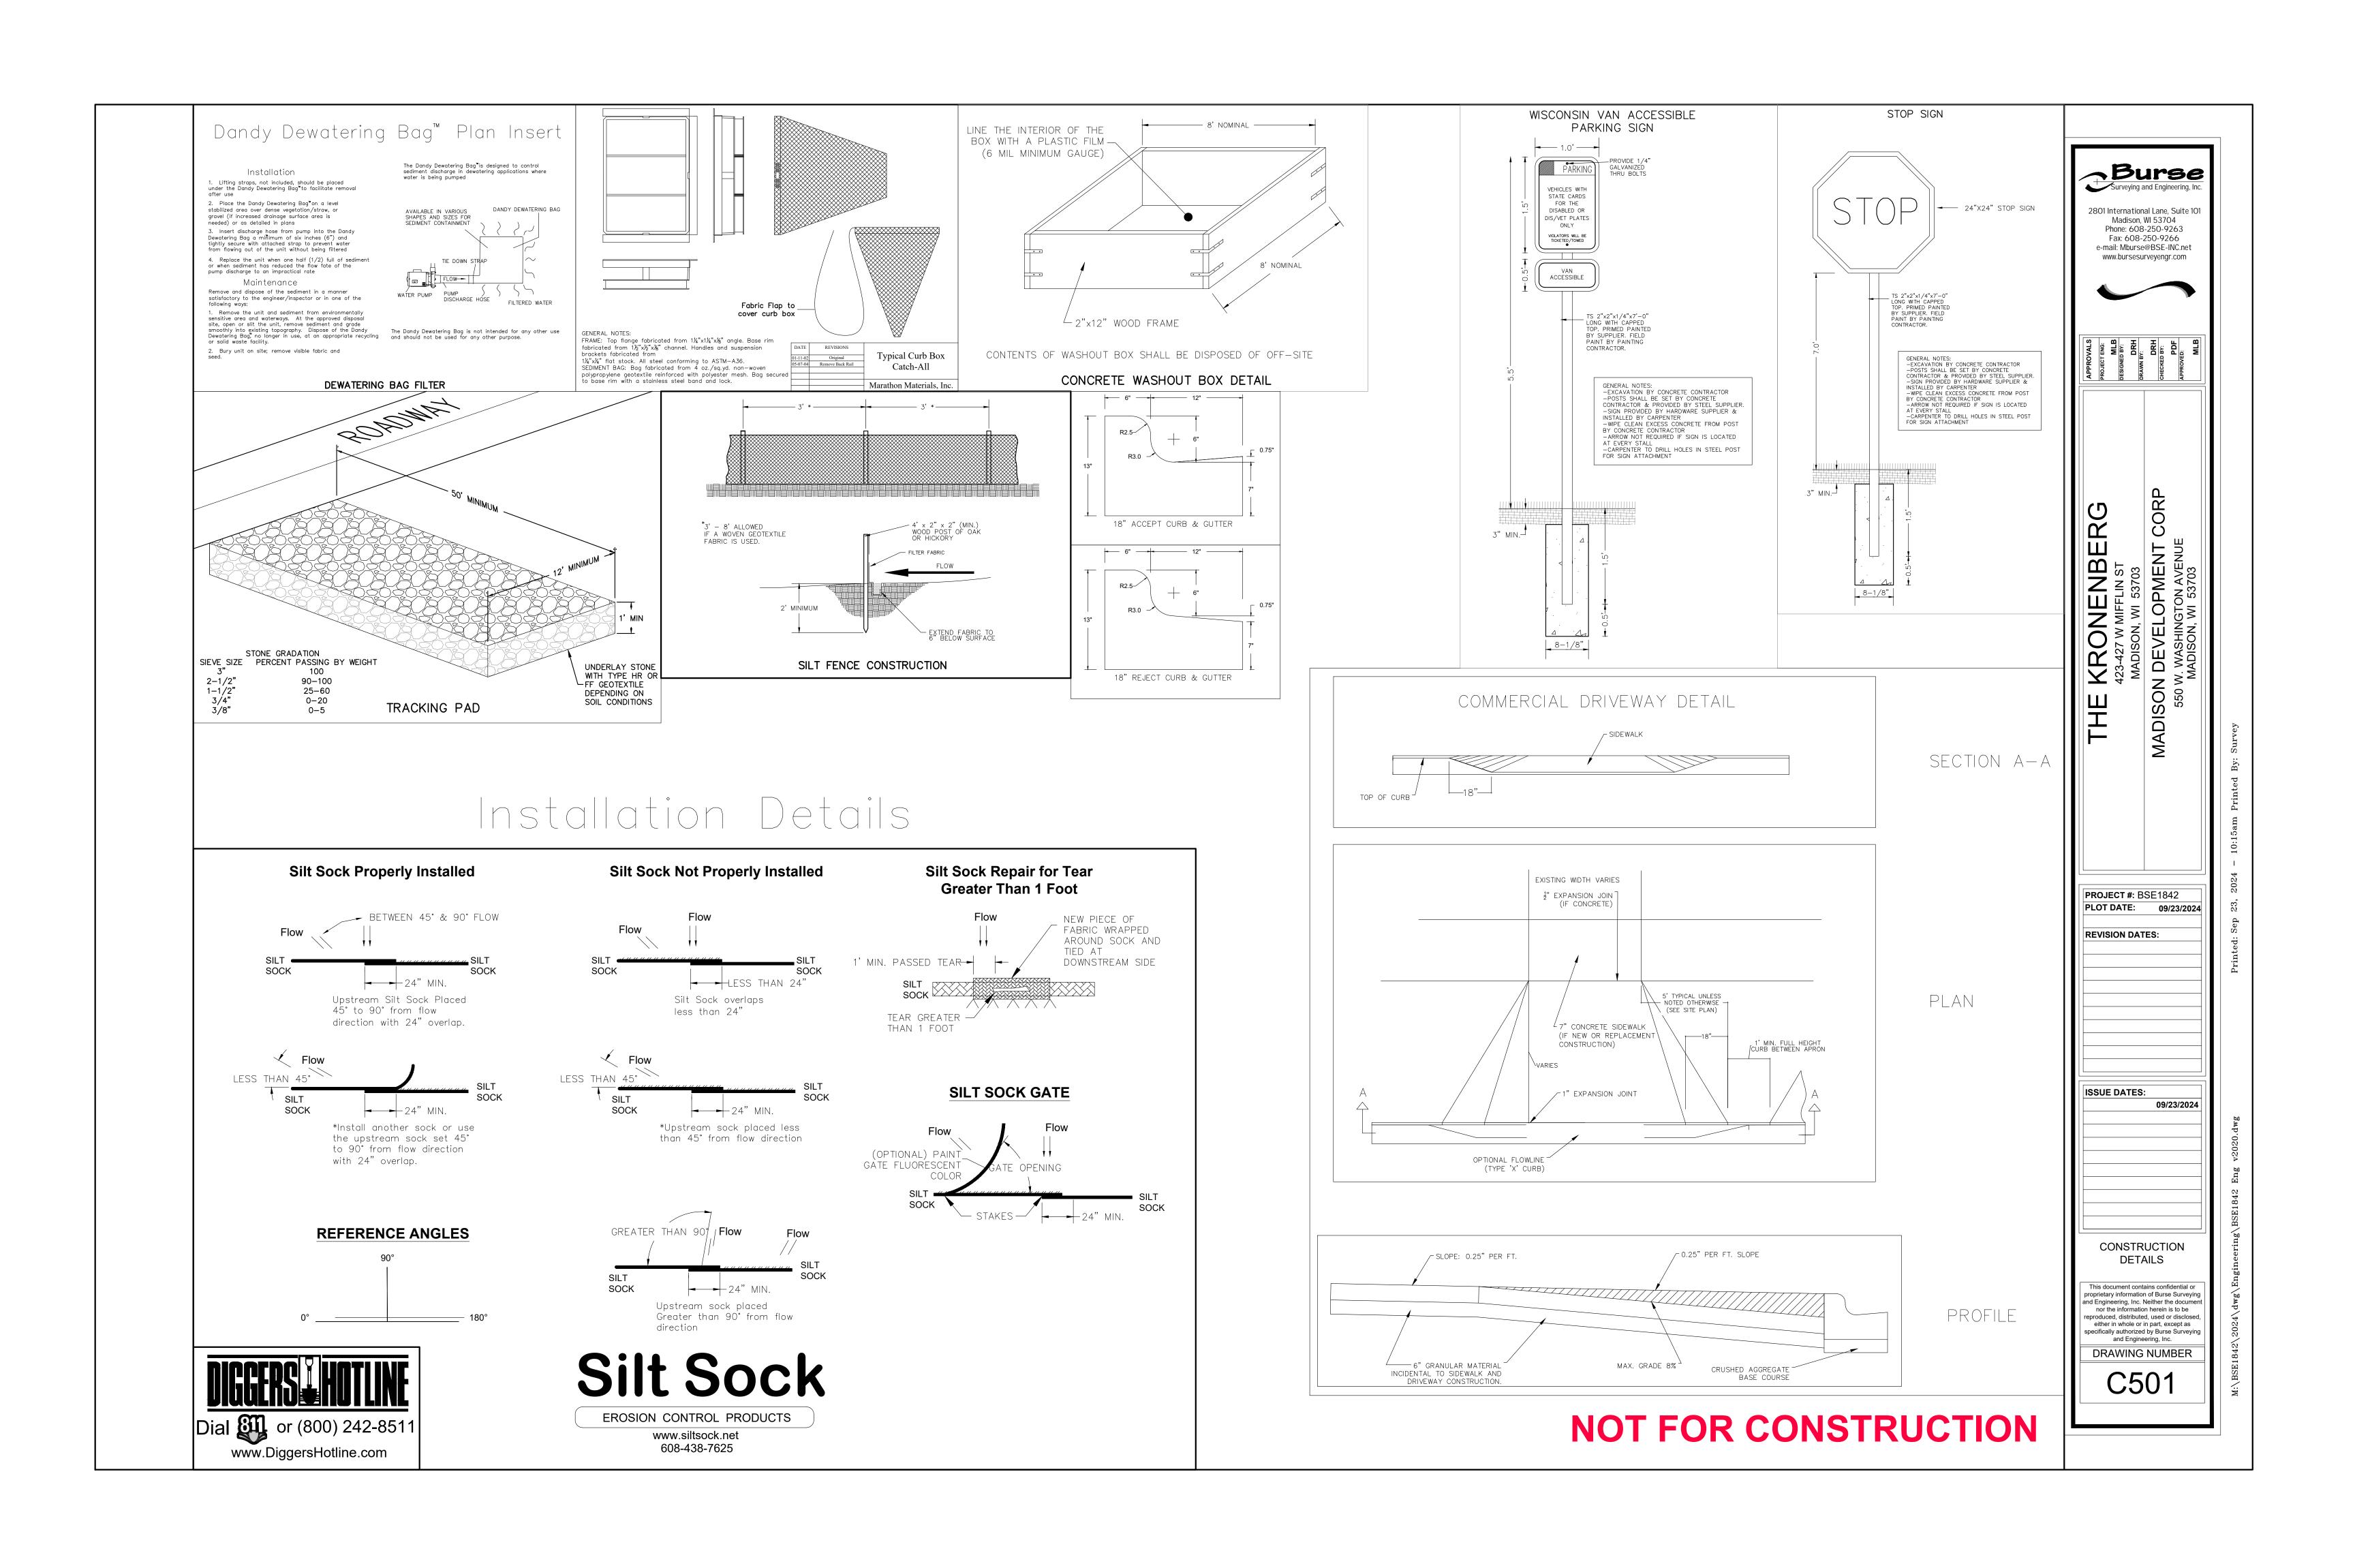

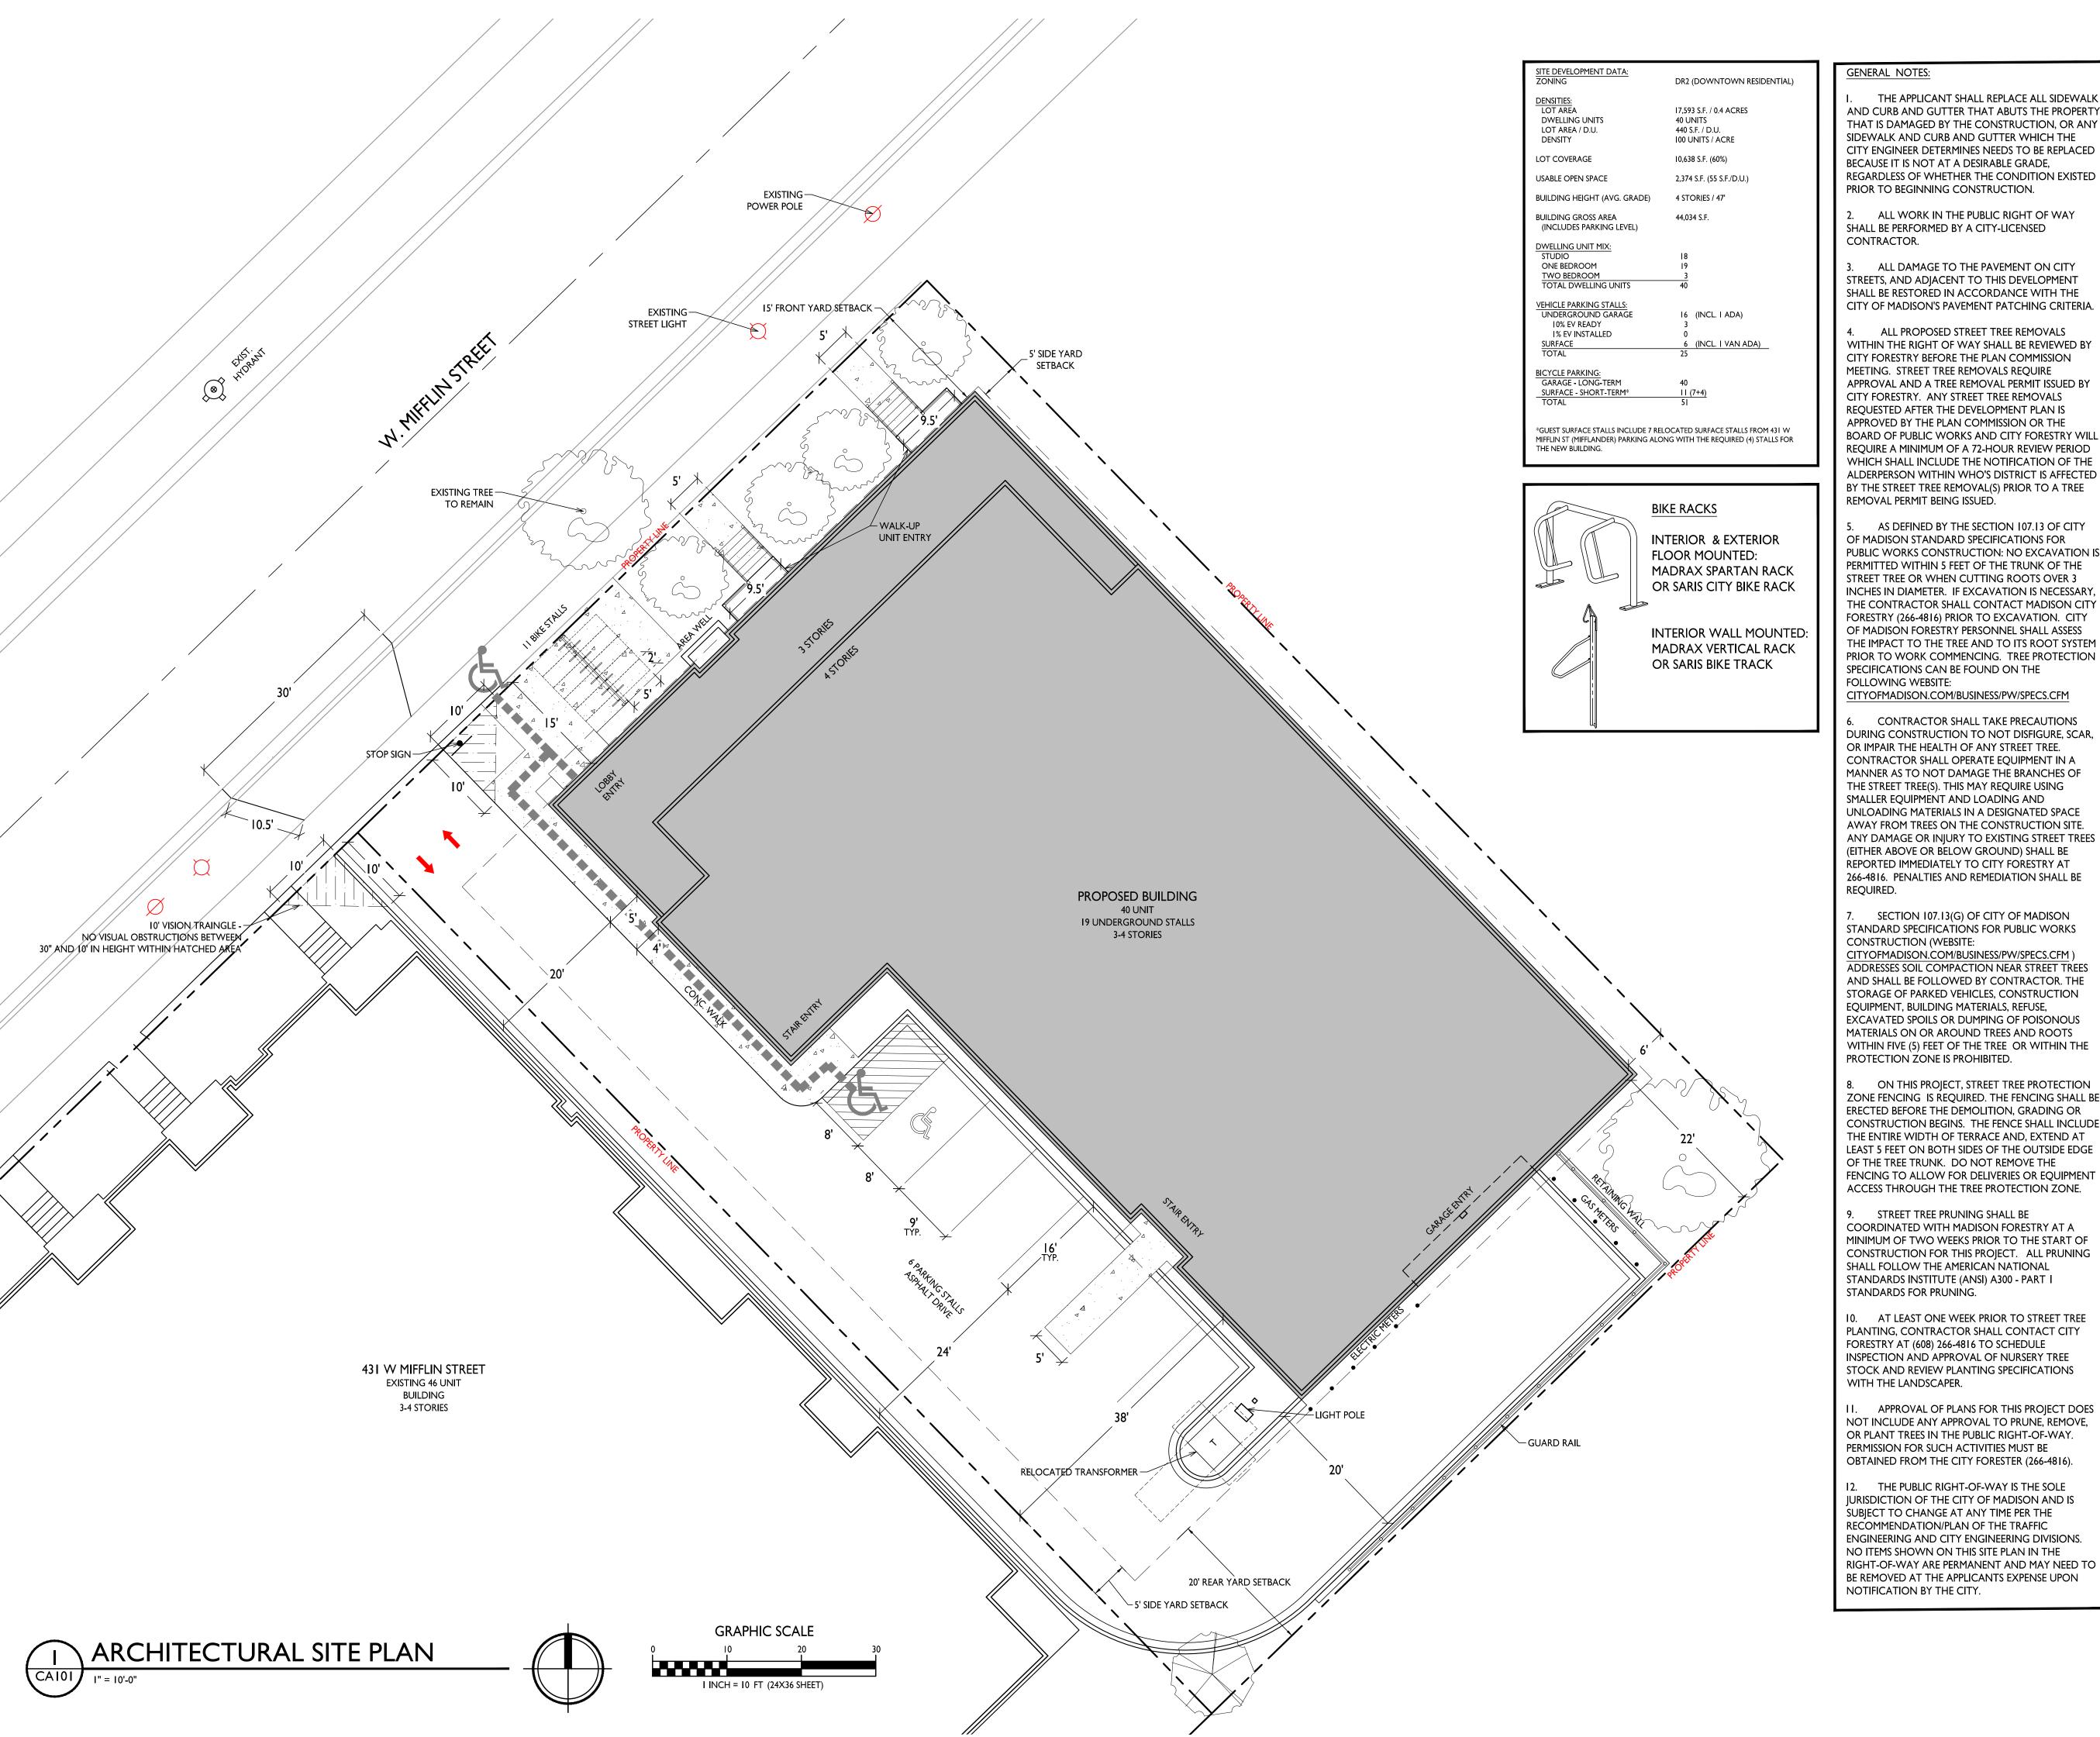

GENERAL NOTES:

CONTRACTOR SHALL TAKE PRECAUTIONS DURING CONSTRUCTION TO NOT DISFIGURE, SCAR, OR IMPAIR THE HEALTH OF ANY STREET TREE. CONTRACTOR SHALL OPERATE EQUIPMENT IN A MANNER AS TO NOT DAMAGE THE BRANCHES OF THE STREET TREE(S). THIS MAY REQUIRE USING SMALLER EQUIPMENT AND LOADING AND UNLOADING MATERIALS IN A DESIGNATED SPACE AWAY FROM TREES ON THE CONSTRUCTION SITE. ANY DAMAGE OR INJURY TO EXISTING STREET TREES (EITHER ABOVE OR BELOW GROUND) SHALL BE REPORTED IMMEDIATELY TO CITY FORESTRY AT 266-4816. PENALTIES AND REMEDIATION SHALL BE REQUIRED.

SECTION 107.13(G) OF CITY OF MADISON STANDARD SPECIFICATIONS FOR PUBLIC WORKS CONSTRUCTION (WEBSITE: CITYOFMADISON.COM/BUSINESS/PW/SPECS.CFM) ADDRESSES SOIL COMPACTION NEAR STREET TREES AND SHALL BE FOLLOWED BY CONTRACTOR. THE STORAGE OF PARKED VEHICLES, CONSTRUCTION EQUIPMENT, BUILDING MATERIALS, REFUSE, **EXCAVATED SPOILS OR DUMPING OF POISONOUS** MATERIALS ON OR AROUND TREES AND ROOTS WITHIN FIVE (5) FEET OF THE TREE OR WITHIN THE

8. ON THIS PROJECT, STREET TREE PROTECTION

STANDARDS FOR PRUNING.

10. AT LEAST ONE WEEK PRIOR TO STREET TREE PLANTING, CONTRACTOR SHALL CONTACT CITY FORESTRY AT (608) 266-4816 TO SCHEDULE INSPECTION AND APPROVAL OF NURSERY TREE STOCK AND REVIEW PLANTING SPECIFICATIONS WITH THE LANDSCAPER.

12. THE PUBLIC RIGHT-OF-WAY IS THE SOLE JURISDICTION OF THE CITY OF MADISON AND IS SUBJECT TO CHANGE AT ANY TIME PER THE RECOMMENDATION/PLAN OF THE TRAFFIC ENGINEERING AND CITY ENGINEERING DIVISIONS. NO ITEMS SHOWN ON THIS SITE PLAN IN THE RIGHT-OF-WAY ARE PERMANENT AND MAY NEED TO BE REMOVED AT THE APPLICANTS EXPENSE UPON NOTIFICATION BY THE CITY.



ALL DAMAGE TO THE PAVEMENT ON CITY STREETS, AND ADJACENT TO THIS DEVELOPMENT SHALL BE RESTORED IN ACCORDANCE WITH THE CITY OF MADISON'S PAVEMENT PATCHING CRITERIA

ALL PROPOSED STREET TREE REMOVALS WITHIN THE RIGHT OF WAY SHALL BE REVIEWED BY CITY FORESTRY BEFORE THE PLAN COMMISSION MEETING. STREET TREE REMOVALS REQUIRE APPROVAL AND A TREE REMOVAL PERMIT ISSUED BY CITY FORESTRY. ANY STREET TREE REMOVALS REQUESTED AFTER THE DEVELOPMENT PLAN IS APPROVED BY THE PLAN COMMISSION OR THE BOARD OF PUBLIC WORKS AND CITY FORESTRY WILL REQUIRE A MINIMUM OF A 72-HOUR REVIEW PERIOD WHICH SHALL INCLUDE THE NOTIFICATION OF THE ALDERPERSON WITHIN WHO'S DISTRICT IS AFFECTED BY THE STREET TREE REMOVAL(S) PRIOR TO A TREE REMOVAL PERMIT BEING ISSUED.

AS DEFINED BY THE SECTION 107.13 OF CITY OF MADISON STANDARD SPECIFICATIONS FOR PUBLIC WORKS CONSTRUCTION: NO EXCAVATION IS PERMITTED WITHIN 5 FEET OF THE TRUNK OF THE STREET TREE OR WHEN CUTTING ROOTS OVER 3 INCHES IN DIAMETER. IF EXCAVATION IS NECESSARY THE CONTRACTOR SHALL CONTACT MADISON CITY FORESTRY (266-4816) PRIOR TO EXCAVATION. CITY OF MADISON FORESTRY PERSONNEL SHALL ASSESS THE IMPACT TO THE TREE AND TO ITS ROOT SYSTEM PRIOR TO WORK COMMENCING. TREE PROTECTION SPECIFICATIONS CAN BE FOUND ON THE FOLLOWING WEBSITE:

CITYOFMADISON.COM/BUSINESS/PW/SPECS.CFM

PROTECTION ZONE IS PROHIBITED.

ZONE FENCING IS REQUIRED. THE FENCING SHALL BE ERECTED BEFORE THE DEMOLITION, GRADING OR CONSTRUCTION BEGINS. THE FENCE SHALL INCLUDE THE ENTIRE WIDTH OF TERRACE AND, EXTEND AT LEAST 5 FEET ON BOTH SIDES OF THE OUTSIDE EDGE OF THE TREE TRUNK. DO NOT REMOVE THE FENCING TO ALLOW FOR DELIVERIES OR EQUIPMENT ACCESS THROUGH THE TREE PROTECTION ZONE.

9. STREET TREE PRUNING SHALL BE COORDINATED WITH MADISON FORESTRY AT A MINIMUM OF TWO WEEKS PRIOR TO THE START OF CONSTRUCTION FOR THIS PROJECT. ALL PRUNING SHALL FOLLOW THE AMERICAN NATIONAL STANDARDS INSTITUTE (ANSI) A300 - PART I

II. APPROVAL OF PLANS FOR THIS PROJECT DOES NOT INCLUDE ANY APPROVAL TO PRUNE, REMOVE, OR PLANT TREES IN THE PUBLIC RIGHT-OF-WAY. PERMISSION FOR SUCH ACTIVITIES MUST BE OBTAINED FROM THE CITY FORESTER (266-4816).

7601 University Ave, Ste 201 608.836.3690 Middleton, WI 53562

ISSUED Issued for Land Use Submittal - September 23, 2024

PROJECT TITLE THE KRONENBERG


423-427 W. Mifflin Street, Madison, WI SHEET TITLE

Architectural Site Plan

SHEET NUMBER

CA101

PROJECT NO.

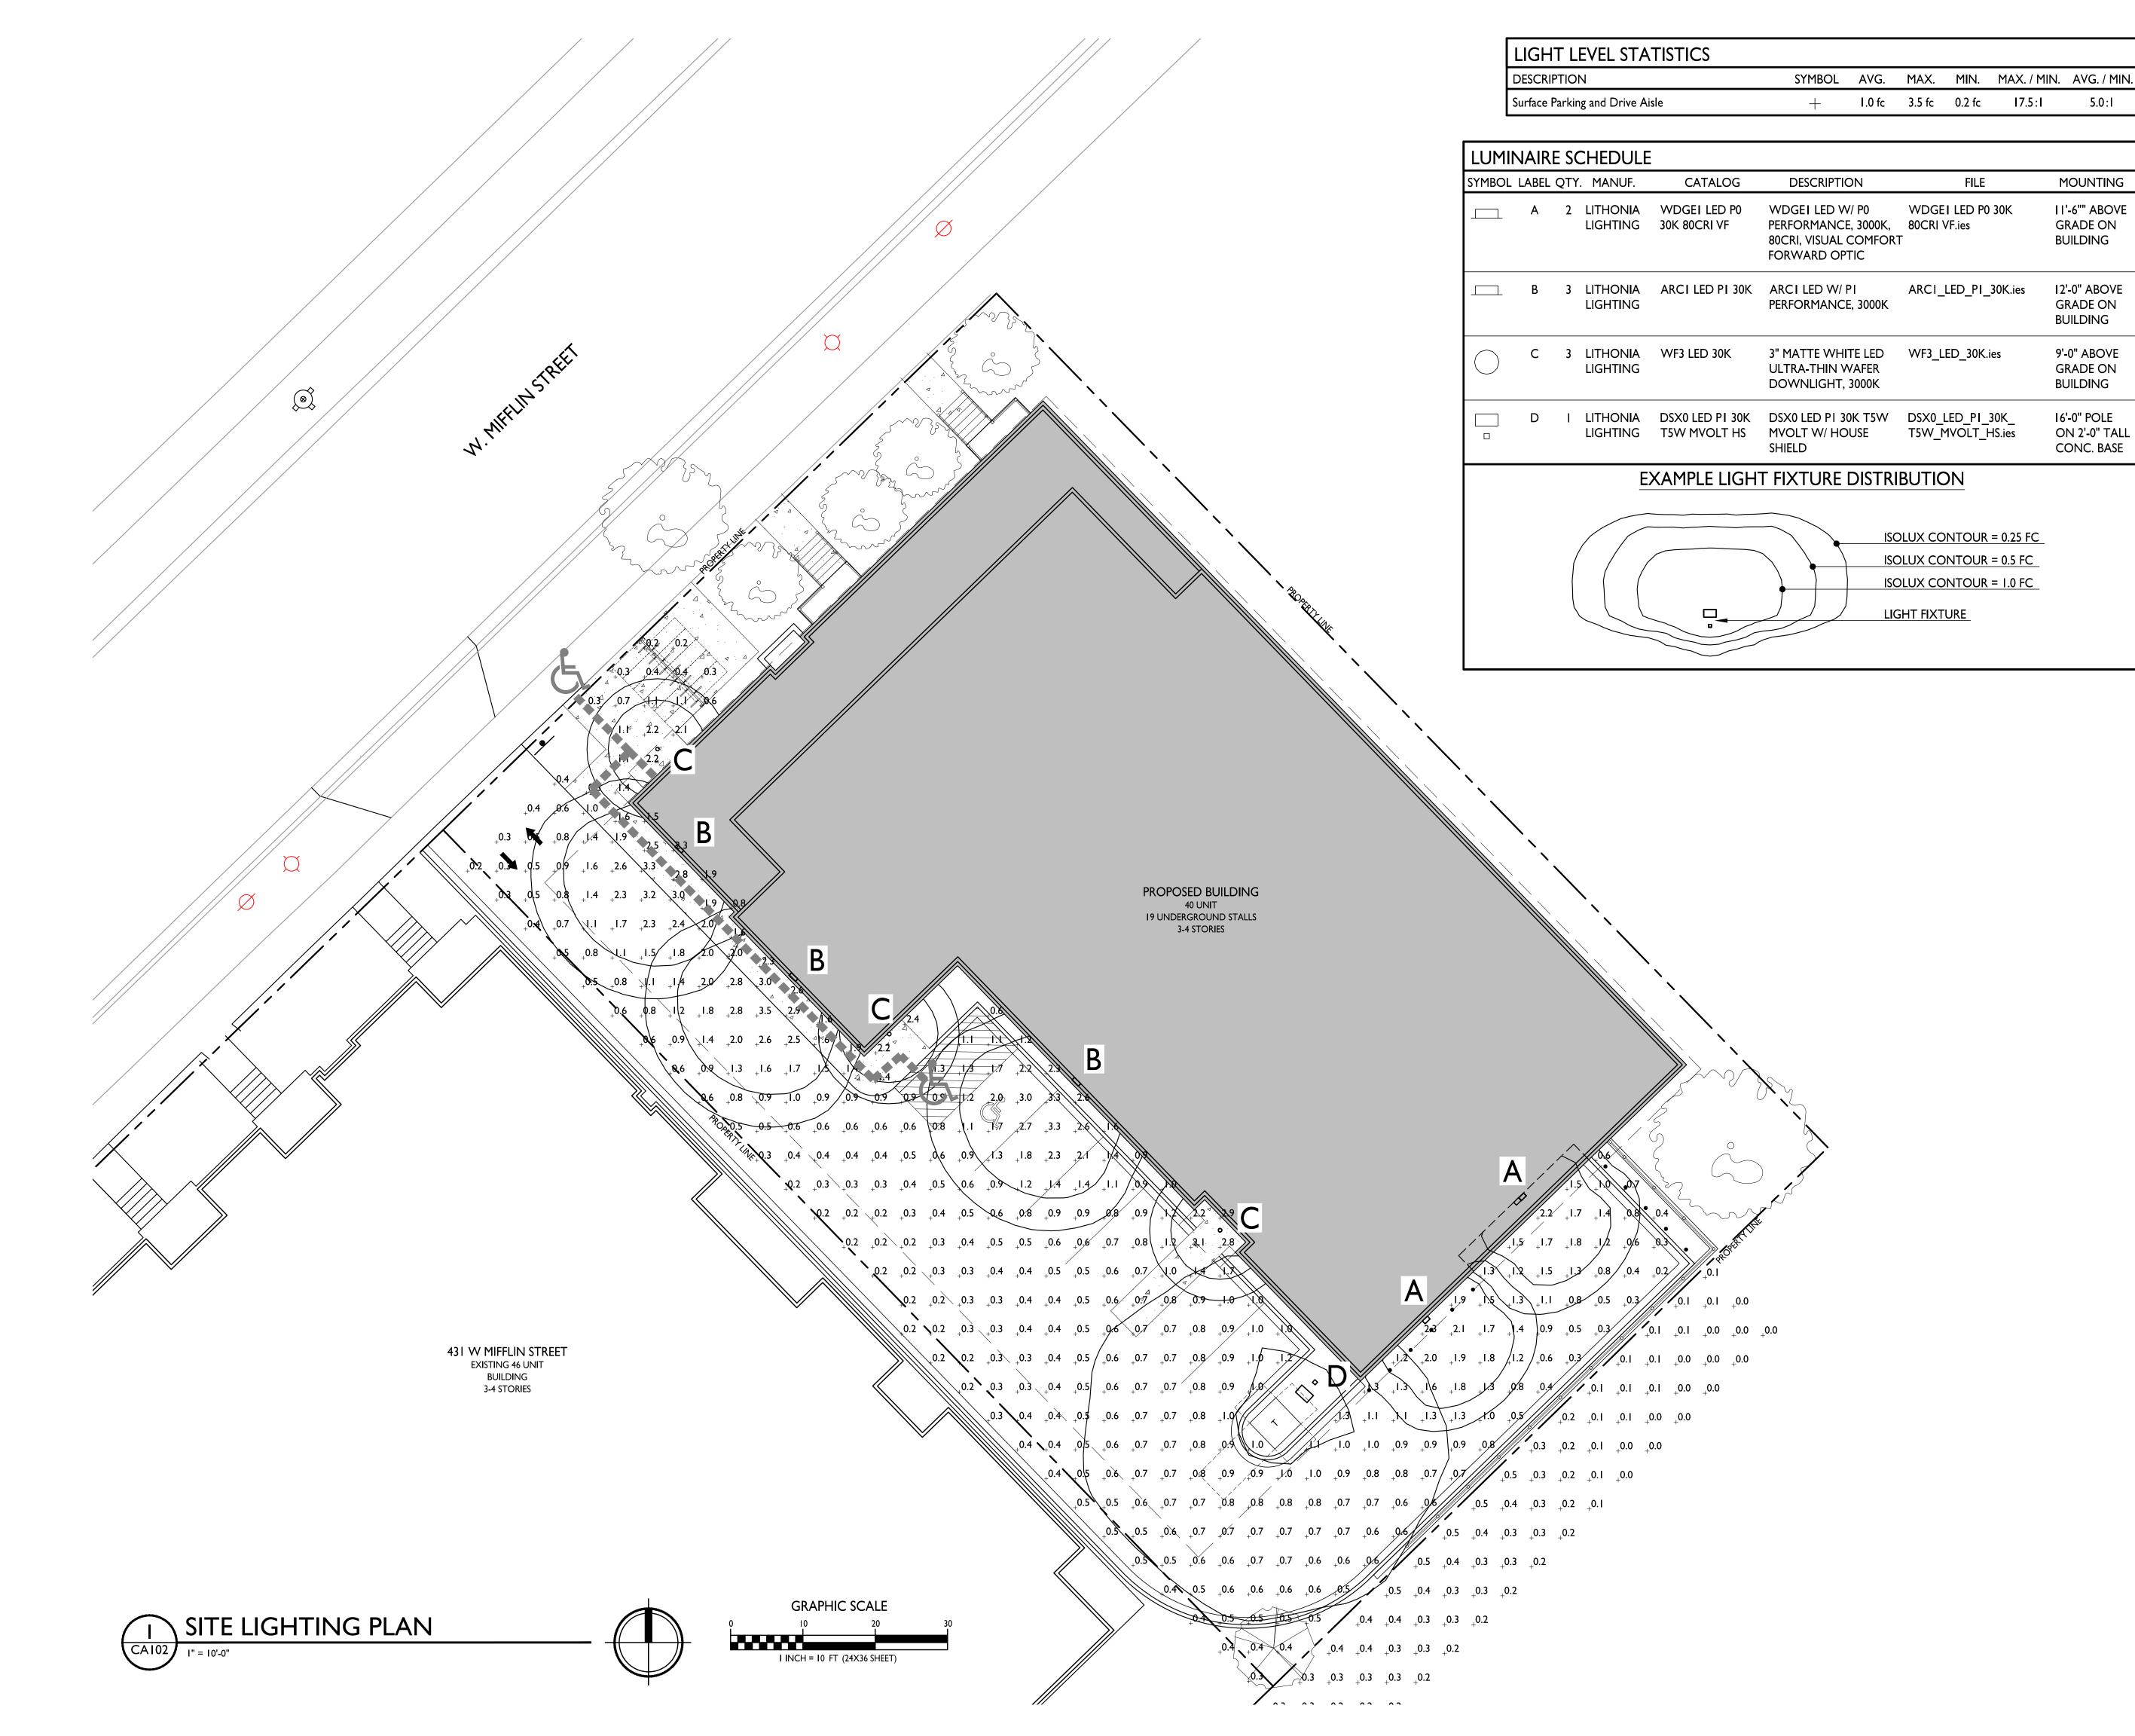



ISSUED Issued for Land Use Submittal - September 23, 2024


PROJECT TITLE THE KRONENBERG

423-427 W. Mifflin Street, Madison, WI SHEET TITLE Site Lighting Plan

SHEET NUMBER

CAI02

PROJECT NO.

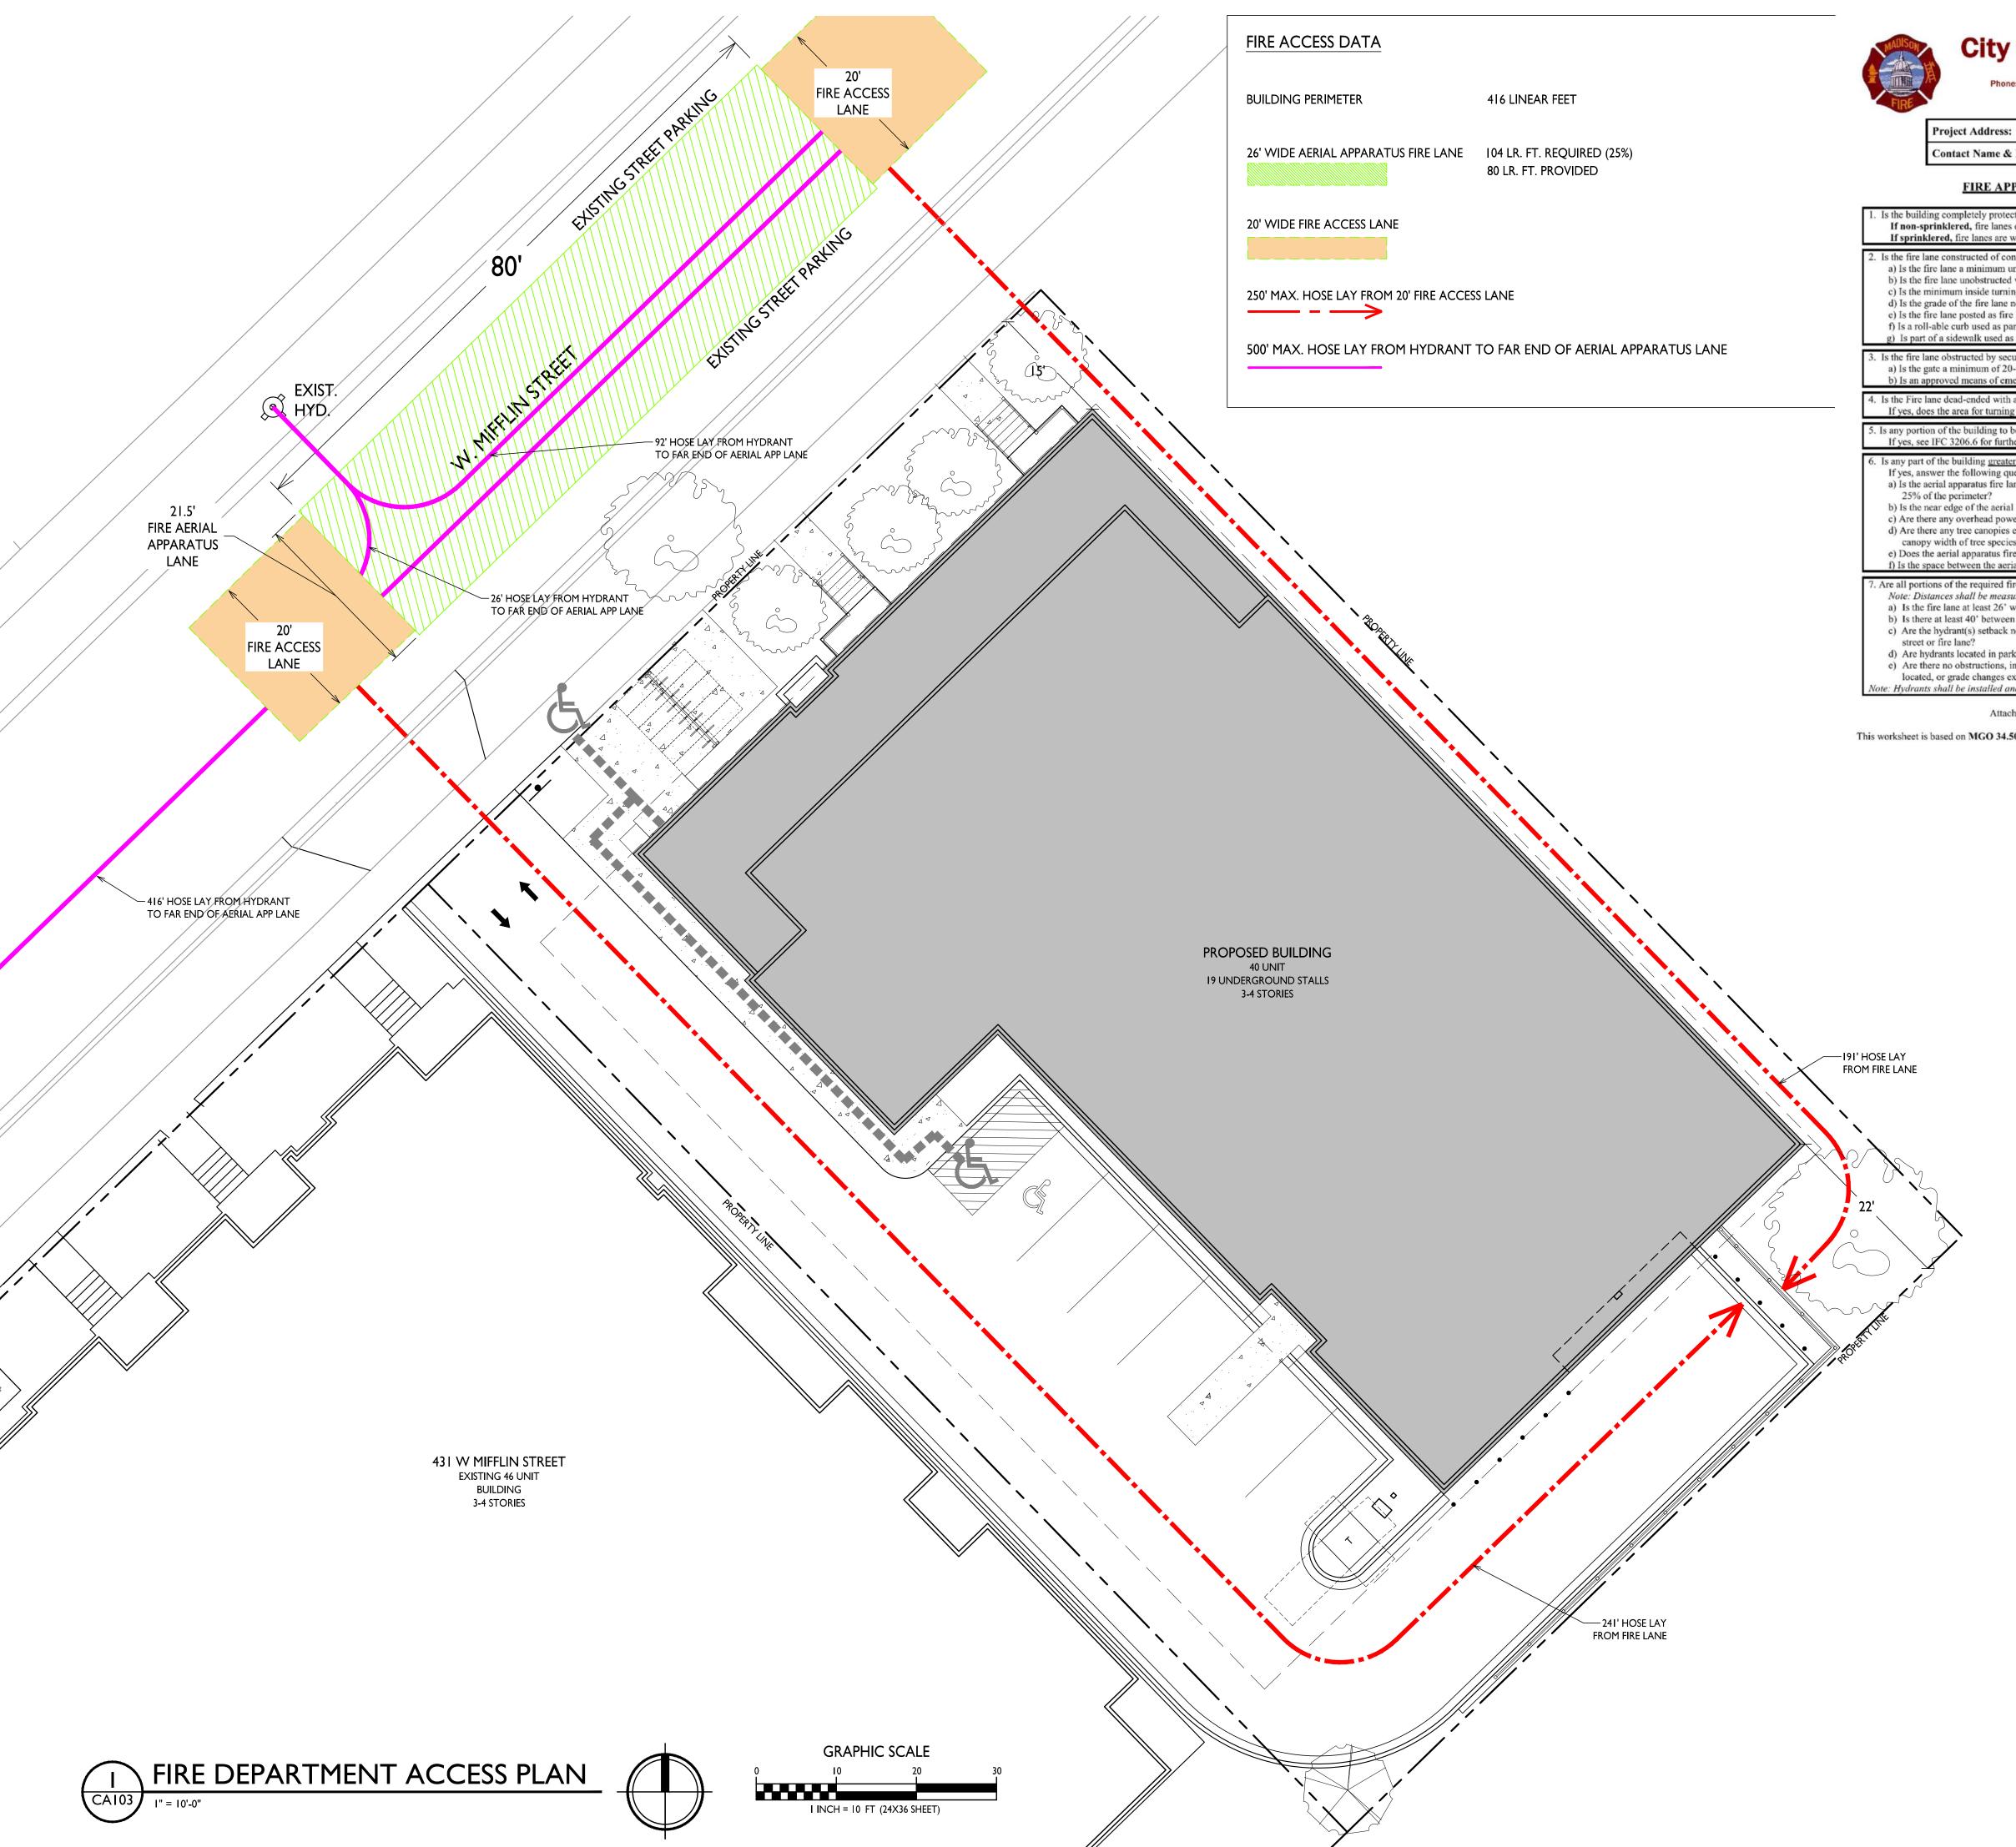



Project Address: 427 W Mifflin Street

Contact Name & Phone #: Kevin Burow, Knothe & Bruce Architects - 608-836-3690

#### FIRE APPARATUS ACCESS AND FIRE HYDRANT WORKSHEET

<ol> <li>Is the building completely protected by an NFPA 13 or 13R automatic fire sprinkler system?         If non-sprinklered, fire lanes extend to within 150-feet of all portions of the exterior wall?         If sprinklered, fire lanes are within 250-feet of all portions of the exterior wall?     </li> </ol>	X Yes ☐ Yes X Yes	No No	
<ul> <li>2. Is the fire lane constructed of concrete or asphalt, designed to support a minimum load of 85,000 lbs? <ul> <li>a) Is the fire lane a minimum unobstructed width of at least 20-feet?</li> <li>b) Is the fire lane unobstructed with a vertical clearance of at least 13½-feet?</li> <li>c) Is the minimum inside turning radius of the fire lane at least 28-feet?</li> <li>d) Is the grade of the fire lane not more than a slope of 8%?</li> <li>e) Is the fire lane posted as fire lane? (Provide detail of signage.)</li> <li>f) Is a roll-able curb used as part of the fire lane? (Provide detail of curb.)</li> <li>g) Is part of a sidewalk used as part of the required fire lane? (Must support +85,000 lbs.)</li> </ul> </li> </ul>	X Yes X Yes X Yes Yes Yes Yes Yes Yes Yes Yes Yes	No   No   No   No   No   No   No   No	
<ul> <li>3. Is the fire lane obstructed by security gates or barricades? If yes:</li> <li>a) Is the gate a minimum of 20-feet clear opening?</li> <li>b) Is an approved means of emergency operations installed, key vault, padlock or key switch?</li> </ul>	☐ Yes ☐ Yes ☐ Yes	No No No	□ N ⊠ N
4. Is the Fire lane dead-ended with a length greater than 150-feet? If yes, does the area for turning around fire apparatus comply with IFC D103?	☐ Yes ☐ Yes	□ No	X N
<ol> <li>Is any portion of the building to be used for high-piled storage in accordance with IFC Chapter 3206.6         If yes, see IFC 3206.6 for further requirements.     </li> </ol>	☐ Yes	X No	□N
6. Is any part of the building greater than 30-feet above the grade plane? If yes, answer the following questions:	X Yes	☐ No	
a) Is the aerial apparatus fire lane parallel to one entire side of the building and covering at least 25% of the perimeter?	☐ Yes	No No	$\square$ N
<ul><li>b) Is the near edge of the aerial apparatus fire lane between 15' and 30' from the building?</li><li>c) Are there any overhead power or utility lines located across the aerial apparatus fire lane?</li></ul>	X Yes  ☐ Yes	☐ No 図 No	
	☐ Yes	X No	
d) Are there any tree canopies expected to grow across the aerial fire lane? (Based on mature			
canopy width of tree species)	☐ Yes	X No	
	☐ Yes X Yes	X No □ No	
canopy width of tree species) e) Does the aerial apparatus fire lane have a minimum unobstructed width of 26-feet? f) Is the space between the aerial lane and the building free of trees exceeding 20' in heights?  7. Are all portions of the required fire lanes within 500-feet of at least (2) hydrants?		-	□ N
canopy width of tree species) e) Does the aerial apparatus fire lane have a minimum unobstructed width of 26-feet? f) Is the space between the aerial lane and the building free of trees exceeding 20' in heights?	X Yes	☐ No	
canopy width of tree species) e) Does the aerial apparatus fire lane have a minimum unobstructed width of 26-feet? f) Is the space between the aerial lane and the building free of trees exceeding 20' in heights?  7. Are all portions of the required fire lanes within 500-feet of at least (2) hydrants?  Note: Distances shall be measured along the path of the hose lay as it comes off the fire apparatus. a) Is the fire lane at least 26' wide for at least 20-feet on each side of the hydrants? b) Is there at least 40' between a hydrant and the building? c) Are the hydrant(s) setback no less than 5-feet nor more than 10-feet from the curb or edge of the	X Yes X Yes	□ No □ No	
canopy width of tree species) e) Does the aerial apparatus fire lane have a minimum unobstructed width of 26-feet? f) Is the space between the aerial lane and the building free of trees exceeding 20' in heights?  7. Are all portions of the required fire lanes within 500-feet of at least (2) hydrants?  Note: Distances shall be measured along the path of the hose lay as it comes off the fire apparatus. a) Is the fire lane at least 26' wide for at least 20-feet on each side of the hydrants? b) Is there at least 40' between a hydrant and the building?	X Yes X Yes X Yes X Yes	No No No No	

Attach an additional sheet if further explanation is required for any answers.

This worksheet is based on MGO 34.503 and IFC 2021 Edition Chapter 5 and Appendix D; please see the codes for further information.

Revised 06/2022

PROJECT TITLE THE KRONENBERG

608.836.3690 Middleton, WI 53562

Issued for Land Use Submittal - September 23, 2024

423-427 W. Mifflin Street, Madison, WI SHEET TITLE Fire Department


SHEET NUMBER

Access Plan

CAI03

PROJECT NO.

2253

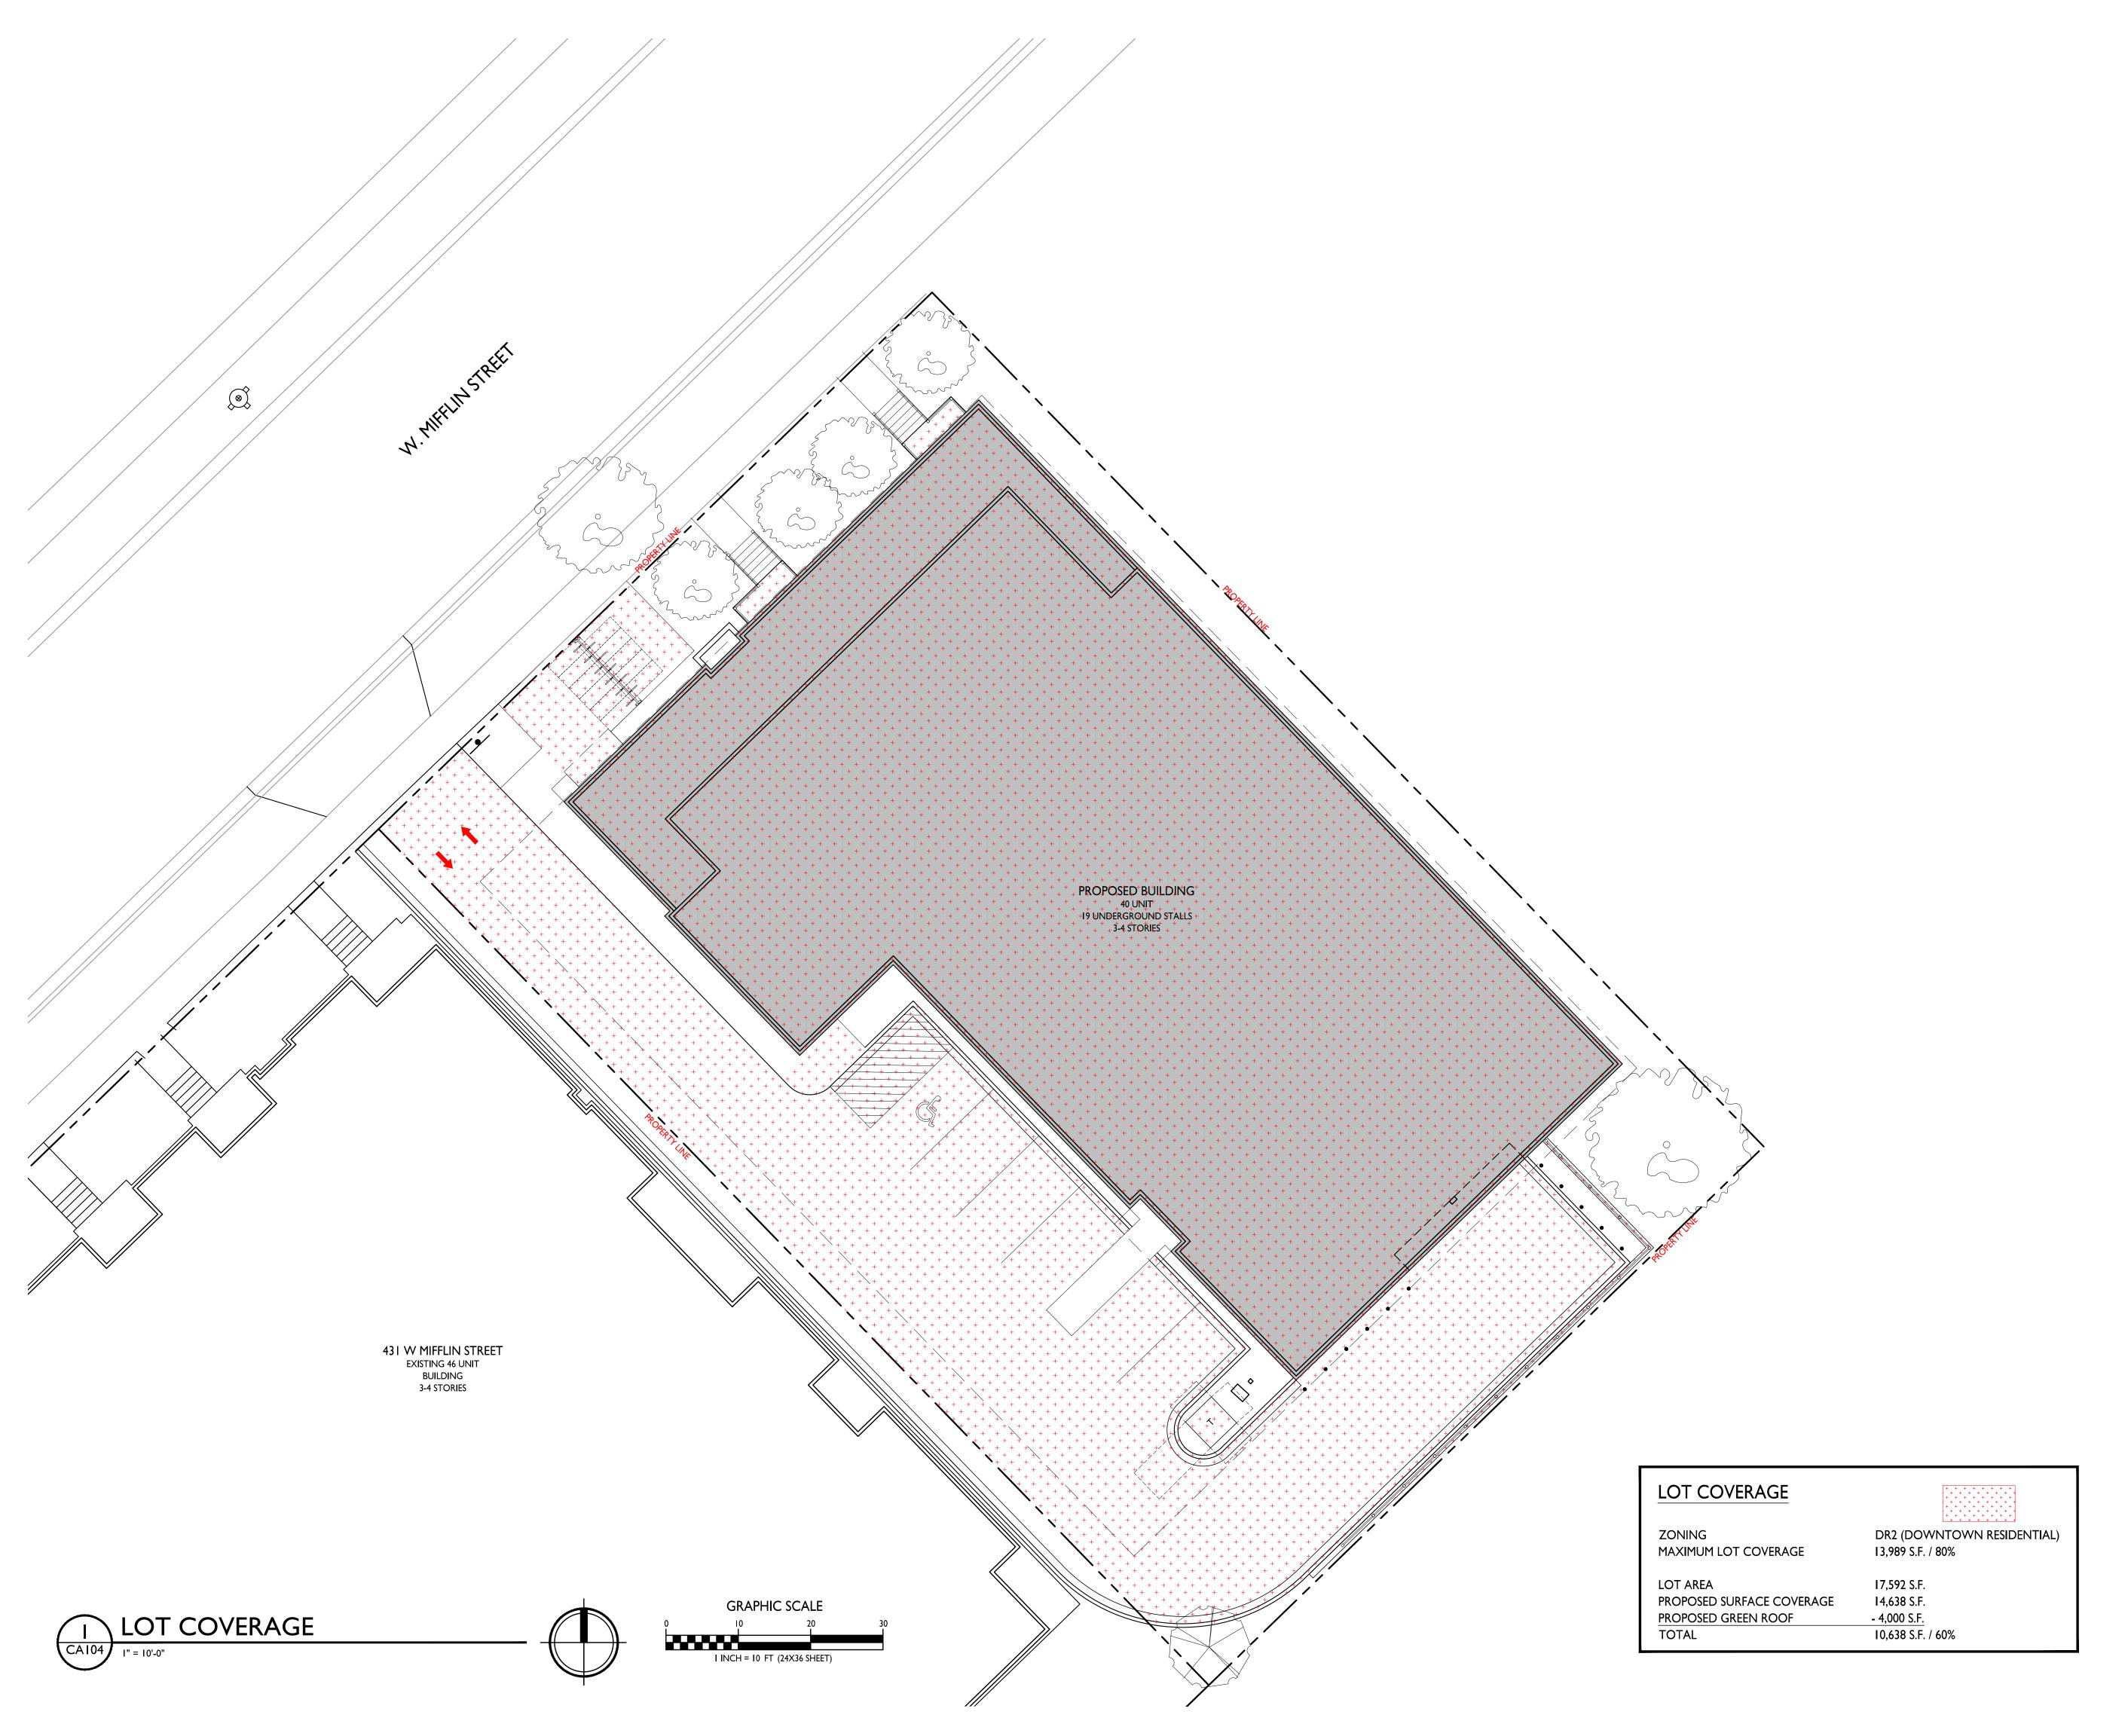



Issued for Land Use Submittal - September 23, 2024

PROJECT TITLE THE KRONENBERG

423-427 W. Mifflin Street, Madison, WI


SHEET TITLE


Lot Coverage

SHEET NUMBER

CAI04

PROJECT NO.

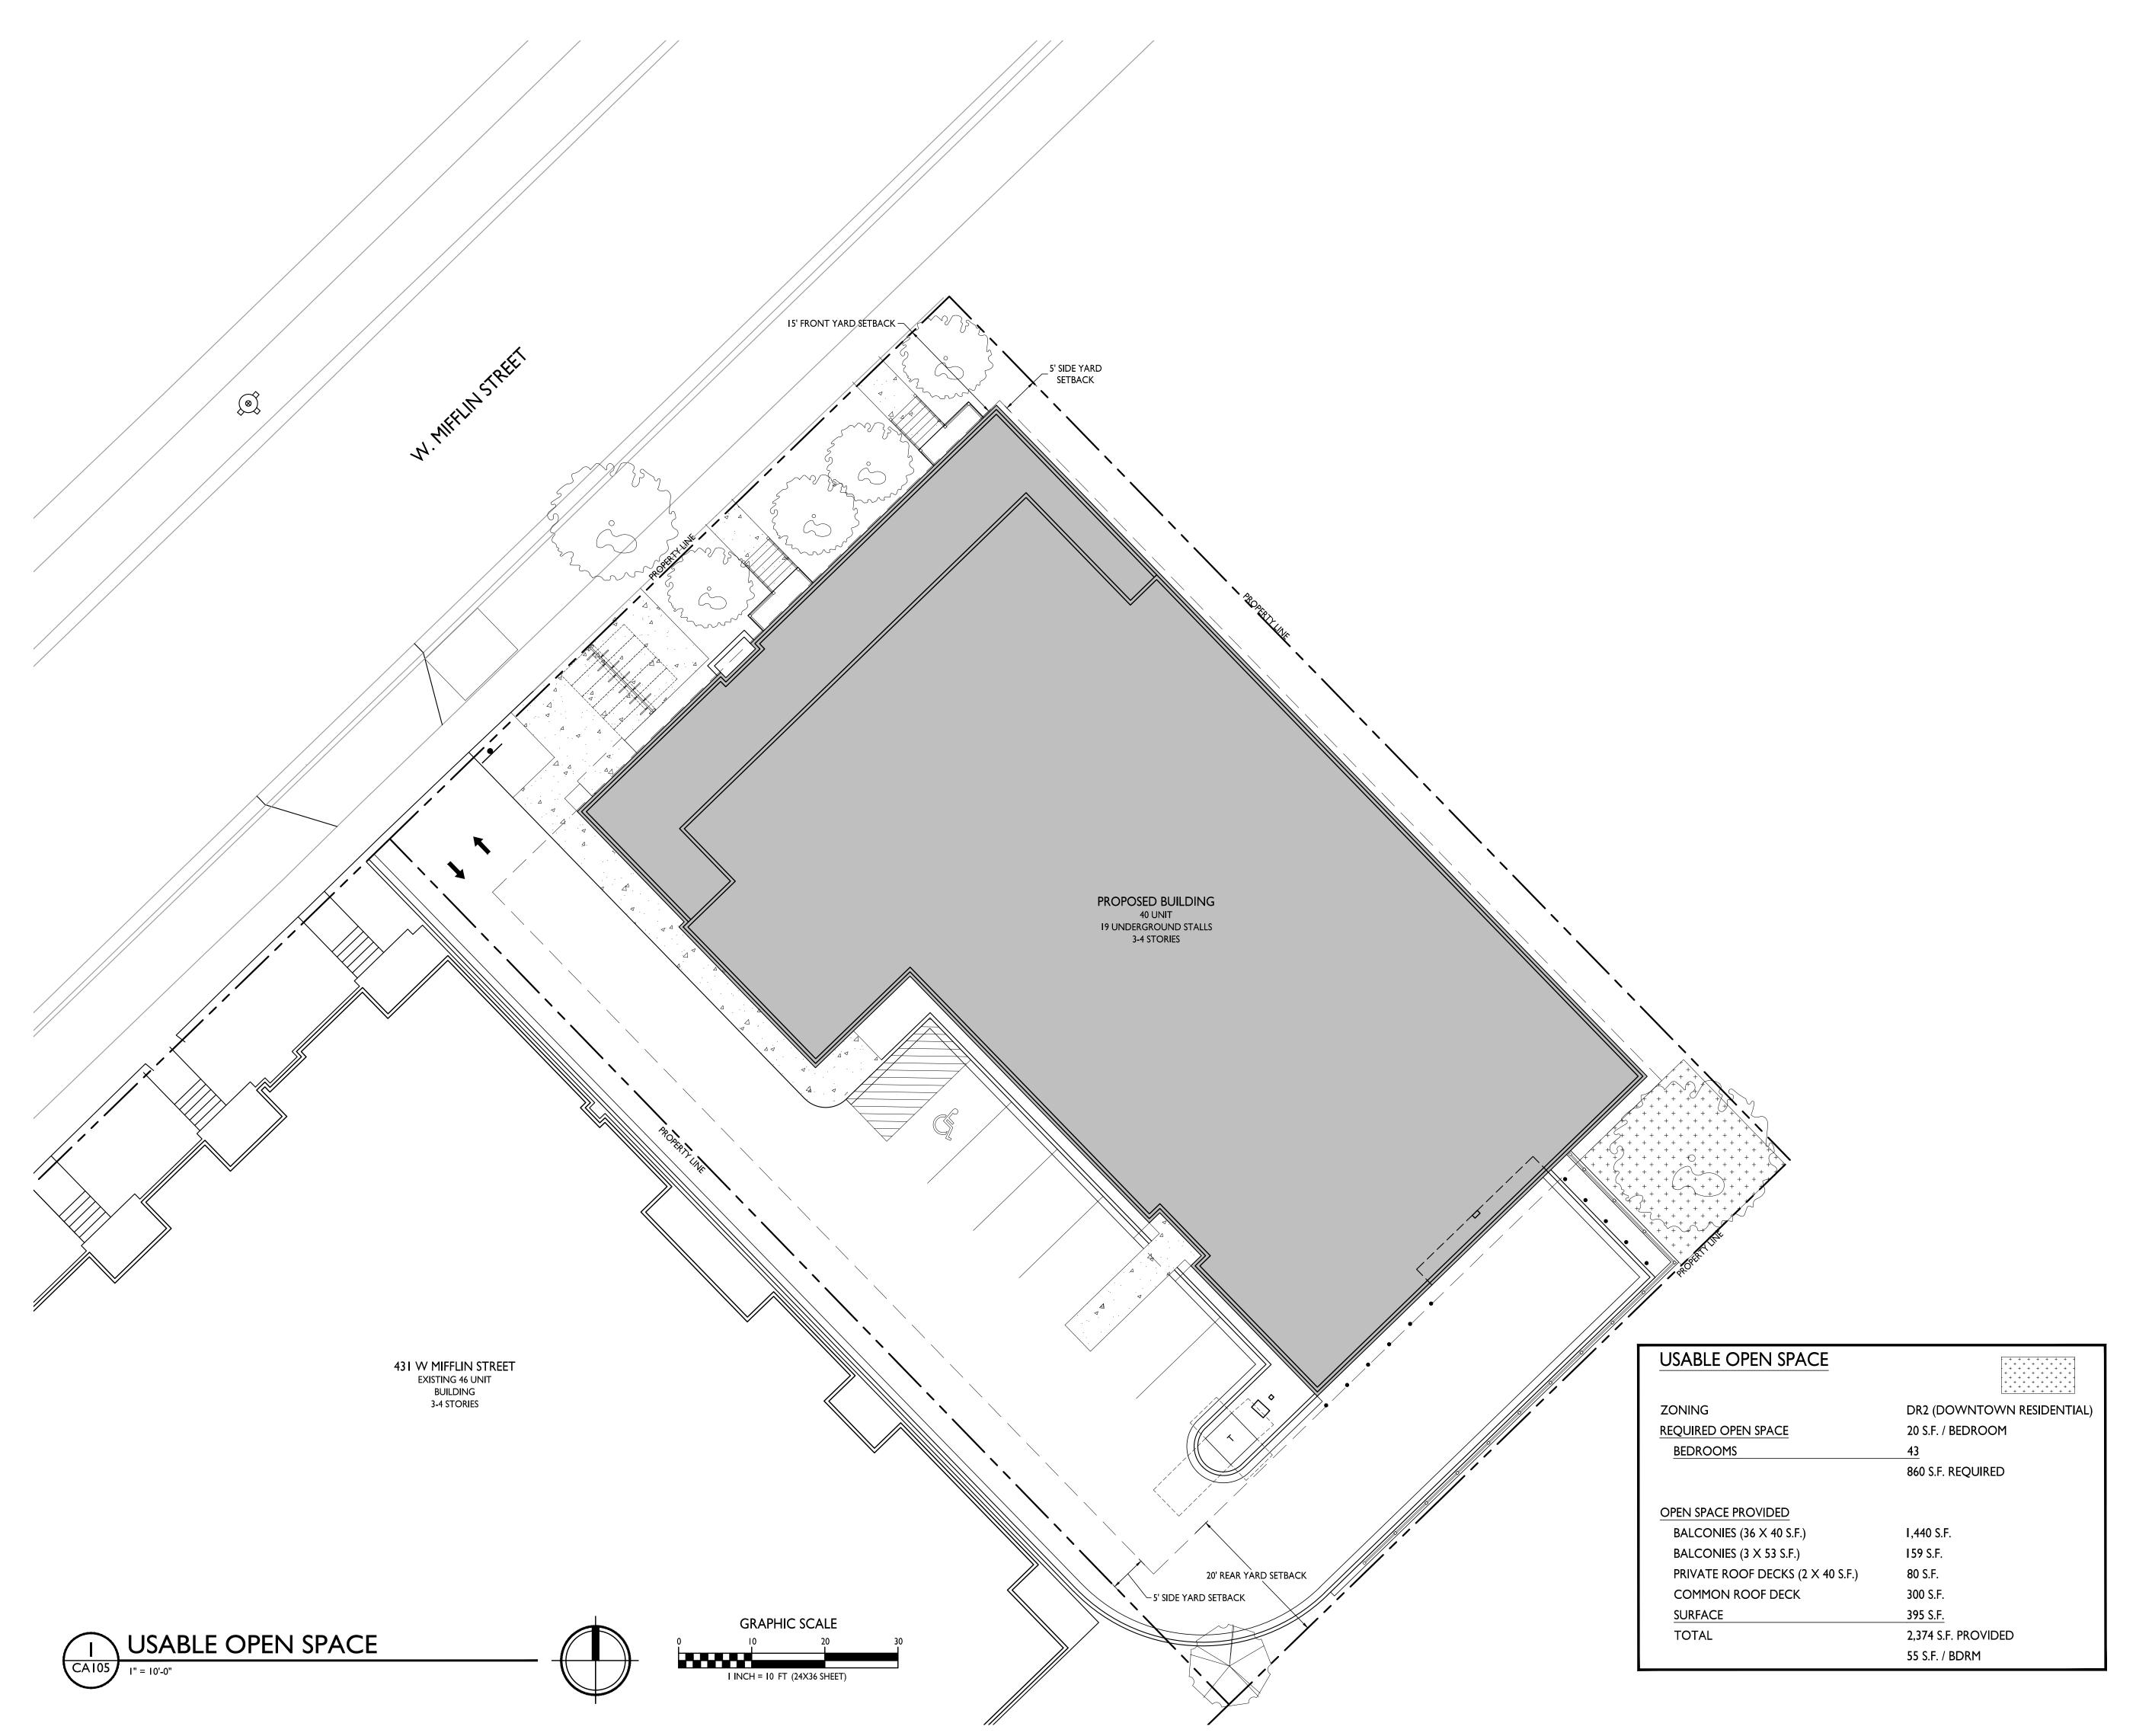

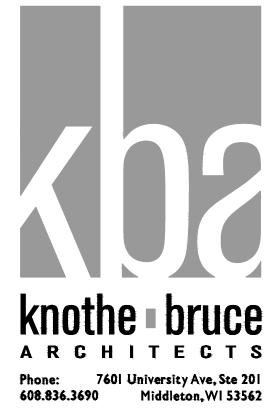

ISSUED
Issued for Land Use Submittal - September 23, 2024

PROJECT TITLE
THE
KRONENBERG


423-427 W. Mifflin Street,
Madison, WI

SHEET TITLE
Usable Open
Space

SHEET NUMBER

**CA105** 

PROJECT NO. 2253
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#### PLANT LIST 423-427 W. Mifflin Street, Madison, Wi

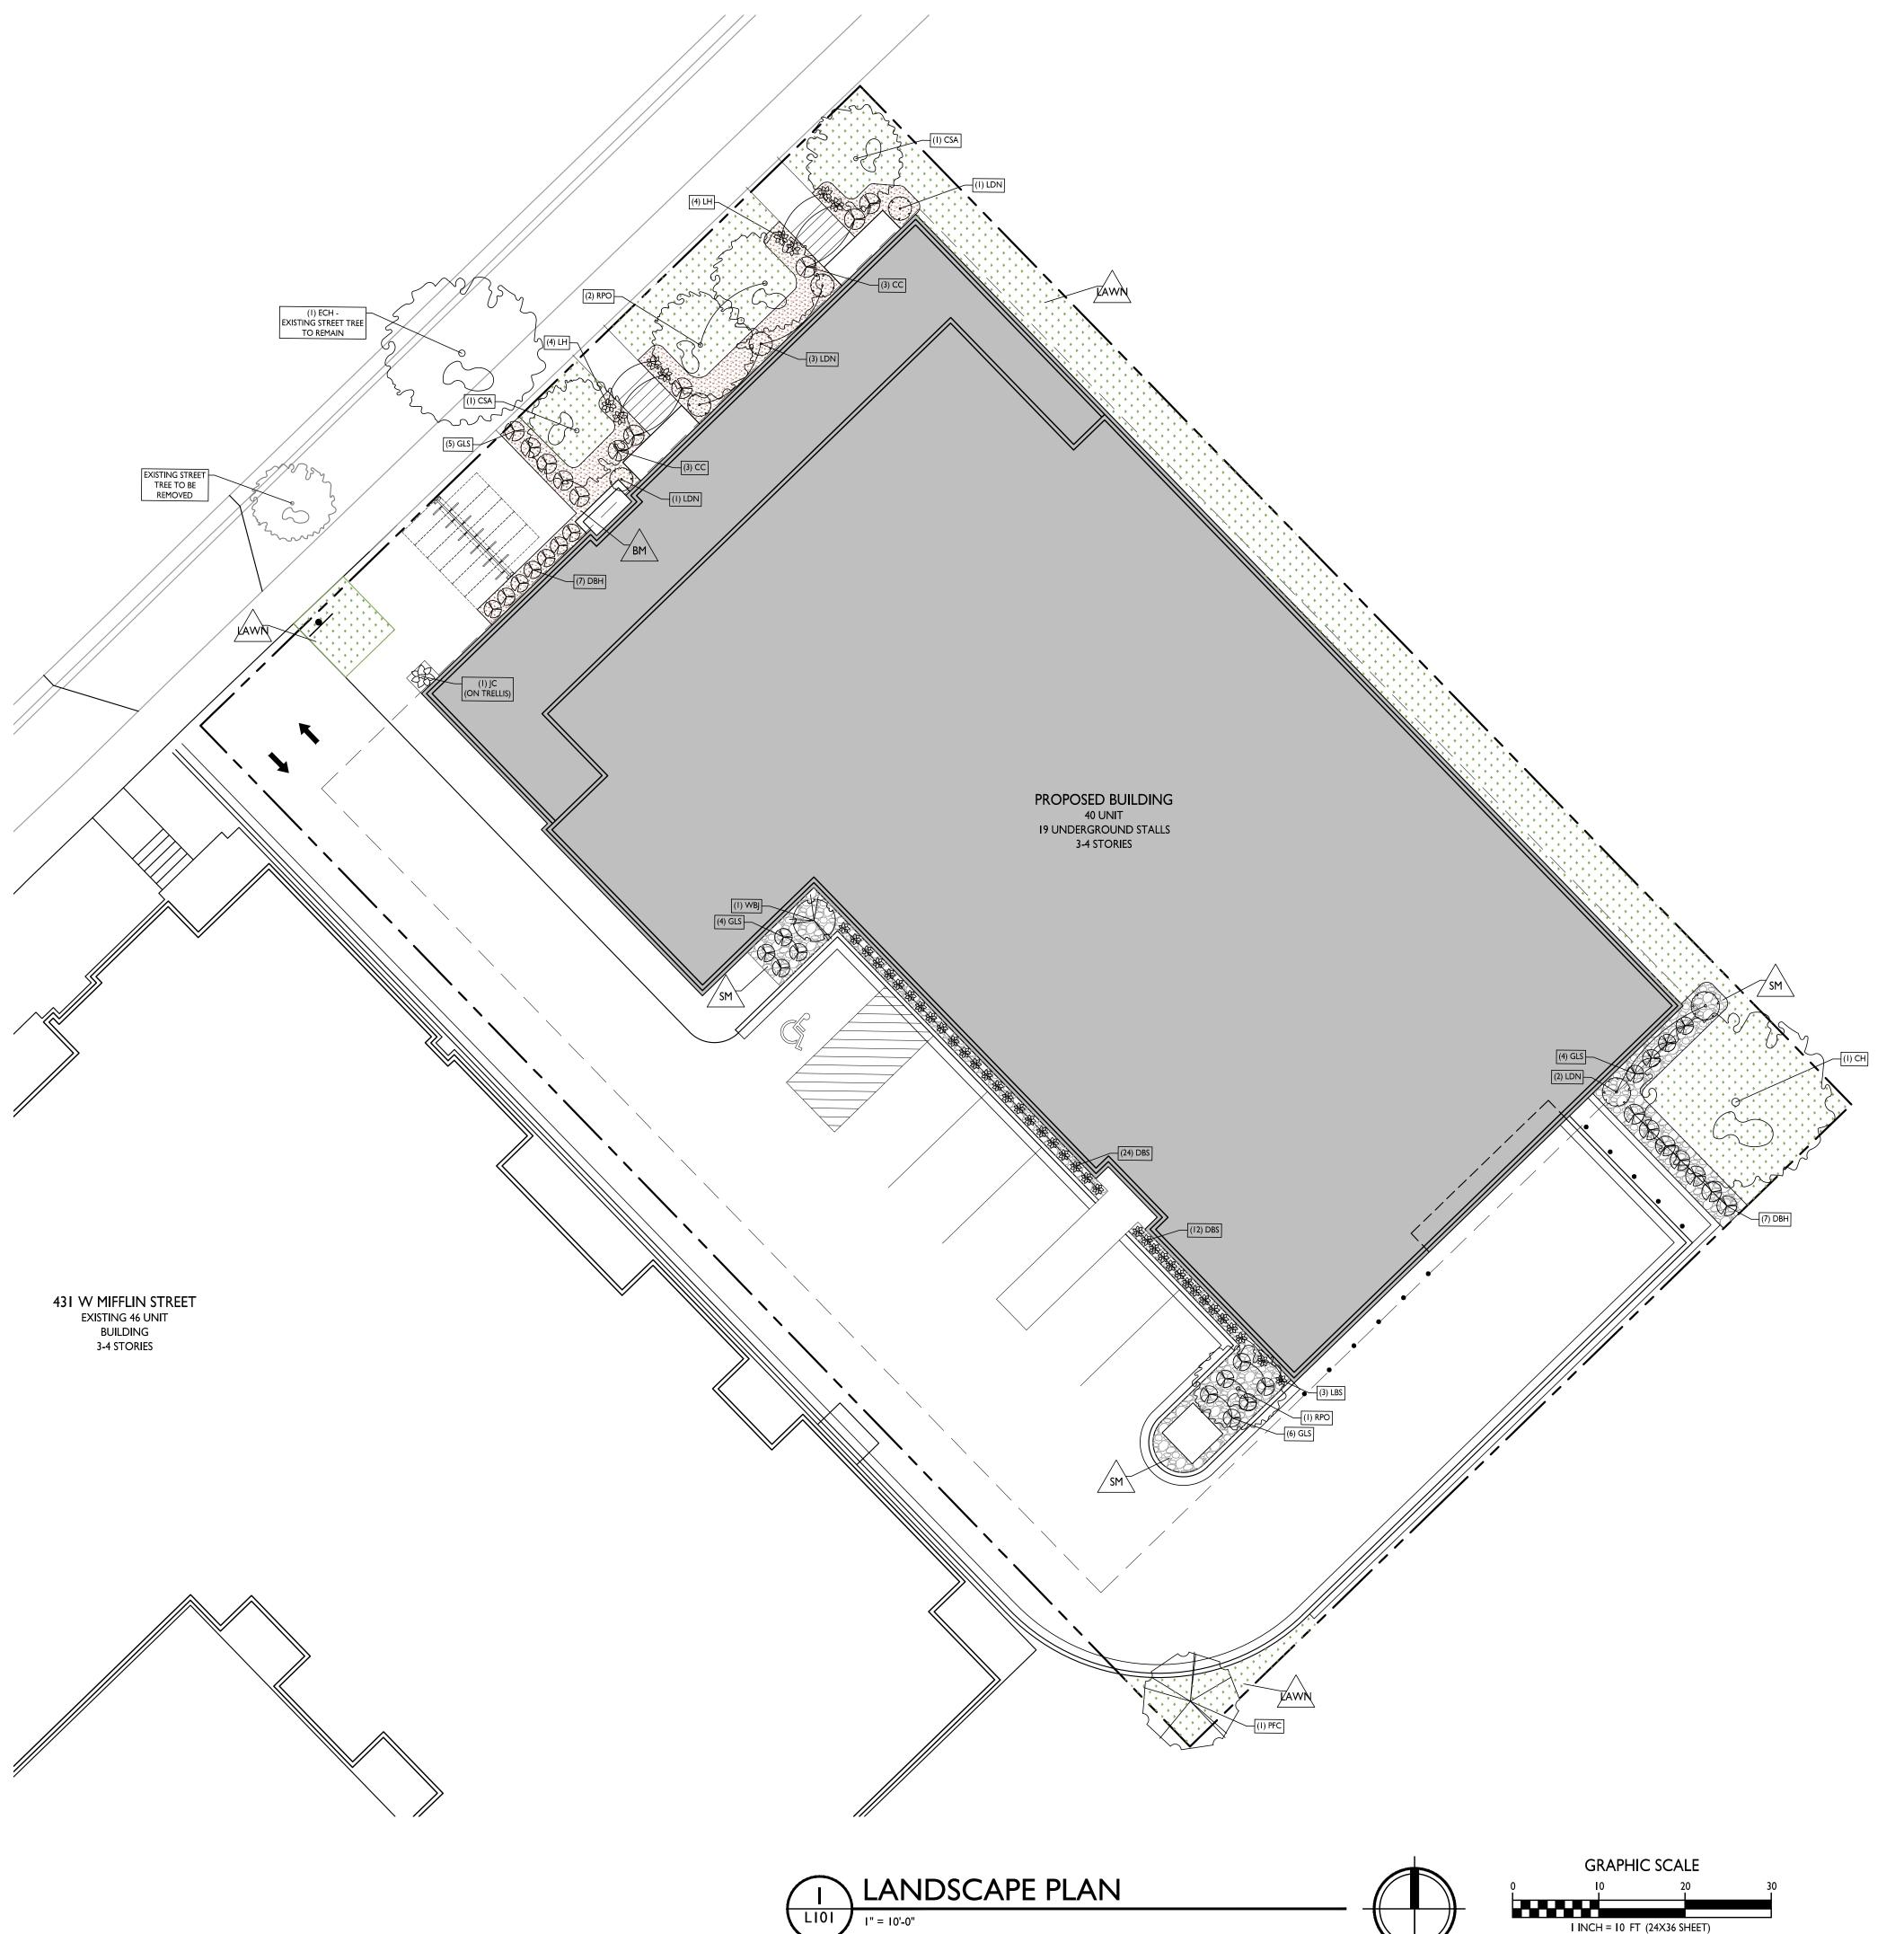KEY	SIZE	QUAN	Common Name	Botanical Name	ROOT
CH CSA ECH RPO	2 ½" 2 ½" 6" 2 ½"	(7) 1 2 1 3	Canopy Trees Common Hackberry Columnar Swedish Aspen Existing Common Hackberry Pyramidal English Oak	Celtis Occidentalis Populus Tremula 'Erecta' Celtis Occidentalis Quercus Robar "Fastigiata'	BB BB EX* BB
PFC	2"	<b>(1)</b> 1	<u>Ornamental Trees</u> Prairie Fire Crab	Malus 'Prairie Fire'	ВВ
CC DBH GLS LDN LQFH	18" 24" 18" 24" 24"	(37) 6 14 9 7	Deciduous Shrubs Cranberry Cotoneaster Dwarf Bush Honeysuckle Gro Low Sumac Little Devil Ninebark Little Quick Fire Hydrangea	Coloneaster Apiculatus Diervilla Lonicera Rhus Aromatica Physocarpus O 'Donna May' Hydrangea Paniculata	Pot Pot Pot Pot
RC WBJ	18" 5'	<b>(5)</b> 4 1	<u>Evergreen Shrubs</u> Russian Cyprus Wichita Blue Juniper	Microbiota Decussata Juniperus Scopulorum	Con BB
JC LBS LH DBS	2 G 1 G 1 G 1 G	(48) 1 3 8 36	Perennials Jackman's Clematis Little Bluestem Grass Loyalist Hosta Dragon's Blood Sedum	Clematis 'Jackmanii' Schizachyrium Scoparium Hosta 'Loyalist' Sedum S 'Dragon's Blood'	Con Con Con Con
NOTES	S:				

- Lawn areas to receive a minimum of 4" of topsoil, premium bluegrass seed mix, start fertilizer, and straw mat mulch.
- 2) Planting beds designated as 'bark mulch' to receive shredded hardwood bark spread to depth of 3".3) Individual trees and shrub groupings in lawn areas to receive shredded hardwood bark
- mulch to a depth of 3".4) Planting beds designated as 'stone mulch' to receive #2 washed stone spread to a depth of 3" over weed barrier fabric.
- 5) Designated planting beds to be separated from lawn areas with 5" black vinyl bed edging.
   6) \* Denotes street tree planted on public property (terrace).

#### <u>LANDSCAPE WORKSHEET</u> 423-427 W. Mifflin Street, Madison, WI

## Landscape Points Required:

<u> </u>	
Developed Area = Landscape Points: 8,576 SF / 300 X 5 =	8,576 SF <b>143 points</b>
Total Landscape Points Required:	143 points
Landscape Points Supplied:	
Existing canopy trees – 0 @ 35 = Proposed canopy trees – 6 @ 35 = Existing evergreen trees – 0 @ 35 = Proposed evergreen trees – 0 @ 35 = Existing ornamental trees – 0 @ 15 = Proposed ornamental trees – 1 @ 15 = Existing upright evergreen shrubs – 0 @ 10 = Proposed upright evergreen shrubs – 1 @ 10 = Existing deciduous shrubs – 0 @ 3 = Proposed deciduous shrubs – 37 @ 3 = Existing evergreen shrubs – 0 @ 4 = Proposed evergreen shrubs – 4 @ 4 = Existing perennials & grasses 0 @ 2 = Proposed perennials & grasses 48 @ 2 =  Total Landscape Points Supplied =	0 points 210 points 0 points 0 points 0 points 15 points 10 points 10 points 10 points 111 points 0 points 16 points 16 points 96 points
Lot Frontage Landscape Required:	

#### <u>Lot Frontage Landscape Required</u>: (Section 28.142(5) Development Frontage Landscaping)

"One (1) over-story deciduous tree and five (5) shrubs shall be planted for each thirty (30) lineal feet of lot frontage. Two (2) ornamental trees or two (2) evergreen trees may be used in place of one (1) over-story deciduous tree."

# W. Mifflin Street = Over story trees required 259:

Over stand trace required 250,00/201 -9,66	A troo
Over story trees required 259.99/30' =8.66 Shrubs required (259.99'/30') x 5 = 43.33	<u>4 tree</u> 18 shrub
Over story trees supplied Ornamental/Evergreen trees supplied Shrubs supplied	<u>6 tree</u> <u>1 tre</u> 42 shrub

#### GENERAL NOTES:

I. ALL PROPOSED STREET TREE REMOVALS
WITHIN THE RIGHT OF WAY SHALL BE REVIEWED BY
CITY FORESTRY BEFORE THE PLAN COMMISSION
MEETING. STREET TREE REMOVALS REQUIRE
APPROVAL AND A TREE REMOVAL PERMIT ISSUED BY
CITY FORESTRY. ANY STREET TREE REMOVALS
REQUESTED AFTER THE DEVELOPMENT PLAN IS
APPROVED BY THE PLAN COMMISSION OR THE
BOARD OF PUBLIC WORKS AND CITY FORESTRY WILL
REQUIRE A MINIMUM OF A 72-HOUR REVIEW PERIOD
WHICH SHALL INCLUDE THE NOTIFICATION OF THE
ALDERPERSON WITHIN WHO'S DISTRICT IS AFFECTED
BY THE STREET TREE REMOVAL(S) PRIOR TO A TREE
REMOVAL PERMIT BEING ISSUED.

2. AS DEFINED BY THE SECTION 107.13 OF CITY OF MADISON STANDARD SPECIFICATIONS FOR PUBLIC WORKS CONSTRUCTION: NO EXCAVATION IS PERMITTED WITHIN 5 FEET OF THE TRUNK OF THE STREET TREE OR WHEN CUTTING ROOTS OVER 3 INCHES IN DIAMETER. IF EXCAVATION IS NECESSARY, THE CONTRACTOR SHALL CONTACT MADISON CITY FORESTRY (266-4816) PRIOR TO EXCAVATION. CITY OF MADISON FORESTRY PERSONNEL SHALL ASSESS THE IMPACT TO THE TREE AND TO ITS ROOT SYSTEM PRIOR TO WORK COMMENCING. TREE PROTECTION SPECIFICATIONS CAN BE FOUND ON THE FOLLOWING WEBSITE:

CITYOFMADISON.COM/BUSINESS/PW/SPECS.CFM

3. CONTRACTOR SHALL TAKE PRECAUTIONS DURING CONSTRUCTION TO NOT DISFIGURE, SCAR, OR IMPAIR THE HEALTH OF ANY STREET TREE. CONTRACTOR SHALL OPERATE EQUIPMENT IN A MANNER AS TO NOT DAMAGE THE BRANCHES OF THE STREET TREE(S). THIS MAY REQUIRE USING SMALLER EQUIPMENT AND LOADING AND UNLOADING MATERIALS IN A DESIGNATED SPACE AWAY FROM TREES ON THE CONSTRUCTION SITE. ANY DAMAGE OR INJURY TO EXISTING STREET TREES (EITHER ABOVE OR BELOW GROUND) SHALL BE REPORTED IMMEDIATELY TO CITY FORESTRY AT 266-4816. PENALTIES AND REMEDIATION SHALL BE REQUIRED.

4. SECTION 107.13(G) OF CITY OF MADISON STANDARD SPECIFICATIONS FOR PUBLIC WORKS CONSTRUCTION (WEBSITE:

CITYOFMADISON.COM/BUSINESS/PW/SPECS.CFM )
ADDRESSES SOIL COMPACTION NEAR STREET TREES
AND SHALL BE FOLLOWED BY CONTRACTOR. THE
STORAGE OF PARKED VEHICLES, CONSTRUCTION
EQUIPMENT, BUILDING MATERIALS, REFUSE,
EXCAVATED SPOILS OR DUMPING OF POISONOUS
MATERIALS ON OR AROUND TREES AND ROOTS
WITHIN FIVE (5) FEET OF THE TREE OR WITHIN THE
PROTECTION ZONE IS PROHIBITED.

5. ON THIS PROJECT, STREET TREE PROTECTION ZONE FENCING IS REQUIRED. THE FENCING SHALL BE ERECTED BEFORE THE DEMOLITION, GRADING OR CONSTRUCTION BEGINS. THE FENCE SHALL INCLUDE THE ENTIRE WIDTH OF TERRACE AND, EXTEND AT LEAST 5 FEET ON BOTH SIDES OF THE OUTSIDE EDGE OF THE TREE TRUNK. DO NOT REMOVE THE FENCING TO ALLOW FOR DELIVERIES OR EQUIPMENT ACCESS THROUGH THE TREE PROTECTION ZONE.

6. STREET TREE PRUNING SHALL BE COORDINATED WITH MADISON FORESTRY AT A MINIMUM OF TWO WEEKS PRIOR TO THE START OF CONSTRUCTION FOR THIS PROJECT. ALL PRUNING SHALL FOLLOW THE AMERICAN NATIONAL STANDARDS INSTITUTE (ANSI) A300 - PART I STANDARDS FOR PRUNING.

7. AT LEAST ONE WEEK PRIOR TO STREET TREE PLANTING, CONTRACTOR SHALL CONTACT CITY FORESTRY AT (608) 266-4816 TO SCHEDULE INSPECTION AND APPROVAL OF NURSERY TREE STOCK AND REVIEW PLANTING SPECIFICATIONS WITH THE LANDSCAPER.

8. APPROVAL OF PLANS FOR THIS PROJECT DOES NOT INCLUDE ANY APPROVAL TO PRUNE, REMOVE, OR PLANT TREES IN THE PUBLIC RIGHT-OF-WAY. PERMISSION FOR SUCH ACTIVITIES MUST BE OBTAINED FROM THE CITY FORESTER (266-4816).

9. THE PUBLIC RIGHT-OF-WAY IS THE SOLE JURISDICTION OF THE CITY OF MADISON AND IS SUBJECT TO CHANGE AT ANY TIME PER THE RECOMMENDATION/PLAN OF THE TRAFFIC ENGINEERING AND CITY ENGINEERING DIVISIONS. NO ITEMS SHOWN ON THIS SITE PLAN IN THE RIGHT-OF-WAY ARE PERMANENT AND MAY NEED TO BE REMOVED AT THE APPLICANTS EXPENSE UPON NOTIFICATION BY THE CITY.





ISSUED 2024-09-18 Markup - Denise 2024-09-23 Land Use & UDC Submittal


PROJECT TITLE
THE
KRONENBERG

423-427 W. Mifflin Street,
Madison, WI
SHEET TITLE
Landscape Plan


SHEET NUMBER

LIOI

PROJECT NO.

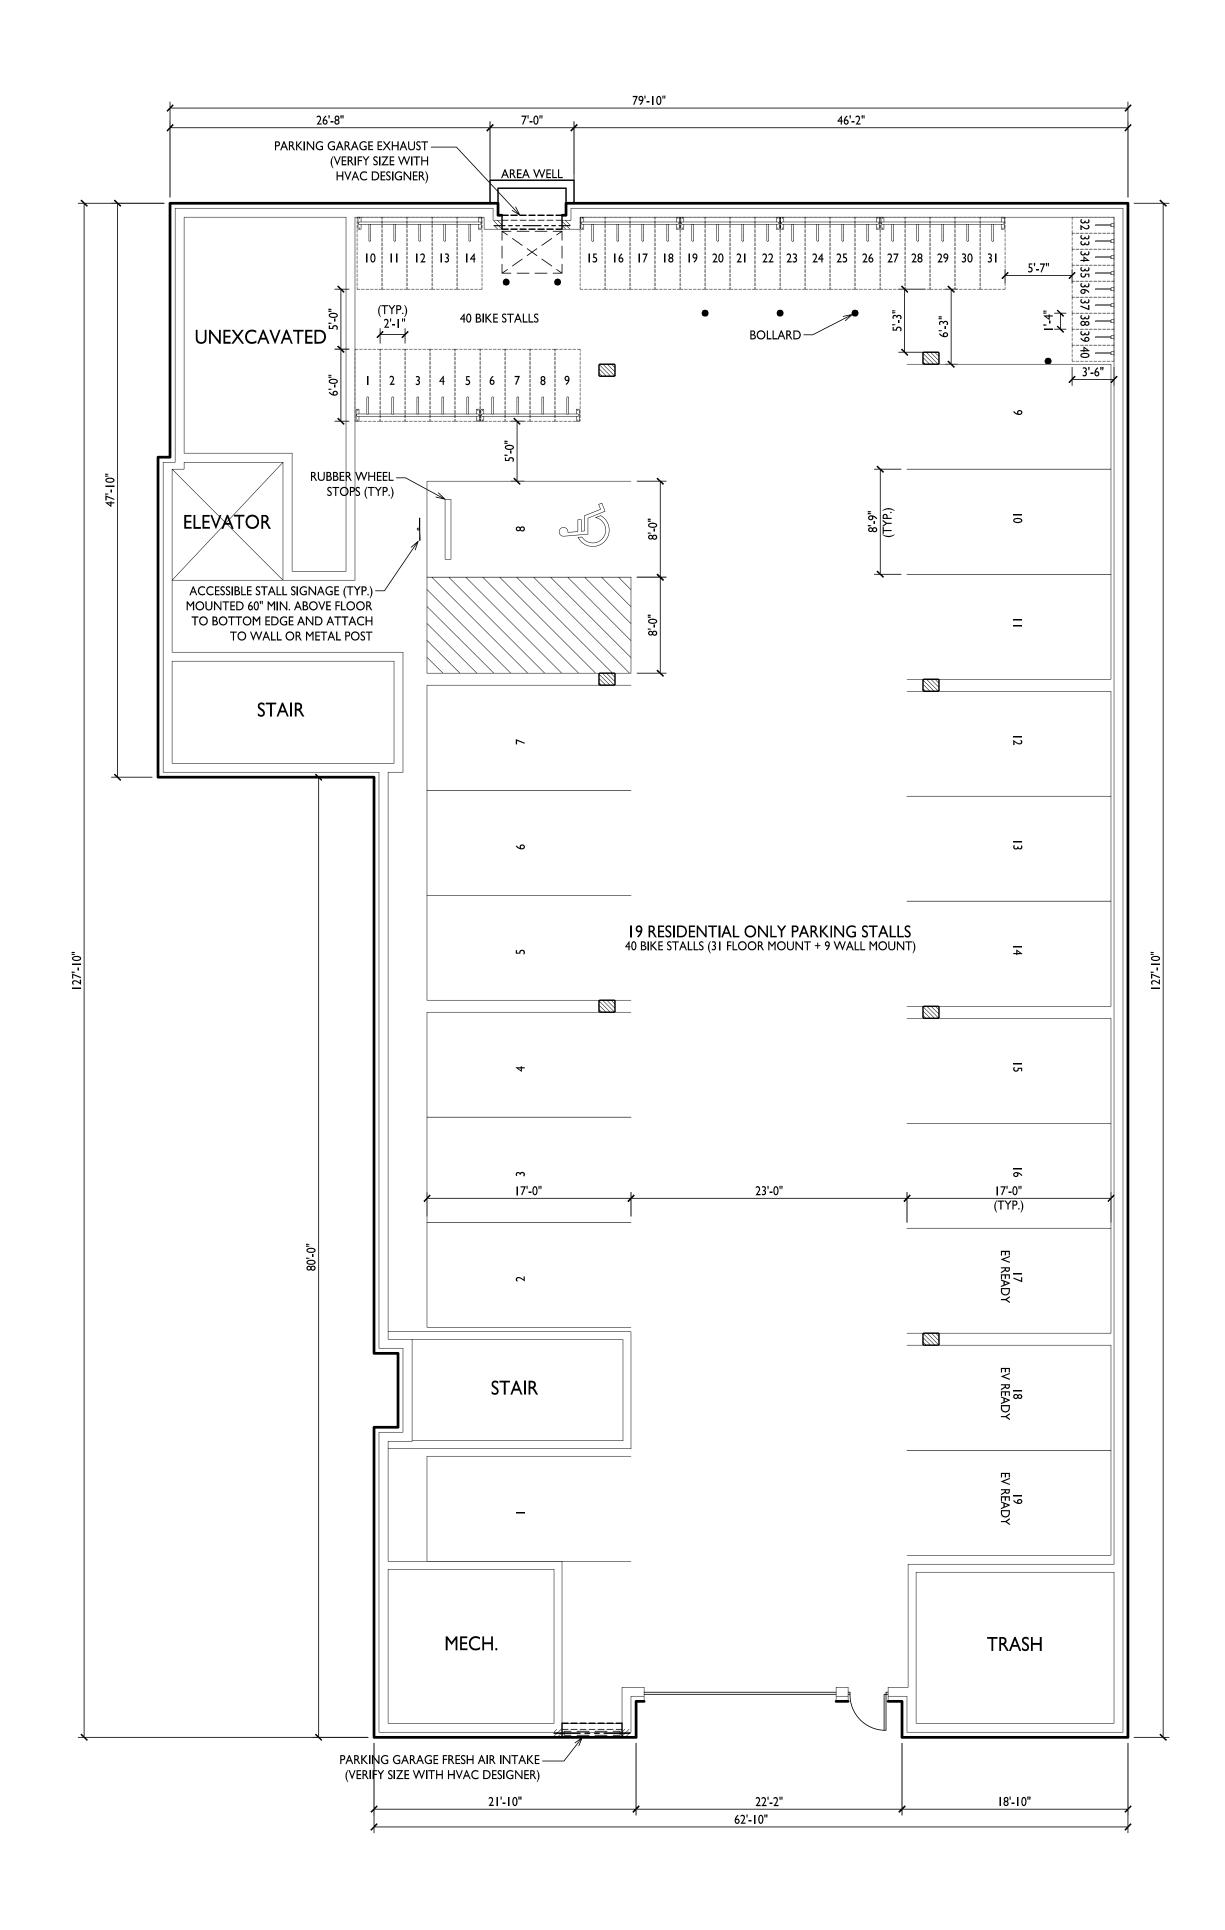



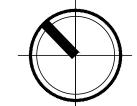



**ISSUED** Issued for Review - June 17, 2024 Issued for Review - September 23, 2024

PROJECT TITLE THE KRONENBERG


423-427 W. Mifflin Street, Madison, WI
SHEET TITLE Basement Floor

SHEET NUMBER

Plan

ACI00

PROJECT NO.

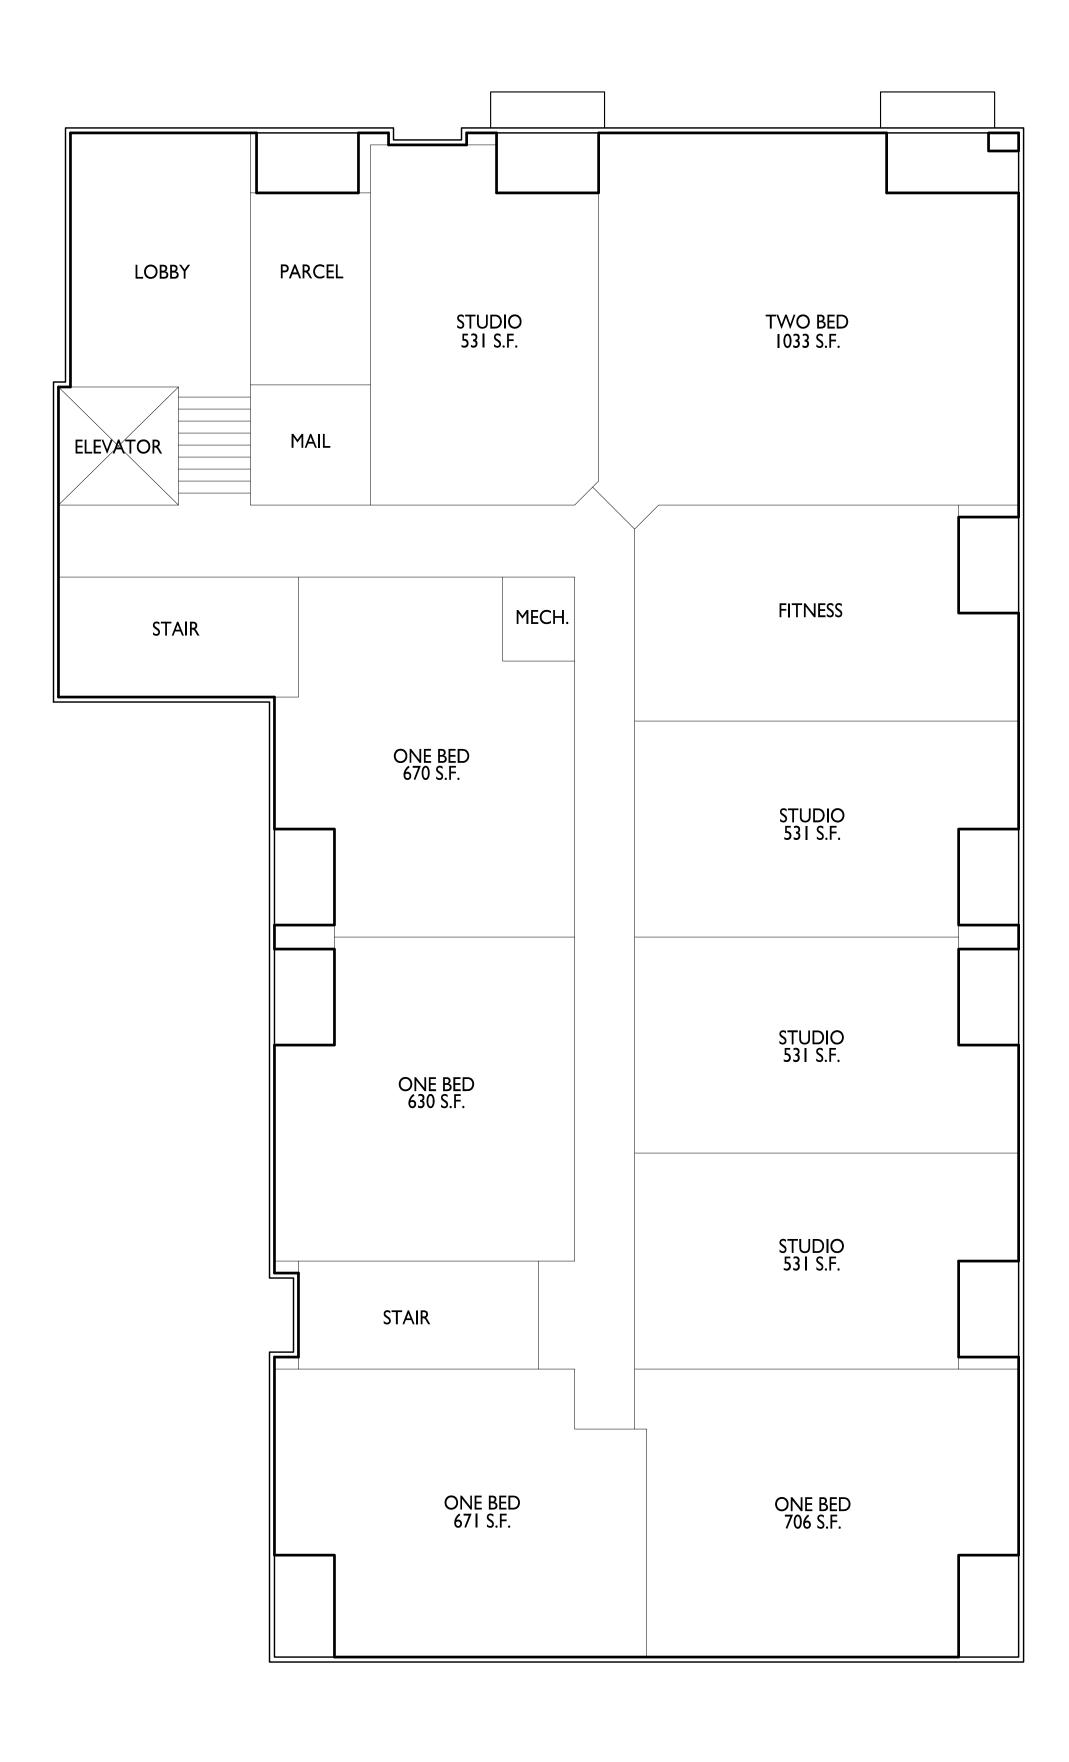



ISSUED

Issued for Review - June 17, 2024
Issued for Review - September 23, 2024

PROJECT TITLE
THE
KRONENBERG

423-427 W. Mifflin Street, Madison, WI

First Floor Plan

SHEET NUMBER


ACI0I

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2253

PROJECT NO.





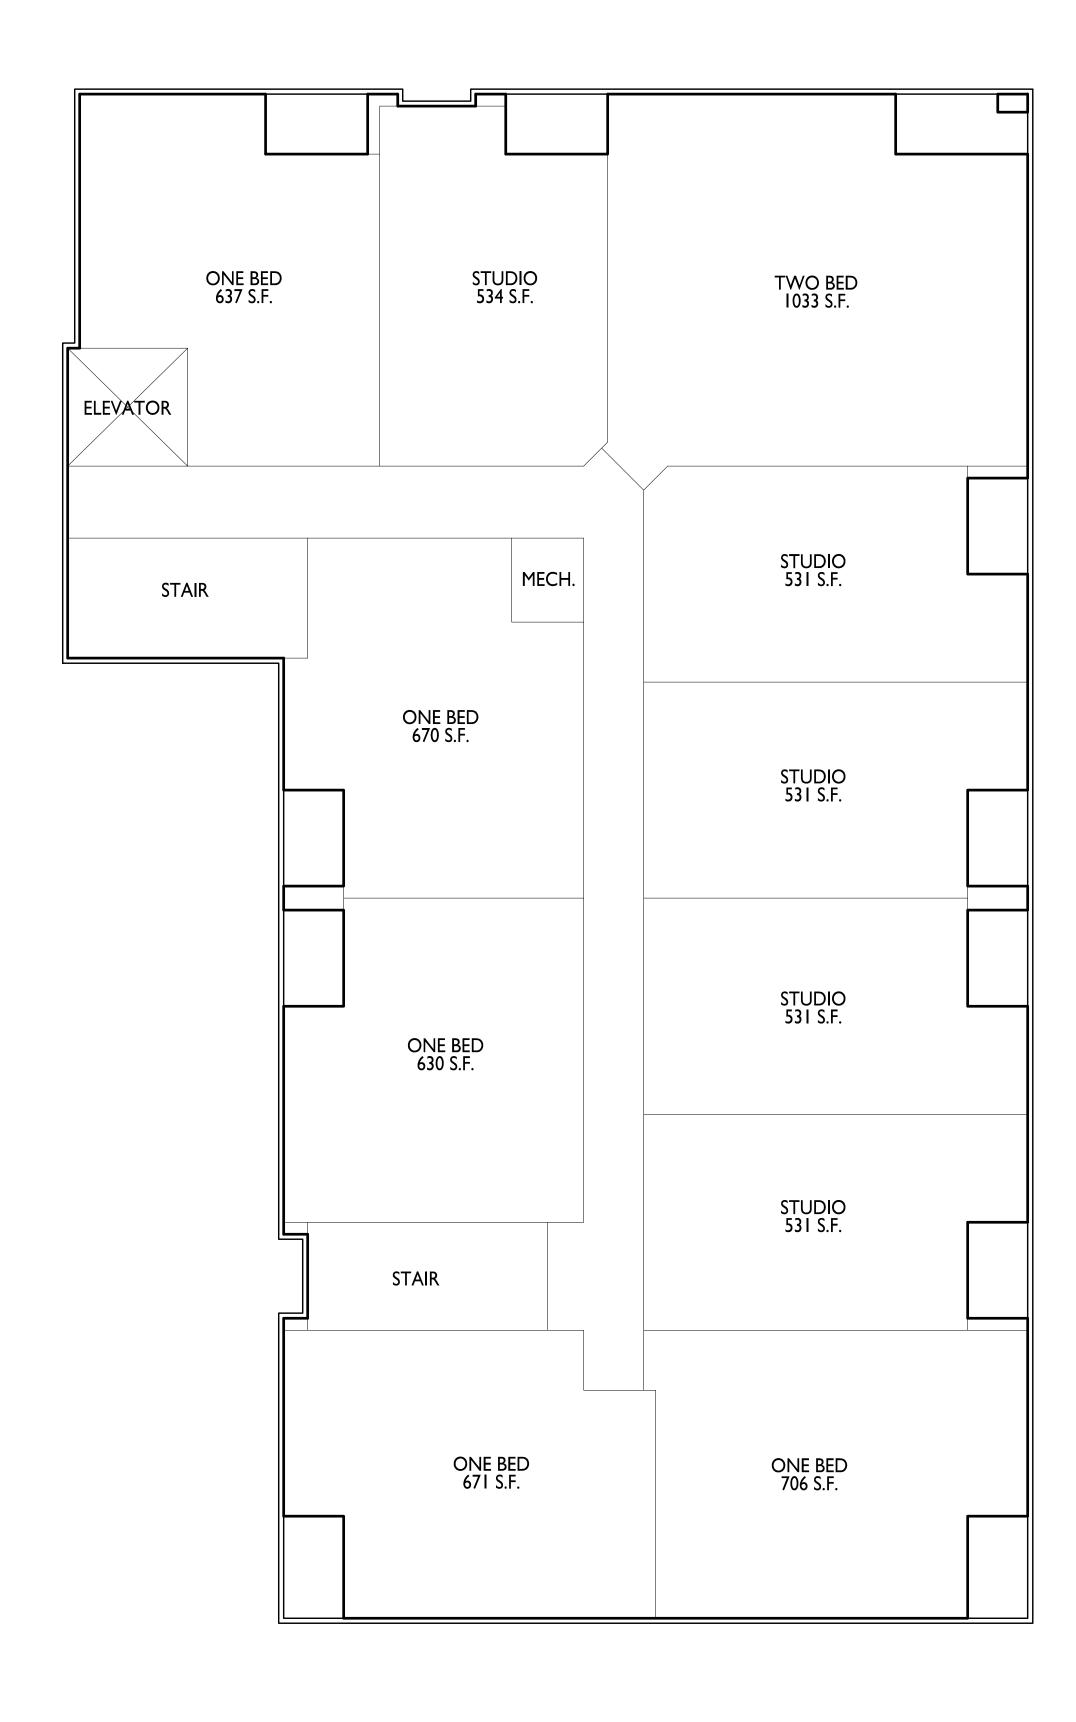

ISSUED

Issued for Review - June 17, 2024 Issued for Review - September 23, 2024

PROJECT TITLE THE KRONENBERG

423-427 W. Mifflin Street, Madison, WI
SHEET TITLE

Second Floor Plan


SHEET NUMBER

ACI02

PROJECT NO.





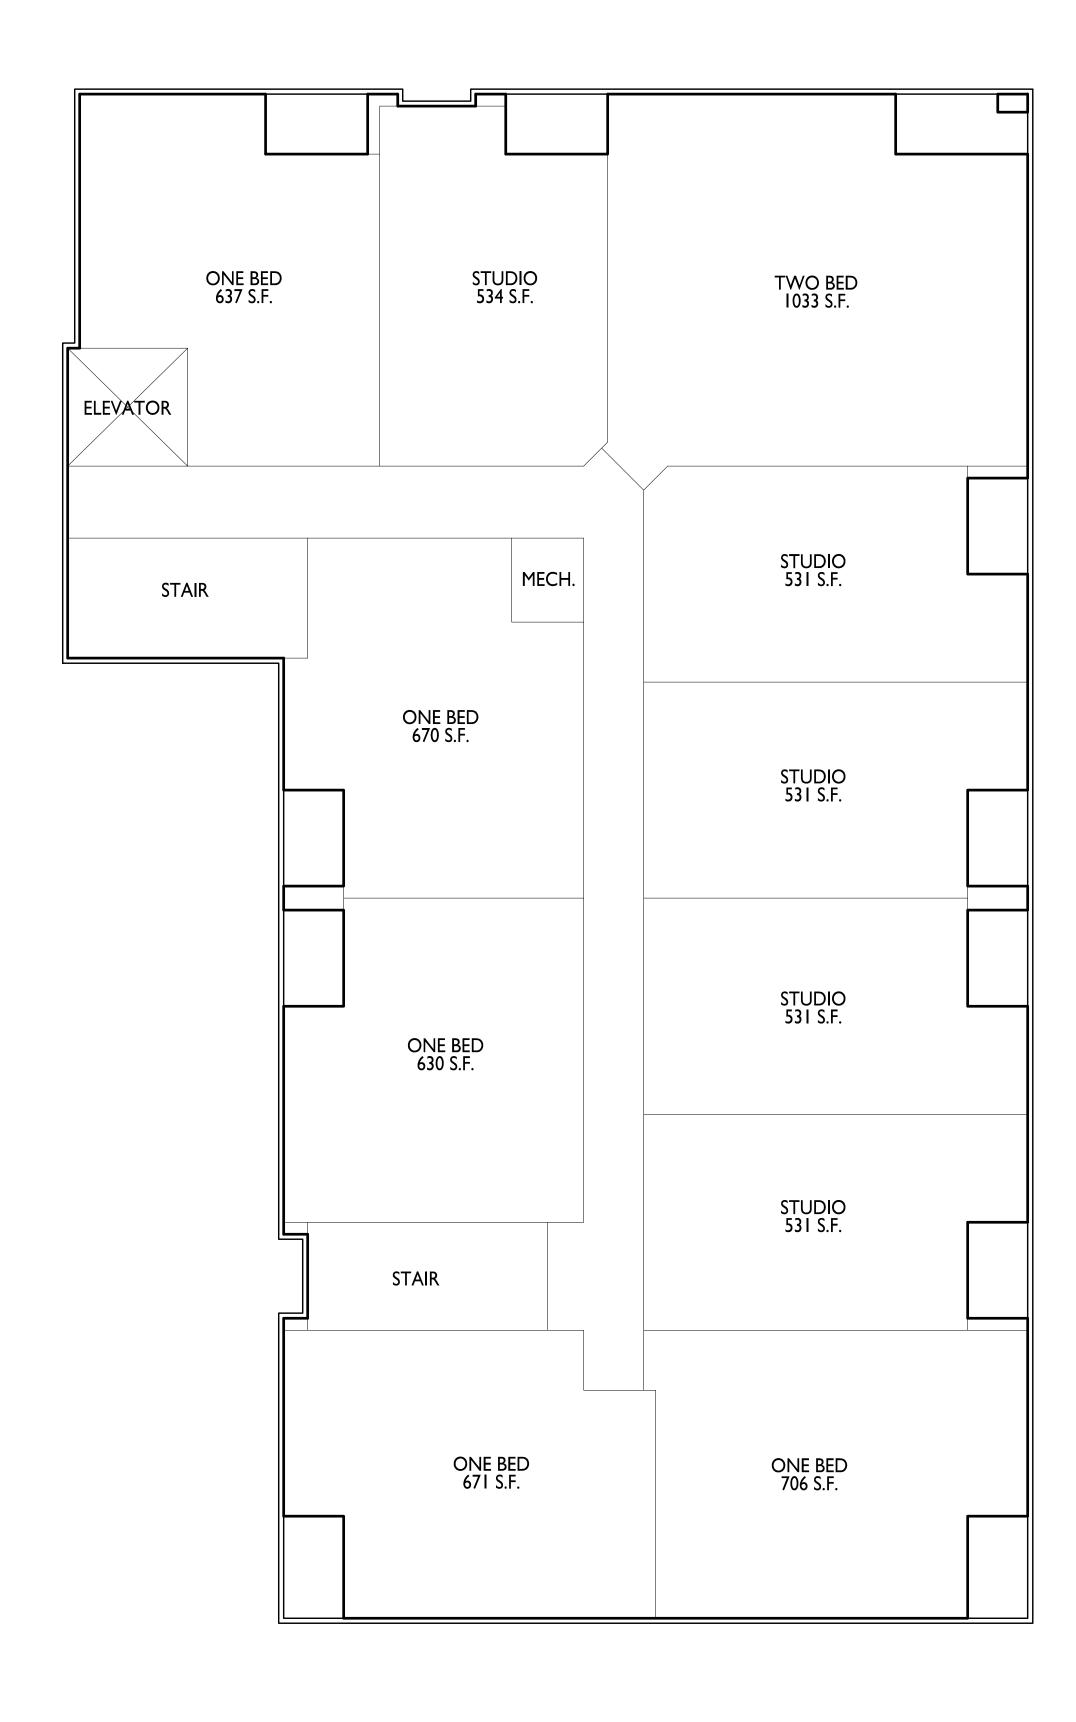



Issued for Review - June 17, 2024 Issued for Review - September 23, 2024

PROJECT TITLE
THE KRONENBERG

423-427 W. Mifflin Street, Madison, WI
SHEET TITLE

Third Floor Plan


SHEET NUMBER

ACI03

PROJECT NO.





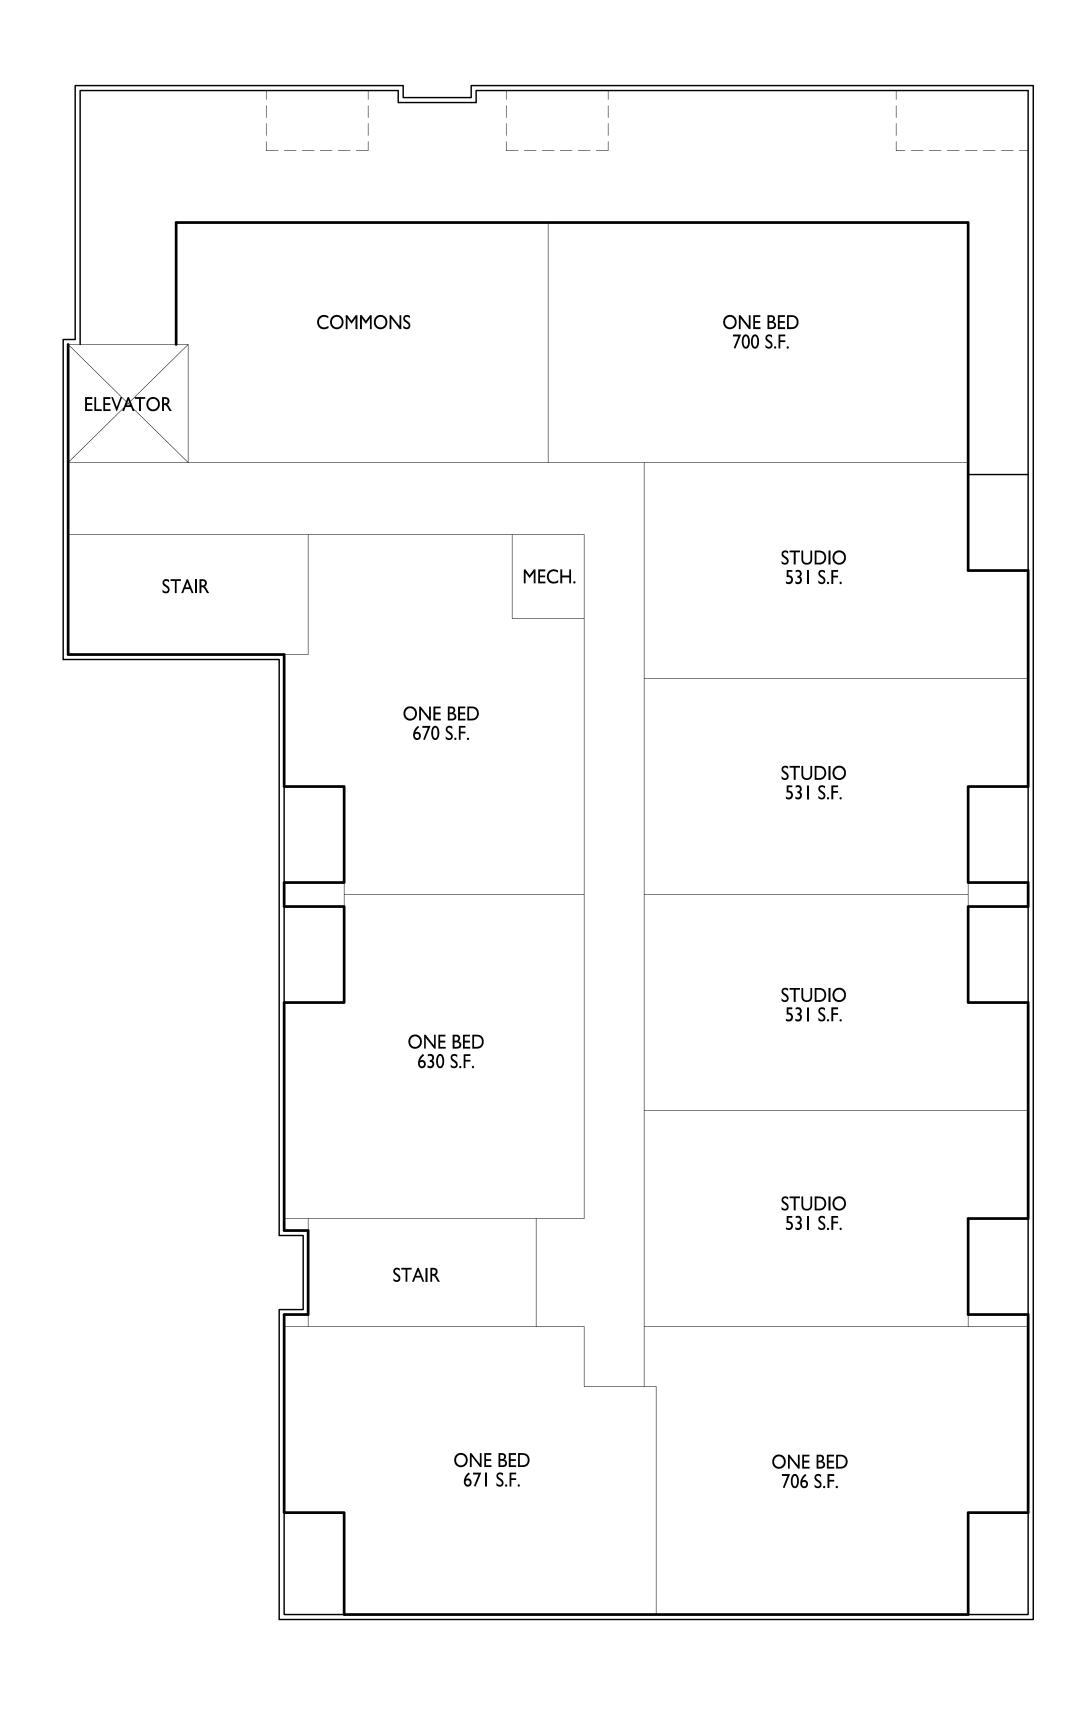



Issued for Review - June 17, 2024 Issued for Review - September 23, 2024

PROJECT TITLE KRONENBERG

423-427 W. Mifflin Street, Madison, WI
SHEET TITLE

Fourth Floor Plan

SHEET NUMBER

ACI04

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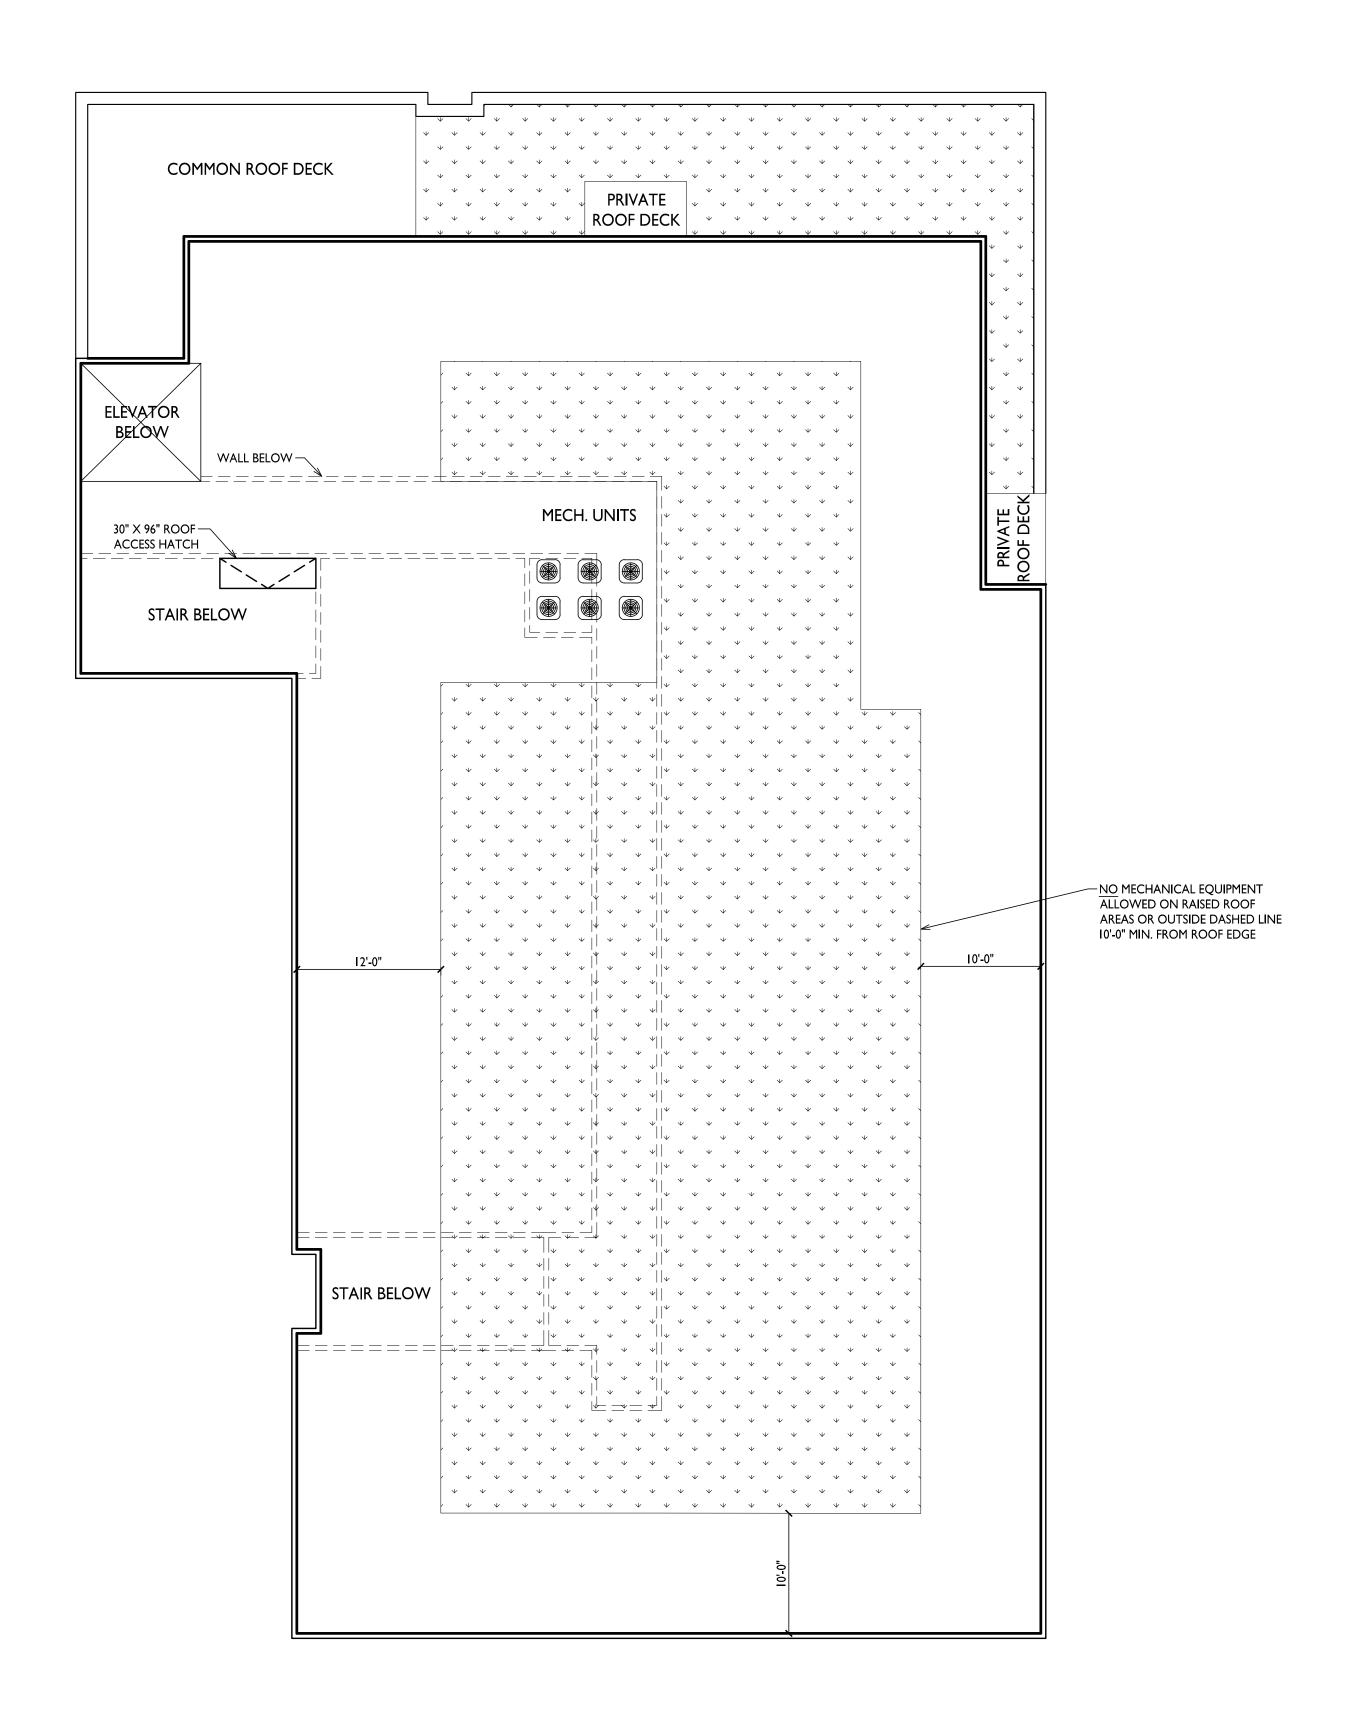
2253

PROJECT NO.


FOURTH FLOOR PLAN

I/8" = 1'-0"







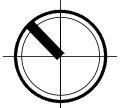



Issued for Review - June 17, 2024 Issued for Review - September 23, 2024

PROJECT TITLE THE KRONENBERG

423-427 W. Mifflin Street, Madison, WI SHEET TITLE

Roof Plan

SHEET NUMBER

ACI05

PROJECT NO.





ISSUED LUA SUBMITTAL - 2024.09.23



1 CITY ELEVATION - NORTHWEST 1/8" = 1'-0"

	EX	TERIOR MATERIAL SCHEDULE	
MARK	BUILDING ELEMENT	MANUFACTURER	COLOR
01	COMPOSITE LAP SIDING - ALTERNATING	JAMES HARDIE	IRON GRAY
02	COMPOSITE LAP SIDING - ALTERNATING	JAMES HARDIE	GRAY SLATE
03	COMPOSITE LAP SIDING - 6"	JAMES HARDIE	WOOD TONE - WINCHESTER BROWN
04	BRICK VENEER	SUMMIT BRICK	DOVE
05	BRICK SOLDIER COURSE	SUMMIT BRICK	DOVE
06	CAST STONE	ROCKCAST	REISLING
07	COMPOSITE TRIM	JAMES HARDIE	MATCH ADJ.
08	ALUMINIUM STOREFRONT	N/A	BLACK
09	RAILINGS & HANDRAILS	SUPERIOR	BLACK
10	COMPOSITE WINDOWS	ANDERSEN	BLACK

1/8" = 1 '- 0"

PROJECT TITLE

The Kronenberg

423-427 W. Mifflin St., Madison, WI SHEET TITLE Exterior Elevations

SHEET NUMBER

A201

PROJECT NUMBER 2253





1/8" = 1 '- 0"





ISSUED LUA SUBMITTAL - 2024.09.23

PROJECT TITLE

The Kronenberg

423-427 W. Mifflin St., Madison, WI SHEET TITLE

Exterior

Elevations

SHEET NUMBER


PROJECT NUMBER 2253



2 COLORED CITY ELEVATION - NORTHEAST 1/8" = 1'-0"



1 COLORED CITY ELEVATION - NORTHWEST 1/8" = 1'-0"

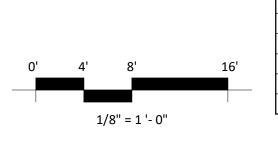

EXTERIOR MATERIAL SCHEDULE					
MARK	BUILDING ELEMENT	MANUFACTURER	COLOR		
01	COMPOSITE LAP SIDING - ALTERNATING	JAMES HARDIE	IRON GRAY		
02	COMPOSITE LAP SIDING - ALTERNATING	JAMES HARDIE	GRAY SLATE		
03	COMPOSITE LAP SIDING - 6"	JAMES HARDIE	WOOD TONE - WINCHESTER BROWN		
04	BRICK VENEER	SUMMIT BRICK	DOVE		
05	BRICK SOLDIER COURSE	SUMMIT BRICK	DOVE		
06	CAST STONE	ROCKCAST	REISLING		
07	COMPOSITE TRIM	JAMES HARDIE	MATCH ADJ.		
08	ALUMINIUM STOREFRONT	N/A	BLACK		
09	RAILINGS & HANDRAILS	SUPERIOR	BLACK		
10	COMPOSITE WINDOWS	ANDERSEN	BLACK		



ISSUED LUA SUBMITTAL - 2024.09.23

PROJECT TITLE

The Kronenberg

423-427 W. Mifflin St., Madison, WI SHEET TITLE

Exterior

**Elevations Colored** 

SHEET NUMBER

PROJECT NUMBER 2253







1 COLORED CITY ELEVATION - SOUTHEAST 1/8" = 1'-0"

0'	4'	8'	16'
	1,	/8" = 1 '- 0"	

EXTERIOR MATERIAL SCHEDULE				
MARK	BUILDING ELEMENT	MANUFACTURER	COLOR	
01	COMPOSITE LAP SIDING - ALTERNATING	JAMES HARDIE	IRON GRAY	
02	COMPOSITE LAP SIDING - ALTERNATING	JAMES HARDIE	GRAY SLATE	
03	COMPOSITE LAP SIDING - 6"	JAMES HARDIE	WOOD TONE - WINCHESTER BROWN	
04	BRICK VENEER	SUMMIT BRICK	DOVE	
05	BRICK SOLDIER COURSE	SUMMIT BRICK	DOVE	
06	CAST STONE	ROCKCAST	REISLING	
07	COMPOSITE TRIM	JAMES HARDIE	MATCH ADJ.	
08	ALUMINIUM STOREFRONT	N/A	BLACK	
09	RAILINGS & HANDRAILS	SUPERIOR	BLACK	
10	COMPOSITE WINDOWS	ANDERSEN	BLACK	



ISSUED LUA SUBMITTAL - 2024.09.23

PROJECT TITLE

The Kronenberg

423-427 W. Mifflin St., Madison, WI SHEET TITLE

Exterior

**Elevations Colored** 

SHEET NUMBER

PROJECT NUMBER 2253











## **City of Madison Fire Department**

314 W Dayton Street, Madison, WI 53703

Phone: 608-266-4420 • Fax: 608-267-1100 • E-mail: fire@cityofmadison.com

Project Address:	
Contact Name & Phone #:	

#### FIRE APPARATUS ACCESS AND FIRE HYDRANT WORKSHEET

1. Is the building completely protected by an NFPA 13 or 13R automatic fire sprinkler system?  If non-sprinklered, fire lanes extend to within 150-feet of all portions of the exterior wall?  If sprinklered, fire lanes are within 250-feet of all portions of the exterior wall?	☐ Yes ☐ Yes ☐ Yes	☐ No ☐ No ☐ No	<ul><li>N/A</li><li>N/A</li><li>N/A</li></ul>
<ul> <li>2. Is the fire lane constructed of concrete or asphalt, designed to support a minimum load of 85,000 lbs? <ul> <li>a) Is the fire lane a minimum unobstructed width of at least 20-feet?</li> <li>b) Is the fire lane unobstructed with a vertical clearance of at least 13½-feet?</li> <li>c) Is the minimum inside turning radius of the fire lane at least 28-feet?</li> <li>d) Is the grade of the fire lane not more than a slope of 8%?</li> <li>e) Is the fire lane posted as fire lane? (Provide detail of signage.)</li> <li>f) Is a roll-able curb used as part of the fire lane? (Provide detail of curb.)</li> <li>g) Is part of a sidewalk used as part of the required fire lane? (Must support +85,000 lbs.)</li> </ul> </li> </ul>	Yes Yes Yes Yes Yes Yes Yes Yes Yes	No   No   No   No   No   No   No   No	<ul> <li>N/A</li> <li>N/A</li> <li>N/A</li> <li>N/A</li> <li>N/A</li> <li>N/A</li> <li>N/A</li> <li>N/A</li> <li>N/A</li> </ul>
3. Is the fire lane obstructed by security gates or barricades? If yes:  a) Is the gate a minimum of 20-feet clear opening?  b) Is an approved means of emergency operations installed, key vault, padlock or key switch?	☐ Yes ☐ Yes ☐ Yes	No No No	<ul><li> N/A</li><li> N/A</li><li> N/A</li></ul>
4. Is the Fire lane dead-ended with a length greater than 150-feet?  If yes, does the area for turning around fire apparatus comply with IFC D103?	Yes Yes	□ No	□ N/A □ N/A
5. Is any portion of the building to be used for high-piled storage in accordance with IFC Chapter 3206.6 If yes, see IFC 3206.6 for further requirements.	Yes	☐ No	□ N/A
<ul> <li>6. Is any part of the building greater than 30-feet above the grade plane? If yes, answer the following questions: <ul> <li>a) Is the aerial apparatus fire lane parallel to one entire side of the building and covering at least 25% of the perimeter?</li> <li>b) Is the near edge of the aerial apparatus fire lane between 15' and 30' from the building?</li> <li>c) Are there any overhead power or utility lines located across the aerial apparatus fire lane?</li> <li>d) Are there any tree canopies expected to grow across the aerial fire lane? (Based on mature canopy width of tree species)</li> <li>e) Does the aerial apparatus fire lane have a minimum unobstructed width of 26-feet?</li> <li>f) Is the space between the aerial lane and the building free of trees exceeding 20' in heights?</li> </ul> </li> <li>7. Are all portions of the required fire lanes within 500-feet of at least (2) hydrants?</li> </ul>	<ul> <li>Yes</li> <li>Yes</li> <li>Yes</li> <li>Yes</li> <li>Yes</li> <li>Yes</li> <li>Yes</li> </ul>	<ul> <li>No</li> <li>No</li> <li>No</li> <li>No</li> <li>No</li> <li>No</li> <li>No</li> </ul>	<ul> <li>N/A</li> <li>N/A</li> <li>N/A</li> <li>N/A</li> <li>N/A</li> <li>N/A</li> <li>N/A</li> </ul>

Attach an additional sheet if further explanation is required for any answers.

This worksheet is based on MGO 34.503 and IFC 2021 Edition Chapter 5 and Appendix D; please see the codes for further information.