APPLICATION FOR URBAN DESIGN COMMISSION REVIEW AND APPROVAL

AGENDA	ITEM#	
Project # _		

DATE SUBMITTED: 1-26-11 UDC MEETING DATE: 2-2-11	Action Requested Informational Presentation Initial Approval and/or Recommendation Final Approval and/or Recommendation
PROJECT ADDRESS: 5402 WORLD	DRAIRY DRIVE
ALDERMANIC DISTRICT:	
OWNER/DEVELOPER (Partners and/or Principals) MADISON DEVELOPMENT CORP.	ARCHITECT/DESIGNER/OR AGENT: STEANG, INC.
550 W. WASHINGTON AVE.	6411 MINERAL POINT ROAD
MADISON, WI 53703	MADISON, WI 53705
CONTACT PERSON: PETER TAN	
Address: STRANG, INC.	
MADISON, WI	
Phone: 608-276-9200 Fax: 608-276-9204	
E-mail address: Lan @strang-inc.	
well as a fee) School, Public Building or Space (Fee may be re	Urban Design District * (A public hearing is required as equired) of a Retail, Hotel or Motel Building Exceeding 40,000
(See Section B for:) New Construction or Exterior Remodeling in C4	District (Fee required)
(See Section C for:) R.P.S.M. Parking Variance (Fee required)	
(See Section D for:) Comprehensive Design Review* (Fee required) Street Graphics Variance* (Fee required)	
Other	
*Public Hearing Required (Submission Deadline 3 Weel	ks in Advance of Meeting Date)
Where fees are required (as noted above) they apply with	n the first submittal for either initial or final approval of

a project.

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January 5, 2011

Madison Plan Commission 215 Martin Luther King, Jr. Blvd. Madison, WI 53701-2985

Re.: Letter of Intent for Midwest BioLink Commercialization and Business Center 5402 World Dairy Drive, Madison 53716

Project Name:

Midwest BioLink Commercialization and Business Center. Shortened reference may be made as "The BioLink Center."

Construction Schedule:

Estimated to be from July 2011 through June of 2012.

Existing Project Conditions:

The existing conditions on the property are vacant land, graded and somewhat overgrown by wild vegetation. The lot is fairly flat with some mild contour as indicated on the survey map.

Involved Parties:

Owner: Madison Development Corporation

550 West Washington Avenue Madison, Wisconsin 53703 Frank Staniszewski, President

608-256-2799, Ext 212 fstan@mdcorp.org

Owner Representative:

Ruedebusch Development & Construction

4605 Dovetail Drive Madison, WI 53704

Mike Mathews, Senior Vice-President

608-249-2112, Ext 211

Land is Owned by: City of Madison

Contact: Michael Gay, City Office of Business Resources and BioAg

Gateway Project Manager

(Land will be transferred to Madison Development Corporation upon execution of a TIF Development Agreement-TIF Resolution has been

approved.)

Architect: Strang, Inc.

6411 Mineral Point Road Madison, WI 53705

Wayne Whiting, Principal in Charge

Peter Tan, Design Principal Tom Kleinheinz, Project Manager

608-276-9200

Civil Engineer: JSD Professional Services

161 Horizon Drive Verona, WI 53593 Wade Wyse, PE 608-848-5060

Landscape: JSD Professional Services

161 Horizon Drive Verona, WI 53593

Michael Schmeltzer, Landscape Architect

608-848-5060

Contractor: Not yet selected and will be done so by advertised bid.

Land Surveyor: MSA Professional Services

2901 International Lane, Suite 300

Madison, WI 53704 Kevin Lord, RLS, P.E.

608-242-7779

Soils Engineer: River Valley Testing Corp.

1060 Breezewood Lane, Suite 102

Neenah, WI 54956 Matthew Meyer, P.E. 920-886-1406

Project Description/Uses:

Madison Development Corporation, in conjunction with the City of Madison, is planning to construct a new state-of-the-art research facility at 5402 World Dairy Drive. This project is receiving public assistance in the form of a TIF loan and the transfer of land currently owned by the City, as part of the approved TIF. The project is also receiving considerable construction financing in the form of a grant from the US Dept. of Commerce, Economic Development Administration (EDA). The facility will provide bio and agro-science entrepreneurs the catalyst to take their technology to the next level. The 31,000 SF project will include: experimentation and prototyping flex space, controlled environmental research space, plant science commercialization greenhouses, offices, research laboratory space, pilot plant processing, small conferencing/meeting spaces, and business support services.

The proposed one-story (high-bay) building will be constructed of a brick veneer, concrete masonry, and metal panels wall systems. Aluminum framed glass storefront windows are

Midwest BioLink Commercialization and Business Center

provided at the primary entrance, and the west and north elevations. Aluminum framed greenhouse structures will be provided on the south side of the facility. A small second floor interstitial area is being provided to accommodate mechanical equipment. A roof-top screen wall system will screen anticipated roof-mounted mechanical equipment. The building is also designed to include a "flat", adhered, single-ply membrane roof system.

Building height above grade is one story plus equipment mezzanine

- / 23'-0" to highest roof
- / 34'-0" to top of roof screen

The uses of the proposed building include:

- / Flexible Space for agribusiness related business tenants: 12,974 square feet. This will be open high bay area which may be improved by tenants for production, packing, storage, or some laboratory uses.
- / Greenhouse: 5,520 square feet. Enclosed greenhouse for planting and growing various research plants.
- / Headhouse: 3,490 square feet. Headhouse area is fairly rough space intended for plant preparation, potting, planting and post harvest of plants and initial processing of plants and plant material.
- / Headhouse/common equipment rooms: 745 square feet. These rooms will contain common use equipment related to plant functions, including items such as autoclave to sterilize plant and other materials prior to disposal, storage area for pesticides, a centrifuge area and other tools.
- Office and Reception/Vestibule: 827 square feet. Used for reception area, and office of facility manager.
- / Conference/Break Rooms: 865 square feet. Common use spaces for building tenant businesses.
- / Mechanical Room: 5,786 square feet. For building mechanicals.
- / Receiving: 247 square feet, receiving room adjacent to loading dock area.
- / Other Miscellaneous Spaces: 5,400 square feet. Includes circulation, rest rooms, shower room, janitor closet.

The total gross square footage of the building is 35,800 GSF. The building "foot-print" on the site is 31,000 SF.

Roughly 20,000 gross square feet is devoted to general business space for agribusinesses that may include some laboratory and associated space, related offices and work stations, production and processing of agricultural products. Roughly 10,000 gross square feet is devoted to planting, greenhouse growing, and related plant and plant product processing functions.

The estimated number of employees is 86. This was calculated by adding the rentable square footage of Flex space and Headhouse space, plus the office/reception--totaling 17,195 – and dividing by one employee per 200 square feet. (The rentable greenhouse space is not calculated to have an employee contribution, since those employees would be housed in either the headhouse or flex space areas.)

Potential Capacity (as determined by building code): 254 occupants

Parking & Loading:

Number of parking spaces: 75 total, including 3 accessible spaces. Accessible parking is provided adjacent to the main building entrance for staff and visitors.

There is one truck loading dock (covered) suitable for a 67 foot vehicle. Most deliveries for potential tenants will be via small box trucks.

Bicycle parking: 7-stall bicycle parking rack by the main building entry.

Hours of Operation:

The hours of operation will generally be during normal business hours (8-5) for most functions. Since the facility will include greenhouses and live plants, there will likely be some late hour usage for plant care workers. The facility will have automated systems for heat, plant lighting, and watering which may limit the need for extensive off hours attention to live plants.

Site Area:

The site contains a total of 2.63 acres, or 114,563 square feet.

Trash Removal/Storage:

Trash removal and storage consists of 2 dumpsters of 6-yd (ea.) capacity located near the loading dock on the north side of the building.



January 5, 2011

Zoning Text: Specific Implementation Plan (PUD-SIP)

Project Name: Midwest BioLink Commercialization and Business Center

Site Address: 5402 World Dairy Drive

Legal Description: This PUD-SIP zoning district is established to allow for the construction of office, research, laboratory and greenhouse facilities.

A. Statement of Purpose:

1. This Planned Unit Development (PUD) District is established to provide employment opportunities within and aesthetically attractive working environment exclusively for and conducive to the development and protection of research and development institutions, certain specialized manufacturing and industrial establishments and offices of a non-nuisance type. The essential purpose of this district is to achieve development which is practical, feasible and economical and maintain desirable economic development activities in an attractive urban setting. The district is intended to provide sites which are suitable for industrial and office uses within and aesthetically attractive area.

B. Permitted Uses:

1. Lot Number Permitted Use Zoning Requested

Lot 10 (Ten) Office, Research and PUD-SIP

Development, Laboratory,

Greenhouse, Business engaged In Dairy or Agricultural purpose

- 2. The temporary building for storage of building materials and equipment for construction purposes when on the same lot as a principal use for a period not to exceed the duration of such construction.
- C. Lot Area:
 - 1. Lot area = 114,563 square feet, (2.63 Acres)
- D. Floor Area Ratio:
 - 1. The building coverage on any zoning lot shall not exceed 0.5.

- 2. Floor area Ratio for this project is .31
- 3. Maximum Height for this building is 2 (two) stories (the second story is a small interstitial area for mechanical equipment and access).

E. Yard Requirements:

1. Yard areas will be as provided and shown on approved plans.

Note: The submitted drawings currently show an emergency generator enclosure at the east end of the building, which is located within the setback area. At the time of this application City of Madison staff (Matt Tucker) was in the process of determining if this was in compliance with the PUD/GDP zoning for the site. If he should determine that it is not in compliance, the owner intends to seek an amendment to the GDP which would permit this.

F. Landscaping:

1. Site landscaping will be as provided and shown on approved plans.

G. Accessory and off-street parking & loading:

1. Accessory off-street parking and loading will be provided as shown on approved plans.

H. Lighting:

1. Site lighting will be provided as shown on approved plans.

I. Signage:

1. Signage will be allowed as per Chapter 31 of the Madison General Ordinances, and approved plans.

J. Alterations and revisions:

1. No alteration or revision of this planned unit development shall be permitted unless approved by the City Plan Commission, however, the Zoning Administrator may issue permits for minor alterations or additions which are approved by the Director of Planning and Development and the alderperson of the district and are compatible with the concept approved by the City Plan Commission.



MINUTES

CLIENT:

Madison Development Corp. Midwest BioLink Commercialization PROJECT NAME:

and Business Center

Meeting with Alder Judy 2009064 SUBJECT: **PROJECT**

> Compton NUMBER:

DATE: 1/12/11

Peter Tan ISSUED BY:

Alder Judy Compton **Participants** COPIES TO: IN Frank Staniszewski - MDC Strang file ATTENDANCE:

Mike Mathews - Ruedebusch

Wayne Whiting Peter Tan - Strang Tom Kleinheinz

Michael Gay, City of Madison

Meeting Purpose:

To present the design and exterior materials and finishes of the project to Alder Judy Compton, and to address the concerns she has regarding the project.

Discussion:

1. Exterior materials:

Peter presented the design of the project and indicated where each material was located on the exterior of the building. The corrugated galvalume metal panel is used as an accent in combination with a palette of materials that includes brick, grey concrete block and grey concealed fastener metal panel to reinforce both the agrarian and high-tech metaphors used in the design. Peter showed photographs of Class A type buildings in our community that Strang has designed that use this material, including Summit Credit Union Rimrock Road, GE Lunar, APT Touchstone Theatre, SAFC Tetrionics, HealthEmotions Research Institute and General Heating and Air Conditioning. After a discussion, Alder Judy Compton accepted the choice of materials as presented.

2. Dumpster enclosure:

The next item of discussion focused on Alder Compton's concern that dumpster enclosures in the city have been use for illicit activities related to drugs and temporary shelter for the homeless. The decision was made to locate a person-door on the east side of the dumpster enclosure to enable building occupants to safely access the dumpsters without having to open the large vehicular access doors. The large dumpster doors will be locked and secured for entry only by management and the waste disposal service. The height of the enclosure will also be raised by 8" to 16" to make it more difficult for people to climb into the enclosure. Alder Compton agreed that it was not necessary to place a roof over the enclosure.

ARCHITECTURE ENGINEERING INTERICA DESIGN


3. Sustainability:


The project will be designed with strong emphasis on sustainability. In keeping with our shared goal of being responsible stewards of the environment, sustainable building materials and energy efficient systems have been incorporated into the project. LEED Certification will not be pursued. In the final cost estimating and setting of Bid Alternates, MDC, the architects and engineers shall consider materials and methods to enhance sustainability such as a green roof or other techniques.

4. Handling of hazardous material disposal:

The facility shall follow all applicable and required standards for biohazard waste disposal. Hazardous biological material will be sterilized in autoclaves before disposal. Flammable and toxic chemicals will be deposited in secure fireproof containers and disposed of by a contracted service.

MEETING ADJOURNED: 2:30 PM
NEXT MEETING: To be determined

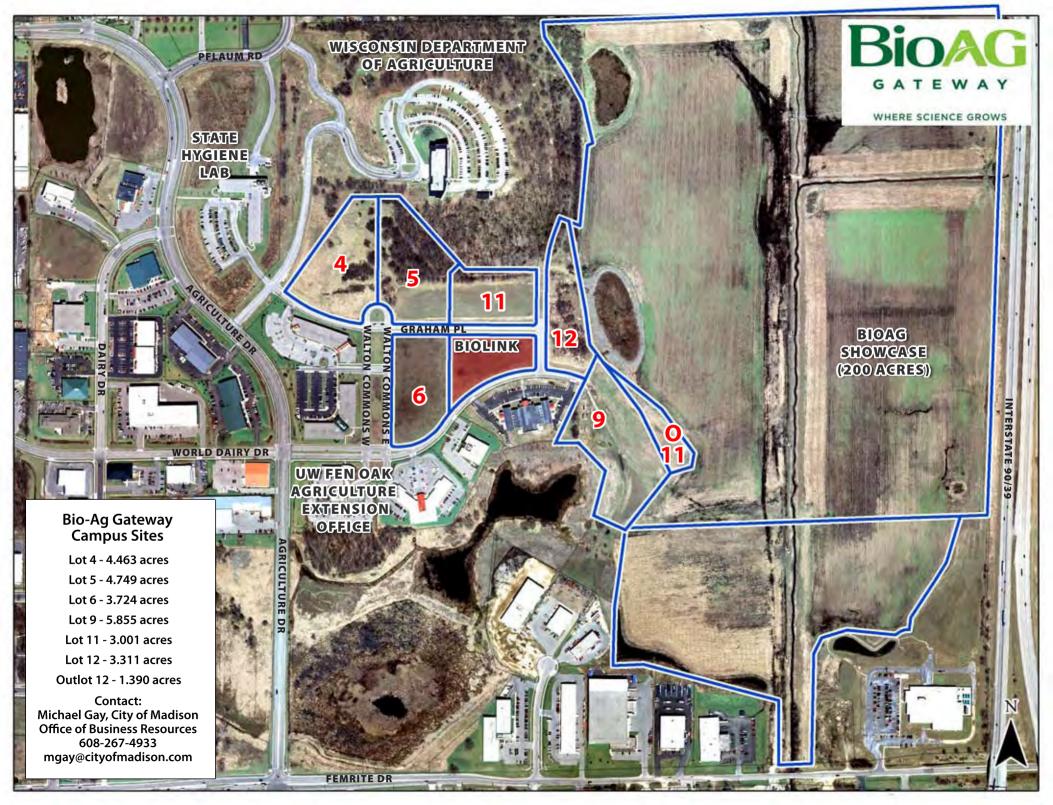

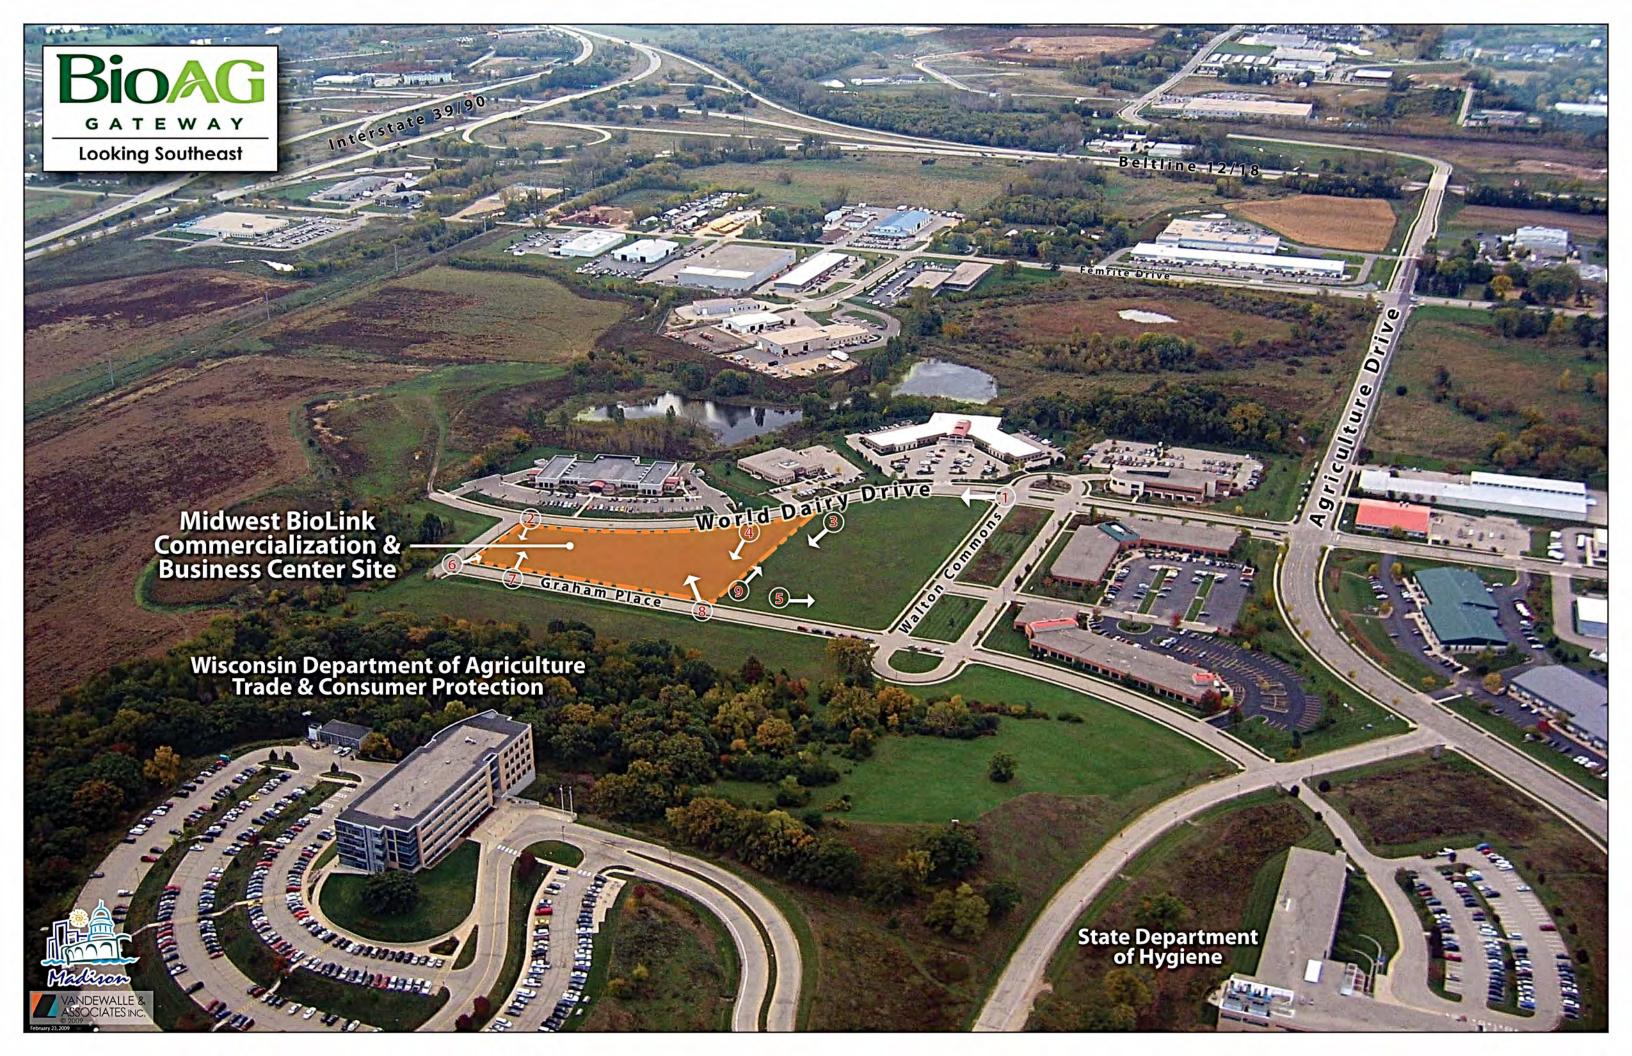

BioLink Site Photos

(Locations indicated in aerial photo)



Photo 1



Photo 3



Photo 2



Photo 4





Photo 5





Photo 6 Photo 7



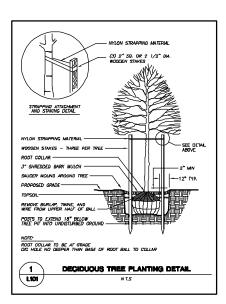



Photo 8





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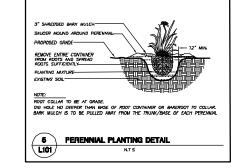






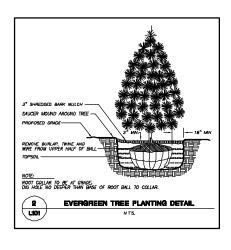

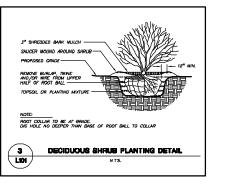

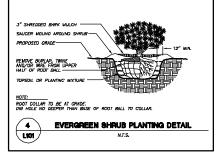



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- 15. MAINTENANCE. (DINNER) THE CHINER IS RESPONSIBLE FOR THE CONTINUED MAINTENANCE, REPAR AND REPLACEMENT OF ALL LANDSCAFING MATERIALS AND BARRIERS AS NECESSARY FOLLOWING THE ONE (1) YEAR CONTRACTOR GUARANTEE PERSON.



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STRANG INC. 8411 MINERAL POINT ROAD MADISON, WI \$3708-4888

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- CIVIL ENGINEERING SURVEYING & MAPPING
- CONSTRUCTION SERVICES
 WATER RESOURCES
 PLANNING & DEVELOPMENT
 TRANSPORTATION ENGINEER
- MADISON REGIONAL OFFICE 161 HORIZON DRIVE, SUITE 101 VERDNA, WISCONEN 63583 101.048.0005 PHONE II 000.040,2305 FA

DRAWING SET COPYRIGHT STRANG, INC 12-23-10 FILE NAME D9-3827 Landscape REVISIONS

DRAWN JLF CHECKED DATE 12-23-10 PROJECT NO. 2009064

MIDWEST BIOLINK COMMERCIALIZATION AND BUSINESS CENTER

5402 WORLD DAIRY DRIVE MADISON, WI 53716


SHEET TITLE

LANDSCAPE **SPECIFICATIONS** AND DETAILS

SHEET NO. L101

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6 MAIN BUILDING ENTRANCE
L101 N.T.S.

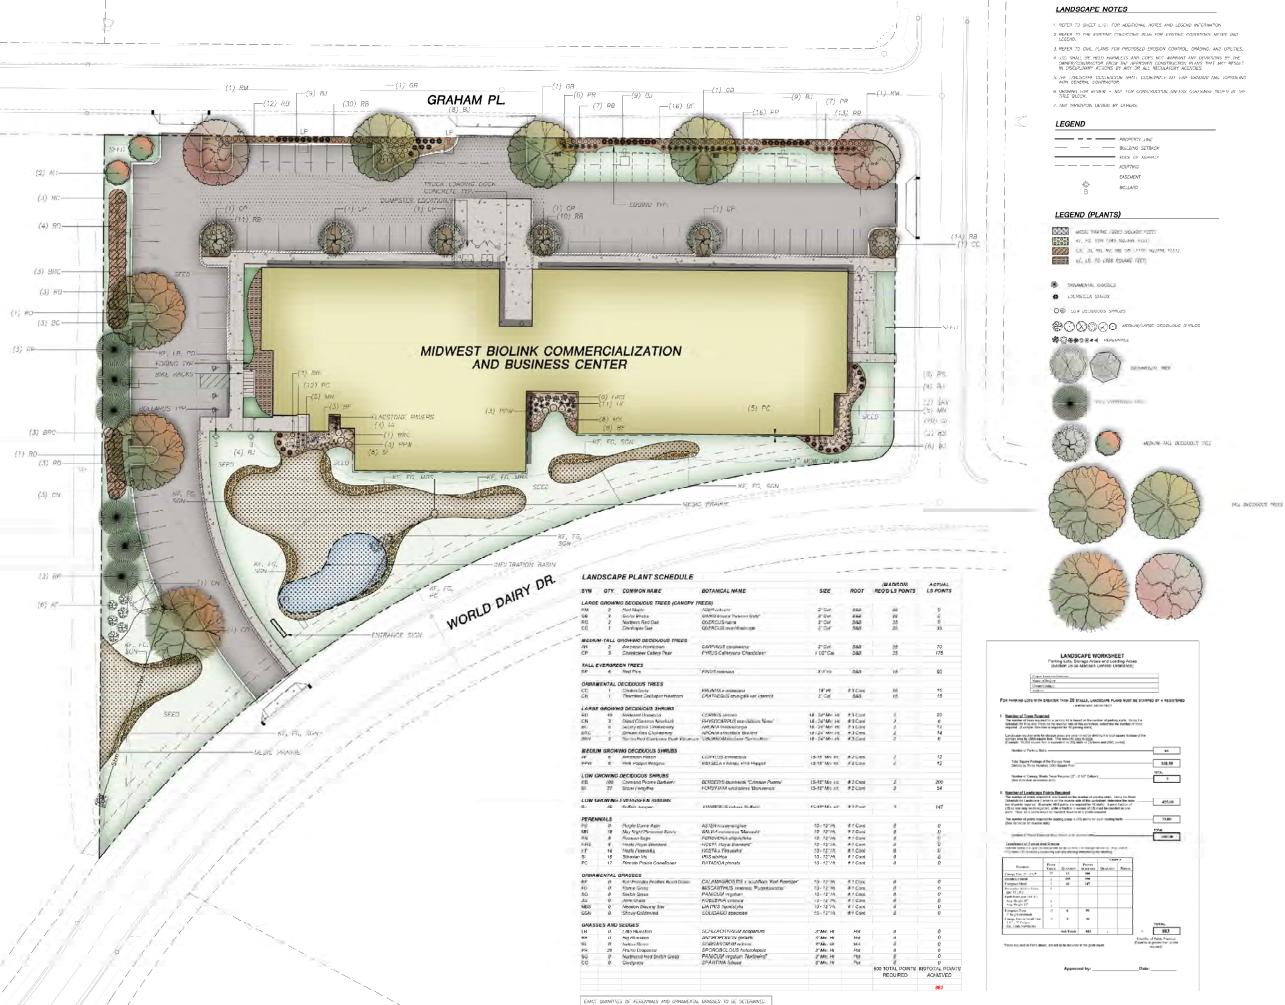

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DATE	12-23-10
PROJECT NO.	2009 064

PROJECT TITLE

MIDWEST BIOLINK COMMERCIALIZATION AND BUSINESS CENTER

5402 WORLD DAIRY DRIVE MADISON, WI 53716

SHEET TITLE

LANDSCAPE PLAN

SHEET NO. L100



ARCHITECTURE ENGINEERING INTERIOR DESIGN

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ISD Professional Services, Inc. · Engineers · Surveyors · Plunners

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 TRANSPORTATION ENGINEERING
 ATRICCTURE
 LANDSCAPE ANCHITECTURE
- MADISON REGIONAL OFFICE
 181 HORIZON DRIVE SUITE 101
 VERONA, WISCONSIN 63893
 808.848.5060 PHONE | 608.848.2266 FAX

- www.jsdinc.com



ARCHITECTURE ENGINEERING INTERIOR DEGEN

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MIDWEST BIOLINK COMMERCIALIZATION AND BUSINESS CENTER


5402 WORLD DAIRY DRIVE MADISON, WI 53716

SHEET TITLE

PRELIMINARY DESIGN NOT FOR CONSTRUCTION SITE LIGHTING PHOTOMETRIC PLAN

SHEET NO.

E001

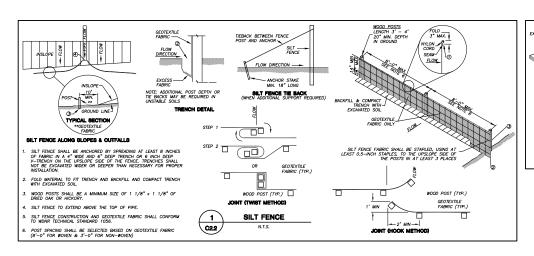

PAVEMENT MIXTURE SHALL BE E-1.0 BITUMINOUS PAVEMENT.

6 PAVEMENT SECTION B
C22 N.T.S.

REFER TO GEOTENICAL EXPLORATION REPORT FOR FURTHER DETAILS AND SPECIFICATIONS.


1-3/4"
BITUMINOUS
BINDER COURSE


12" CRUSED AGGREGATE
BASE COURSE
(6" OF 1-1/2" & 6" (
3/4" OR 8" OF 3/4")

PAYEMENT MIXTURE SHALL BE E-1.0 BITUMINOUS PAYEMENT.

5 PAVEMENT SECTION A
C22 N.T.S.

REFER TO GEOTENICAL EXPLORATION REPORT FOR FURTHER DETAILS AND SPECIFICATIONS.

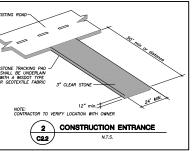

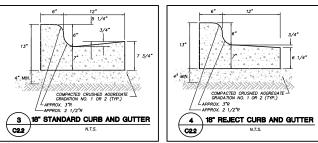



ARCHITECTURE ENGINEERING INTERIOR DESIGN


BTRANG INC. 8411 MINERAL POINT ROAD MADISON, WI 52705-4295 T/ 808 276 8200 F/ 808 276 8204



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 161 HORIZON DRIVE, SUITE 101
 VERONA, WISCONSIN 53593
 608.848.5060 PHONE

 608.848.2255 FAX

- MADISON MILWAUKEE KENOSHA APPLETON Www.jsdinc.com

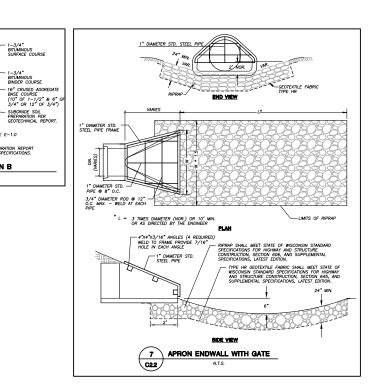

PRELIMINARY DESIGN NOT FOR CONSTRUCTION

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COPYRIGHT STRANG, INC.	12-23-10
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REVISIONS	01-26-2011
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PROJECT NO.	2009 064
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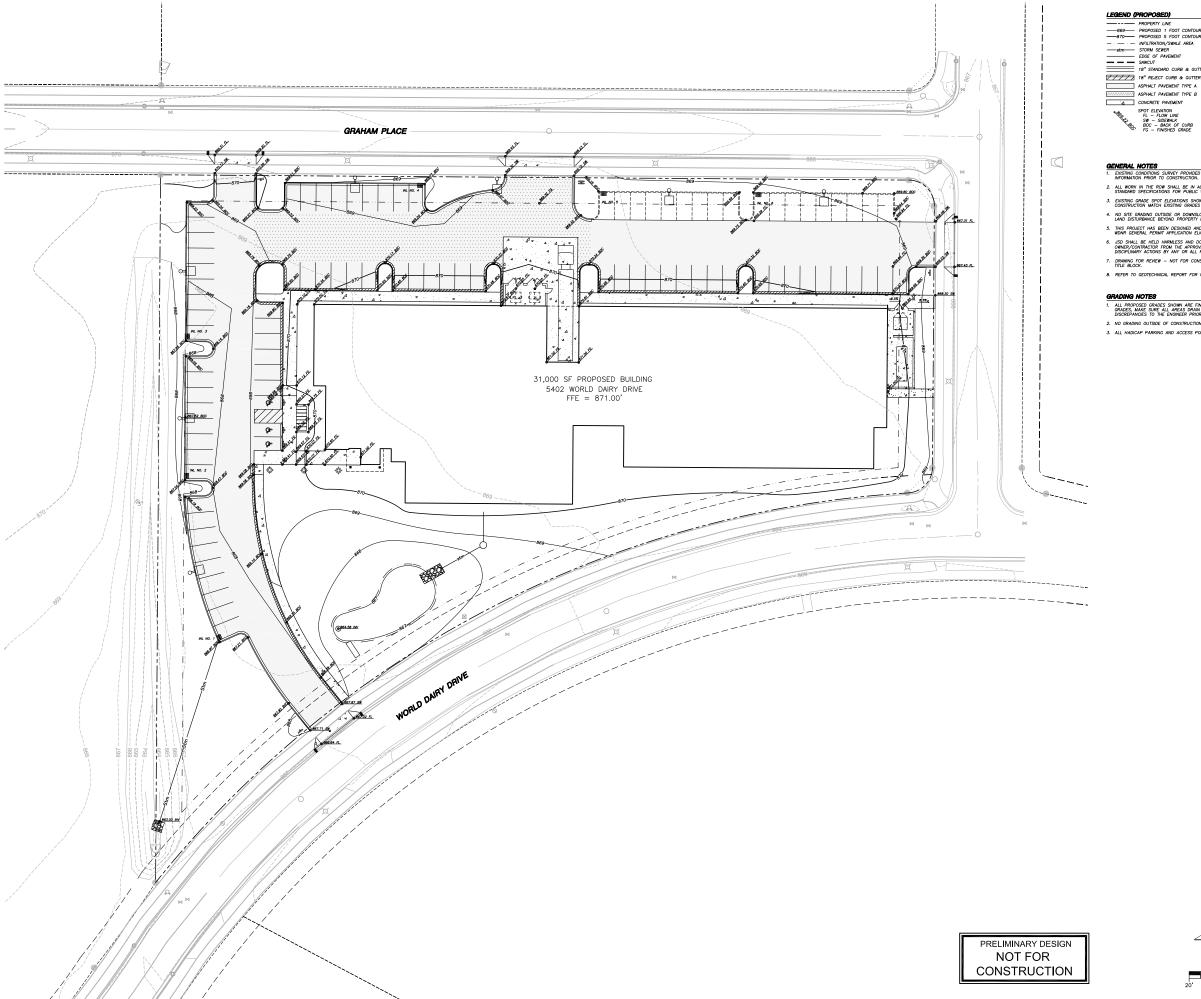
MIDWEST BIOLINK COMMERCIALIZATION AND BUSINESS CENTER

5402 WORLD DAIRY DRIVE

SHEET TITLE

DETAILS

C203



LEGEND (PROPOSED)

SPOT ELEVATION
FL - FLOW LINE
SW - SIDEWALK
BOC - BACK OF CURB
FG - FINISHED GRADE



GENERAL NOTES

1. EXISTING CONDITIONS SURVEY PROVIDED BY OTHERS. CONTRACTOR TO FIELD VERIFY INFORMATION PRIOR TO CONSTRUCTION.

- ALL WORK IN THE ROW SHALL BE IN ACCORDANCE WITH THE CITY OF MADISON STANDARD SPECIFICATIONS FOR PUBLIC WORKS CONSTRUCTION.
- EXISTING GRADE SPOT ELEVATIONS SHOWN FOR INFORMATIONAL PURPOSES. DURING CONSTRUCTION MATCH EXISTING GRADES AT CONSTRUCTION LIMITS.
- NO SITE GRADING OUTSIDE OR DOWNSLOPE OF PROPOSED SILT FENCE LOCATION. NO LAND DISTURBANCE BEYOND PROPERTY LINES.
- THIS PROJECT HAS BEEN DESIGNED AND WILL BE CONSTRUCTED IN COMPLIANCE WITH WDNR GENERAL PERMIT APPLICATION ELIGIBILITY STANDARDS.
- DRAWING FOR REVIEW NOT FOR CONSTRUCTION UNLESS OTHERWISE NOTED IN THE TITLE BLOCK.
- 8. REFER TO GEOTECHNICAL REPORT FOR FURTHER PAVEMENT INFORMATION.

- 2. NO GRADING OUTSIDE OF CONSTRUCTION LIMITS OR BEYOND SILT FENCE LOCATIONS.

BTRANG INC. 8421 MINERAL POINT ROAD MADISON, WI 53705-4395

ARCHITECTURE ENGINEERING INTERIOR DESIGN

T/ 808 276 8200 F/ 808 276 8204

JSD Professional Services, Inc.
- Ingineers • Surveyors • Planners

THROCOT TRIST, QUALITA AND EXPERIENCE*

CIVIL ENOIMEERING

SURVEYING & MAPPING

CONSTRUCTION SERVICES

WATER RESOURCES

PLANNING & DEVELOPMENT

TRANSPORTATION ENGINEERING

LANDSCAPE ARCHITECTURE

MADISON REGIONAL OFFICE

161 HORIZON DRIVE, SUITE 101

VERONA, WISCONSIN S3593

608 845 5060 PHONE | 608 848 2255 FAX

MADISON | MILWARDSON | MILWA

MADISON MILWAUKEE
KENOSHA APPLETON

www.jsdinc.com

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COPYRIGHT STRANG, INC.	12-23-10
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REVISIONS	01-26-201
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DATE	12-23-10

MIDWEST BIOLINK COMMERCIALIZATION AND BUSINESS CENTER

2009 064

5402 WORLD DAIRY DRIVE MADISON, WI 53716


north 0 11"x17" NTS

SHEET TITLE

PROJECT NO.

DETAILED GRADING PLAN

C202

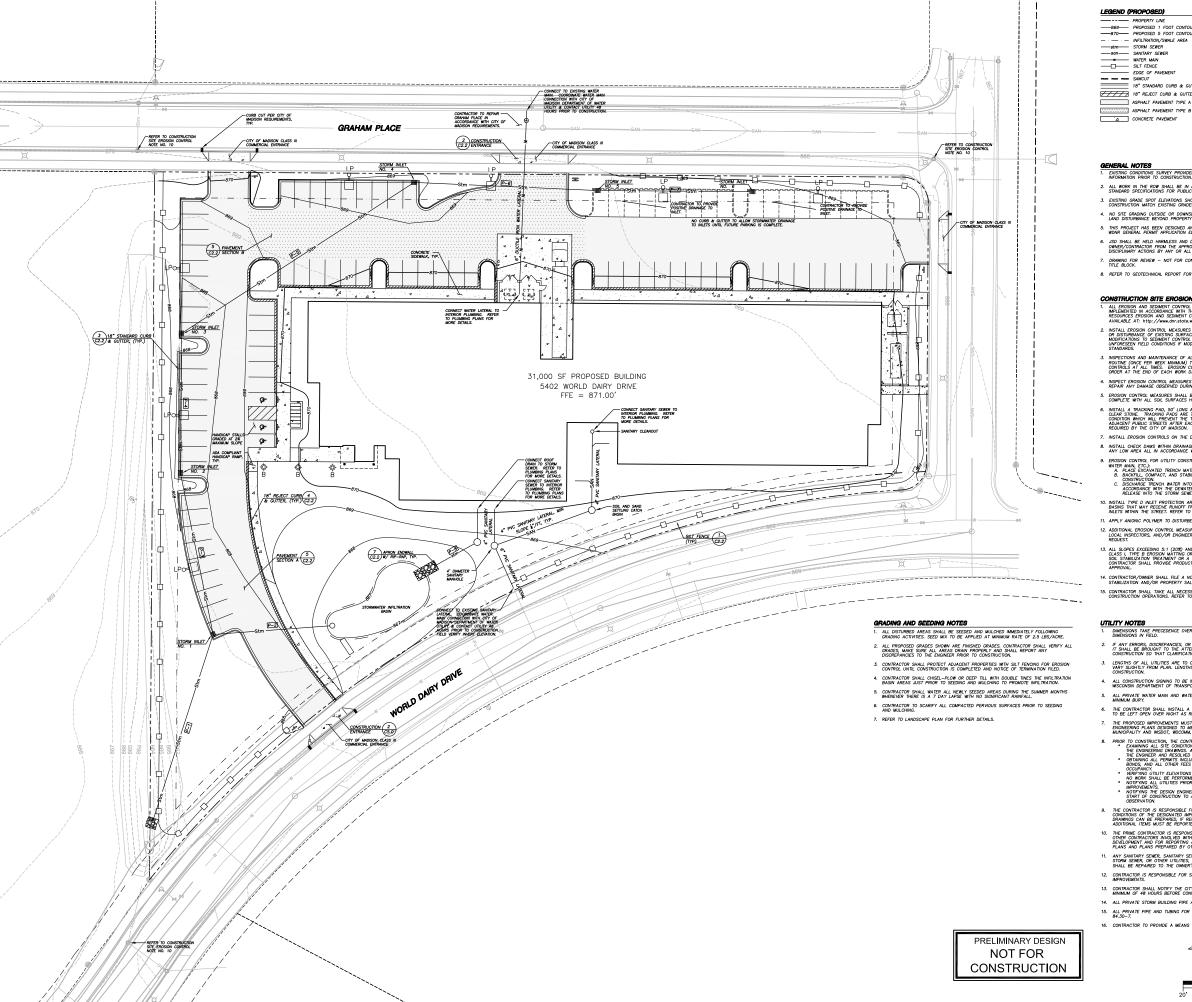

LEGEND (PROPOSED)

BOOKEN LINE

BOOKE

18" REJECT CURB & GUTTER ASPHALT PAVEMENT TYPE A



- GENERAL NOTES

 1. EXISTING CONDITIONS SURVEY PROVIDED BY OTHERS. CONTRACTOR TO FIELD VERIFY INFORMATION PRIOR TO CONSTRUCTION.
- ALL WORK IN THE ROW SHALL BE IN ACCORDANCE WITH THE CITY OF MADISON STANDARD SPECIFICATIONS FOR PUBLIC WORKS CONSTRUCTION.
- EXISTING GRADE SPOT ELEVATIONS SHOWN FOR INFORMATIONAL PURPOSES. DURING CONSTRUCTION MATCH EXISTING GRADES AT CONSTRUCTION LIMITS.
- 4. NO SITE GRADING OUTSIDE OR DOWNSLOPE OF PROPOSED SILT FENCE LOCATION. NO LAND DISTURBANCE BEYOND PROPERTY LINES.
- THIS PROJECT HAS BEEN DESIGNED AND WILL BE CONSTRUCTED IN COMPLIANCE WITH WONR GENERAL PERMIT APPLICATION ELIGIBILITY STANDARDS.
- JSD SHALL BE HELD HARMLESS AND DOES NOT WARRANT ANY DEVIATIONS BY THE OWNER/CONTRACTOR FROM THE APPROVED CONSTRUCTION PLANS THAT MAY RESULT IN DISCIPLINARY ACTIONS BY ANY OR ALL REGULATORY AGENCIES.
- DRAWING FOR REVIEW NOT FOR CONSTRUCTION UNLESS OTHERWISE NOTED IN THE TITLE BLOCK.
- 8. REFER TO GEOTECHNICAL REPORT FOR FURTHER PAVEMENT INFORMATION.

CONSTRUCTION SITE EROSION CONTROL

- ALL EROSION AND SEDIMENT CONTROL PRACTICES SHALL BE DESIGNED AND IMPLEMENTED IN ACCORDANCE WITH THE CURRENT DEPARTMENT OF NATURAL RESOURCES EROSION AND SEDIMENT CONTROL TECHNICAL STANDARDS WHICH ARE AVAILABLE AT: http://www.dmr.stote.mi.us/runoft/stormwater/lechsts.htm

- INSPECT EROSION CONTROL MEASURES AFTER EACH 1/2" OR GREATER RAINFALL REPAIR ANY DAMAGE OBSERVED DURING THE INSPECTION.
- EROSION CONTROL MEASURES SHALL BE REMOVED ONLY AFTER SITE CONSTRUCTION COMPLETE WITH ALL SOIL SURFACES HAVING AN ESTABLISHED VEGETATIVE COVER.
- 6. INSTALL A TRACKING PAD, 50' LONG AND NO LESS THAN 12" THICK BY USE OF 3" CLEAR STONE. TRACKING PADS ARE TO BE MAINTAINED BY THE CONTRACTOR IN A COMDITION WHICH MLL PREVENT THE TRACKING OF MUD OR DRY SEDMENT ONTO THI ADJACENT PUBLIC STREETS AFTER EACH WORKING DAY OR MORE FREQUENTLY AS REQUIRED BY THE CITY OF MADISON.
- 7. INSTALL EROSION CONTROLS ON THE DOWNSTREAM SIDE OF STOCKPILES
- INSTALL CHECK DAMS WITHIN DRAINAGE DITCHES AND IN FRONT OF SILT FENCING IN ANY LOW AREA ALL IN ACCORDANCE WITH WDNR TECHNICAL STANDARDS.
- ANY LOW AREA ALL IN ACCEPTANCE WITH MUMPH TECHNICAL STANDARDS.

 PERSONS OCHROLIC FOR UTILITY CONSTRUCTION (SORM SEMER, SANTHARY SEMER, WATER MAIN, ETC.),

 A. PLACE SECIALIZED TRENCH MATERIAL ON THE HIGH SIDE OF THE TRENCH.

 B. BACKPILL COMMANCE, AND STABLUZE THE TRENCH MAREDATEX FATER PIPH.

 B. BACKPILL COMMANCE, AND STABLUZE THE TRENCH MAREDATEX FATER PIPH.

 C. DISCHARGE TRENCH WATER TOO A SEDUMENTATION BESSIN OF TLEBMINE TANK IN ACCORDANCE WITH THE DEWATERING TECHNICAL STANDARD NO. TOST PRIOR TO RELEASE WITO THE STORM SEWER, RECEPTION STREAM, OR MORAMED DITCH.

- 11. APPLY ANIONIC POLYMER TO DISTURBED AREAS IF EROSION BECOMES PROBLEMATIC
- CONTRACTOR SHALL TAKE ALL NECESSARY STEPS TO CONTROL DUST ARISING FROM CONSTRUCTION OPERATIONS, REFER TO WONR TECHNICAL STANDARD 1068.

UTILITY NOTES

- DIMENSIONS TAKE PRECEDENCE OVER SCALE. CONTRACTOR TO VERIFY ALL DIMENSIONS IN FIELD.
- IF ANY ERRORS, DISCREPANCIES, OR OMISSIONS WITHIN THE PLAN BECOME APPARENT IT SHALL BE BROUGHT TO THE ATTENTION OF THE ENGINEER PRIOR TO CONSTRUCTION SO THAT CLARIFICATION OR REDESIGN MAY OCCUR.
- LENGTHS OF ALL UTILITIES ARE TO CENTER OF STRUCTURES OR FITTINGS AND MAY VARY SLIGHTLY FROM PLAN. LENGTHS SHALL BE VERIFIED IN THE FIELD DURING CONSTRUCTION.
- ALL CONSTRUCTION SIGNING TO BE IN ACCORDANCE WITH THE CITY OF MADISON AN WISCONSIN DEPARTMENT OF TRANSPORTATION REQUIREMENTS.
- THE CONTRACTOR SHALL INSTALL A PEDESTRIAN FENCE AROUND ALL EXCAVATIONS TO BE LEFT OPEN OVER NIGHT AS REQUIRED.
- MUNICHALITY AND MISDOT, WOCOMA, AND WORKS.

 PROPO TO CONSTRUCTION, THE CONTROLLOR IS RESPONSIBLE FOR.

 FOR THE CONTROLLOR AND THE CONTROLLOR IS RESPONSIBLE FOR THE PROPOSED AND THE STREET OF CONTROLLOR AND THE STREET OF CONSTRUCTION.

 THE ENGINEER AND RESOLVED PRIOR TO THE STREET OF CONSTRUCTION, FOR THE ENGINEER AND RESOLVED PRIOR TO THE STREET OF CONSTRUCTION, FOR THE PROPOSED WORK TO AND ALL OTHER TEST REQUIRED FOR PROPOSED WORK TO REPORT OF ANY DISCREPANCY.

 NO WORK SHALL EPERFORMED JURIT, THE DESPREAKEY IS RESURED.

 NO DITTION ALL UTILIES PRIOR TO THE INSTALLATION OF ANY UNDERGROUND IN THE PROPOSED WORK TO THE STREET OF CONSTRUCTION TO ARRANGE FOR APPROPRIATE CONSTRUCTION TO RESISTANCE.
- THE CONTRACTOR IS RESPONSIBLE FOR PROVIDING THE ENGINEER WITH AS-BUILT CONDITIONS OF THE DESIGNATED IMPROVEMENTS IN ORDER THAT THE APPROPRIATE PRAMMISS CAN BE PREPARED, IF REQUIRED. ANY CHANGES TO THE DRAWNISS OR ADDITIONAL ITEMS MUST BE REPORTED TO THE ENGINEER AS WORK PROGRESSES.
- THE PRINCE CONTRACTOR IS RESPONSIBLE FOR COORDINATING ALL CONSTRUCTION WITH OTHER CONTRACTORS INVOLVED WITH CONSTRUCTION OF THE PROPOSED DEVELOPMENT AND FOR REPORTING ANY ERRORS OR DISCREPANCIES BETWEEN THESE PLANS AND PLANS PREPARED BY OTHERS.
- 11. ANY SANITARY SEWER, SANITARY SEWER SERVICES, WATER MAIN, WATER SERVICES, STORM SEWER, OR OTHER UTILITES, WHICH ARE DAMAGED BY THE CONTRACTORS, SHALL BE REPAIRED TO THE OWNER'S SATISFACTION AT THE CONTRACTOR'S EXPENSE
- CONTRACTOR IS RESPONSIBLE FOR SITE SAFETY DURING THE CONSTRUCTION OF IMPROVEMENTS.
- CONTRACTOR SHALL NOTIFY THE CITY OF MADISON PUBLIC WORKS DEPARTMENT A MINIMUM OF 48 HOURS BEFORE CONNECTING TO PUBLIC UTILITIES. 14. ALL PRIVATE STORM BUILDING PIPE AND TUBING SHALL CONFORM TO COMM 84.30-6
- 15. ALL PRIVATE PIPE AND TUBING FOR WATER SERVICE SHALL CONFORM TO COMM 84.30-7.
- 16. CONTRACTOR TO PROVIDE A MEANS OF LOCATING ALL PIPES.



STRANG INC. 6411 MINERAL POINT ROAD MADISON, WI 53705-4395

ARCHITECTURE ENGINEERING INTERIOR DESIGN

T/ 808 276 8200 F/ 808 276 8204 JSD Protessional Services, Inc.

- CIVIL ENGINEERING
- SURVEYING & MAPPING
 CONSTRUCTION SERVICES
 WATER RESOURCES
 PLANNING & DEVELOPMENT
 TRANSPORTATION ENGINEERING

- MADISON REGIONAL OFFICE 161 HORIZON DRIVE, SUITE 101 VERONA, WISCONSIN 53593 608.848.5060 PHONE

 608.848.2255 FAX
- MADISON MILWAUKEE KENOSHA APPLETON WWW.jsdinc.com


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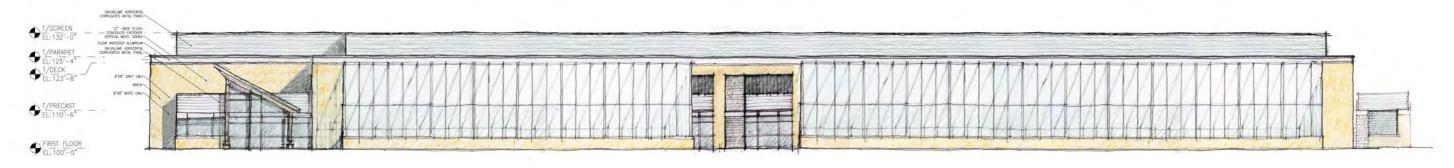
MIDWEST BIOLINK COMMERCIALIZATION AND BUSINESS CENTER

5402 WORLD DAIRY DRIVE

GRADING, EROSION CONTROL, & UTILITY PLAN

C201




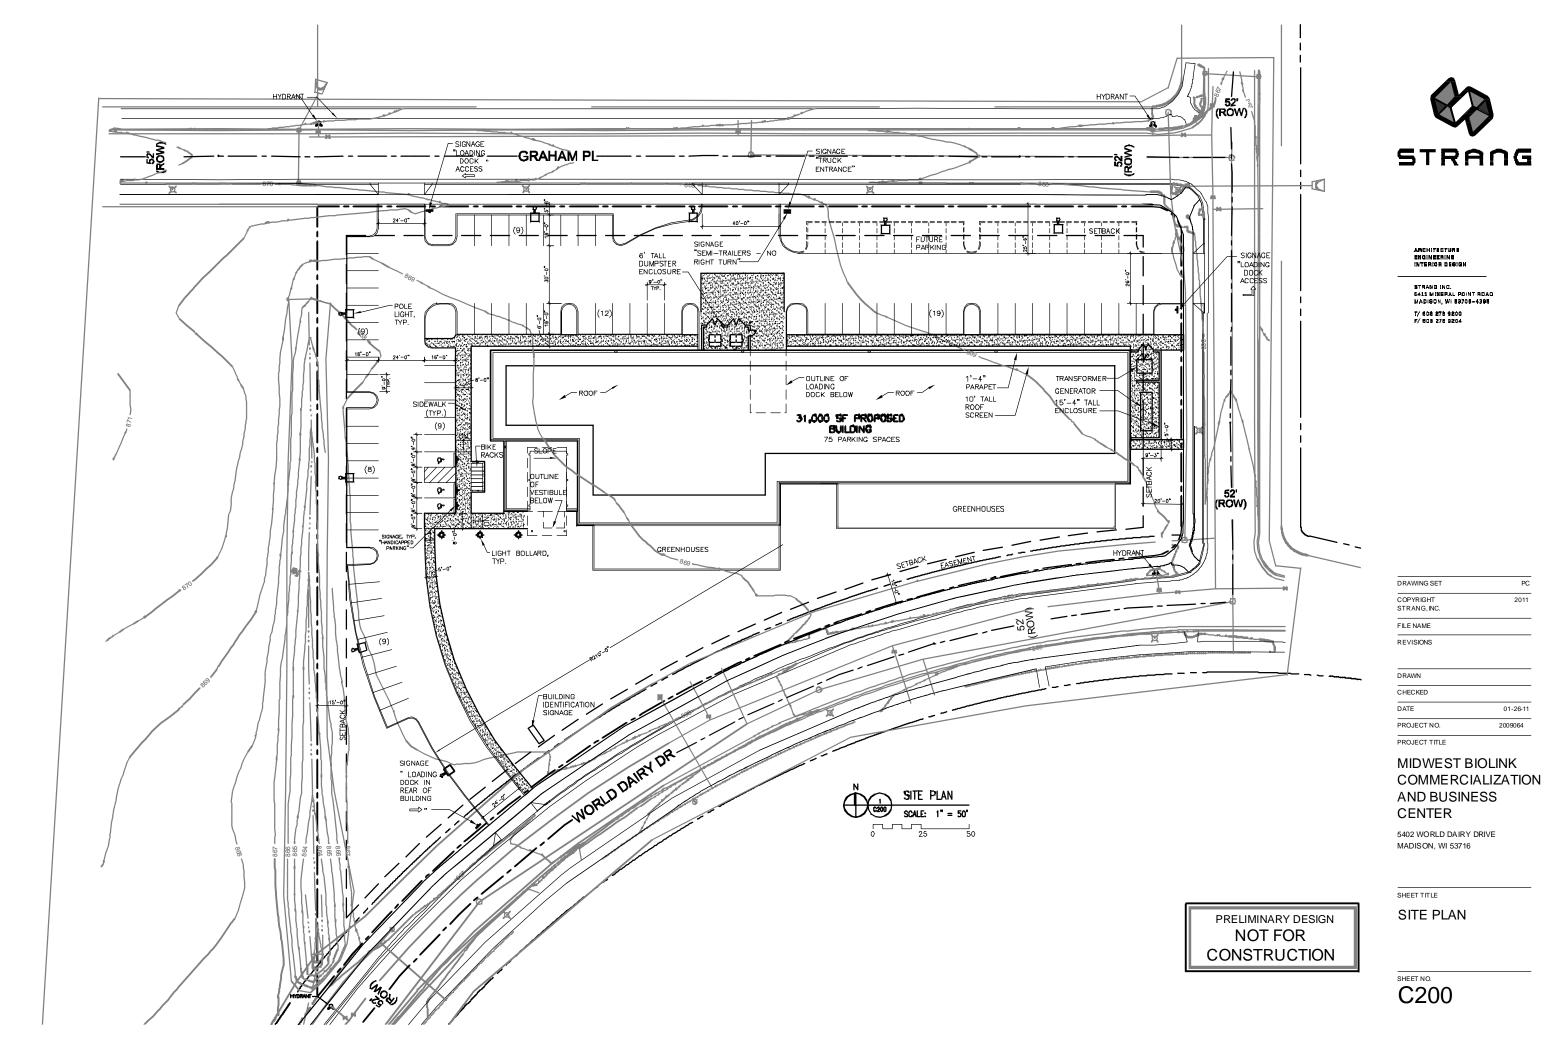

SOUTH ELEVATION

SCALE: 3/32" = 1'-0"

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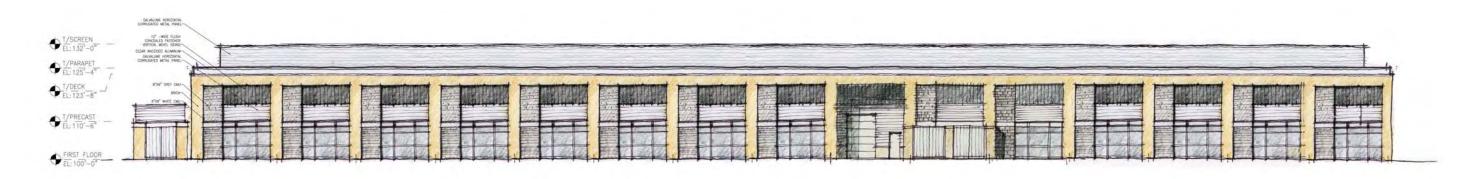


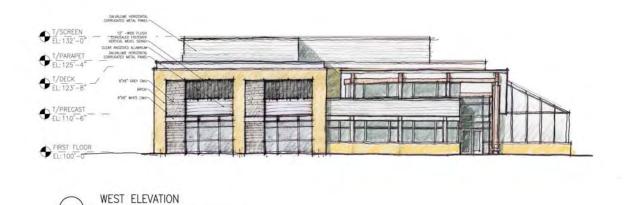

3 EAST ELEVATION

SCALE: 3/32" = 1'-0"

ARCHITECTURE ENGINEERING INTERIOR DESIGN







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