URBAN DESIGN COMMISSION APPLICATION

UDC

City of Madison Planning Division Madison Municipal Building, Suite 017 215 Martin Luther King, Jr. Blvd. P.O. Box 2985 Madison, WI 53701-2985 (608) 266-4635



FOR OFFICE USE ONLY:

Date Received _____

Initial Submittal

Paid _____

Signage

Other

Please specify

Revised Submittal

Complete all sections of this application, including the desired meeting date and the action requested. If your project requires both UDC <u>and</u> Land Use application submittals, a completed <u>Land Use Application</u> and accompanying submittal materials are also required to be submitted.

If you need an interpreter, translator, materials in alternate formats or other accommodations to access these forms, please call the Planning Division at (608) 266-4635.

Si necesita interprete, traductor, materiales en diferentes formatos, u otro tipo de ayuda para acceder a estos formularios, por favor llame al (608) 266-4635.

Yog tias koj xav tau ib tug neeg txhais lus, tus neeg txhais ntawv, los sis xav tau cov ntaub ntawv ua lwm hom ntawv los sis lwm cov kev pab kom paub txog cov lus qhia no, thov hu rau Koog Npaj (Planning Division) (608) 266-4635.

Comprehensive Design Review (CDR)

Modifications of Height, Area, and Setback

Sign Exceptions as noted in Sec. 31.043(3), MGO

1. Project Information

Address (list all addresses on the project site): _____

Title: _____

2. Application Type (check all that apply) and Requested Date

UDC meeting date requested

| New development | Alteration to an existing or prev | viously-approved development |
|-----------------|-----------------------------------|------------------------------|
| Informational | Initial Approval | Final Approval |

3. Project Type

Project in an Urban Design District

Project in the Downtown Core District (DC), Urban Mixed-Use District (UMX), or Mixed-Use Center District (MXC)

Project in the Suburban Employment Center District (SEC), Campus Institutional District (CI), or Employment Campus District (EC)

Planned Development (PD)

General Development Plan (GDP) Specific Implementation Plan (SIP)

Planned Multi-Use Site or Residential Building Complex

4. Applicant, Agent, and Property Owner Information

| Applicant name | Company |
|-----------------------------------|----------------|
| Street address | City/State/Zip |
| Telephone | Email |
| Project contact person | Company |
| Street address | City/State/Zip |
| Telephone | Email |
| Property owner (if not applicant) | |
| Street address | City/State/Zip |
| Telephone | Email |
| | |

Introduction

The City of Madison's Urban Design Commission (UDC) has been created to:

- Encourage and promote high quality in the design of new buildings, developments, remodeling, and additions so as to maintain and improve the established standards of property values within the City.
- Foster civic pride in the beauty and nobler assets of the City, and in all other ways possible assure a functionally efficient and visually attractive City in the future.

Types of Approvals

There are three types of requests considered by the UDC:

- <u>Informational Presentation</u>. A request for an Informational Presentation to the UDC may be requested prior to seeking any
 approvals to obtain early feedback and direction before undertaking detailed design efforts. Applicants should provide
 details on the context of the site, design concept, site and building plans, and other relevant information to help the UDC
 understand the proposal and provide feedback. (Does not apply to CDR's or Signage Modification requests)
- <u>Initial Approval</u>. Applicants may, at their discretion, request Initial Approval of a proposal by presenting preliminary design information. As part of their review, the Commission will provide feedback on the design information that should be addressed at Final Approval stage.
- <u>Final Approval</u>. Applicants may request Final Approval of a proposal by presenting all final project details. Recommendations or concerns expressed by the UDC in the Initial Approval must be addressed at this time.

Presentations to the Commission

The Urban Design Commission meets virtually via Zoom, typically on the second and fourth Wednesdays of each month at 4:30 p.m. Applicant presentations are strongly encouraged, although not required. Prior to the meeting, each individual speaker is required to complete an online registration form to speak at the meeting. A link to complete the online registration will be provided by staff prior to the meeting. Please note that individual presentations will be limited to a **maximum of three (3) minutes**. The pooling of time may be utilized to provide one speaker more time to present, however the additional time will be based on the number of registrants from the applicant team, i.e. two (2) applicant registrants = six (6) minutes for one (1) speaker.

Primarily, the UDC is interested in the appearance and design quality of projects. Emphasis should be given to the site plan, landscape plan, lighting plan, building elevations, exterior building materials, color scheme, and graphics. Please note that presentation slides, in a PDF file format, are required to be submitted **the Friday before** the UDC meeting.

URBAN DESIGN DEVELOPMENT PLANS CHECKLIST

The items listed below are minimum application requirements for the type of approval indicated. Please note that the UDC and/ or staff may require additional information in order to have a complete understanding of the project.

Providing additional

information beyond these

a greater level of feedback

minimums may generate

from the Commission.

1. Informational Presentation

- Locator Map
- Letter of Intent (If the project is within an Urban Design District, a summary of <u>how</u> the development proposal addresses the district criteria is required)
- Contextual site information, including photographs and layout of adjacent buildings/structures
- □ Site Plan
- □ Two-dimensional (2D) images of proposed buildings or structures.

2. Initial Approval

- Locator Map
- □ Letter of Intent (If the project is within a Urban Design District, a summary of <u>how</u> the development proposal addresses the district criteria is required)
- Contextual site information, including photographs and layout of adjacent buildings/structures
- □ Site Plan showing location of existing and proposed buildings, walks, drives, bike lanes, bike parking, and existing trees over 18" diameter
- □ Landscape Plan and Plant List (must be legible)
- Building Elevations in <u>both</u> black & white and color for all building sides, including material and color callouts
- PD text and Letter of Intent (if applicable)

3. Final Approval

All the requirements of the Initial Approval (see above), plus:

- □ Grading Plan
- Lighting Plan, including fixture cut sheets and photometrics plan (must be legible)
- Utility/HVAC equipment location and screening details (with a rooftop plan if roof-mounted)
- □ Site Plan showing site amenities, fencing, trash, bike parking, etc. (if applicable)
- D PD text and Letter of Intent (if applicable)
- □ Samples of the exterior building materials
- □ Proposed sign areas and types (if applicable)

4. Signage Approval (Comprehensive Design Review (CDR), Sign Modifications, and Sign Exceptions (per Sec. 31.043(3))

- Locator Map
- Letter of Intent (a summary of how the proposed signage is consistent with the CDR or Signage Modifications criteria is required)
- □ Contextual site information, including photographs of existing signage both on site and within proximity to the project site
- □ Site Plan showing the location of existing signage and proposed signage, dimensioned signage setbacks, sidewalks, driveways, and right-of-ways
- Proposed signage graphics (fully dimensioned, scaled drawings, including materials and colors, and night view)
- □ Perspective renderings (emphasis on pedestrian/automobile scale viewsheds)
- □ Illustration of the proposed signage that meets <u>Ch. 31, MGO</u> compared to what is being requested
- Graphic of the proposed signage as it relates to what the <u>Ch. 31, MGO</u> would permit

Requirements for All Plan Sheets

- 1. Title block
- 2. Sheet number
- 3. North arrow
- 4. Scale, both written and graphic
- 5. Date
- Fully dimensioned plans, scaled at 1"= 40' or larger

** All plans must be legible, including the full-sized landscape and lighting plans (if required)

> Providing additional information beyond these minimums may generate a greater level of feedback from the Commission.

UDC

5. Required Submittal Materials

Application Form

• A completed application form is required for <u>each</u> UDC appearance. For projects also requiring Plan Commission approval, applicants must also have submitted an accepted application for Plan Commission consideration prior to obtaining any formal action (Initial or Final Approval) from the UDC.

Letter of Intent

- If the project is within an Urban Design District, a summary of how the development proposal addresses the district criteria is required.
- For signage applications, a summary of how the proposed signage is consistent with the applicable Comprehensive Design Review (CDR) or Signage Modification review criteria is required.

Development Plans (Refer to checklist on Page 4 for plan details)

Filing Fee (Refer to Section 7 (below) for a list of application fees by request type)

Electronic Submittal

- Complete electronic submittals <u>must</u> be received prior to the application deadline before an application will be scheduled for a UDC meeting. Late materials will not be accepted. All plans must be legible and scalable when reduced. Individual PDF files of each item submitted should be submitted via email to <u>UDCapplications@cityofmadison.com</u>. The email must include the project address, project name, and applicant name.
- Email Size Limits. Note that <u>an individual email cannot exceed 20MB</u> and <u>it is the responsibility of the applicant</u> to present files in a manner that can be accepted. Applicants who are unable to provide the materials electronically should contact the Planning Division at (608) 266-4635 for assistance.

Notification to the District Alder

• Please provide an email to the District Alder notifying them that you are filing this UDC application. Please send this as early in the process as possible and provide a copy of that email with the submitted application.

6. Applicant Declarations

- 2. The applicant attests that all required materials are included in this submittal and understands that if any required information is not provided by the application deadline, the application will not be placed on an Urban Design Commission agenda for consideration.

Name of applicant _

Authorizing signature of property owner _____

_____ Relationship to property_____ Alex Weis _____ Date____

7. Application Filing Fees

Fee payments are due by the submittal date. Payments received after the submittal deadline may result in the submittal being scheduled for the next application review cycle. Fees may be paid in-person, via US Mail, or City drop box. If mailed, please mail to: *City of Madison Building Inspection, P.O. Box 2984, Madison, WI 53701-2984*. The City's drop box is located outside the Municipal Building at 215 Martin Luther King, Jr. Blvd. on the E Doty Street side of the building. Please make checks payable to *City Treasurer,* and include a completed application form or cover letter indicating the project location and applicant information with all checks mailed or submitted via the City's drop box.

Please consult the schedule below for the appropriate fee for your request:

Urban Design Districts: \$350 (per <u>§33.24(6) MGO</u>).

Minor Alteration in the Downtown Core District (DC) or Urban Mixed-Use District (UMX) : \$150 (per <u>\$33.24(6)(b) MGO</u>)

Comprehensive Design Review: \$500 (per §31.041(3)(d)(1)(a) MGO)

Minor Alteration to a Comprehensive Sign Plan: \$100 (per §31.041(3)(d)(1)(c) MGO)

All other sign requests to the Urban Design Commission, including, but not limited to: appeals from the decisions of the Zoning Administrator, requests for Sign Modifications (of height, area, and setback), and additional sign code approvals: \$300 (per §31.041(3)(d)(2) MGO)

A filing fee is not required for the following project applications if part of the combined application process involving both Urban Design Commission and Plan Commission:

Date

- Project in the Downtown Core District (DC), Urban Mixed-Use District (UMX), or Mixed-Use Center District (MXC)
- Project in the Suburban Employment Center District (SEC), Campus Institutional District (CI), or Employment Campus District (EC)
- Planned Development (PD): General Development Plan (GDP) and/or Specific Implementation Plan (SIP)
- Planned Multi-Use Site or Residential Building Complex



October 7, 2024

City of Madison Plan Commission & Urban Design Commission c/o City of Madison Planning Division 215 Martin Luther King Jr. Blvd, Suite 017 Madison, WI 53701

Sent via email only:

Plan Commission: <u>PCApplications@cityofmadison.com</u> Urban Design Commission: <u>UDCApplications@cityofmadison.com</u>

Re: Letter of Intent Plan Commission Land Use Application & Urban Design Commission Final Approval Project: 6701 McKee Rd Mixed-Use Development

City of Madison Plan Commission and Urban Design Commission Members:

On behalf of our client, Livesey Company LLC, JLA Architects is pleased to submit SIP application materials to the City of Madison Plan Commission and Urban Design Commission for final land use for a mixed-use development located at 6701 McKee Rd. This Letter of Intent serves as a summary to the enclosed submittal documents for this Project.

Project Team:

Owner: Livesey Company LLC, 2248 Deming Way, Suite 200 Middleton, WI 53562 Architect of Record: JLA Architects, 800 W. Broadway, Suite 200, Monona, WI 53713 Civil Engineer: D'Onofrio Kottke and Associates, 7530 Westward Way, Madison, WI 53717 Landscape Designer: Olson Toon Landscaping, Inc. 3570 Pioneer Rd. Verona, WI 53593

Site & Surroundings:

The lot is comprised of 111,071 SF (2.55 acres) of currently undeveloped land at the SW corner of McKee Rd. and Maple Grove Dr. The property will have strong pedestrian and bicycle linkages, carefully planned parking areas and green spaces. The building will be designed with four-sided architecture consistent with the existing buildings located on adjacent properties, following guidelines reviewed as part of the original GDP. The mixed-use building will be oriented toward Maple Grove Dr, with entrances to the parking areas located on Mader Dr. (a private road which presently connects Stone Creek Dr. to Maple Grove Dr.)

Lot Size = 111,071 SF/ 2.55 acres Lot Area/Dwelling Unit = 889 SF/Unit Open Space Requirement = 40 SF/Unit Proposed Impervious Area = 32,366 SF Total Building Area = 51,348 SF Impervious Surface Ratio = 0.754

UDC and PD Zoning History:

Content for this section has been taken from the 'Planning Division Staff Report' for the Urban Design Commission dated September 25, 2024.

- UDC made and advisory recommendation to the Plan Commission to grant Final Approval of the Planned Development- General Development Plan (PD-GDP) on January 11, 2023.
- Plan Commission conditionally approved the PD-GDP on January 23, 2023.
- The Common Council conditionally approved the PD-GDP on February 7, 2023.
 - The common council conditionally approved the PD-GDP, which included conditions of approval, including a condition to "Reduce the on-site parking to create more green space, especially adjacent to the Building Area A2 on the northwest side of the building."
- The project site is located within the Maple Grove Commons General Development Plan- Planned Development (est. 2010).
- The site holds the Neighborhood Mixed-Use land use recommendation per the Comprehensive Plan adopted by the City for the area.

Project Overview:

The project is a 3-story multi-family/commercial mixed-use building of approximately 60,000 developed square feet as illustrated in the submitted design documents. The lower level connects the two sections of multi-family apartments and contains 2500 SF of ground floor tenant commercial/retail space, refuse enclosures, and resident parking. The exact square footage of the project may vary slightly as the design is refined and finalized.

The development will feature a variety of amenities that enhance the quality of life for the residents including a fitness center, clubroom with access to an extensive outdoor amenity patio featuring a pool and lounge seating around multiple fire tables, secure bicycle storage, private resident storage lockers, and electric vehicle charging stations. The property is ideal for fostering a vibrant and connected community, making it an attractive option for potential tenants.

The 125 residential units will have the following unit mix- as illustrated in the submitted design document.

- Studio Units: 40 (32%)
- 1 Bedroom: 65 (52%)
- 2 bedrooms: 20 (16%)

Parking and Traffic Circulation:

Parking is available for the commercial tenant(s), residents and their guests over two surface parking lots while 104 restricted-access parking stalls for residents is available within the lower level parking garage. Both surface parking lots are accessible from Mader Dr., at the south end of the property, with lower level garage access at the southwest corner of the lot. Refuse and recycling rooms will be accessed by Waste Management from the southwest approach on Mader Dr.

The final parking counts contain:

- 104 Total Below-Grade Parking Stalls
- 84 Above-Ground Off-Street Parking Stalls
- 188 Total Parking Stalls
- 9 Accessible Parking Stalls (6 surface lot, 3 below-grade)
- 11 (10%) 'Electric Vehicle Ready' Spaces per MGO 28.141(8)(e)
- 3 (2%) "Electrical Vehicle Installed' Spaces per MGO 28.141(8)(e)

In addition to vehicular parking, the project will have 131 bicycle parking spaces to meet the requirements of MGP 28.141(11).

- Residential Long Term (Interior) = 125
- Commercial Short Term (Exterior) = 6

Urban Design Commission Informational:

The project was presented to the Urban Design Commission on September 25, 2024 for an informational meeting and received the following notable comments, which have been addressed in the submitted documentation:

- Include louver panels in the SIP submittal elevations:
 - All visible louver panels have been added to the elevations and measures taken to reduce the visibility of them from street-facing facades by matching the panel color to the surrounding exterior material and recessing panels under balconies and behind railings.
- Consider adding interest or design elements to the building entries at the NE corner of the site to connect to the east façade street level.
 - An additional patio amenity space has been added to the NE corner off the resident fitness center to connect the building to the pedestrian entry off Maple Grove Dr. and connect the resident experience to the neighboring businesses surrounding the intersection of McKee Rd. and Maple Grove Dr.
- Make improvements to the landscape to soften exposed base level of structures and add taller landscaping to building elements facing McKee Rd.
 - Landscaping has been significantly enhanced and added to on and along the amenity patio screen wall. A uniquely designed fencing screen wall and plantings have been added around the dog run at the NW corner of the lot and additional plantings have been incorporated along all facades where exposed parking level is present, most notably the west-facing façade of the property facing the neighboring commercial building.

Neighborhood Engagement:

- Pre-Application Alder Engagement/Notification: August 26, 2024
- Pre-Application Meeting with Alder Wehelie, District 7 and Planning Staff: September 10, 2024
- UDC Informational Meeting: September 25, 2024

6701 McKee Rd. Mixed-Use Development JLA Project No.: 22-0201 October 7, 2024

- Land Use Application Submittal: October 7, 2024
- Neighborhood Meeting: November 7, 2024
- UDC Meeting: November 20, 2024
- Plan Commission Meeting: December 2, 2024
- Common Council Meeting: December 10, 2024

Project Schedule:

Construction is anticipated to start in March 2025 and be completed for resident leases beginning in Spring 2026.

JLA Architects and Livesey Company LLC respectfully requests the Urban Design Commission review the application materials for the upcoming UDC meeting on November 20, 2024. Thank you very much for considering our proposal. We are excited for the opportunity to contribute to the City of Madison's west-side housing development initiatives.

Sincerely,

9E

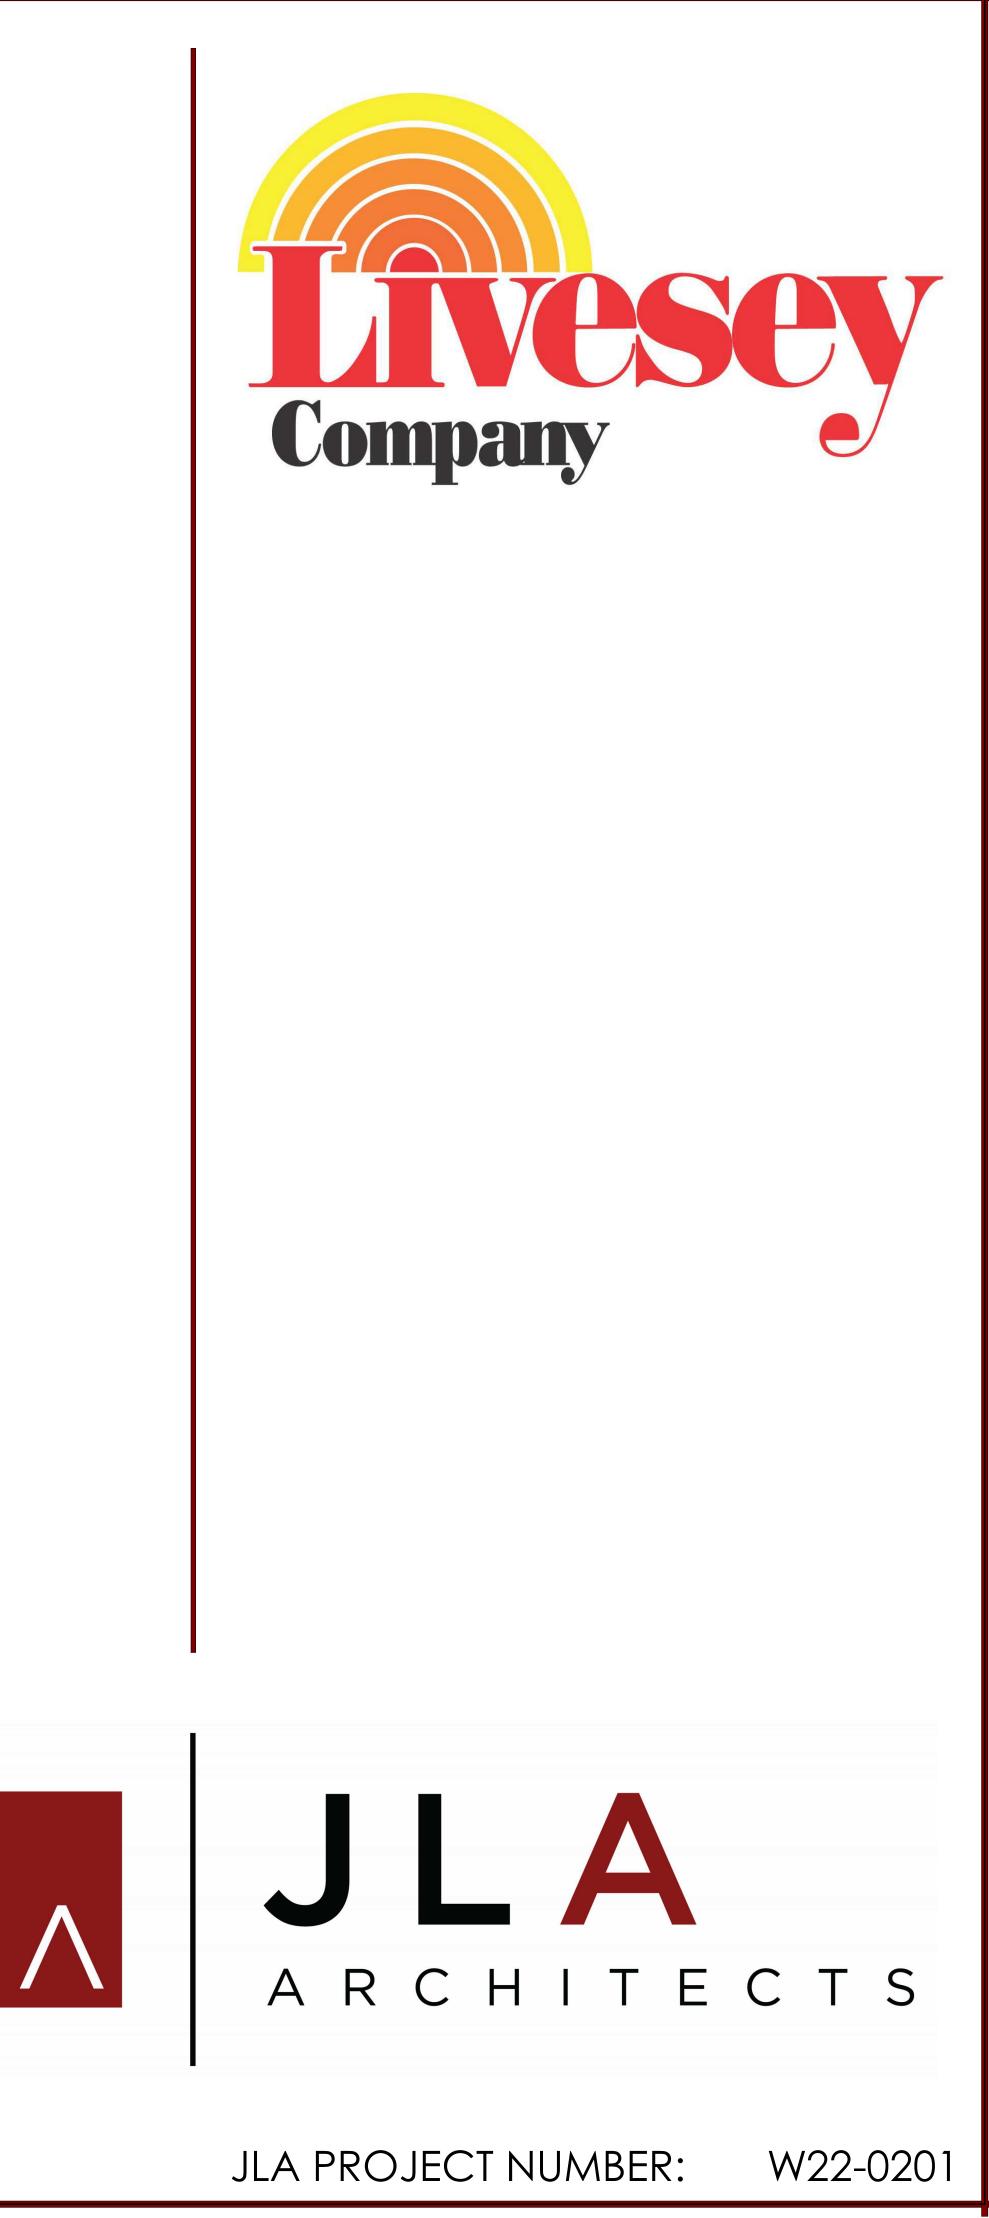
Abby Hultman JLA Architects- Project Manager

MCKEE ROAD MIXED USE DEVELOPMENT 6701 MCKEE ROAD MADISON, WISCONSIN 53719



CITY OF MADISON LAND USE AND URBAN DESIGN COMMISSION SUBMITTAL

OCTOBER 18, 2024



Mckee ROAD MIXED-USE DEVELOPMENT BUILDING A1

October 7, 2024


| | UNIT NAME | | STUDIO | | 1 BEDI | ROOM | 2 BEDROOMS | AL | AL MS | ERCIAL REA ABLE | VTIAL REA BLE | ROSS N (S.F.) | ICΥ | С [-: | G D | щ Ц С | <u>ں</u> | |
|----|-------------|-------|--------|-------|--------|-------|------------|--------------|----------|-----------------------|----------------------|------------------|------------|----------|-------|----------------|------------|-----------|
| | | A1 | A2 | A3 | B1 | B2 | D1 | NITS | 101 | N A S | AF | sro A (S | EFFICIENC | A (S.I | VERED | RFACE RKING | ARKIN | |
| | BEDROOMS | 1 | 1 | 1 | 1 | 1 | 2 | Ξ | EDR 1 | | RESID NET LEA: | (3) G AREA | Ĕ | PAI | PAF | SURF. PARK | PAR | 2 |
| | AREA (S.F.) | 558 | 559 | 584 | 718 | 680 | 1,249 | | B | Ŭ | 8 | A | Ξ | _ ◄ | 01 | , H | | |
| R | 3RD | 2 | 1 | 4 | 9 | 2 | 4 | 22 | 26 | - | 16,829 | 19,460 | 86.5% | | | | | |
| 0 | 2ND | 2 | 1 | 4 | 9 | 2 | 4 | 22 | 26 | - | 16,829 | 19,460 | 86.5% | | | | RETAIL | RATIO |
| ΓO | 1ST | 2 | 0 | 3 | 9 | 2 | 0 | 16 | 16 | | 10,690 | 19,460 | 54.9% | | | 19 | 7.6 | PER 1K SF |
| F | LL | | | | | | | | | 2,500 | | 24,628 | 10.2% | 21,350 | 54 | 18 | PER UNIT | PER BR |
| | TOTALS | 6 | 2 | 11 | 27 | 6 | 8 | 60 | 68 | 2,500 | 44,348 | 83,008 | 53.4% | 21,350 | 54 | 18 | 1.20 | 1.06 |
| | PERCENT | 10.0% | 3.3% | 18.3% | 45.0% | 10.0% | 13.3% | | | | | | | | | | | |
| | FERCEINT | | 31.7% | | 55. | .0% | 13.3% | . | | | 739 | Average N.S.F | . per unit | | 395 | Average | S.F. per s | space |

October 7, 2024

| | UNIT NAME | | STUDIO | | 1 BED | ROOM | 2 BEDROOMS | AL | AL MS | ERCIAL KREA ABLE | NTIAL REA \BLE | OSS (S.F.) | lcγ | PARKING REA (S.F.) | ଘ ଦ୍ର | IG CE | <u>ں</u> | ~ |
|--------|-------------|-------|--------|-------|-------|------|------------|------------|---------------------|------------------------|-----------------------------------|----------------|------------|-----------------------|--------|--------------------|------------|--------|
| | | A1 | A2 | A3 | B1 | B2 | D1 | NITS | (1) TOTA BEDROOI | MER ARI SAB | RESIDENTI NET AREA LEASABLE | e | EFFICIENC | A (S | OVERED | SURFACE PARKING | ARKING | Ĭ |
| | BEDROOMS | 1 | 1 | 1 | 1 | 1 | 2 | Ξ Ξ | Ξü | OMMI NET A LEASA | ESII LEA | (3) GI AREA | Ĕ | RE | PAF | SUR | PAF | Z |
| | AREA (S.F.) | 558 | 559 | 584 | 718 | 680 | 1,249 | | - 8 | ŭ | R | ~ 4 | Ξ | < | 0- | | | |
| R | 3RD | 2 | 1 | 4 | 9 | 2 | 4 | 22 | 26 | - | 16,829 | 19,460 | 86.5% | | | | | |
| 0 | 2ND | 2 | 1 | 4 | 9 | 2 | 4 | 22 | 26 | - | 16,829 | 19,460 | 86.5% | | | | | |
| 0 | 1ST | 3 | 0 | 4 | 8 | 2 | 4 | 21 | 25 | (1 72 | 16,110 | 19,460 | 82.8% | | | | | |
| L L | LL | | | | | | | | | () | - | 24,628 | 0.0% | 24,300 | 50 | 43 | PER UNIT | PER BR |
| | TOTALS | 7 | 2 | 12 | 26 | 6 | 12 | 65 | 77 | Ĩ | 49,768 | 83,008 | 60.0% | 24,300 | 50 | 43 | 1.43 | 1.21 |
| | PERCENT | 10.8% | 3.1% | 18.5% | 40.0% | 9.2% | 18.5% | | | | | | | | | | | |
| | FERCEINI | | 32.3% | | 49. | .2% | 18.5% | C | | | 766 | Average N.S.F | . per unit | | 486 | Average S | S.F. per s | pace |

NOTES:

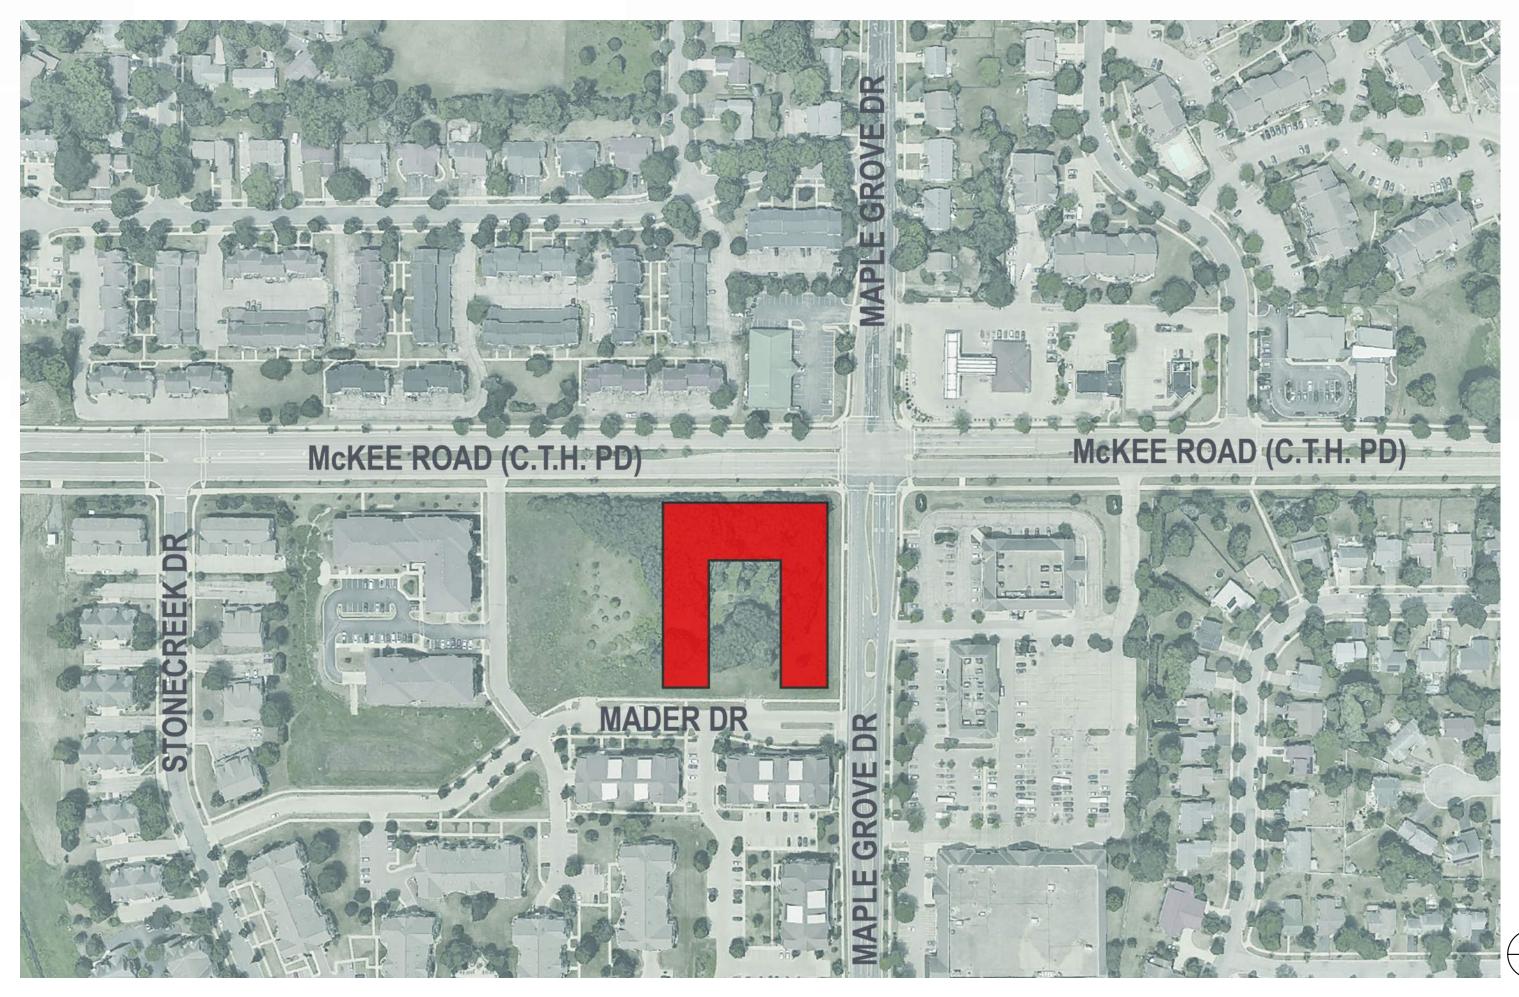- **3** GROSS AREA DOES NOT INCLUDE PARKING AREAS.
- 5 PARKING AREAS INCLUDE THE STAIRS & ELEVATOR.



| J | L | A | | | | |
|-----|----|----|---|---|---|---|
| ARO | сн | ΙT | E | С | Т | S |
| | | | | - | | |

973 Average G.S.F per unit

A R C H I T E C T S

McKEE ROAD MIXED-USE DEVELOPMENT BUILDING A2

898 Average G.S.F per unit

1 TOTAL UNIT & BEDROOM COUNT ASSUMES IDENTICAL FOOTPRINT FROM FLOORS 2 & 3.


2 TABLE ABOVE ASSUMES 3,500 S.F. (+/-) OF COMMON AMENITY SPACE ON 1st FLOOR. ADDITIONAL COMMON AMENTIY SPACE WOULD REDUCE NET LEASABLE S.F. OF THE BUILDING.


4 1st FLOOR IN EACH BUILDING CONTAINS THE MAIN ENTRY LOBBY AT MID-LEVEL.

6 LOWER LEVEL GROSS SQUARE FOOTAGE IS DIVIDED EQUALLY BETWEEN BUILDINGS A1 & A2.

PROJECT LOCATOR MAP

| | SHEET INDEX - UDC SUBMITTAL |
|--------------|---------------------------------------|
| SHEET NUMBER | SHEET NAME |
| U000 | COVER |
| U001 | INDEX SHEET |
| C100 | SITE LAYOUT PLAN |
| C200 | SITE GRADING PLAN |
| C300 | SITE UTILITY PLAN |
| C400 | CONSTRUCTION DETAILS |
| C500 | FIRE ACCESS PLAN |
| L100 | LANDSCAPE PLAN |
| U010 | EXISTING SITE CONTEXT PHOTOS |
| U011 | EXISTING SITE CONTEXT PHOTOS |
| USP-100 | MASTER SITE PLAN |
| U100 | LOWER LEVEL PLAN |
| U101 | FIRST FLOOR PLAN |
| U102 | TYPICAL FLOOR PLAN |
| U103 | ROOF PLAN |
| U200 | EXTERIOR ELEVATIONS |
| U201 | EXTERIOR ELEVATIONS |
| U202 | EXTERIOR ELEVATIONS |
| U210 | EXTERIOR ELEVATIONS- BIRDGLASS |
| U211 | EXTERIOR ELEVATIONS- BIRDGLASS |
| U212 | EXTERIOR ELEVATIONS- BIRDGLASS |
| U213 | BIRDGLASS CALCULATIONS |
| U220 | EXTERIOR MATERIALS & BUILDING DETAILS |
| U230 | EXTERIOR RENDERINGS |
| U231 | EXTERIOR RENDERINGS |
| U232 | EXTERIOR RENDERINGS |
| U233 | EXTERIOR RENDERINGS |
| U234 | EXTERIOR RENDERINGS |
| U235 | EXTERIOR RENDERINGS |
| U236 | EXTERIOR RENDERINGS |
| U300 | BUILDING SECTIONS |
| U400 | SITE PHOTOMETRICS |

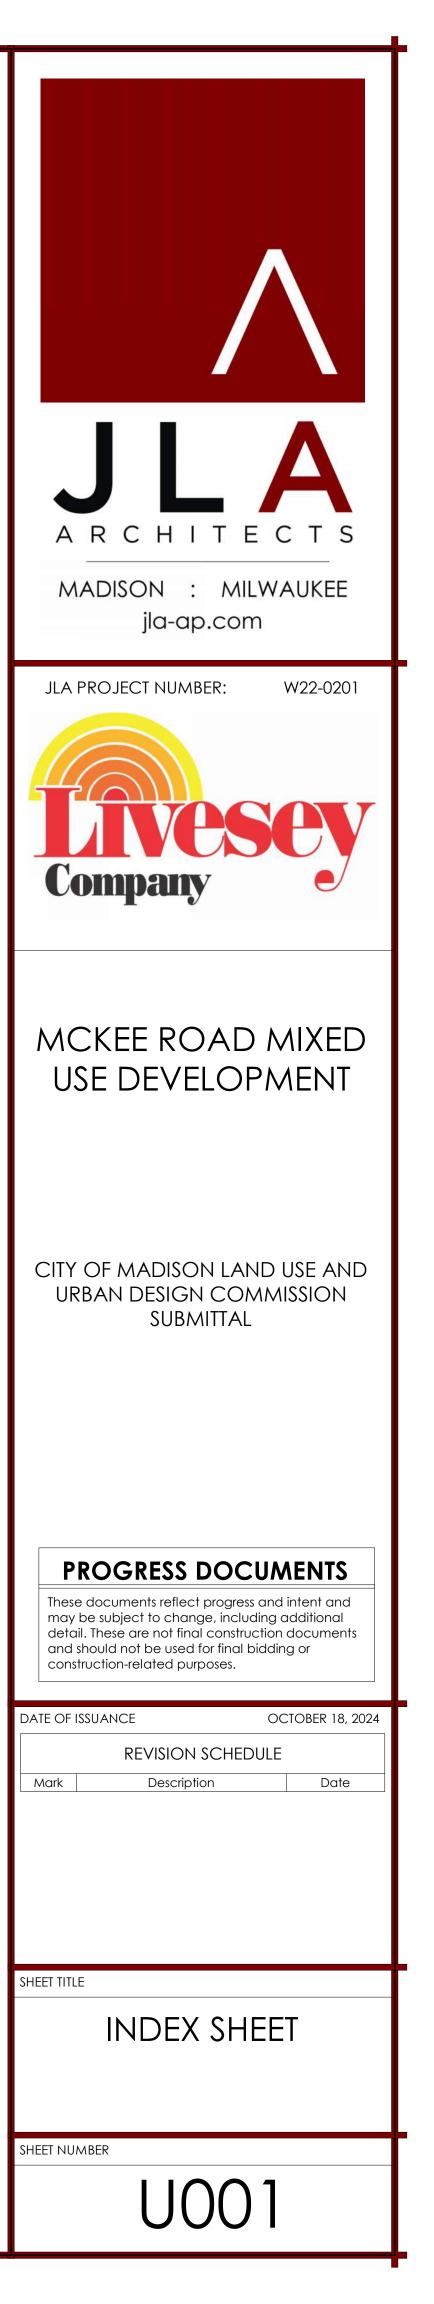

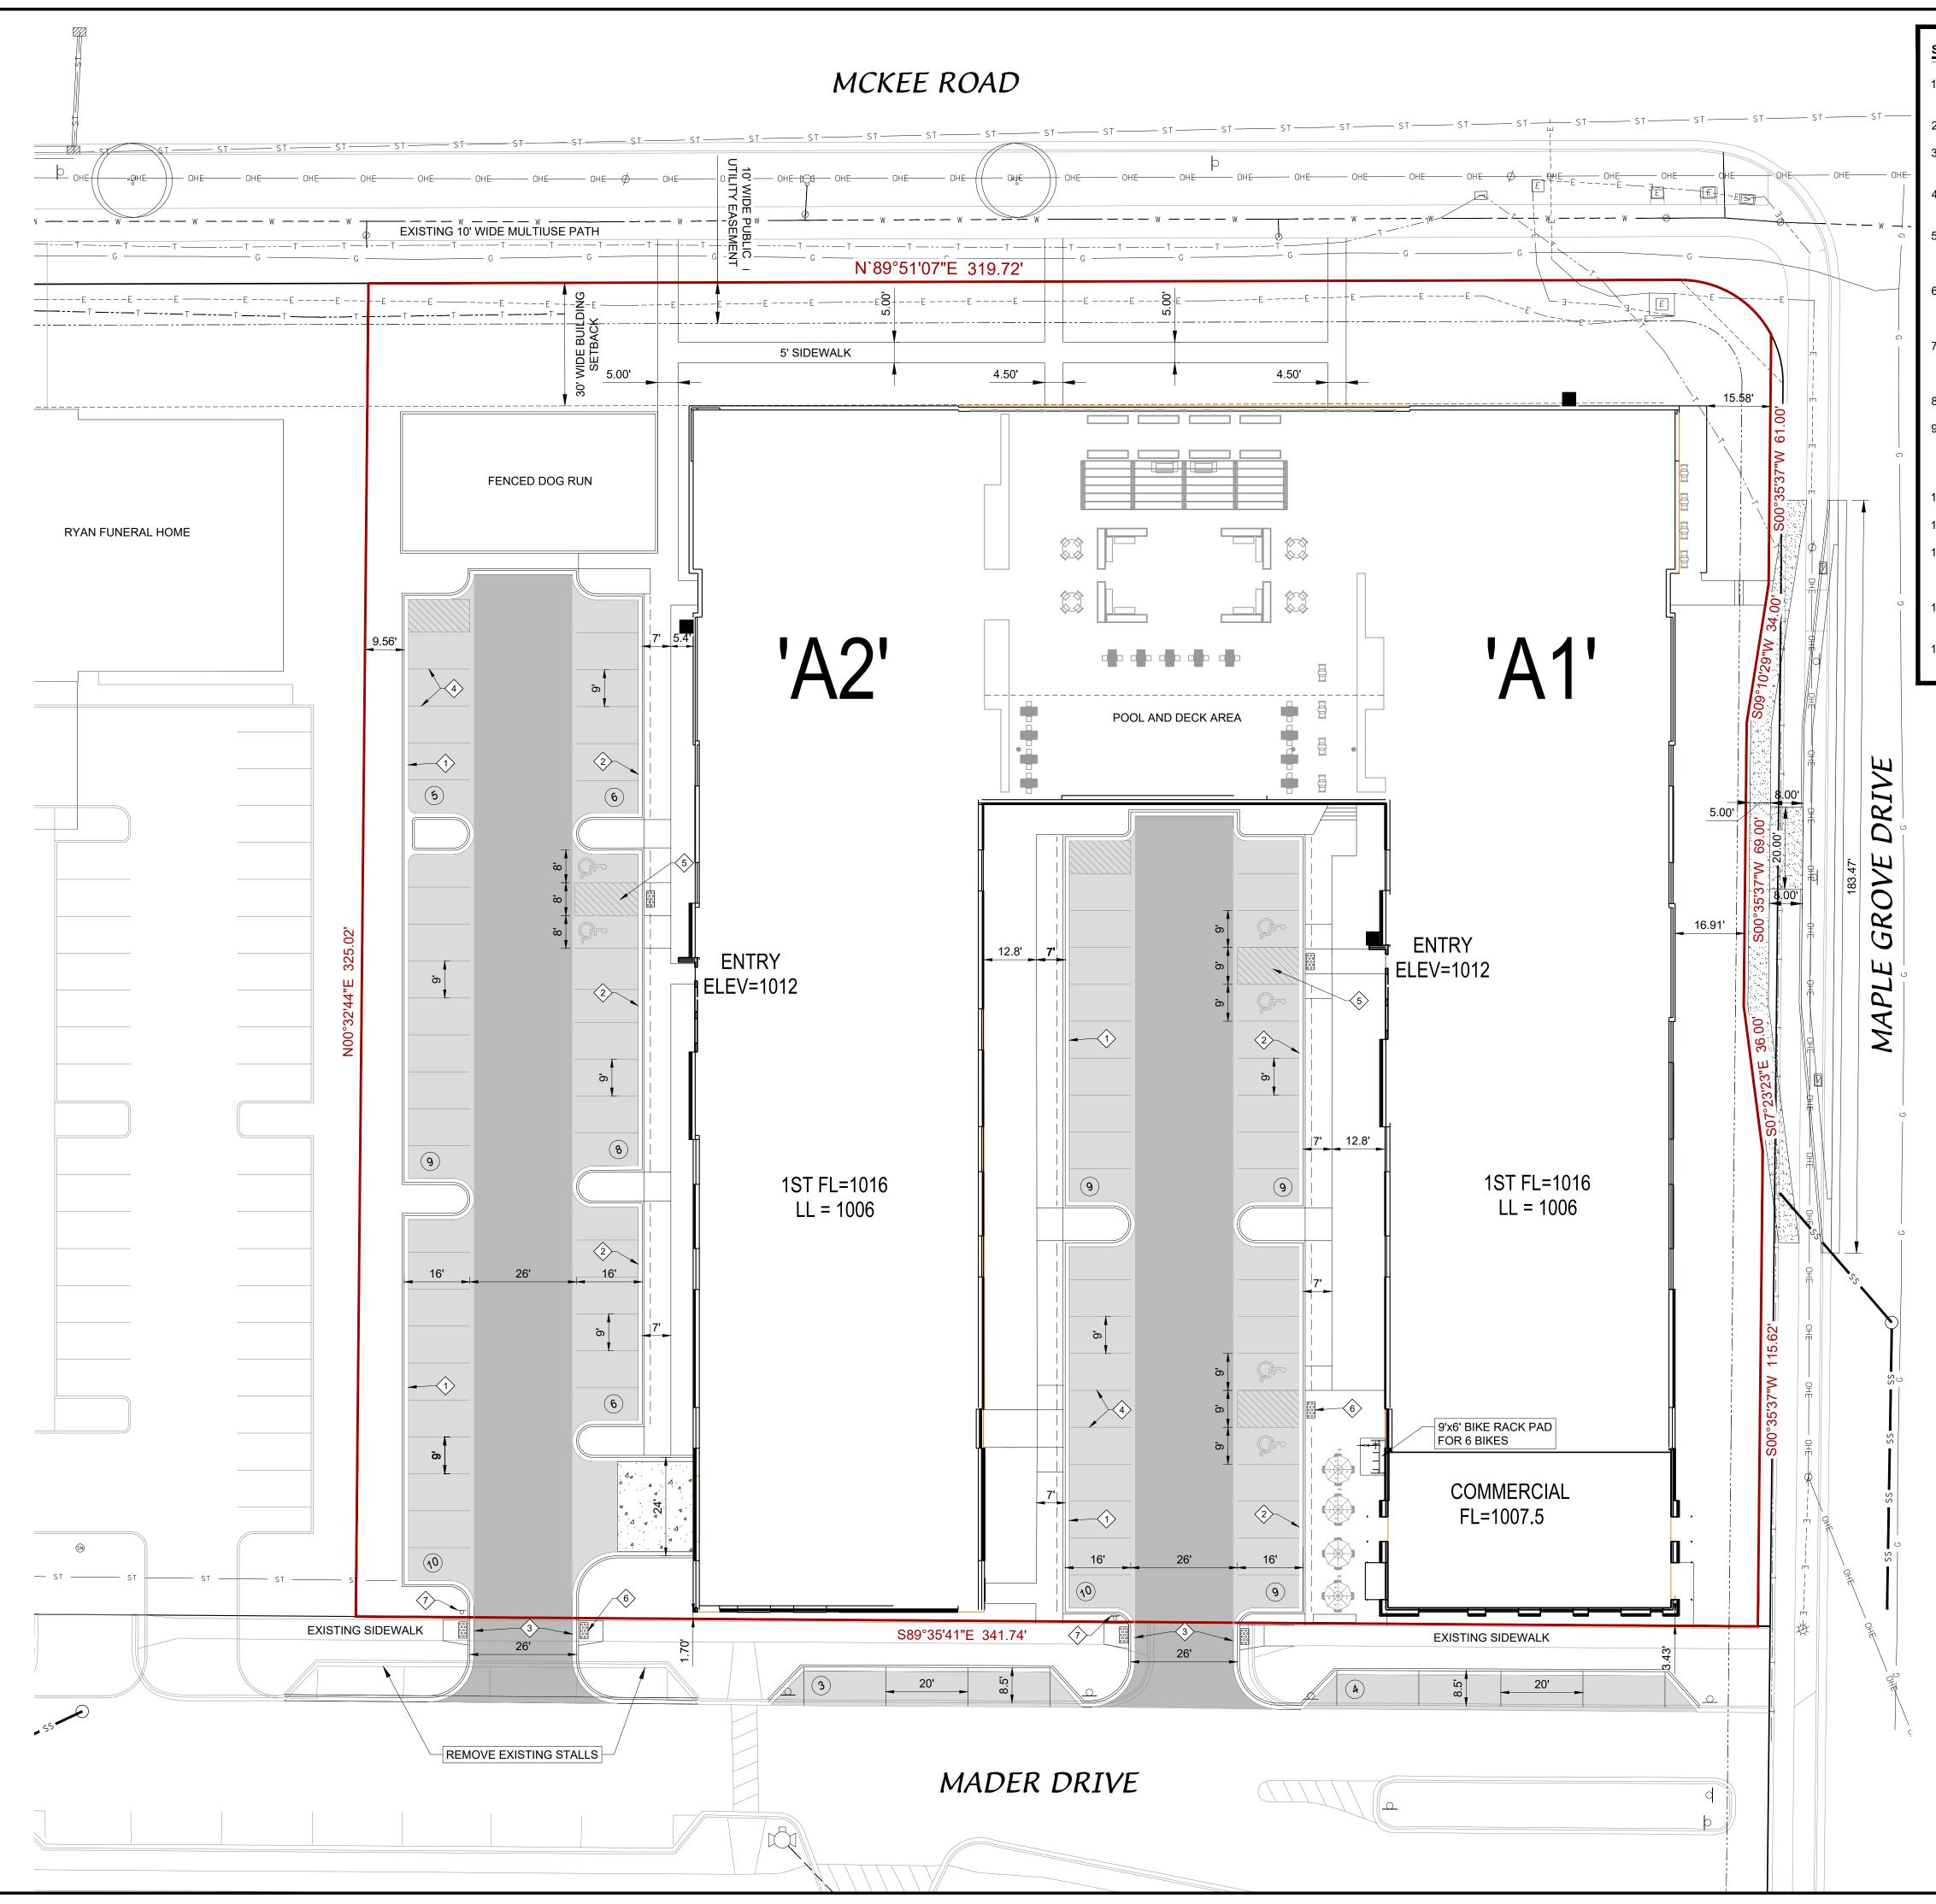



SITE PLAN NOTES


- SEE GRADING PLAN TO DETERMINE LOCATIONS OF HOLDING OR REJECT CURBS.
- 2. PROVIDE CONTROL JOINTS 10'+/- O.C. PROVIDE EXPANSION JOINTS 50' O.C.
- EARTHWORK CONTRACTOR TO SUBGRADE AND STONE 12" BEYOND BACK OF CURB TO PROVIDE COMPACTED LEVELING BASE FOR CURB AND GUTTER.
- EARTHWORK CONTRACTOR TO OVER EXCAVATE/CLEAN OUT ALL LANDSCAPE AREAS TO ALLOW FOR THE PLACEMENT OF 12" OF BLACK DIRT/TOPSOIL.
- EARTHWORK CONTRACTOR TO REMOVE ALL EXCESS STONE BEHIND BACK OF CURB IN LANDSCAPE ISLANDS. THIS APPLIES TO EXCESS STONE BEYOND 12" AT BACK OF CURB.
- . PAVING CONTRACTOR SHALL PROVIDE FLUSH ASPHALT PAVING TO CONCRETE CURB. IF SURFACE COURSE IS RAISED AFTER PAVING, PAVING CONTRACTOR SHALL HEAT UP, REMOVE AND COMPACT EXCESS PAVEMENT.
- IF ANY ERRORS, DISCREPANCIES, OR DIMENSIONS WITH PLAN BECOME APPARENT. IT SHALL BE BROUGHT TO THE ATTENTION OF THE ENGINEER PRIOR TO CONSTRUCTION
- ALL DIMENSIONS TO FACE OF CURB UNLESS OTHERWISE NOTED
- CONTRACTOR SHALL REPLACE CURB AND GUTTER AND PAVEMENT WHICH ABUTS THE PROJECT AND IS DAMAGED BY CONSTRUCTION OR CURB AND GUTTER WHICH THE ENGINEER DETERMINES NEEDS TO BE REPLACED BECAUSE IT IS NOT AT A DESIRABLE GRADE
- 0. ALL WORK SHALL BE PER THE CITY OF MADISON STANDARD SPECIFICATIONS
- 1. CONTRACTOR IS RESPONSIBLE TO OBTAIN ANY AND ALL PERMITS REQUIRED.
- 12. THE RIGHT-OF-WAY IS THE SOLE JURISDICTION OF THE CITY OF MADISON AND IS SUBJECT TO CHANGE AT ANYTIME PER THE RECOMMENDATION/PLAN OF TRAFFIC ENGINEERING AND CITY ENGINEERING DEPARTMENTS.
- 13. UPON CONSULTATION, THE CITY TRAFFIC ENGINEER MAY DETERMINE A DELAY IN CONSTRUCTION OF THE STREETS IS APPROPRIATE
- 4. ALL WORK IN THE PUBLIC RIGHT-OF-WAY SHALL BE PERFORMED BY A CITY LICENSED CONTRACTOR

PAVEMENT LEGEND LIGHT DUTY PAVEMENT 3.5" ASPHALT (2.00" BINDER, 1.50" SURFACE) 4" UPPER BASE COURSE, 1-1/4" STONE 4" LOWER BASE COURSE, 3" STONE MEDIUM DUTY PAVEMENT 4" ASPHALT (2.25" BINDER, 1.75" SURFACE) 4" UPPER BASE COURSE, 1-1/4" STONE 6" LOWER BASE COURSE, 3" STONE CONCRETE SIDEWALK 4" CONCRETE OVER 3" GRANULAR BASE CONCRETE PAVEMENT 6" CONCRETE W/WIRE MESH REINFORCEMENT 6" CRUSHED AGGREGATE BASE COURSE (10) PROPOSED PARKING SPACE COUNT KEYNOTES 18-INCH CURB & GUTTER (TYPE D - ACCEPTING PAN) 2 18-INCH CURB & GUTTER (TYPE D - REJECTING PAN) (3) DEPRESSED CURB & GUTTER (NO CURB HEAD) 4 4" WIDE PARKING SPACE STRIPING - TYP. (5) 4" WIDE STRIPING, 2' ON-CENTER, 45-DEGREES 6 2'x4' DETECTABLE WARNING FIELD $\langle \hat{7} \rangle$ STOP SIGN

| SITE PLAN INFORMATION BLOCK | |
|----------------------------------------------------------------------------------------------------------------------------------------------------------------------------------------------------------------------------------------------|--------------------------------------------------------------------------------|
| PROPERTY AREA EXISTING IMPERVIOUS AREA PROPOSED IMPERVIOUS AREA TOTAL BUILDING AREA IMPERVIOUS SURFACE RATIO ABOVE-GROUND OFF-STREET STALLS BELOW GRADE STALLS TOTAL PARKING STALLS TOTAL ACCESSIBLE STALLS INCLUDED | 111,071 SF 0 SF 32,366 SF 51,348 SF 0.754 84 104 188 9 |
| | 9 |
| EXTERIOR BICYCLE STALLS | <u>9</u> <u>6</u> 125 |
| INTERIOR BICYCLE STALLS TOTAL BICYCLE STALLS | 125 |

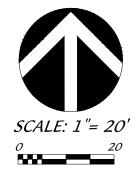

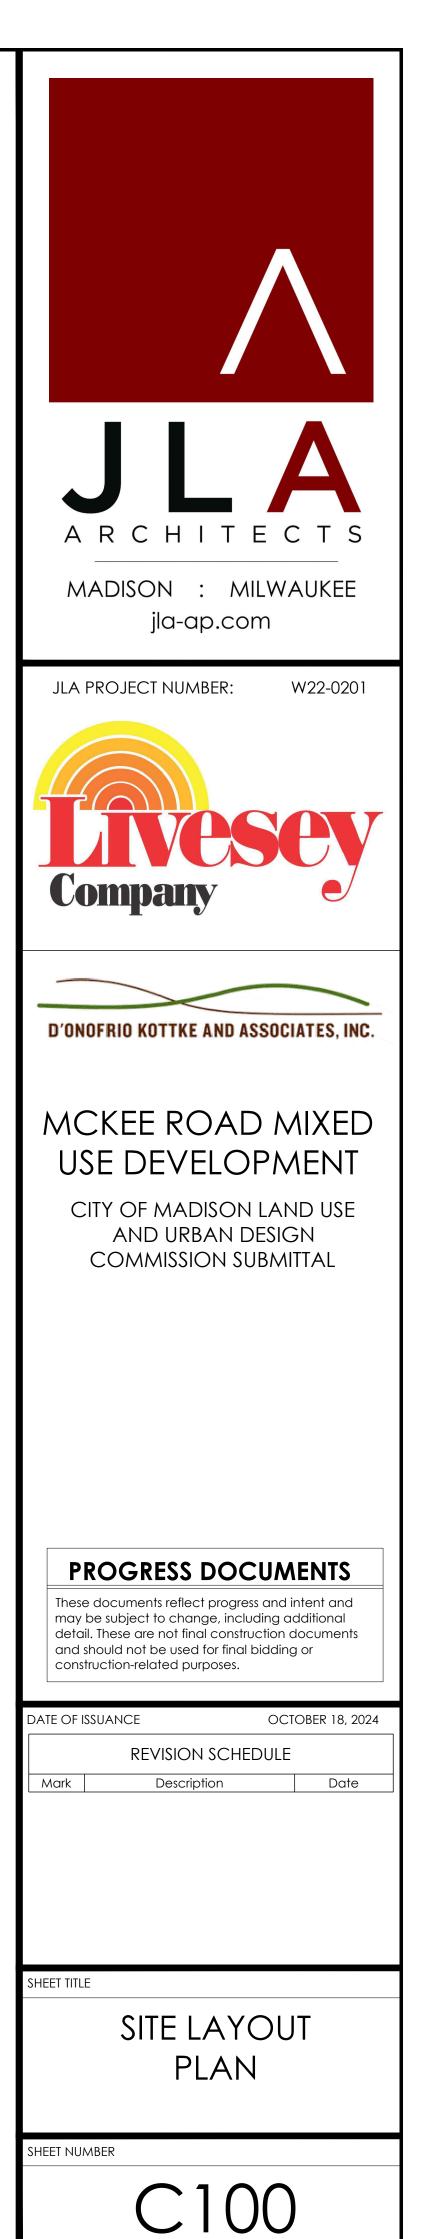

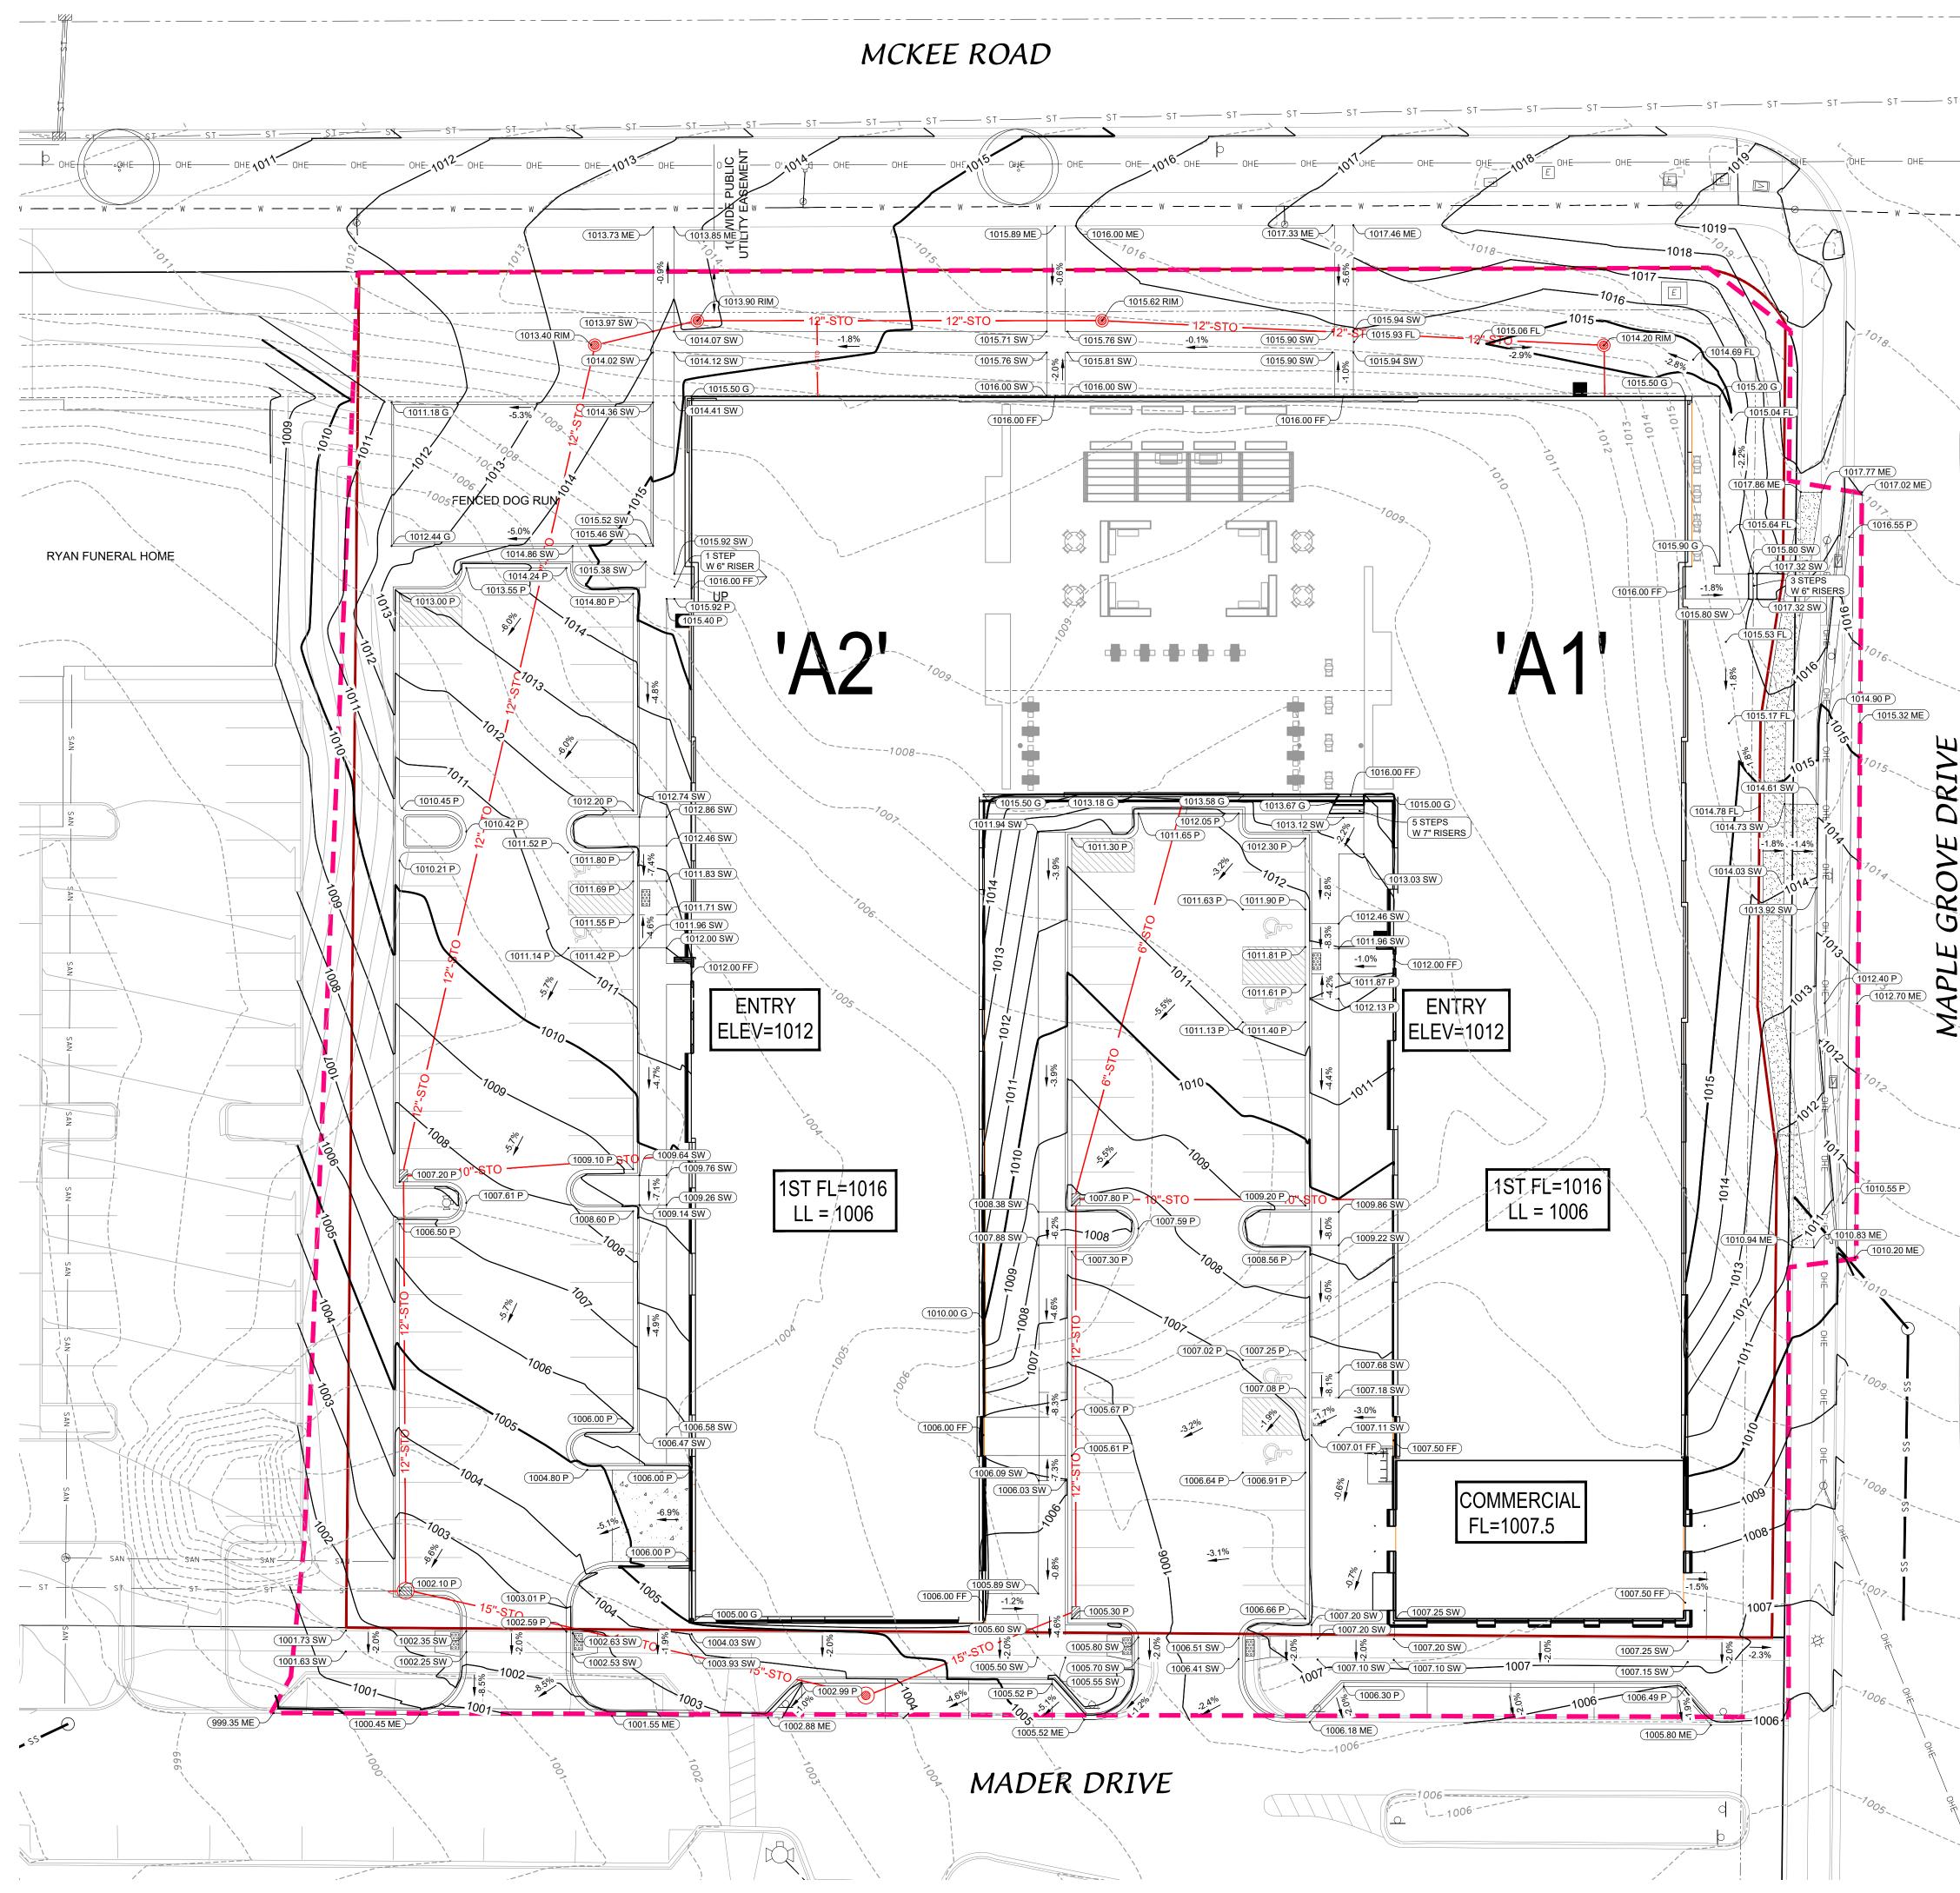

GRADING AND EROSION CONTROL NOTES:


- ALL EROSION CONTROL MEASURES SHALL BE CONSTRUCTED AND MAINTAINED BY THE CONTRACTOR IN ACCORDANCE WITH THE WISCONSIN DNR AND CITY OF MADISON TECHNICAL STANDARDS. IT IS THE CONTRACTOR'S RESPONSIBILITY TO OBTAIN A COPY OF THESE STANDARDS.
- INSTALL EROSION CONTROL MEASURES PRIOR TO ANY SITE WORK, INCLUDING GRADING OR DISTURBANCE OF EXISTING SURFACE MATERIALS AS SHOWN ON PLAN. MODIFICATIONS TO SEDIMENT CONTROL DESIGN MAY BE CONDUCTED TO MEET UNFORESEEN FIELD CONDITIONS IF MODIFICATIONS CONFORM TO CITY OR WDNR TECHNICAL STANDARDS TECHNICAL STANDARDS.
- EROSION CONTROL MEASURES INDICATED ON THE PLANS SHALL BE CONSIDERED MINIMUMS. IF DETERMINED NECESSARY DURING CONSTRUCTION ADDITIONAL MEASURES SHALL BE INSTALLED TO PREVENT SEDIMENT FROM LEAVING THE SITE.
- I. INSPECTIONS AND MAINTENANCE OF ALL EROSION CONTROL MEASURES SHALL BE ROUTINE (ONCE PER WEEK MINIMUM) TO ENSURE PROPER FUNCTION OF EROSION CONTROLS AT ALL TIMES. EROSION CONTROL MEASURES ARE TO BE IN WORKING ORDER AT THE END OF EACH WORK DAY.
- . INSPECT EROSION CONTROL MEASURES AFTER EACH 1/2" OR GREATER RAINFALL. REPAIR ANY DAMAGE OBSERVED DURING THE INSPECTION.
- 6. NO SITE GRADING OUTSIDE OF THE LIMITS OF DISTURBANCE 7. EROSION CONTROL MEASURES SHALL BE REMOVED ONLY AFTER SITE CONSTRUCTION IS COMPLETE WITH ALL SOIL SURFACES HAVING AN ESTABLISHED VEGETATIVE COVER
- 8. SLOPES EXCEEDING 4:1 SHALL BE STABILIZED WITH CLASS I, TYPE B EROSION MATTING AND ALL DRAINAGE SWALES SHALL BE STABILIZED WITH CLASS II, TYPE B EROSION MATTING.
- 9. ALL INCIDENTAL MUD TRACKING FROM CONSTRUCTION AND MATERIAL HAULING WILL OCCUR ON INTERNAL ROADS. TRACKING WILL BE KEPT ON-SITE AND CLEANED UP AND REMOVED BY THE END OF EACH WORKING DAY USING PROPER DISPOSAL METHODS.
- 10. ANY DISTURBED AREA EXPECTED TO BE DORMANT FOR GREATER THAN 5 DAYS SHALL BE STABILIZED WITH TEMPORARY SEEDING AND MULCH.
- 11. PREVENT EXCESSIVE DUST FROM LEAVING THE CONSTRUCTION SITE IN ACCORDANCE WITH LOCAL AND STATE REGULATIONS. 12. INSTALL EROSION CONTROLS ON THE DOWNSTREAM SIDE OF STOCKPILES.
- 13. AT A MINIMUM ALL DISTURBED AREAS SHALL RECEIVE A MINIMUM OF 4" OF TOPSOIL FERTILIZER, SEED AND MULCH. SEED MIXTURE SHALL BE WISCONSIN DOT SEED MIX #40 OR EQUIVALENT APPLIED AT A RATE OF 5 POUNDS PER 1000 SQFT ON ALL DISTURBED AREAS. ANNUAL RYEGRASS AT A RATE OF 1 2 POUNDS PER 1000 SQFT SHALL BE ADDED TO THE MIXTURE. FERTILIZER RATES SHALL BE PLACED PER A SOIL TEST.
- 14. EARTHWORK CONTRACTOR TO OVER EXCAVATE/CLEAN OUT ALL LANDSCAPE AREAS TO ALLOW FOR THE PLACEMENT OF 6" OF BLACK DIRT/TOPSOIL.
- 15. CONTRACTOR SHALL VERIFY DEPTH OF ALL UTILITIES TO ENSURE PROPOSED GRADES HAVE ENOUGH COVER.


GRADING PLAN LEGEND


| <u>965</u> | PROPOSED CONTOURS |
|------------------|--------------------------------------|
| | DISTURBED AREA |
| (1000.50 TC) | SPOT GRADE - TOP (BACK) OF CURB |
| (1000.50 T/WALL) | SPOT GRADE - TOP OF WALL |
| (1000.50 P) | SPOT GRADE - FINISH GRADE (PAVEMENT) |
| (1000.50 SW) | SPOT GRADE - SIDEWALK FINISH GRADE |
| (1000.50 G) | SPOT GRADE - GROUND (BOTTOM OF WALL) |

LIMITS OF DISTURBANCE

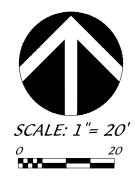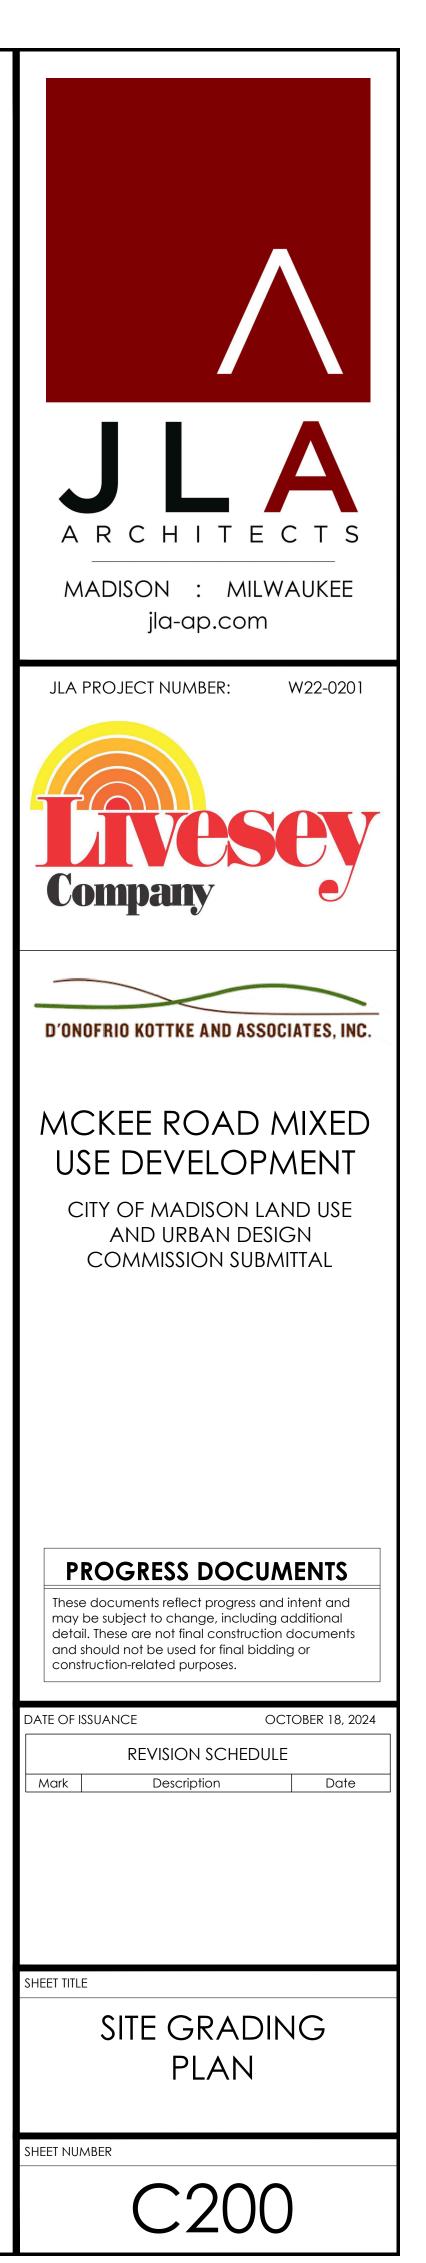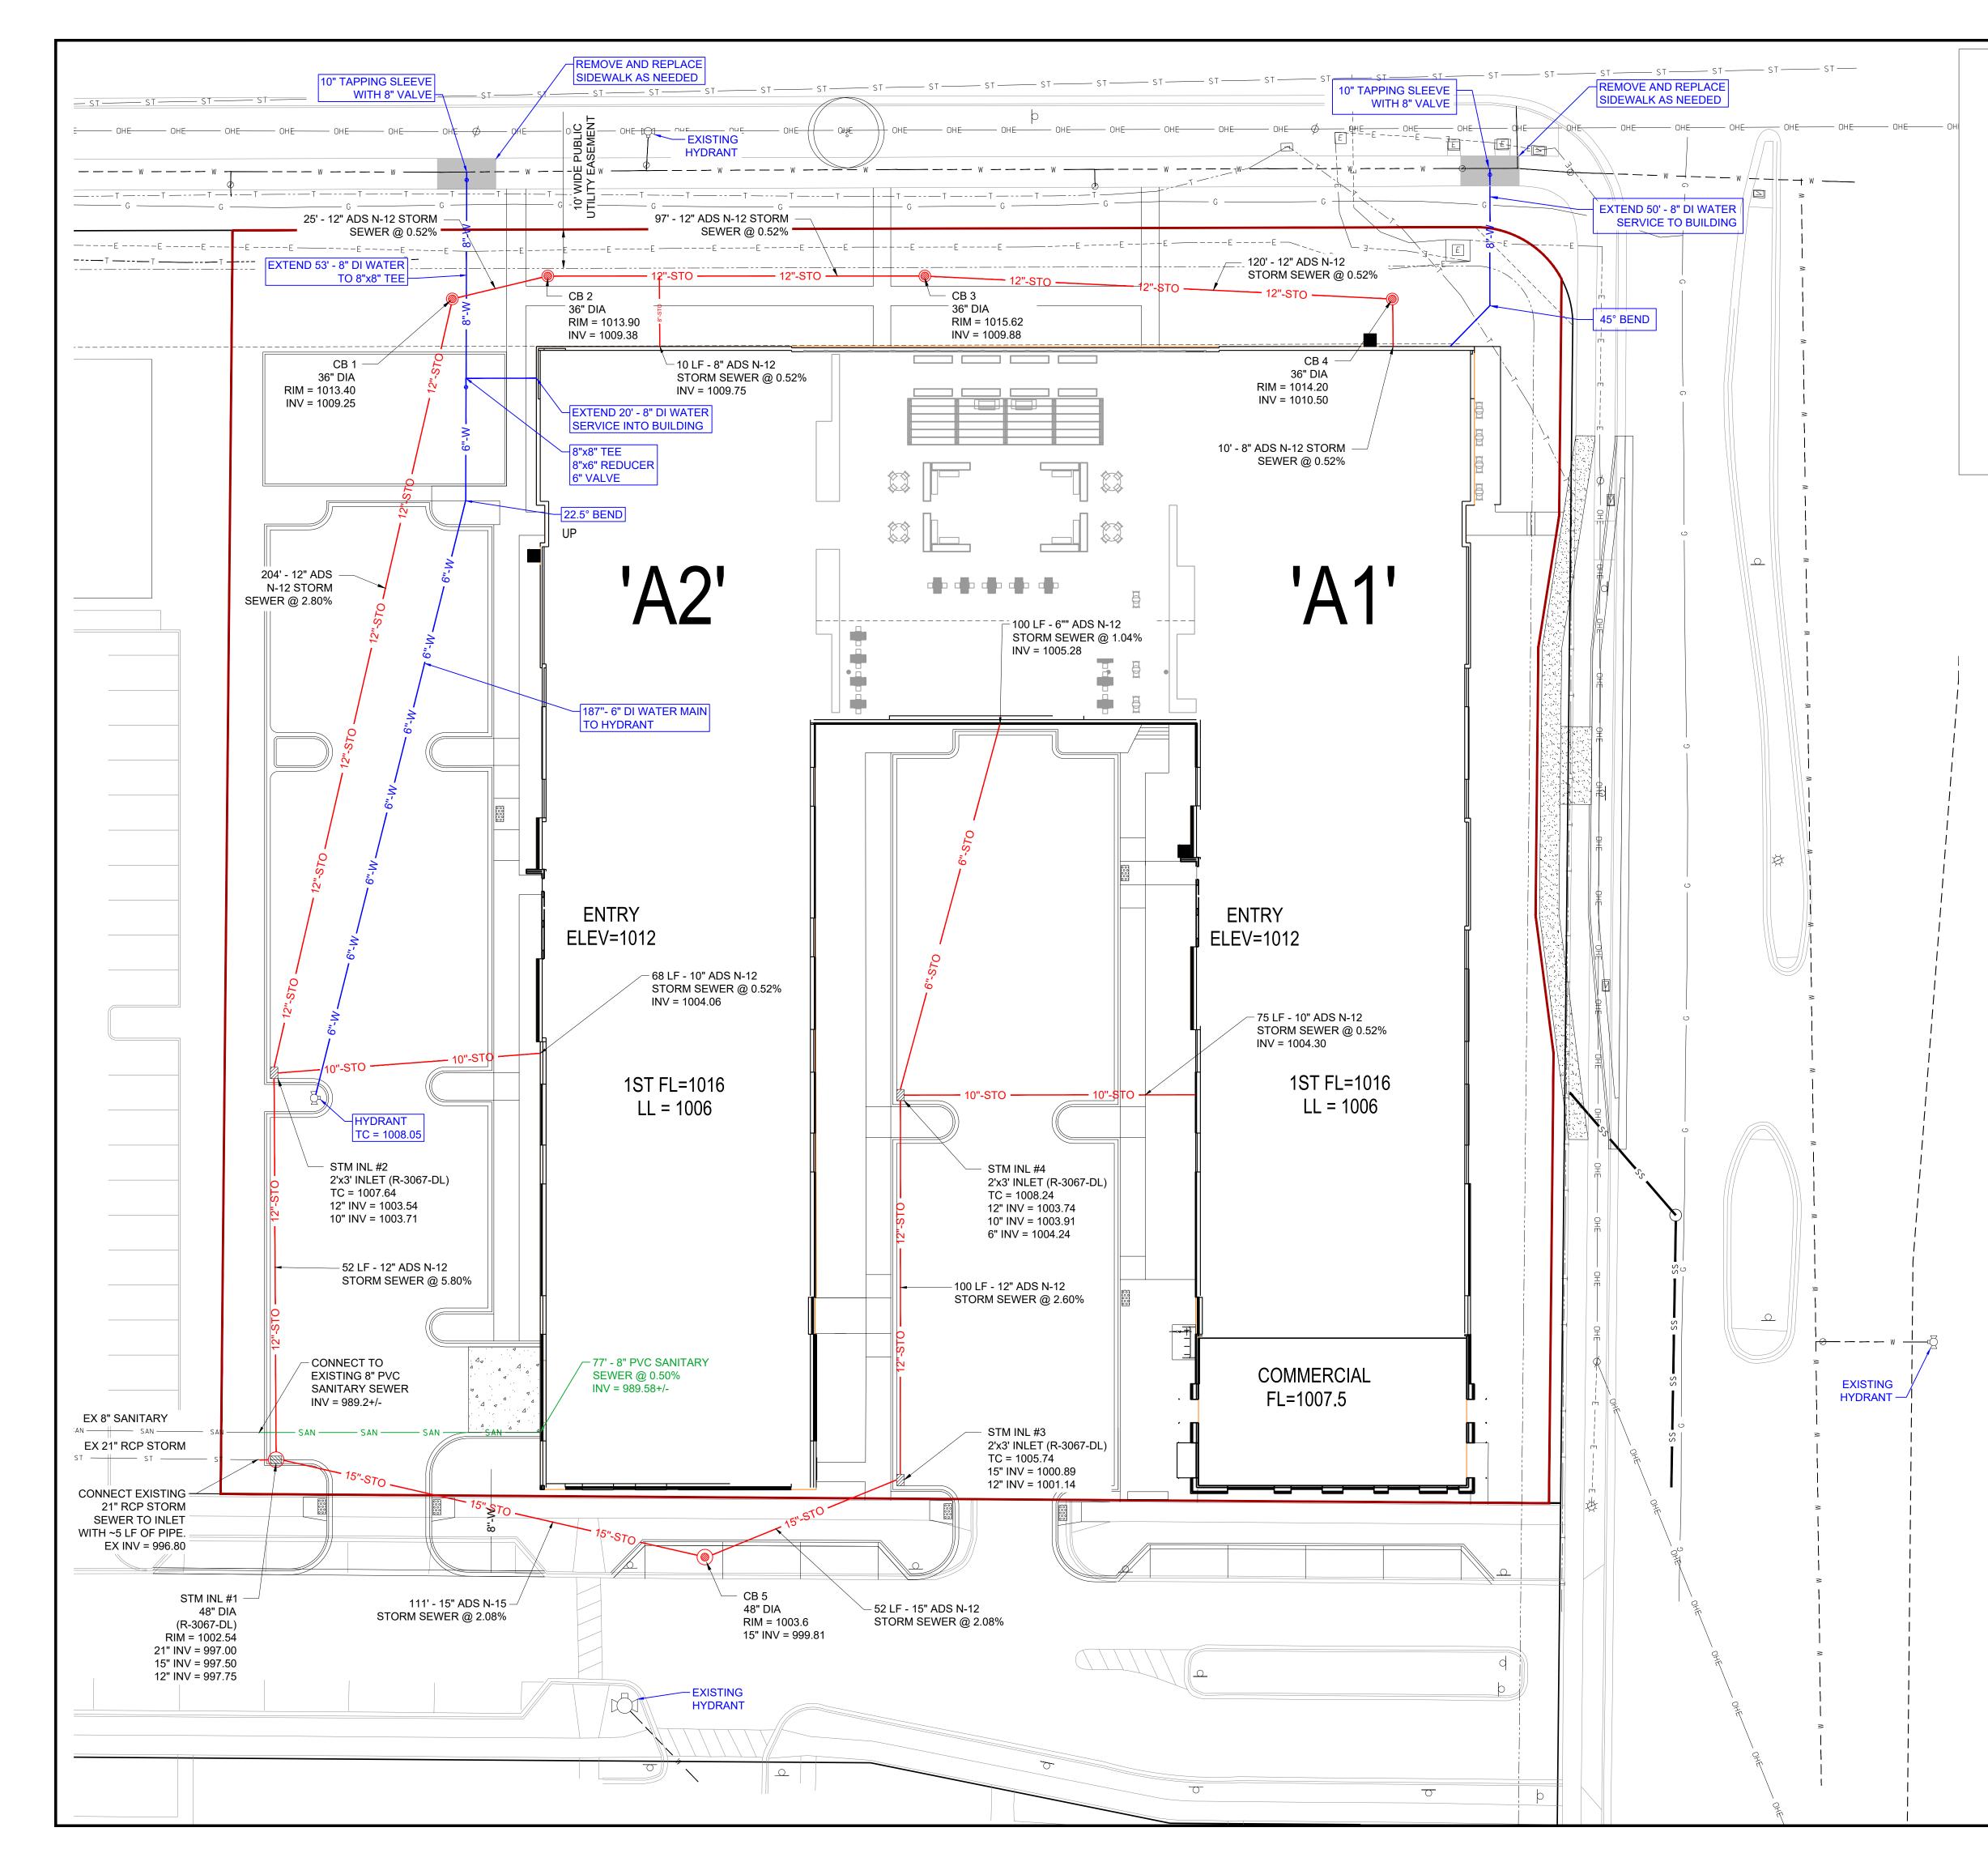= 120,500 SQ FT = 2.77 AC










SITE UTILITY NOTES

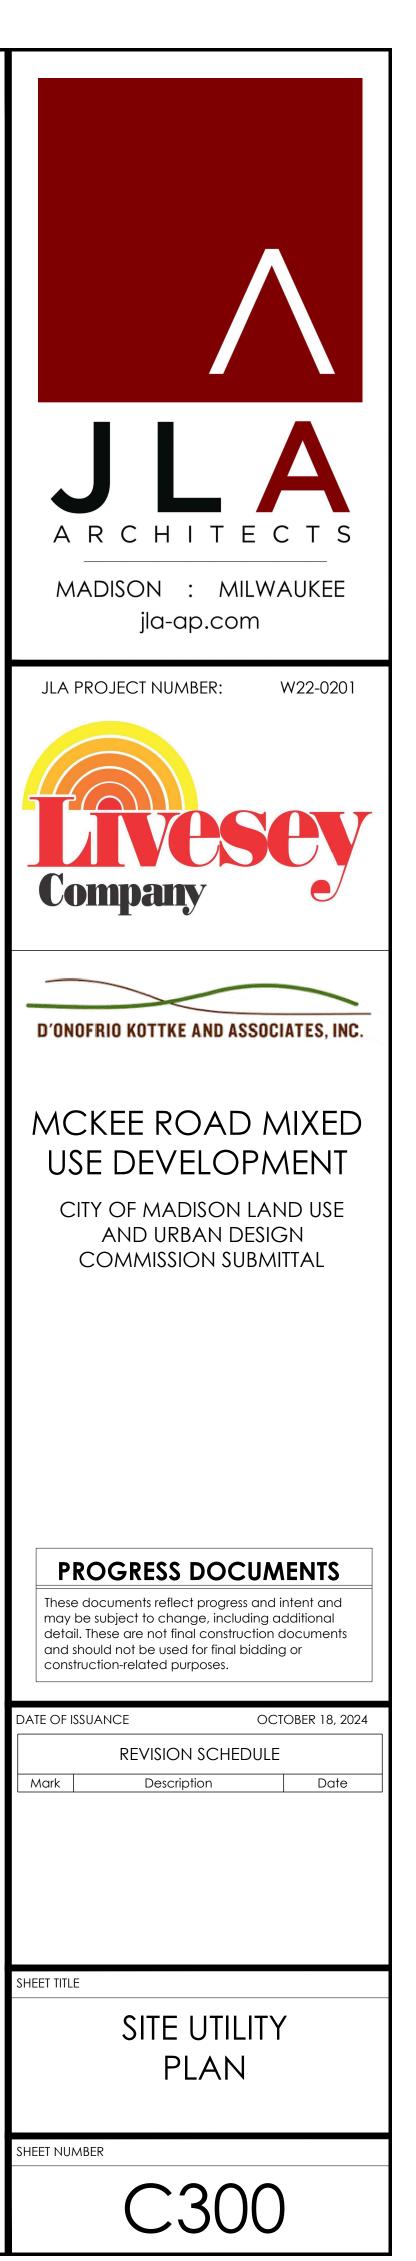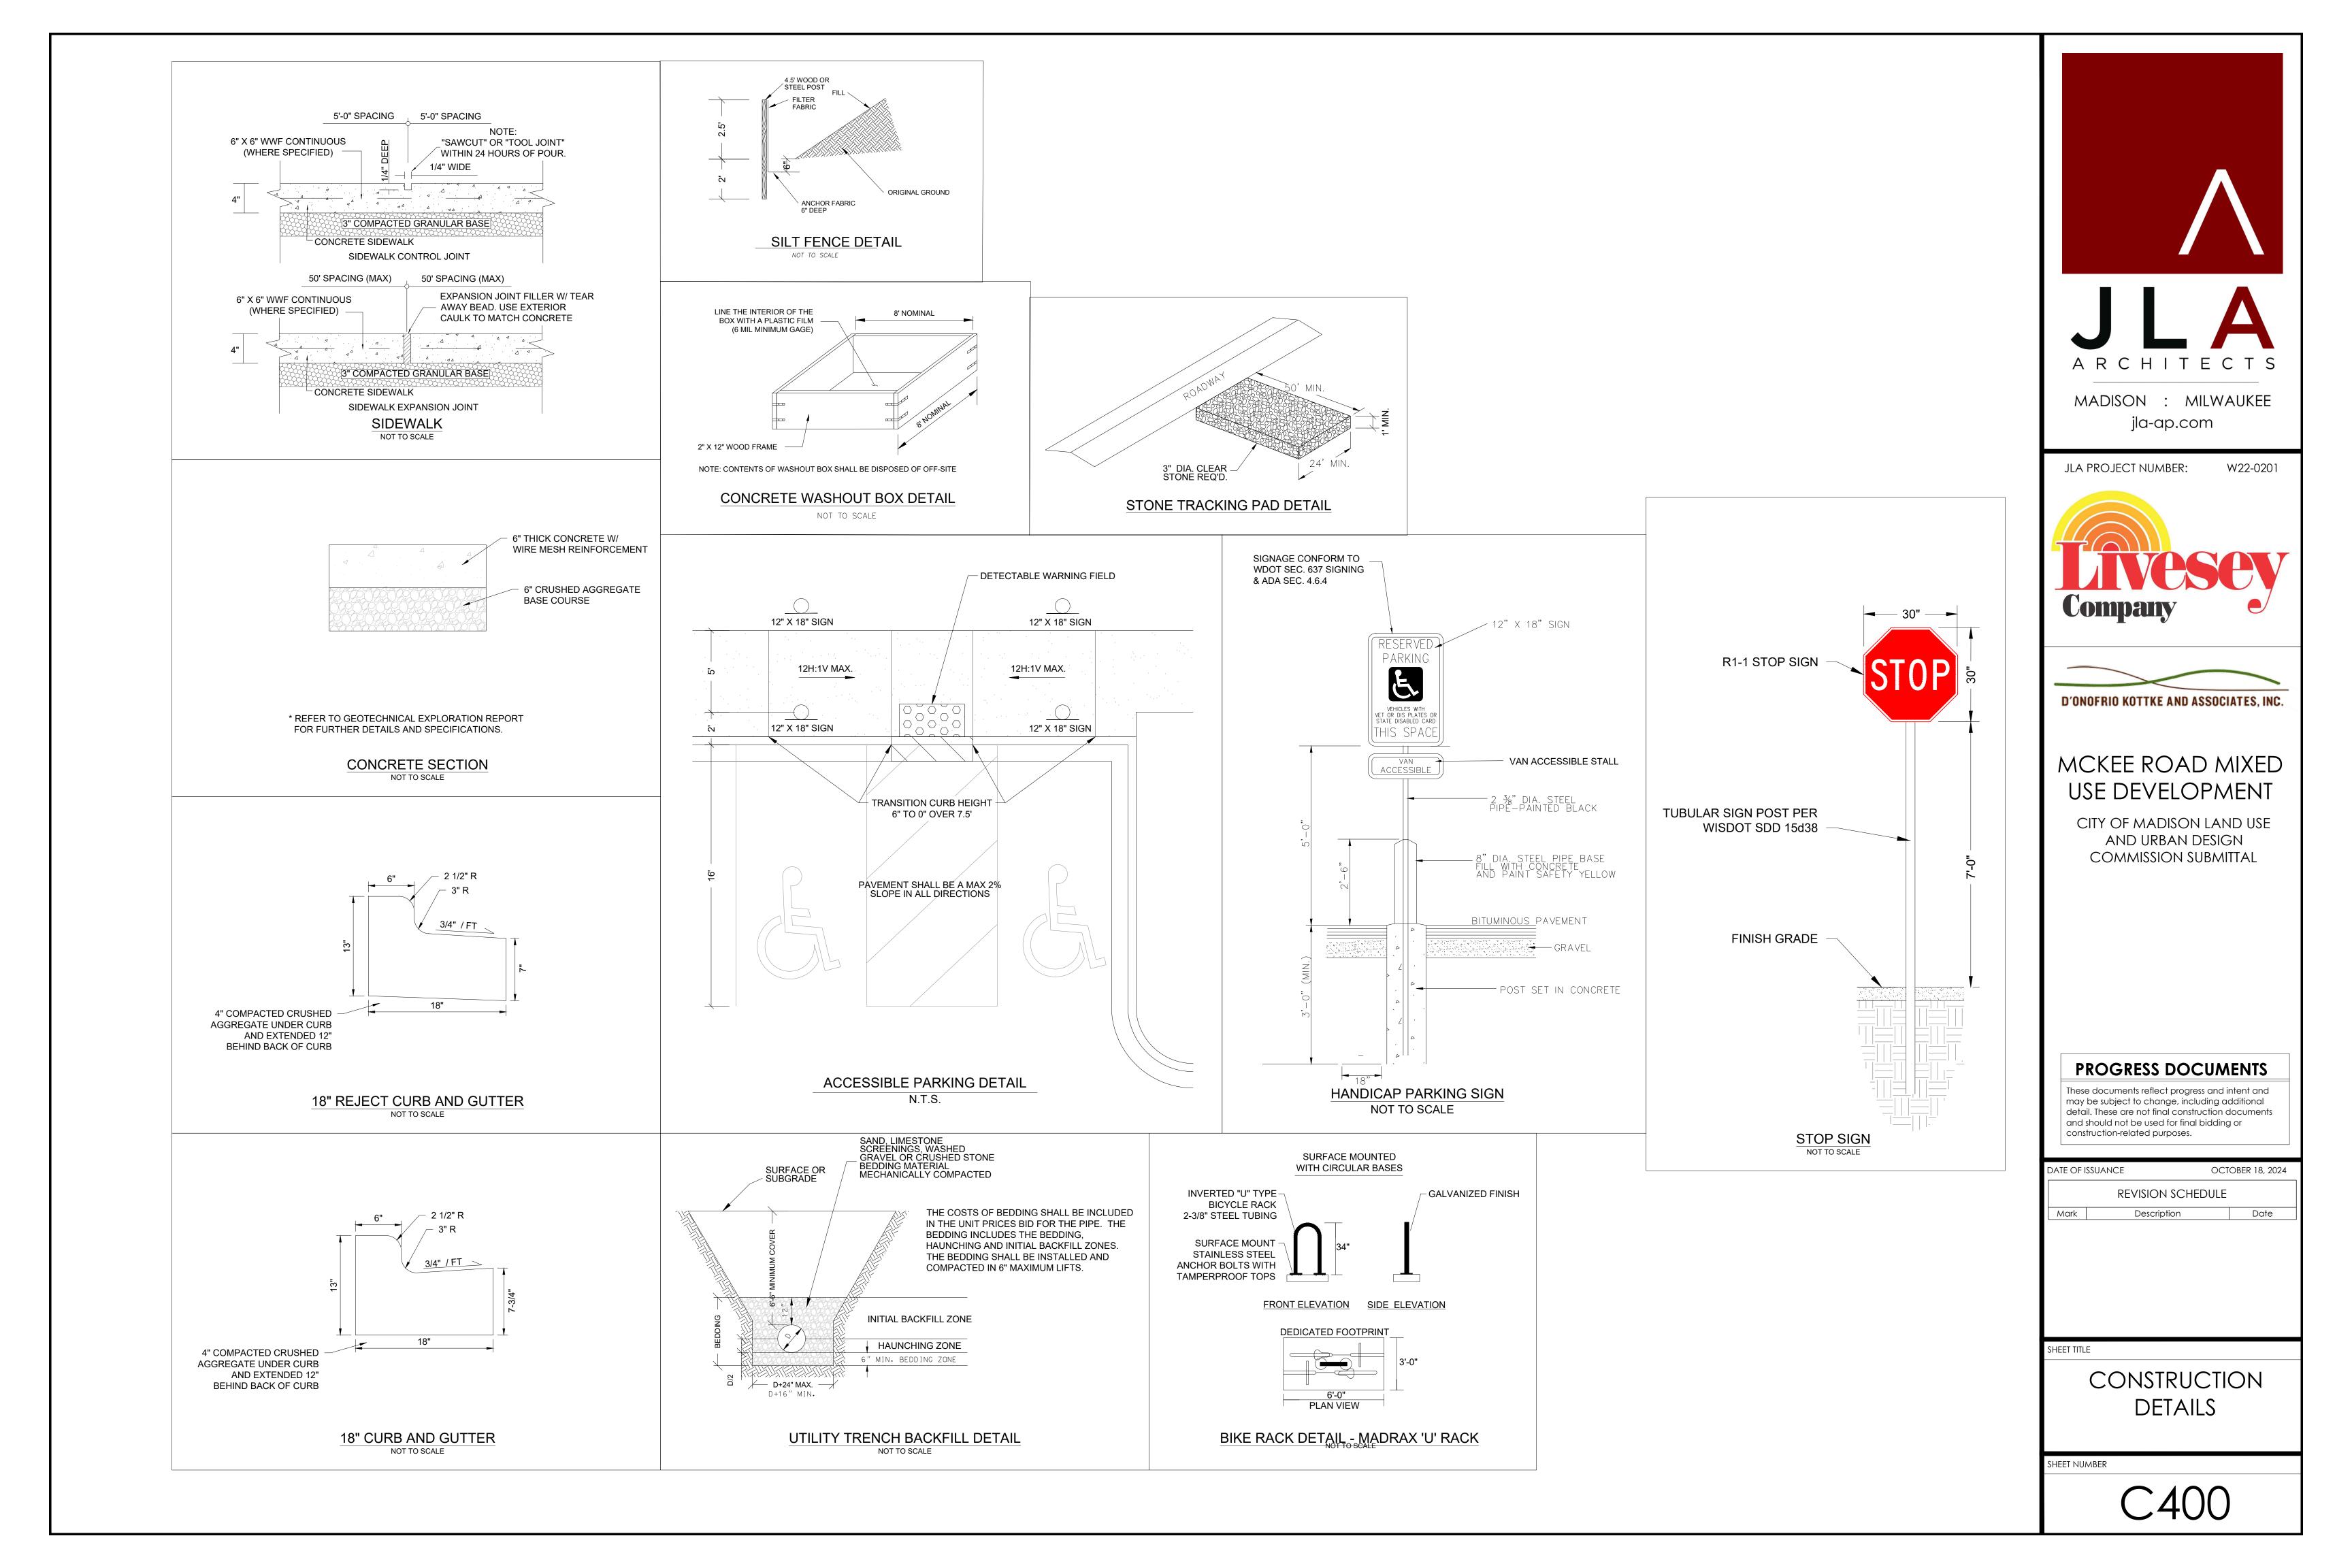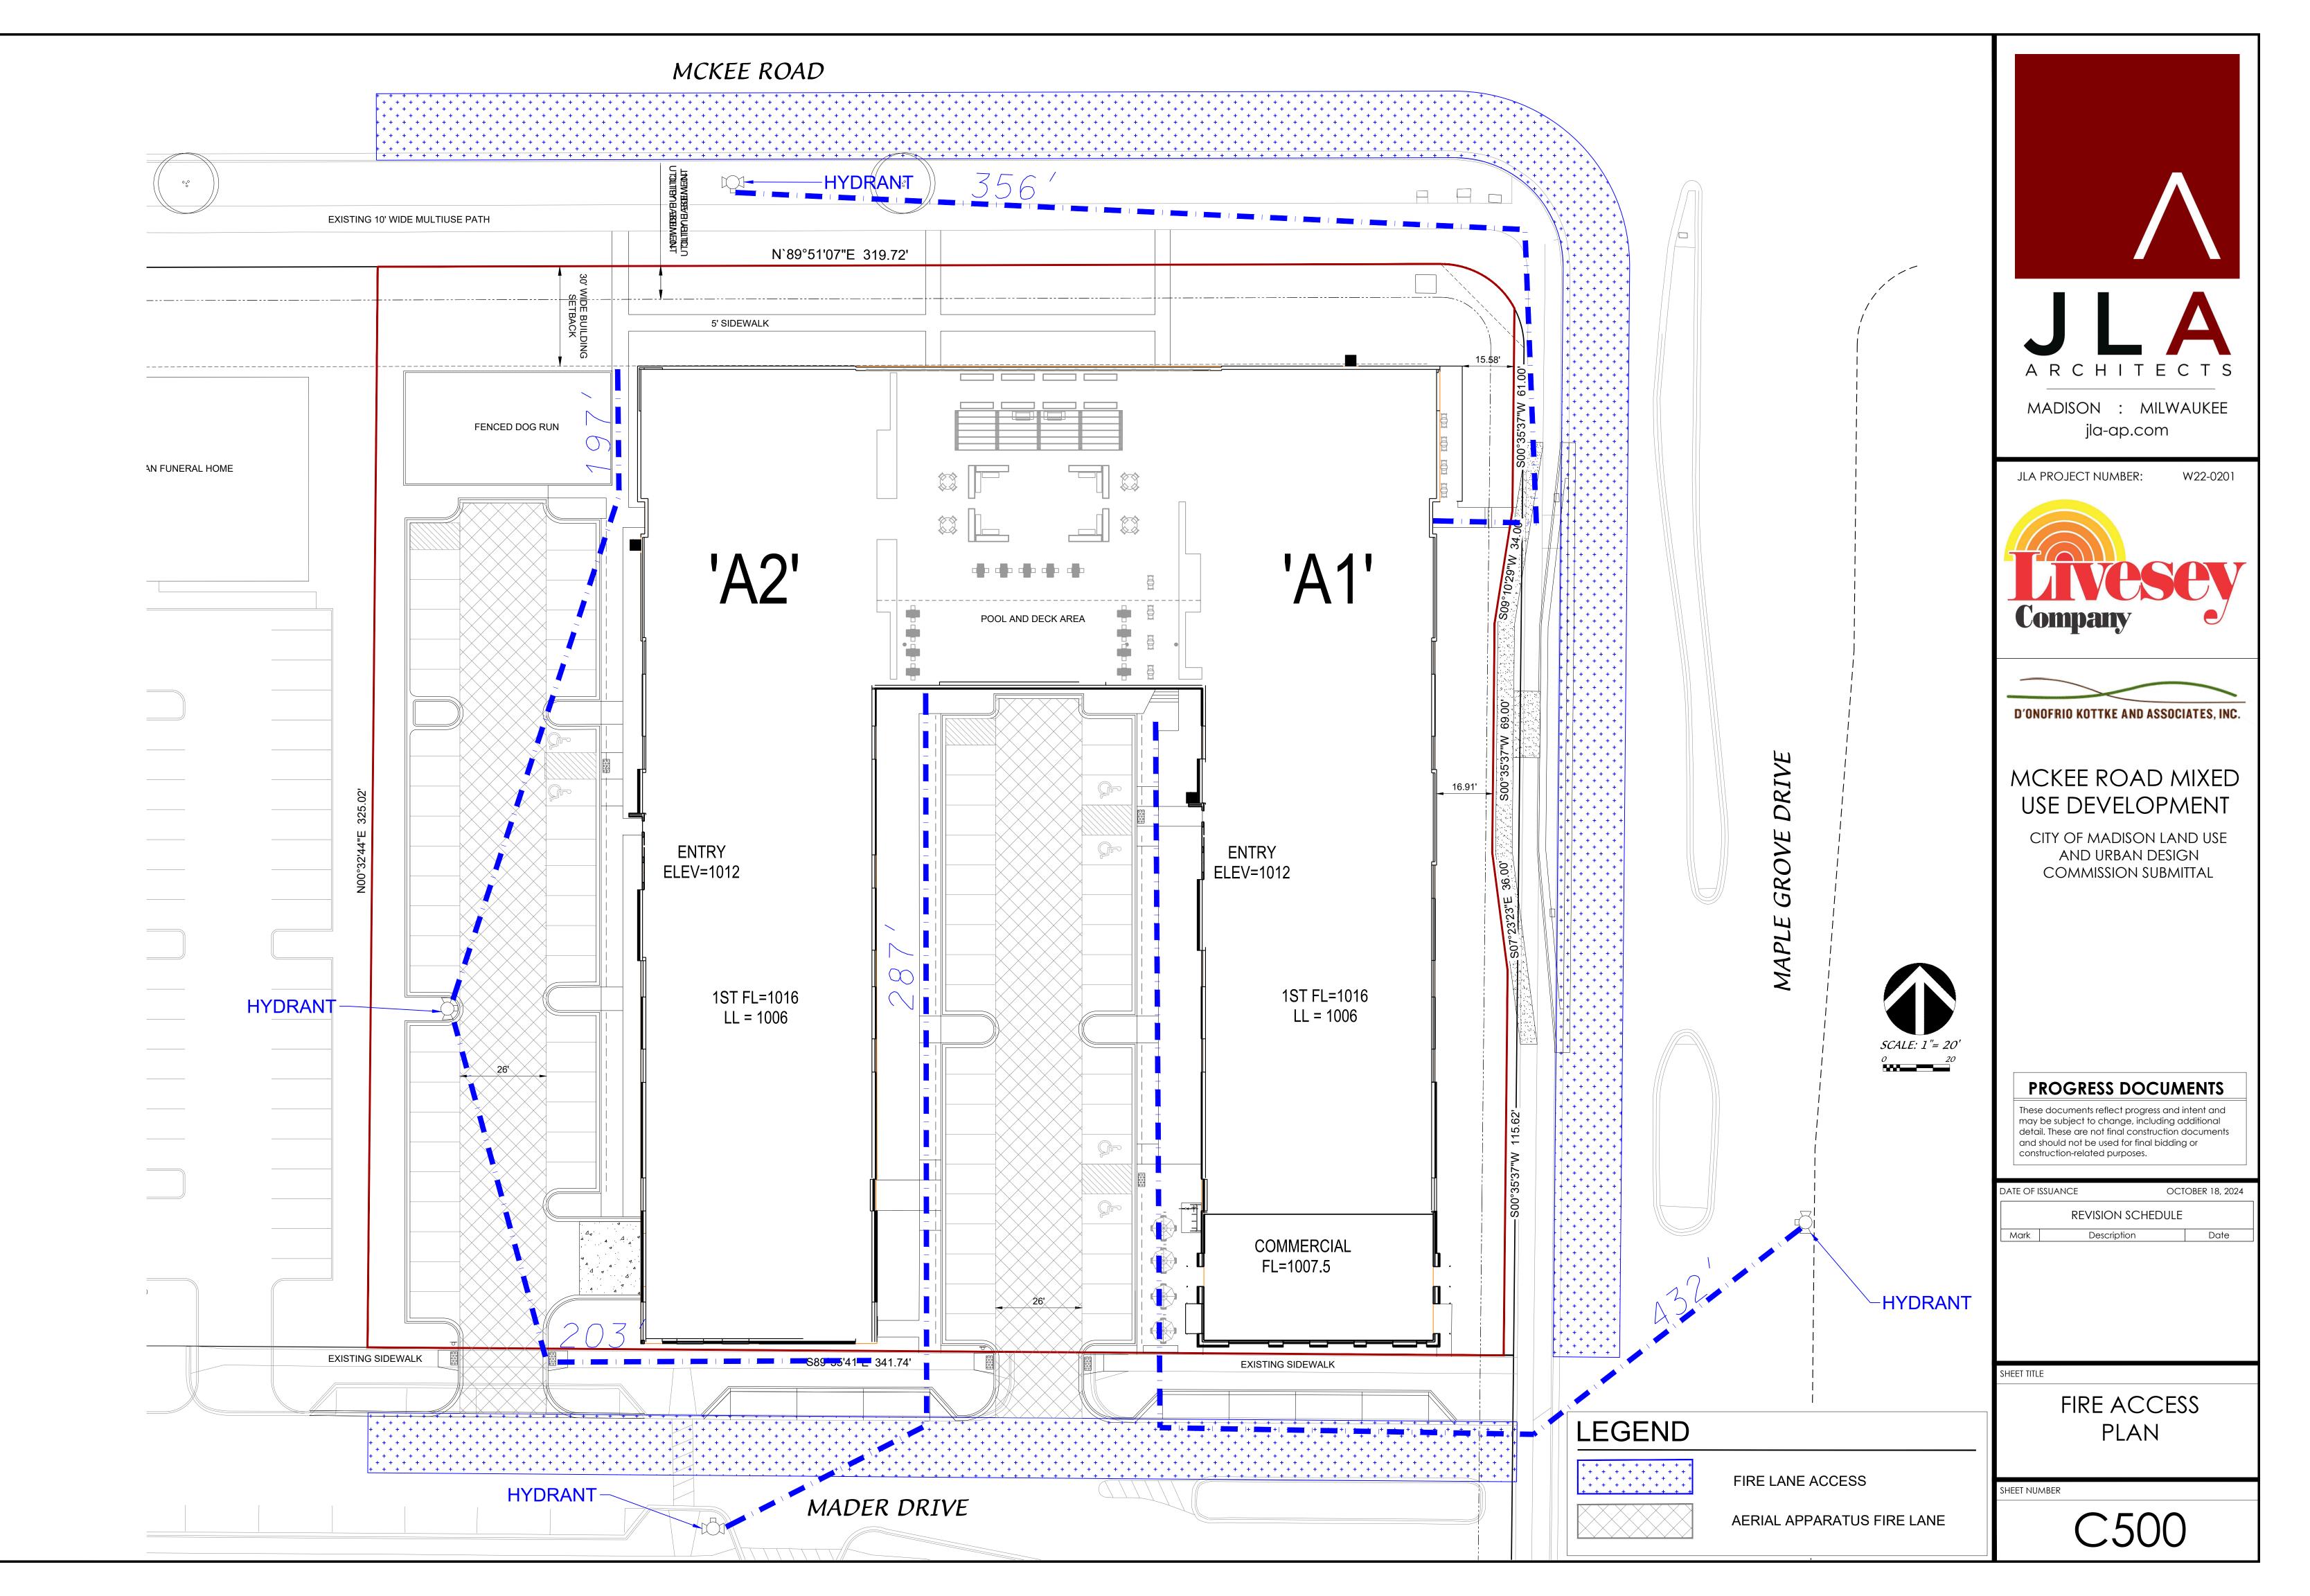- 1. THE LOCATION OF EXISTING UTILITIES SHOWN ON THE PLANS ARE APPROXIMATE. PROTECTION OF EXISTING UTILITIES IS THE CONTRACTOR'S RESPONSIBILITY.
- 2. ALL SITE UTILITY WORK SHALL BE CONSTRUCTED PER THE CITY OF MADISON STANDARD SPECIFICATIONS.
- 3. CONTRACTOR TO COORDINATE ELECTRIC, GAS, PHONE & CABLE INSTALLATION WITH THE RESPECTIVE UTILITY COMPANIES.
- 4. WATER MAIN SHALL HAVE A MINIMUM 6.5' BURY TO TOP OF PIPE.
- 5. CONTRACTOR TO COORDINATE SANITARY LATERAL AND WATER SERVICE ROUTING AND BUILDING CONNECTION WITH PLUMBING PLANS PRIOR TO CONSTRUCTION.
- 6. UTILITY CONTRACTOR SHALL VERIFY EXISTING UNDERGROUND UTILITY GRADES AND NOTIFY THE PROJECT SUPERINTENDENT IF A CONFLICT ARISES WITH THE INSTALLATION OF NEW UTILITIES.
- 7. ALL INLETS TO BE 2' X 3' INLET BOXES WITH NEENAH R-3067 COMBINATION INLET FRAME, GRATE UNLESS OTHERWISE NOTED.
- 8. CIRCULAR CATCH BASIN CASTINGS IN GRASS AREAS TO BE NEENAH R-2560-D8
- 9. CITY OF MADISON WATER UTILITY TO BE NOTIFIED PRIOR TO ANY LIVE TAPPING.









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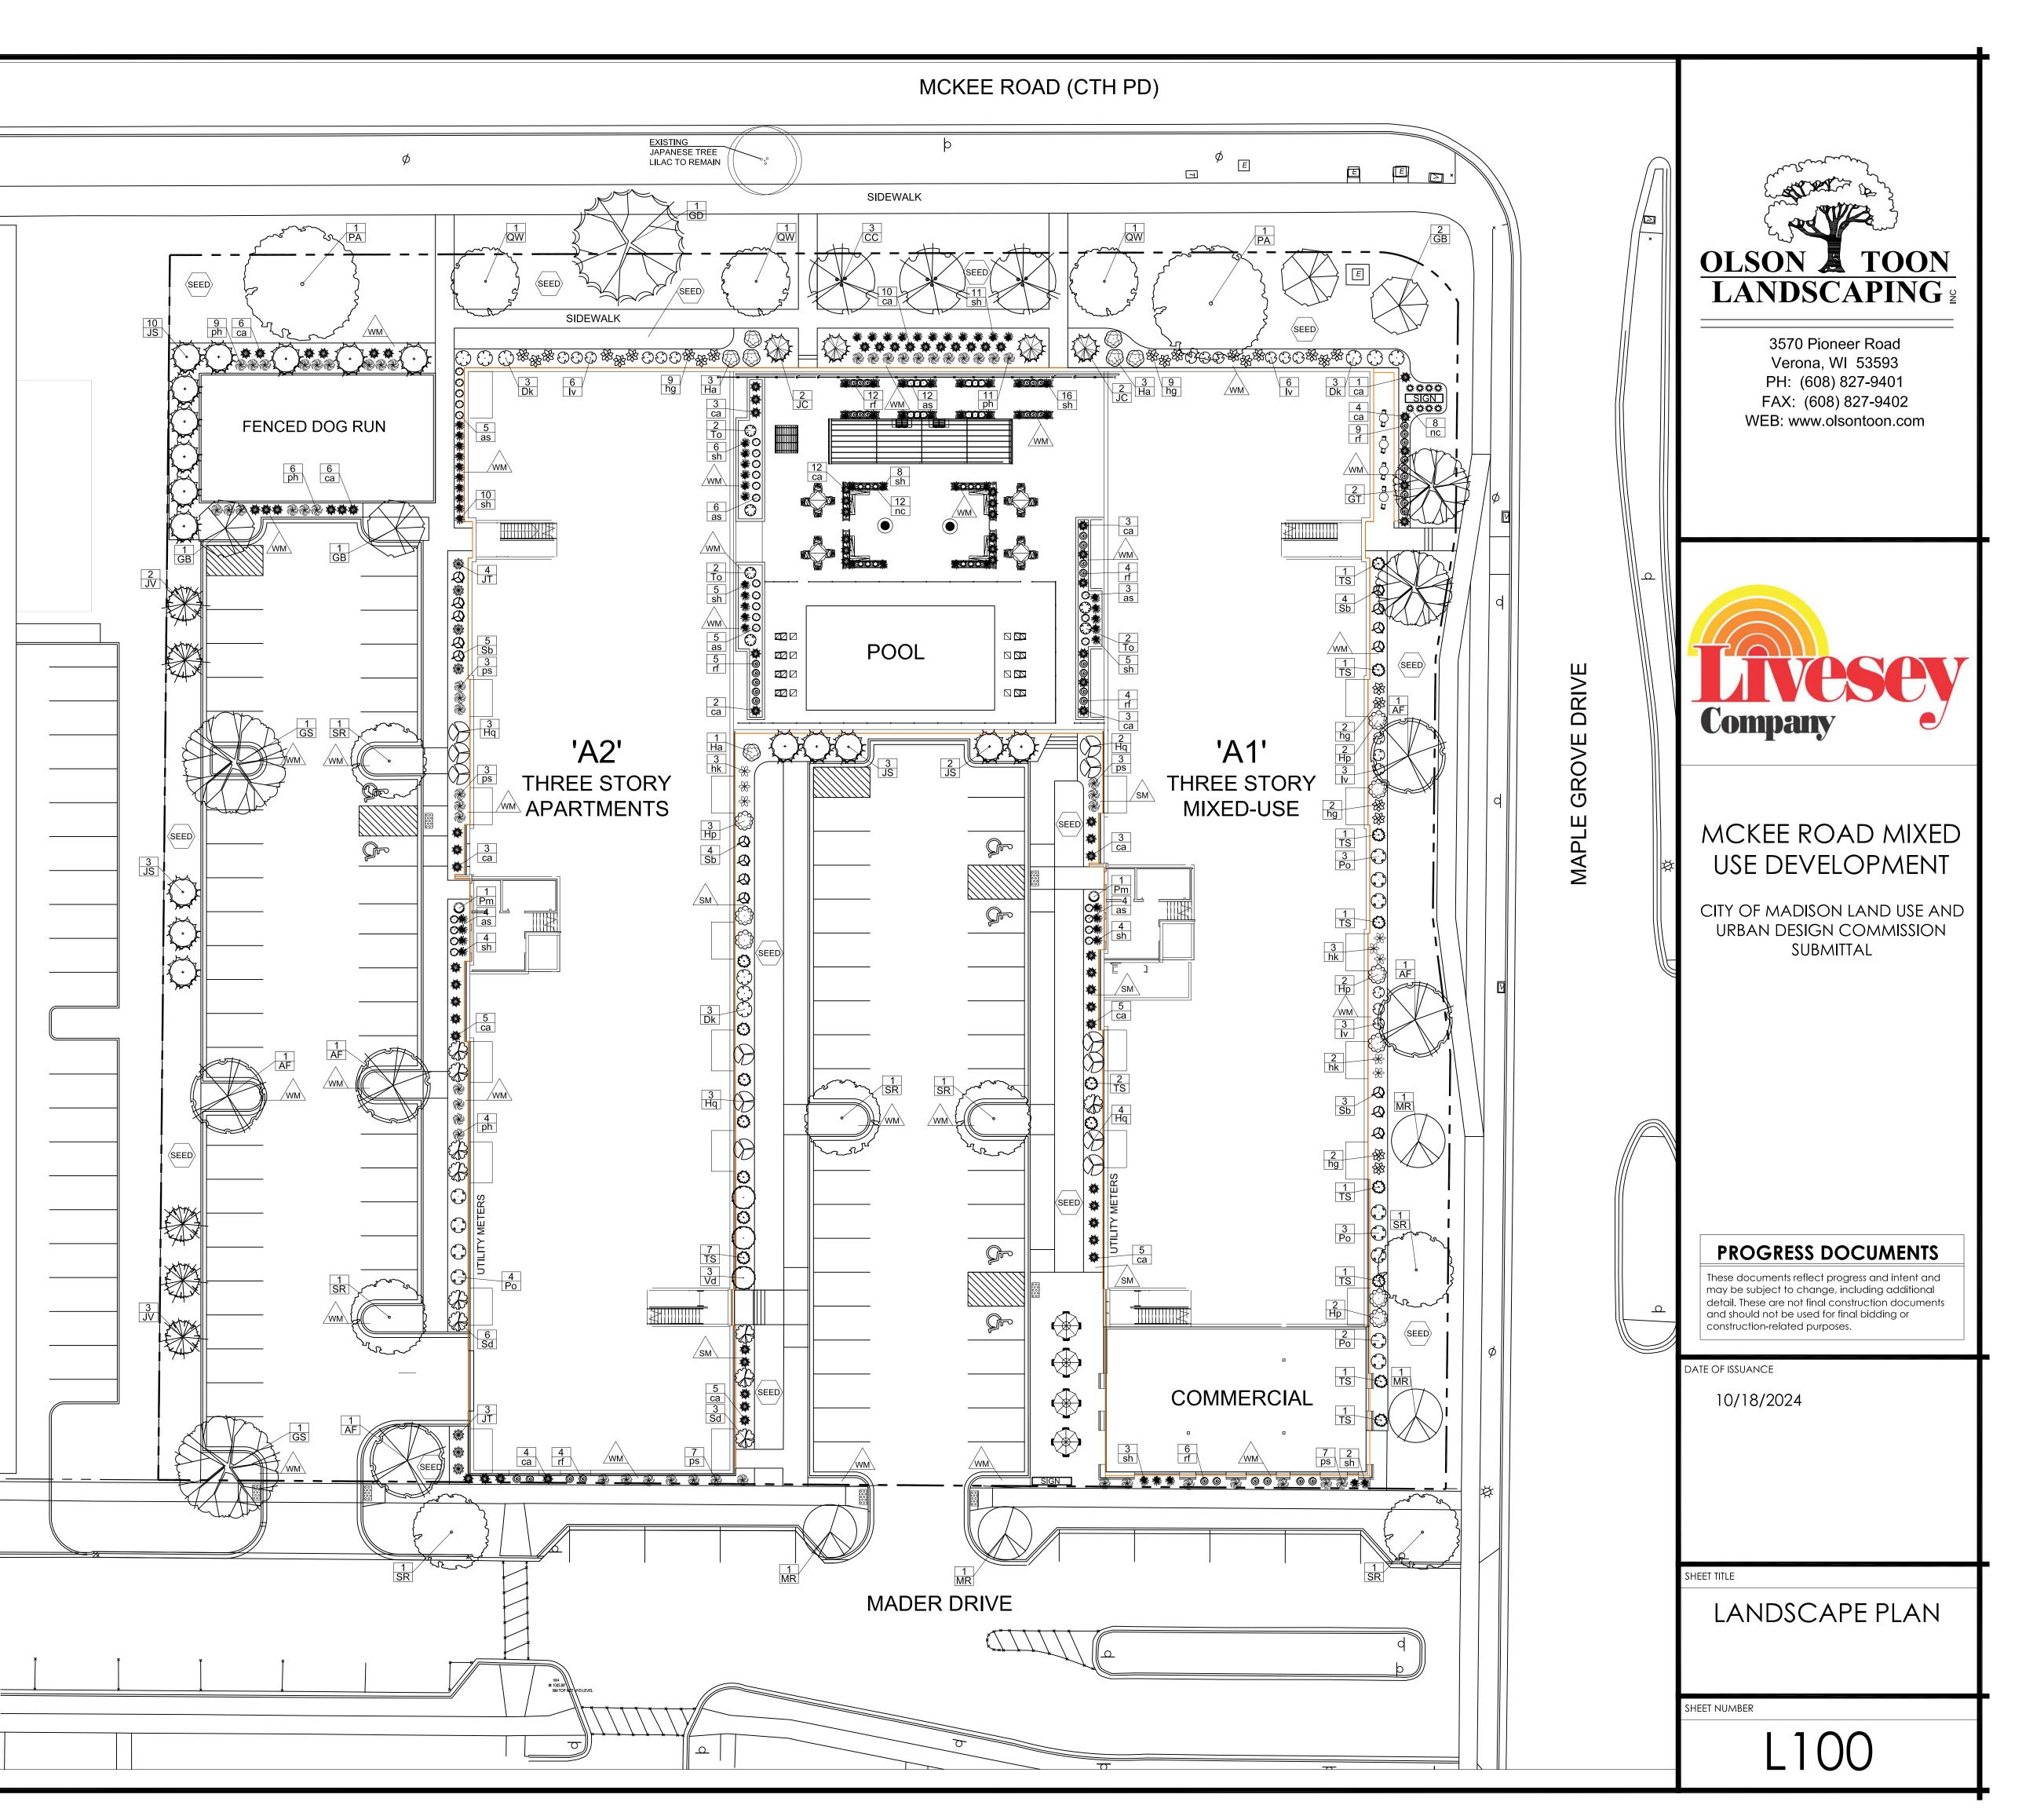
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CITY OF MADISON LANDSCAPE WORKSHEET LANDSCAPE POINTS REQ. Total Developed Area 5 points per 59,723 300 sq ft 111,071 sf (lot) - 50,551 sf (building footprint) 995 CREDITS / EXISTING LANDSCAPING NEW / PROPOSED LANDSCAPING PLANT TYPE / ELEMENT POINT VALUE OUANTITY QUANTITY | POINTS ACHIEVE POINTS ACHIEVED Overstory Deciduous (2.5" caliper) Tall Evergreen Tree (5'-6') Drnamental Tree (1.5" caliper) 15 210 14 Upright Evergreen Shrub (i.e. arborvitae) 3'-4' tall 10 510 Shrub, deciduous (#3 gal cont) Shrub, evergreen (#3 gal. cont) rnamental Grasses/Perennials (#1 gal cont) 337 674 Ornamental/Decorative Fencing or Wall (4pts / 10LF) Existing Significant Specimen Tree (2.5" dbh) andscape Furniture for public seating and/or transit connections (5pts. per seat) 2376

PLANT LIST

| | SCIENTIFIC NAME | | QTY | SIZE | ROOT | STEM |
|----|----------------------------------------------|-------------------------------------------------------|----------|------|----------------|----------|
| | DECIDUOUS TREES | | | | | <u> </u> |
| AF | Acer x freemanii 'Armstrong' | Armstrong Maple | 5 | 2.5" | B&B | |
| GB | Ginkgo biloba 'Princeton Sentry' | Princeton Sentry Ginkgo | 4 | 2" | B&B | |
| GD | Gymnocladus dioicus 'Espresso-JFS' | Espresso Kentucky Coffeetree | 1 | 2" | B&B | |
| GS | Gleditsia triacanthos var. inermis 'Skyline' | Skyline Honeylocust | 2 | 2" | B&B | |
| GT | Gleditsia triacanthos 'Draves' PP21,698 | Street Keeper Honeylocust | 2 | 2" | B&B | |
| PA | Plantus x acerifolia 'Morton Circle' | Exclamation! London Planetree | 2 | 2.5" | B&B | |
| QW | Quercus x warei 'Long' | Regal Prince Oak | 3 | 2.5" | B&B | |
| | | | | | | |
| | ORNAMENTAL TREES | | | | - DOD | |
| CC | Cercis canadensis | Eastern Redbud | 3 | 6' | B&B | CLUN |
| MR | Malus 'Jewelcole' | Red Jewel Crabapple | 4 | 2" | B&B | |
| SR | Syringa reticulata 'lvory Silk' | Ivory Silk Japanese Tree Lilac | 7 | 2" | B&B | TF |
| | UPRIGHT EVERGREEN SHRUBS | COMMON NAME | | | | <u> </u> |
| JC | Juniperus chinensis 'Mountbatten' | Mountbatten Juniper | 4 | 6' | B&B | |
| JS | Juniperus x 'J.N. Select Blue' | Star Power Juniper | 18 | 6' | B&B | |
| JT | Juniperus virginiana 'Taylor' | Taylor Juniper | 7 | 6' | B&B | |
| JV | Juniperus virginiana 'Canaertii' | Canaert Juniper | 5 | 6' | B&B | |
| TS | Thuja occidentalis 'Smaragd' | Emerald Arborvitae | 17 | 5' | B&B | |
| | EVERGREEN SHRUBS | | | | | Τ |
| То | Thuja occidentalis 'Linesville' | Linesville Arborvitae | 6 | #5 | Cont. | <u> </u> |
| Pm | Pinus mugo 'Slowmound' | Dwarf Mountain Mugo Pine | 2 | #3 | Cont. | |
| | DECIDUOUS SHRUBS | | | | | 1 |
| Dk | Diervilla 'G2X885411' | Kodiak Red Bush Honeysuckle | 9 | #3 | Cont. | |
| lv | Itea virginica 'Sprich' | Little Henry Virginia Sweetspire | 18 | #3 | Cont. | <u> </u> |
| Ha | Hydrangea arborescens 'Abetwo' | Incrediball Hydrangea | 7 | #3 | Cont. | - |
| Нр | Hydrangea paniculata 'Jane' | Little Lime Hydrangea | 9 | #3 | Cont. | |
| Hq | Hydrangea paniculata 'Bulk' | Quick Fire Hydrangea | 12 | #3 | Cont. | |
| Po | Physocarpus opulifoius 'Donna May' | Little Devil Ninebark | 12 | #3 | Cont. | |
| Sb | Spirea betufolia 'Tor' | Tor Birchleaf Spirea | 12 | #3 | Cont. | + |
| Sd | Syringa 'SNSJBP7' | Bloomerang Dark Purple Lilac | 9 | #3 | Cont. | + |
| Vd | Viburnum dentatum 'Christom' | Blue Muffin Arrowwood Viburnum | 3 | #5 | Cont. | + |
| | | | | | 1 | |
| | ORNAMENTAL GRASSES & PERENNIALS | | | | | |
| as | Allium 'MGsmmpkb13' | Summer Peek-A-Boo Allium | 39 | #1 | Cont. | <u> </u> |
| ca | Calamagrostis x acutiflora 'Karl Foerster' | Karl Foerster Feather Reed Grass | 75 | #1 | Cont. | <u> </u> |
| hg | Hosta 'Guacamole' | Guacamole Hosta | 24 | #1 | Cont. | |
| hk | Hosta 'Krossa Regal' | Krossa Regal Hosta | 8 | #1 | Cont. | <u> </u> |
| nc | Nepeta 'Cat's Pajamas' | Cat's Pajamas Catmint | 20 | #1 | Cont. | <u> </u> |
| ph | Panicum virgatum 'Heavy Metal' | Heavy Metal Switch Grass | 30 | #1 | Cont. | <u> </u> |
| ps | Panicum virgatum 'Shenandoah' | Shenandoah Red Switch Grass Prairie Dropseed Grass | 23 74 | #1 | Cont. Cont. | <u> </u> |
| sh | Sporobolus heterolepsis | | | | | 1 |



 SM
 over weed barrier fabric with Dimex EdgePro polyvinyl edging or equivalent.

 Image: WM
 Brown Dyed Wood Mulch spread to 3" depth, with Dimex EdgePro polyvinyl Edging or equivalent.

 \land 1.5" diameter washed stone mulch spread to 3" depth,

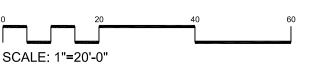
• Please refer to Grading & Erosion Control Plan for final contour

• Individual trees in lawn areas to receive wood mulch rings

 $\langle s_{EED} \rangle$ Premium grass seed with straw mat erosion blanket.

LANDSCAPE NOTES:

information.





STREET TREE NOTE:

Existing street trees shall be protected. Contractor shall install tree protection fencing in the area between the curb and sidewalk and extend it at least 5 feet from both sides of the tree along the length of the terrace. No excavation is permitted within 5 feet of the outside edge of a tree trunk. If excavation within 5 feet of any tree is necessary, contractor shall contact City Forestry at (608-266-4816) prior to excavation to assess the impact to the tree and root system. Tree pruning shall be coordinated with City Forestry prior to the start of construction. Tree protection specifications can be found in section 107.13 of *City of Madison Standard Specifications for Public Works Construction* -

http://www.cityofmadison.com/business/pw/documents/StdSpecs/2013/Part1.pdf. Any tree removals that are required for construction after the development plan is approved will

require at least a 72 hour wait period before a tree removal permit can be issued by Forestry, to notify the Alder of the change in the tree plan.

At least one week prior to street tree planting, Contractor shall contact City Forestry (608-266-4816) to schedule inspection and approval of nursery tree stock and review planting specifications with the landscaper.



NORTHEAST CORNER - McKEE RD & MAPLE GROVE DR (OPPOSITE CORNER)

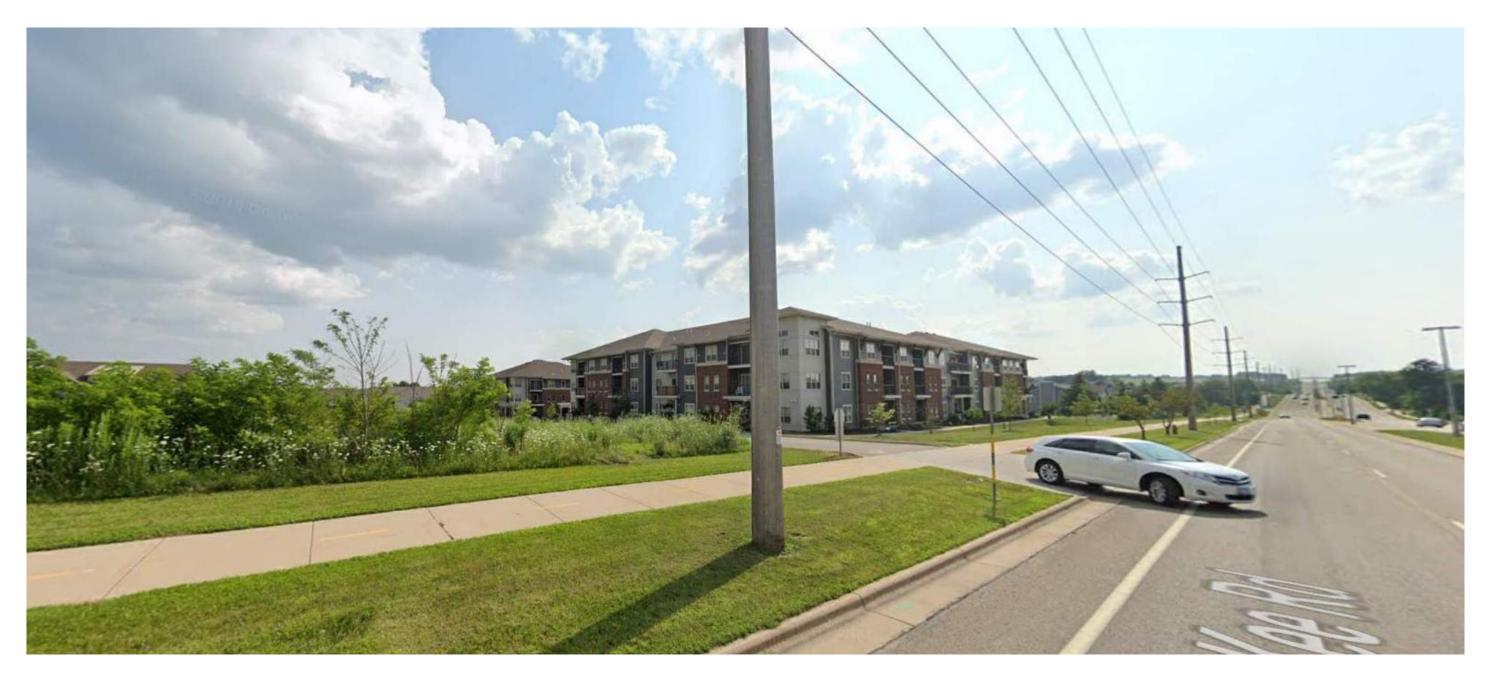





NORTHEAST CORNER - McKEE RD & MAPLE GROVE DR (SITE CORNER)

SHEET NUMBER


U010



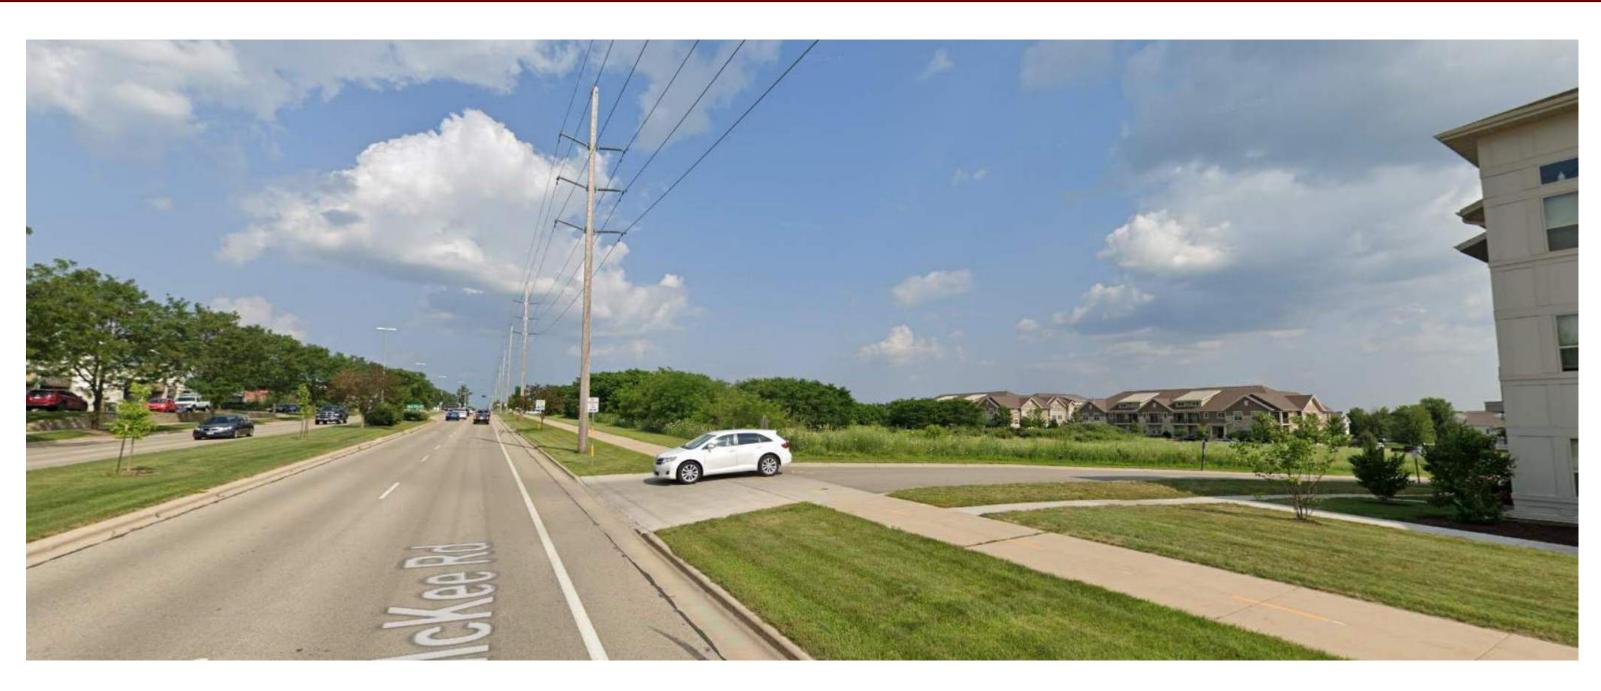
NORTHWEST CORNER - McKEE RD (LOOKING SOUTHWEST)



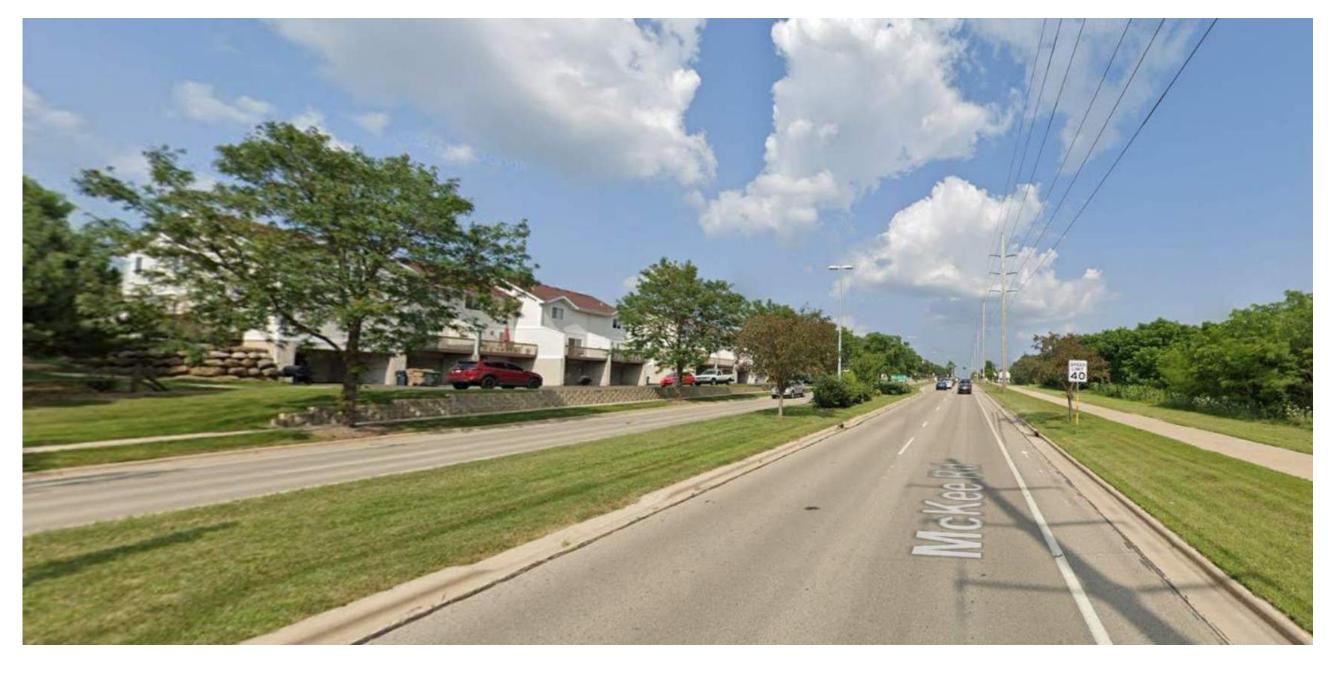
NORTHWEST CORNER - McKEE RD (LOOKING SOUTHEAST)



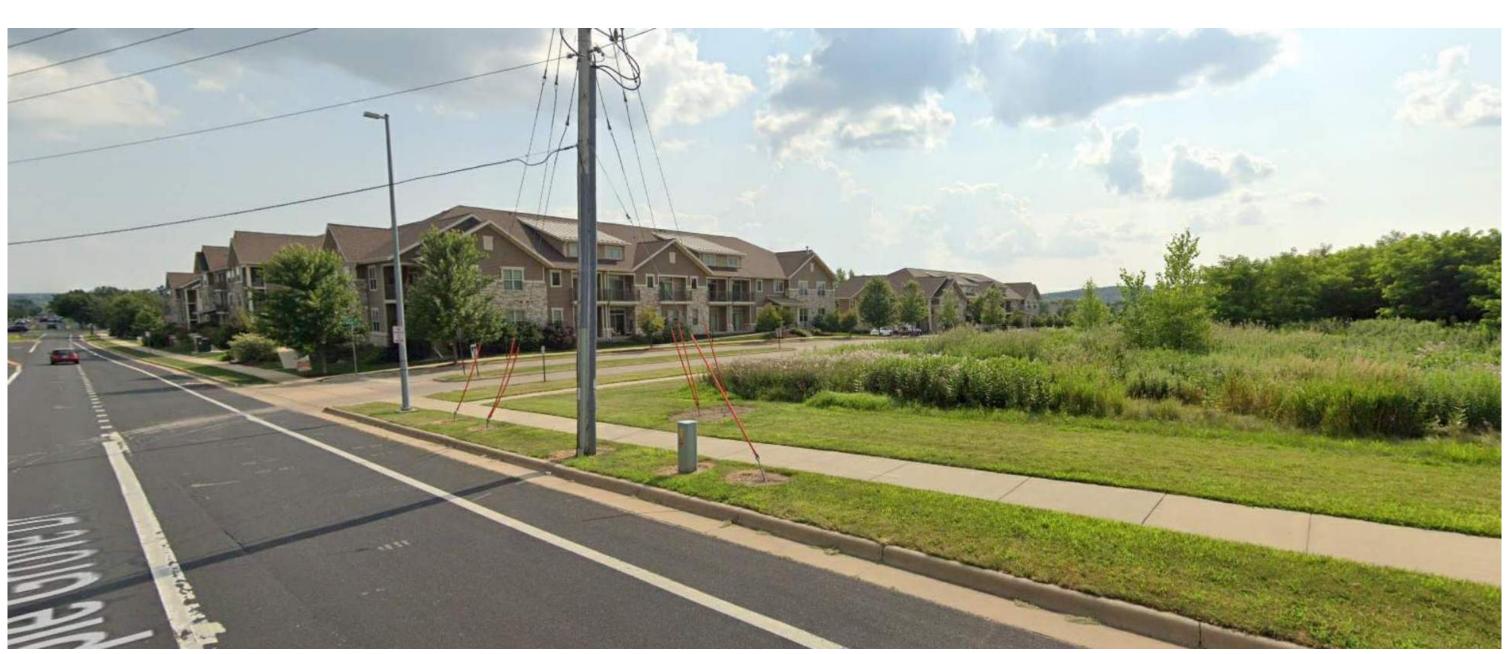NORTHWEST CORNER - McKEE RD (LOOKING EAST)




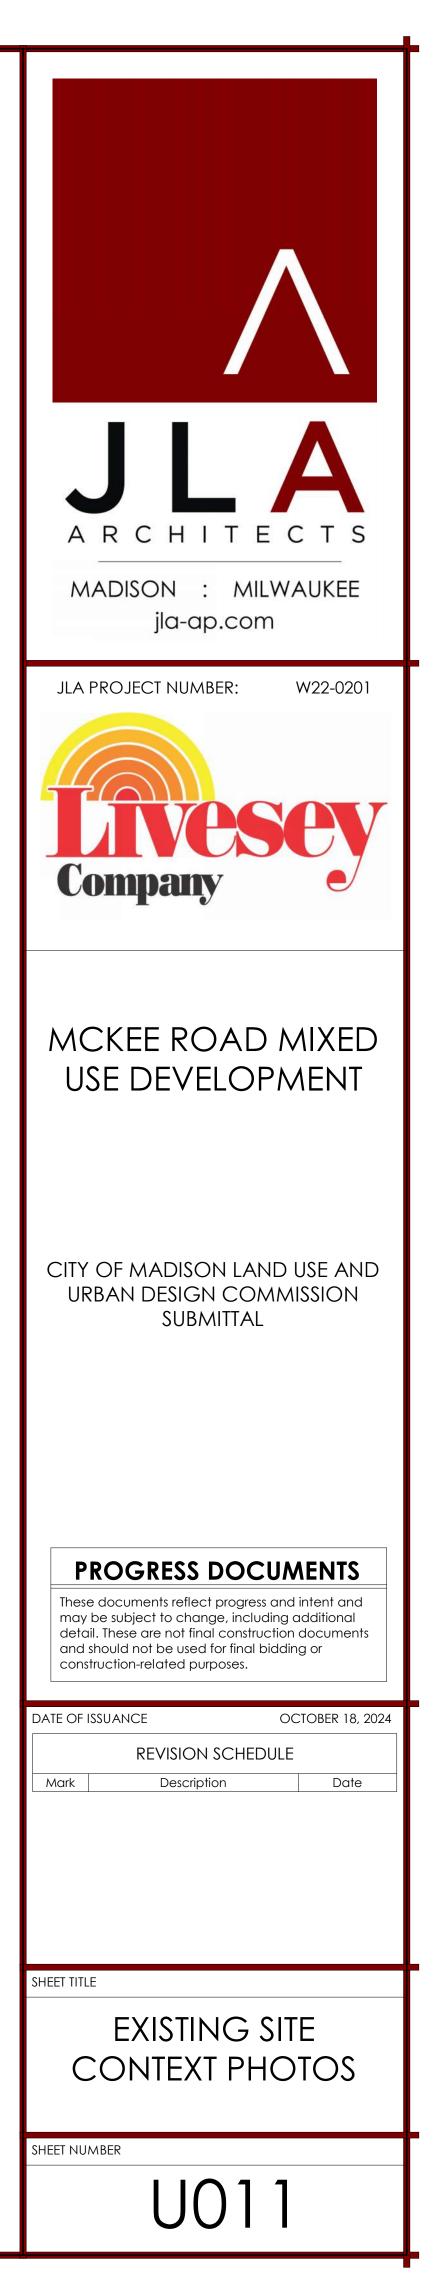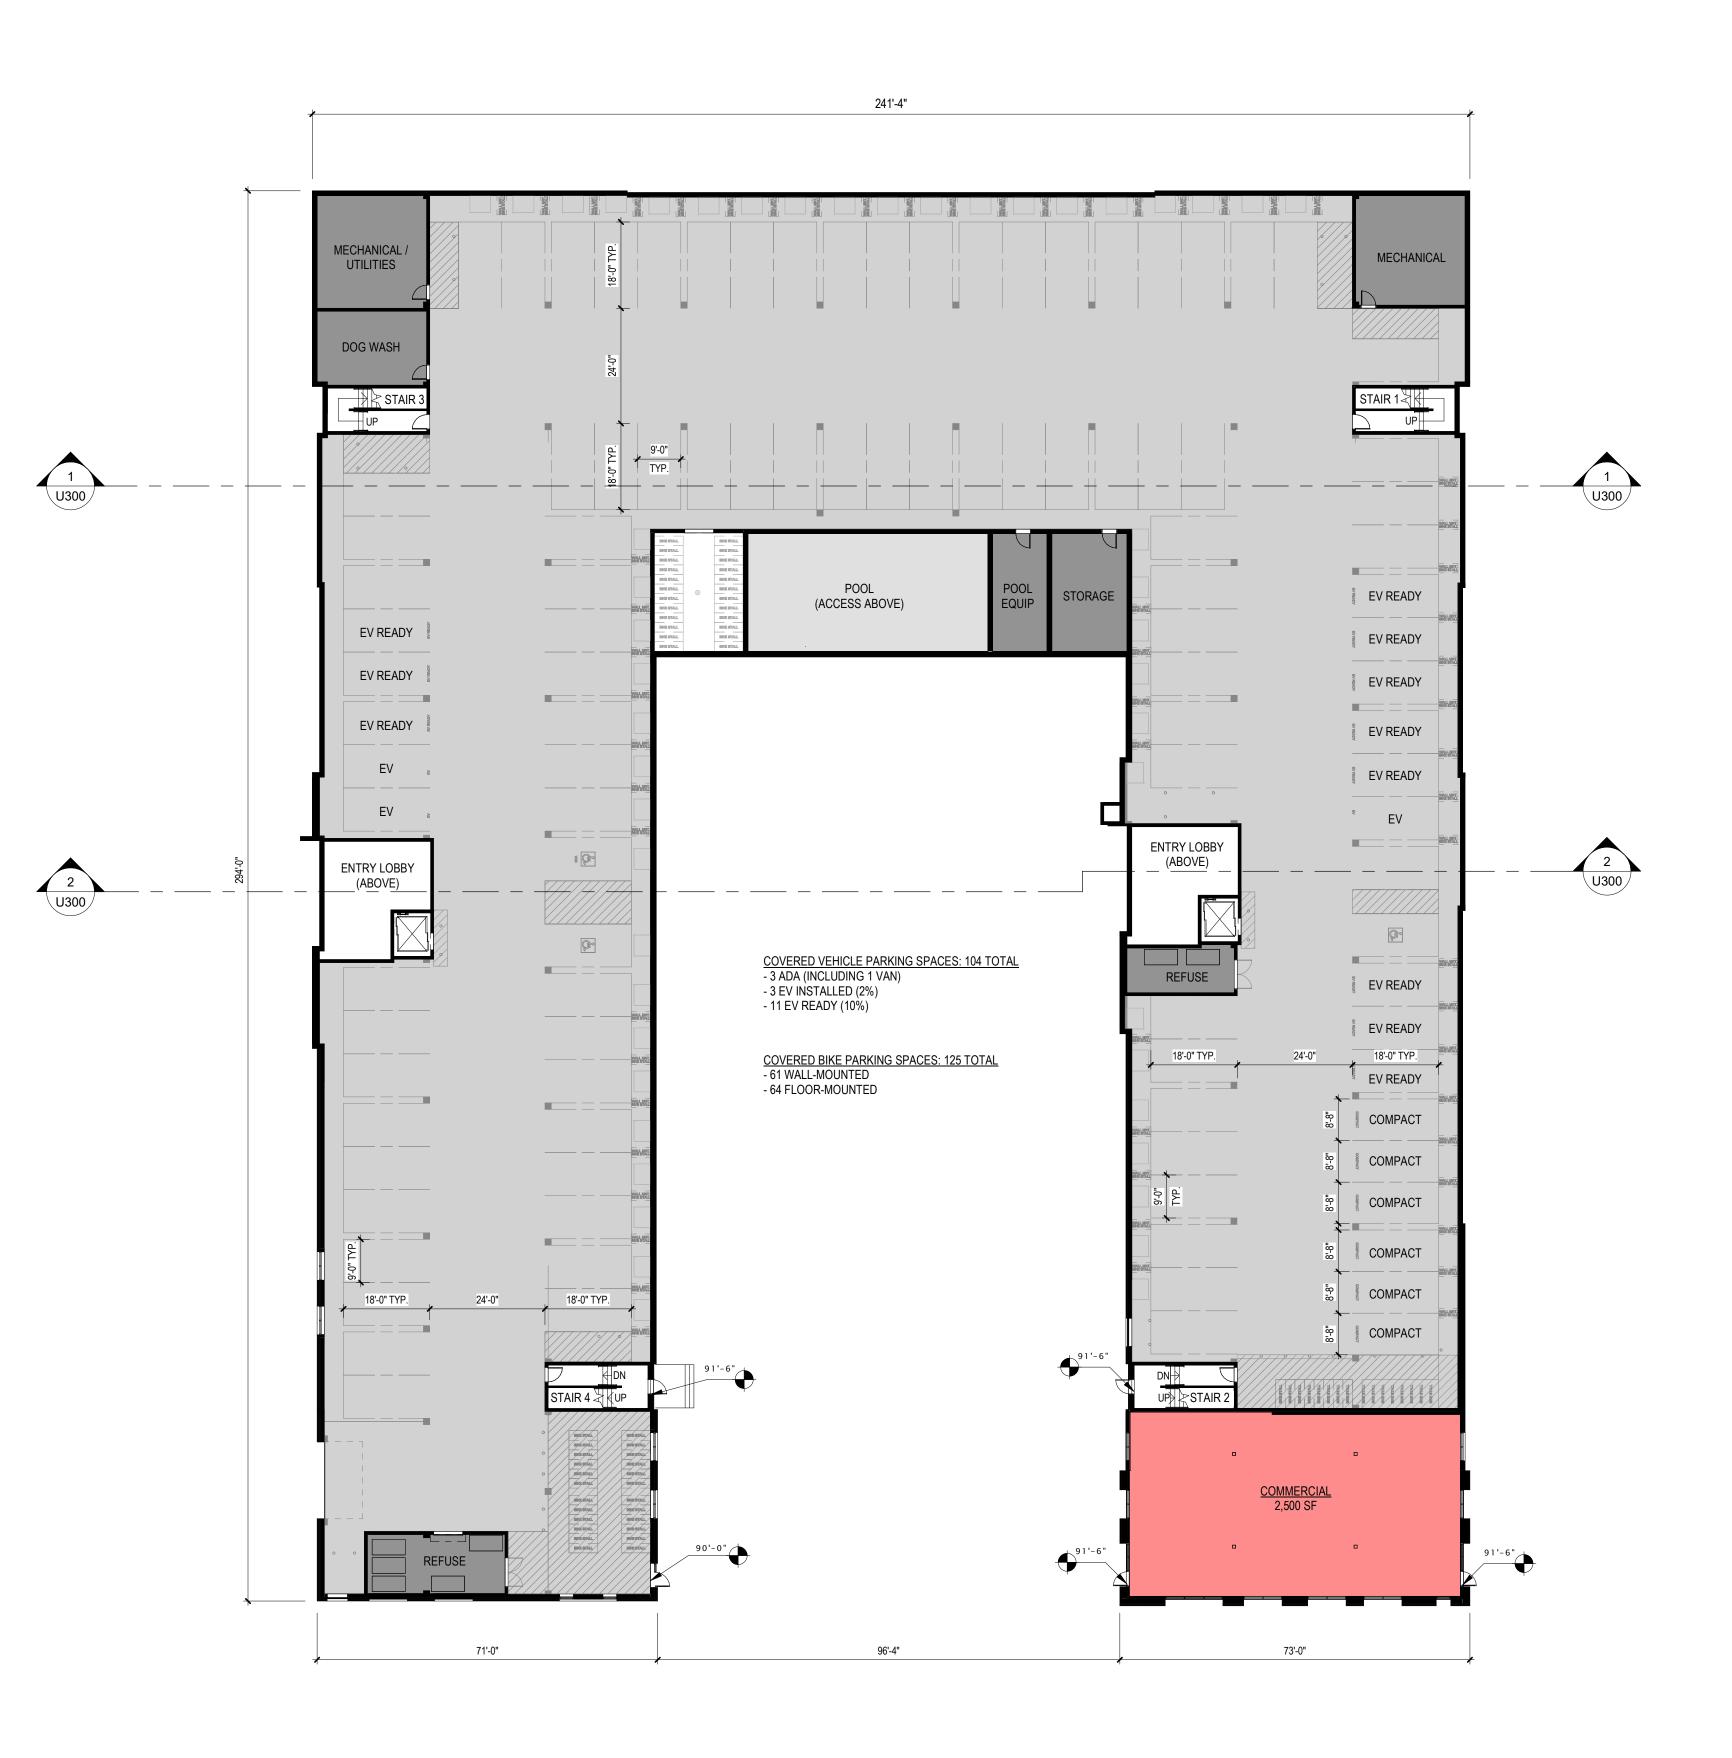SOUTHEAST CORNER - MAPLE GROVE DR (LOOKING TOWARDS MARDER DR)














| ARCHITECTS MADISON : MILWAUKEE |
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| MCKEE ROAD MIXED USE DEVELOPMENT |
| CITY OF MADISON LAND USE AND URBAN DESIGN COMMISSION SUBMITTAL |
| PROGRESS DOCUMENTS These documents reflect progress and intent and may be subject to change, including additional detail. These are not final construction documents and should not be used for final bidding or construction-related purposes. |
| DATE OF ISSUANCE OCTOBER 18, 2024 REVISION SCHEDULE Mark Description Date |
| SHEET TITLE LOWER LEVEL PLAN |
| sheet number U100 |

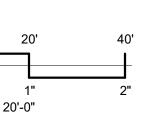


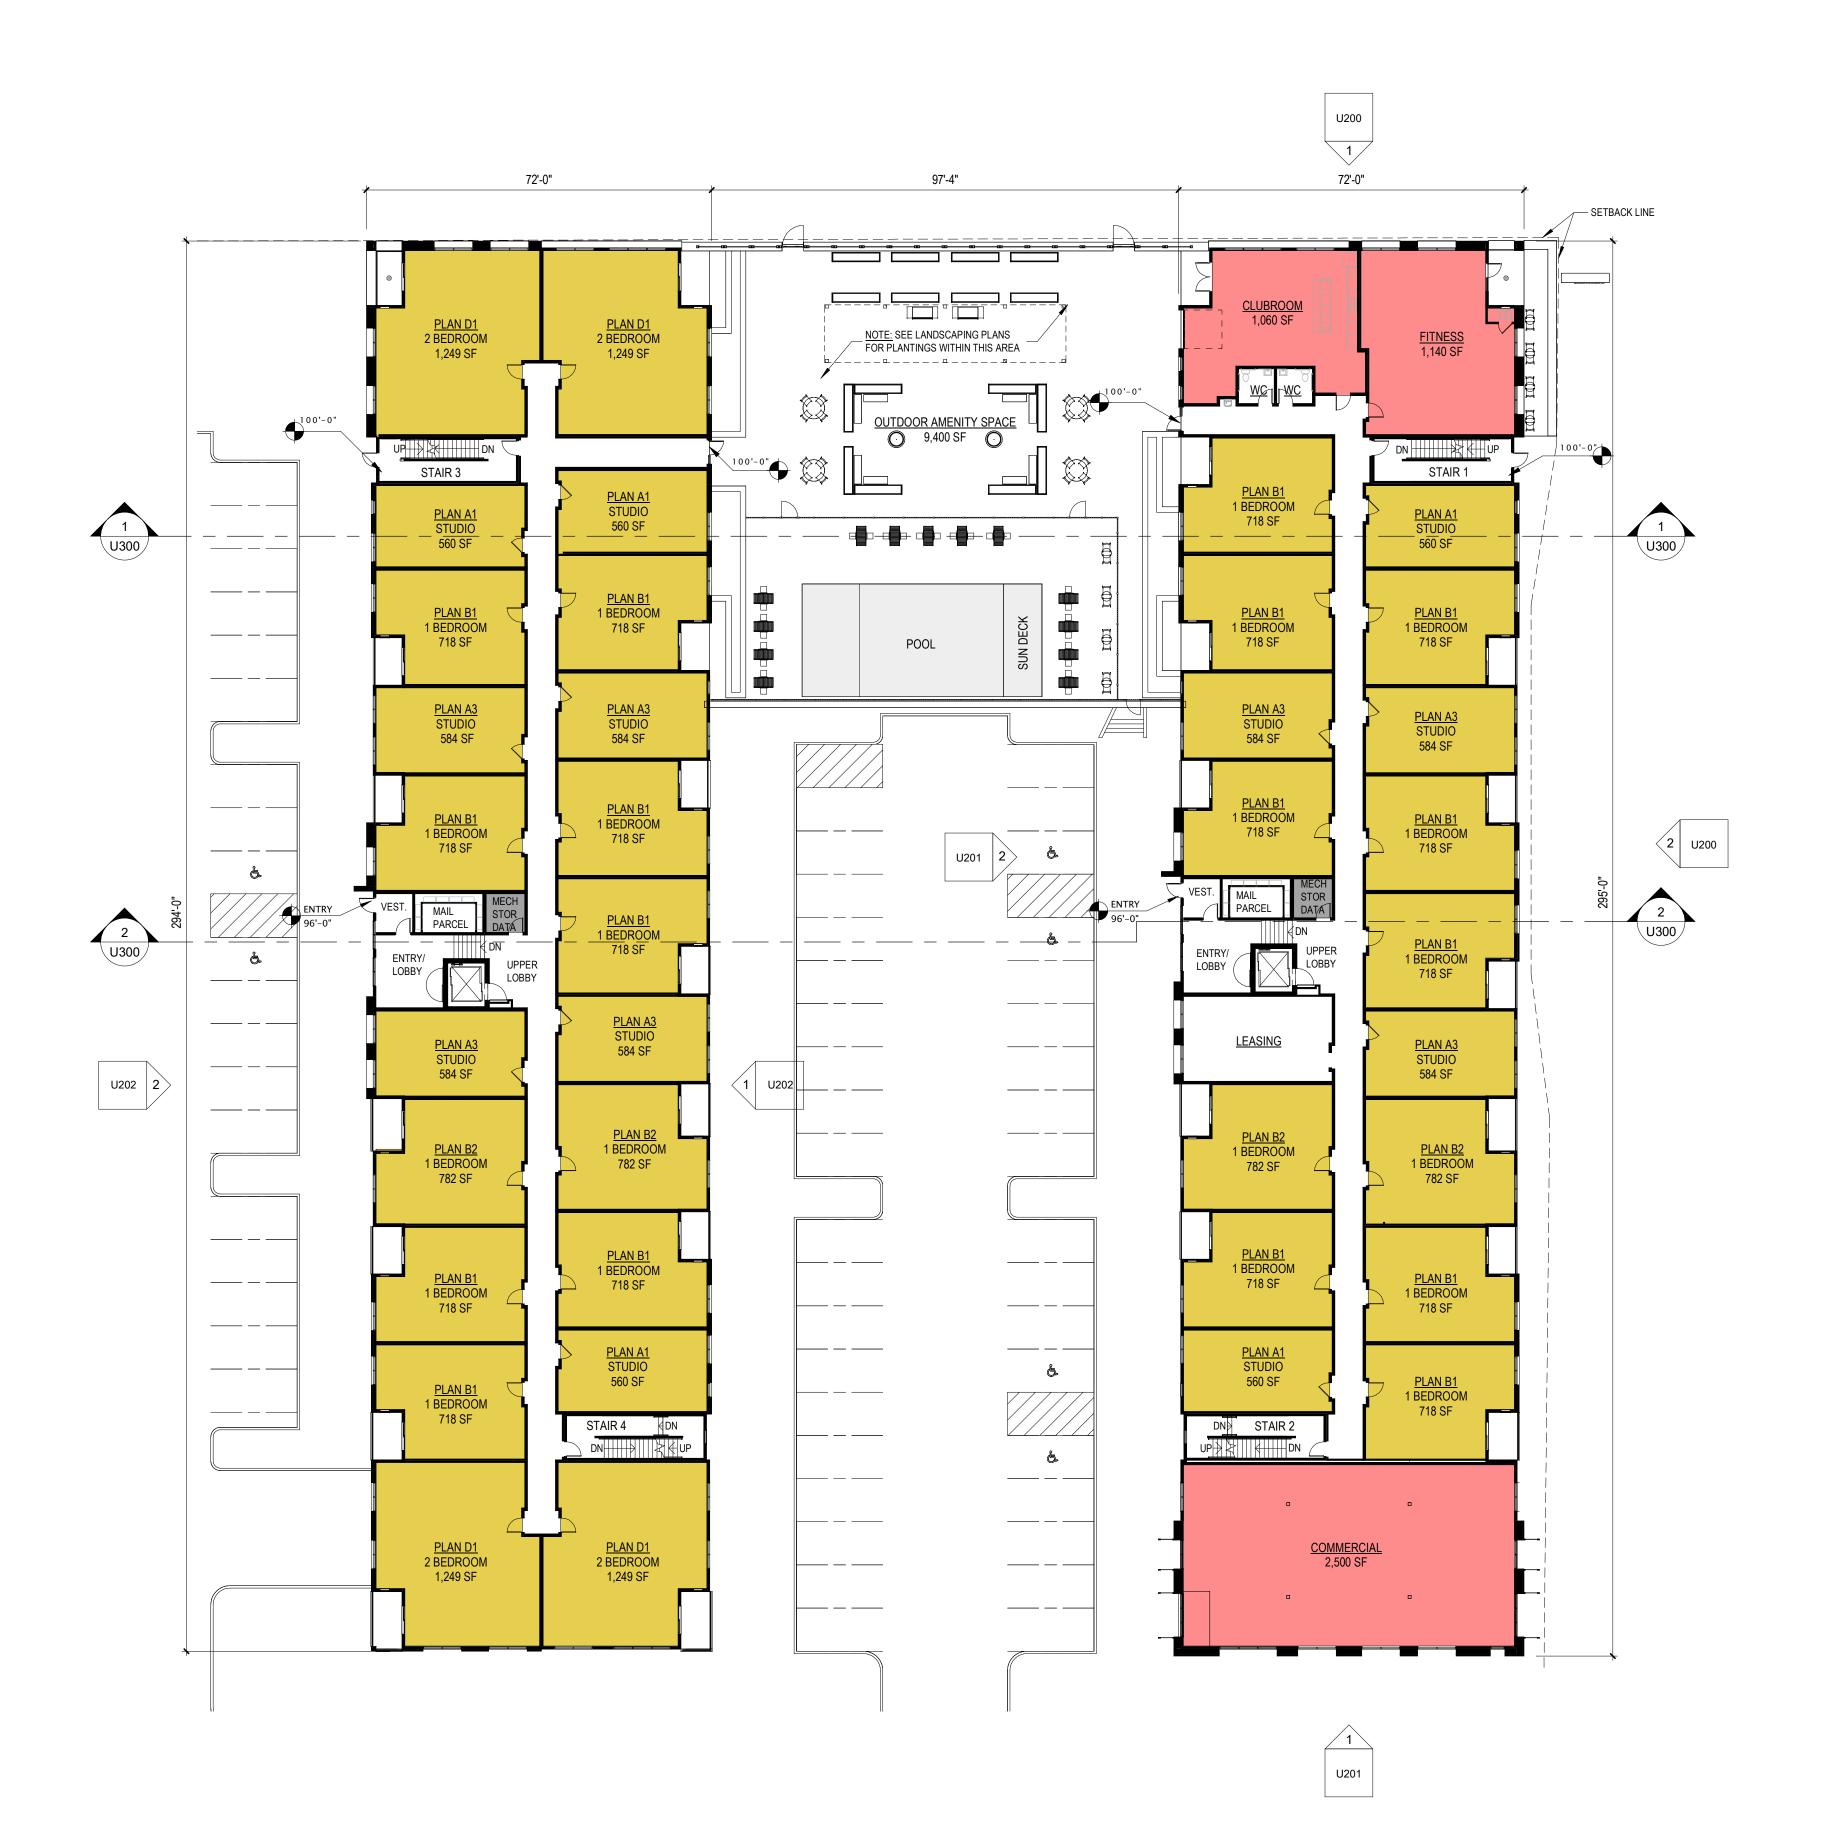


1 FIRST FLOOR PLAN SCALE: 1" = 20'-0"

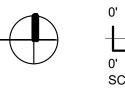


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| JLA PROJECT NUMBER: W22-0201 |
| MCKEE ROAD MIXED USE DEVELOPMENT |
| CITY OF MADISON LAND USE AND URBAN DESIGN COMMISSION SUBMITTAL |
| PROGRESS DOCUMENTS These documents reflect progress and intent and may be subject to change, including additional detail. These are not final construction documents and should not be used for final bidding or construction-related purposes. |
| DATE OF ISSUANCE OCTOBER 18, 2024 REVISION SCHEDULE Mark Description |
| SHEET TITLE FIRST FLOOR PLAN |
| sheet number U101 |

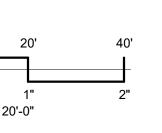


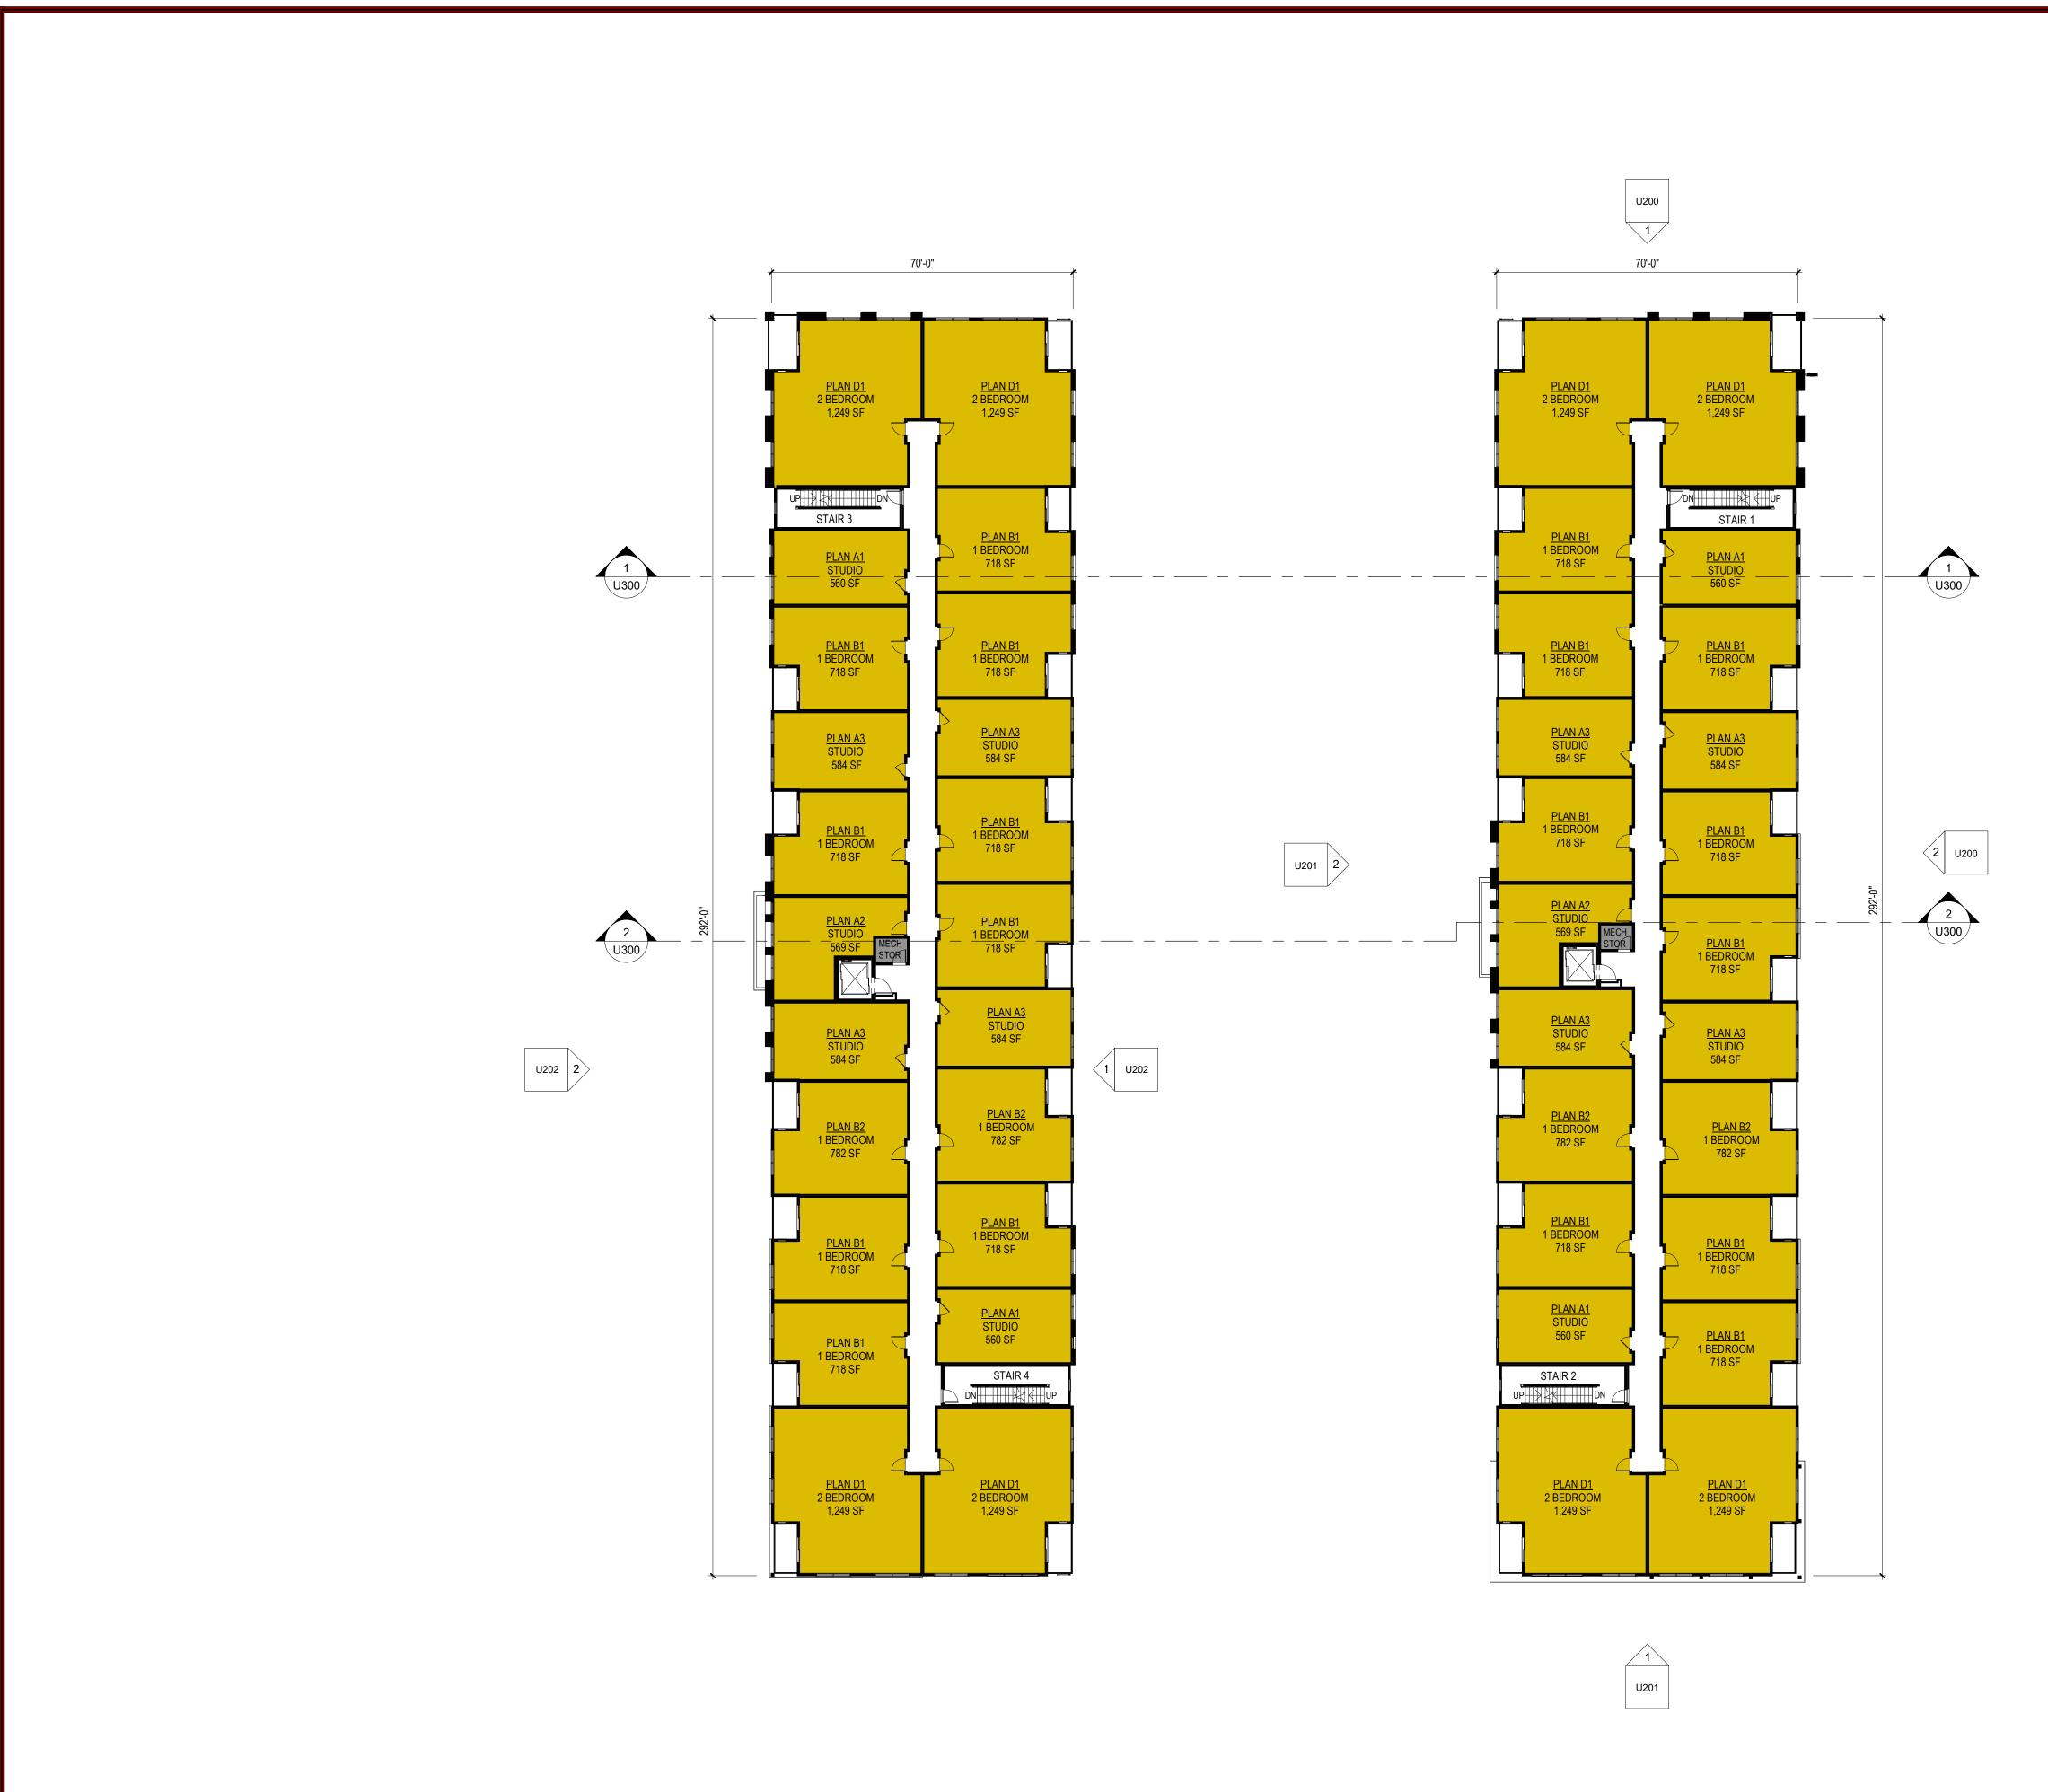





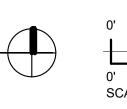

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| JLA PROJECT NUMBER: W22-0201 |
| MCKEE ROAD MIXED USE DEVELOPMENT |
| CITY OF MADISON LAND USE AND URBAN DESIGN COMMISSION SUBMITTAL |
| DATE OF ISSUANCE |
| DATE OF ISSUANCE OCTOBER 18, 2024 REVISION SCHEDULE Mark Description |
| SHEET TITLE TYPICAL FLOOR PLAN |
| sheet number U102 |

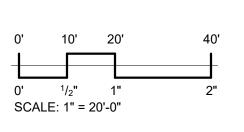

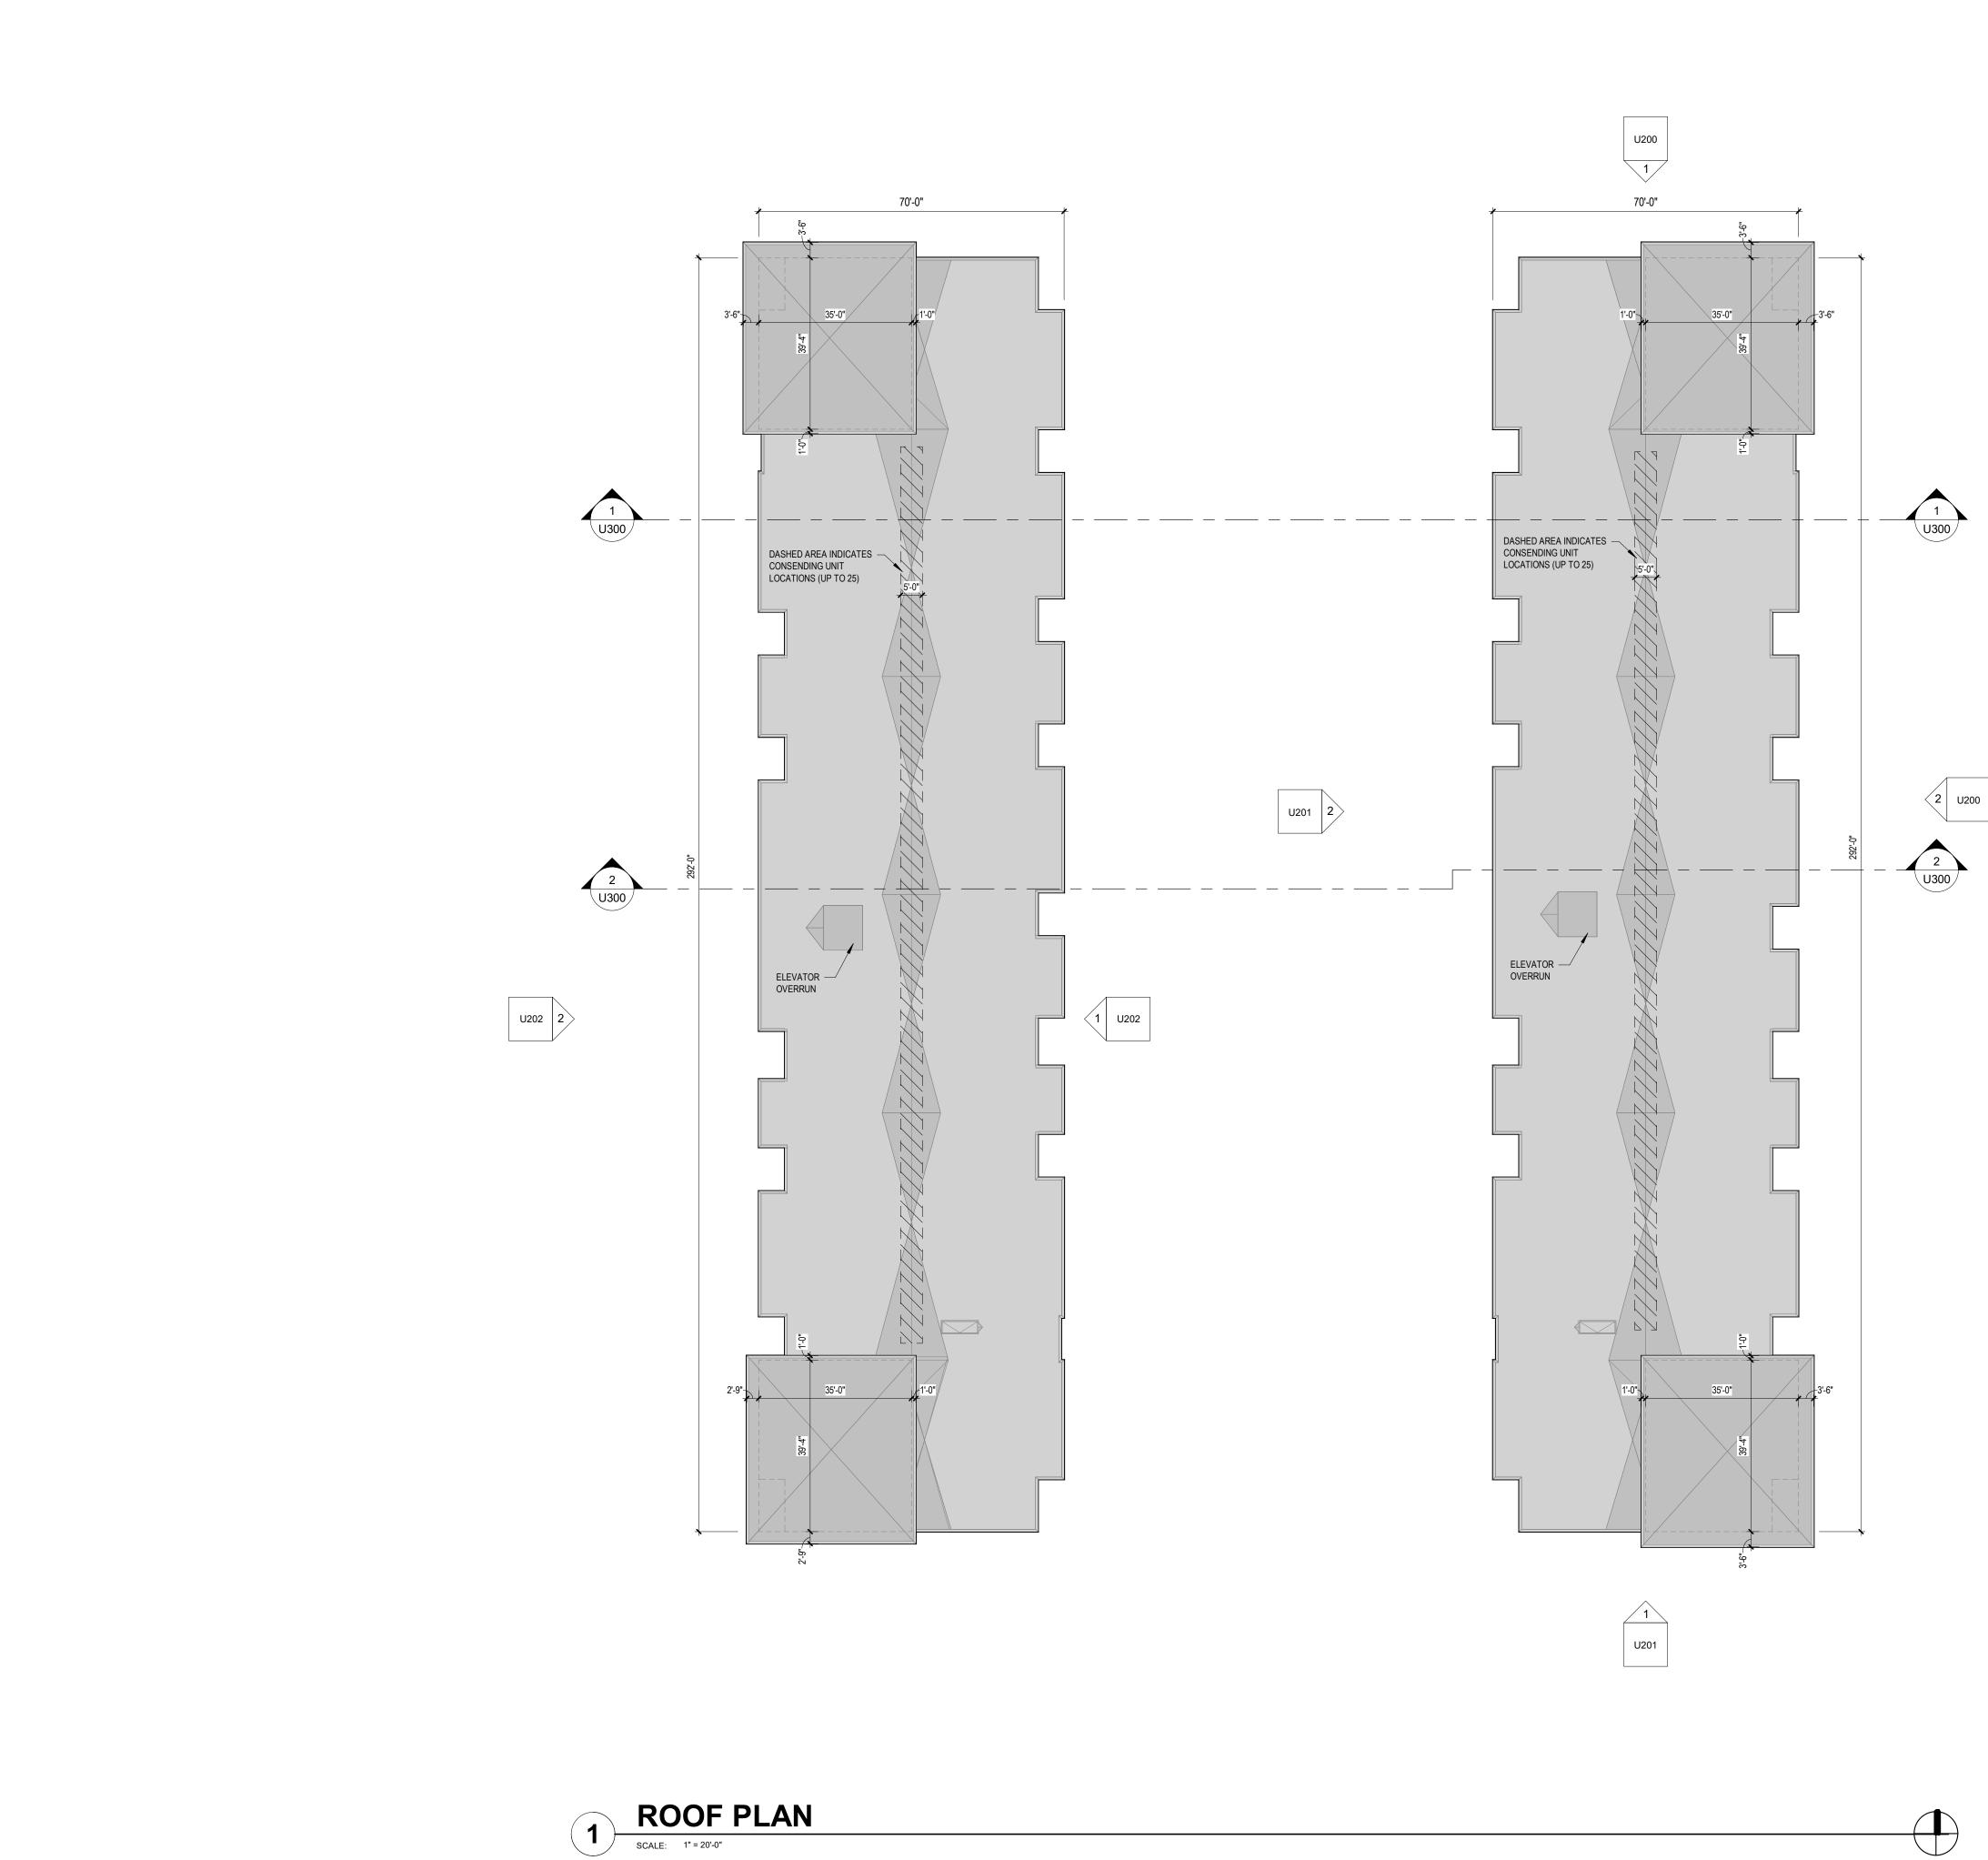

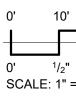

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| JLA PROJECT NUMBER: W22-0201 | | | | | |
| MCKEE ROAD MIXED USE DEVELOPMENT | | | | | |
| CITY OF MADISON LAND USE AND URBAN DESIGN COMMISSION SUBMITTAL | | | | | |
| PROGRESS DOCUMENTS These documents reflect progress and intent and may be subject to change, including additional detail. These are not final construction documents and should not be used for final bidding or construction-related purposes. | | | | | |
| DATE OF ISSUANCE OCTOBER 18, 2024 REVISION SCHEDULE Mark Description | | | | | |
| SHEET TITLE ROOF PLAN | | | | | |
| sheet number U103 | | | | | |

 $\begin{array}{c} 0' & 10' & 20' & 40' \\ \hline \\ 0' & 1/2" & 1" & 2" \\ \end{array}$ $\begin{array}{c} 0' & 1/2" & 1" & 2" \\ \end{array}$ $\begin{array}{c} SCALE: 1" = 20'-0" \end{array}$














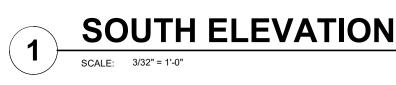







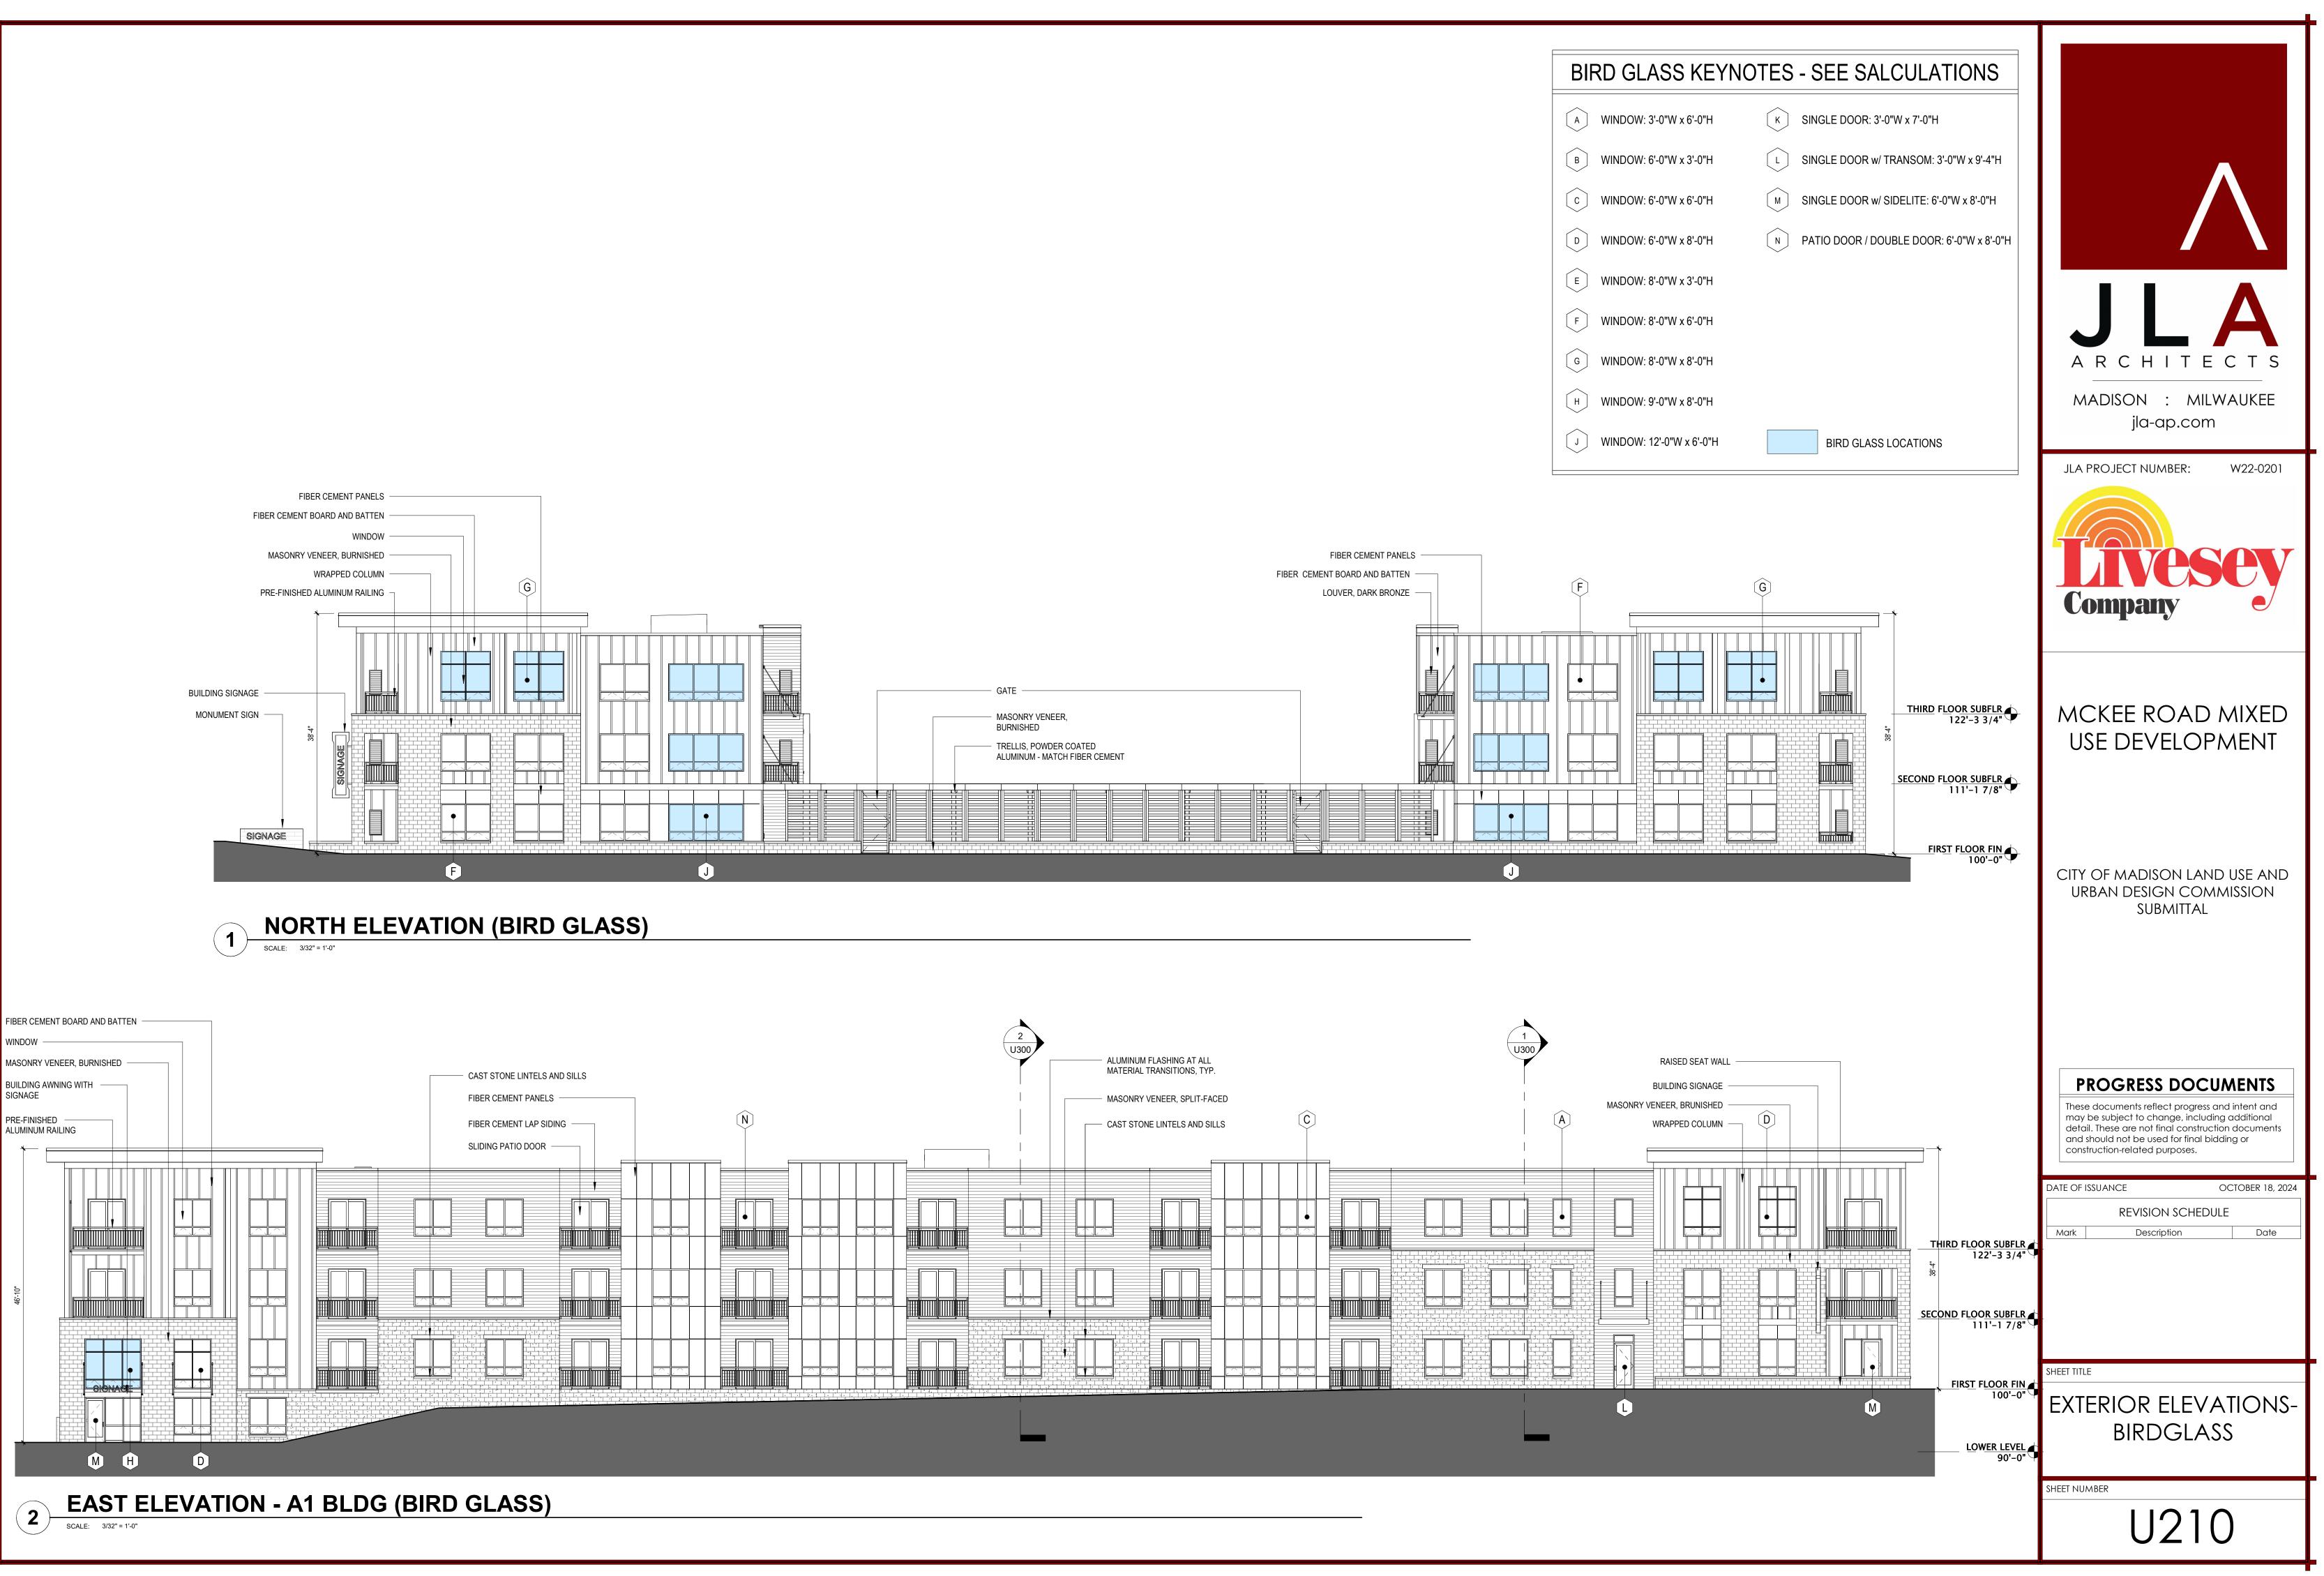


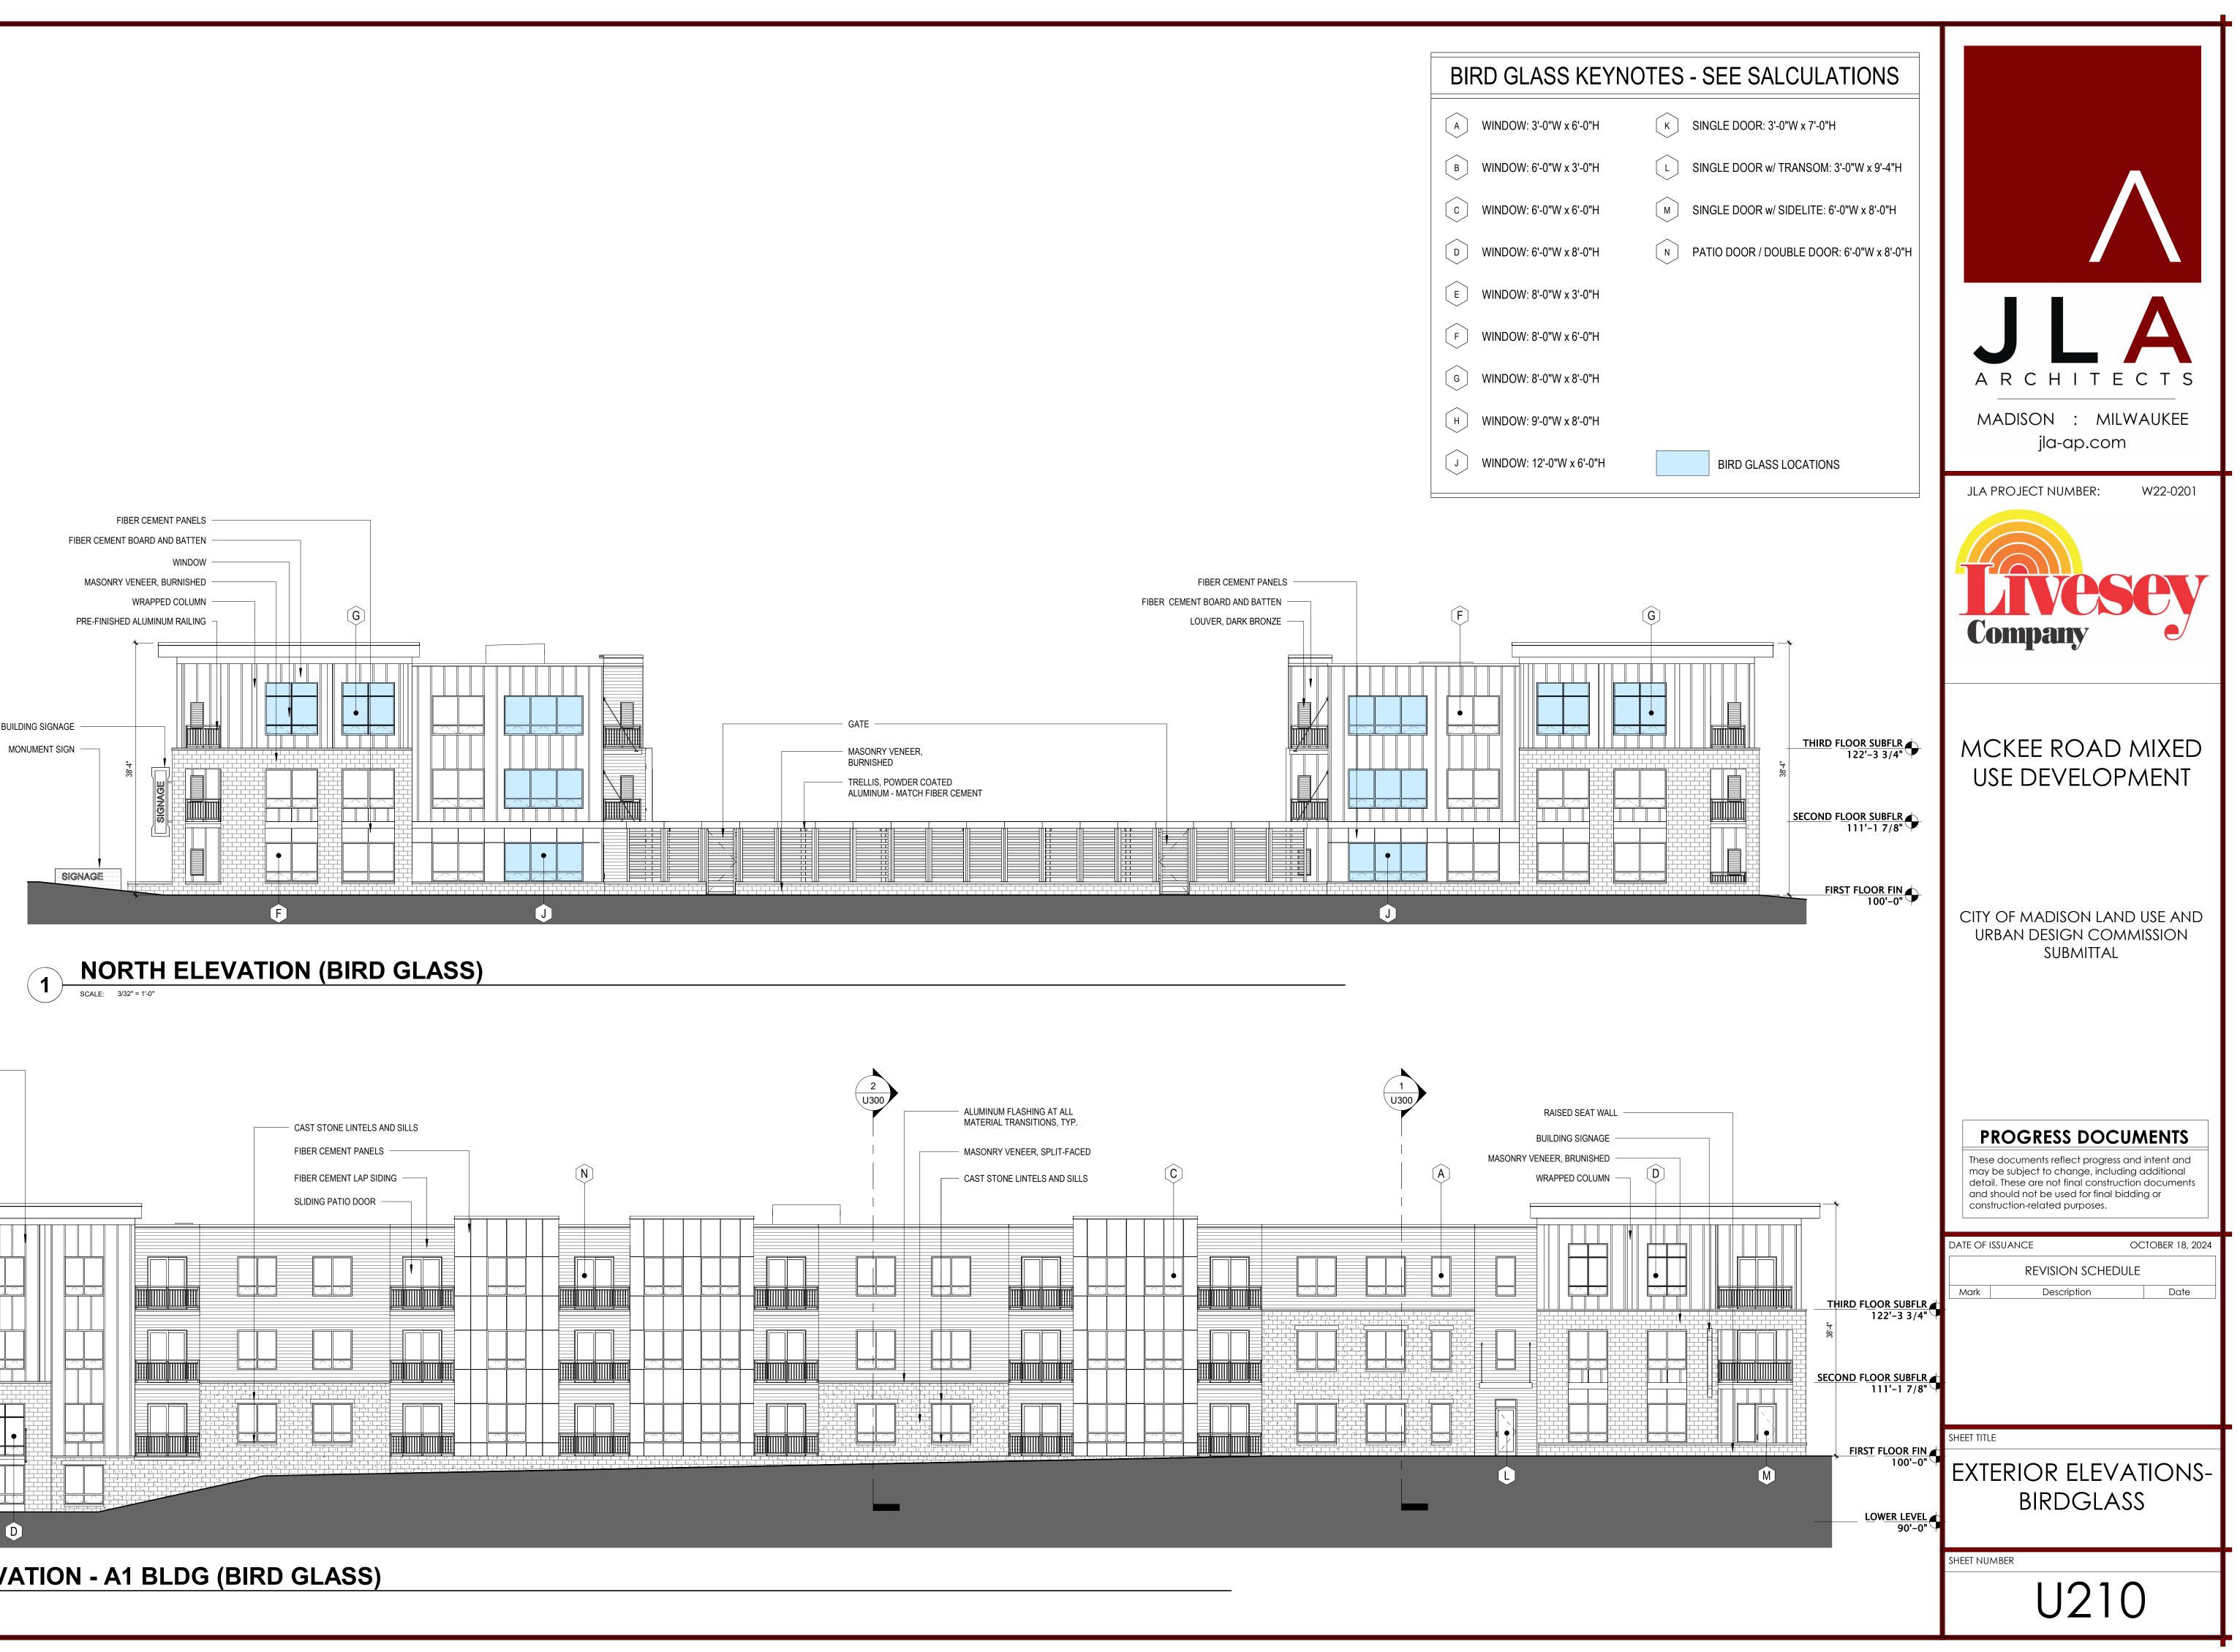



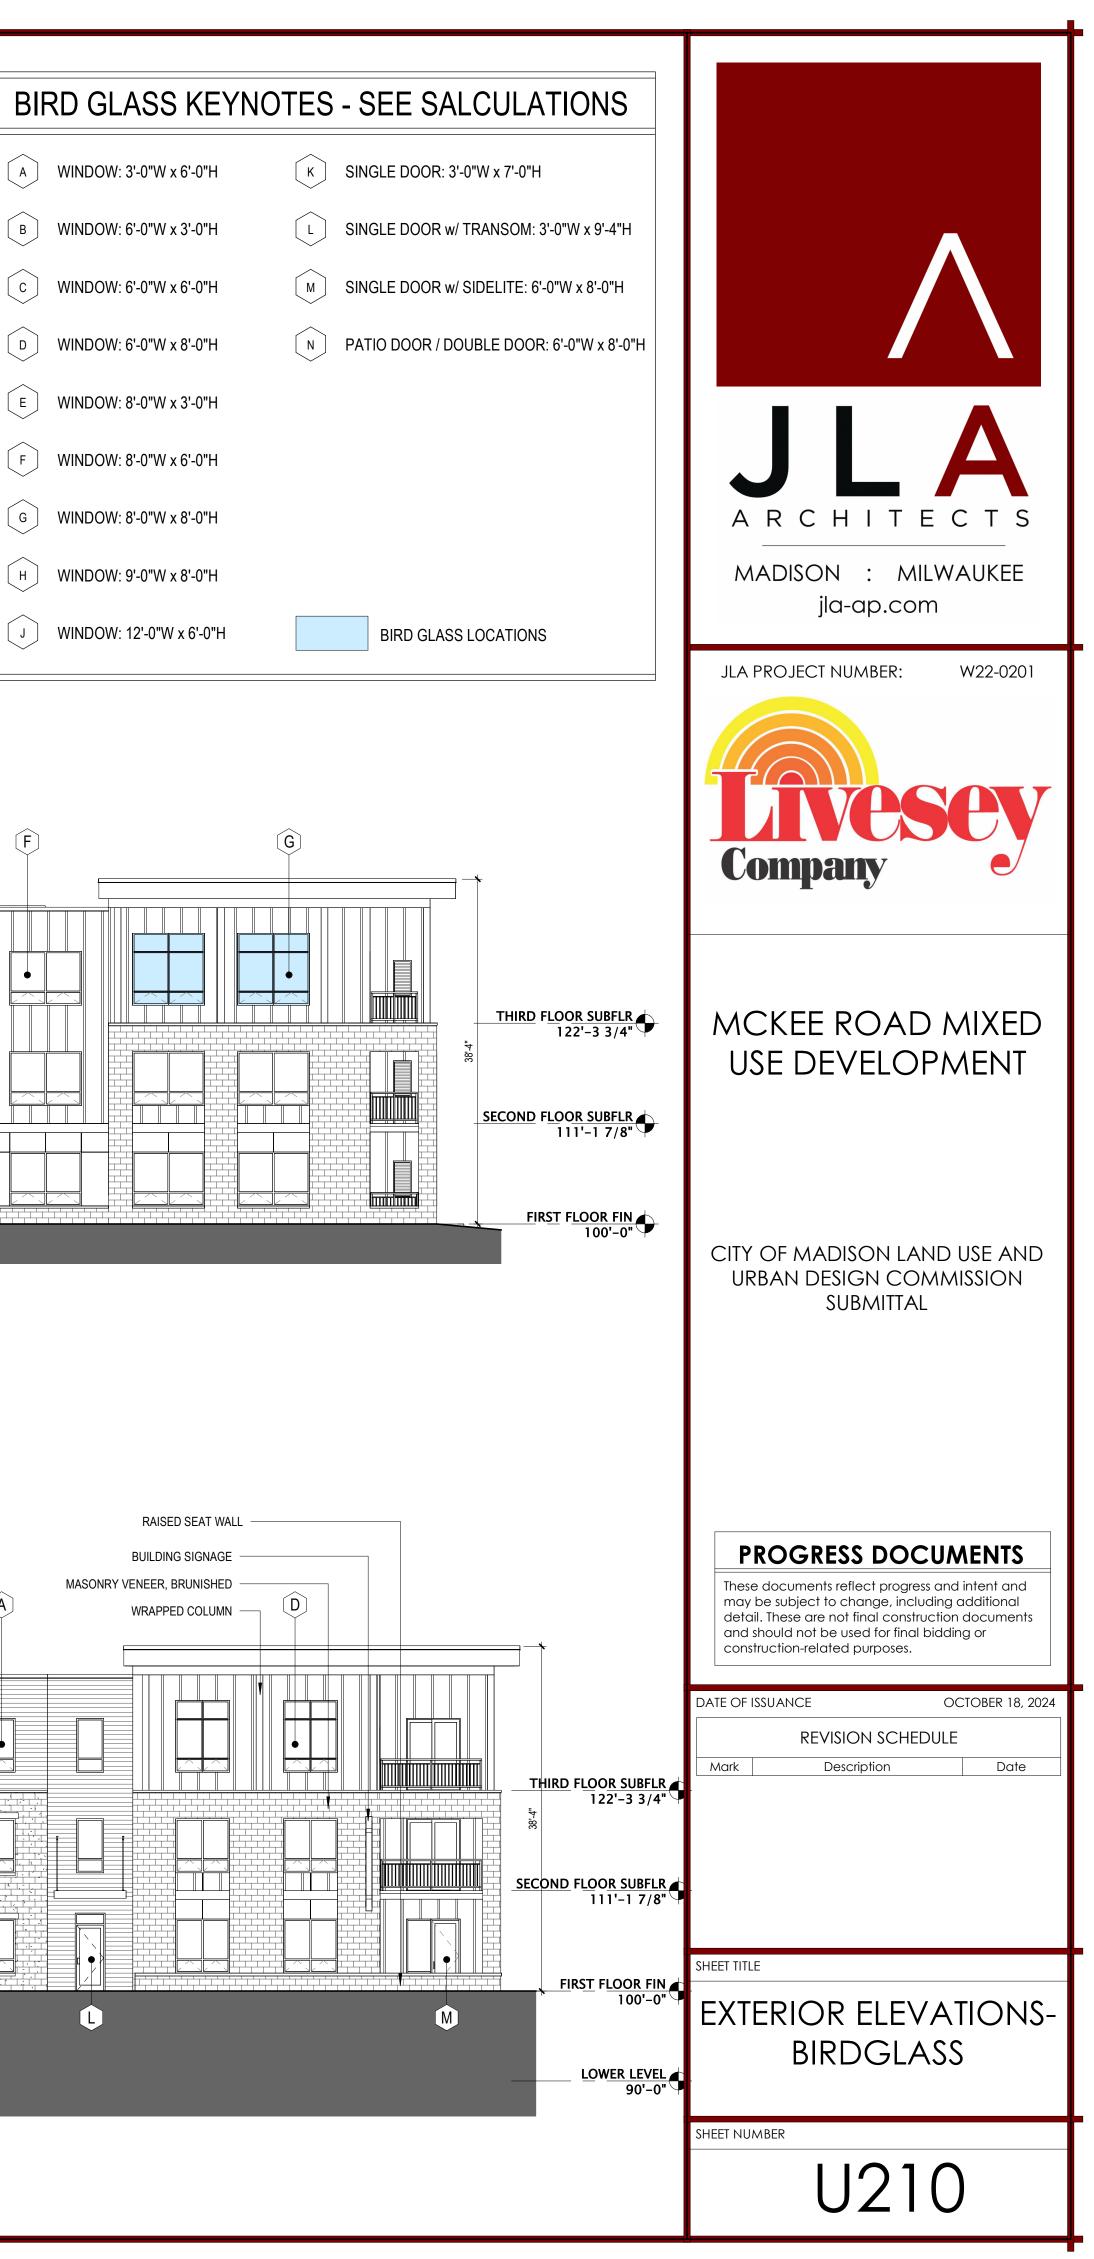

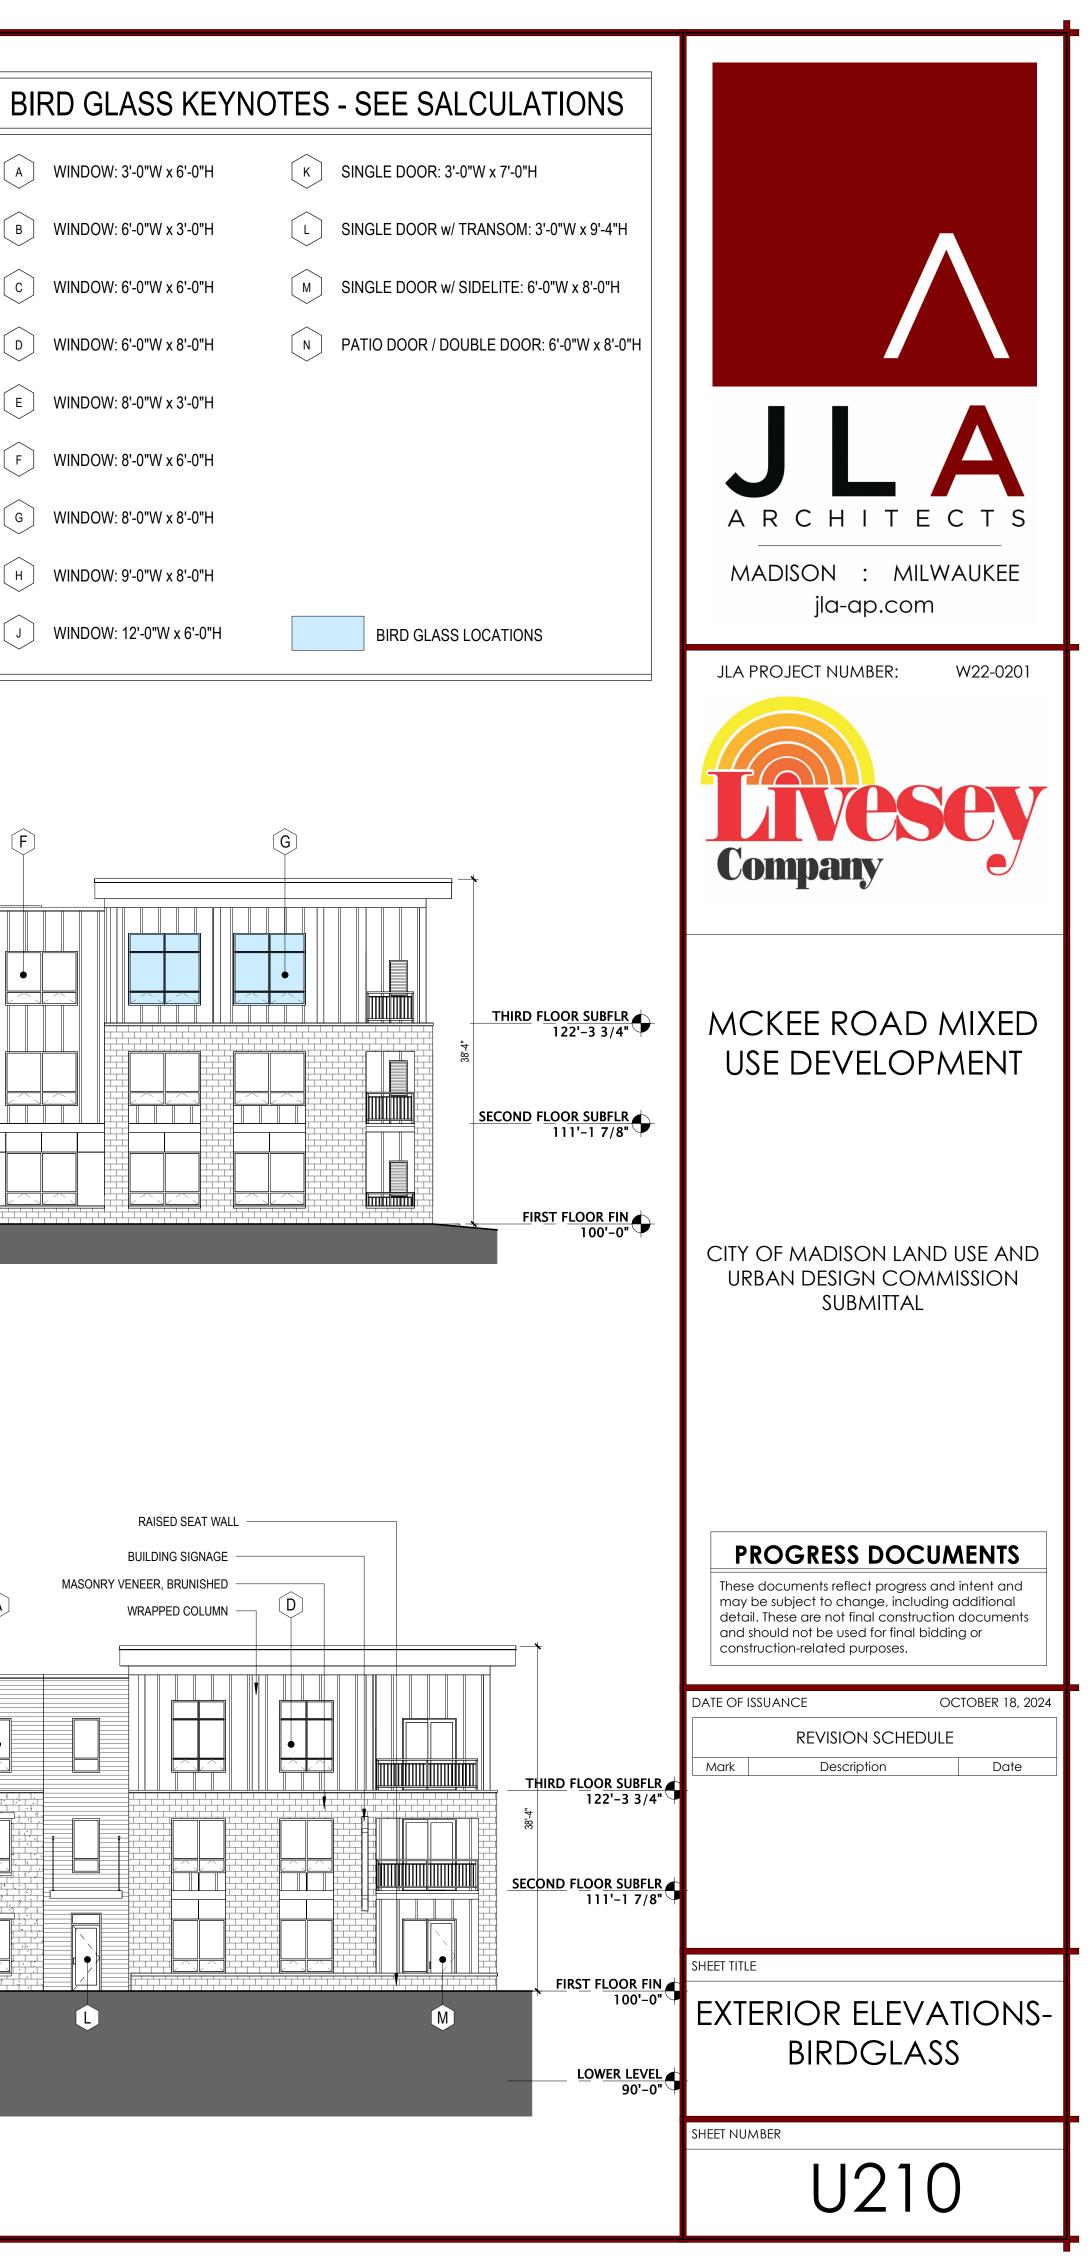

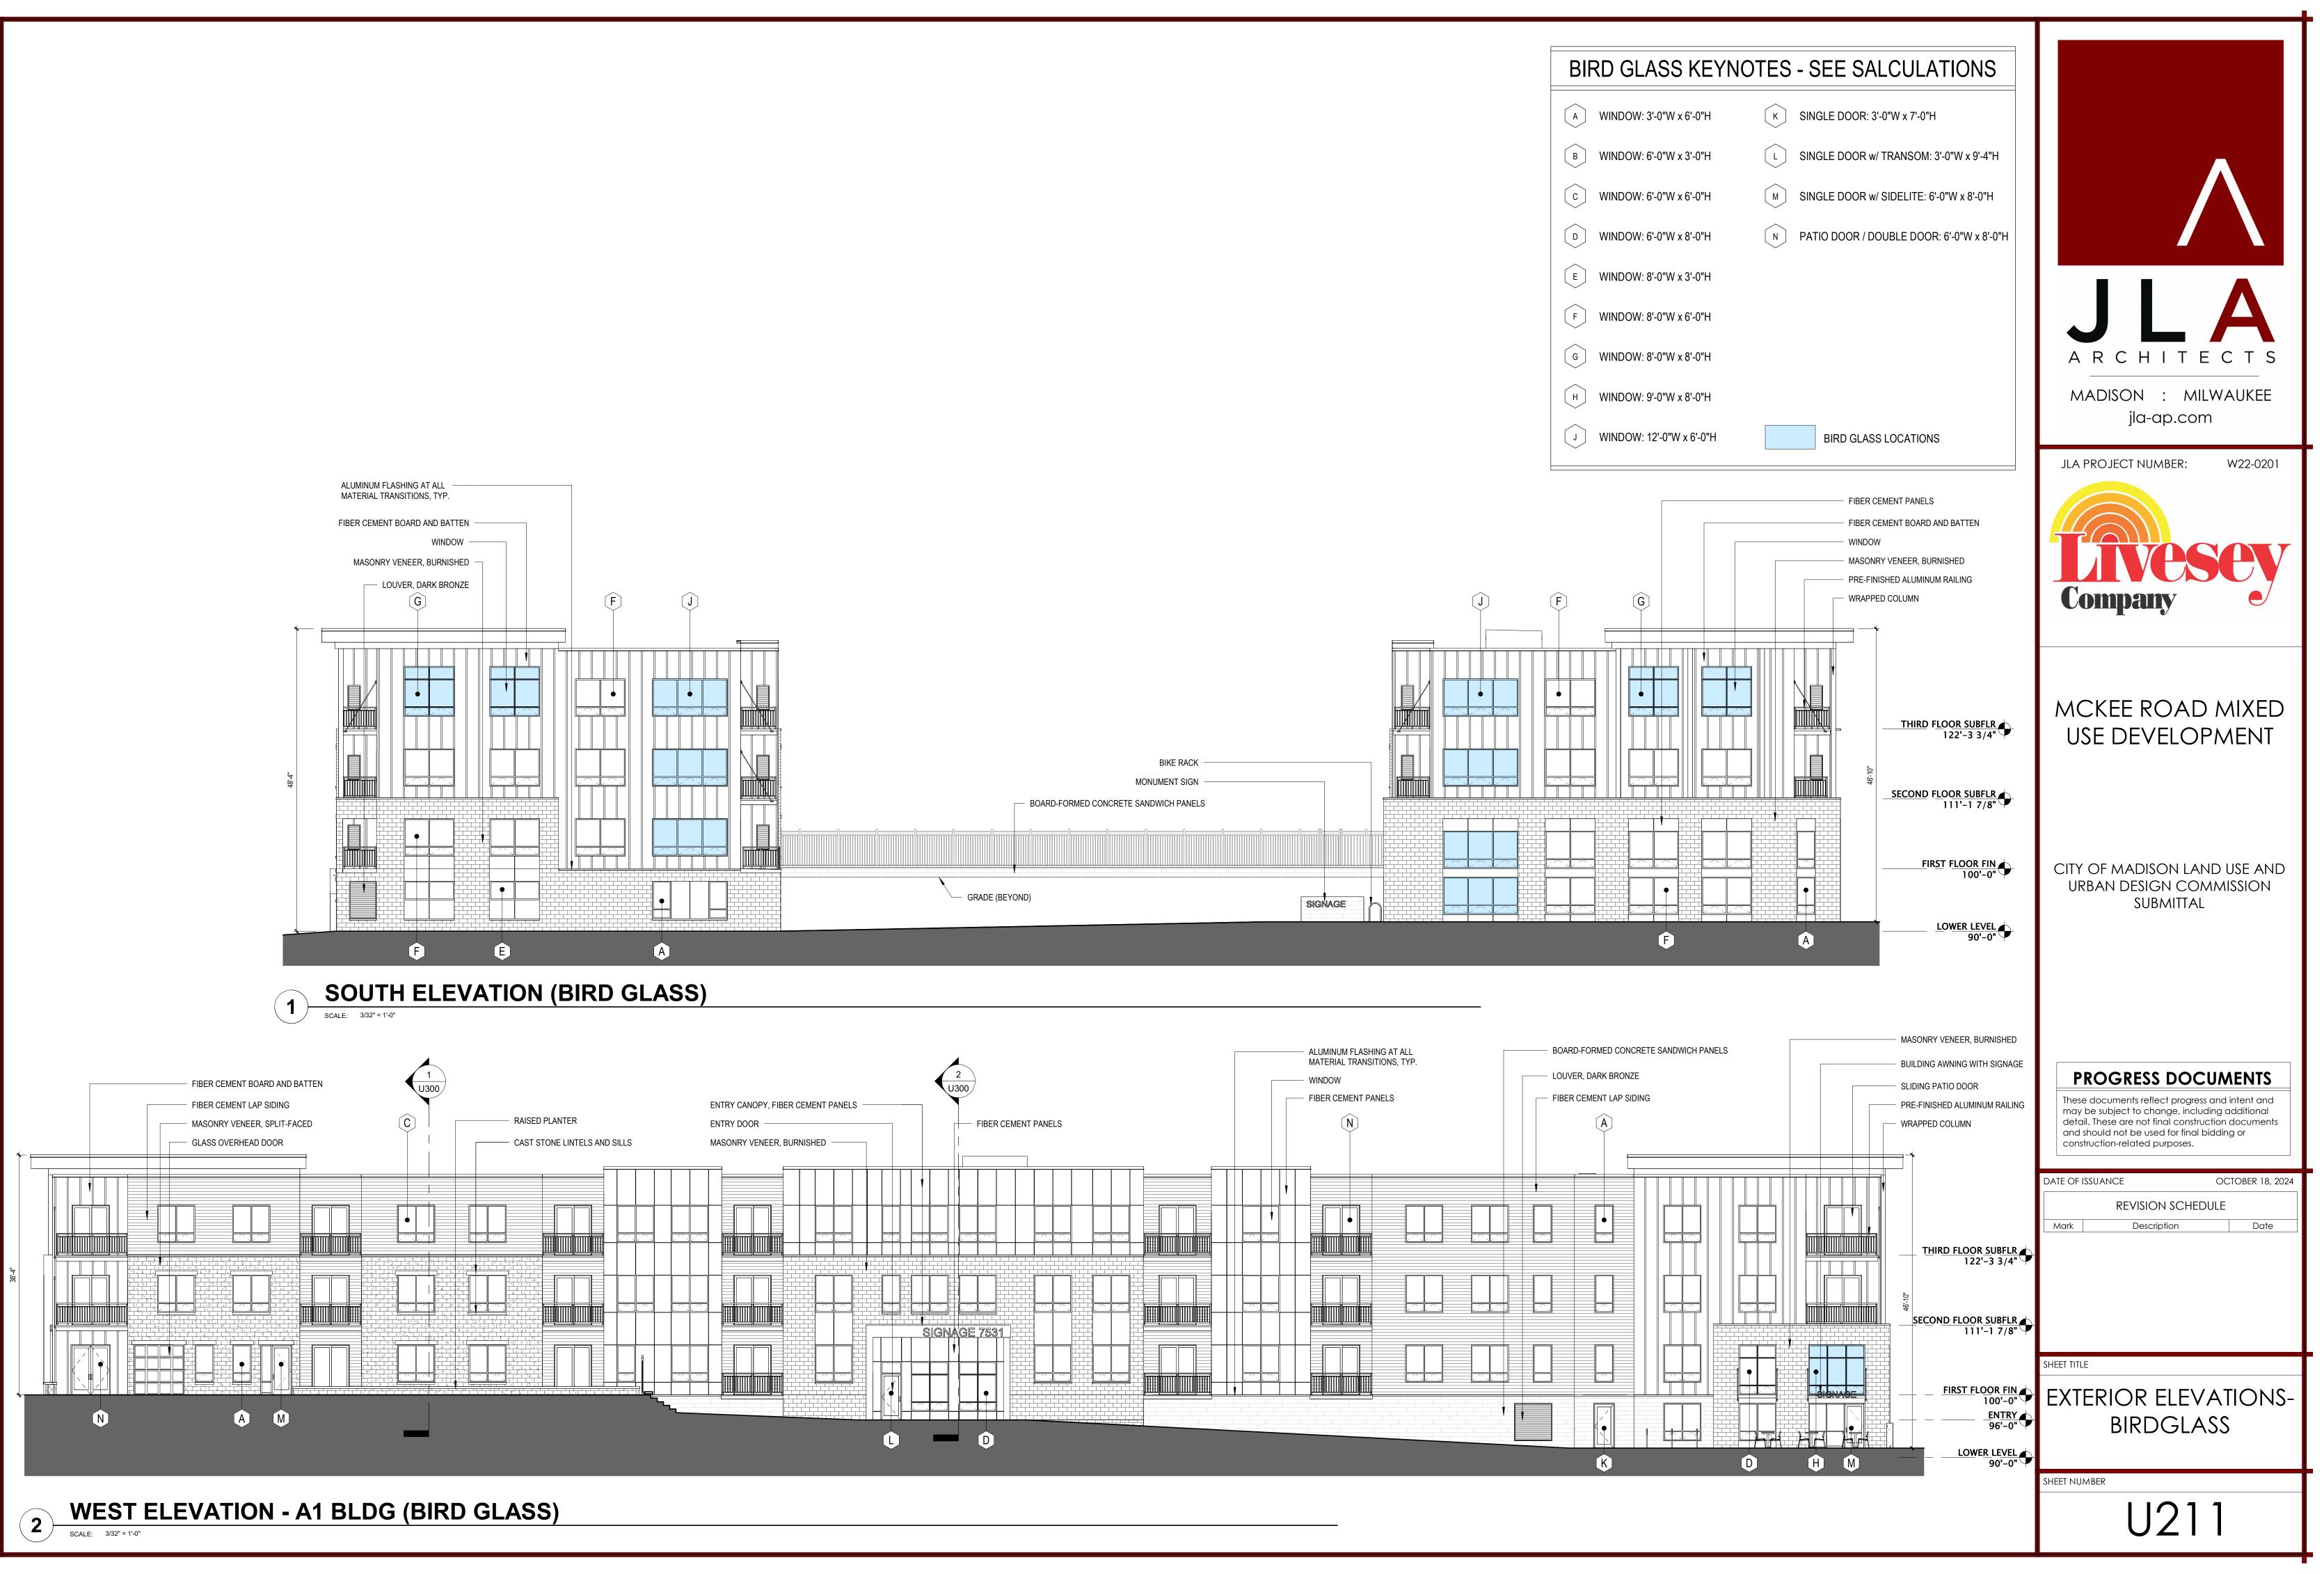




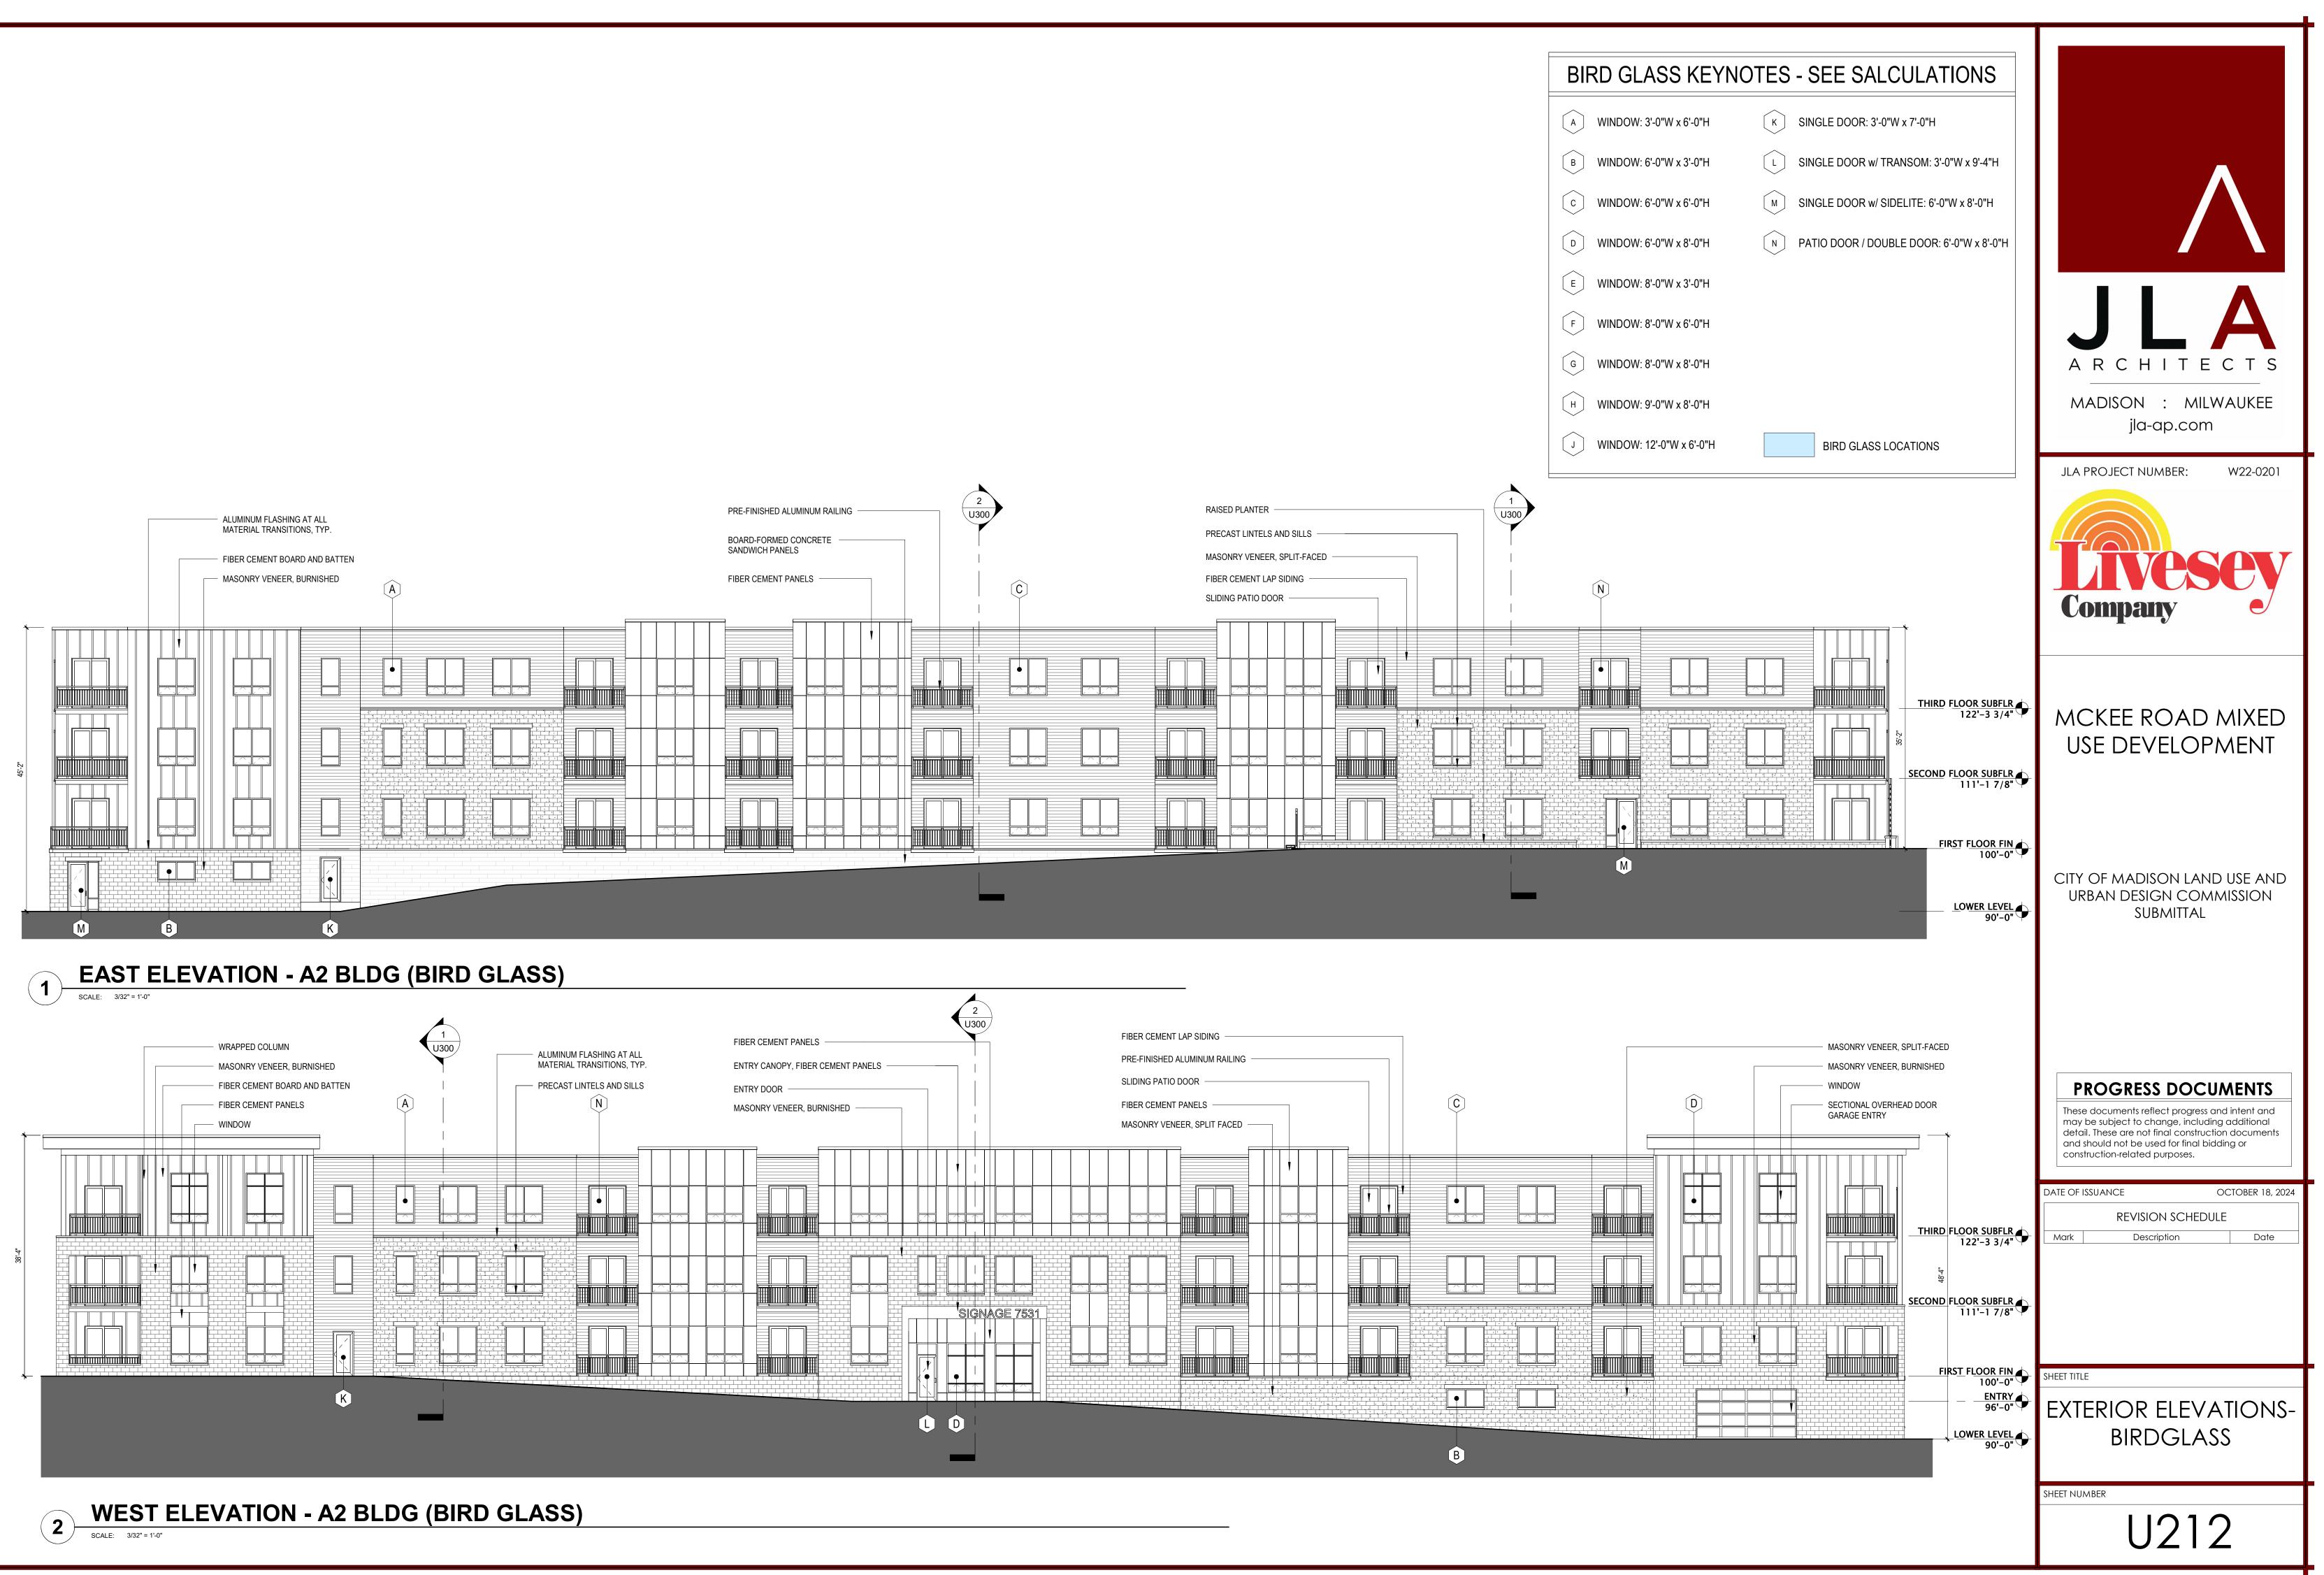


Figure 1 - Window Mullion Graphic SPANDRELL (OPAQUE) SPANDRELL (OPAQUE) GLASS GLASS _ _ _ _ _ _ _ _ _ _ -----GLASS GLASS AREA OF 50 sq. ft. AREA OF 50 sq. ft. CALCULATION CALCULATION ×_____ ≮6 in. OR∮ LESS

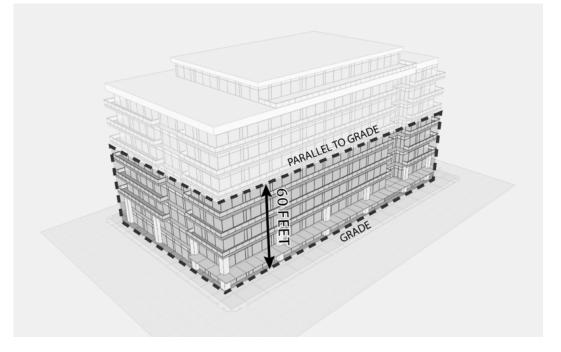BIRD- SAFE GLASS WINDOW MULLION GRAPHIC



BIRD- SAFE GLASS 60-FOOT GRAPHIC

28.129 BIRD-SAFE REQUIREMENTS:

(1) Statement of Purpose: The Bird-Safe Glass Requirements in this section are intended to reduce the heightened risk for bird collisions with glass on specified building designs and configurations.

(2) Applicability: Subsection (4) applies to all exterior construction and development activity, including the expansion of existing buildings and structures, as specified therein.

- (3) Measuring Glass Area: Under this Ordinance, glass area shalle be measured as one (1) continuous panel of glass or other transparent material, or a set of two (2) or more such panels divided by mullions of six (6) inches in width or narrower. Panels surrounded on all sides by solid walls or mullions wider than six (6) inches shall be considered individual windows. Spandrel or opaque reflectivity of 14% or less shall not be included in the calculation of glass area. See Revised Figure 1.
- (4) Bird-Safe Glass Treatment Requirements: Glass areas on the following buildings or structures shall be treated to reduce the risk of bird collision by incorporating a pattern of visual markers that are either; a) dots or other isolated shapes that are 1/4" in diameter or larger and spaced at not more than a two-inch (2") by two-inch (2") pattern; or b) lines that are 1/8" in width or greater and spaced no more than 2" apart; low reflective opaque materials; building-integrated structures like non-glass double-skin facades, metal screens, fixed solar shading, exterior insect screens, and other features that cover the glass surface; or other similar mitigation treatments approved by the Zoning Administrator.

(a) Buildings or structures over 10,000 square feet: For any building or structure over 10,000 square feet in size (floor area of above-grade stories), bird-safe glass treatment is required as follows:

- 1. For building facades where the first sixty (60) feet (See REVISED Figure 2) from grade are comprised of greater than or equal to fifty percent (50%) glass: a. At least eighty-five percent (85%) of the glass must be treated; and b. All glass within fifteen (15) feet of a building corner must be treated when see through or fly through conditions exist. See Figure 3.
- 2. For building facades where the first sixty (60) feet from grade are comprised of less than fifty percent (50%) glass; a. At least eighty-five percent (85%) of the glass on glass areas fifty (50) square feet or over must be treated; and b. Of all glass areas over fifty (50) square feet, any glass within fifteen (15) feet of a building corner must be treated.

3. All glass railings must be treated.

- 4. All glass on enclosed building connections shall be treated up to sixty (60) feet above grade.
- (b) Sky-bridges: For buildings and structures of any size, all glass on above-ground bridges must be treated.

(c) At grade glass: For buildings and structures of any size, all at grade glass features such as sound walls or glass screens must be treated.

(5) This Ordinance shall become effective October 1, 2020.

McKee Avenue Mixed-Use BIRD GLASS CALCULATIONS 10/7/2024

Building Δ1

Building A2


*50+ SQ FT AND REQUIRE A BIRD GLAZING

| | | | | | WALL DESIGNATION | | | | | | | |
|-----------------------------------|-------|--------|------------|------|------------------|-----------|----------|-----------|----------|-----------|----------|-----------|
| | | | | | NORTH E | LEVATION | SOUTH E | LEVATION | EAST EL | EVATION | WEST EL | EVATION |
| WINDOW/ DOOR DESIGNATION | WIDTH | HEIGHT | # OF PANES | AREA | GLZ AREA | # WINDOW | GLZ AREA | # WINDOW | GLZ AREA | # WINDOW | GLZ AREA | # WINDOW |
| A: WINDOW - 3'-0"x 6'-0" | 3.0 | 6.0 | 2 | 18.0 | 0.0 | 0 | 36.0 | 2 | 162.0 | 9 | 180.0 | 10 |
| B: WINDOW - 6'-0"x 3'-0" | 6.0 | 3.0 | 2 | 18.0 | 0.0 | 0 | 0.0 | 0 | 0.0 | 0 | 0.0 | (|
| C: WINDOW - 6'-0" x 6'-0" | 6.0 | 6.0 | 4 | 36.0 | 0.0 | 0 | 0.0 | 0 | 1620.0 | 45 | 1620.0 | 45 |
| D: WINDOW - 6'-0" x 8'-0" | 6.0 | 8.0 | 6 | 48.0 | 0.0 | 0 | 0.0 | 0 | 144.0 | 3 | 144.0 | 3 |
| E: WINDOW - 8'-0" x 3'-0" | 8.0 | 3.0 | 2 | 24.0 | 0.0 | 0 | 0.0 | 0 | 0.0 | 0 | 0.0 | C |
| F: WINDOW - 8'-0" x 6'-0" | 8.0 | 6.0 | 4 | 48.0 | 336.0 | 7 | 480.0 | 10 | 0.0 | 0 | 0.0 | C |
| G: WINDOW - 8'-0" x 8'-0" | 8.0 | 8.0 | 6 | 64.0 | 128.0 | 2 | 128.0 | 2 | 0.0 | 0 | 0.0 | (|
| H: WINDOW - 9'-0" x 8'-0" | 9.0 | 8.0 | 9 | 72.0 | 0.0 | 0 | 0.0 | 0 | 72.0 | 1 | 72.0 |] |
| J: WINDOW - 12'-0" x 6'-0" | 12.0 | 6.0 | 6 | 72.0 | 216.0 | 3 | 288.0 | 4 | 0.0 | 0 | 0.0 | C |
| K: DOOR - 3'-0" x 7'-0" | 3.0 | 7.0 | 1 | 21.0 | 0.0 | 0 | 0.0 | 0 | 21.0 | 1 | 21.0 |] |
| L: DOOR & TRANSOM: 3'-0" x 9'-4" | 3.0 | 9.3 | 2 | 27.9 | 0.0 | 0 | 0.0 | 0 | 27.9 | 1 | 27.9 | 1 |
| M: DOOR & SIDELITE: 6'-0" x 8'-0" | 6.0 | 8.0 | 2 | 48.0 | 0.0 | 0 | 0.0 | 0 | 96.0 | 2 | 96.0 | 2 |
| N: PATIO DOOR: 6'-0" x 8'-0" | 6.0 | 8.0 | 2 | 48.0 | 0.0 | 0 | 0.0 | 0 | 960.0 | 20 | 960.0 | 20 |
| | | | | | 680.0 | TOTAL GLZ | 932.0 | TOTAL GLZ | 3,102.9 | TOTAL GLZ | 3,120.9 | TOTAL GLZ |
| | | | | | 2,045 | WALL AREA | 2,834 | WALL AREA | 11,592 | WALL AREA | 11,087 | WALL AREA |
| | | | | | 33.25% | % GLAZING | 32.89% | % GLAZING | 26.77% | % GLAZING | 28.15% | % GLAZING |

*50+ SQ FT AND REQUIRE A BIRD GLAZING SAFETY SYSTEM ON A MIN. OF 85% OF THE GLAZING

| | | | | | WALL DESIGNATION | | | | | | | |
|-----------------------------------|-------|--------|------------|------|------------------|-----------|----------|-----------|----------|-----------|----------|-----------|
| | | | | | NORTH E | LEVATION | SOUTH E | LEVATION | EAST EL | EVATION | WEST EL | EVATION |
| WINDOW/ DOOR DESIGNATION | WIDTH | HEIGHT | # OF PANES | AREA | GLZ AREA | # WINDOW | GLZ AREA | # WINDOW | GLZ AREA | # WINDOW | GLZ AREA | # WINDOW |
| A: WINDOW - 3'-0"x 6'-0" | 3.0 | 6.0 | 2 | 18.0 | 0.0 | 0 | 36.0 | 2 | 108.0 | 6 | 126.0 | |
| B: WINDOW - 6'-0"x 3'-0" | 6.0 | 3.0 | 2 | 18.0 | 0.0 | 0 | 0.0 | 0 | 36.0 | 2 | 36.0 | |
| C: WINDOW - 6'-0" x 6'-0" | 6.0 | 6.0 | 4 | 36.0 | 0.0 | 0 | 0.0 | 0 | 1620.0 | 45 | 1512.0 | 4 |
| D: WINDOW - 6'-0" x 8'-0" | 6.0 | 8.0 | 6 | 48.0 | 0.0 | 0 | 0.0 | 0 | 0.0 | 0 | 288.0 | |
| E: WINDOW - 8'-0" x 3'-0" | 8.0 | 3.0 | 2 | 24.0 | 0.0 | 0 | 0.0 | 0 | 0.0 | 0 | 0.0 | |
| F: WINDOW - 8'-0" x 6'-0" | 8.0 | 6.0 | 4 | 48.0 | 336.0 | 7 | 336.0 | 7 | 0.0 | 0 | 0.0 | |
| G: WINDOW - 8'-0" x 8'-0" | 8.0 | 8.0 | 6 | 64.0 | 128.0 | 2 | 128.0 | 2 | 0.0 | 0 | 0.0 | |
| H: WINDOW - 9'-0" x 8'-0" | 9.0 | 8.0 | 9 | 72.0 | 0.0 | 0 | 0.0 | 0 | 0.0 | 0 | 0.0 | |
| J: WINDOW - 12'-0" x 6'-0" | 12.0 | 6.0 | 6 | 72.0 | 216.0 | 3 | 216.0 | 3 | 0.0 | 0 | 0.0 | |
| K: DOOR - 3'-0" x 7'-0" | 3.0 | 7.0 | 1 | 21.0 | 0.0 | 0 | 0.0 | 0 | 21.0 | 1 | 21.0 | |
| L: DOOR & TRANSOM: 3'-0" x 9'-4" | 3.0 | 9.3 | 2 | 27.9 | 0.0 | 0 | 0.0 | 0 | 0.0 | 0 | 27.9 | |
| M: DOOR & SIDELITE: 6'-0" x 8'-0" | 6.0 | 8.0 | 2 | 48.0 | 0.0 | 0 | 0.0 | 0 | 96.0 | 2 | 0.0 | |
| N: PATIO DOOR: 6'-0" x 8'-0" | 6.0 | 8.0 | 2 | 48.0 | 0.0 | 0 | 0.0 | 0 | 1104.0 | 23 | 1008.0 | 2 |
| | | | | | 680.0 | TOTAL GLZ | 716.0 | TOTAL GLZ | 2,985.0 | TOTAL GLZ | 3,018.9 | TOTAL GLZ |
| | | | | | 2,045 | WALL AREA | 2,755 | WALL AREA | 11,384 | WALL AREA | 11,785 | WALL AREA |
| | | | | | 33.25% | % GLAZING | 25.99% | % GLAZING | 26.22% | % GLAZING | 25.62% | % GLAZING |

| SAFETY SYSTEM ON A MIN. OF 8 | 85% OF THE GLAZING |
|------------------------------|--------------------|
|------------------------------|--------------------|

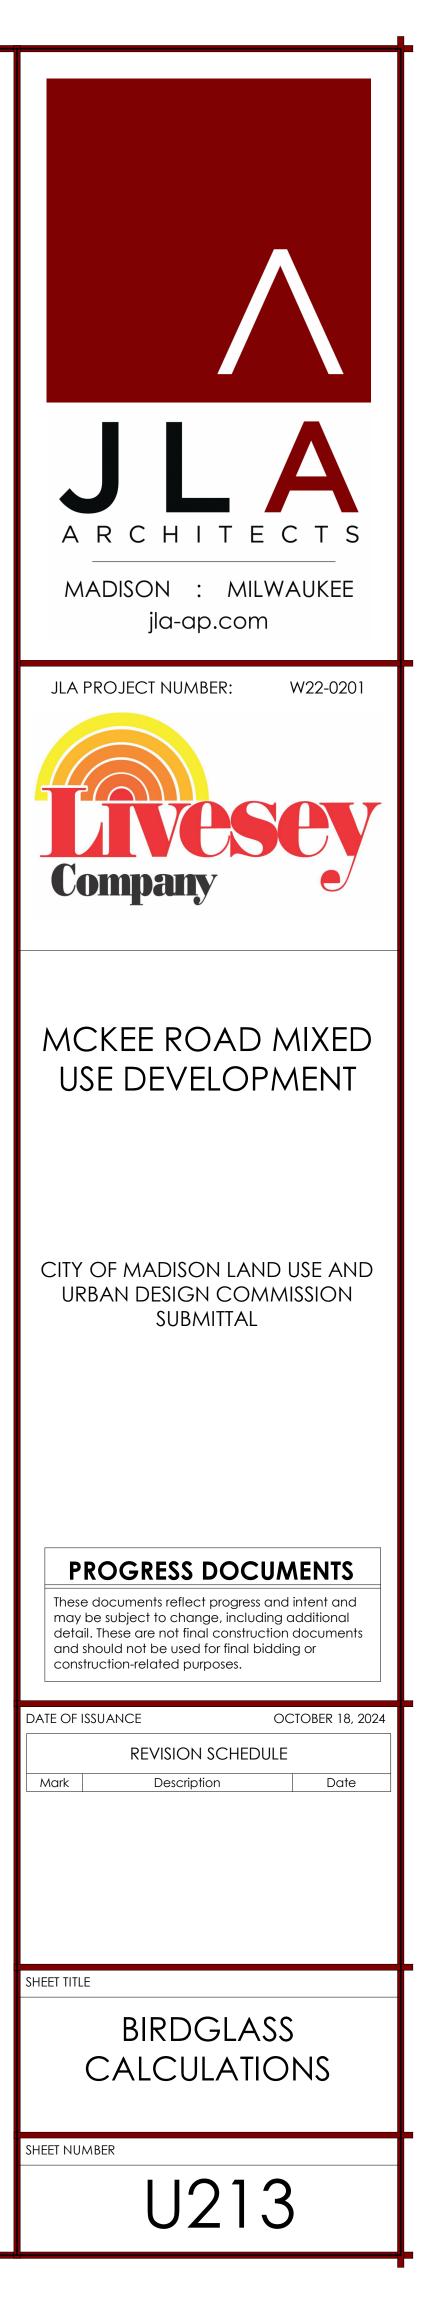



DARK BRONZE FINISH: WINDOWS, LOUVERS, COPING, RAILINGS, PICKET FENCES

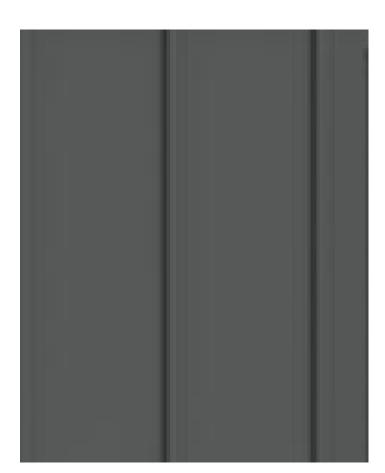


FIBER CEMENT LAP SIDING: AGED PEWTER





FIBER CEMENT PANEL: **IRON GRAY**



FIBER CEMENT BOARD AND BATTEN: **IRON GRAY**



PRECAST CONCRETE: LINTEL, SILL, WALL CAPS



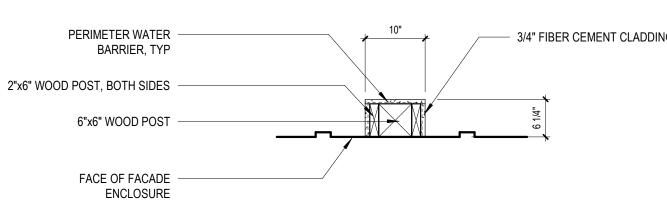


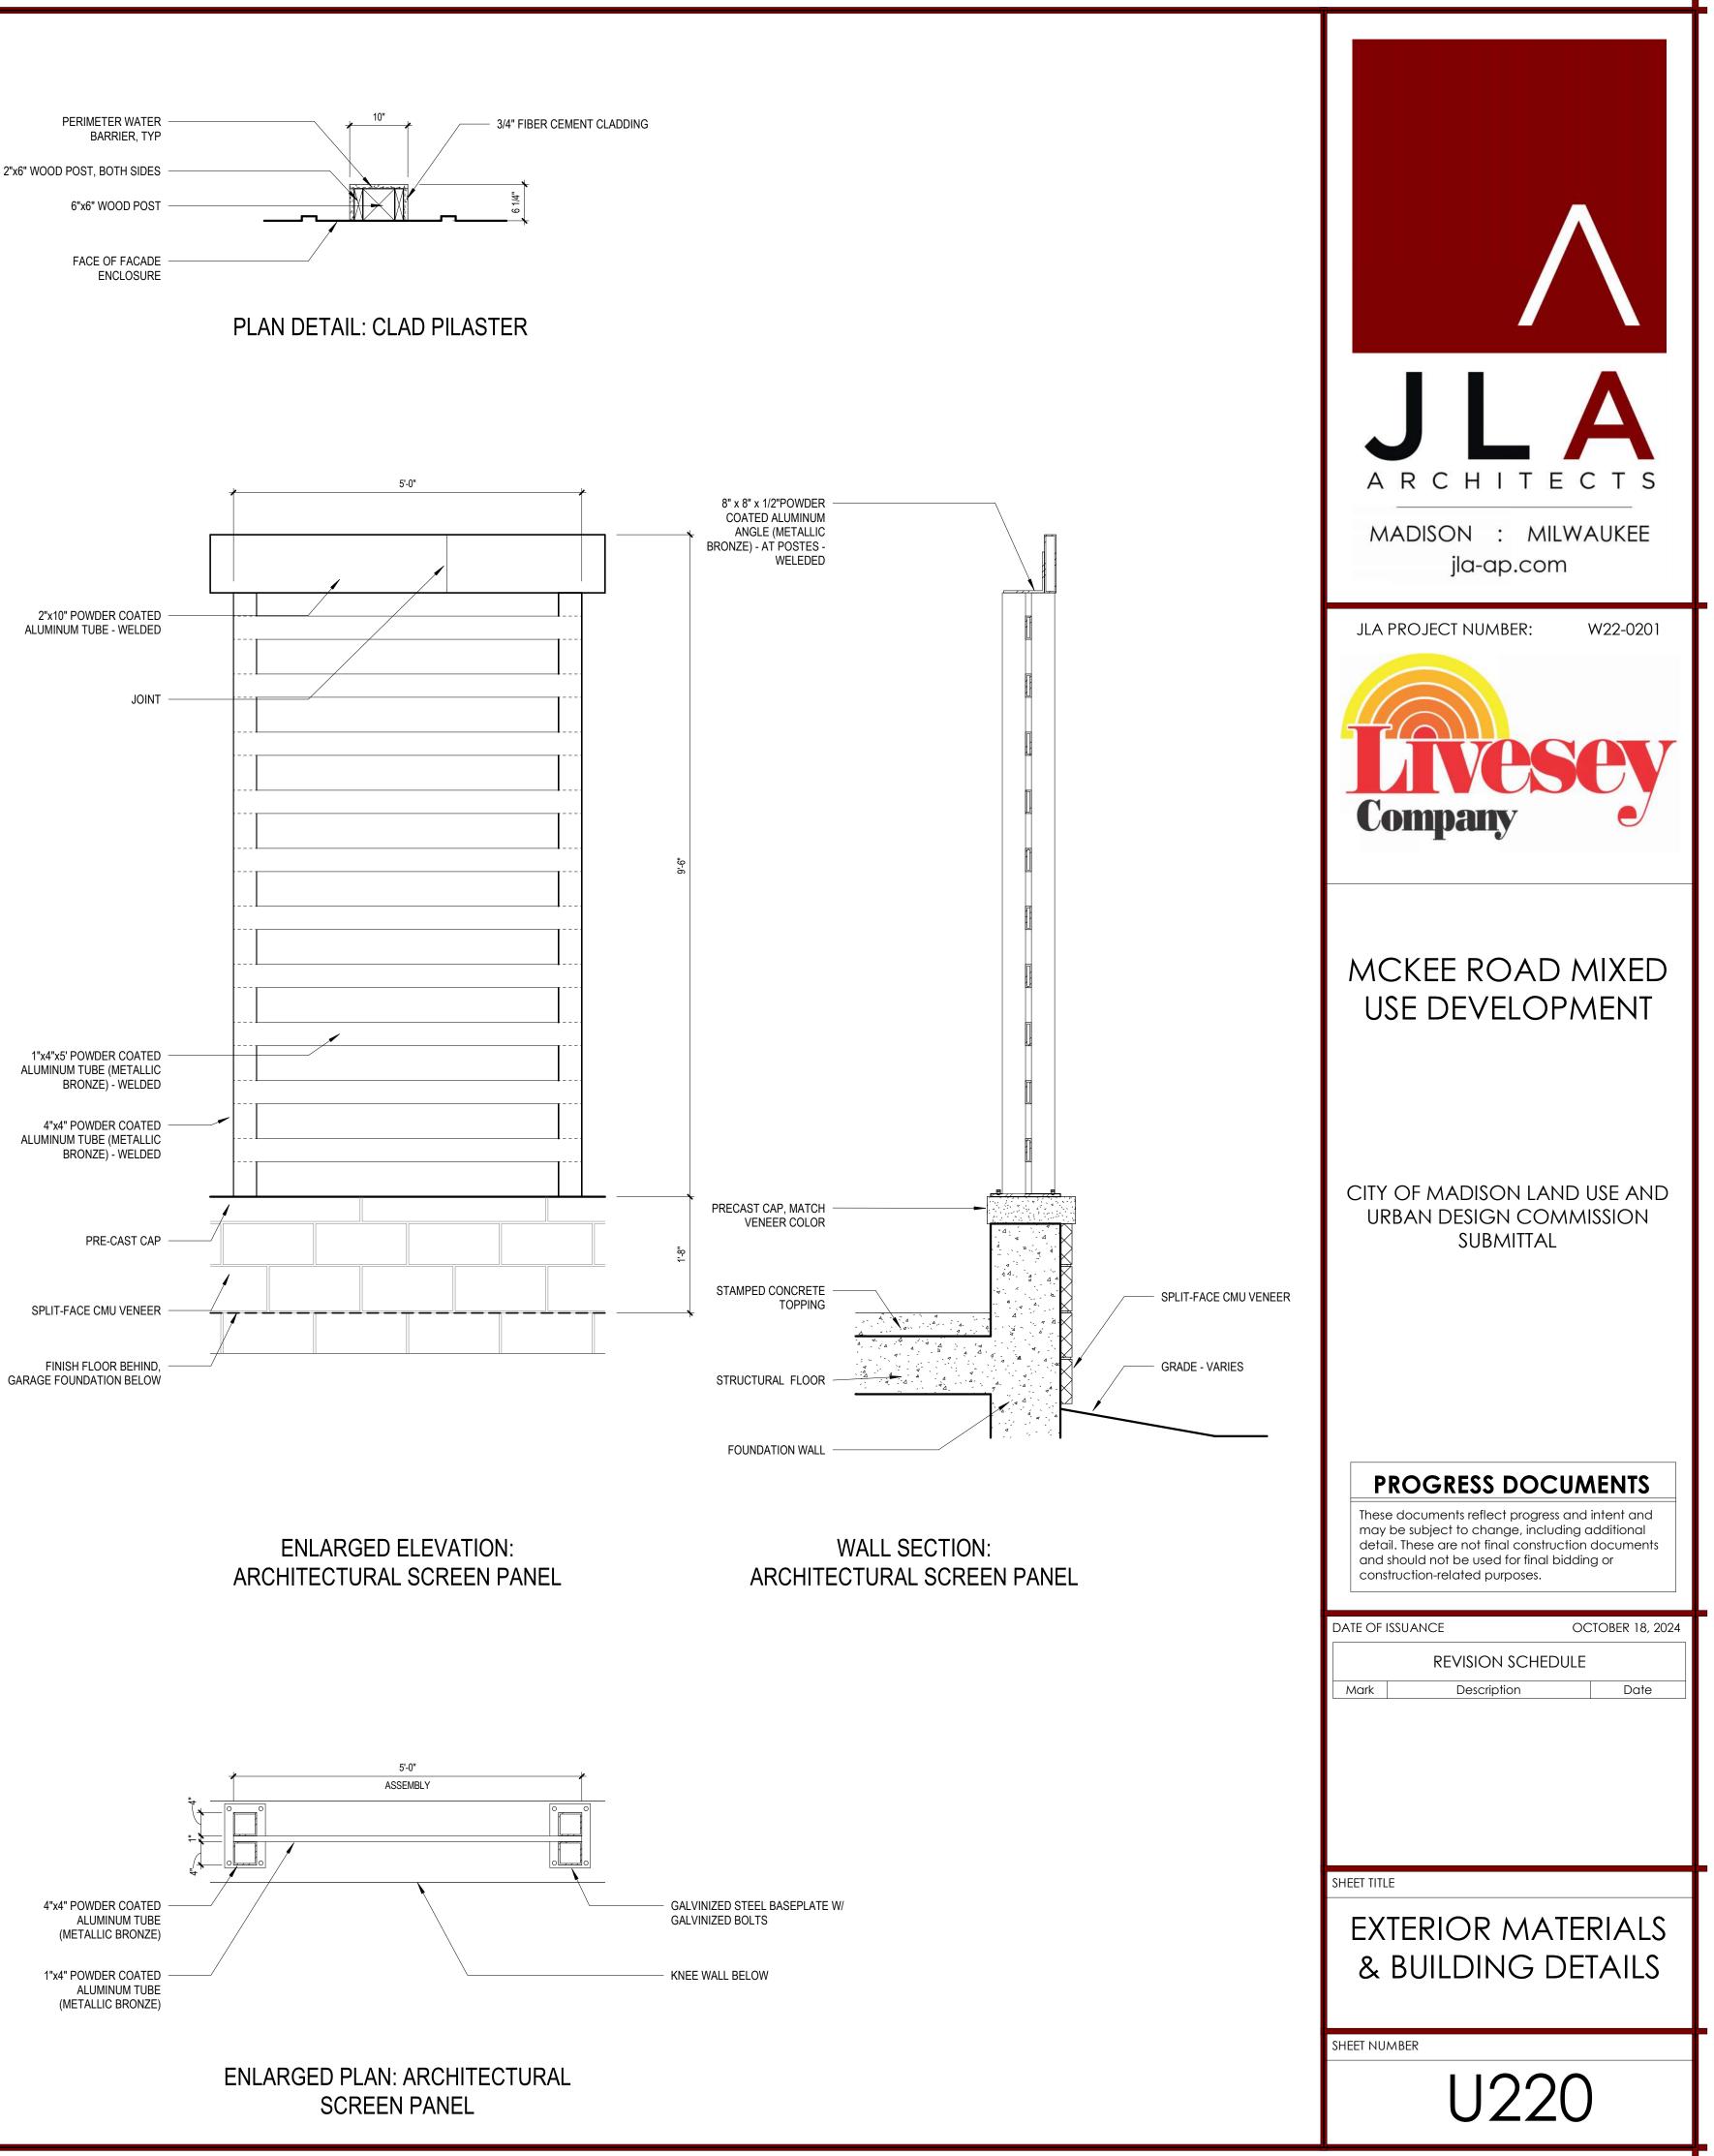


METALIC BRONZE: FIBER CEMENT CLADDING AND ARCHITECTURAL SCREEN POWDER COAT

CMU: SPLITFACE CREAM COLOR

BOARD FORMED CONCRETE











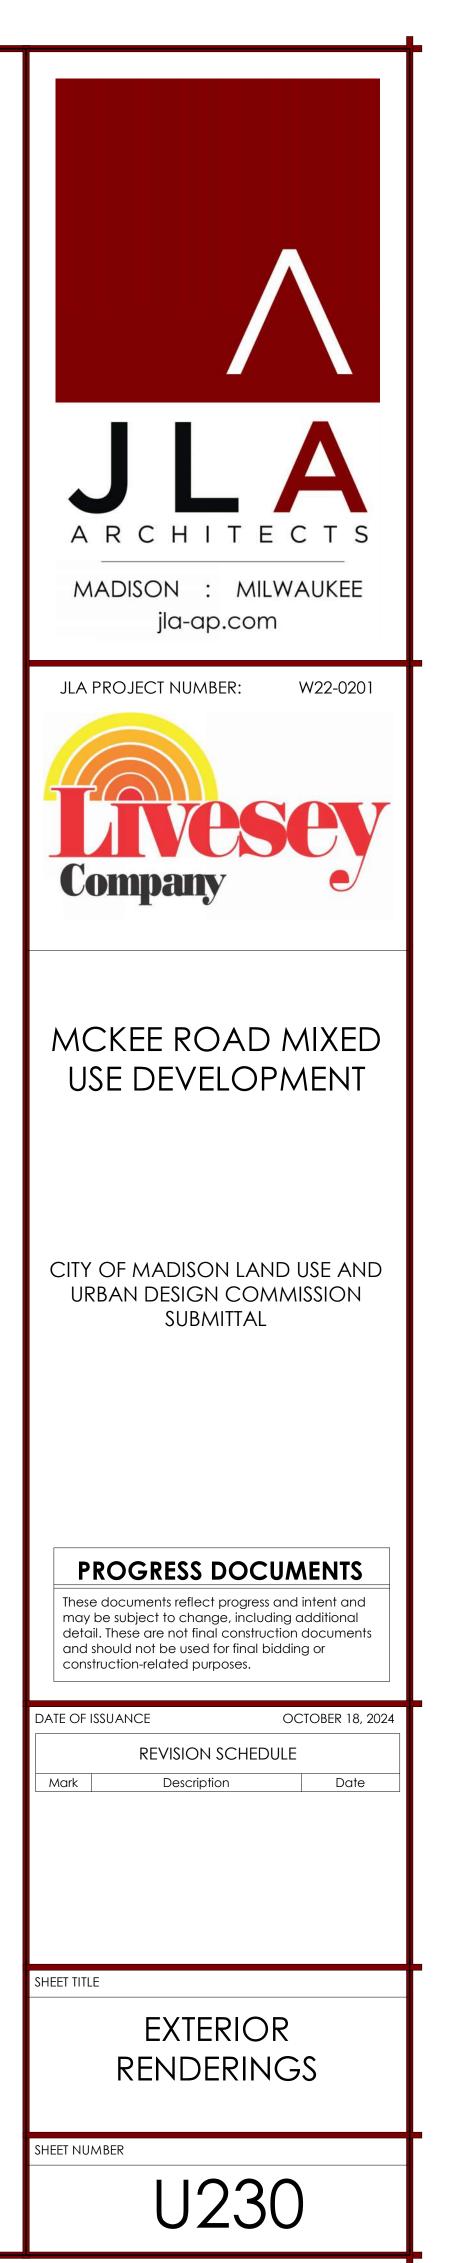PERSPECTIVE RENDERING: CORNER OF McKEE ROAD AND MAPLE GROVE DR.






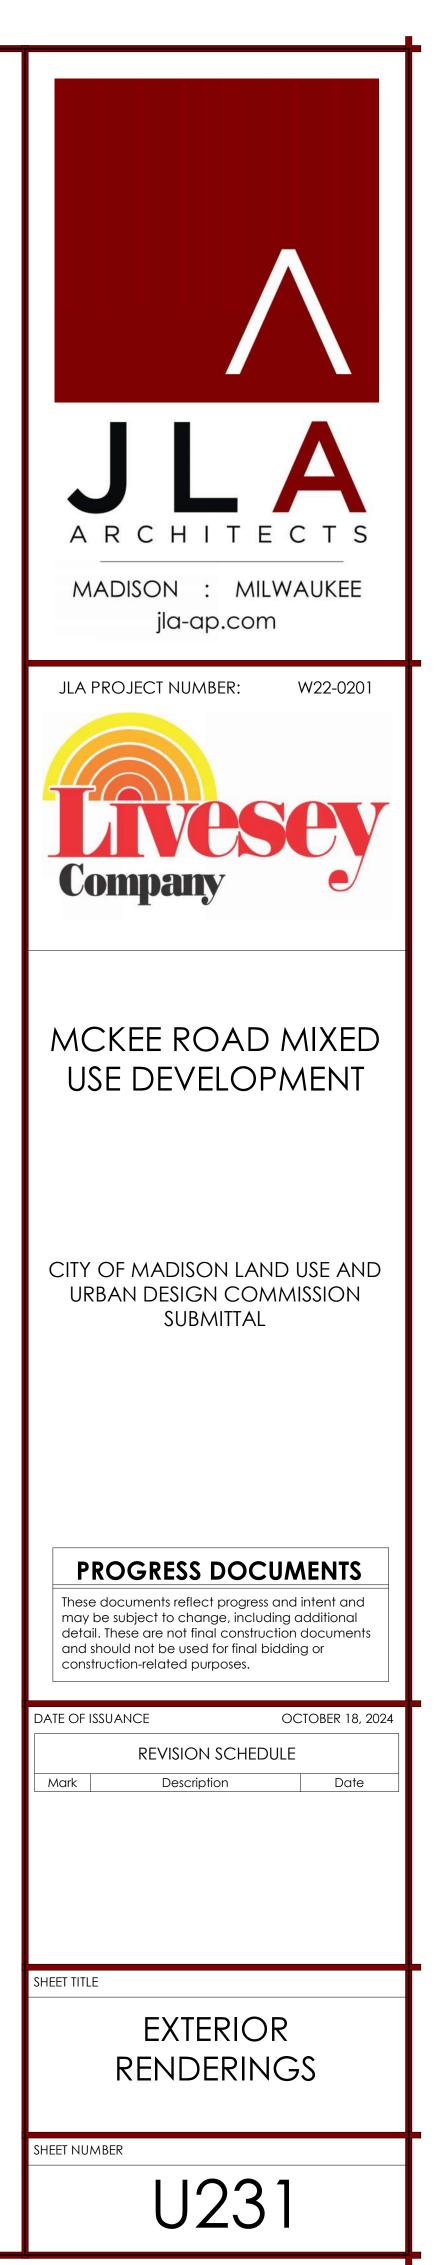PERSPECTIVE RENDERING: McKEE ROAD - CORNER OF BUILDING A2






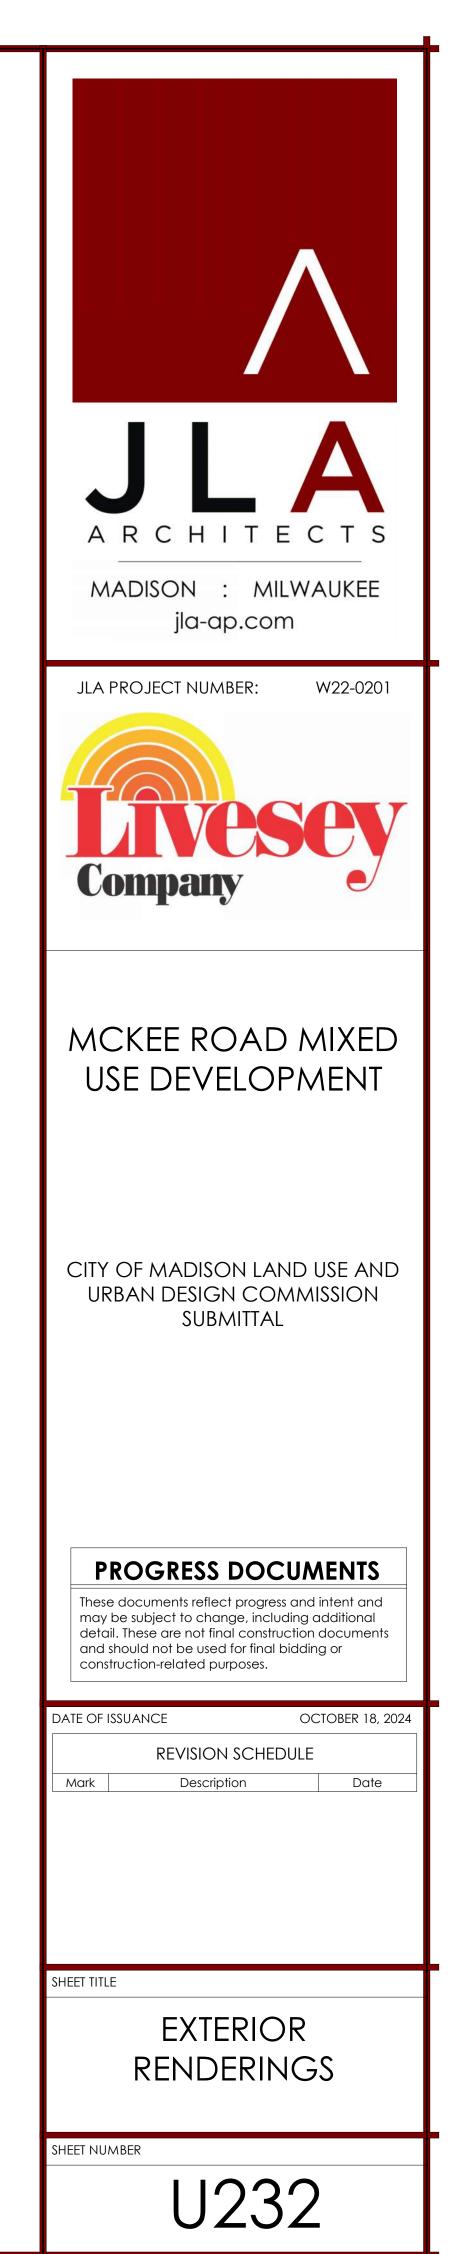PERSPECTIVE RENDERING: TERRACE AND POOL DECK FROM BACLONY






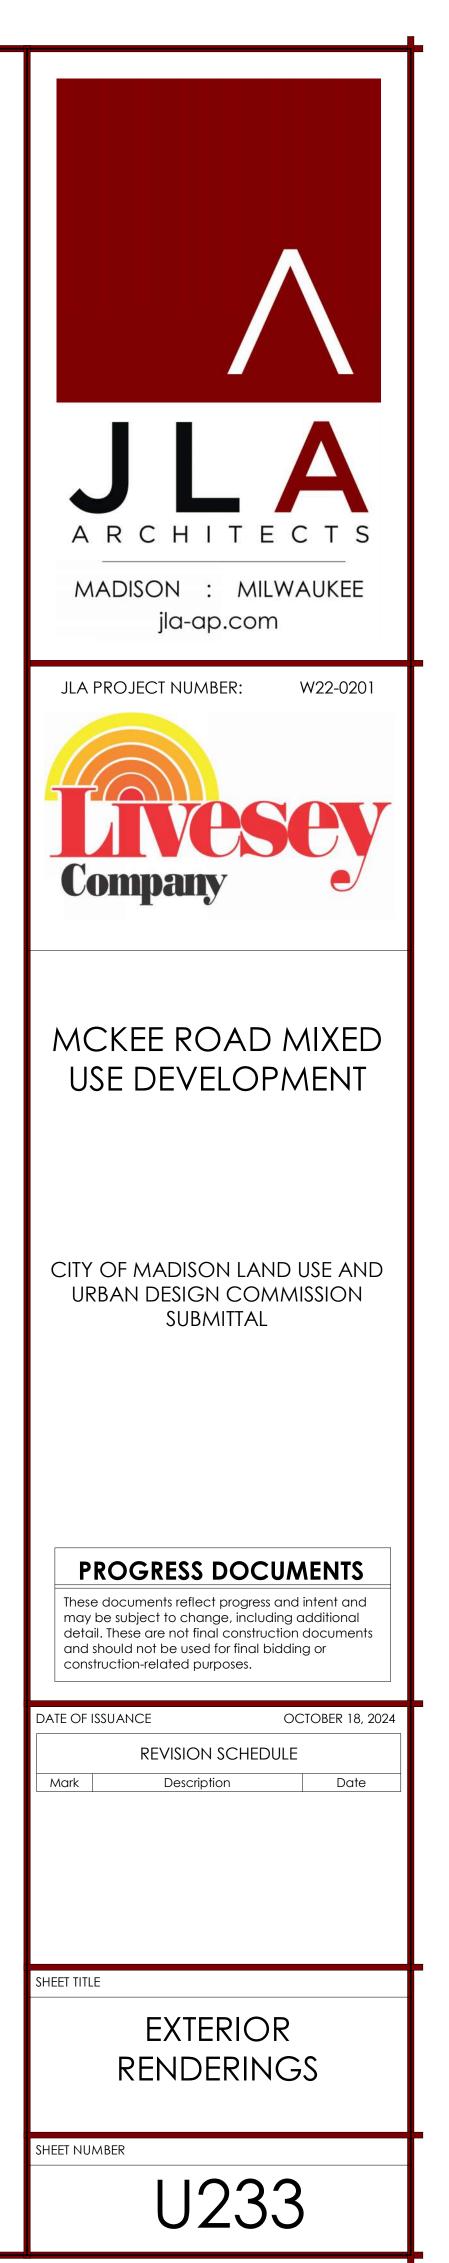PERSPECTIVE RENDERING: CORNER OF MAPLE GROVE DR. AND MADER DR. COMMERICAL FACADE





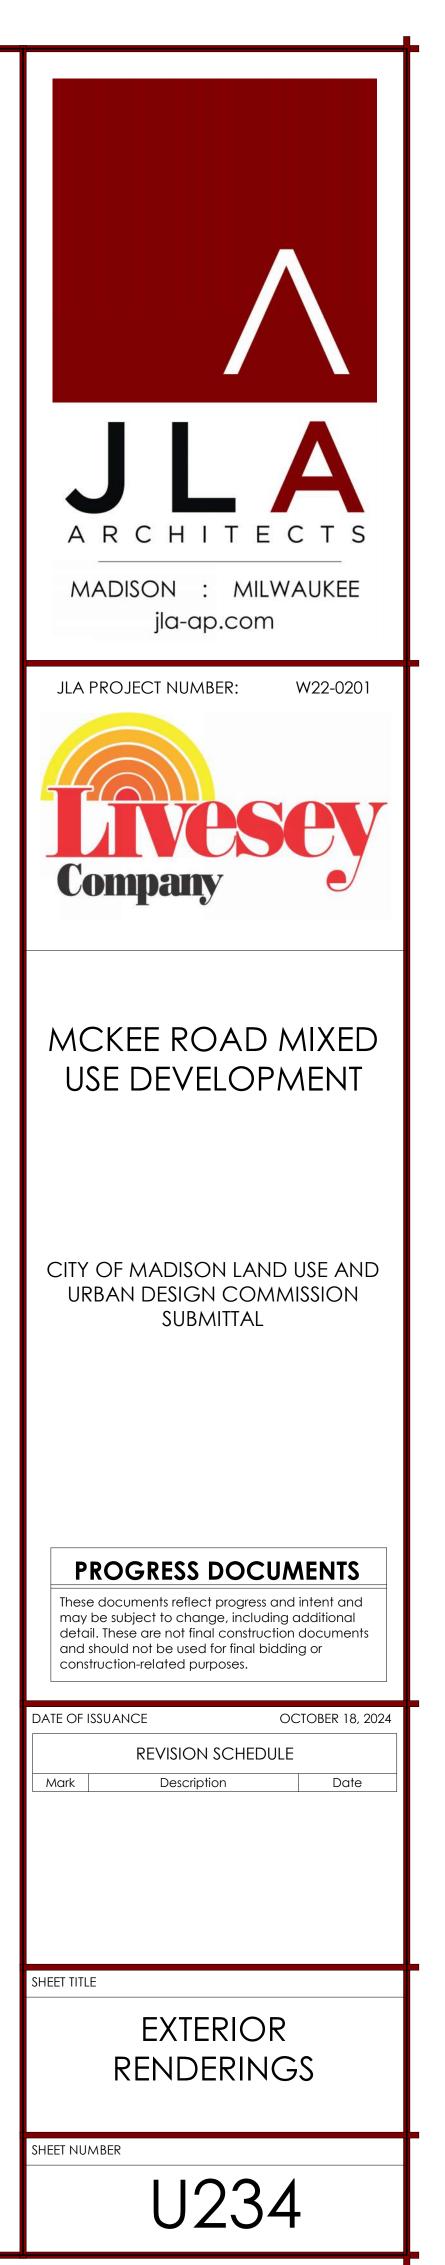PERSPECTIVE RENDERING: INTERNAL PARKING LOT AND COMMERCIAL FACADE






PERSPECTIVE RENDERING: MAIN RESIDENTIAL ENTRY

| JLAA ARCHITECTS MADISON : MILWAUKEE jla-ap.com |
|---------------------------------------------------------------------------------------------------------------------------------------------------------------------------------------------------------------------------------------------------------------------------------|
| JLA PROJECT NUMBER: W22-0201 |
| MCKEE ROAD MIXED USE DEVELOPMENT |
| CITY OF MADISON LAND USE AND URBAN DESIGN COMMISSION SUBMITTAL |
| DROGRESS DOCUMENTS These documents reflect progress and intent and may be subject to change, including additional detail. These are not final construction documents and should not be used for final bidding or construction-related purposes. DATE OF ISSUANCE |
| REVISION SCHEDULE Mark Description Date |
| SHEET TITLE EXTERIOR RENDERINGS |
| SHEET NUMBER U235 |



RENDERING: PARTIAL ELEVATION OF PATIO AMENITY AND RESIDENTIAL STAIR ACCESS

| A R C H I T E C T S MADISON : MILWAUKEE jla-ap.com |
|-----------------------------------------------------------------------------------------------------------------------------------------------------------------------------------------------------------------------------------------------------------------------|
| JLA PROJECT NUMBER: W22-0201 |
| MCKEE ROAD MIXED USE DEVELOPMENT |
| CITY OF MADISON LAND USE AND URBAN DESIGN COMMISSION SUBMITTAL |
| PROGRESS DOCUMENTS These documents reflect progress and intent and may be subject to change, including additional detail. These are not final construction documents and should not be used for final bidding or construction-related purposes. |
| DATE OF ISSUANCE OCTOBER 18, 2024 REVISION SCHEDULE Mark Description |
| SHEET TITLE EXTERIOR RENDERINGS |
| sheet number U236 |

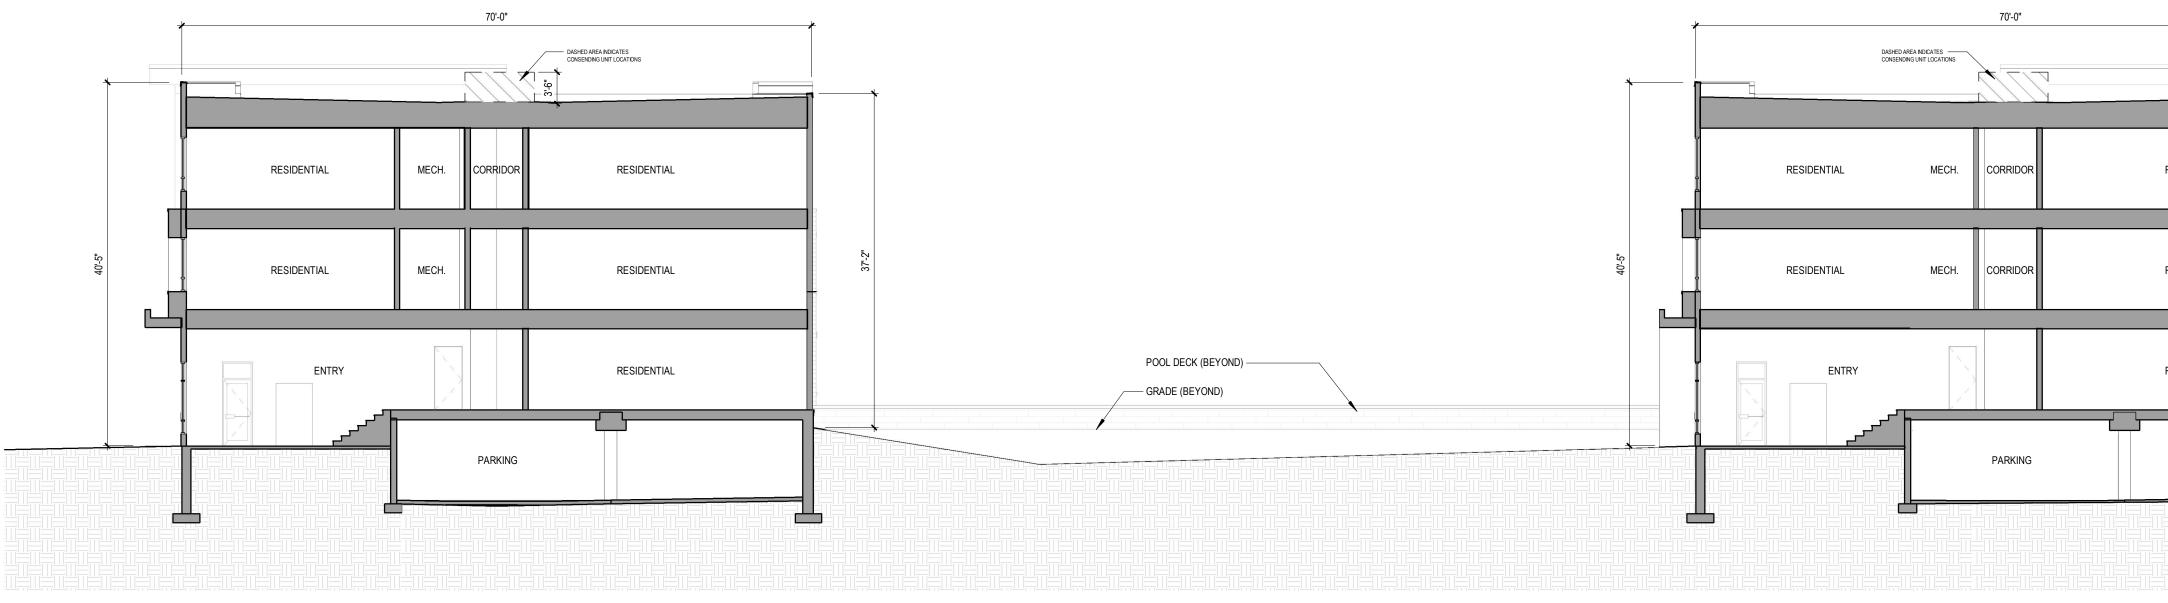







NOTES:

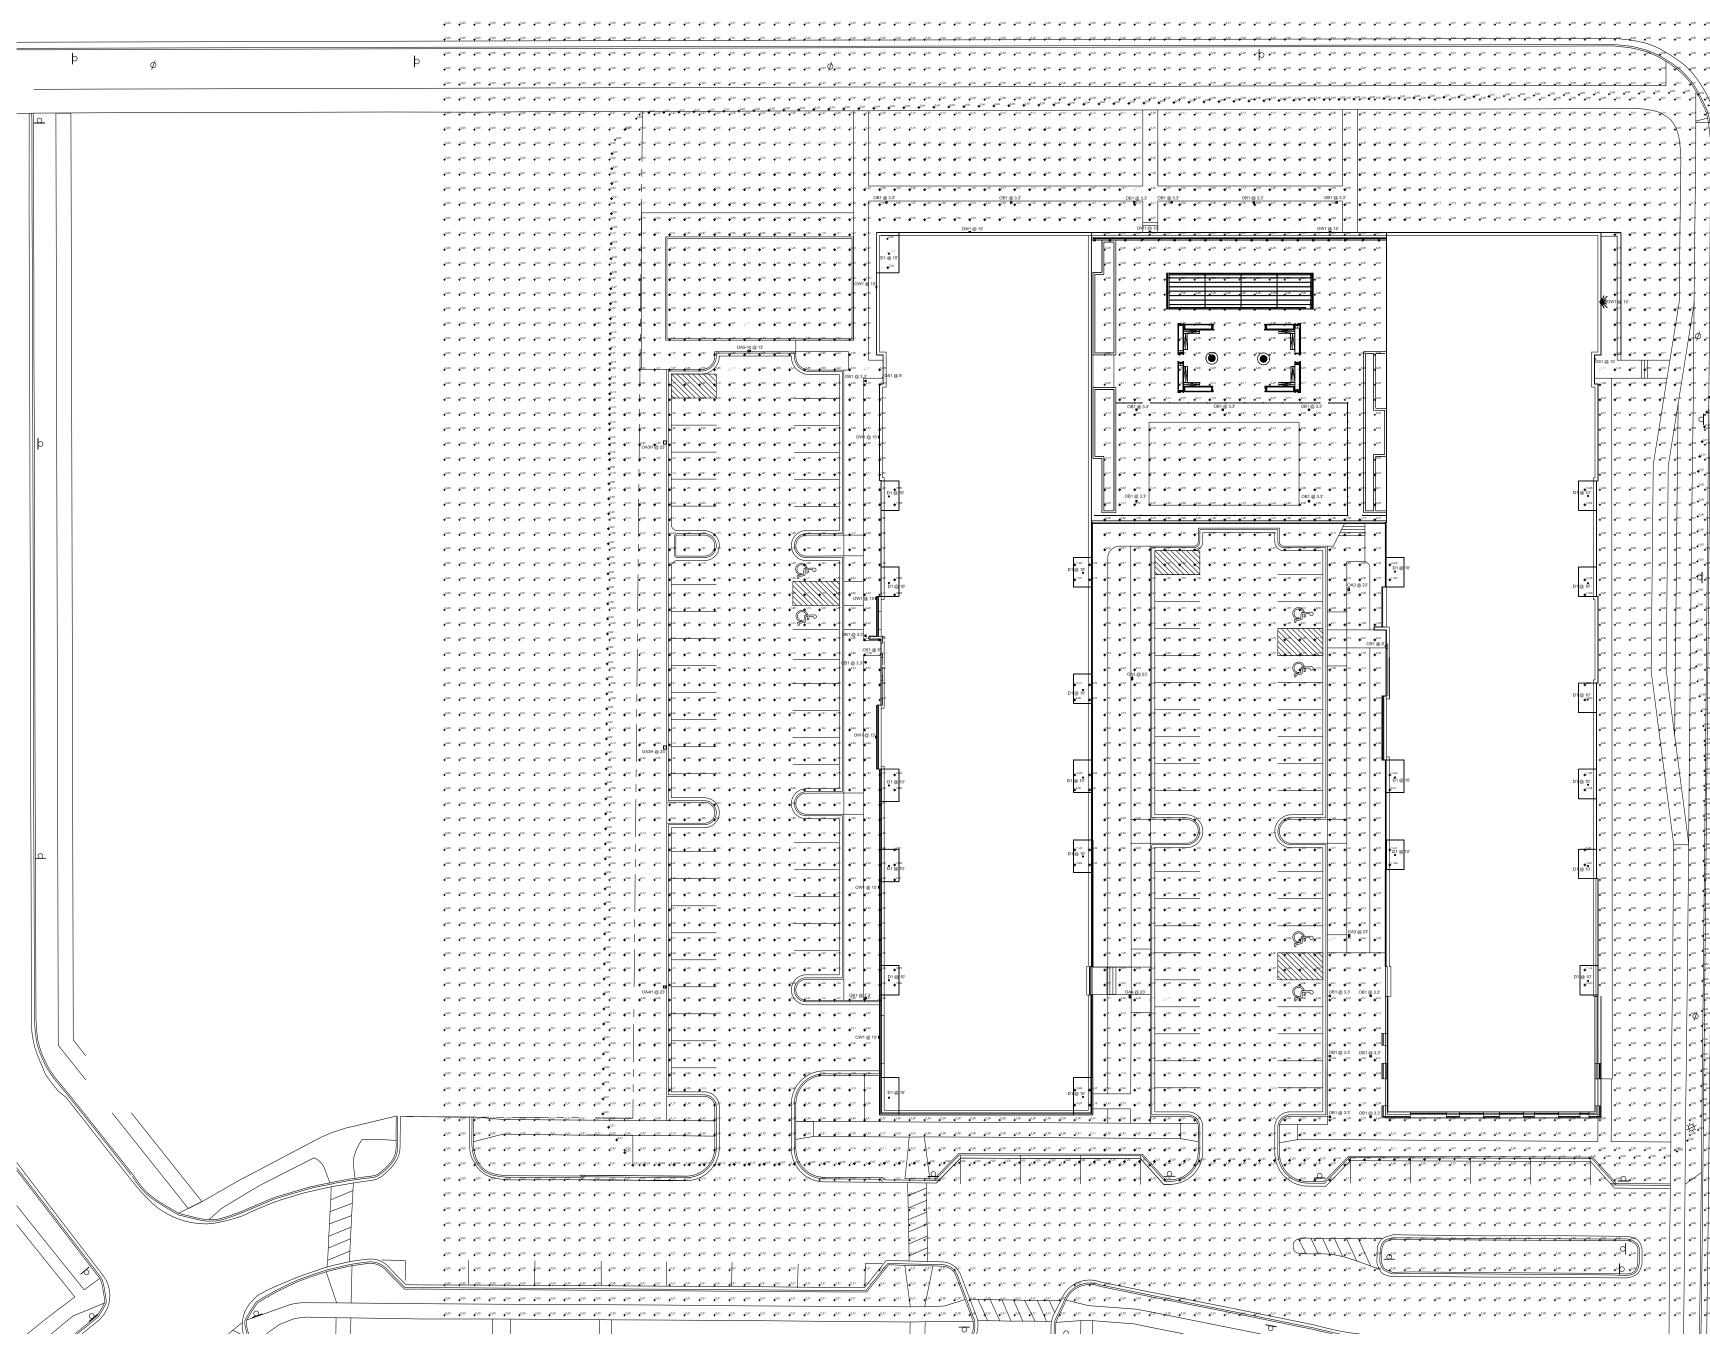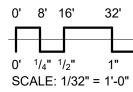- Customers are responsible for confirming mounting heights, fixture suspension types/ lengths, color temperature, CRI, linear fixture lengths, pole lengths, and bollard heights/ lengths prior to ordering.
- Mounting height (MH) is measured from the bottom of the fixture to the floor.
- This Lighting layout assumes the following unless values are specified and must be confirmed by the customer prior to ordering.
- Room reflectance of 80, 50, 20 for standard ceilings and 50, 50, 20 for exposed ceilings
- Wall sconces are mounted at 7' for calculation purposes. Customer must confirm desired •• mounting height before rough in.









| Statistics | ; | | | | | | | | |
|--------------------------------|-------------------------------------|-------------------|---------------------------------------|---------------|-----------------|----------------|---------|----------------|---------|
| Description | | | | Symbol | Avg | Max | Min | Max/Min | Avg/Min |
| Dog Run_A | t Grade | | | + | 2.16 fc | 4.16 fc | 0.57 fc | 7.3:1 | 3.8:1 |
| Lot 1 East S | Sidewalk | At Grade | | + | 2.36 fc | 6.27 fc | 1.00 fc | 6.3:1 | 2.4:1 |
| Lot 2 East S | Sidewalk | At Grade | | + | 1.90 fc | 3.43 fc | 0.64 fc | 5.4:1 | 3.0:1 |
| Lot 2 West | Sidewalk | _At Grade | + | 1.91 fc | 3.85 fc | 0.67 fc | 5.7:1 | 2.9:1 | |
| NE Patio_A | t Grade | | + | 2.17 fc | 5.46 fc | 0.61 fc | 9.0:1 | 3.6:1 | |
| North Sidev | valk_At G | Grade | | + | 1.64 fc | 3.72 fc | 0.62 fc | 6.0:1 | 2.6:1 |
| Parking Lot | 1_At Gra | ade | | + | 1.70 fc | 4.55 fc | 0.48 fc | 9.5:1 | 3.5:1 |
| Parking Lot | 2_At Gra | ade | | + | 1.74 fc | 3.53 fc | 0.84 fc | 4.2:1 | 2.1:1 |
| Typical Unc | ler Canop | oy_At Grade | | + | 9.36 fc | 13.86 fc | 6.29 fc | 2.2:1 | 1.5:1 |
| 10FT Past I Grade | ast Presumed Prop Line_At 4Ft Above | | | | 0.04 fc | 0.31 fc | 0.00 fc | N/A | N/A |
| Schedule | | | | | | | | | |
| Label QTY Manufacturer Catalog | | | | | | Lamp Output | LLF | Input Power | |
| D1 | 21 | Lithonia Lighting | LDN4 ALO2 (1000LM | 1) SWW1 AR LS | S 80CRI | 1353 | 0.9 | 12.57 | |
| OA3 | 3 | Lithonia Lighting | RSX1 LED P2 XXK R (ASSUMES 3FT BAS | | + 20FT SSS POLE | 9843 | 0.95 | 72.95 | |
| 0.4.01.1 | 2 | Lithonia Lighting | RSX1 LED P2 XXK R | 3 HS MVOLT X | XXX + 20FT SSS | 6909 | 0.95 | 72.95 | |

RSX1 LED P2 XXK R5 MVOLT XXXX + 10FT SSS POLE (ASSUMES 3FT BASE)

RSX1 LED P2 XXK R4 MVOLT XXXX + 20FT SSS POLE 9972 0.95 72.95

10106 0.95 72.95

881 0.95 6.8702

2913 0.95 24.42

10.72

OLE (ASSUMES 3FT BASE

FCB6C-4WN03-UNV-40-XXK-3L-XXX-LD

7070-08-PL-U07-WD-XXK

WPX1 LED P2 XXK MVOLT XXXX

Lithonia Lighting

Lithonia Lighting

Lithonia Lighting

Lithonia Lighting

BROWNLEE LIGHTING

FC Lighting

OA4

OS1

| | | L | С | W? | 1 | | 10 | L | ithon | ia Lig | hting | |
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| 0 | +0.0 | 0 | + ^{0.00} | + ^{0.00} | + ^{0.00} | +0.00 | + ^{0,00} | + ^{0.00} | + ^{0.00} | + ^{0.00} | +' +' | |
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| | •00 •00 | 8 | 0.00 ^{0.01} | ◆ ^{0.02} | + ^{0.02} | 0.01 | + ^{0,01} | +0.01 +0.01 | 0.00 | +0.00 +0.00 | +' +' | |
| | •0.0 | | \$0.0 0 .02 | ◆ ^{0.03} | + ^{0.02} | ● ^{0.01} | + ^{0.01} | ••• | ♠ ^{0,01} | + ^{0.00} | + | |
| I 1 | 0.1 | | 0.00 ^{0.02} | + ^{0.04} | + ^{0.63} | + ^{0.02} | + ^{0,01} | • | + ^{0,01} | + ^{0.01} | +' +' | |
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| | • ^{0.1} | 4 4 | 0.00 ^{0.03} | • ^{0.04} | + ^{0.03} | + ^{0.02} | + ^{0,01} + ^{0,01} | | + ^{0.01} | + ^{0.00} | +' +' | |
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| | •••• | 0 | ••• ⁶ *** | + ^{0.05} | + ^{0.03} | ◆ ^{0.02} | + ^{0.01} + ^{0.01} | 0.01 | + ^{0.00} | •°** | +' +' | |
| | • | | 989 985 | • ^{0.05} | •0.03 | 0.02 | + ^{0,01} | • | + ^{0.01} | +0.00 +0.00 | * ^c | |
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| 8 | + ^{cc} | 9,04 | + ^{0.07} | • ^{сли} | + ^{0.03} | + ^{0.02} | + ^{0,01} | + ^{0,01} | here c | ۲۰۰۲ ۵۰۰ور | + + | |
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| ю ю 4 | | 0 | + ⁰⁰⁰ | + ^{0.00} | + ^{0.00} | + ^{0.00} | +000 +000 | • | +0.00 | +0.00 \ | ľ | |
| | | 0 | • ^{0.00} | + ^{0.00} | + ^{0.00} | + ^{0.00} | + ^{0.00} | ff | + ^{0.00} | •°°°° | + | |
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ARCHITECTS MADISON : MILWAUKEE jla-ap.com JLA PROJECT NUMBER: W22-0201 Company MCKEE ROAD MIXED USE DEVELOPMENT CITY OF MADISON LAND USE AND URBAN DESIGN COMMISSION SUBMITTAL **PROGRESS DOCUMENTS** These documents reflect progress and intent and may be subject to change, including additional detail. These are not final construction documents and should not be used for final bidding or construction-related purposes. DATE OF ISSUANCE OCTOBER 18, 2024 **REVISION SCHEDULE** Date Description Mark SHEET TITLE SITE PHOTOMETRICS

Sheet NUMBER

U400



CITY OF MADISON LANDSCAPE WORKSHEET

Section 28.142 Madison General Ordinance

| Project Location / | Address | 6701 McKee Rd./ 6702 Ma | ader Dr. | |
|--------------------|-----------|-------------------------|---------------|--------------------|
| Name of Project | McKee Rc | Mixed Use Development | | |
| Owner / Contact | Livesey C | ompany | | |
| Contact Phone | 608-833-2 | 929 | Contact Email | jake@liveseyco.com |

** Landscape plans for zoning lots greater than ten thousand (10,000) square feet in size MUST be prepared by a registered landscape architect. **

Applicability

The following standards apply to all exterior construction and development activity, including the expansion of existing buildings, structures and parking lots, except the construction of detached single-family and two-family dwellings and their accessory structures. The entire development site must be brought up to compliance with this section unless **all** of the following conditions apply, in which case only the affected areas need to be brought up to compliance:

- (a) The area of site disturbance is less than ten percent (10%) of the entire development site during any ten-(10) year period.
- (b) Gross floor area is only increased by ten percent (10%) during any ten-(10) year period.
- (c) No demolition of a principal building is involved.
- (d) Any displaced landscaping elements must be replaced on the site and shown on a revised landscaping plan.

Landscape Calculations and Distribution

Required landscaped areas shall be calculated based upon the total developed area of the property. Developed area is defined as that area within a single contiguous boundary which is made up of structures, parking, driveways and docking/loading facilities, but excluding the area of any building footprint at grade, land designated for open space uses such as athletic fields, and undeveloped land area on the same zoning lot. There are three methods for calculating landscape points depending on the size of the lot and Zoning District.

(a) For all lots except those described in (b) and (c) below, five (5) landscape points shall be provided for each three hundred (300) square feet of developed area.

Total square footage of developed area _____59,723

Total landscape points required _____995

(b) For lots larger than five (5) acres, points shall be provided at five (5) points per three hundred (300) square feet for the first five (5) developed acres, and one (1) point per one hundred (100) square feet for all additional acres.

Total square footage of developed area _____

Five (5) acres = $\underline{217,800}$ square feet

First five (5) developed acres = 3,630 points

Remainder of developed area _____

Total landscape points required _____

(c) For the Industrial – Limited (IL) and Industrial – General (IG) districts, one (1) point shall be provided per one hundred (100) square feet of developed area.

Total square footage of developed area _____

Total landscape points required _____

Tabulation of Points and Credits

Use the table to indicate the quantity and points for all existing and proposed landscape elements.

| Diout Truce/ Element | Minimum Size at | Dointa | | Existing caping | | roposed caping |
|-------------------------------------------------------------------------|-------------------------------------------------------------------------------------------------------------------------------------------------------------------------------------|----------------------------------------------------------------------|----------|--------------------|----------|--------------------|
| Plant Type/ Element | Installation | Points | Quantity | Points Achieved | Quantity | Points Achieved |
| Overstory deciduous tree | 2 ¹ / ₂ inch caliper measured diameter at breast height (dbh) | 35 | | | 19 | 665 |
| Tall evergreen tree (i.e. pine, spruce) | 5-6 feet tall | 35 | | | 0 | 0 |
| Ornamental tree | 1 1/2 inch caliper | 15 | | | 14 | 210 |
| Upright evergreen shrub (i.e. arborvitae) | 3-4 feet tall | 10 | | | 51 | 510 |
| Shrub, deciduous | #3 gallon container size, Min. 12"-24" | 3 | | | 95 | 285 |
| Shrub, evergreen | #3 gallon container size, Min. 12"-24" | 4 | | | 8 | 32 |
| Ornamental grasses/ perennials | #1 gallon container size, Min. 8"-18" | 2 | | | 337 | 674 |
| Ornamental/ decorative fencing or wall | n/a | 4 per 10 lineal ft. | | | | |
| Existing significant specimen tree | Minimum size: 2 ¹ / ₂ inch caliper dbh. *Trees must be within developed area and cannot comprise more than 30% of total required points. | 14 per caliper inch dbh. Maximum points per tree: 200 | | | | |
| Landscape furniture for public seating and/or transit connections | * Furniture must be within developed area, publically accessible, and cannot comprise more than 5% of total required points. | 5 points per "seat" | | | | |
| Sub Totals | | | | | | 2376 |

Total Number of Points Provided ______

* As determined by ANSI, ANLA- American standards for nursery stock. For each size, minimum plant sizes shall conform to the specifications as stated in the current American Standard for Nursery Stock.

Landscaping shall be distributed throughout the property along street frontages, within parking lot interiors, as foundation plantings, or as general site landscaping. The total number of landscape points provided shall be distributed on the property as follows.

Total Developed Area

Required landscaped areas shall be calculated based upon the total developed area of the property. Developed area is defined as that area within a single contiguous boundary which is made up of structures, parking, driveways and docking/loading facilities, but excluding the area of any building footprint at grade, land designated for open space uses such as athletic fields, and undeveloped land area on the same zoning lot.

Development Frontage Landscaping

Landscaping and/or ornamental fencing shall be provided between buildings or parking areas and the adjacent street(s), except where buildings are placed at the sidewalk. Landscape material shall include a mix of plant materials.

Interior Parking Lot Landscaping

The purpose of interior parking lot landscaping is to improve the appearance of parking lots, provide shade, and improve stormwater infiltration. All parking lots with twenty (20) or more parking spaces shall be landscaped in accordance with the interior parking lot standards.

Foundation Plantings

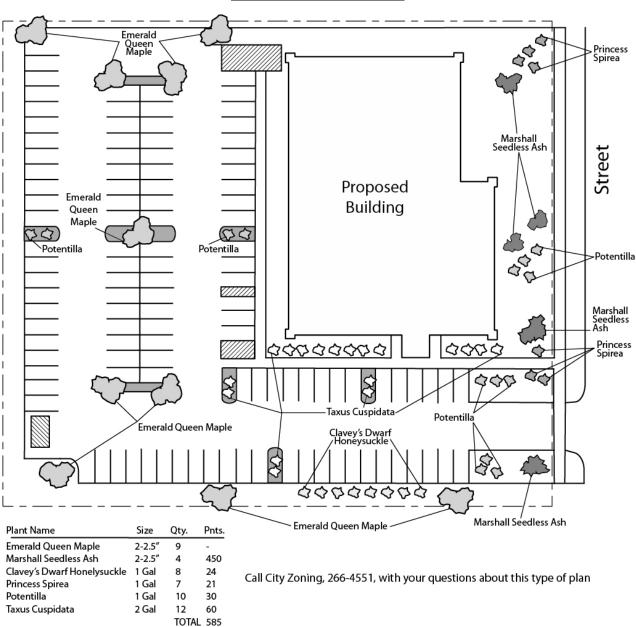
Foundation plantings shall be installed along building facades, except where building facades directly abut the sidewalk, plaza, or other hardscape features. Foundation plantings shall consist primarily of shrubs, perennials, and native grasses.

Screening Along District Boundaries

Screening shall be provided along side and rear property boundaries between commercial, mixed use or industrial districts and residential districts.

Screening of Other Site Elements

The following site elements shall be screened in compatibility with the design elements, materials and colors used elsewhere on the site: refuse disposal areas, outdoor storage areas, loading areas, and mechanical equipment.



Example Landscape Plan

LANDSCAPE PLAN AND LANDSCAPE WORKSHEET INSTRUCTIONS

Refer to Zoning Code Section 28.142 LANDSCAPING AND SCREENING REQUIREMENTS for the complete requirements for preparing and submitting a Landscape Plan and Landscape Worksheet.

Applicability.

The following standards apply to all exterior construction and development activity, including the expansion of existing buildings, structures and parking lots, except the construction of detached single-family and two-family dwellings and their accessory structures. The entire development site must be brought up to compliance with this section unless all of the following conditions apply, in which case only the affected areas need to be brought up to compliance:

- (a) The area of site disturbance is less than ten percent (10%) of the entire development site during any ten-(10) year period.
- (b) Gross floor area is only increased by ten percent (10%) during any ten-(10) year period.
- (c) No demolition of a principal building is involved.
- (d) Any displaced landscaping elements must be replaced on the site and shown on a revised landscaping plan.

Landscape Plan and Design Standards.

Landscape plans shall be submitted as a component of a site plan, where required, or as a component of applications for other actions, including zoning permits, where applicable. Landscape plans for zoning lots greater than ten thousand (10,000) square feet in size must be prepared by a registered landscape architect.

- (a) Elements of the landscape plan shall include the following:
 - 1. Plant list including common and Latin names, size and root condition (i.e. container or ball & burlap).
 - 2. Site amenities, including bike racks, benches, trash receptacles, etc.
 - 3. Storage areas including trash and loading.
 - 4. Lighting (landscape, pedestrian or parking area).
 - 5. Irrigation.
 - 6. Hard surface materials.
 - 7. Labeling of mulching, edging and curbing.
 - 8. Areas of seeding or sodding.
 - 9. Areas to remain undisturbed and limits of land disturbance.
 - 10. Plants shall be depicted at their size at sixty percent (60%) of growth.
 - 11. Existing trees eight (8) inches or more in diameter.
 - 12. Site grading plan, including stormwater management, if applicable.
- (b) Plant Selection. Plant materials provided in conformance with the provisions of this section shall be nursery quality and tolerant of individual site microclimates.
- (c) Mulch shall consist of shredded bark, chipped wood or other organic material installed at a minimum depth of two (2) inches.

Landscape Calculations and Distribution.

Required landscaped areas shall be calculated based upon the total developed area of the property. Developed area, for the purpose of this requirement, is defined as that area within a single contiguous boundary which is made up of structures, parking driveways and docking/loading facilities, but **excluding** the area of any building footprint at grade, land designated for open space uses such as athletic fields, and undeveloped land area on the same zoning lot.

- (a) Landscaping shall be distributed throughout the property along street frontages, within parking lot interiors, and as foundation plantings, or as general site landscaping.
- (b) Planting beds or planted areas must have at least seventy-five percent (75%) vegetative cover.
- (c) Canopy tree diversity requirements for new trees:
 - 1. If the development site has fewer than 5 canopy trees, no tree diversity is required.
 - 2. If the development site has between 5 and 50 canopy trees, no single species may comprise more than 33% of trees.
 - 3. If the development site has more than 50 canopy trees, no single species may comprise more than 20% of trees.

Development Frontage Landscaping.

Landscaping and/or ornamental fencing shall be provided between buildings or parking areas and the adjacent street(s), except where buildings are placed at the sidewalk. Landscape material shall include a mix of plant material meeting the following minimum requirements:

- (a) One (1) overstory deciduous tree and five (5) shrubs shall be planted for each thirty (30) lineal feet of lot frontage. Two (2) ornamental trees or two (2) evergreen trees may be used in place of one (1) overstory deciduous tree.
- (b) In cases where building facades directly abut the sidewalk, required frontage landscaping shall be deducted from the required point total.
- (c) In cases where development frontage landscaping cannot be provided due to site constraints, the zoning administrator may waive the requirement or substitute alternative screening methods for the required landscaping.
- (d) Fencing shall be a minimum of three (3) feet in height, and shall be constructed of metal, masonry, stone or equivalent material. Chain link or temporary fencing is prohibited.

Interior Parking Lot Landscaping.

The purpose of interior parking lot landscaping is to improve the appearance of parking lots, provide shade, and improve stormwater infiltration. All parking lots with twenty (20) or more parking spaces shall be landscaped in accordance with the following interior parking lot standards.

- (a) For new development on sites previously undeveloped or where all improvements have been removed, a minimum of eight percent (8%) of the asphalt or concrete area of the parking lot shall be devoted to interior planting islands, peninsulas, or landscaped strips. For changes to a developed site, a minimum of five percent (5%) of the asphalt or concrete area shall be interior planting islands, peninsulas, or landscaped strips. A planting island shall be located at least every twelve (12) contiguous stalls with no break or alternatively, landscaped strips at least seven (7) feet wide between parking bays.
- (b) The primary plant materials shall be shade trees with at least one (1) deciduous canopy tree for every one hundred sixty (160) square feet of required landscaped area. Two (2) ornamental deciduous trees may be substituted for one (1) canopy tree, but ornamental trees shall constitute no more than twenty-five percent (25%) of the required trees. No light poles shall be located within the area of sixty percent (60%) of mature growth from the center of any tree.
- (c) Islands may be curbed or may be designed as uncurbed bio-retention areas as part of an approved low impact stormwater management design approved by the Director of Public Works. The ability to maintain these areas over time must be demonstrated. (See Chapter 37, Madison General Ordinances, Erosion and Stormwater Runoff Control.)

Foundation Plantings.

Foundation plantings shall be installed along building facades, except where building facades directly abut the sidewalk, plaza, or other hardscape features. Foundation plantings shall consist primarily of shrubs, perennials, and native grasses. The Zoning Administrator may modify this requirement for development existing prior to the effective date of this ordinance, as long as improvements achieve an equivalent or greater level of landscaping for the site.

Screening Along District Boundaries.

Screening shall be provided along side and rear property boundaries between commercial, mixed use or industrial districts and residential districts. Screening shall consist of a solid wall, solid fence, or hedge with year-round foliage, between six (6) and eight (8) feet in height, except that within the front yard setback area, screening shall not exceed four (4) feet in height. Height of screening shall be measured from natural or approved grade. Berms and retaining walls shall not be used to increase grade relative to screening height.

Screening of Other Site Elements.

The following site elements shall be screened in compatibility with the design elements, materials and colors used elsewhere on the site, as follows:

- (a) <u>Refuse Disposal Areas.</u> All developments, except single family and two family developments, shall provide a refuse disposal area. Such area shall be screened on four (4) sides (including a gate for access) by a solid, commercial-grade wood fence, wall, or equivalent material with a minimum height of six (6) feet and not greater than seven (7) feet.
- (b) <u>Outdoor Storage Areas.</u> Outdoor storage areas shall be screened from abutting residential uses with a by a building wall or solid, commercial-grade wood fence, wall, year-round hedge, or equivalent material, with a minimum height of six (6) feet and not greater than seven (7) feet. Screening along district boundaries, where present, may provide all or part of the required screening.
- (c) <u>Loading Areas.</u> Loading areas shall be screened from abutting residential uses and from street view to the extent feasible by a building wall or solid, commercial-grade wood fence, or equivalent material, with a minimum height of six (6) feet and not greater than seven (7) feet. Screening along district boundaries, where present, may provide all or part of the required screening.
- (d) <u>Mechanical Equipment.</u> All rooftop and ground level mechanical equipment and utilities shall be fully screened from view from any street or residential district, as viewed from six (6) feet above ground level. Screening may consist of a building wall or fence and/or landscaping as approved by the Zoning Administrator.

Maintenance.

The owner of the premises is responsible for the watering, maintenance, repair and replacement of all landscaping, fences, and other landscape architectural features on the site. All planting beds shall be kept weed free. Plant material that has died shall be replaced no later than the upcoming June 1.


October 7, 2024

Prepared by: Sal Impellitteri

Building A1

| AVERAGE EXTERIOR WA | LL ELEVATIONS | | | | | | | | | | | | | | | |
|---------------------|----------------------------------------------------------|-------------|------------|----------|--------|-----------------------------|-------------|------------|----------|--------------------|----------------|--------------------|-----------|--------------|-----------|-----------|
| Exterior Wall | Exterior Wall Overall Length Uniformly Sloping Grade (1) | | | | | Uniformly Sloping Grade (2) | | | | Constant Grade (1) | | Constant Grade (2) | | Average Wall | | |
| Exterior wai | (in Feet) | Length (ft) | EL (start) | EL (end) | Slope | Avg. Elevation | Length (ft) | EL (start) | EL (end) | Slope | Avg. Elevation | Length (ft) | Elevation | Length (ft) | Elevation | Elevation |
| North | 169.3 | | | | | | | | | | | 169.3 | 99.5 | | | 99.5 |
| West | 295.0 | 5.5 | 100.0 | 97.1 | 52.73% | 98.6 | 143.5 | 97.1 | 91.5 | 3.90% | 94.3 | 95.5 | 100.0 | 50.5 | 91.5 | 95.7 |
| South | 169.3 | | | | | 0.0 | | | | | | 73.0 | 91.5 | 96.3 | 98.0 | 95.2 |
| East | 295.0 | 25.0 | 97.0 | 91.5 | 22.00% | 94.3 | 151.3 | 99.5 | 97.0 | 1.65% | 98.3 | 83.0 | 99.5 | 35.7 | 91.5 | 97.4 |

| | Overall Length | Avera | age Wall | Weighted Wall | |
|---------------------------------------------|------------------------------|-----------|----------------------|----------------------------------|--------------------------------------------------------------------------------------------|
| Exterior Wall | (L) | | on (AWE) | Elevation (L x AWE) | |
| North | 169.3 | | 99.5 | 16848.3 | |
| West | 295.0 | 9 | 95.7 | 28244.8 | |
| South | 169.3 | ç | 95.2 | 16116.9 | |
| East | 295.0 | ç | 97.4 | 28741.6 | |
| Totals | 928.6 | | | 89951.7 | |
| GRADE PLANE = GRADE PLANE = | Weighted Wall Ele 89951.7 | evation / | Wall Perime 928.6 | ter | |
| GRADE PLANE = | 96.9 | , | 528.0 | | |
| First Floor Elevation = | 100.0 | | Designed | First Floor Elevation | |
| Average Grade Plane = | 96.9 | | As determ | ined per 2015 IBC Chap | oter 2, figure 202(7) |
| | 3.1 | | First Floo | r distance above averga | e grade plane (feet) |
| Lower Level Floor Elevation = | 90.0 | | first floor | is <u>less</u> than 6 feet above | nent / Lower Level because e average grade plane, and nan 12' below the first floor. |
| Max. Bldg. Hgt. Allowed: | 70.0 | | Per 2015 | BC Table 504.3 | |
| Max. Roof Elevation: (Above Grade Plane) | 160.0 | | | | |

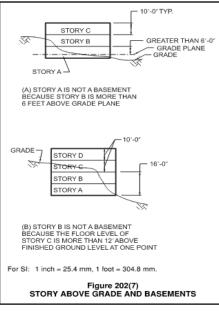


October 7, 2024

Prepared by: Sal Impellitteri

Building A2

| AVERAGE EXTER | RIOR WALL ELI | EVATIONS | | | | | | | | | | | | | | | |
|---------------|----------------------------------------------------------|-----------|-------------|------------|-----------------------------|--------|----------------|-------------|--------------------|----------|--------------------|----------------|--------------|-----------|-------------|-----------|-----------|
| Extorior | Exterior Wall Overall Length Uniformly Sloping Grade (1) | | | | Uniformly Sloping Grade (2) | | | | Constant Grade (1) | | Constant Grade (2) | | Average Wall | | | | |
| Exterior | vvali | (in Feet) | Length (ft) | EL (start) | EL (end) | Slope | Avg. Elevation | Length (ft) | EL (start) | EL (end) | Slope | Avg. Elevation | Length (ft) | Elevation | Length (ft) | Elevation | Elevation |
| North | | 72.0 | | | | | | | | | | | 72.0 | 99.5 | | | 99.5 |
| West | | 295.0 | 204.5 | 100.0 | 90.0 | 4.89% | 95.0 | | | | | | 50.5 | 100.0 | 40.0 | 90.0 | 95.2 |
| South | | 72.0 | | | | | | | | | | | 72.0 | 89.0 | | | 89.0 |
| East | | 295.0 | 24.5 | 94.5 | 90.0 | 18.37% | 92.3 | 128.5 | 100.0 | 94.5 | 4.28% | 97.3 | 92.0 | 100.0 | 50.0 | 90.0 | 96.5 |

| GRADE PLANE CALCULATION | | | | | |
|-------------------------------|-------------------|---------|---------------|----------------------------------|-------------------------------------------------------------------------------------------|
| Exterior Wall | Overall Length | Ave | erage Wall | Weighted Wall | |
| | (L) | Eleva | ation (AWE) | Elevation (L x AWE) | |
| North | 72.0 | | 99.5 | 7164.0 | |
| West | 295.0 | | 95.2 | 28077.5 | |
| South | 72.0 | | 89.0 | 6408.0 | |
| East | 295.0 | | 96.5 | 28456.8 | |
| Totals | 734.0 | | | 70106.3 | |
| | | | | | |
| GRADE PLANE = | Weighted Wall Ele | evation | / Wall Perime | ter | |
| GRADE PLANE = | 70106.3 | / | 734.0 | | |
| GRADE PLANE = | 95.5 | | | | |
| First Floor Elevation = | 100.0 | | Designed | First Floor Elevation | |
| Average Grade Plane = | 95.5 | | As detern | nined per 2015 IBC Chap | ter 2, figure 202(7) |
| | 4.5 | | First Floo | r distance above averga | e grade plane (feet) |
| Lower Level Floor Elevation = | 90.0 | | first floor | is <u>less</u> than 6 feet above | ent / Lower Level because e average grade plane, and nan 12' below the first floor. |
| | | | | IBC Table 504.3 | |

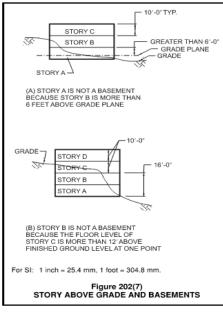

SLOPE SLIM

BROWNLEE





7070 LED -

Slope is a sleek and minimal lighting solution for both interior and exterior spaces. Crafted from stout aluminum, the series features a low-profile tapered form factor and is available in three sizes with various beam spreads. Perfect for architectural entrances, columns, facades, elevator lobbies, patios, and more. Less than 3" projection, ADA-compliant.

FINISHES





SLOPE SLIM

STANDARD SPECIFICATIONS

OUTER FRAME & MOUNT PLATE

Formed and welded aluminum. Closed cell foam gasket on rear mount plate.

OPTIC + DIFFUSER

High quality optic is regressed within fixture and offered in multiple distributions. Gasketed clear acrylic lens at bottom of housing - 1.875" aperture.

LED PERFORMANCE

120-277, Dimmable (0-10V), 90+ CRI, L80 rating > 60,000 hrs - L70 rating (projected) - 100,000 hrs Amperage rated @ 110V input Operating ambient temperature: -20°C / -4°F - 40°C / 104°F

Delivered 3500K lumens noted. Consult Brownlee.com for performance of all CCTs.

| ſ | CODE | WATTS | AMPS | NARROW | WIDE | FWD THROW |
|---|------|-------|------|------------|---------|-----------|
| | U07 | 7 | .06 | .06 925 lm | | 675 lm |
| | U11 | 11 | .10 | 1395 lm | 1325 lm | 1015 lm |

MOUNTING

Fixture mounts to a vertically positioned 2x4 switch box (by others).

Refer to Accessories section for optional cover plates.

Wet-listed in the downward orientation only (light source facing down). Must apply silicone to upper half of fixture when mounting outdoors. Indirect mounting acceptable in dry indoor locations only.

FINISH

Durable corrosion resistant powder coat finish. Custom colors available, contact factory.

WARRANTY

5 year limited warranty on this LED product. Consult factory for details.

ORDERING INFORMATION

| 7070 | | - | 6. 7. |
|---------------------------------------------------------------------------------------------------------------------------------------------------------------------------------------------------------------------------------------------|-------------------------------------------------------------------------------------------------------------------------------------------------------|-----------------------------------------------------------------------------------------------------------------------------------------------------------------------------|----------------------------------------------------------------------------------------------------------------------------------|
| 2. SIZE | 4. WATTAGE | 6. COLOR TEMPERATURE | 7. AVAILABLE OPTIONS |
| 08 L: 08" 16 L: 16" 24 L: 24" 3. FINISH | U07 7W U Series LED U11 11W U Series LED 5. DISTRIBUTION | 27K 2700K color temperature 30K 3000K color temperature 35K 3500K standard color temperature 40K 4000K color temperature | BABBuild America, Buy America CompliantBACBuy American CompliantDTR4Triac (Line Voltage) Dimming (120V)FCL7French Canadian Label |
| BL Black BZ Bronze MG Metallic Gold NT Nickel Tone WH White CUSTOM Additional finishes available as a modified option. Refer to Brownlee's Einishes. webpage for inspiration. | NWNarrow SpotWDWide AsymmetricFTForward ThrowRefer to last page of spec sheet for photometric diagrams. | | |
| 100068xx Cover Plate for 16" s | slim size - Specify Finish (xx) (Covers 4x4 jbo slim size - Specify Finish (xx) (Covers 4x4 jbo slim size - Specify Finish (xx) (Covers 4x4 jbo | (X(| |

DIMENSIONS

Standard Fixture

Cover Plate Accessory

L: 8", 16", 24", W: 2.75", D: 2.9"

L: 9.75", 17.75", 25.75", W: 4.5", D: 0.25"

3.25" from fixture bottom on all sizes.

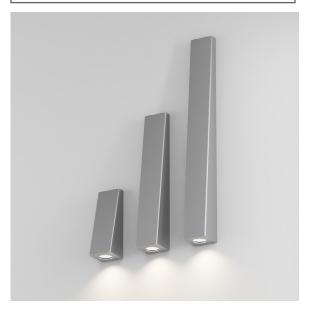
Denotes wiring pass-through located

Universal Footnotes (only applies if option is listed on spec sheet): (0) 90R - 90 CRI output-loss multiplier: 0.85 (estimate). Cannot be combined with ES. 1) BAC - cannot be combined with FCL. (2) BBI/BBS/BBC - cannot be combined with ECW or EXT. (3) BLD - includes integral microwave motion sensor (do not combine with OCC option). Cannot be combined with DTR. (4) DTR - cannot be combined with BLD. (5) ECW - cannot be combined with BBI, BBC, or DTR. (6) ES - cannot be combined with 90R or T24. (7) FCL - cannot be combined with BAC. 80 OCC - integral microwave motion sensor (ON/OFF). (9) T24 - includes JA8 labeling and 90 CRI LEDs (do not combine with 90R option). Cannot be combined with ES. (10) PCH/PC4 - cannot be combined with BLD or OCC. Add'I Notes: *BBI/BBC - BBI minimum operating temp: 10C/50F unless otherwise stated. BBC minimum operating temp: 20C/4F. **BLD - integral microwave motion sensor with step-dim control. 1: Motion is detected, illuminate to 100%. S: Motion no longer detected, dim to set level. 3: Remain in continuous dimmed state or turn off after set period. Configurable via onboard dip switches. Specifications and dimensions subject to change without notice.

Consult your Brownlee Lighting representative for availability and ordering information.

PROJECT: MODEL #:

FIXTURE TYPE:








REVISED 2024.07.7

POLAR PLOT LEGEND: BLUE: 0-180° Vertical | BLACK: 90-270° Vertical | RED: Horizontal Cone Through Max Candela

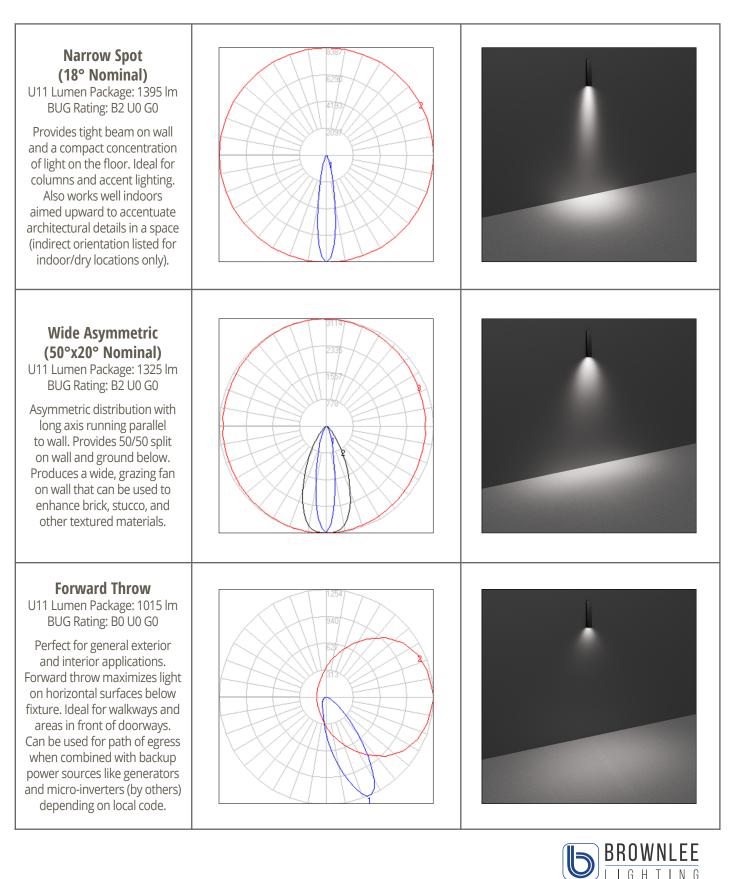

REVISED 2024.07.12

ww.brownlee.com



0.57 ft² (0.05 m²)

21.8" (55.4 cm)

13.3" (33.8 cm)

3.0" (7.6 cm) Main Body

7.2" (18.4 cm) Arm

22.0 lbs (10.0 kg)

(SPA mount)



L



Catalog Number Notes Type

Hit the Tab key or mouse over the page to see all interactive elements.

Introduction

The new RSX LED Area family delivers maximum value by providing significant energy savings, long life and outstanding photometric performance at an affordable price. The RSX1 delivers 7,000 to 17,000 lumens allowing it to replace 70W to 400W HID luminaires.

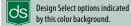
The RSX features an integral universal mounting mechanism that allows the luminaire to be mounted on most existing drill hole patterns. This "no-drill" solution provides significant labor savings. An easy-access door on the bottom of mounting arm allows for wiring without opening the electrical compartment. A mast arm adaptor, adjustable integral slipfitter and other mounting configurations are available.



Н

Items marked by a shaded background qualify for the Design Select program and ship in 15 days or less. To learn more about Design Select, visit <u>www.acuitybrands.com/designselect</u>. *See ordering tree for details

EXAMPLE: RSX1 LED P4 40K R3 MVOLT SPA DDBXD



Specifications

EPA

(ft²@0°):

Length:

Width:

Height:

Weight:

(SPA mount):

Ordering Information

RSX1 LED Performance Color Series Distribution Voltage Mounting Package Temperature RSX1 LED P1 R2 Type 2 Wide MVOLT (120V-277V)² SPA Square pole mounting (3.0" min. SQ pole for 1 at 90°, 3.5" min. SQ pole for 2, 3, 4 at 90°) 30K 3000K Round pole mounting (3.2" min. dia. RND pole for 2, 3, 4 at 90°, 3.0" min. dia. RND pole for 1 at 90°, 2 at 180°, 3 at 120°) P2 40K 4000K R3 Type 3 Wide HVOLT (347V-480V)³ RPA P3 50K R3S (277V-480V)⁴ 5000K Type 3 Short **XVOLT** Mast arm adaptor (fits 2-3/8" OD horizontal tenon) MA (use specific voltage for options as noted) P4 R4 Type 4 Wide Adjustable slipfitter (fits 2-3/8" OD tenon) 6 IS R4S Type 4 Short Wall bracket 1 120³ 277 5 WBA R5 Type 5 Wide 1 208³ 347 5 WBASC Wall bracket with surface conduit box R5S Type 5 Short ¹ 240³ AASP Adjustable tilt arm square pole mounting 6 480 5 AFR Automotive Front Row AARP Adjustable tilt arm round pole mounting 6 Automotive Front Row AFRR90 AAWB Adjustable tilt arm with wall bracket ⁶ Right Rotated Automotive Front Row Left Rotated AAWSC Adjustable tilt arm wall bracket and surface conduit box ⁶ AFRL90

| Options | | | | Finish | |
|------------|-------------------------------------------------------------|---------------|----------------------------------------------------------------------------------------|--------|---------------------------|
| Shipped In | istalled | Shipped Inst | talled | DDBXD | Dark Bronze |
| HS | House-side shield 7 | *Standalone | e and Networked Sensors/Controls (factory default settings, see table page 9) | DBLXD | Black |
| PE | Photocontrol, button style 8,9 | NLTAIR2 PIRHN | InLight AIR generation 2, with Networked, Bi-Level motion/ambient sensor 9, 12, 13, 14 | DNAXD | Natural Aluminum |
| PER7 | Seven-wire twist-lock receptacle only (no controls) 9,10,11 | BAA | Buy America(n) Act and/or Build America Buy America Qualified | DWHXD | White |
| SF | Single fuse (120, 277, 347) ⁵ | CCE | Coastal Construction ¹⁵ | DDBTXD | Textured Dark Bronze |
| DF | Double fuse (208, 240, 480) 5 | *Note: NLTAIF | R2 PIRHN with nLight Air can be used as a standalone or networked solution. Sensor | DBLBXD | Textured Black |
| SPD20KV | 20KV Surge pack (10KV standard) | coverage patt | tern is affected when luminaire is tilted. | DNATXD | Textured Natural Aluminum |
| FAO | Field adjustable output 9 | Shipped Sep | varately (requires some field assembly) | DWHGXD | Textured White |
| DMG | 0–10V dimming extend out back of housing for external | EGS | External glare shield 7 | | |
| | control (control ordered separate) 9 | | External glare full visor (360° around light aperture) 7 | | |
| | | BS | Bird spikes ¹⁶ | | |



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COMMERCIAL OUTDOOR

Lithonia RSX1 Area LED Rev. 07/22/24 Page 1 of 9

Ordering Information

Accessories

| RSX1HS RSX1 House side shield (includes 1 shield) RSX1HSAFRR U RSX1 House side shield for AFR rotated optics (in RSX1EGS (FINISH) U External glares hield (specify finish) RSXTEGFV (FINISH) U External glare full visor (specify finish) RSXPR (FINISH) U RSXUervesar round pole adaptor plate (specify RSXPRA (FINISH) U RSX WBA wall bracket (specify finish) * RSXSUBS (FINISH) U RSX Surface conduit box (specify finish, for use w DL1275 1-5 JU Photocell -SSL twist-lock (120-2777) * DL1430F 1-5 CULJ U Photocell -SSL twist-lock (480V) * DSHORT SBK U Shorting cap * | Oldel | eu and snippeu separately. |
|-----------------------------------------------------------------------------------------------------------------------------------------------------------------------------------------------------------------------------------------------------------------------------------------------------------------------------------------------------------------------------------------------------------------------------------------------------------------------------------------------------------------------------------------------------------------------------------------------------------------------------------------------------------------------------------------------------------------------------------------------------------|--------------------|--------------------------------------------------|
| RSX1EGS (FINISH) U External glares hield (specify finish) RSX1EGFV (FINISH) U External glare full visor (specify finish) RSXRPA (FINISH) U RSX Universal round pole adaptor plate (specify finish) RSXWBA (FINISH) U RSX WBA wall bracket (specify finish) ¹ RSXSCB (FINISH) U RSX WBA wall bracket (specify finish) ¹ RSXSCB (FINISH) U RSX Surface conduit box (specify finish, or use to DL127F 1.5 /U Photocell -SSL twist-lock (120-277V) ¹⁷ DL1347F 1.5 (ULJU Photocell -SSL twist-lock (347V) ¹⁷ DL1480F 1.5 (ULJU | SX1HS | RSX1 House side shield (includes 1 shield) |
| RSX1EGFV (FINISH) U External glare full visor (specify finish) RSXRPA (FINISH) U RSX Universal round pole adaptor plate (specify finish) RSXWBA (FINISH) U RSX WBA wall bracket (specify finish) ¹ RSXSCB (FINISH) U RSX Surface conduit box (specify finish) ¹ RSXSCB (FINISH) U RSX Surface conduit box (specify finish, for use v DL127F 1.5 JU Photocell -SSL twist-lock (120-277V) ¹⁷ DL1347F 1.5 CULJU Photocell -SSL twist-lock (347V) ¹⁷ DL1480F 1.5 CULJU Photocell -SSL twist-lock (480V) ¹⁷ | SX1HSAFRR U | RSX1 House side shield for AFR rotated optics (|
| RSXRPA (FINISH) U RSX Universal round pole adaptor plate (specify RSXWBA (FINISH) U RSX WBA wall bracket (specify finish) ¹ RSXS (FINISH) U RSX Surface conduit box (specify finish) ¹ RSX Surface conduit box (specify finish, for use v DL1127F 1.5 JU Photocell -SSL twist-lock (120-277V) ¹⁷ Photocell -SSL twist-lock (347V) ¹⁷ DL1434F 1.5 CUL JU Photocell -SSL twist-lock (347V) ¹⁷ Photocell -SSL twist-lock (347V) ¹⁷ | SX1EGS (FINISH) U | External glares hield (specify finish) |
| RSXWBA (FINISH) U RSX WBA wall bracket (specify finish) ¹ RSXSCB (FINISH) U RSX Surface conduit box (specify finish, for use v DLL127F 1.5 JU Photocell -SSL twist-lock (120-277V) ¹⁷ DLL347F 1.5 CUL JU Photocell -SSL twist-lock (347V) ¹⁷ DLL480F 1.5 CUL JU Photocell -SSL twist-lock (480V) ¹⁷ | SX1EGFV (FINISH) U | External glare full visor (specify finish) |
| RSXSCB (FINISH) U RSX Surface conduit box (specify finish, for use v DLI127F 1.5 JU Photocell -SSL twist-lock (120-277V) ¹⁷ DLI347F 1.5 CUL JU Photocell -SSL twist-lock (347V) ¹⁷ DLL480F 1.5 CUL JU Photocell -SSL twist-lock (480V) ¹⁷ | SXRPA (FINISH) U | RSX Universal round pole adaptor plate (specif |
| DL1127F 1.5 JU Photocell -SSL twist-lock (120-277V) ¹⁷ DL1347F 1.5 CUL JU Photocell -SSL twist-lock (347V) ¹⁷ DL1480F 1.5 CUL JU Photocell -SSL twist-lock (480V) ¹⁷ | SXWBA (FINISH) U | RSX WBA wall bracket (specify finish) 1 |
| DLL347F 1.5 CUL JU Photocell -SSL twist-lock (347V) ¹⁷ DLL480F 1.5 CUL JU Photocell -SSL twist-lock (480V) ¹⁷ | SXSCB (FINISH) U | RSX Surface conduit box (specify finish, for use |
| DLL480F 1.5 CUL JU Photocell -SSL twist-lock (480V) ¹⁷ | LL127F 1.5 JU | Photocell -SSL twist-lock (120-277V) 17 |
| | LL347F 1.5 CUL JU | Photocell -SSL twist-lock (347V) 17 |
| DSHORT SBK U Shorting cap 17 | LL480F 1.5 CUL JU | Photocell -SSL twist-lock (480V) 17 |
| | SHORT SBK U | Shorting cap 17 |

External Shields

NOTES

- Any Type 5 distribution, is not available with WBA.
- MVOLT driver operates on any line voltage from 120-277V (50/60 Hz). HVOLT driver operates on any line voltage from 347-480V (50/60 Hz).
- XVOLT driver not available with P1 or P2. XVOLT driver operates on any line voltage from 277V-480V (50/60 Hz). XVOLT not available with fusing 4
- (SF or DF) and not available with PE. Single fuse (SF) requires 120V, 277V or 347V. Double fuse (DF) requires 5 208V, 240V or 480V.
- 6 Maximum tilt is 90° above horizontal.
- It may be ordered as an accessory.
- Requires MVOLT or 347V. 8
- Two or more of the following options cannot be combined including PE, DMG, PER7, FAO and NLTAIR2 PIRHN. (Exception: PE and FAO can be 9 combined; also PE and DMG can be combined.)
- 10 Compatible with standard twist-lock photocells for dusk to dawn operation or advanced control nodes that provide 0-10V dimming

signals. Wire 4/Wire 5 wired to dimming leads on driver. Wire6/Wire7 capped inside luminaire. Twistlock photocell ordered and shipped as a separate line item from Acuity Brands Controls. See accessories. Shorting Cap included.

- For units with option PER7, the mounting must be restricted to +/- 45° from horizontal aim per ANSI C136.10-2010. 11
- 12 Must be ordered with PIRHN.
- Requires MVOLT or HVOLT. 13
- Must be ordered with NLTAIR2. For additional information on PIRHN 14 visit
- CCE option not available with WBA, WBASC, AASP, AARP, AAWB, 15 AAWBSC, EGS, EGFV and BS.
- 16 Must be ordered with fixture for factory pre-drilling. Requires luminaire to be specified with PER7 option. Ordered and 17 shipped as a separate line item from Acuity Brands Controls.



External Glare Shield

Round Tenon Mount - Pole Top Slipfitters RSY Mor

RPA AARP

RPA, AARP

RPA, AARP

Drill/Side Location by Configuration Type

nting Opt Head Location

Drill Nomenclature

Tilt

0°

Single

0.57

0.62

0.49

2 - 3/8

2 - 7/8'

4"

#8

RSX1 - Luminaire EPA

Fixture Quantity & Mounting Configuration

Mounting Type

SPA - Square Pole Adaptor

RPA - Round Pole Adaptor

MA - Mast Arm Adaptor

External 360 Full Visor

AS3-5 320

AST25-320

AST35-320

Round Pole Only

DM32AS

4 @ 90

2.03

2.13

1.87

bv Sid

1.31

1.36

1.23

AS3-5 390

AST25-390

AST35-390

3 @ 90

Side B C & D

DM39AS

by Side

1.7

1.8

1.54

1.7

2.03

2.62

3.73

5.43

6.33

694

8.14

8.27

8.27

8.18

2 at 90

AS3-5 290

AST25-290

AST35-290

Side B & C

DM29AS

1.36

1.46

1.2

AS3-5 280

AST25-280

AST35-280

2@180

Side B & D

DM28AS

*Includes luminaire and integral mounting arm. Other tenons, arms, brackets or other accessories are not included in this EPA data.

3 @ 90

1.52

1.62

1.36

2 @ 180

1.05

1.15

0.89

Pole/Mounting Informatiion

Accessories including bullhorns, cross arms and other adpaters are available under the accessories tab at Lithonia's Outdoor Poles and Arms product page. Click here to visit Accessories.

AS3-5 190

AST25-190

AST35-190

Single

Side B

DM19AS

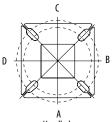
2 @ 90

1.03


1.08

0.95


HANDHOLE ORIENTATION



RSX POLE DRILLING

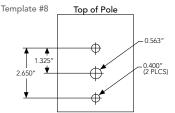

RSX STANDARD ARM & ADJUSTABLE ARM

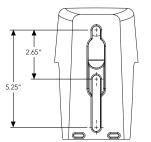

0° 0.57 1.03 1.05 1.52 1.36 2.03 1.31 10° 0.68 1.34 1.33 2 1.74 2.64 1.35 20° 0.87 1.71 1.73 2.56 2.26 3.42 1.75 30° 1.24 2.19 2.3 3.21 2.87 4.36 2.49 40° 1.81 2.68 2.98 3.85 3.68 5.30 3.62 IS - Integral Slipfitter AASP/AARP - Adjustable 45° 2.11 2.92 3.44 4.2 4.08 5.77 4.22 Arm Square/Round Pole 4 4 4 50° 2.31 3.17 3.72 4 52 6.26 4.62 60° 2.71 3.66 4.38 5.21 5.15 7.24 5.43 70° 2.78 3.98 4.54 5.67 5.47 7.91 5.52 80° 2.76 4.18 4.62 5.97 5.76 8.31 5.51 90° 2.73 4.25 4.64 6.11 5.91 8.47 5.45



4 at 90°

AS3-5490

AST25-490

AST35-490

4 @ 90

Side A B C & D

DM49AS

4 Side

by Side

2.26

2.36

2.1

2.26

2.71

3.49

4.97

7.24

8.44

925

10.86

11.03

11.03

10.97

COMMERCIAL OUTDOOR

Handhole

Isofootcandle plots for the RSX1 LED P4 40K. Distances are in units of mounting height (20').

1 2 3

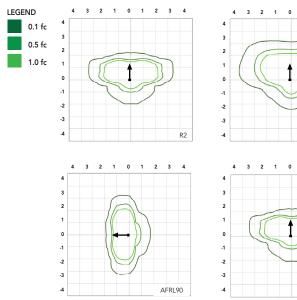
4

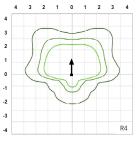
R3

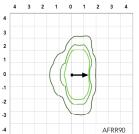
AFR

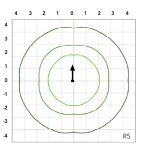
2 3 4

1









Performance Data

Lumen Ambient Temperature (LAT) Multipliers

Use these factors to determine relative lumen output for average ambient temperatures from 0-50°C (32-122°F).

| Ambient | Ambient | Lumen Multiplier |
|---------|---------|------------------|
| 0°C | 32°F | 1.05 |
| 5℃ | 41°F | 1.04 |
| 10°C | 50°F | 1.03 |
| 15℃ | 59°F | 1.02 |
| 20°C | 68°F | 1.01 |
| 25℃ | 77°F | 1.00 |
| 30°C | 86°F | 0.99 |
| 35℃ | 95°F | 0.98 |
| 40°C | 104°F | 0.97 |
| 45°C | 113°F | 0.96 |
| 50°C | 122°F | 0.95 |

Electrical Load

| | | Current (A) | | | | | | | | |
|---------------------|------------------|-------------|------|------|------|------|------|--|--|--|
| Performance Package | System Watts (W) | 120V | 208V | 240V | 277V | 347V | 480V | | | |
| P1 | 51W | 0.42 | 0.25 | 0.21 | 0.19 | 0.14 | 0.11 | | | |
| P2 | 72W | 0.60 | 0.35 | 0.30 | 0.26 | 0.21 | 0.15 | | | |
| P3 | 109W | 0.91 | 0.52 | 0.45 | 0.39 | 0.31 | 0.23 | | | |
| P4 | 133W | 1.11 | 0.64 | 0.55 | 0.48 | 0.38 | 0.27 | | | |

Projected LED Lumen Maintenance

| Operating Hours | 50,000 | 75,000 | 100,000 |
|--------------------------|--------|--------|---------|
| Lumen Maintenance Factor | >0.97 | >0.95 | >0.92 |

Values calculated according to IESNA TM-21-11 methodology and valid up to 40°C.



Lumen Output

Lumen values are from photometric tests performed in accordance with IESNA LM-79-08. Data is considered to be representative of the configurations shown, within the tolerances allowed by Lighting Facts. Contact factory for performance data on any configurations not shown here.

| Performance | System Watts | Distribution. | 30K (3000K, 70 CRI) | | | 40K (4000K, 70 CRI) | | | | 50K (5000K, 70 CRI) | | | | | | | |
|-------------|--------------|---------------|------------------------|---|---|------------------------|-----|--------|---|------------------------|---|-----|--------|---|---|---|-----|
| Package | | Туре | Lumens | В | U | G | LPW | Lumens | В | U | G | LPW | Lumens | В | U | G | LPW |
| | | R2 | 6,482 | 1 | 0 | 1 | 126 | 7,121 | 1 | 0 | 1 | 139 | 7,121 | 1 | 0 | 1 | 139 |
| | | R3 | 6,459 | 1 | 0 | 2 | 127 | 7,096 | 1 | 0 | 2 | 139 | 7,096 | 1 | 0 | 2 | 139 |
| | | R3S | 6,631 | 1 | 0 | 1 | 129 | 7,286 | 1 | 0 | 2 | 142 | 7,286 | 1 | 0 | 2 | 142 |
| | | R4 | 6,543 | 1 | 0 | 2 | 128 | 7,189 | 1 | 0 | 2 | 141 | 7,189 | 1 | 0 | 2 | 141 |
| P1 | 51W | R4S | 6,313 | 1 | 0 | 1 | 124 | 6,936 | 1 | 0 | 1 | 136 | 6,936 | 1 | 0 | 1 | 136 |
| F I | JIW | R5 | 6,631 | 3 | 0 | 2 | 130 | 7,286 | 3 | 0 | 2 | 143 | 7,286 | 3 | 0 | 2 | 143 |
| | | R5S | 6,807 | 3 | 0 | 1 | 133 | 7,479 | 3 | 0 | 1 | 147 | 7,479 | 3 | 0 | 1 | 147 |
| | | AFR | 6,473 | 1 | 0 | 1 | 127 | 7,112 | 1 | 0 | 1 | 139 | 7,112 | 1 | 0 | 1 | 139 |
| | | AFRR90 | 6,535 | 2 | 0 | 2 | 127 | 7,179 | 2 | 0 | 2 | 140 | 7,179 | 2 | 0 | 2 | 140 |
| | | AFRL90 | 6,562 | 2 | 0 | 1 | 128 | 7,210 | 2 | 0 | 2 | 140 | 7,210 | 2 | 0 | 2 | 140 |
| | | R2 | 8,991 | 2 | 0 | 1 | 123 | 9,878 | 2 | 0 | 1 | 135 | 9,878 | 2 | 0 | 1 | 135 |
| | | R3 | 8,959 | 2 | 0 | 2 | 124 | 9,843 | 2 | 0 | 2 | 137 | 9,843 | 2 | 0 | 2 | 137 |
| | | R3S | 9,198 | 2 | 0 | 2 | 126 | 10,106 | 2 | 0 | 2 | 139 | 10,106 | 2 | 0 | 2 | 139 |
| | | R4 | 9,077 | 2 | 0 | 2 | 126 | 9,972 | 2 | 0 | 2 | 139 | 9,972 | 2 | 0 | 2 | 139 |
| P2 | 72W | R4S | 8,757 | 1 | 0 | 2 | 122 | 9,622 | 2 | 0 | 2 | 134 | 9,622 | 2 | 0 | 2 | 134 |
| FZ | /200 | R5 | 9,198 | 4 | 0 | 2 | 128 | 10,106 | 4 | 0 | 2 | 140 | 10,106 | 4 | 0 | 2 | 140 |
| | | R5S | 9,443 | 3 | 0 | 1 | 131 | 10,374 | 3 | 0 | 1 | 144 | 10,374 | 3 | 0 | 1 | 144 |
| | | AFR | 8,979 | 2 | 0 | 1 | 125 | 9,865 | 2 | 0 | 1 | 137 | 9,865 | 2 | 0 | 1 | 137 |
| | | AFRR90 | 9,064 | 3 | 0 | 2 | 124 | 9,959 | 3 | 0 | 2 | 137 | 9,959 | 3 | 0 | 2 | 137 |
| | | AFRL90 | 9,102 | 3 | 0 | 2 | 125 | 10,001 | 3 | 0 | 2 | 137 | 10,001 | 3 | 0 | 2 | 137 |
| | | R2 | 12,808 | 2 | 0 | 1 | 117 | 14,072 | 2 | 0 | 2 | 129 | 14,072 | 2 | 0 | 2 | 129 |
| | | R3 | 12,763 | 2 | 0 | 2 | 117 | 14,023 | 2 | 0 | 2 | 129 | 14,023 | 2 | 0 | 2 | 129 |
| | | R3S | 13,104 | 2 | 0 | 2 | 120 | 14,397 | 2 | 0 | 2 | 132 | 14,397 | 2 | 0 | 2 | 132 |
| | | R4 | 12,930 | 2 | 0 | 2 | 119 | 14,206 | 2 | 0 | 2 | 130 | 14,206 | 2 | 0 | 2 | 130 |
| P3 | 109W | R4S | 12,475 | 2 | 0 | 2 | 114 | 13,707 | 2 | 0 | 2 | 126 | 13,707 | 2 | 0 | 2 | 126 |
| rs | 10900 | R5 | 13,104 | 4 | 0 | 2 | 120 | 14,397 | 4 | 0 | 2 | 132 | 14,397 | 4 | 0 | 2 | 132 |
| | | R5S | 13,452 | 3 | 0 | 2 | 123 | 14,779 | 3 | 0 | 2 | 136 | 14,779 | 3 | 0 | 2 | 136 |
| | | AFR | 12,791 | 2 | 0 | 1 | 117 | 14,053 | 2 | 0 | 2 | 129 | 14,053 | 2 | 0 | 2 | 129 |
| | | AFRR90 | 12,913 | 3 | 0 | 3 | 118 | 14,187 | 3 | 0 | 3 | 130 | 14,187 | 3 | 0 | 3 | 130 |
| | | AFRL90 | 12,967 | 3 | 0 | 2 | 118 | 14,247 | 3 | 0 | 3 | 130 | 14,247 | 3 | 0 | 3 | 130 |
| | | R2 | 14,943 | 2 | 0 | 2 | 112 | 16,417 | 2 | 0 | 2 | 123 | 16,417 | 2 | 0 | 2 | 123 |
| | | R3 | 14,890 | 2 | 0 | 3 | 112 | 16,360 | 2 | 0 | 3 | 123 | 16,360 | 2 | 0 | 3 | 123 |
| | | R3S | 15,287 | 2 | 0 | 2 | 115 | 16,796 | 2 | 0 | 2 | 126 | 16,796 | 2 | 0 | 2 | 126 |
| | | R4 | 15,085 | 2 | 0 | 3 | 113 | 16,574 | 2 | 0 | 3 | 125 | 16,574 | 2 | 0 | 3 | 125 |
| P4 | 133W | R4S | 14,554 | 2 | 0 | 2 | 109 | 15,991 | 2 | 0 | 2 | 120 | 15,991 | 2 | 0 | 2 | 120 |
| F* | WCCI | R5 | 15,287 | 4 | 0 | 2 | 115 | 16,796 | 4 | 0 | 2 | 126 | 16,796 | 4 | 0 | 2 | 126 |
| | | R5S | 15,693 | 4 | 0 | 2 | 118 | 17,242 | 4 | 0 | 2 | 130 | 17,242 | 4 | 0 | 2 | 130 |
| | | AFR | 14,923 | 2 | 0 | 2 | 112 | 16,395 | 2 | 0 | 2 | 123 | 16,395 | 2 | 0 | 2 | 123 |
| | | AFRR90 | 15,065 | 3 | 0 | 3 | 113 | 16,551 | 3 | 0 | 3 | 124 | 16,551 | 3 | 0 | 3 | 124 |
| | | AFRL90 | 15,128 | 3 | 0 | 3 | 114 | 16,621 | 3 | 0 | 3 | 125 | 16,621 | 3 | 0 | 3 | 125 |




Dimensions & Weights

Luminaire Weight by Mounting Type


| Mounting Configuration | Total Luminaire Weight |
|------------------------|------------------------|
| SPA | 22 lbs |
| RPA | 24 lbs |
| MA | 22 lbs |
| WBA | 25 lbs |
| WBASC | 28 lbs |
| IS | 25 lbs |
| AASP | 25 lbs |
| AARP | 27 lbs |
| AAWB | 28 lbs |
| AAWSC | 31 lbs |

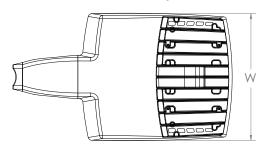RSX1 with Round Pole Adapter (RPA)




Length: 22.8" (57.9 cm) Width: 13.3" (33.8 cm) Height: 3.0" (7.6 cm) Main Body 7.2" (18.4 cm) Arm

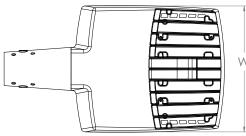RSX1 with Mast Arm Adapter (MA)




Length: 23.2" (59.1 cm) Width: 13.3" (33.8 cm) Height: 3.0" (7.6 cm) Main Body 3.5" (8.9 cm) Arm

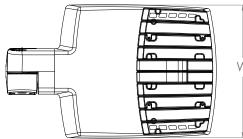RSX1 with Adjustable Slipfitter (I




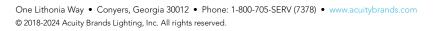Length: 20.7" (52.7 cm) Width: 13.3" (33.8 cm) Height: 3.0" (7.6 cm) Main Body 7.6" (19.3 cm) Arm





| 7/16" locking thru bolt/nut provided | |
|----------------------------------------------|--|
| 7/8" KO - fits 1/2" NPT water- tight fitting | |

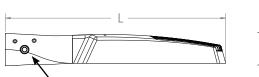

Note: RPA — Round Pole mount can also be used to mount on square poles by omitting

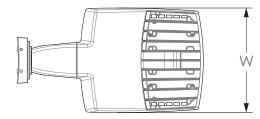
the round pole adapter plate shown here.



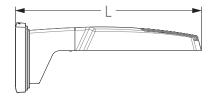
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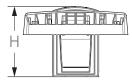
COMMERCIAL OUTDOOR

RSX1 with Wall Bracket (WBA)

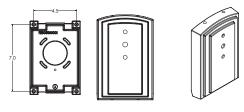


Length: 23.6" (59.9 cm) Width: 13.3" (33.8 cm) Height: 3.0" (7.6 cm) Main Body 8.9" (22.6 cm) Arm








Wall Bracket (WBA) Mounting Detail



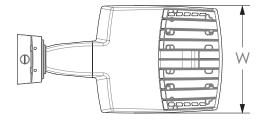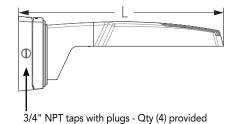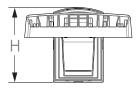RSX1 with Wall Bracket with Surface Conduit Box (WBASC)









Length: 25.3" (64.3 cm) Width: 13.3" (33.8 cm) Height: 3.0" (7.6 cm) Main Body 9.2" (23.4 cm) Arm

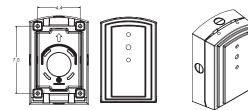Surface Conduit Box (SCB) Mounting Detail





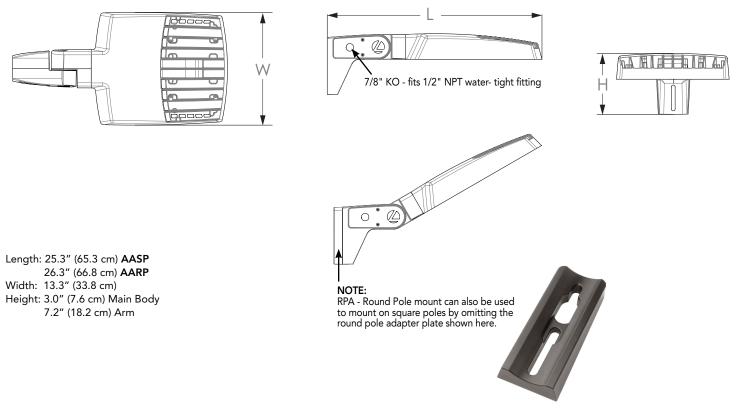
RSX1 with Adjustable Tilt Arm - Square or Round Pole (AASP or AARP)



Notes


AASP: Requires 3.0" min. square pole for 1 at 90°. Requires 3.5" min. square pole for mounting 2, 3, 4 at 90°. AARP: Requires 3.2" min. dia. round pole for 2, 3, 4 at 90°. Requires 3.0" min. dia. round pole for mounting 1 at 90°, 2 at 180°, 3 at 120°.

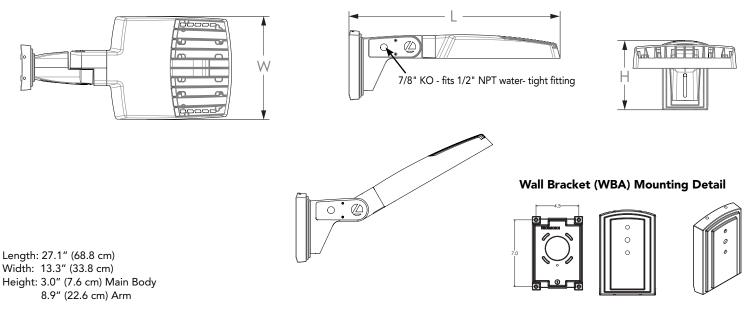RSX1 with Adjustable Tilt Arm with Wall Bracket (AAWB)






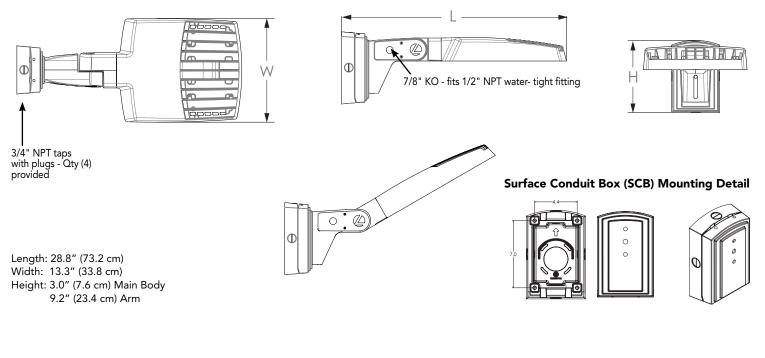RSX1 with Adjustable Tilt Arm with Wall Bracket and Surface Conduit Box (AAWSC)



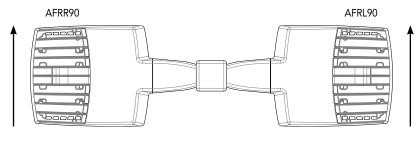Automotive Front Row - Rotated Optics (AFRL90/R90)



(Example: 2@180 - arrows indicate direction of light exiting the luminaire)







Date:

Approved:

Type:

Fixture:

Project:

FCB6C-4WN03 Exterior die-cast aluminum, 6" nominal diameter bollard with a 4-way, 3" high window opening.

SPECIFICATIONS

| PHYSICAL | |
|--------------------|-------------------------------------------------------------------------------------------------------------------------------------------------------------------------------------------------------------------------------------------------------------------------------------|
| dimensions | 40" H x 5.50" Ø |
| weight | 18 lbs |
| housing | Marine grade, corrosion resistant, heavy gauge extruded aluminum |
| lens | Impact resistant, UV stabilized, white polycarbonate diffuser |
| mounting | Heavy wall base bracketing for bollard installation provides a unique mounting solution, so the tower body anchors flush to the ground without the appearance of a base plate, anchor bolts included |
| ingress protection | IP66: dry, damp, or wet locations |
| finish | Available in Black, Bronze, Graphite Grey, Silver, White and Custom Colors. Six stage chemical iron phosphate conversion pre-treatment. Polyester powder coat finish, 18 µm minimum, 5,000 hour salt spray test (ASTM B117) compliant with Florida / AAMA 2604 specification. |

| PERFORMANCE | | | | | | | | | |
|-----------------------|--------------------------|--------------------------------|-------|-------|--|--|--|--|--|
| color temperature | 2700K | 3000K | 3500K | 4000K | | | | | |
| lumen output | 283 298 313 330 | | | | | | | | |
| lumen maintenance | L70 > 70,000 hours | L70 > 70,000 hours | | | | | | | |
| color consistency | 3 SDCM 85 or 90 CR | | | | | | | | |
| operating temperature | -13°F to 104°F (-25°C to | -13°F to 104°F (-25°C to 40°C) | | | | | | | |
| warranty | 5-Year limited warranty | | | | | | | | |

| ELECTRICAL | |
|-------------------|----------------------------------------------------------------------------------|
| input voltage | Universal 120 - 277 VAC optional: 347 VAC 480 VAC |
| power supply | Integral Class II, electronic, high power factor > 94% @ 120V |
| certification | ETL/cETL Listed |
| standards | UL1598 / CSA C22.2 No. 250.0; UI 8750 / CSA C22.2 No. 250.13 / IES LM-79 / LM-80 |
| power consumption | 11W @ 120 - 277 VAC (maximum) |
| dimming | 0-10V (10%) |

Due to continuous development and improvements, specifications are subject to change without notice. Product use certifies agreement to FC Lighting terms and conditions.


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Specification Sheet

Ordering Information



ORDERING INFORMATION

| FCB6C-4WN03 | | | 40 | | 3L | | | | |
|-------------|------|---------------------|---------------|------------------|-----------------|-----|---------------|------------------|-----------------------------------------------------------------|
| SERIES | | VOLTAGE | HEIGHT | CCT | LUMENS | | FINISH | | OPTIONS |
| FCB6C-4WN03 | UNV | UNV 120 - 277 VAC | 40 40" | 27K 2700K | 3L 330 lm (11W) | BKE | Black | LD | 0-10V Dimming (Standard) |
| | 347V | 347 VAC | | 3K 3000K | | BRE | Bronze | SP20 | 20kV Surge Protector |
| | 480V | 480 VAC | | 35K 3500K | | GRE | Graphite Grey | BBU | Battery Backup (Integral) |
| | 120V | 120 VAC (Photo Eye) | | 4K 4000K | | SLE | Silver | SP20-BBU | (2) 20kV Surge Protectors (1/LED Driver |
| | 277V | 277 VAC (Photo Eye) | | | | WHE | White | | 1/BBU) and Battery Backup (Integral) |
| | | | | | | CCE | Custom Color | PE120 | Photo Eye for 120 VAC |
| | | | | | | | | PE277 | Photo Eye for 277 VAC |
| | | | | | | | | LAB ¹ | Less Anchor Bolt Kit - for shipment separate of Anchor Bolt Kit |

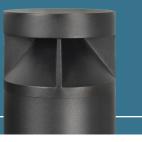ANCHOR BOLT KITS

A00636

Anchor Bolt Kit - Complete Anchor Bolt Kit shipped in advance of fixture.

¹ Note: Fixture must be mounted into FC Lighting supplied Anchor Bolt Kit shipped with or separate of fixture.


Consult Factory for other options and configurations.

To ensure you receive proper configurations for your lighting specifications, contact us directly about any unique application requirements. This may include but not be limited to lumen output, mounting needs, or electrical requirements.

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Physical



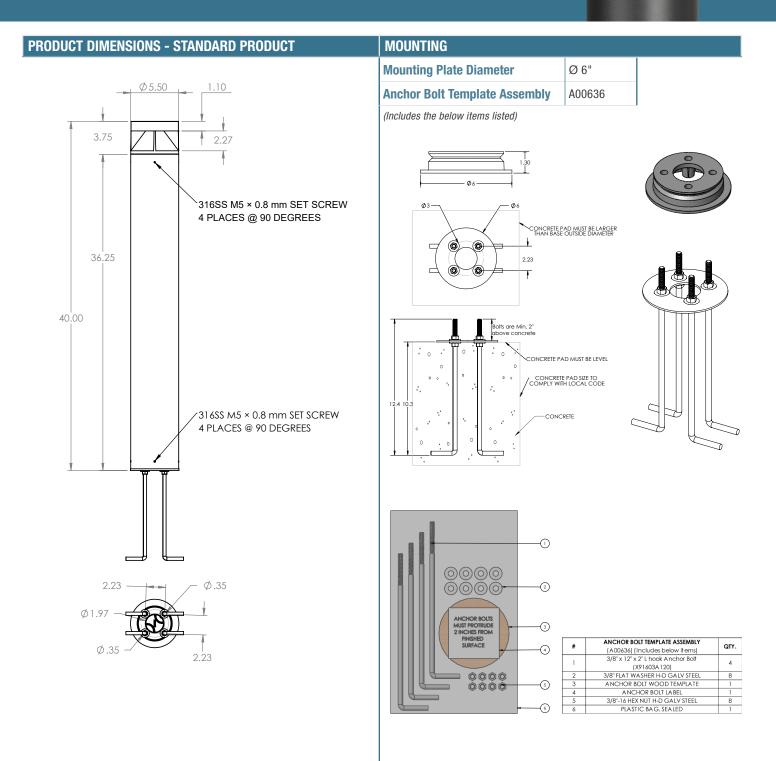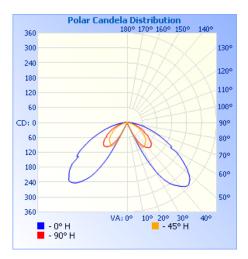
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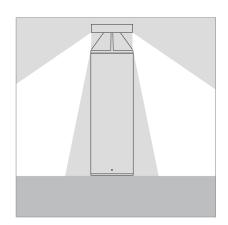
US Commercial Lighting Manufacturer Since 1982

Photometry

OPTICAL DISTRIBUTION




| Illuminance at a Distance | | | | | | | | |
|--------------------------------------------|----------------|----|------------|--------|--|--|--|--|
| | Center Beam fc | | Beam Width | | | | | |
| 1.7 R | 0.06 fc | L. | 1.1 ft | 0.2 ft | | | | |
| 3.3R | 0.02 fc | L | 2.1 ft | 0.4 ft | | | | |
| 5.08 | 0.01 fc | | 3.2 ft | 0.6 ft | | | | |
| 6.7ft | 0.00 fc | | 4.3 ft | 0.8 ft | | | | |
| 8.38 | 0.00 fc | | 5.4 ft | 1.0 ft | | | | |
| | 0.00 fc | | 6.4 ft | 1.2 ft | | | | |
| 10.0ft Strends 25 79 | | | | | | | | |
| Vert. Spread: 35.7° Horiz. Spread: 6.9° | | | | | | | | |



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nLight Control - Sensor Coverage and Settings



| Motion Sensor Default Settings - Option PIRHN | | | | | | | | |
|-----------------------------------------------|------------------------------|-------------------------------|------------------------|--------------------------------------|-----------------------------------------------|-------------------------------------------------|--|--|
| Option | Dimmed State (unoccupied) | High Level (when occupied) | Photocell Operation | Dwell Time (occupancy time delay) | Ramp-up Time (from unoccupied to occupied) | Ramp-down Time (from occupied to unoccupied) | | |
| NLTAIR2 PIRHN | Approx. 30% Output | 100% Output | Enabled @ 1.5FC | 7.5 minutes | 3 seconds | 5 minutes | | |

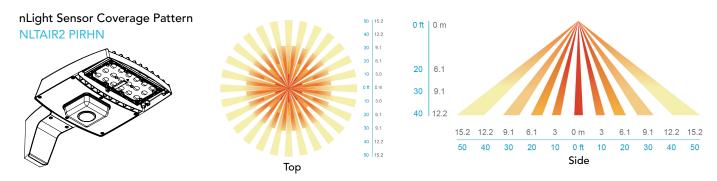*Note: NLTAIR2 PIRHN default settings including photocell set-point, high/low dim rates, and occupancy sensor time delay are all configurable using the Clairity Pro App. Sensor coverage pattern shown with luminaire at 0°. Sensor coverage pattern is affected when luminaire is titled.

FEATURES & SPECIFICATIONS

INTENDED USE

The RSX LED area family is designed to provide a long-lasting, energy-efficient solution for the onefor-one replacement of existing metal halide or high pressure sodium lighting. The RSX1 delivers 7,000 to 17,000 lumens and is ideal for replacing 70W to 400W HID pole-mounted luminaires in parking lots and other area lighting applications.

CONSTRUCTION

The RSX LED area luminaire features a rugged die-cast aluminum main body that uses heatdissipating fins and flow-through venting to provide optimal thermal management that both enhances LED performance and extends component life. Integral "no drill" mounting arm allows the luminaire to be mounted on existing pole drillings, greatly reducing installation labor. The light engines and housing are sealed against moisture and environmental contaminants to IP66. The low-profile design results in a low EPA, allowing pole optimization. All mountings are rated for minimum 1.5 G vibration load per ANSI C136.31. 3G Mountings: Include SPA, RPA, MA, IS, AASP, and AARP rated for 3G vibration. 1.5G Mountings: Include WBA, WBASC, AAWB and AAWSC rated for 1.5G vibration.

FINISH

Exterior parts are protected by a zinc-infused Super Durable TGIC thermoset powder coat finish that provides superior resistance to corrosion and weathering. A tightly controlled multi-stage process ensures superior adhesion as well as a minimum finish thickness of 3 mils. The result is a high-quality finish that is warrantied not to crack or peel.

COASTAL CONSTRUCTION (CCE)

Optional corrosion-resistant construction is engineered with added corrosion protection in materials and/or pre-treatment of base material under super durable paint. Provides additional corrosion protection for applications near coastal areas. Finish is salt spray tested to over 5,000 hours per ASTM B117 with scribe rating of 10. Additional lead times apply.

OPTICS

Precision acrylic refractive lenses are engineered for superior application efficiency, distributing the light to where it is needed most. Available in short and wide pattern distributions including Type 2, Type 3, Type 35, Type 4, Type 4S, Type 5, AFR (Automotive Front Row), and AFR rotated AFRR90 and ARFL90.

ELECTRICAL

Light engine(s) configurations consist of high-efficacy LEDs mounted on metal-core circuit boards and aluminum heat sinks to maximize heat dissipation. Light engines are IP66 rated. LED lumen maintenance is >L92/100,000 hours. CCT's of 3000K, 4000K and 5000K (minimum 70 CRI) are available. Fixtures ship standard with 0-10v dimming driver. Class 1 electronic drivers ensure system power factor >90% and THD <20% Easily serviceable 10kV surge protection device meets a minimum Category C Low operation (per ANSI/IEEE C62.41.2).

STANDARD CONTROLS

The RSX LED area luminaire has a wide assortment of control options. Dusk to dawn controls include MVOLT and 347V button-type photocells and NEMA twist-lock photocell receptacles.

nLIGHT AIR CONTROLS

The RSX LED area luminaire is also available with nLight® AIR for the ultimate in wireless control. This powerful controls platform provides out-of-the-box basic motion sensing with photocontrol functionality and is suitable for mounting heights up to 40 feet. No commissioning is required when using factory default settings that provide basic stand-alone motion occupancy dimming that is switched on and off with a built-in photocell. See chart above for motion sensor default out-of-box settings. For more advanced wireless functionality, such as group dimming, nLight AIR can be commissioned using a smartphone and the easy-touse CLAIRITY app. nLight AIR equipped luminaries can be grouped, resulting in motion sensor and photocell group response without the need for additional equipment. Scheduled dimming with motion sensor over-ride can be achieved when used with the nLight Eclypse. Additional information about nLight Air can be found here.

INSTALLATION

Integral "no-drill" mounting arm allows for fast, easy mounting using existing pole drillings. Select the "SPA" option for square poles and the "RPA" option to mount to round poles. Note, the RPA mount can also be used for mounting to square poles by omitting the RPA adapter plate. Select the "MA" option to attach the luminaire to a 2 3/8" horizontal mast arm or the "IS" option for an adjustable slipfitter that mounts on a 2 3/8" OD tenon. The adjustable slipfitter has an integral junction box and offers easy installation. Can be tilted up to 90° above horizontal. Additional mountings are available including a wall bracket, adjustable til arm for direct-to-pole and wall and a surface conduit box for wall mount applications.

LISTINGS

CSA Certified to meet U.S. and Canadian standards. Suitable for wet locations. Rated for -40°C minimum ambient. DesignLights Consortium® (DLC) Premium qualified product and DLC qualified product. Not all versions of this product may be DLC Premium qualified or DLC qualified. Please check the DLC Qualified Products List at <u>www.designlights.org/QPL</u> to confirm which versions are qualified.

International Dark-Sky Association (IDA) Fixture Seal of Approval (FSA) is available for all products on this page utilizing 3000K color temperature only. U.S. Patent No. D882, 146S

GOVERNMENT PROCUREMENT

BAA – Buy America(n) Act: Product with the BAA option qualifies as a domestic end product under the Buy American Act as implemented in the FAR and DFARS. Product with the BAA option also qualifies as manufactured in the United States under DOT Buy America regulations. BABA – Build America Buy America: Product with the BAA option also qualifies as produced in the United States under the definitions of the Build America, Buy America Act. Please refer to www.acuitybrands.com/buy-american for additional information.

WARRANTY

5-year limited warranty. This is the only warranty provided and no other statements in this specification sheet create any warranty of any kind. All other express and implied warranties are disclaimed. Complete warranty terms located at:

Note: Actual performance may differ as a result of end-user environment and application. All values are design or typical values, measured under laboratory conditions at 25 °C. Specifications subject to change without notice.

