



Madison Public Market

LAND USE APPLICATION

2-24-2020

MSRDesign

MSRDesign

location map

200 N 1st St. Madison, WI 53704

Neighborhood Aerial View



site context

views to [existing] site 01



view from east washington



view from east washington and north 1st

site context

views to [existing] site 02



view from east johnson and north 1st



view from east johnson

site context

views of surrounding context – Burr Jones Park and Yahara River

Burr Jones Park



Burr Jones Park basketball courts



Yahara River bike trails and bridges



Yahara river bike trails and ridges



site context

views of surrounding context

site context looking east



site context looking North



site context looking west



site context looking south



TOPOGRAPHIC SYMBOL LEGEND

- EXISTING BOLLARD
EXISTING MAILBOX
EXISTING POST
EXISTING SIGN (TYPE NOTED)
EXISTING CURB INLET
EXISTING ENDWALL
EXISTING FIELD INLET RECTANGULAR
EXISTING FIELD INLET
EXISTING ROOF DRAIN CLEANOUT
EXISTING STORM MANHOLE
EXISTING SANITARY CLEANOUT
EXISTING SANITARY MANHOLE
EXISTING FIRE HYDRANT
EXISTING FIRE DEPARTMENT CONNECTION
EXISTING WATER MAIN VALVE
EXISTING CURB STOP
EXISTING GAS VALVE
EXISTING GAS METER
EXISTING AIR CONDITIONING PEDESTAL
EXISTING DOWN GUY
EXISTING ELECTRIC MANHOLE
EXISTING ELECTRIC RECTANGULAR MANHOLE
EXISTING ELECTRIC PEDESTAL
EXISTING TRANSFORMER
EXISTING ELECTRIC METER
EXISTING GUY POLE
EXISTING LIGHT POLE
EXISTING GENERIC LIGHT
EXISTING UTILITY POLE
EXISTING TV MANHOLE
EXISTING TV RECTANGULAR MANHOLE
EXISTING TV PEDESTAL
EXISTING TELEPHONE MANHOLE
EXISTING TELEPHONE PEDESTAL
EXISTING UNIDENTIFIED MANHOLE
EXISTING UNIDENTIFIED UTILITY VAULT
EXISTING HANDICAP PARKING
EXISTING SHRUB
EXISTING CONIFEROUS TREE
EXISTING DECIDUOUS TREE
EXISTING BORING
EXISTING TEST PIT

TOPOGRAPHIC LINEWORK LEGEND

- EXISTING UNDERGROUND CABLE TV
EXISTING OVERHEAD CABLE TV
EXISTING FIBER OPTIC LINE
EXISTING OVERHEAD TELEPHONE LINE
EXISTING UNDERGROUND TELEPHONE
EXISTING RETAINING WALL
EXISTING CHAIN LINK FENCE
EXISTING WIRE FENCE
EXISTING WOOD FENCE
EXISTING GAS LINE
EXISTING UNDERGROUND ELECTRIC LINE
EXISTING GUY LINE
EXISTING OVERHEAD ELECTRIC LINE
EXISTING OVERHEAD GENERAL UTILITIES
EXISTING SANITARY SEWER LINE (SIZE NOTED)
EXISTING STORM SEWER LINE (SIZE NOTED)
EXISTING EDGE OF TREES
EXISTING WATER MAIN (SIZE NOTED)
EXISTING MAJOR CONTOUR
EXISTING MINOR CONTOUR

DEMOLITION PLAN LEGEND

- CURB AND GUTTER REMOVAL
ASPHALT REMOVAL
CONCRETE REMOVAL
TREE REMOVAL
SAWCUT (ALL ASPHALT REMOVAL AREAS TO BE SAWCUT)
UTILITY LINE REMOVAL
UTILITY POLE REMOVAL BY OTHERS

EROSION CONTROL LEGEND

- EXISTING MAJOR CONTOURS
EXISTING MINOR CONTOURS
PROPOSED MAJOR CONTOURS
PROPOSED MINOR CONTOURS
SILT FENCE
CLASS II SILT SOCK
DISTURBED LIMITS
INLET PROTECTION
EROSION MAT CLASS I TYPE B
EROSION MAT CLASS II TYPE A
EROSION MAT CLASS III TYPE A
CHANNEL MAT CLASS I TYPE B
TRACKING PAD
RIP RAP

PROPOSED UTILITY LEGEND

- STORM SEWER PIPE
STORM SEWER MANHOLE
STORM SEWER ENDWALL
STORM SEWER CURB INLET
STORM SEWER CURB INLET W/MANHOLE
STORM SEWER FIELD INLET
ROOF DRAIN CLEANOUT
SANITARY SEWER PIPE (GRAVITY)
SANITARY SEWER MANHOLE
SANITARY SEWER CLEANOUT
WATER SERVICE
FIRE HYDRANT
WATER VALVE
PROPOSED PIPE INSULATION
GAS MAIN
ELECTRIC SERVICE

ABBREVIATIONS table with symbols for STMH, FI, CI, CB, EW, SMH

GENERAL NOTES:

- 1. INSTALL A TRACKING PAD WITH MINIMUM DIMENSIONS OF 50'L X 20'W X 1.5'D AT THE SITE EXIT. THE TRACKING PAD SHALL BE MAINTAINED/REPAIRED FREQUENTLY TO AVOID THE TRACKING OF SEDIMENT OUTSIDE OF CONSTRUCTION LIMITS.
2. THE CONTRACTOR IS REQUIRED TO MAKE EROSION CONTROL INSPECTIONS AT THE END OF EACH WEEK AND WHEN 0.5 INCHES OF RAIN FALLS WITHIN 24 HOURS. INSPECTION REPORTS SHALL BE PREPARED AND FILED AS REQUIRED BY THE DNR. ALL MAINTENANCE/REPAIR WILL FOLLOW AN INSPECTION WITHIN 24 HOURS.
3. UTILITY STRUCTURE RIM AND TOP OF CURB ELEVATIONS ON PLANS ARE APPROXIMATE. ALL UTILITY STRUCTURES SHALL BE SET TO FINAL ELEVATIONS AFTER THE CURB & GUTTER AND BASE COURSE HAVE BEEN INSTALLED.
4. THE CONTRACTOR IS RESPONSIBLE FOR ANY DAMAGE CAUSED DURING CONSTRUCTION TO PUBLIC PROPERTY, PRIVATE PROPERTY OR UTILITIES.
5. THE CONTRACTOR SHALL SUBMIT SHOP DRAWINGS FOR REVIEW BY THE ENGINEER, PRIOR TO PLACING AN ORDER OF ANY SUCH ITEM.
6. EXISTING TOPOGRAPHIC INFORMATION IS BASED ON FIELD OBSERVATIONS AND/OR PLAN OF RECORD DRAWINGS. CONTRACTOR SHALL VERIFY TOPOGRAPHIC INFORMATION PRIOR TO STARTING CONSTRUCTION.
7. CONTRACTOR SHALL FIELD VERIFY LOCATION OF EXISTING SANITARY SEWER, STORM SEWER AND WATER MAIN PRIOR TO CONSTRUCTION TO ENSURE PROPER CLEARANCE OF THE NEW UTILITIES. CONTRACTOR MUST TAKE ALL NECESSARY PRECAUTIONS TO PROTECT THE EXISTING UTILITIES DURING CONSTRUCTION. ANY DAMAGE TO THE EXISTING UTILITIES AND ANY REPAIRS NEEDED AS A RESULT OF THE DAMAGE SHALL BE AT THE EXPENSE OF THE CONTRACTOR REGARDLESS OF THE LOCATION MARKED IN THE FIELD OR SHOWN ON THE PLANS.
8. THE CONTRACTOR SHALL REMOVE ANY SEDIMENT TRACKED ONTO ADJACENT ROADS BY MEANS OF STREET SWEEPING (NOT FLUSHING) AT A MINIMUM OF THE END OF EACH WORK DAY OR MORE AS NEEDED.
9. RIGHT OF WAY (ROW) AND PROPERTY LINES ARE APPROXIMATE. CONTRACTOR SHALL BE RESPONSIBLE FOR PROTECTING EXISTING PROPERTY CORNER MONUMENTATION. ANY MONUMENTS DISTURBED BY CONTRACTOR SHALL BE REPLACED AT THE CONTRACTORS EXPENSE.
10. CONTRACTOR SHALL COORDINATE WITH DRY UTILITY COMPANY'S REGARDING ANY POTENTIAL CONFLICTS AND COORDINATE RELOCATIONS AS MAY BE REQUIRED. CONTRACTOR SHALL ALSO COORDINATE THE PROPOSED INSTALLATION OF NEW FACILITIES AS REQUIRED.
11. INSTALL WATER MAIN/SERVICES AT ADEQUATE DEPTH (MIN 6.5' OF COVER) TO AVOID CONFLICT WITH PROPOSED SANITARY SEWER AND STORM SEWER PER DNR STANDARDS EXCEPT WHERE NOTED ON THE PLANS.
12. SANITARY MANHOLES WITH SEWER MAIN CONNECTIONS GREATER THAN 2' ABOVE THE LOWEST INVERT SHALL BE CONSTRUCTED WITH AN EXTERNAL DROP. MANHOLES WITH SEWER LATERAL CONNECTIONS GREATER THAN 2' ABOVE THE LOWEST INVERT SHALL BE CONSTRUCTED WITH AN INTERNAL DROP.
13. INSTALL 1 SHEET OF 4'x8'x4" HIGH DENSITY POLYSTYRENE INSULATION AT ALL LOCATIONS WHERE STORM SEWER CROSSES WATER MAIN OR WATER SERVICE LATERALS.
14. CONTOURS ARE SHOWN FOR PURPOSES OF INDICATING ROUGH GRADING. FINAL GRADES SHALL BE ESTABLISHED ON PAVED SURFACES BY USING SPOT GRADES ONLY.
15. CROSS-SLOPE OF SIDEWALKS SHALL BE 2% UNLESS OTHERWISE NOTED.
16. ACCESSIBLE ROUTES SHALL BE 5% MAX LONGITUDINAL SLOPE AND 2% MAX CROSS SLOPE. ACCESSIBLE LOADING AREAS OR LANDINGS SHALL BE 2% MAX SLOPE IN ANY DIRECTION. RAMPS SHALL BE 8.33% MAX SLOPE.
17. CONTRACTOR SHALL DEEP TILL ANY DISTURBED AREAS AFTER CONSTRUCTION IS COMPLETE AND BEFORE RESTORING.
18. CONTRACTOR SHALL UTILIZE DIRECTIONAL TRACKING ON SLOPES AS A TEMPORARY GRADING PRACTICE TO CREATE RIDGES FROM VEHICLE TRACKS WHICH PREVENT SOIL EROSION.

DEMOLITION NOTES:

- 1. CONTRACTOR SHALL KEEP ALL CITY STREETS FREE AND CLEAR OF CONSTRUCTION RELATED DIRT/DUST/DEBRIS.
2. INSTALL ALL APPLICABLE EROSION CONTROL MEASURES PRIOR TO STARTING DEMOLITION.
3. ALL SAWCUTTING SHALL BE FULL DEPTH TO PROVIDE A CLEAN EDGE TO MATCH NEW CONSTRUCTION. MATCH EXISTING ELEVATIONS AT POINTS OF CONNECTION FOR NEW AND EXISTING PAVEMENT, CURB, SIDEWALKS, ETC. ALL SAWCUT LOCATIONS SHOWN ARE APPROXIMATE AND MAY BE FIELD ADJUSTED TO ACCOMMODATE CONDITIONS, JOINTS, MATERIAL TYPE, ETC. REMOVE MINIMUM AMOUNT NECESSARY FOR INSTALLATION OF PROPOSED IMPROVEMENTS.
4. CONTRACTOR SHALL PROVIDE AND SHALL BE RESPONSIBLE FOR ANY NECESSARY TRAFFIC CONTROL SIGNAGE AND SAFETY MEASURES DURING DEMOLITION AND CONSTRUCTION OPERATIONS WITHIN OR NEAR THE PUBLIC ROADWAY.
5. COORDINATE TREE REMOVAL WITH LANDSCAPE ARCHITECT. ALL TREES TO BE REMOVED SHALL BE REMOVED IN THEIR ENTIRETY AND STUMPS SHALL BE GROUND TO 12" BELOW PROPOSED SUBGRADE. ALL BRUSH SHALL BE CLEARED/REMOVED WITHIN DISTURBANCE LIMITS.
6. IF APPLICABLE, PROVIDE TREE PROTECTION FENCING PRIOR TO CONSTRUCTION OPERATIONS. MAINTAIN THROUGHOUT CONSTRUCTION.
7. COORDINATE ABANDONMENT OF ELECTRICAL LINES WITH ELECTRICAL ENGINEER AND OWNER PRIOR TO DEMOLITION.
8. CONTRACTOR SHALL OBTAIN ANY NECESSARY DEMOLITION AND UTILITY ABANDONMENT/PLUGGING PERMITS FROM THE LOCAL MUNICIPALITY/UTILITY AGENCY.
9. ANY DAMAGE TO THE CITY PAVEMENT, INCLUDING DAMAGE RESULTING FROM CURB REPLACEMENT, WILL REQUIRE RESTORATION IN ACCORDANCE WITH THE CITY STANDARDS.

UTILITY NOTES:

- 1. SANITARY & STORM SEWER LENGTHS SHOWN ARE FROM CENTER OF STRUCTURE TO CENTER OF STRUCTURE. STORM SEWER END SECTIONS ARE INCLUDED IN THE LENGTH AND SLOPE OF THE PIPE.
2. CONTRACTOR SHALL INVESTIGATE ALL UTILITY CROSSINGS PRIOR TO CONSTRUCTION AND NOTIFY ENGINEER OF ANY CONFLICTS.
3. CONTRACTOR SHALL BE RESPONSIBLE FOR ADJUSTING ALL UTILITY STRUCTURES TO FINISHED GRADE (MANHOLE RIMS, WATER VALVES, AND CURB STOPS), IF NECESSARY.
4. FOR ALL SEWER AND WATER MAIN CROSSINGS: PROVIDE MINIMUM 18" SEPARATION WHEN WATER MAIN CROSSES BELOW SEWER AND MINIMUM 6" SEPARATION WHEN WATER MAIN CROSSES ABOVE SEWER.
5. IF DEWATERING OPERATIONS EXCEED 70 GALLONS PER MINUTE OF PUMPING CAPACITY, A DEWATERING WELL PERMIT SHALL BE OBTAINED PRIOR TO STARTING ANY DEWATERING ACTIVITIES.
6. A COPY OF THE APPROVED UTILITY PLANS, SPECIFICATIONS AND PLUMBING PERMIT APPROVAL LETTER SHALL BE ON-SITE DURING CONSTRUCTION AND OPEN TO INSPECTION BY AUTHORIZED REPRESENTATIVES OF THE DEPARTMENT OF SAFETY AND PROFESSIONAL SERVICES AND OTHER LOCAL INSPECTORS.
7. STORM BUILDING SEWER PIPE SHALL CONFORM TO ONE OF THE STANDARDS LISTED IN TABLE 384.30-6 OF SPS 384.30(3)(c).
8. PRIVATE WATER SERVICES AND PRIVATE WATER MAINS SHALL CONFORM TO ONE OF THE STANDARDS LISTED IN TABLE 384.30-7 OF SPS 384.30(4)(d).
9. PRIVATE SANITARY SEWER AND LATERALS SHALL BE POLYVINYL CHLORIDE (PVC) ASTM D3034 - SDR 35 OR APPROVED EQUAL MATERIAL THAT CONFORMS TO ONE OF THE STANDARDS LISTED IN TABLE 384.30-3 OF SPS 384.30(2)(c).
10. A MEANS TO LOCATE BURIED UNDERGROUND EXTERIOR NON METALLIC SEWERS/MAINS AND WATER SERVICES/MAINS MUST BE PROVIDED WITH TRACER WIRE OR OTHER METHODS IN ORDER TO BE LOCATED PER SPS 382.10(11)(h) AND SPS 382.40(8)(k).
11. EXTERIOR WATER SUPPLY PIPING SETBACKS AND CROSSINGS SHALL BE IN ACCORDANCE WITH SPS 382.40(8)(b.).
12. NO PERSON MAY ENGAGE IN PLUMBING WORK IN THE STATE UNLESS LICENSED TO DO SO BY THE DEPARTMENT OF SAFETY AND PROFESSIONAL SERVICES PER S.145.06.
13. SITE CONTRACTOR SHALL LEAVE SANITARY AND WATER LATERALS FIVE (5) FEET SHORT (HORIZONTALLY) FROM THE BUILDING. BUILDING PLUMBER SHALL VERIFY SIZE, LOCATION, AND INVERT ELEVATION OF PROPOSED SANITARY AND WATER LATERALS.
14. IT IS THE CONTRACTOR'S RESPONSIBILITY TO VERIFY THAT THE EXISTING VALVES WILL HOLD THE PRESSURE TEST PRIOR TO CONNECTION. THE CITY IS NOT RESPONSIBLE FOR ANY COSTS INCURRED DUE TO THE CONTRACTOR NOT VERIFYING THAT THE EXISTING VALVE WILL HOLD THE PRESSURE TEST PRIOR TO CONNECTION. IF A NEW VALVE IS REQUIRED, THE APPLICANT WILL BE REQUIRED TO INSTALL ONE AT THEIR EXPENSE, AT THE POINT OF CONNECTION.
15. CLEAN OUT ALL EXISTING AND PROPOSED STORM INLETS AND CATCH BASINS AT THE COMPLETION OF CONSTRUCTION.

AGENCIES:

EMERGENCY - FIRE, RESCUE, AMBULANCE, POLICE DIAL 911
UNITED STATES POST OFFICE
3902 MILWAUKEE ST
MADISON, WI 53714-9998
PHONE: 608-831-5501

MADISON POLICE DEPARTMENT
211 S. CARROL ST
MADISON, WI 53703
PHONE: 608-255-2345 NON-EMERGENCY

MADISON FIRE DEPARTMENT
30 W. MIFFLIN ST.
MADISON, WI 53703
PHONE: 608-266-4420 NON-EMERGENCY

MADISON METRO
1245 E. WASHINGTON AVE.
SUITE 201
MADISON, WI 53703
TIM SOBOTA
PHONE: 608-261-4289

UTILITIES:

MG&E (GAS)
PO BOX 1231
MADISON WI 53701
SHAUN ENDRES
PHONE: 608-252-7224 (O)
608-516-7913 (C)

ALLIANT ENERGY (ELECTRIC)
2147 COUNTY HIGHWAY PB
VERONA, WI 53593
NICHOLAS DACHNIWSKYJ
PHONE: 608-845-1143

CHARTER COMMUNICATIONS (CABLE TV)
2701 DANIELS STREET
MADISON, WI 53718
JON MARSCHKE
PHONE: 608-225-2479

TDS (TELEPHONE + FIBER)
1912 PARMENTER ST
MIDDLETON, WI 53562
JERRY MYERS
PHONE: 608-664-4404

CITY OF MADISON - CITY ENGINEER
CITY-COUNTY BUILDING, ROOM 115
210 MARTIN LUTHER KING JR. BOULEVARD
MADISON, WI 53703
ROBERT F. PHILLIPS, P.E.
PHONE: 608-266-4090

CITY OF MADISON - SANITARY AND STORM SEWER ENGINEER
CITY-COUNTY BUILDING, ROOM 115
210 MARTIN LUTHER KING JR. BOULEVARD
MADISON, WI 53703
GREG FRIES
PHONE: 608-267-1199


CITY OF MADISON - WATER UTILITY
119 EAST OLIN AVE.
MADISON, WI 53703
TOM HEIKKINEN, GENERAL MANAGER
PHONE: 608-266-4651



THE LOCATION OF EXISTING UTILITIES, BOTH UNDERGROUND AND OVERHEAD ARE APPROXIMATE ONLY AND HAVE NOT BEEN INDEPENDENTLY VERIFIED BY THE OWNER OR ITS REPRESENTATIVE. THE CONTRACTOR SHALL BE RESPONSIBLE FOR DETERMINING THE EXACT LOCATION OF ALL EXISTING UTILITIES WHETHER SHOWN ON THESE PLANS OR NOT, BEFORE COMMENCING WORK, AND SHALL BE FULLY RESPONSIBLE FOR ANY AND ALL DAMAGES WHICH MIGHT BE CAUSED BY THE CONTRACTOR'S FAILURE TO EXACTLY LOCATE AND PRESERVE ANY AND ALL UTILITIES.

CALL DIGGER'S HOTLINE 1-800-242-8511


ARCHITECTURE AND INTERIORS
MSRDesign
MEP Associates, LLC
Vierbicher
Ken Saiki Design
IMEG Corporation, Inc.
Mazzetti, Inc.
Boelter Premier
MADISON PUBLIC MARKET
200 N First St, Madison, WI 53704
Signature:
Print Name:
Date:
Issue / Revision table
PROJECT NO. 2019006.00
PROJECT PHASE 100% CDP DOCUMENTS
DRAWN BY: MSCH/MSCS
NOTES & LEGENDS
C-000

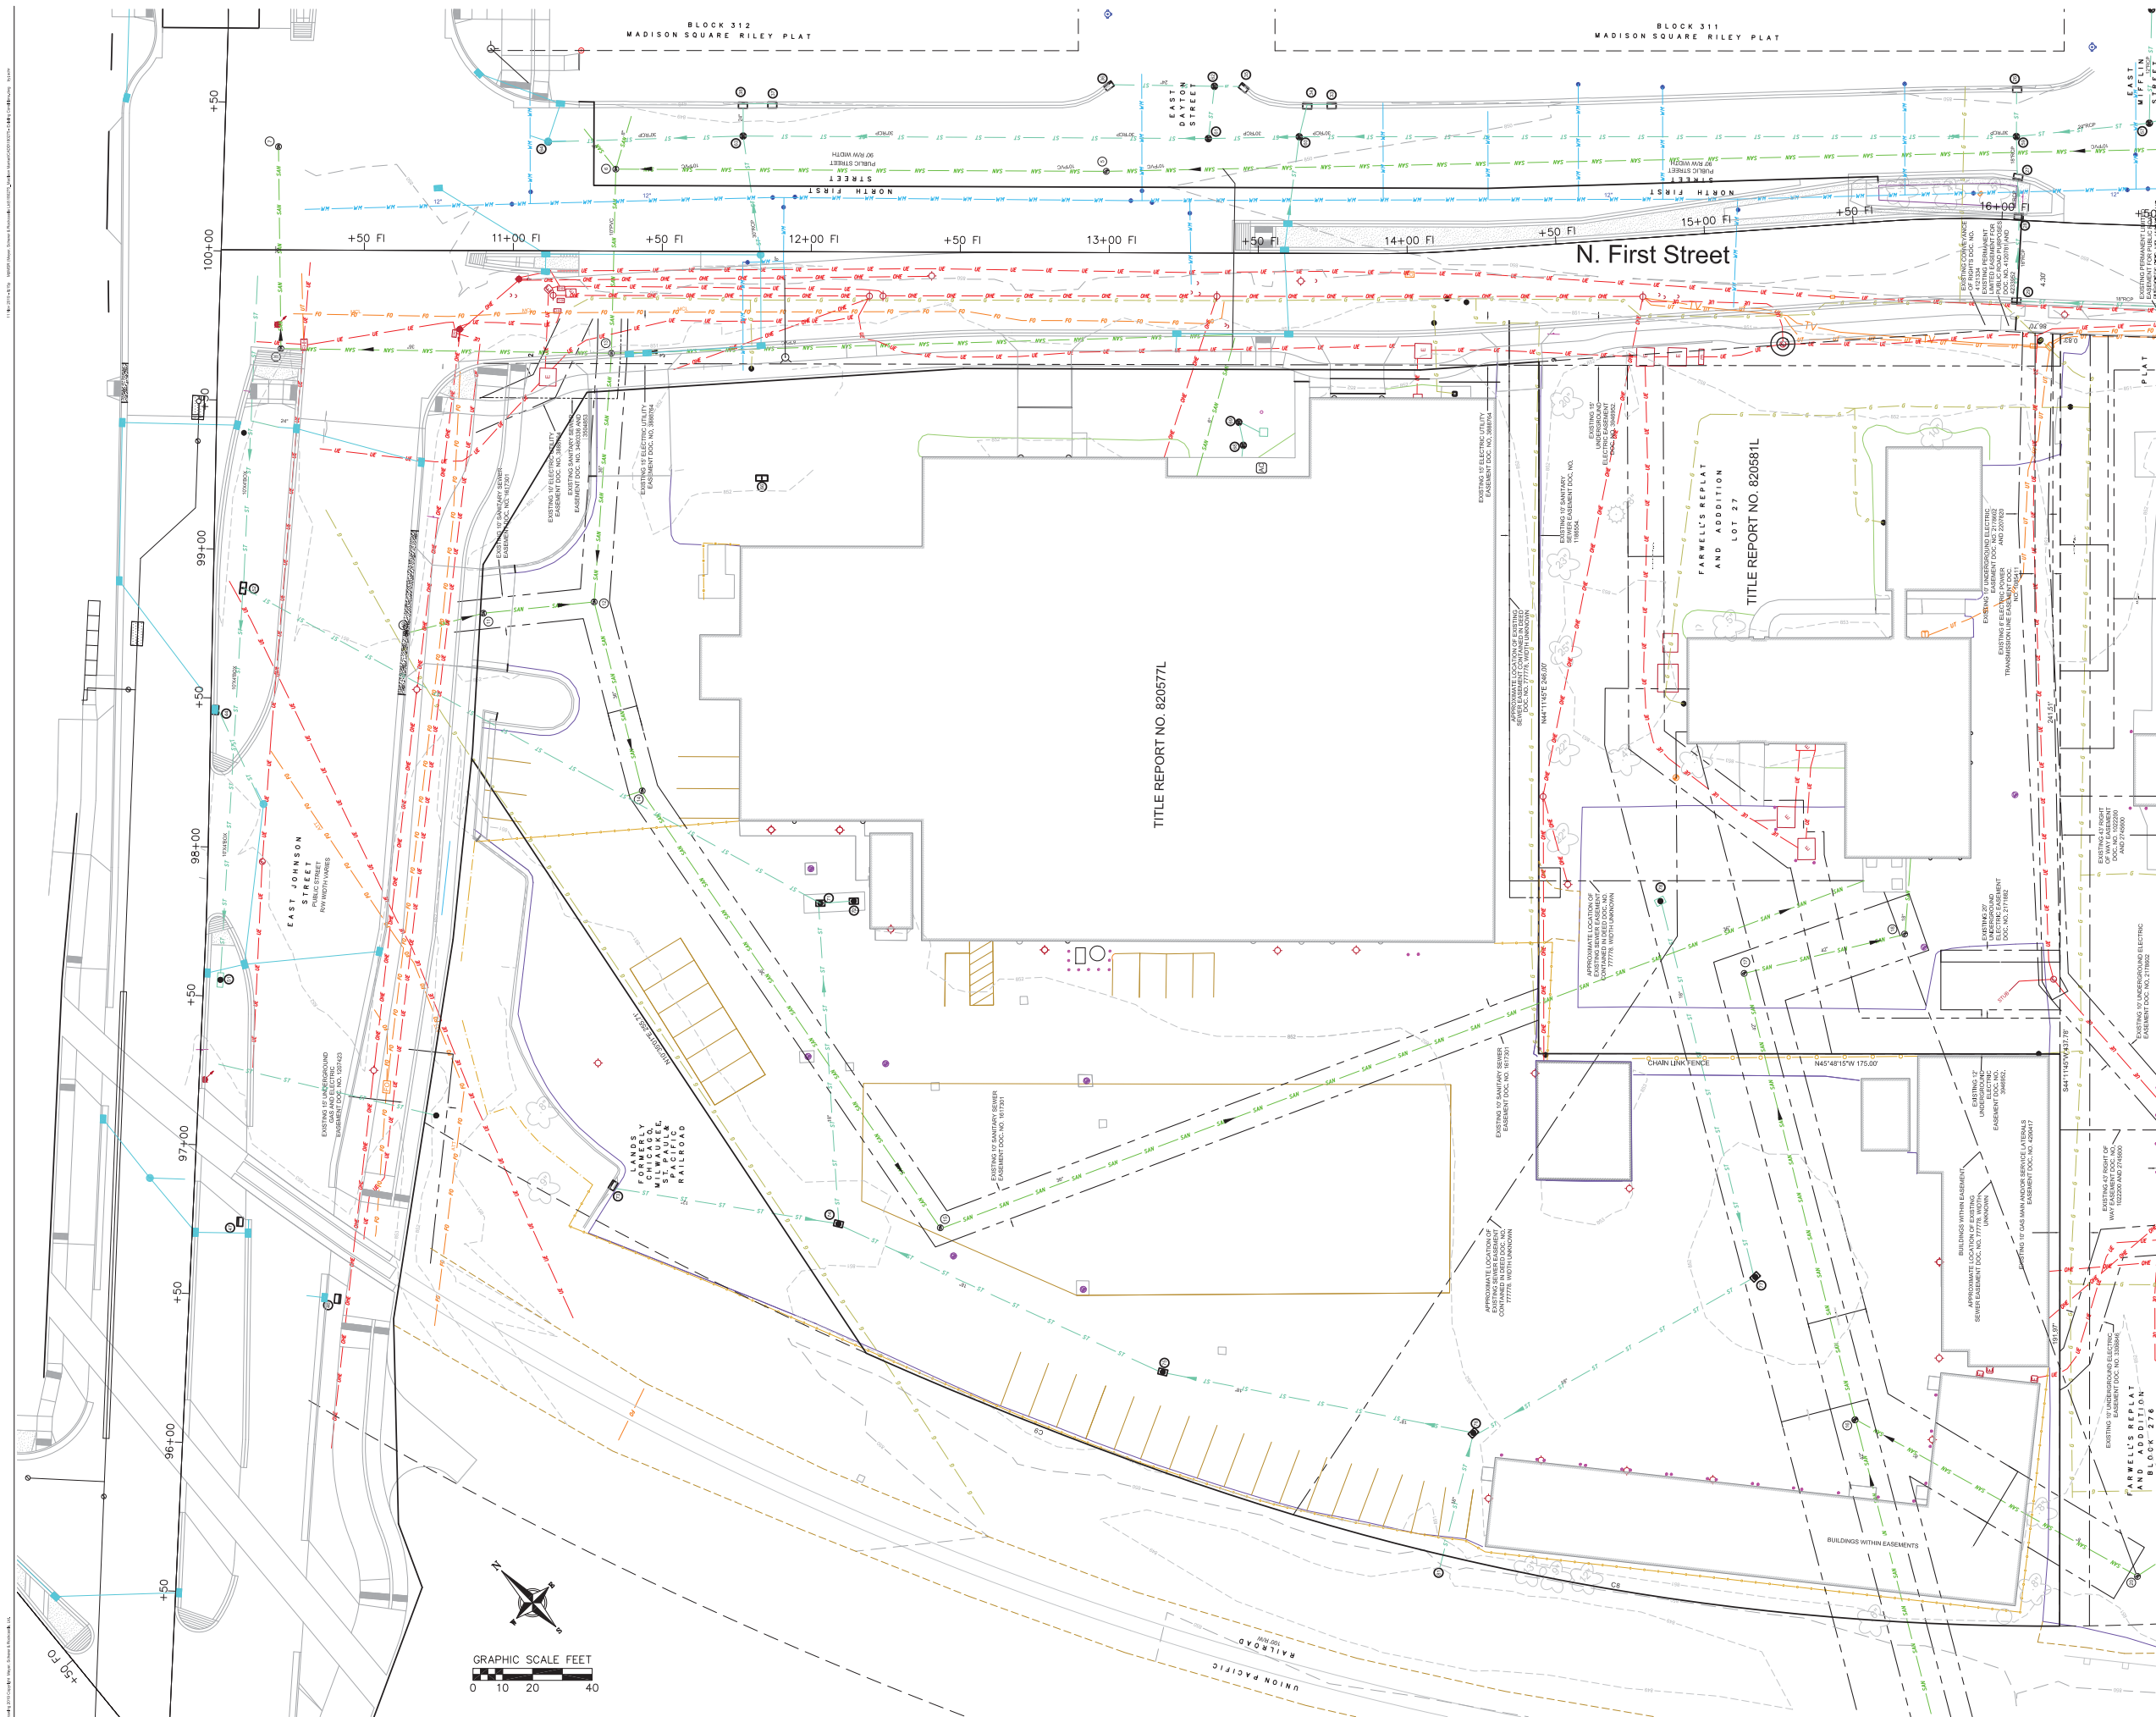

ARCHITECTURE AND INTERIORS

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710 South Second Street, Suite 800
Minneapolis, MN 55401 | 612.375.0336


MEP Engineer

MEP Associates, LLC 
800 Blue Center Rd #170
Eagan, MN 55121 | 651.279.9120


Civil Engineer

Verbicher
909 Fowler Dr, Suite 201
Madison, WI 53717 | 608.826.0532


Landscape Architect

Ken Saiki Design 
1110 S. Park St.
Madison, WI 53715 | 608.251.3600


Structural Engineering, Fire Protection Engineering,
Technology and AV

IMEG Corporation, Inc. 
1800 Dearing Hwy, Suite 200,
Madison, WI 53762

Lighting Design

Mazzetti, Inc. 
1600 Stout St, Suite 400
Denver, CO 80202 | 720.644.5044

Commercial Kitchen Design

Boelter Premier 
7120 Northland Terrace
Minneapolis, MN 55428 | 763.544.8800

MADISON PUBLIC MARKET
200 N First St, Madison, WI 53704

I hereby certify that this plan, specification or report was prepared by me or under my direct supervision and that I am a duly Licensed Architect under the Laws of the State of Minnesota, ARCHITECT SEAL.

Signature: _____
Print Name: _____
Date: _____ License No: _____


ISSUE	DATE	DESCRIPTION
06.04.2019	SITE + BUILDING DESIGN 1 PIRING ISSUE	
06.12.2019	LOC INFORMATIONAL SUBMISSION	
08.16.2019	SITE + BUILDING DESIGN 2 PIRING ISSUE	
11.13.2019	100% CDP DOCUMENTS	

PROJECT NO. 2019006.00
PROJECT PHASE 100% CDP DOCUMENTS
DRAWN BY: SCHR CHECKED BY: MSCH/TSCH
Drawn by: 2019 Copy Right: MSR Design & Associates, LLC

EXISTING CONDITIONS PLAN

C-001

NOT FOR CONSTRUCTION

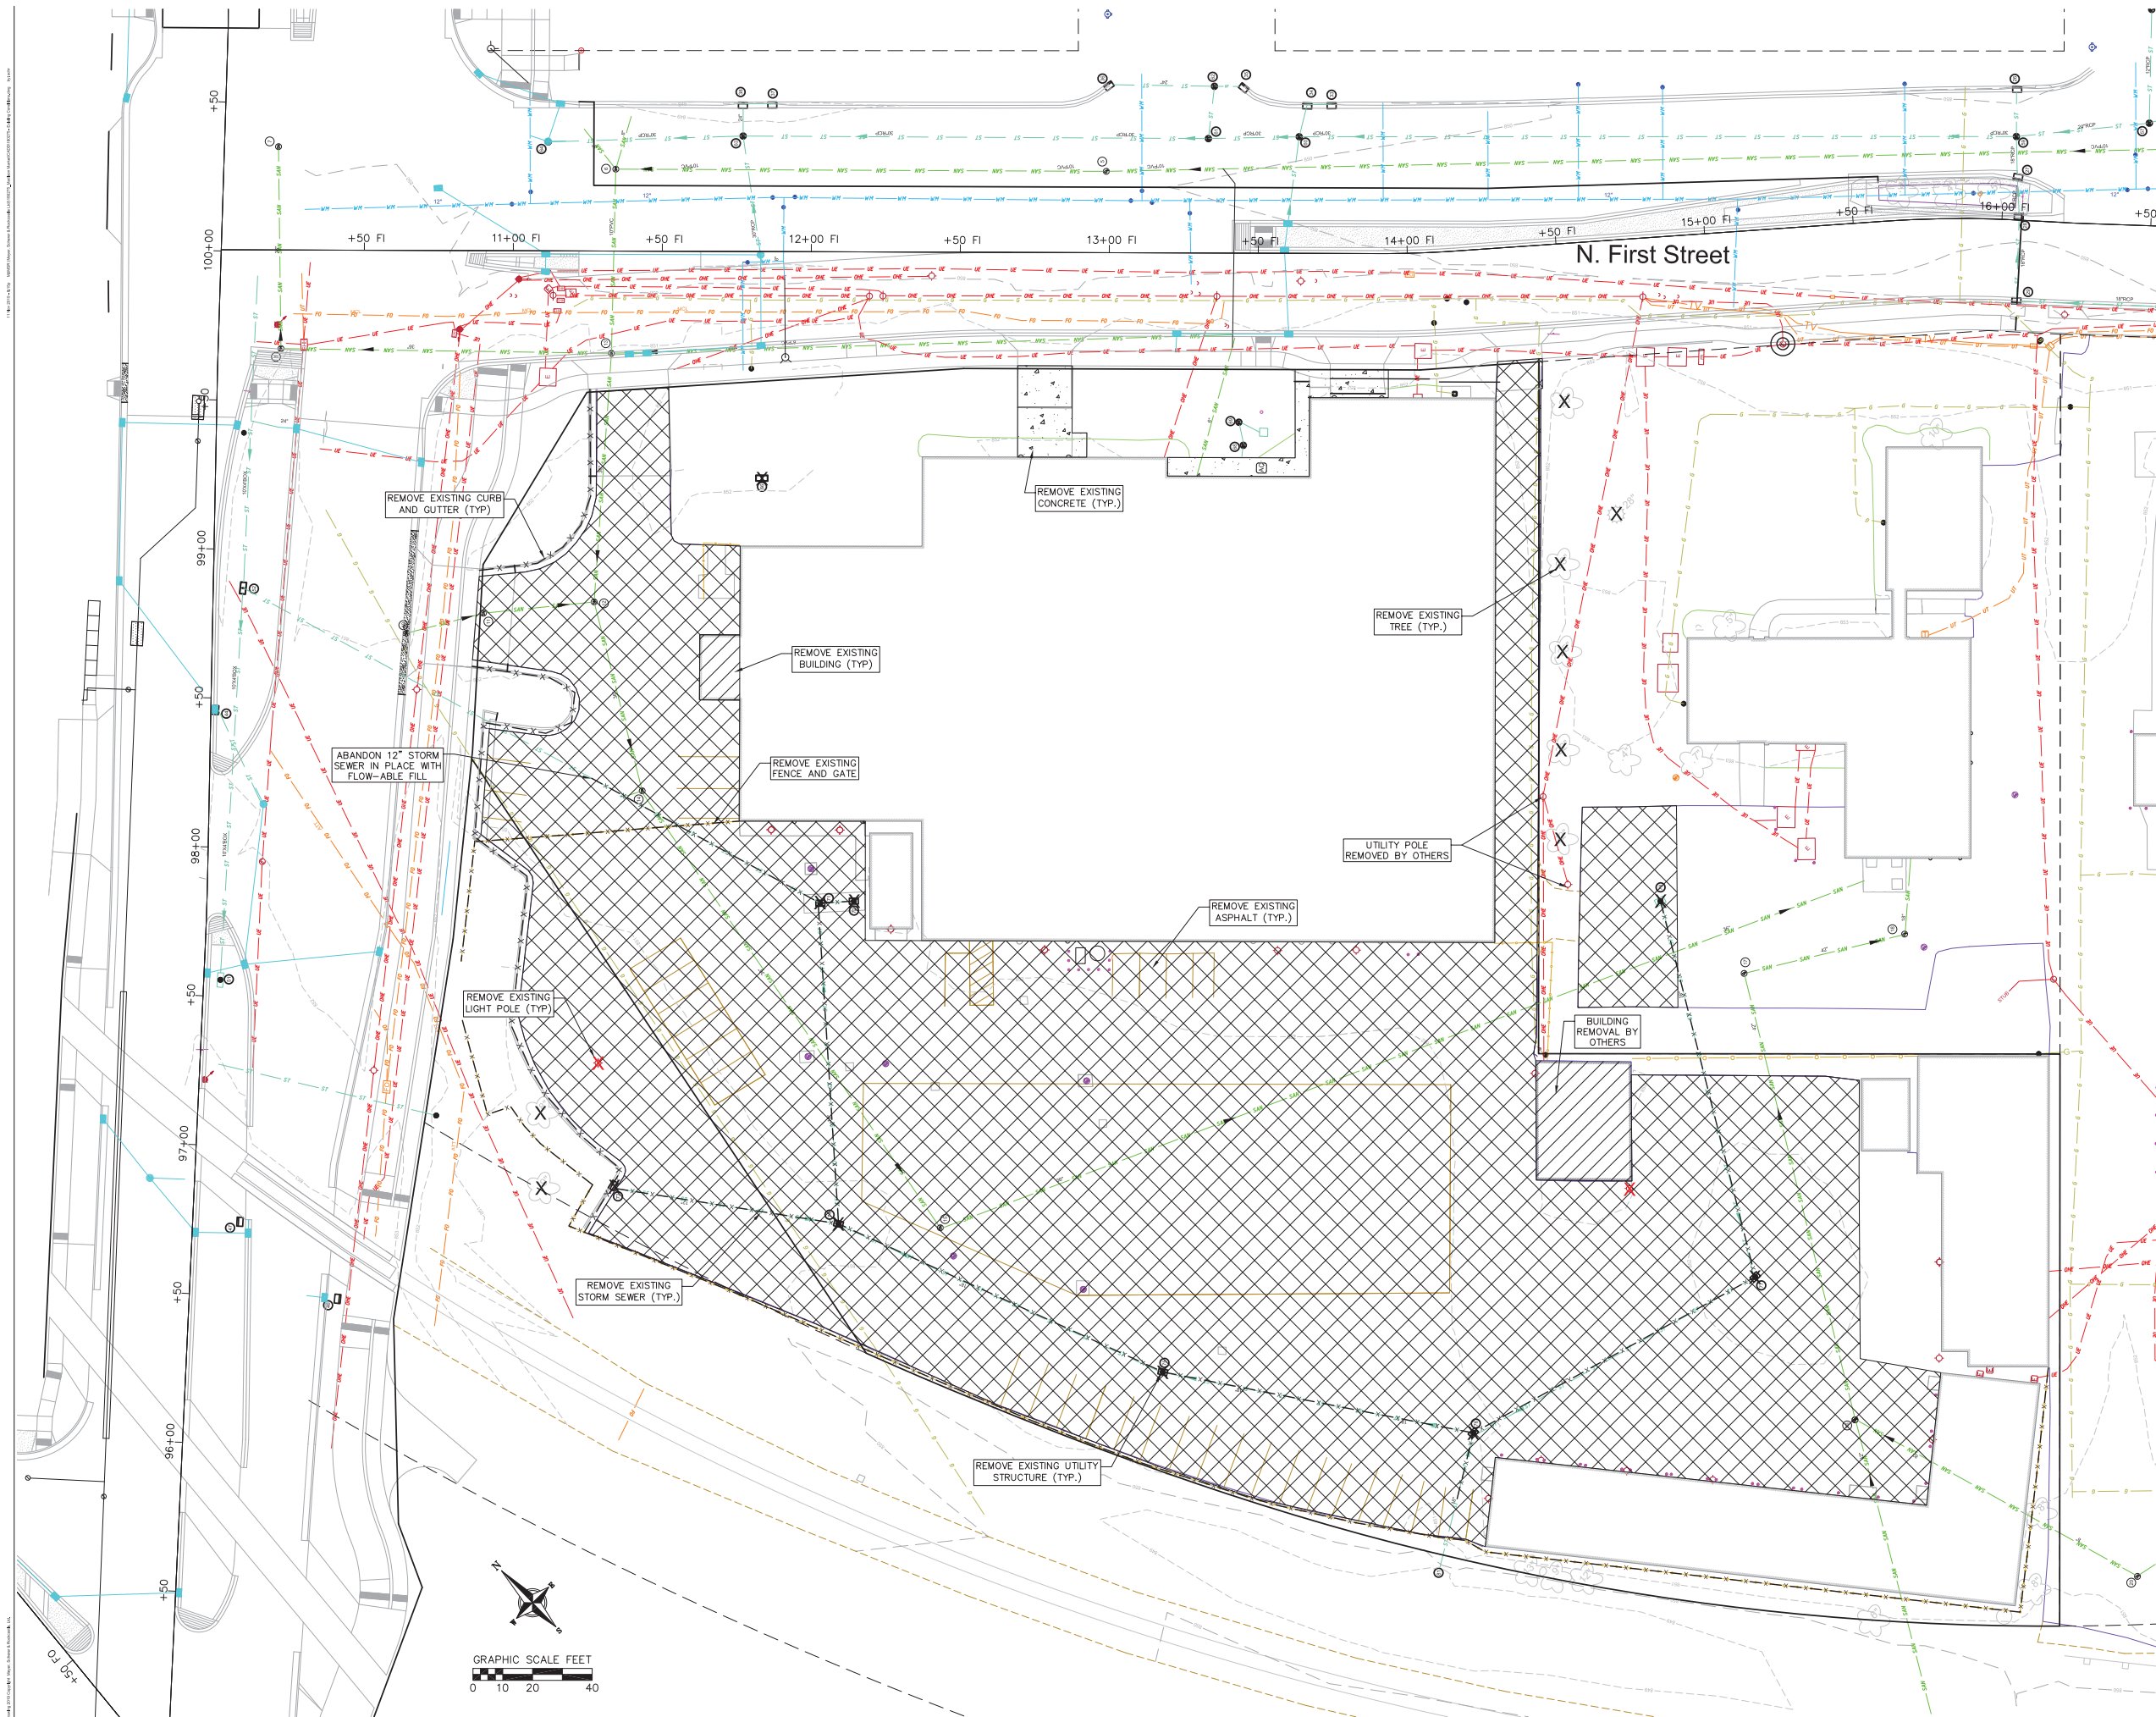

- ARCHITECTURE AND INTERIORS
- MSRDesign**
710 South Second Street, Suite 800
Minneapolis, MN 55401 | 612.375.0336
- MEP Engineer
- MEP Associates, LLC**
800 Blue Garden Rd #170
Eagan, MN 55121 | 651.379.9120
- Civil Engineer
- Vierbicher**
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Madison, WI 53717 | 608.826.6532
- Landscape Architect
- Ken Saiki Design**
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- Structural Engineering, Fire Protection Engineering,
Technology and AV
- IMEG Corporation, Inc.**
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Madison, WI 53762
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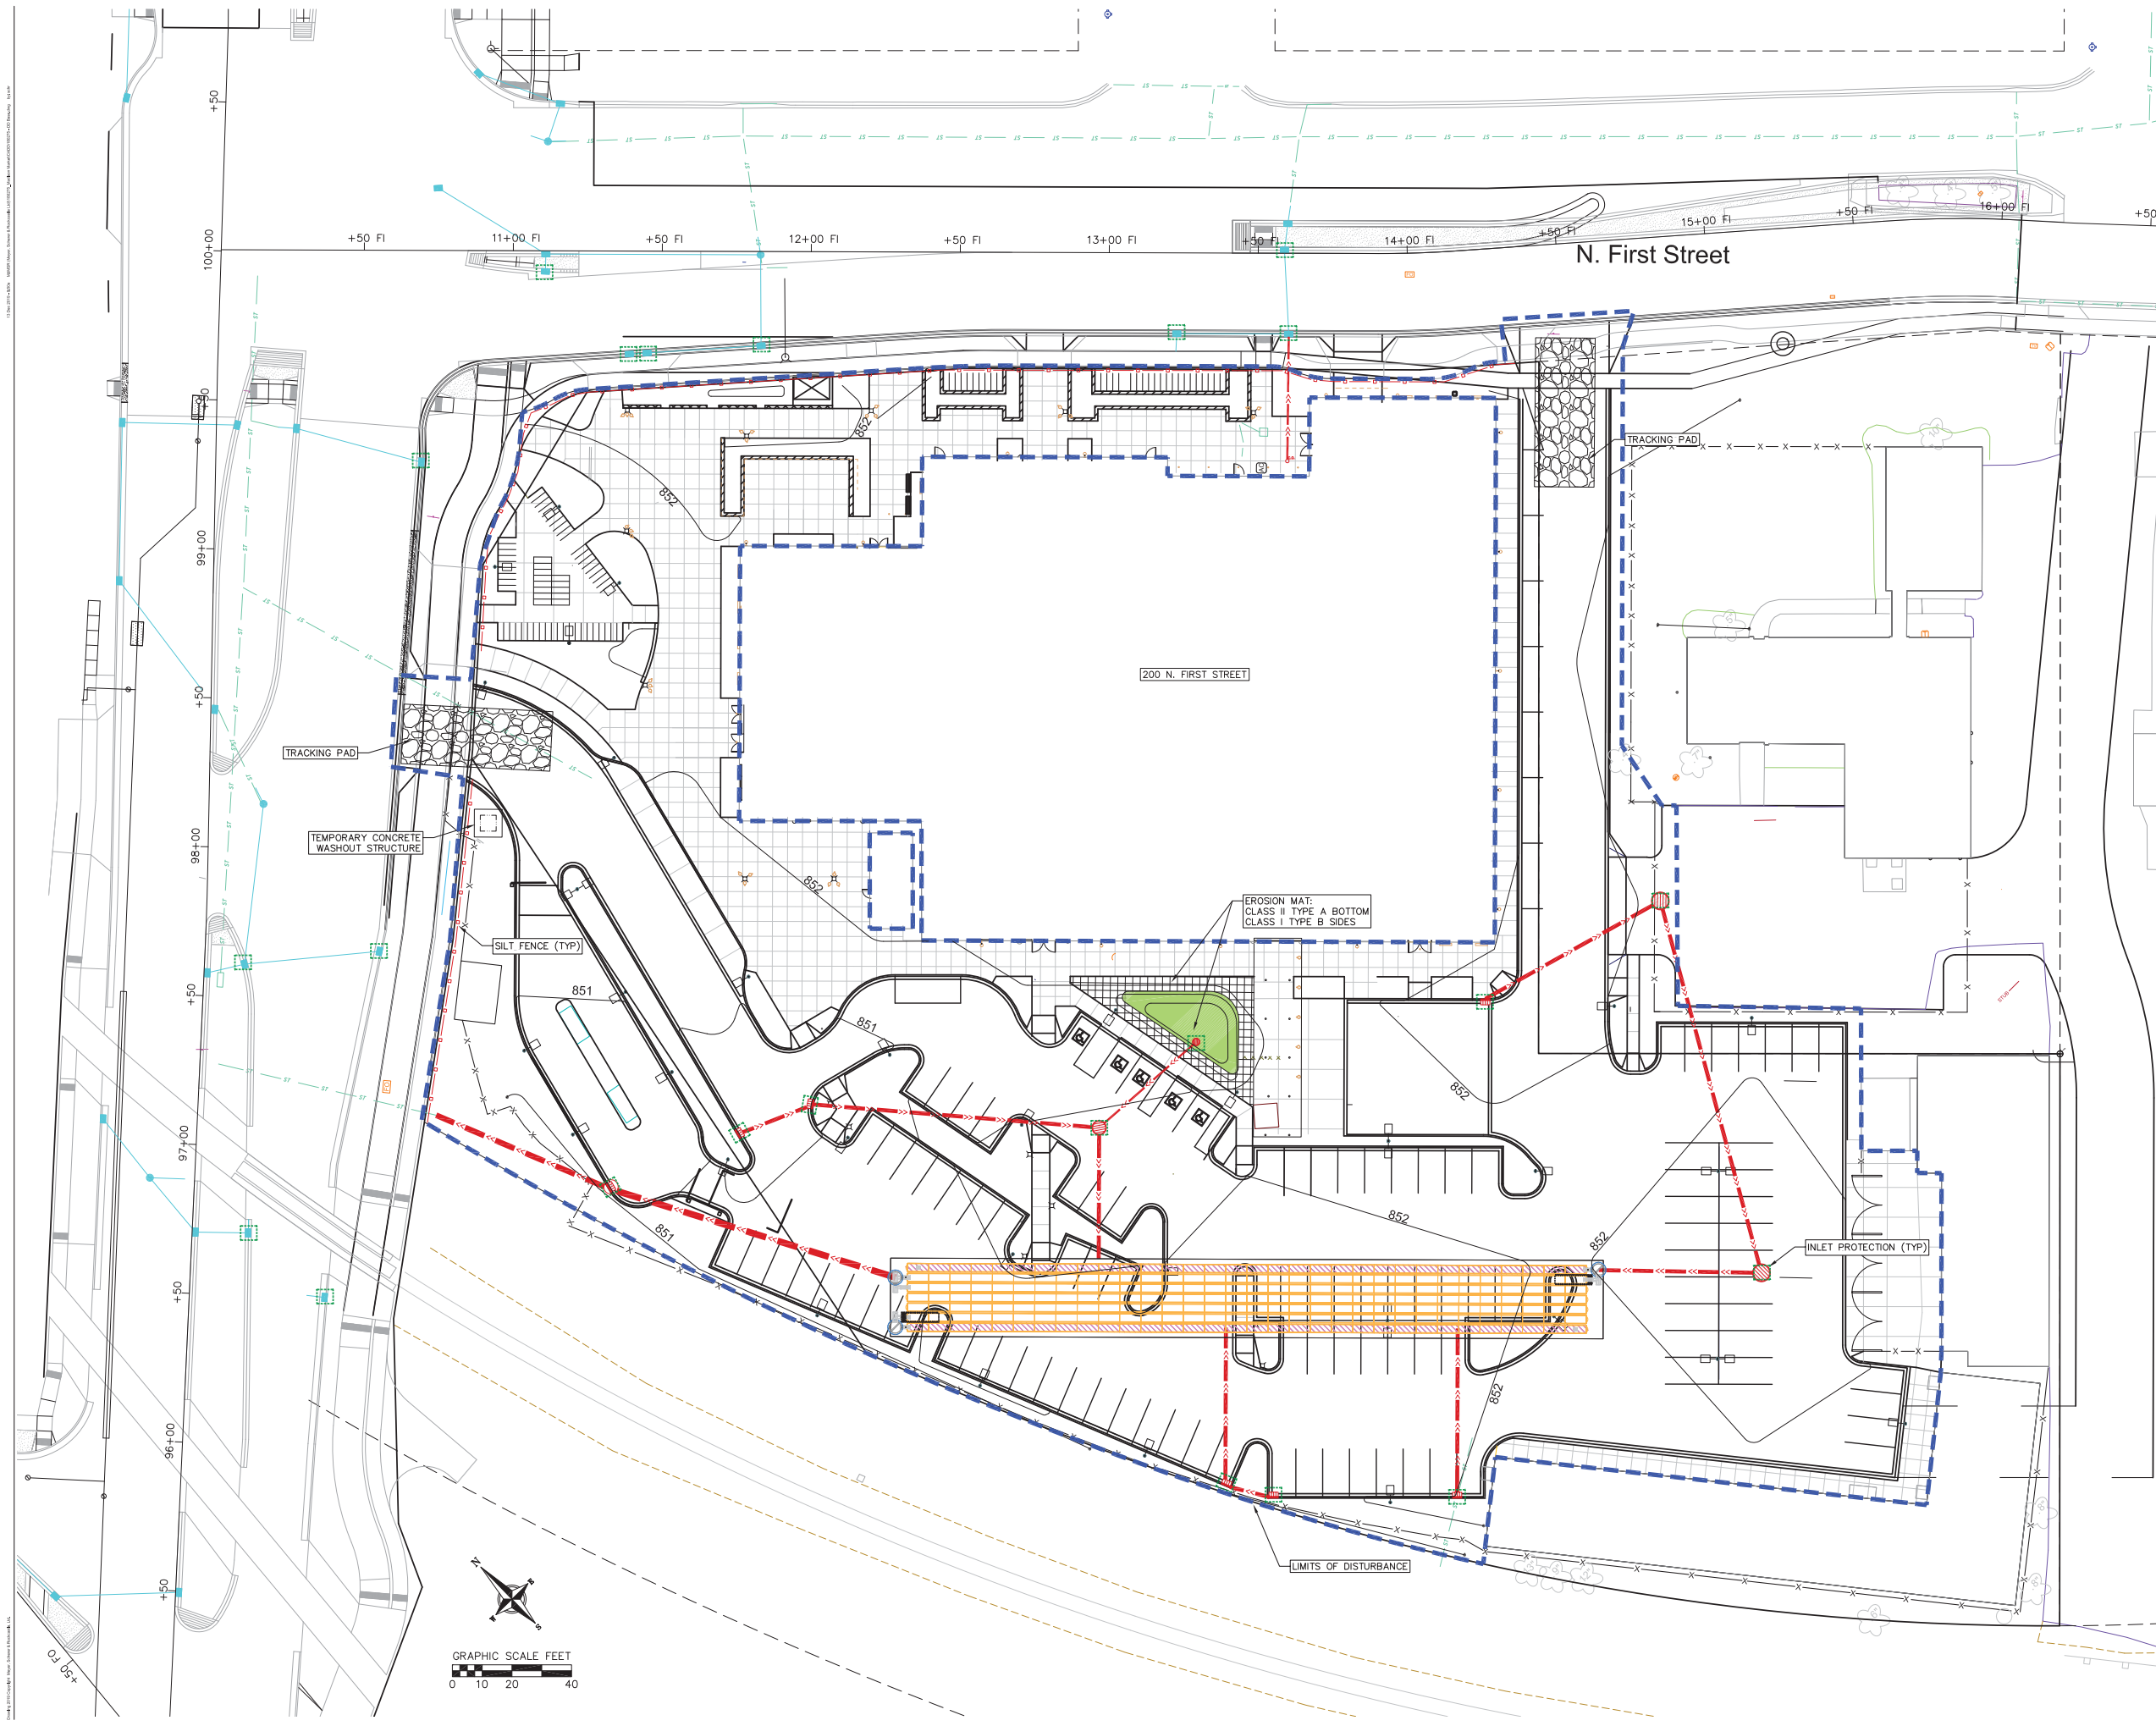
Signature: _____
Print Name: _____
Date: _____ License No: _____

ISSUE	DATE	DESCRIPTION
06.04.2019	06.04.2019	01 SITE & BUILDING DESIGN 1 PRICING ISSUE
06.12.2019	06.12.2019	02C INFORMATIONAL SUBMISSION
08.16.2019	08.16.2019	01 SITE & BUILDING DESIGN 2 PRICING ISSUE
11.13.2019	11.13.2019	100% CDP DOCUMENTS

PROJECT NO. 2019006.00
PROJECT PHASE 100% CDP DOCUMENTS
DRAWN BY: SCHR CHECKED BY: MSCH/TSCH
Drawn by: Schmitt & Associates, Inc. Checked by: Schmitt & Associates, Inc.

DEMOLITION PLAN

C-101



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Landscape Architect
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MADISON PUBLIC MARKET

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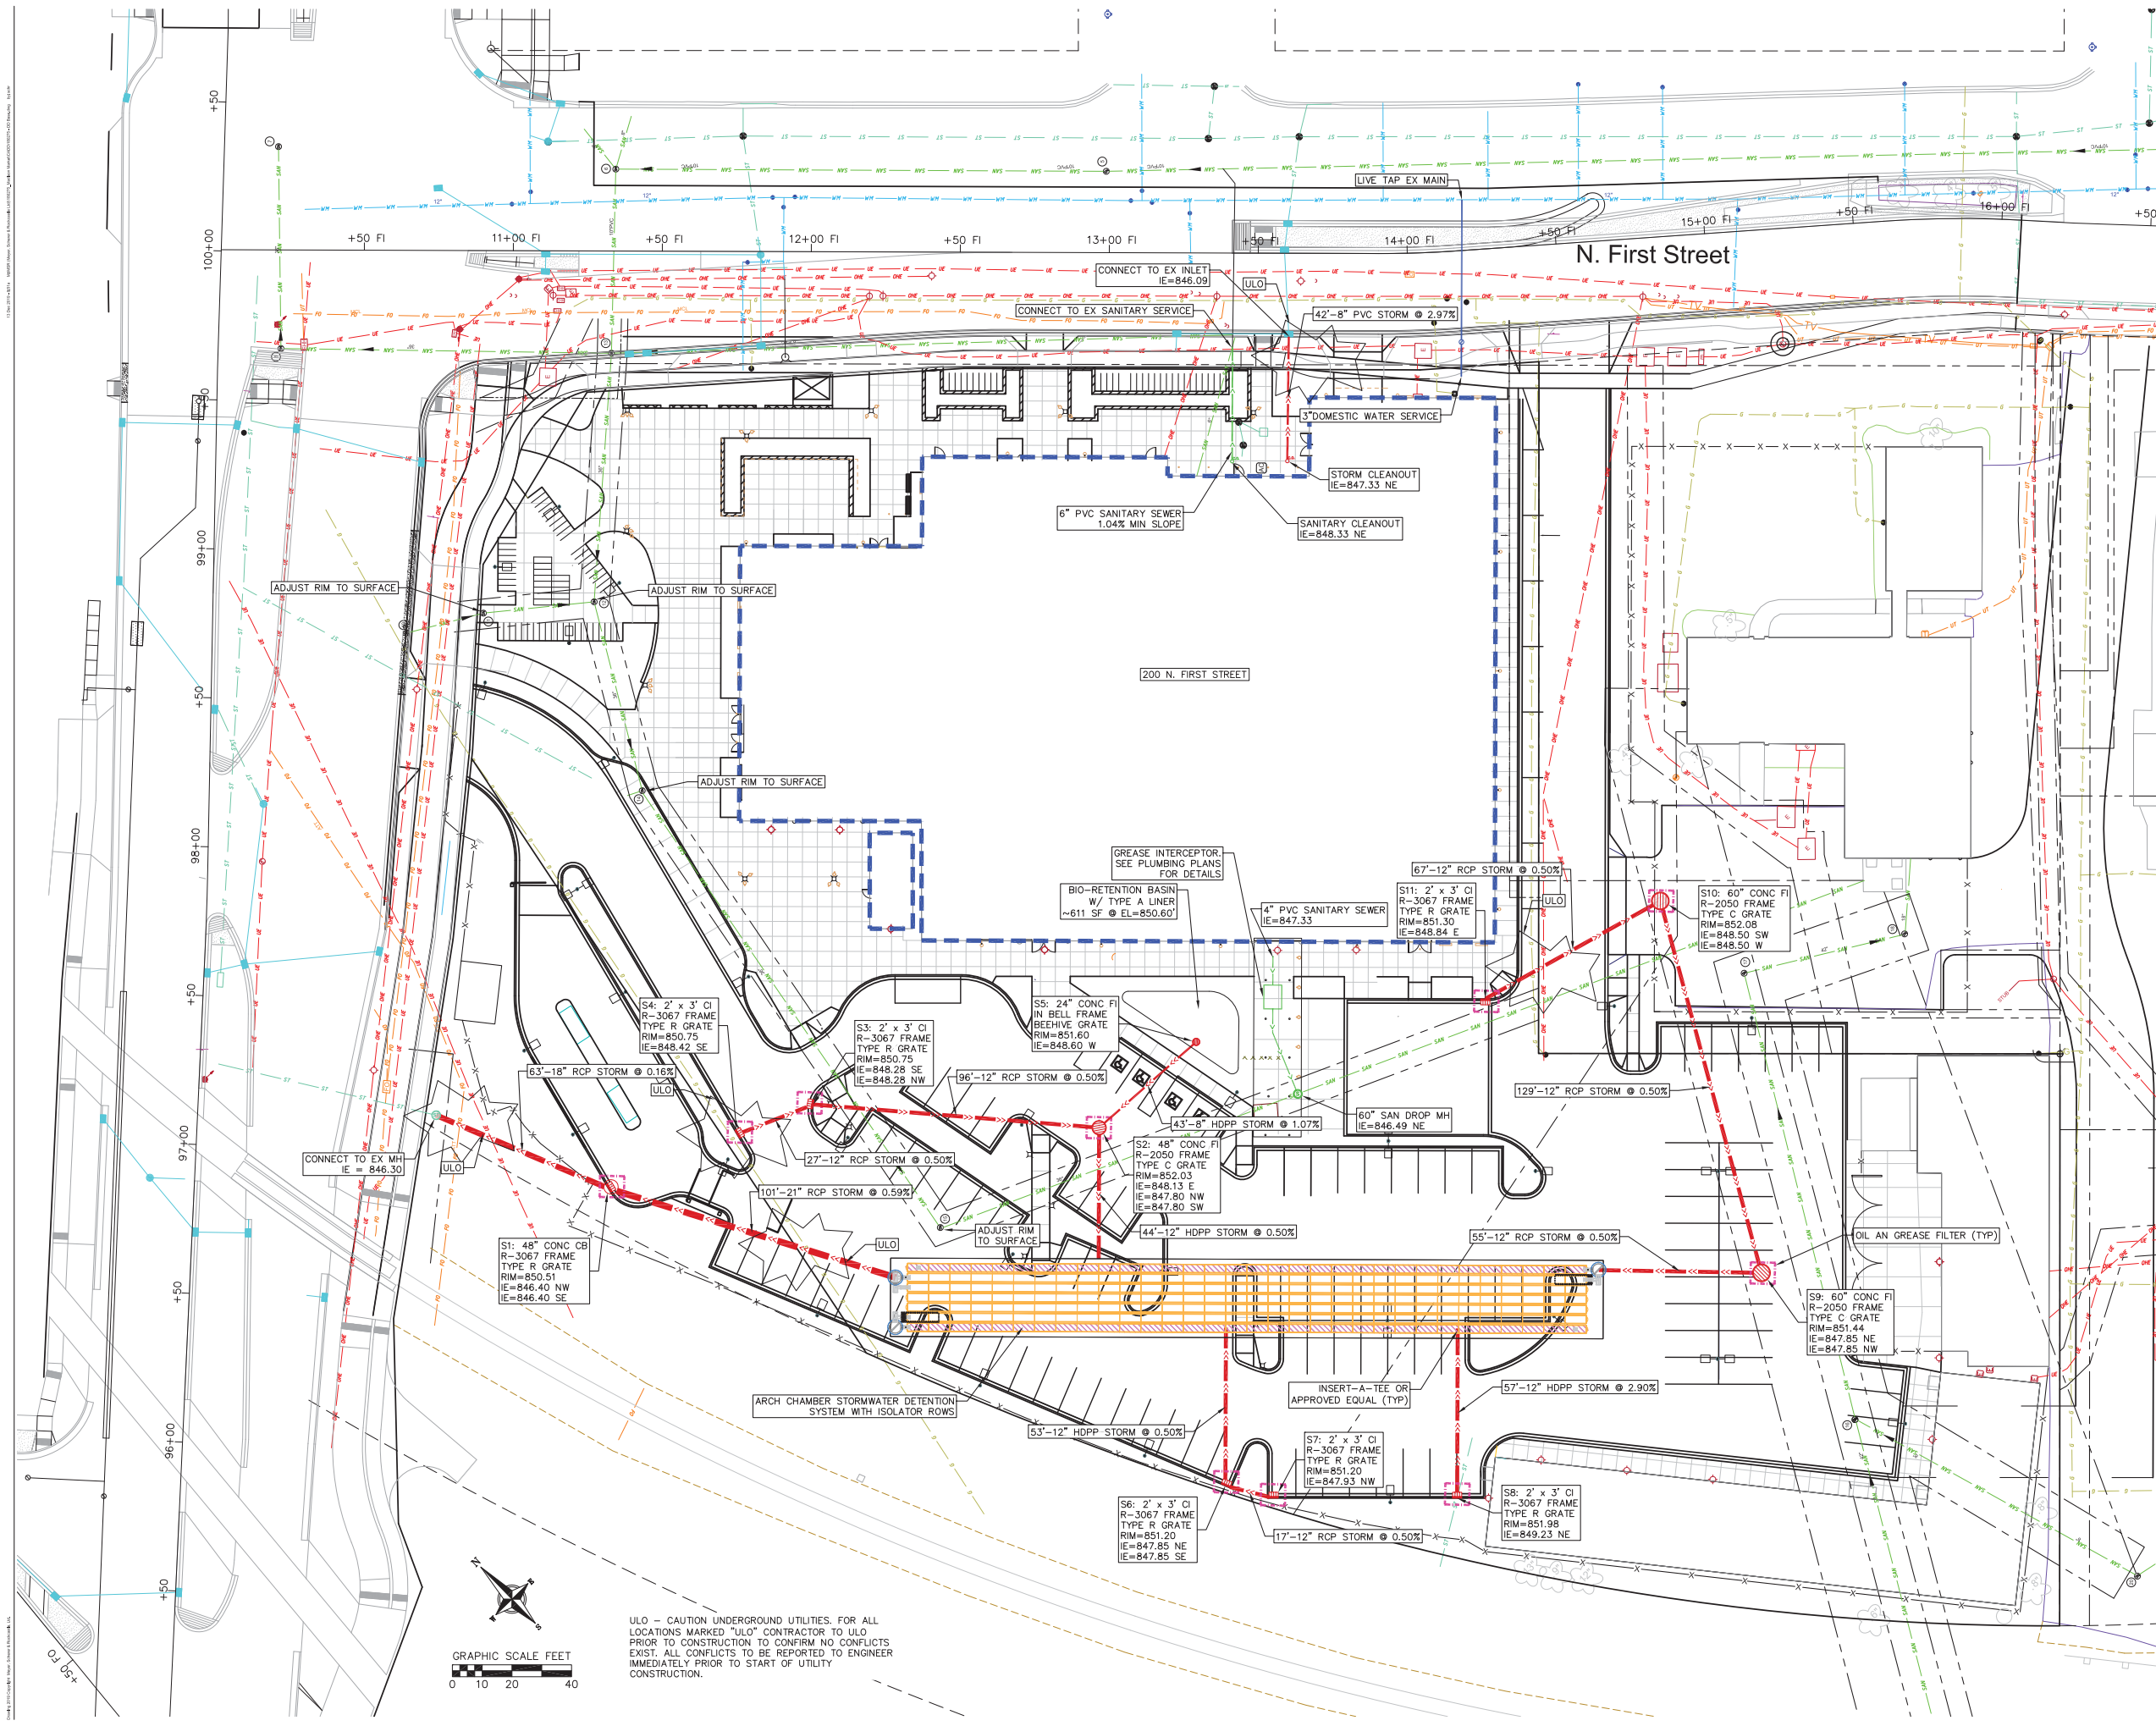
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11.13.2019	11.13.2019	100% CDP DOCUMENTS

PROJECT NO.	2019006.00
PROJECT PHASE	100% CDP DOCUMENTS
DRAWN BY:	SCHR
CHECKED BY:	MSCH/TSCH

EROSION CONTROL PLAN

C-201

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ARCHITECTURE AND INTERIORS

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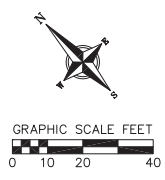
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04	11.13.2019	100% CDP DOCUMENTS

PROJECT NO: 2019006.00
PROJECT PHASE: 100% CDP DOCUMENTS
DRAWN BY: SCHR CHECKED BY: MSCH/TSCH
Drawn by: Schermerhorn, Schermerhorn & Associates, LLC

UTILITY PLAN

C-301



U/L/O - CAUTION UNDERGROUND UTILITIES. FOR ALL LOCATIONS MARKED "U/L/O" CONTRACTOR TO U/L/O PRIOR TO CONSTRUCTION TO CONFIRM NO CONFLICTS EXIST. ALL CONFLICTS TO BE REPORTED TO ENGINEER IMMEDIATELY PRIOR TO START OF UTILITY CONSTRUCTION.


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EROSION CONTROL MEASURES

1. EROSION CONTROL SHALL BE IN ACCORDANCE WITH THE CITY OF MADISON EROSION CONTROL ORDINANCE AND CHAPTER NR 216 OF THE WISCONSIN ADMINISTRATIVE CODE.
2. CONSTRUCT AND MAINTAIN ALL EROSION AND SEDIMENT CONTROL MEASURES IN ACCORDANCE WITH WISCONSIN DNR TECHNICAL STANDARDS (<http://dnr.wi.gov/runoff/stormwater/techstds.htm>) AND WISCONSIN CONSTRUCTION SITE BEST MANAGEMENT PRACTICE HANDBOOK.
3. INSTALL SEDIMENT CONTROL PRACTICES (TRACKING PAD, PERIMETER SILT FENCE, SEDIMENT BASINS, ETC.) PRIOR TO INITIATING OTHER LAND DISTURBING CONSTRUCTION ACTIVITIES.
4. THE CONTRACTOR IS REQUIRED TO MAKE EROSION CONTROL INSPECTIONS AT THE END OF EACH WEEK AND WHEN 0.5 INCHES OF RAIN FALLS WITHIN 24 HOURS. INSPECTION REPORTS SHALL BE PREPARED AND FILED AS REQUIRED BY THE DNR AND/OR CITY. ALL MAINTENANCE WILL FOLLOW AN INSPECTION WITHIN 24 HOURS.
5. EROSION CONTROL IS THE RESPONSIBILITY OF THE CONTRACTOR UNTIL ACCEPTANCE OF THIS PROJECT. EROSION CONTROL MEASURES AS SHOWN SHALL BE THE MINIMUM PRECAUTIONS THAT WILL BE ALLOWED. ADDITIONAL EROSION CONTROL MEASURES, AS REQUESTED IN WRITING BY THE STATE OR LOCAL INSPECTORS, OR THE DEVELOPER'S ENGINEER, SHALL BE INSTALLED WITHIN 24 HOURS.
6. A 3" CLEAR STONE TRACKING PAD SHALL BE INSTALLED AT THE END OF ROAD CONSTRUCTION LIMITS TO PREVENT SEDIMENT FROM BEING TRACKED ONTO THE ADJACENT PAVED PUBLIC ROADWAY. SEDIMENT TRACKING PAD SHALL CONFORM TO WisDNR TECHNICAL STANDARD 1057. SEDIMENT REACHING THE PUBLIC ROAD SHALL BE REMOVED BY STREET CLEANING (NOT HYDRAULIC FLUSHING) BEFORE THE END OF EACH WORK DAY.
7. CHANNELIZED RUNOFF: FROM ADJACENT AREAS PASSING THROUGH THE SITE SHALL BE DIVERTED AROUND DISTURBED AREAS.
8. STABILIZED DISTURBED GROUND: ANY SOIL OR DIRT PILES WHICH WILL REMAIN IN EXISTENCE FOR MORE THAN 7-CONSECUTIVE DAYS, WHETHER TO BE WORKED DURING THAT PERIOD OR NOT, SHALL NOT BE LOCATED WITHIN 25-FEET OF ANY ROADWAY, PARKING LOT, PAVED AREA, OR DRAINAGE STRUCTURE OR CHANNEL (UNLESS INTENDED TO BE USED AS PART OF THE EROSION CONTROL MEASURES). TEMPORARY STABILIZATION AND CONTROL MEASURES (SEEDING, MULCHING, TARPING, EROSION MATTING, BARRIER FENCING, ETC.) ARE REQUIRED FOR THE PROTECTION OF DISTURBED AREAS AND SOIL PILES, WHICH WILL REMAIN UN-WORKED FOR A PERIOD OF MORE THAN 14-CONSECUTIVE CALENDAR DAYS. THESE MEASURES SHALL REMAIN IN PLACE UNTIL SITE HAS STABILIZED.
9. SITE DE-WATERING: WATER PUMPED FROM THE SITE SHALL BE TREATED BY TEMPORARY SEDIMENTATION BASINS OR OTHER APPROPRIATE CONTROL MEASURES. SEDIMENTATION BASINS SHALL HAVE A DEPTH OF AT LEAST 3 FEET, BE SURROUNDED BY SNOWFENCE OR EQUIVALENT BARRIER AND HAVE SUFFICIENT SURFACE AREA TO PROVIDE A SURFACE SETTLING RATE OF NO MORE THAN 750 GALLONS PER SQUARE FOOT PER DAY AT THE HIGHEST DEWATERING PUMPING RATE. WATER MAY NOT BE DISCHARGED IN A MANNER THAT CAUSES EROSION OF THE SITE, A NEIGHBORING SITE, OR THE BED OR BANKS OF THE RECEIVING WATER. POLYMERS MAY BE USED AS DIRECTED BY DNR TECHNICAL STANDARD 1061 (DE-WATERING).
10. IN NO CASE WILL RIP-RAP BE SMALLER THAN 3" TO 6".
11. INLET FILTERS ARE TO BE PLACED IN STORMWATER INLET STRUCTURES AS SOON AS THEY ARE INSTALLED. ALL PROJECT AREA STORM INLETS NEED WISCONSIN D.O.T. TYPE D INLET PROTECTION. THE FILTERS SHALL BE MAINTAINED UNTIL THE CITY HAS ACCEPTED THE BINDER COURSE OF ASPHALT.
12. RESTORATION (SEED, FERTILIZE AND MULCH) SHALL BE PER SPECIFICATIONS ON THIS SHEET UNLESS SPECIAL RESTORATION IS CALLED FOR ON THE LANDSCAPE PLAN.
13. TERRACES SHALL BE RESTORED WITH 6" TOPSOIL, PERMANENT SEED, FERTILIZER AND MULCH. LOTS SHALL BE RESTORED WITH 6" TOPSOIL, TEMPORARY SEED, FERTILIZER AND MULCH.
14. SEED, FERTILIZER AND MULCH SHALL BE APPLIED WITHIN 7 DAYS AFTER FINAL GRADE HAS BEEN ESTABLISHED. IF DISTURBED AREAS WILL NOT BE RESTORED IMMEDIATELY AFTER ROUGH GRADING, TEMPORARY SEED SHALL BE PLACED.
15. FOR THE FIRST SIX WEEKS AFTER RESTORATION (E.G. SEED & MULCH, EROSION MAT, SOD) OF A DISTURBED AREA, INCLUDE SUMMER WATERING PROVISIONS OF ALL NEWLY SEEDED AND MULCHED AREAS WHENEVER 7 DAYS ELAPSE WITHOUT A RAIN EVENT.
16. EROSION MAT (CLASS I, TYPE A URBAN PER WISCONSIN D.O.T. P.A.L.) SHALL BE INSTALLED ON ALL SLOPES 3:1 OR GREATER BUT LESS THAN 1:1.
17. SILT FENCE OR EROSION MAT SHALL BE INSTALLED ALONG THE CONTOURS AT 100 FOOT INTERVALS DOWN THE SLOPE ON THE DISTURBED SLOPES STEEPER THAN 5% AND MORE THAN 100 FEET LONG THAT SHEET FLOW TO THE ROADWAY UNLESS SOIL STABILIZERS ARE USED.
18. SILT FENCE TO BE USED ACROSS AREAS OF THE LOT THAT SLOPE TOWARDS A PUBLIC STREET OR WATERWAY. SEE DETAILS.
19. SEDIMENT SHALL BE CLEANED FROM CURB AND GUTTER AFTER EACH RAINFALL AND PRIOR TO PROJECT ACCEPTANCE.
20. ACCUMULATED CONSTRUCTION SEDIMENT SHALL BE REMOVED FROM ALL PERMANENT BASINS TO THE ELEVATION SHOWN ON THE GRADING PLAN FOLLOWING THE STABILIZATION OF DRAINAGE AREAS.
21. ANY PROPOSED CHANGES TO THE EROSION CONTROL PLAN MUST BE SUBMITTED AND APPROVED BY THE CITY OF MADISON AND DNR.
22. THE CITY, OWNER AND/OR ENGINEER MAY REQUIRE ADDITIONAL EROSION CONTROL MEASURES AT ANY TIME DURING CONSTRUCTION.

CONSTRUCTION SEQUENCE:


1. INSTALL EROSION CONTROL MEASURES
2. CONDUCT DEMOLITION
3. STRIP TOPSOIL (UNWORKED AREAS MAY REMAIN NON-STABILIZED FOR A MAXIMUM OF 14 DAYS)
4. ROUGH GRADE SITE
5. CONSTRUCT UNDERGROUND UTILITIES
6. INSTALL INLET PROTECTION IN NEW INLETS
7. CONSTRUCT PAVEMENT
8. FINAL GRADE AND RESTORE DISTURBED AREA
9. REMOVE EROSION CONTROL MEASURES AFTER DISTURBED AREAS ARE 70% RESTORED OR PAVED.

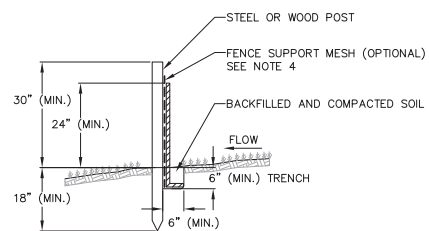


1 SILT FENCE
NOT TO SCALE

NOTES:

1. INSTALL SILT FENCE TO FOLLOW THE GROUND CONTOURS AS CLOSELY AS POSSIBLE. SEE NOTE 4
2. CURVE THE SILT FENCE UP THE SLOPE TO PREVENT WATER FROM RUNNING AROUND THE ENDS.
3. POST SPACING WITH FENCE SUPPORT MESH = 10 FT. (MAX.)
POST SPACING WITHOUT FENCE SUPPORT MESH = 6 FT. (MAX.)
4. SILT FENCE SUPPORT MESH CONSISTS OF 14-GAUGE STEEL WIRE WITH A MESH SPACING OF 6 IN. X 6 IN. OR PREFABRICATED POLYMERIC MESH OF EQUIVALENT STRENGTH

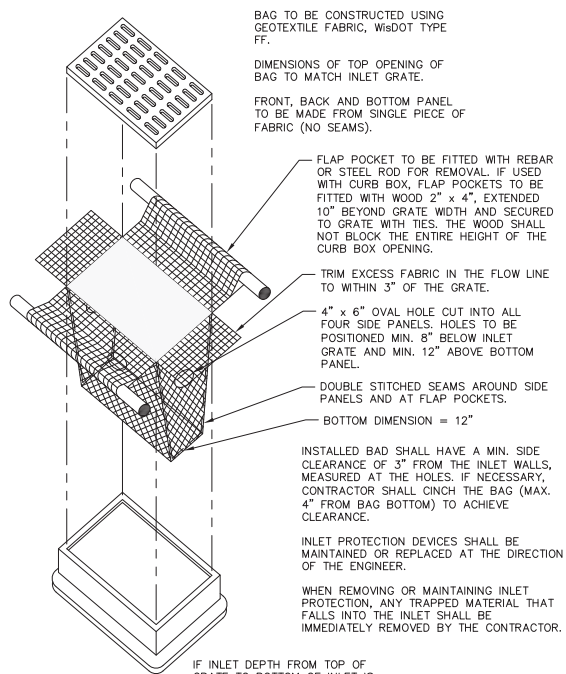


2 INLET PROTECTION TYPE D
NOT TO SCALE

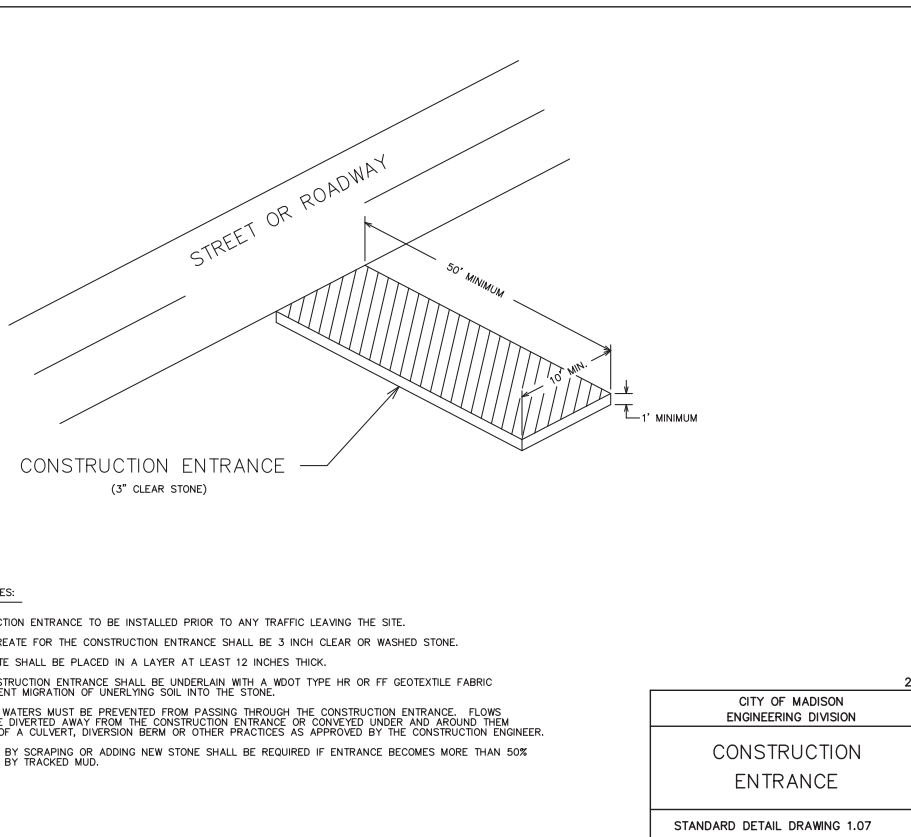

GENERAL NOTES:

1. CONSTRUCTION ENTRANCE TO BE INSTALLED PRIOR TO ANY TRAFFIC LEAVING THE SITE.
2. THE AGGREGATE FOR THE CONSTRUCTION ENTRANCE SHALL BE 3 INCH CLEAR OR WASHED STONE.
3. AGGREGATE SHALL BE PLACED IN A LAYER AT LEAST 12 INCHES THICK.
4. THE CONSTRUCTION ENTRANCE SHALL BE UNDERLAIN WITH A WOOL TYPE HR OR FF GEOTEXTILE FABRIC TO PREVENT MIGRATION OF UNDERLYING SOIL INTO THE STONE.
5. SURFACE WATERS MUST BE PREVENTED FROM PASSING THROUGH THE CONSTRUCTION ENTRANCE. FLOWS SHALL BE DIVERTED AWAY FROM THE CONSTRUCTION ENTRANCE OR CONVEYED UNDER AND AROUND THEM BY USE OF A CULVERT, DIVERSION BEAM OR OTHER PRACTICES AS APPROVED BY THE CONSTRUCTION ENGINEER.
6. CLEANING BY SCRAPING OR ADDING NEW STONE SHALL BE REQUIRED IF ENTRANCE BECOMES MORE THAN 50% COVERED BY TRACKED MUD.

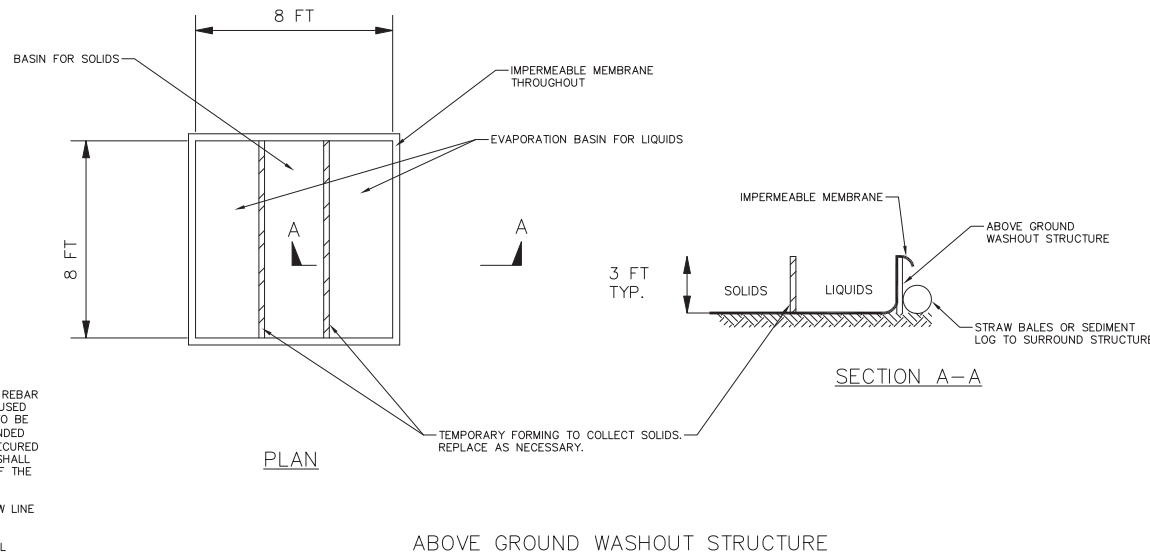

CONSTRUCTION SPECIFICATIONS

1. WASHOUT STRUCTURE SHALL MEET THE REQUIREMENTS OF THE ABOVE DETAIL OR AS APPROVED BY THE ENGINEER.
2. LOCATE WASHOUT STRUCTURE A MINIMUM OF 50 FEET AWAY FROM OPEN CHANNELS, STORM DRAIN INLETS, SENSITIVE AREAS, WETLANDS, BUFFERS AND WATER COURSES AND AWAY FROM CONSTRUCTION TRAFFIC.
3. PREPARE BASE TO BE FREE OF ROCKS OR OTHER DEBRIS THAT MAY CAUSE TEARS OR HOLES IN THE LINER. FOR LINER, USE 10 MIL OR THICKER UV RESISTANT, IMPERMEABLE SHEETING, FREE OF HOLES AND TEARS OR OTHER DEFECTS THAT COMPROMISE IMPERMEABILITY OF THE MATERIAL.
4. KEEP CONCRETE WASHOUT STRUCTURE WATER TIGHT. REPLACE IMPERMEABLE LINER IF DAMAGED (E.G., RIPPED OR PUNCTURED). EMPTY OR REPLACE WASHOUT STRUCTURE THAT IS 75 PERCENT FULL, AND DISPOSE OF ACCUMULATED MATERIAL PROPERLY. DO NOT REUSE PLASTIC LINER. WET-VACUUM STORED LIQUIDS THAT HAVE NOT EVAPORATED AND DISPOSE OF IN AN APPROVED MANNER. REMOVE HARDENED SOLIDS, WHOLE OR BROKEN UP, FOR DISPOSAL OR RECYCLING. MAINTAIN RUNOFF DIVERSION AROUND EXCAVATED WASHOUT STRUCTURE UNTIL STRUCTURE IS REMOVED.

3 TEMPORARY CONCRETE WASHOUT (ABOVE GROUND)
NOT TO SCALE

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I hereby certify that this plan, specification or report was prepared by me or under my direct supervision and that I am a duly Licensed Architect under the laws of the State of Minnesota. ARCHITECT SEAL

Signature: _____
Print Name: _____
Date: _____ License No: _____

ISSUE	DATE	DESCRIPTION
06.04.2019	06.04.2019	010% BUILDING DESIGN 1 PRICING ISSUE
06.12.2019	06.12.2019	100% INFORMATIONAL SUBMISSION
08.16.2019	08.16.2019	010% BUILDING DESIGN 2 PRICING ISSUE
11.13.2019	11.13.2019	100% CDP DOCUMENTS


PROJECT NO. 2019006.00

PROJECT PHASE 100% CDP DOCUMENTS


DRAWN BY: SCHR CHECKED BY: MSCH/TSCH

**CONSTRUCTION
DETAILS - 1**


C-401

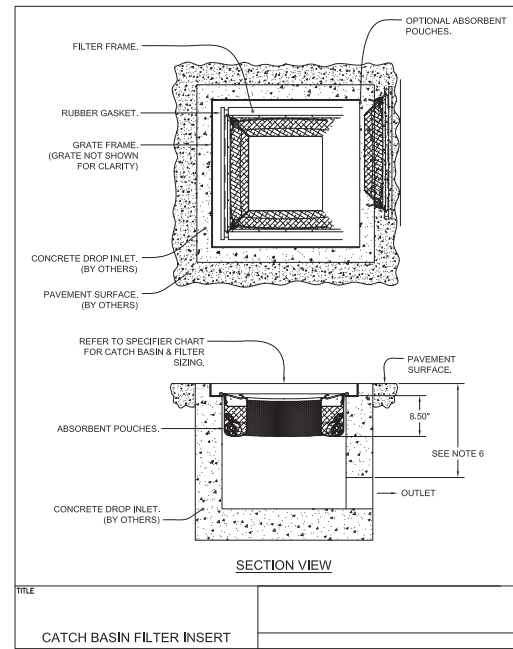


1 **STORM INLET OIL FILTER**
402 NOT TO SCALE

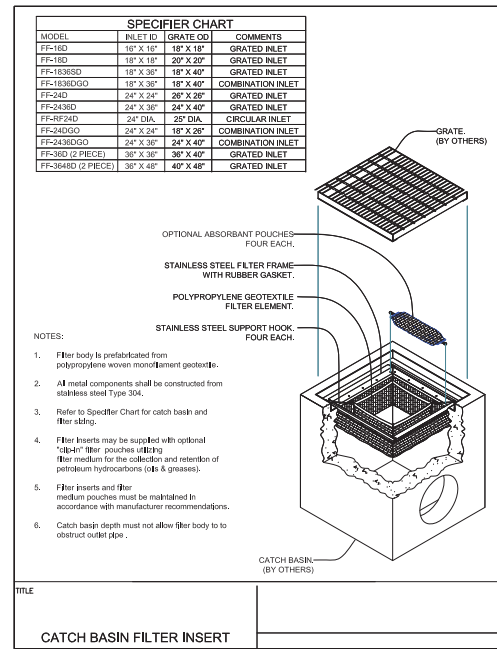


CATCH BASIN FILTER INSERT

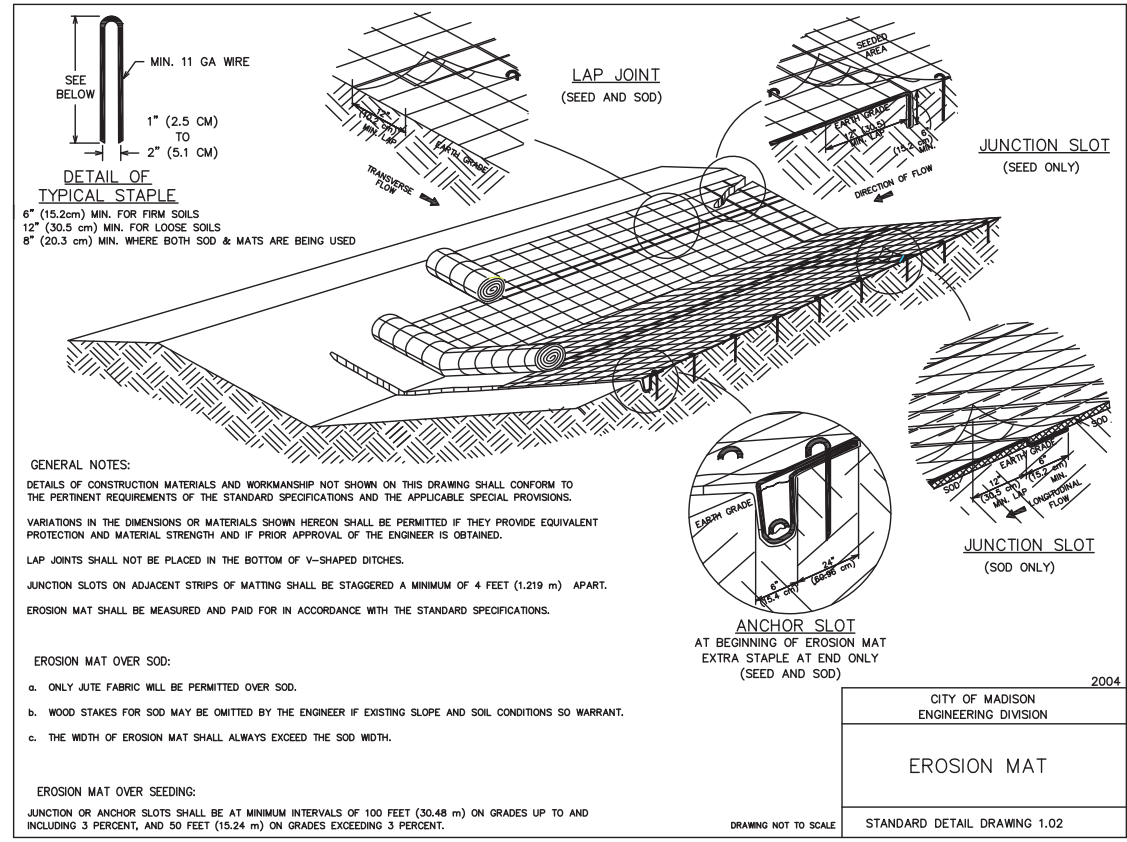

CITY OF MADISON ENGINEERING DIVISION
EROSION MAT
STANDARD DETAIL DRAWING 1.02

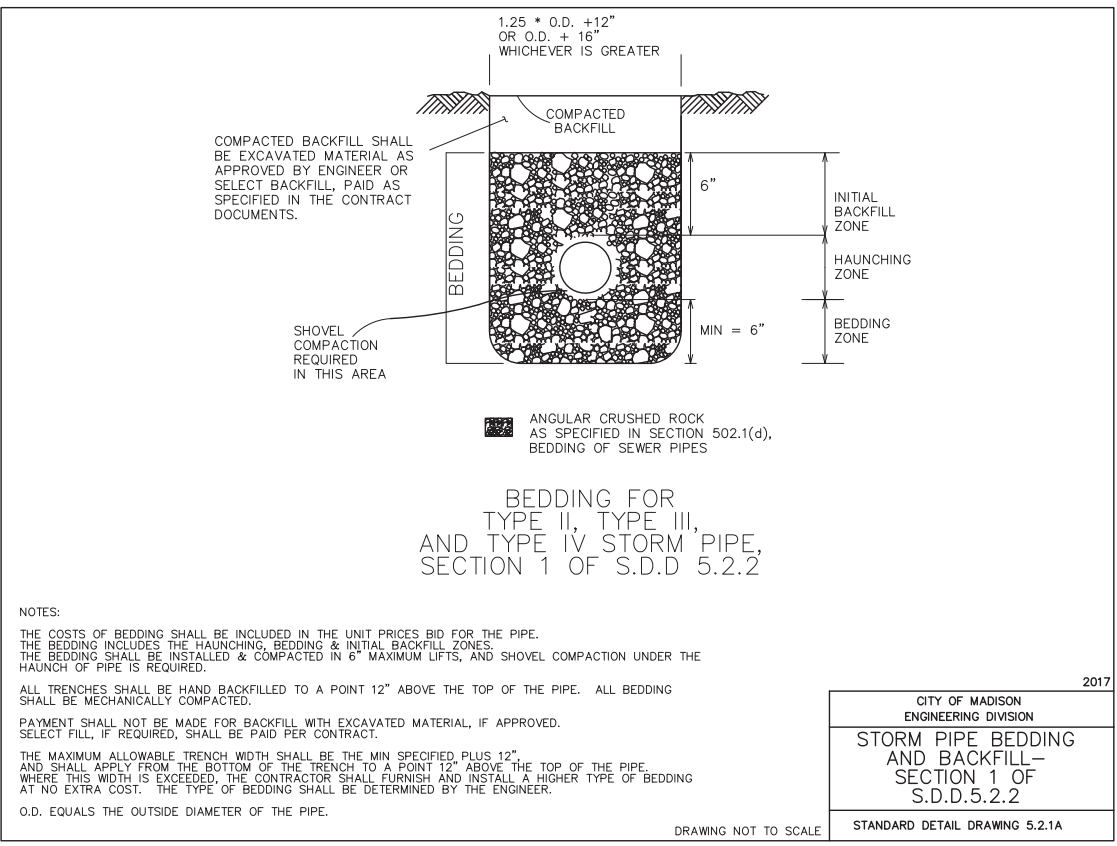

CITY OF MADISON ENGINEERING DIVISION
STORM PIPE BEDDING AND BACKFILL - SECTION 1 OF S.D.D. 5.2.1A
STANDARD DETAIL DRAWING 5.2.1A

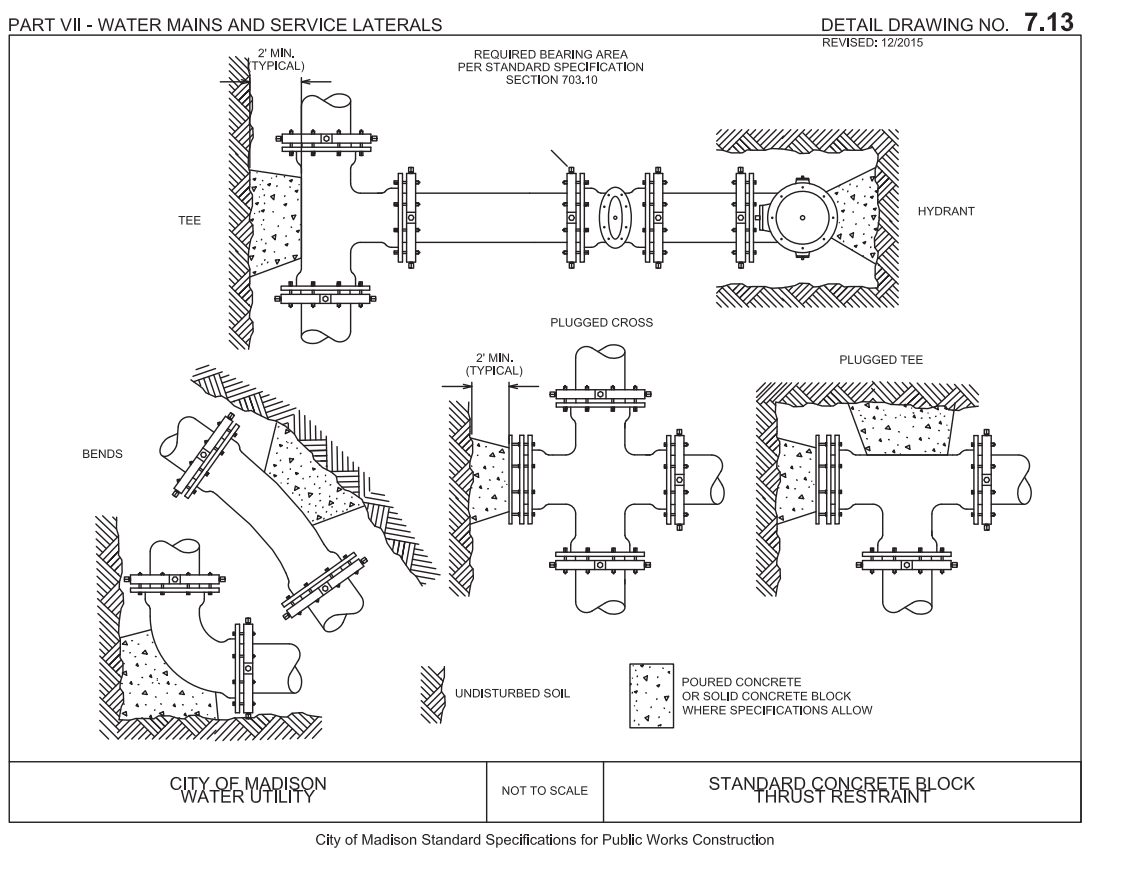

CITY OF MADISON WATER UTILITY
NOT TO SCALE
STANDARD CONCRETE BLOCK THRUST RESTRAINT
City of Madison Standard Specifications for Public Works Construction

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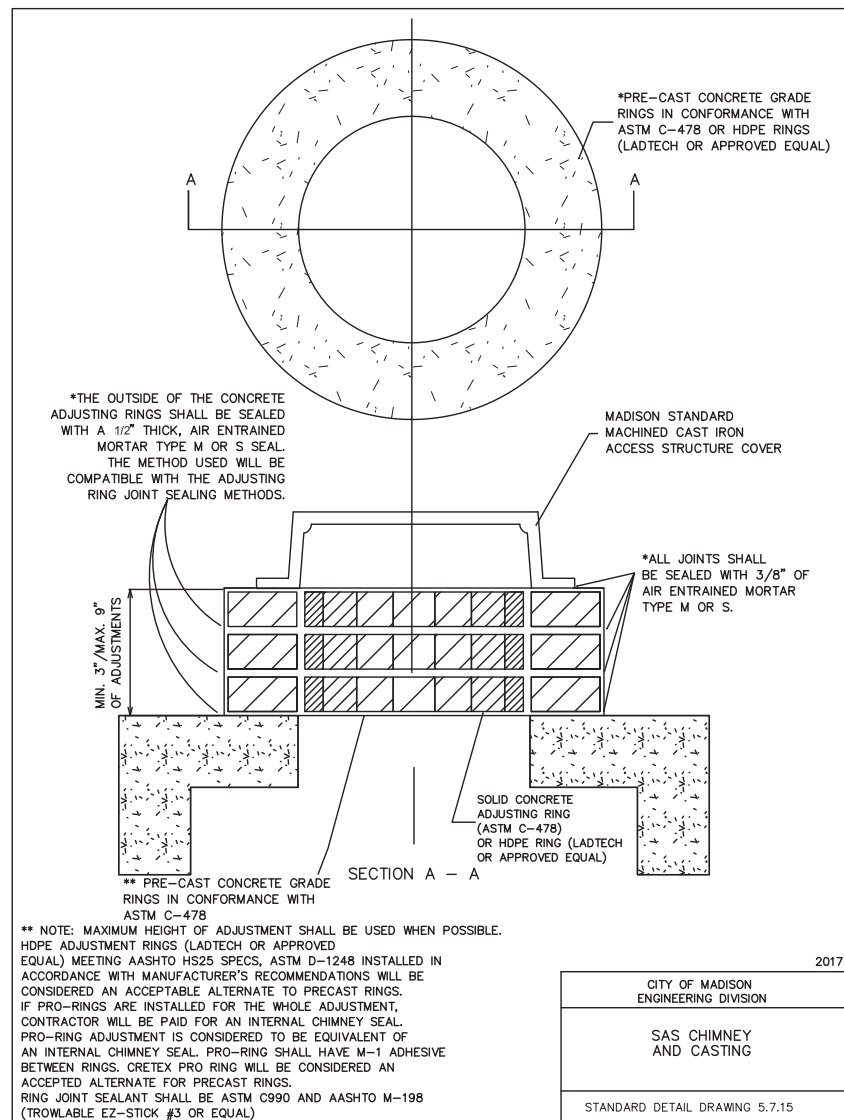
MADISON PUBLIC MARKET
 200 N First St, Madison, WI 53704

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 Print Name: _____
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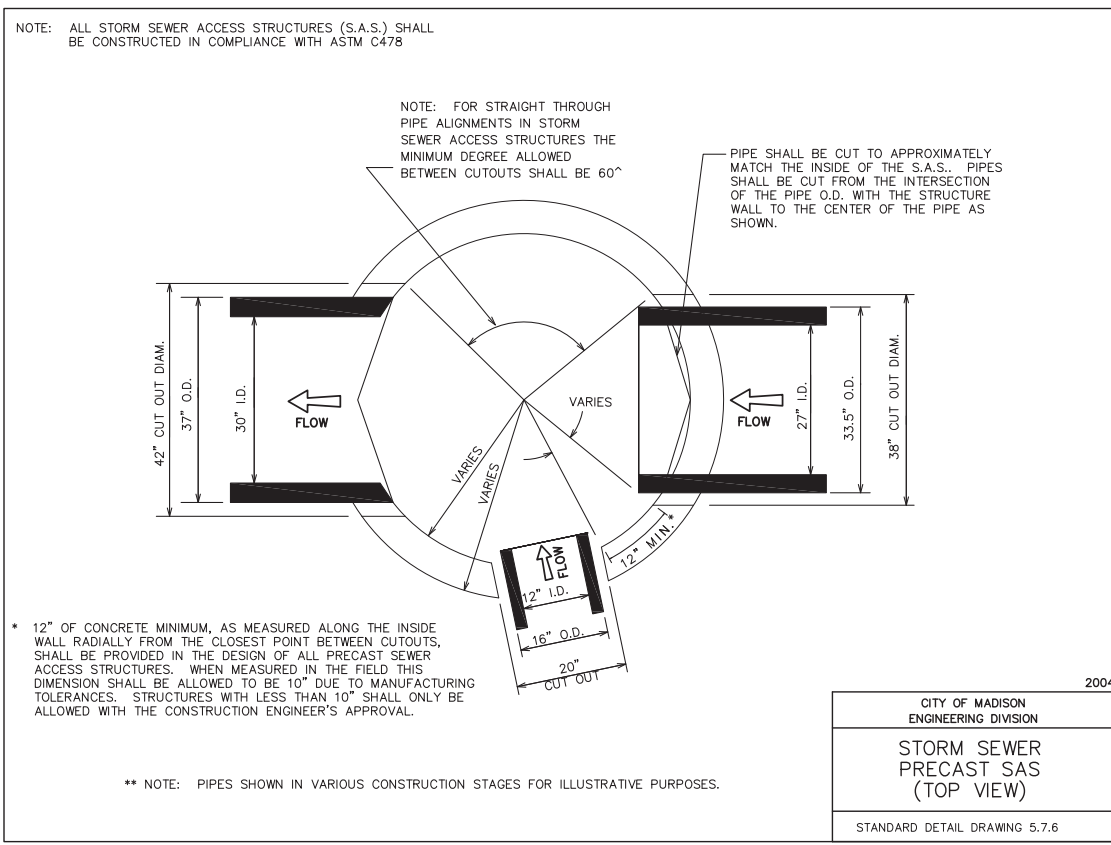
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	06.12.2015	02C INFORMATIONAL SUBMISSION
	06.16.2015	01 - BUILDING DESIGN 2 PRICING ISSUE
	11.13.2019	100% CDP DOCUMENTS

PROJECT NO. 2019006.00
 PROJECT PHASE 100% CDP DOCUMENTS
 DRAWN BY: SCHR CHECKED BY: MSCHT/SCH
 06/2017 Update: New, Scales & Blocks, etc.


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C-402




2017
CITY OF MADISON ENGINEERING DIVISION
SAS CHIMNEY AND CASTING
STANDARD DETAIL DRAWING 5.7.15



2004
CITY OF MADISON ENGINEERING DIVISION
STORM SEWER PRECAST SAS (TOP VIEW)
STANDARD DETAIL DRAWING 5.7.6

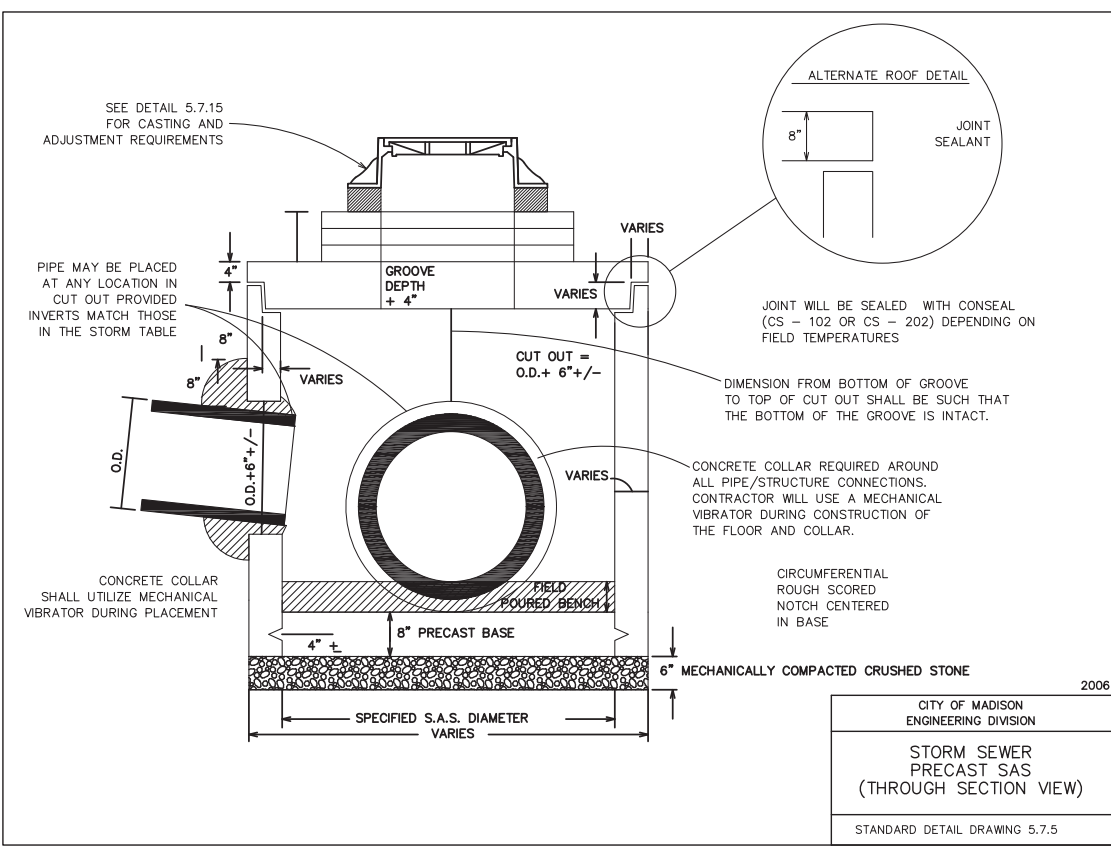

2006
CITY OF MADISON ENGINEERING DIVISION
STORM SEWER PRECAST SAS (THROUGH SECTION VIEW)
STANDARD DETAIL DRAWING 5.7.5

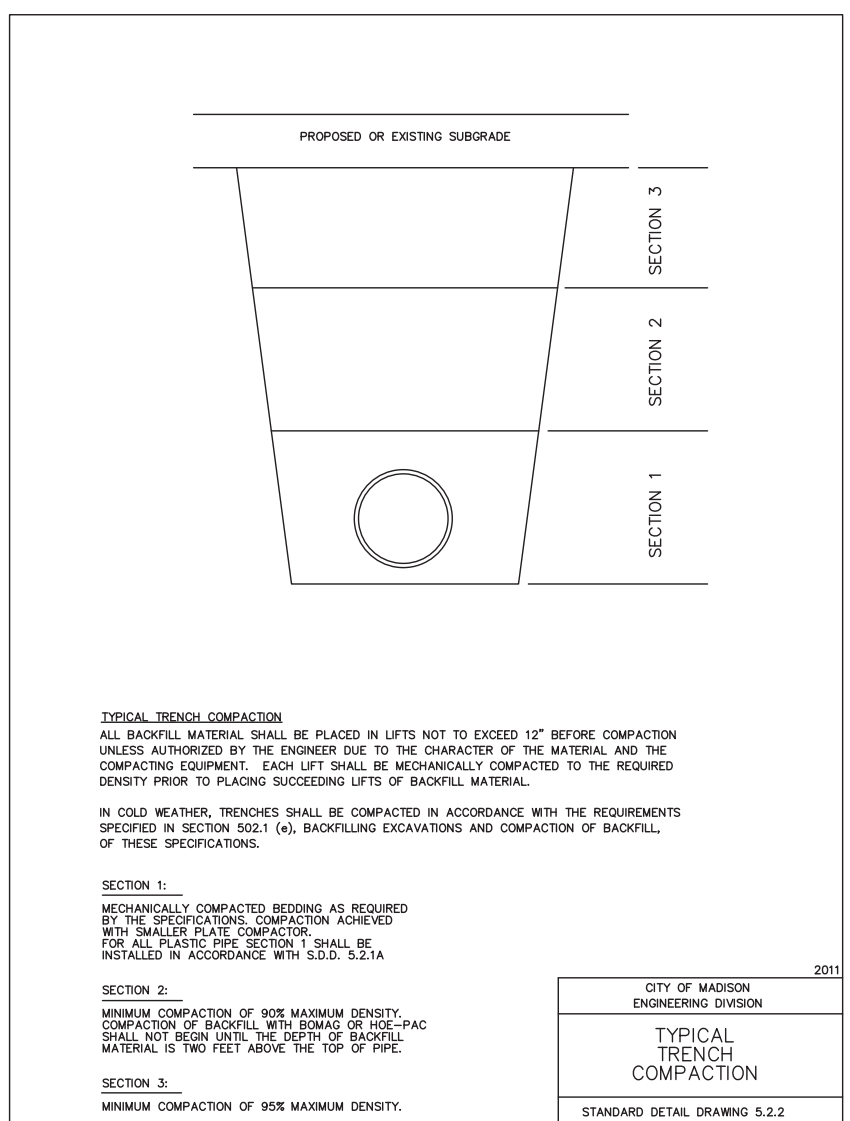

2011
CITY OF MADISON ENGINEERING DIVISION
TYPICAL TRENCH COMPACTION
STANDARD DETAIL DRAWING 5.2.2

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Signature: _____
Print Name: _____
Date: _____ License No: _____

ISSUE	DATE	DESCRIPTION
06.04.2019	06.04.2019	06.04.2019 SITE & BUILDING DESIGN 1 PIRING ISSUE
06.12.2019	06.12.2019	06.12.2019 LOC INFORMATIONAL SUBMISSION
08.16.2019	08.16.2019	08.16.2019 SITE & BUILDING DESIGN 2 PIRING ISSUE
11.13.2019	11.13.2019	100% CDP DOCUMENTS

PROJECT NO.	2019006.00
PROJECT PHASE	100% CDP DOCUMENTS
DRAWN BY:	SCHR
CHECKED BY:	MSCH/TSCH

**CONSTRUCTION
DETAILS - 4**

C-404

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Print Name: _____
Date: _____ License No: _____


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	06.12.2019	LOC INFORMATIONAL SUBMISSION
	08.16.2019	SITE + BUILDING DESIGN 2 PRICING ISSUE
	11.13.2019	100% CDP DOCUMENTS

PROJECT NO. 2019006.00
PROJECT PHASE 100% CDP DOCUMENTS
DRAWN BY: MSCH/TSCH
CHECKED BY: MSCH/TSCH

CONSTRUCTION
DETAILS - 6

C-406


TECHNICAL SPECIFICATION
WTS

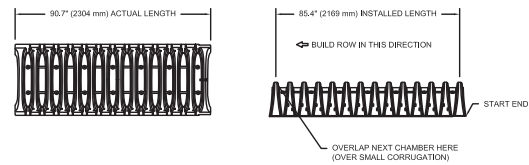

NOMINAL CHAMBER SPECIFICATIONS

SIZE (W X H X INSTALLED LENGTH)	34.0\"/>	
CHAMBER STORAGE	14.7 CUBIC FEET (0.42 m ³)	(864 mm X 406 mm X 2169 mm)
MINIMUM INSTALLED STORAGE*	31.0 CUBIC FEET (0.88 m ³)	
WEIGHT	35.0 lbs. (16.8 kg)	

*ASSUMES 6\"/>

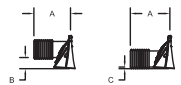

STUB	A	B	C
6\"/>			


ALL STUBS, EXCEPT FOR THE 12\"/>

* FOR THE 12\"/>

NOTE: ALL DIMENSIONS ARE NOMINAL

LEGEND

-  SHORTGRASS PRAIRIE (SEED)
-  SEASONAL ARRANGEMENTS
-  BIORETENTION BASIN (PLUGS)
-  LAWN (SEED)
-  STONE COBBLES

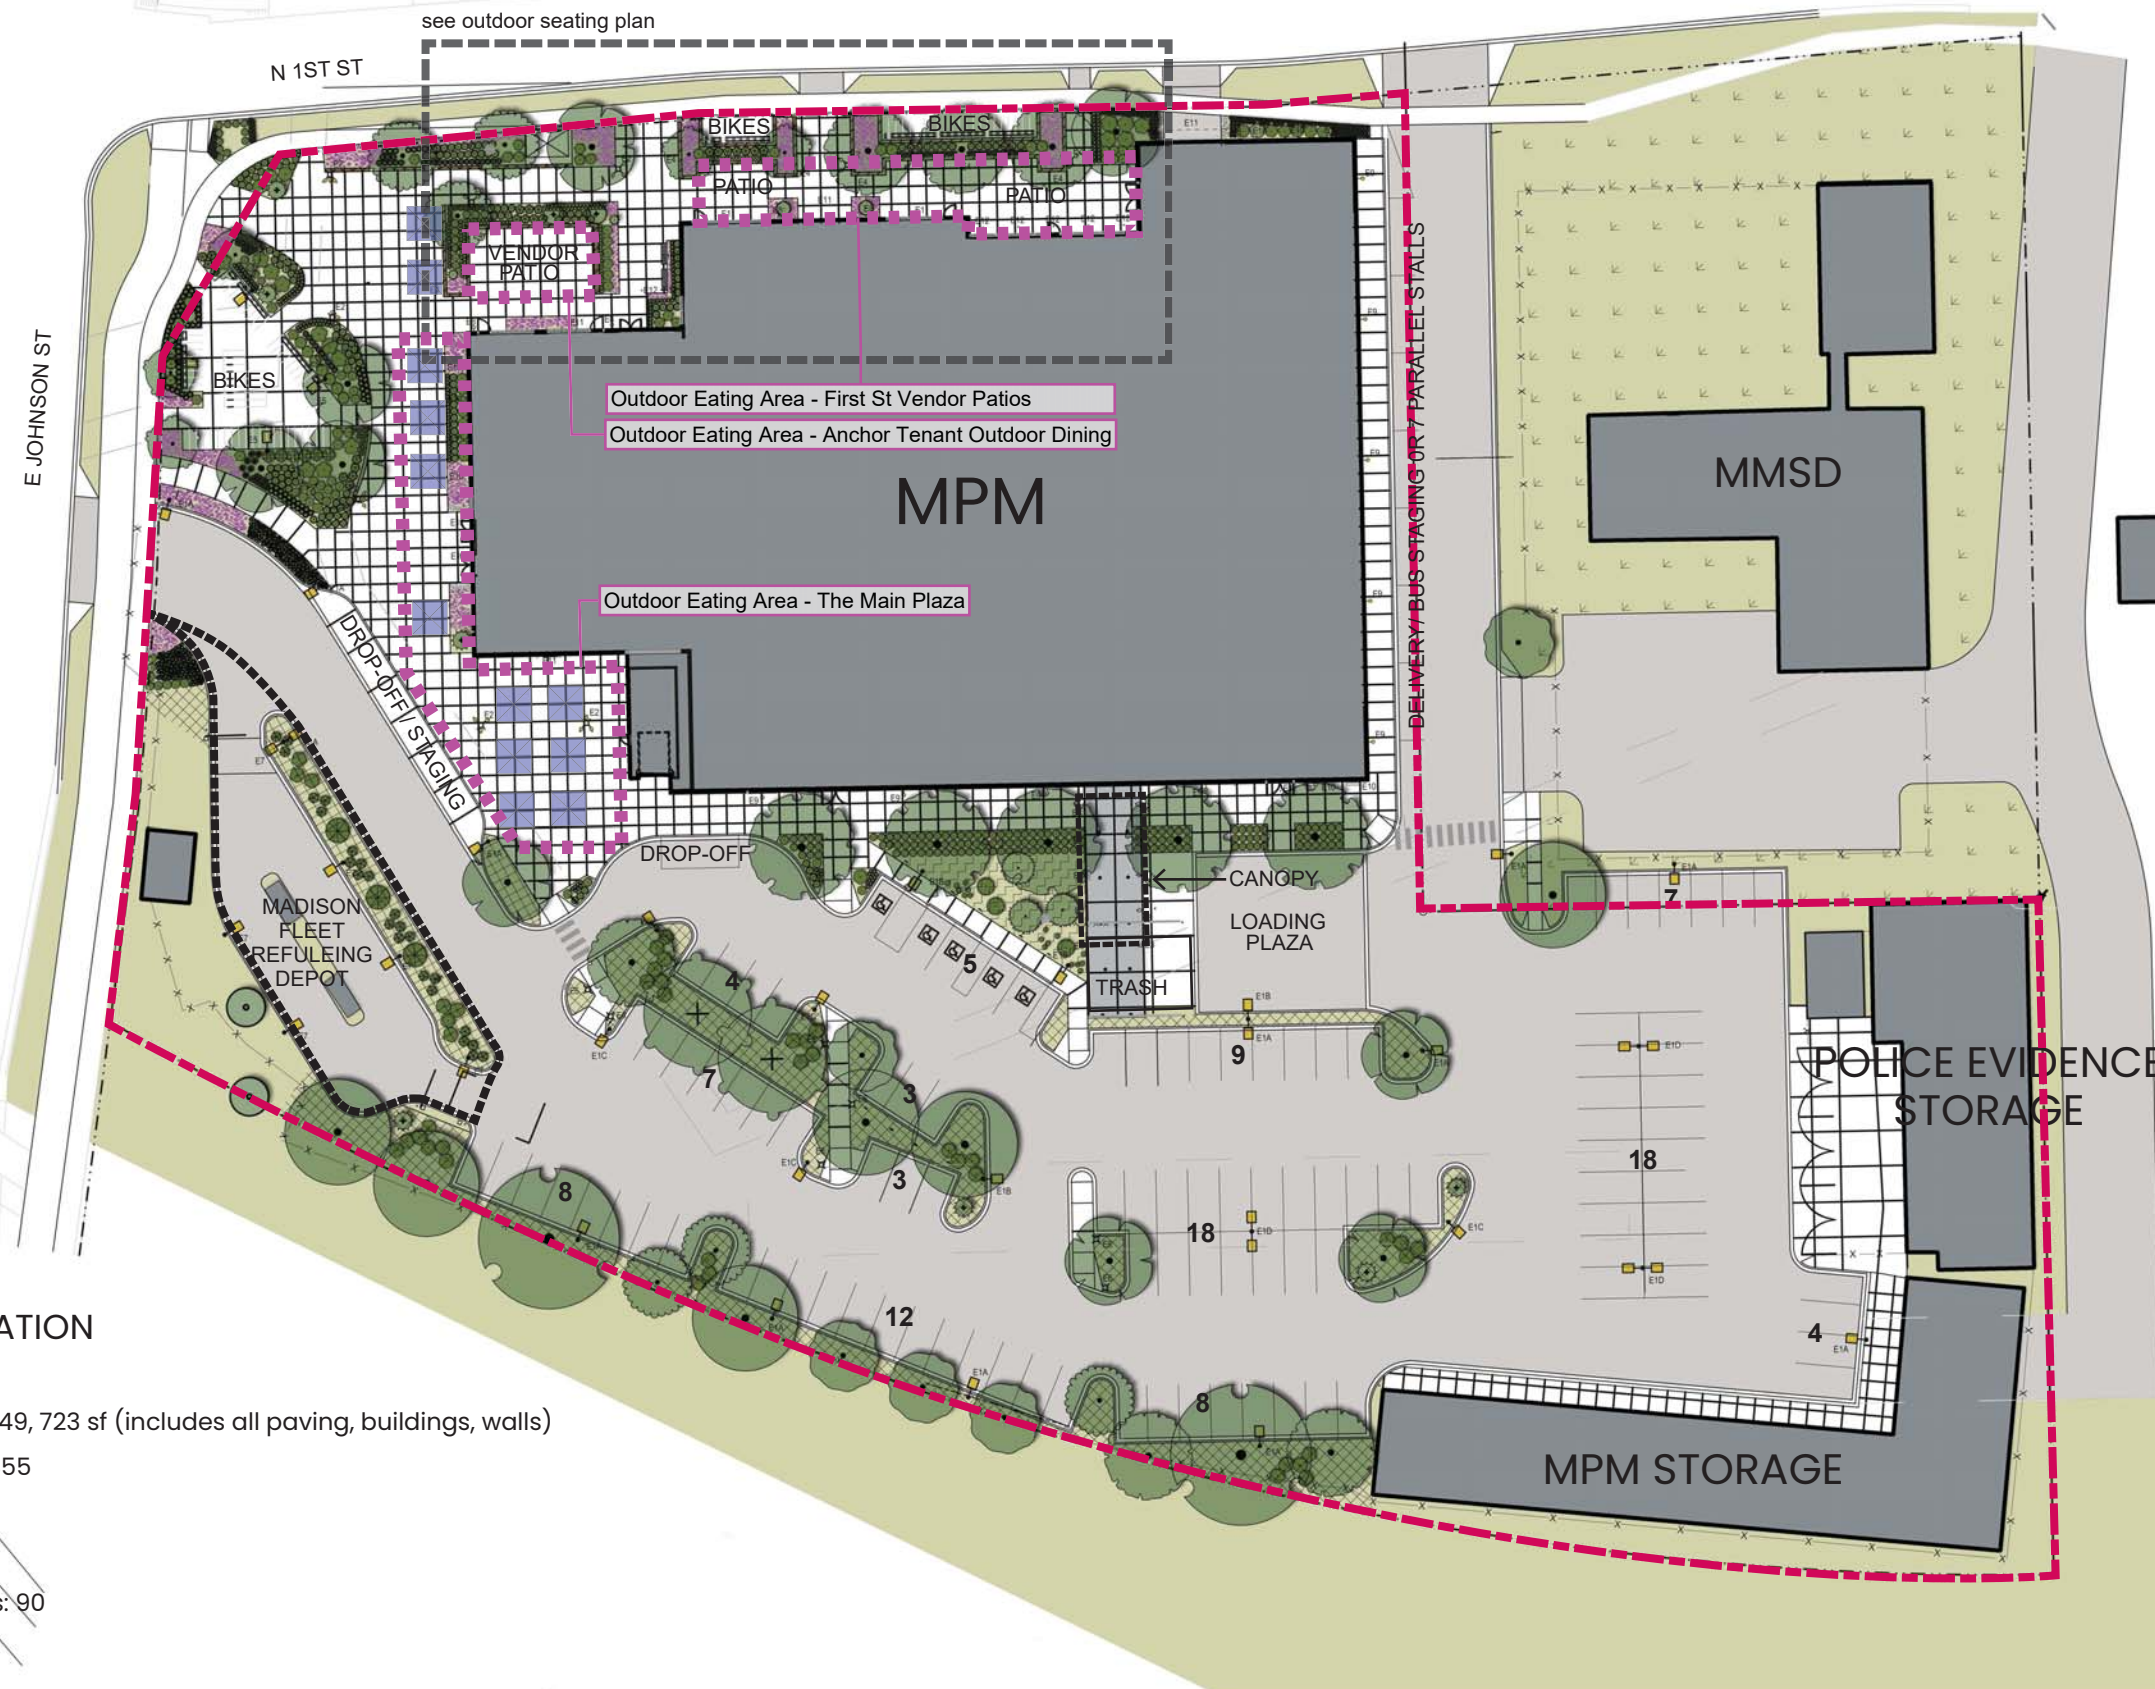

SITE INFORMATION

total sf: 162,578 sf
 impermeable sf: 149, 723 sf (includes all paving, buildings, walls)
 permeable sf: 12,855
 % permeable: 8%
 parking stalls: 113
 bike parking stalls: 90

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Signature: _____
 Print Name: _____
 Date: _____ License No: _____

DATE	DESCRIPTION
08-04-2019	PRELIMINARY DESIGN & PERMITTING
08-12-2019	SCHEMATIC DESIGN SUBMISSION
09-18-2019	SCHEMATIC DESIGN & PERMITTING
11-13-2019	FINAL DESIGN DOCUMENTS

PROJECT NO: 2019006.00
 PROJECT PHASE: SITE AND BUILDING DESIGN 2
 DRAWN BY: SAIKI DESIGN
 CHECKED BY: MSR


LAYOUT PLAN



L-3

outdoor seating plan

N 1st St Patio Areas

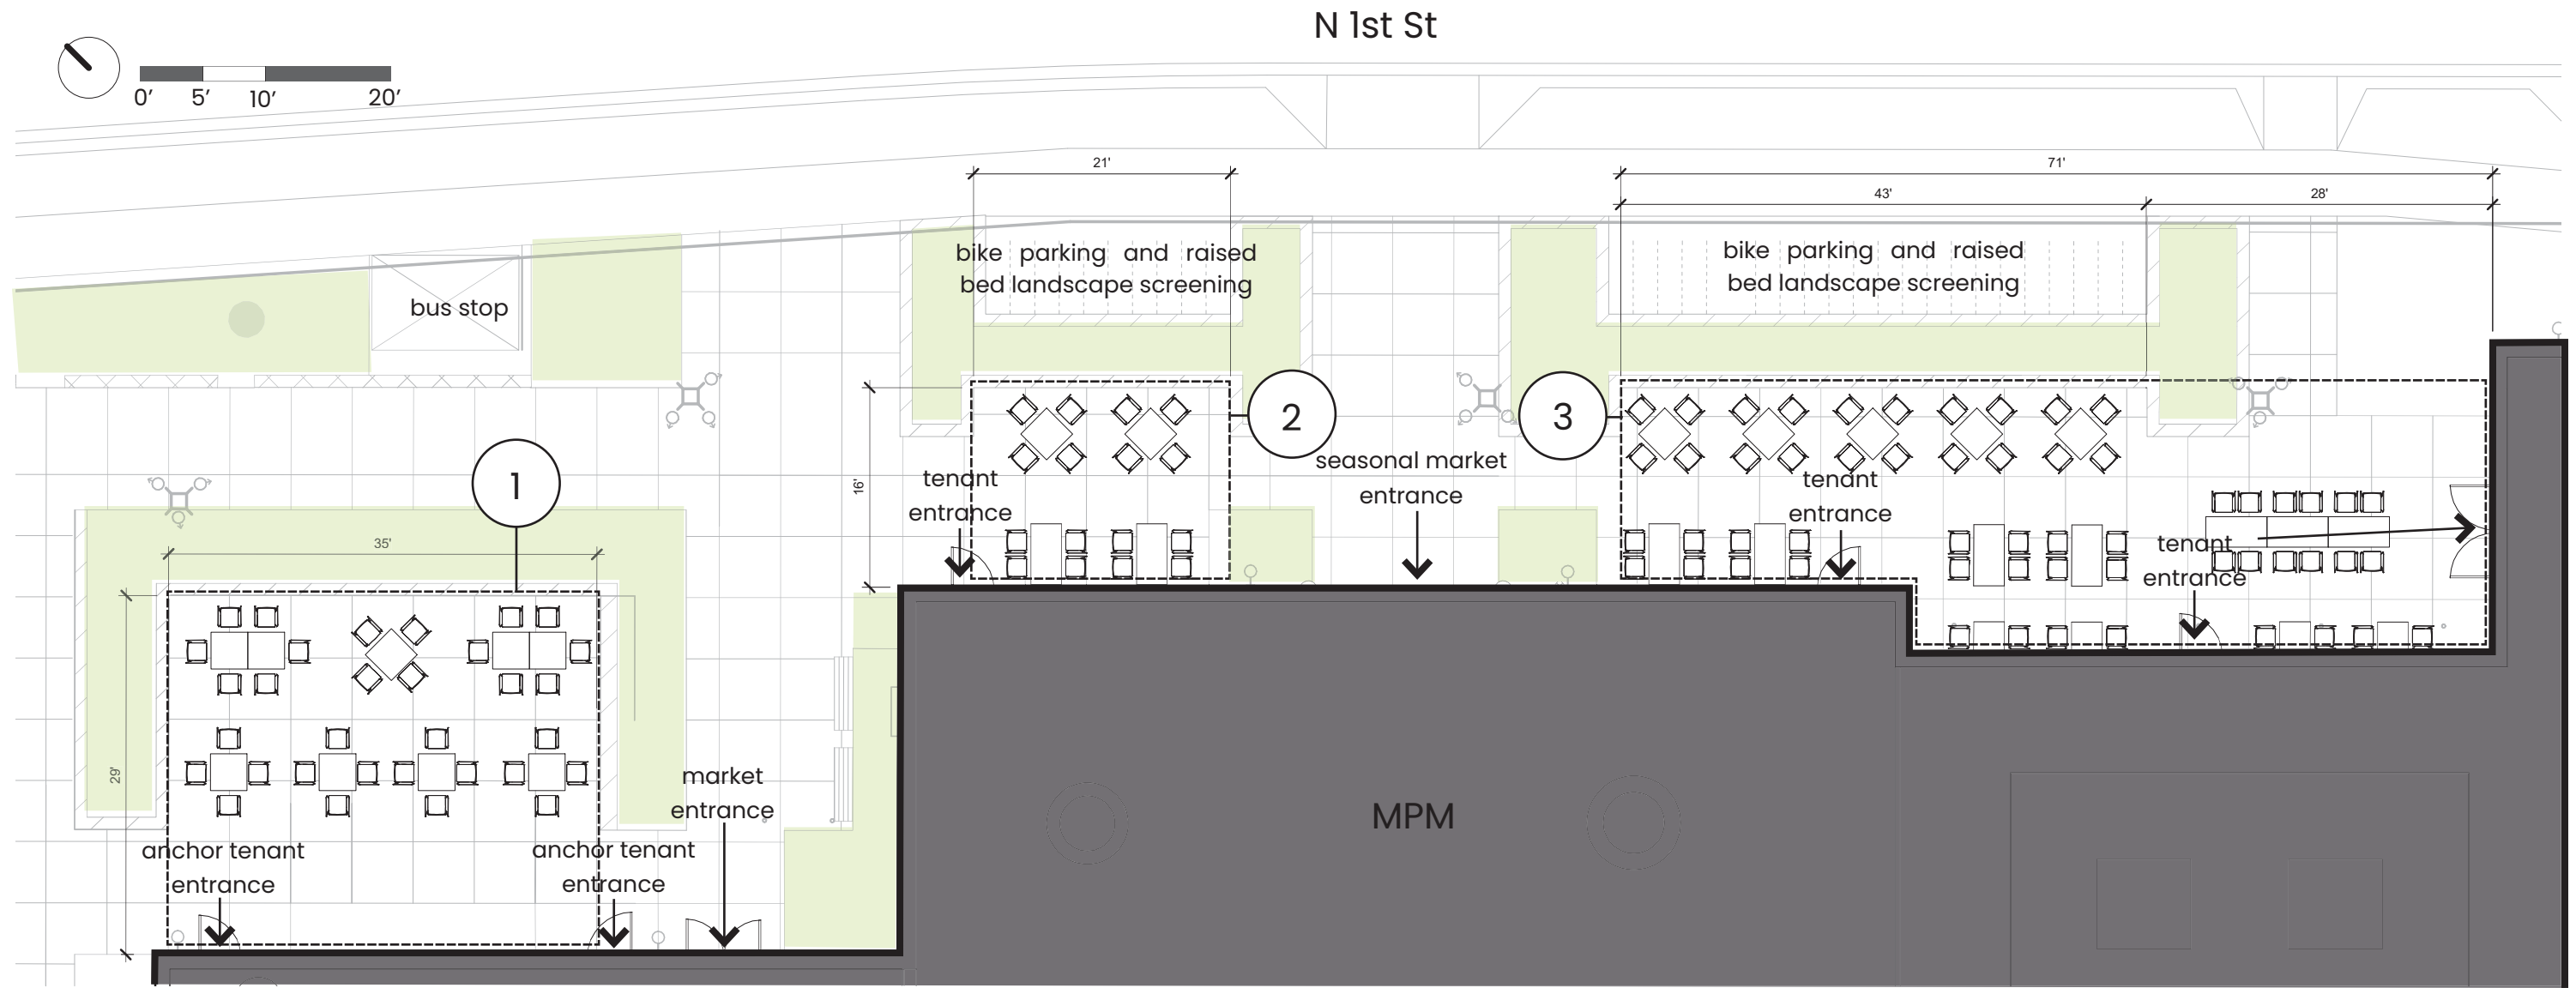

1. anchor tenant private patio

- 1,015 sf
- 32 occupants as shown*

2. market patio

- 336 sf
- 16 occupants as shown*


3. market patio

- 1,276 sf
- 56 occupants as shown*

*All furniture arrangements are placeholders, actual furniture type and arrangement will be by actual market tenants. Occupancies noted are based on suggested furniture arrangements

Anchor tenant private patio is available only to customers of the anchor tenant space. Market patios are adjacent to vendors inside the market but are available for all market visitors to use.

Market Entrances will be open and closed based on standard market operating hours. The seasonal market entrance is an overhead door and will not be available at some times of the year. The anchor tenant entrances will have independent hours based on operating hours of the anchor tenant space. Standard tenant entrances will default to standard market operating hours but can be over-ridden by the individual tenants they serve.

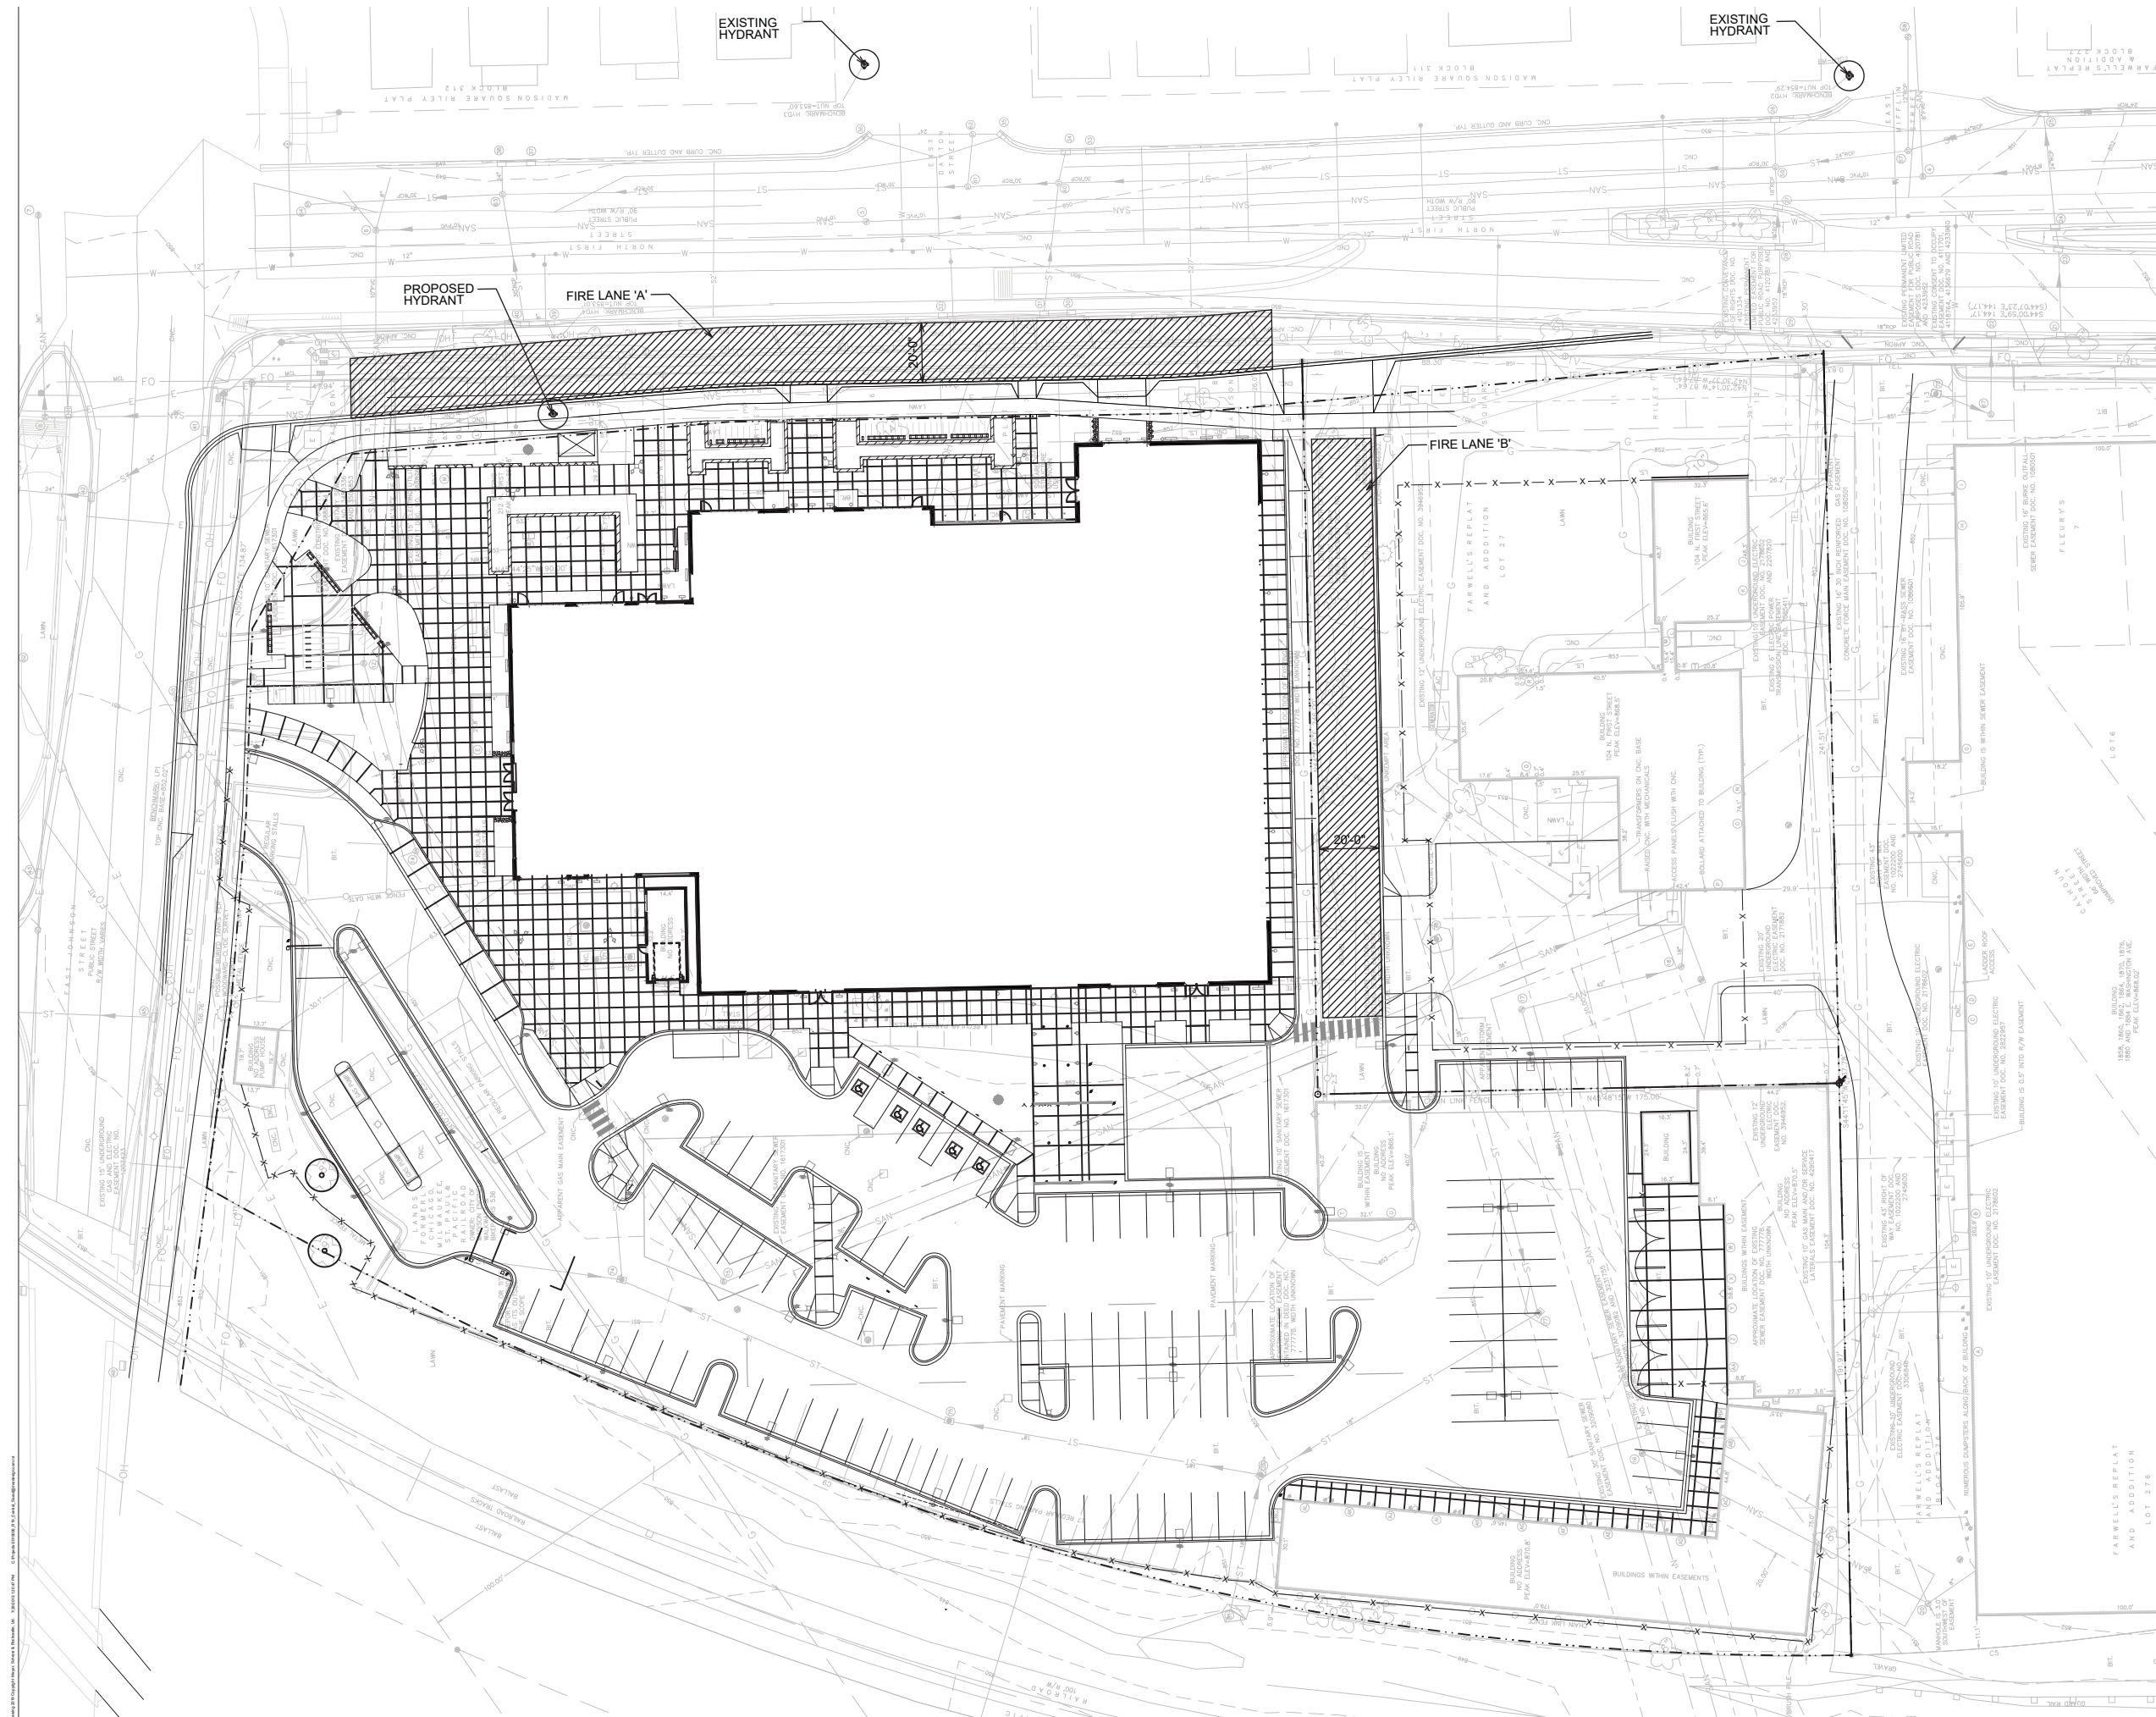

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




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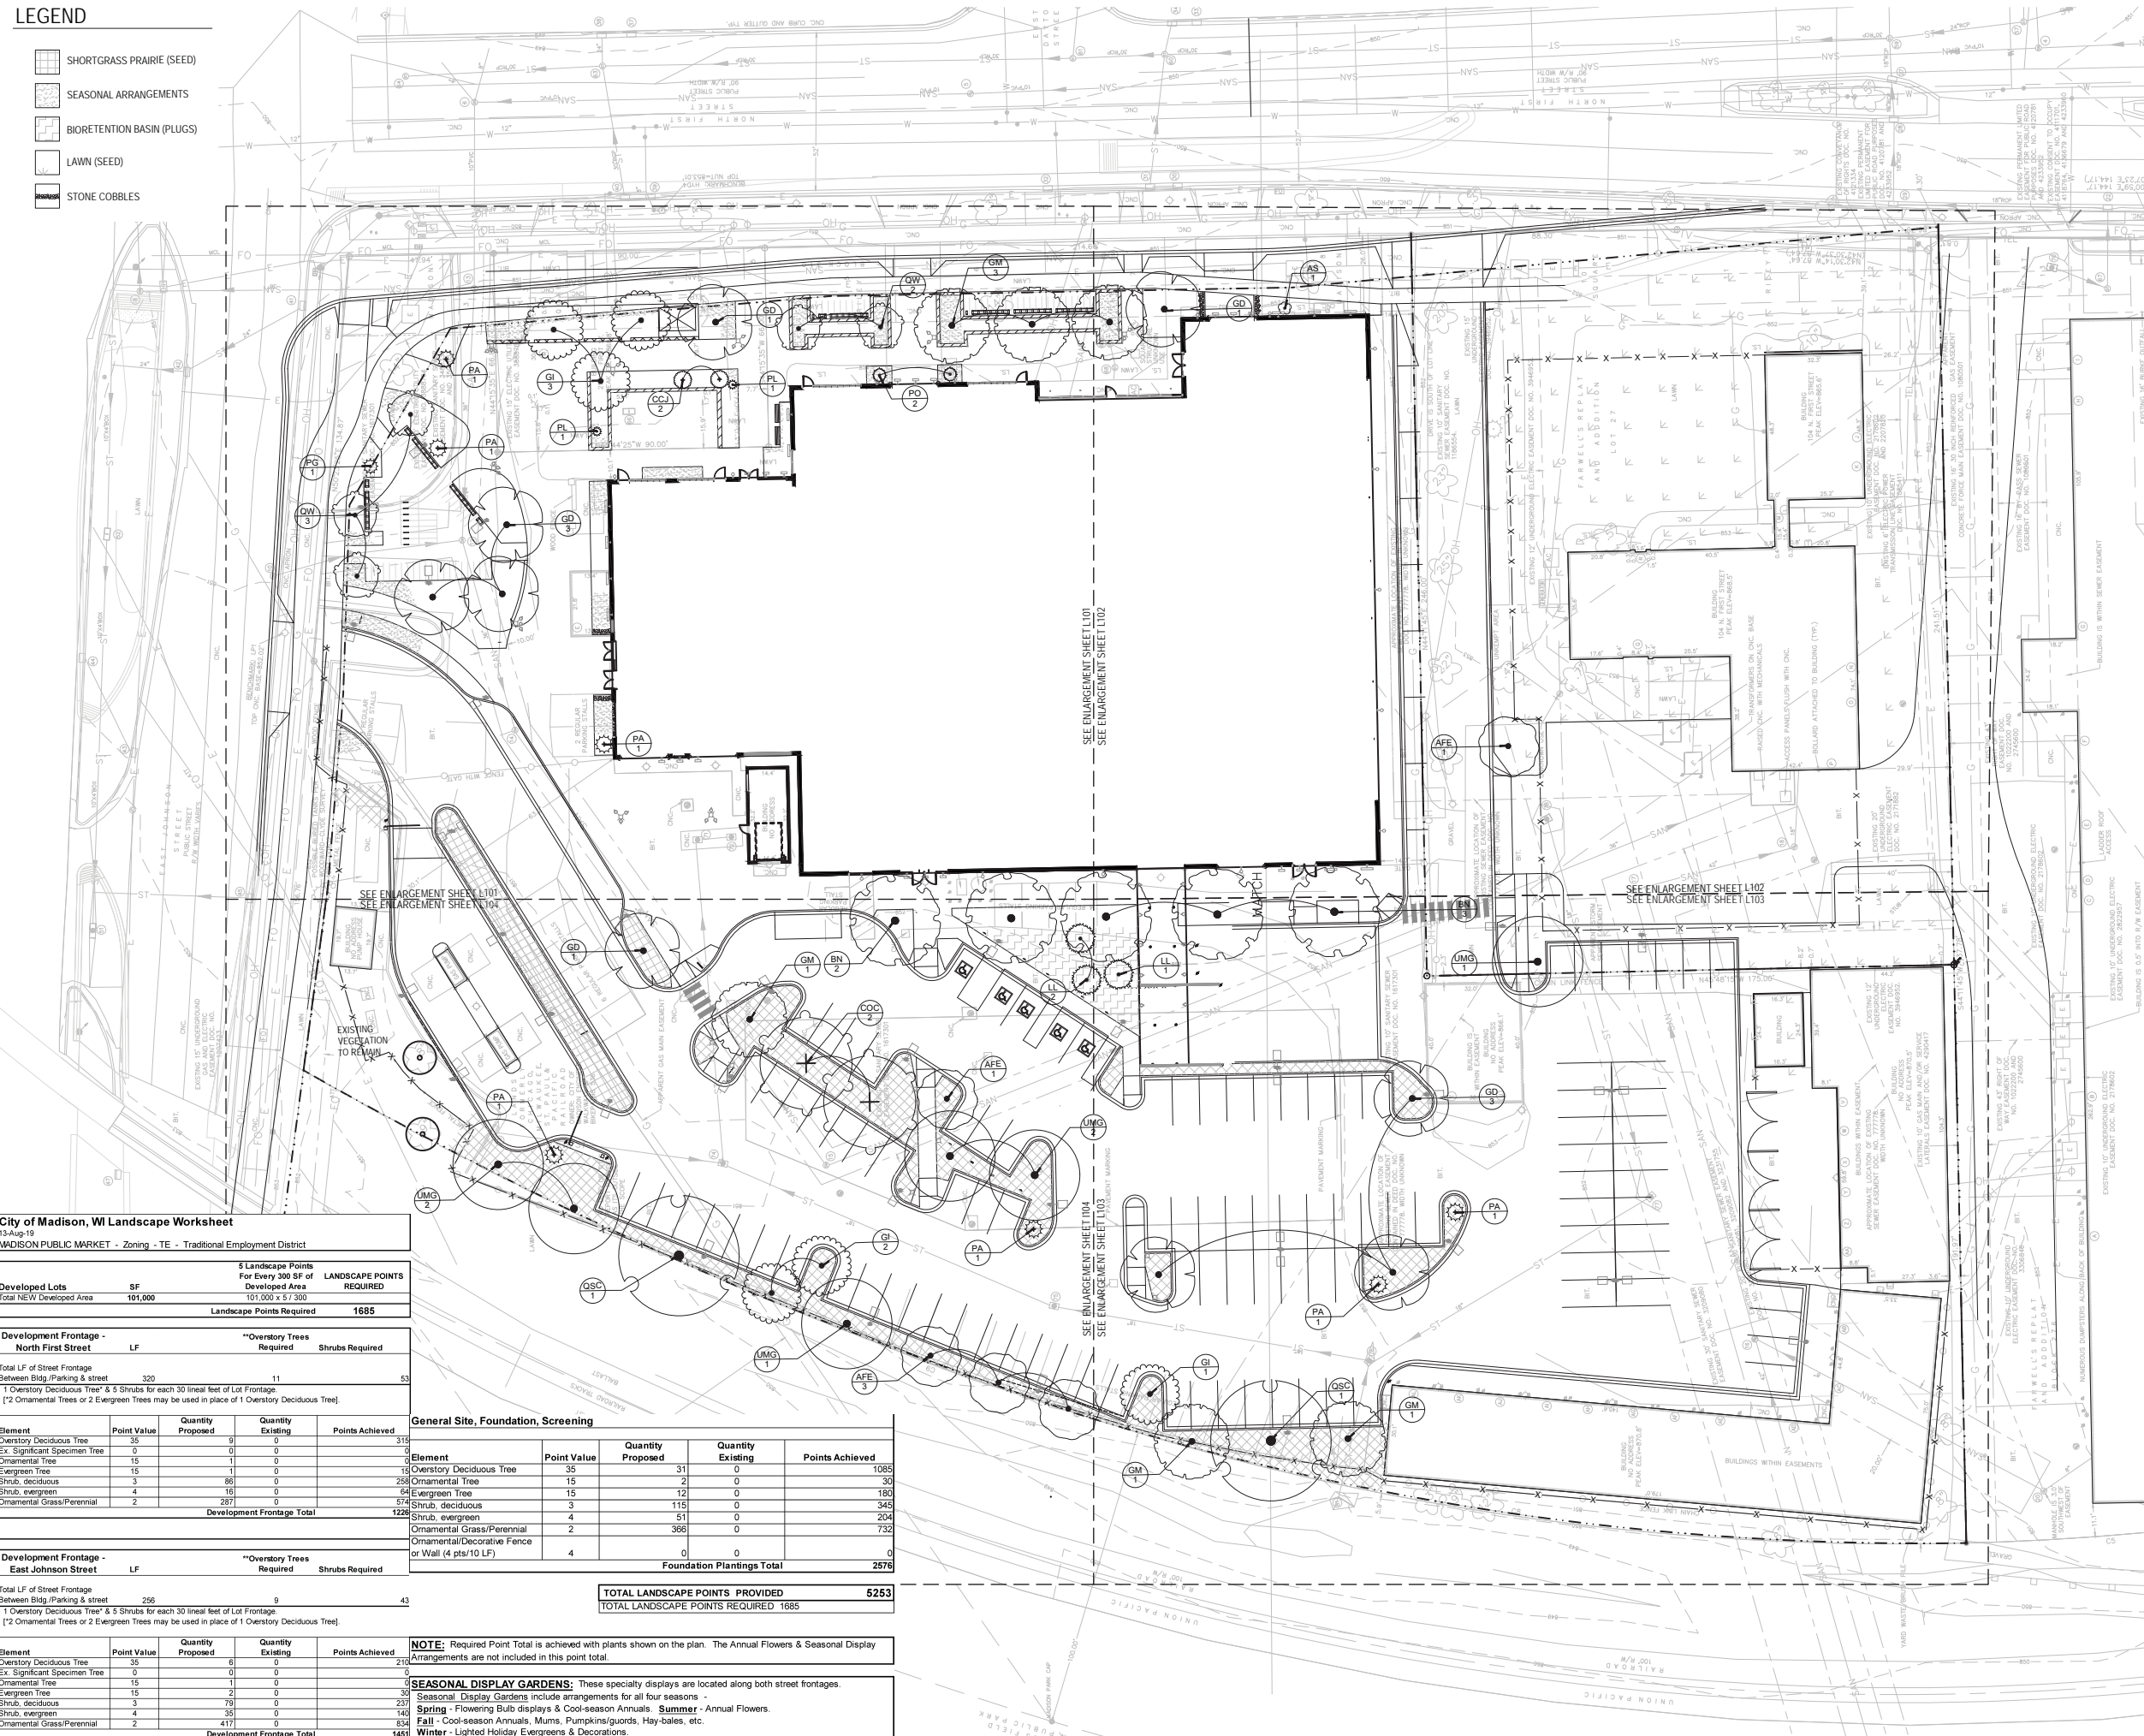
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 CHECKED BY: MSR

FIRE ACCESS PLAN

0 20' 30'
 1" = 20'-0"

LEGEND

-  SHORTGRASS PRAIRIE (SEED)
-  SEASONAL ARRANGEMENTS
-  BIORETENTION BASIN (PLUGS)
-  LAWN (SEED)
-  STONE COBBLES



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MADISON PUBLIC MARKET
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L-3

City of Madison, WI Landscape Worksheet
 13-Aug-19
 MADISON PUBLIC MARKET - Zoning - TE - Traditional Employment District

Developed Lots	SF	5 Landscape Points For Every 300 SF of Developed Area	LANDSCAPE POINTS REQUIRED
Total NEW Developed Area	101,000	101,000 x 5 / 300	1685

Development Frontage - North First Street	LF	**Overstory Trees Required	Shrubs Required
Total LF of Street Frontage			
Between Bldg / Parking & street	320	11	53

1 Overstory Deciduous Tree* & 5 Shrubs for each 30 linear feet of Lot Frontage.
 [*2 Ornamental Trees or 2 Evergreen Trees may be used in place of 1 Overstory Deciduous Tree.]

Element	Point Value	Quantity Proposed	Quantity Existing	Points Achieved
Overstory Deciduous Tree	35	9	0	315
Ex. Significant Specimen Tree	0	0	0	0
Ornamental Tree	15	11	0	165
Evergreen Tree	15	11	0	165
Shrub, deciduous	3	80	0	240
Shrub, evergreen	4	16	0	64
Ornamental Grass/Perennial	2	287	0	574
Development Frontage Total				1228

Development Frontage - East Johnson Street	LF	**Overstory Trees Required	Shrubs Required
Total LF of Street Frontage			
Between Bldg / Parking & street	256	9	43

1 Overstory Deciduous Tree* & 5 Shrubs for each 30 linear feet of Lot Frontage.
 [*2 Ornamental Trees or 2 Evergreen Trees may be used in place of 1 Overstory Deciduous Tree.]

Element	Point Value	Quantity Proposed	Quantity Existing	Points Achieved
Overstory Deciduous Tree	35	6	0	210
Ex. Significant Specimen Tree	0	0	0	0
Ornamental Tree	15	2	0	30
Evergreen Tree	15	2	0	30
Shrub, deciduous	3	79	0	237
Shrub, evergreen	4	35	0	140
Ornamental Grass/Perennial	2	417	0	834
Development Frontage Total				1451


General Site, Foundation, Screening

Element	Point Value	Quantity Proposed	Quantity Existing	Points Achieved
Overstory Deciduous Tree	35	31	0	1085
Ornamental Tree	15	12	0	180
Evergreen Tree	15	12	0	180
Shrub, deciduous	3	115	0	345
Shrub, evergreen	4	51	0	204
Ornamental Grass/Perennial	2	366	0	732
Ornamental/Decorative Fence or Wall (4 pts/10 LF)	4	0	0	0
Foundation Plantings Total				2576

TOTAL LANDSCAPE POINTS PROVIDED	5253
TOTAL LANDSCAPE POINTS REQUIRED	1685

NOTE: Required Point Total is achieved with plants shown on the plan. The Annual Flowers & Seasonal Display Arrangements are not included in this point total.

SEASONAL DISPLAY GARDENS: These specialty displays are located along both street frontages.
 Seasonal Display Gardens include arrangements for all four seasons:
 Spring - Flowering Bulb displays & Cool-season Annuals, Summer - Annual Flowers,
 Fall - Cool-season Annuals, Mums, Pumpkins/gourds, Hay-bales, etc.
 Winter - Lighted Holiday Evergreens & Decorations.

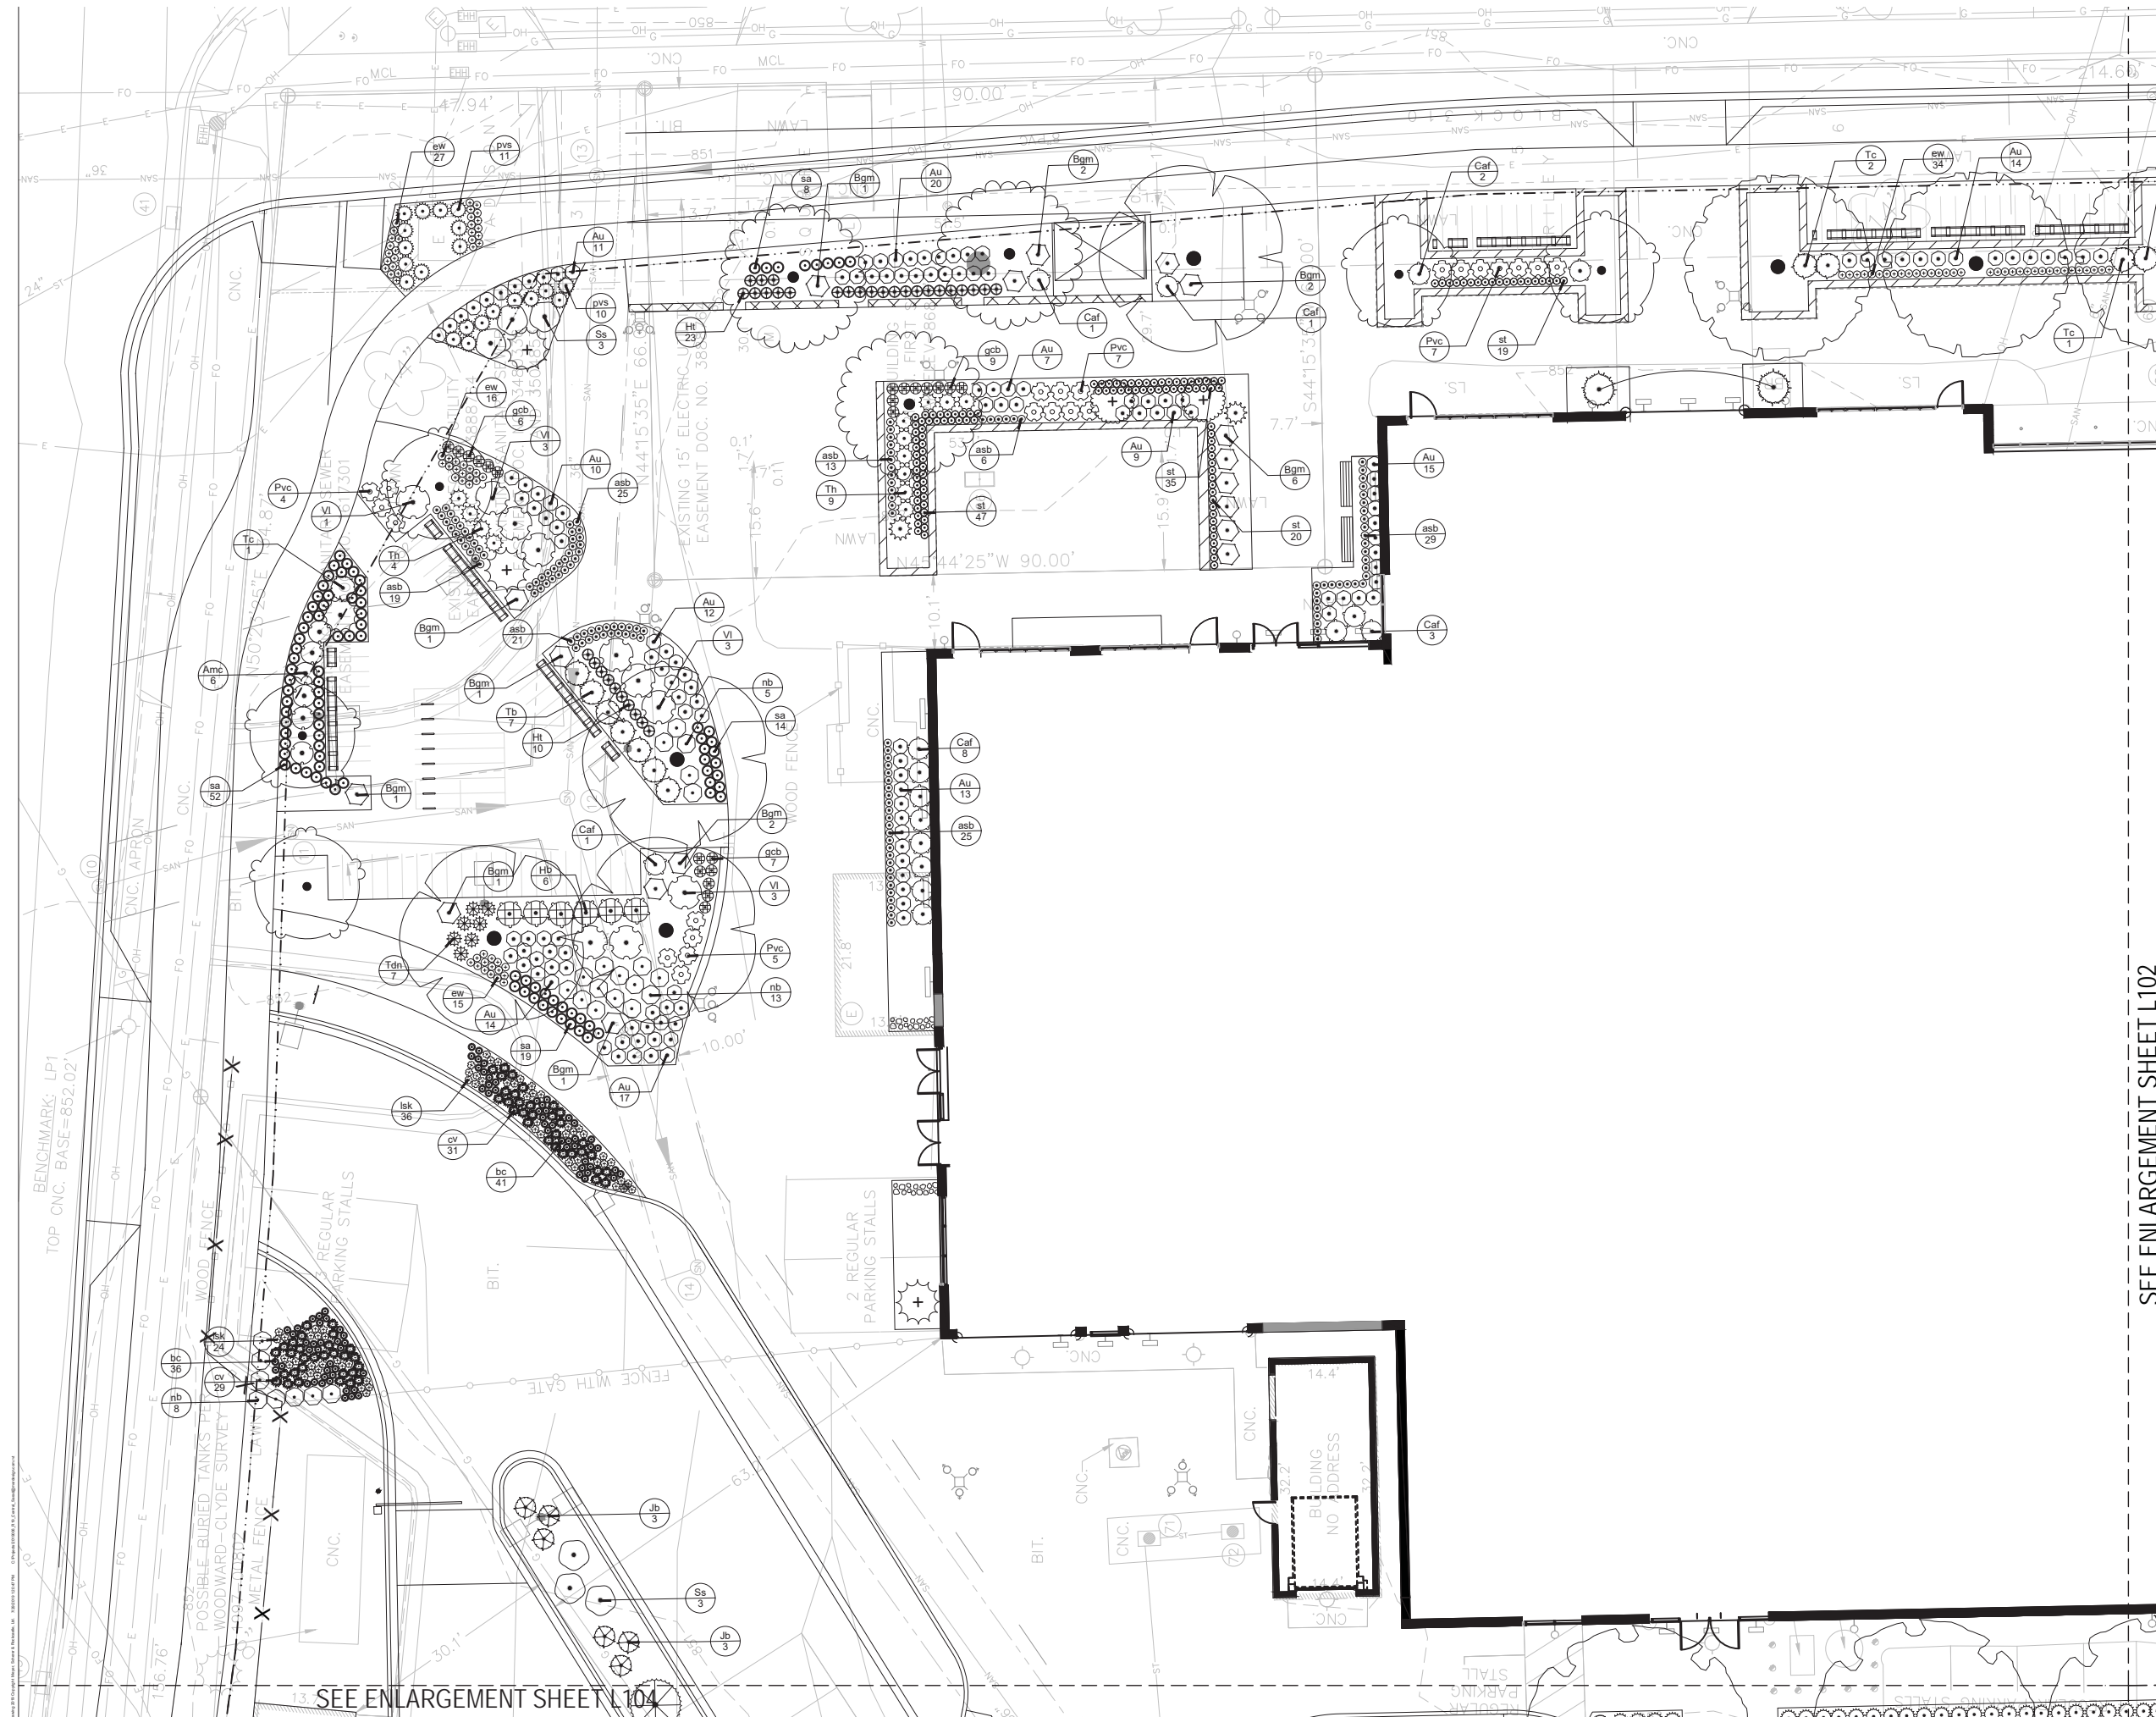

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PLANTING PLAN ENLARGEMENT

0 2' 4' 8' 12'
 1/8" = 1'-0"


L-4

SEE ENLARGEMENT SHEET L102

SEE ENLARGEMENT SHEET L104

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SEE ENLARGEMENT SHEET L101

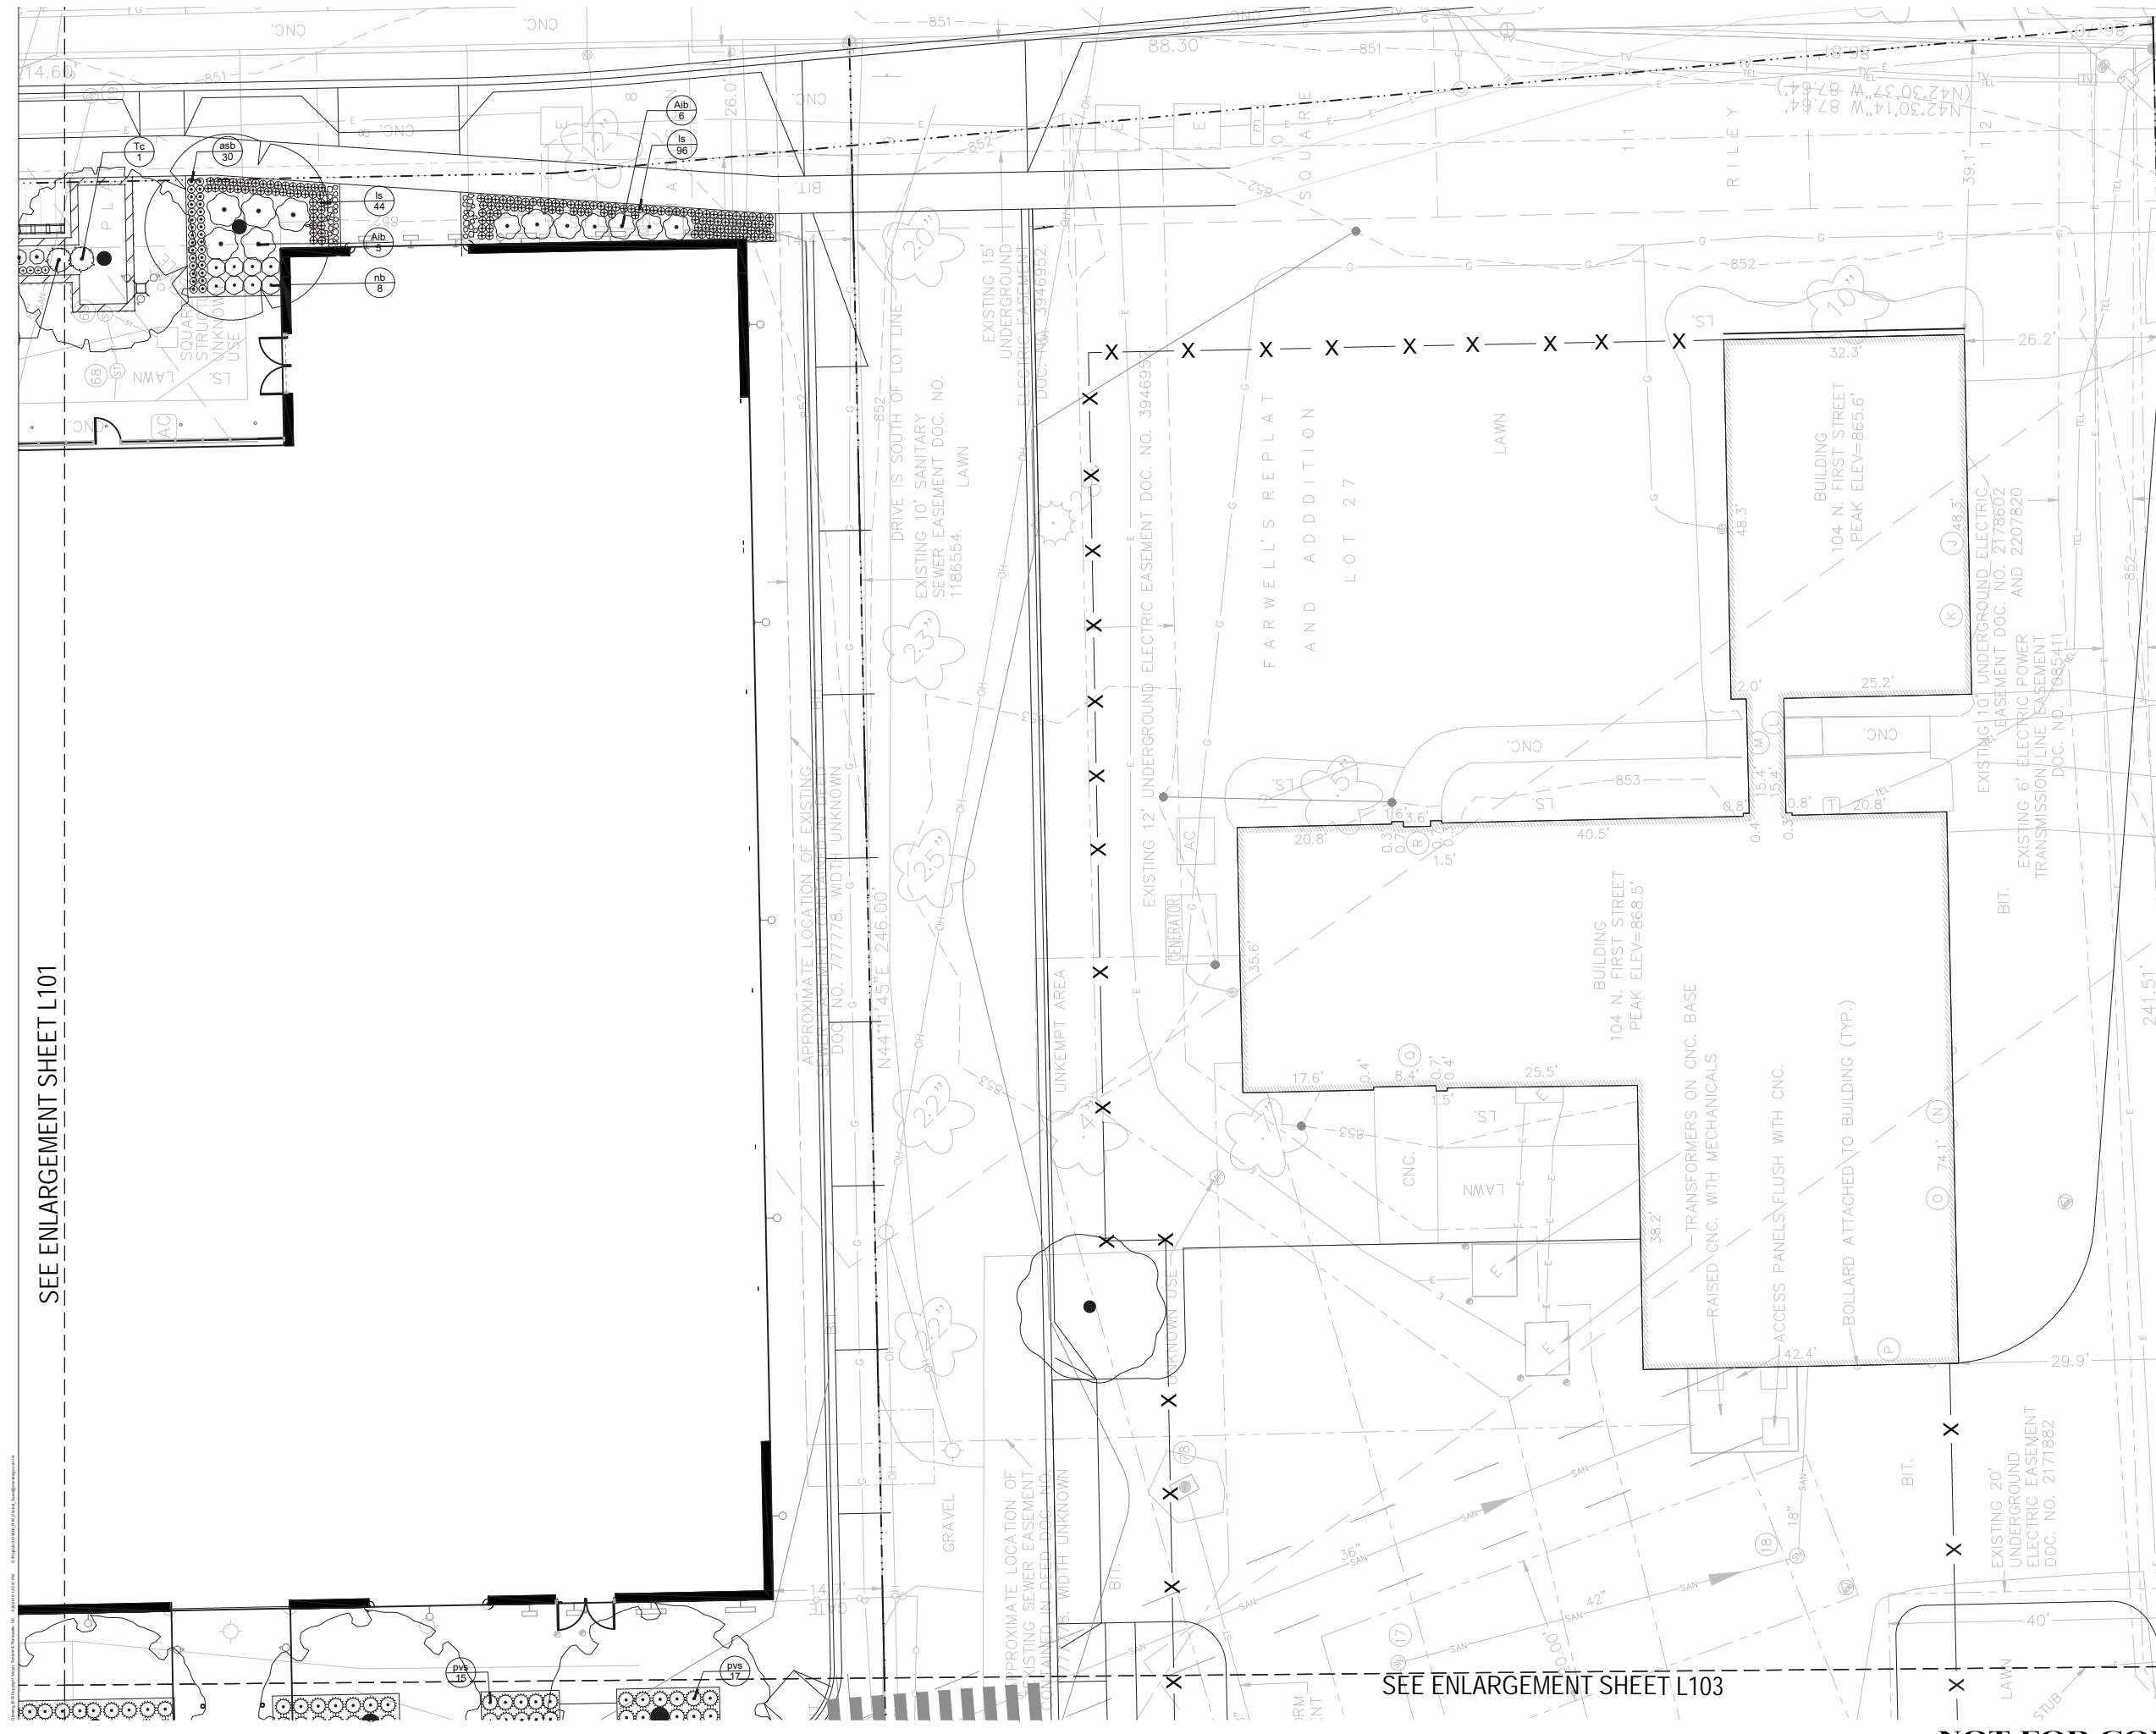

SEE ENLARGEMENT SHEET L103

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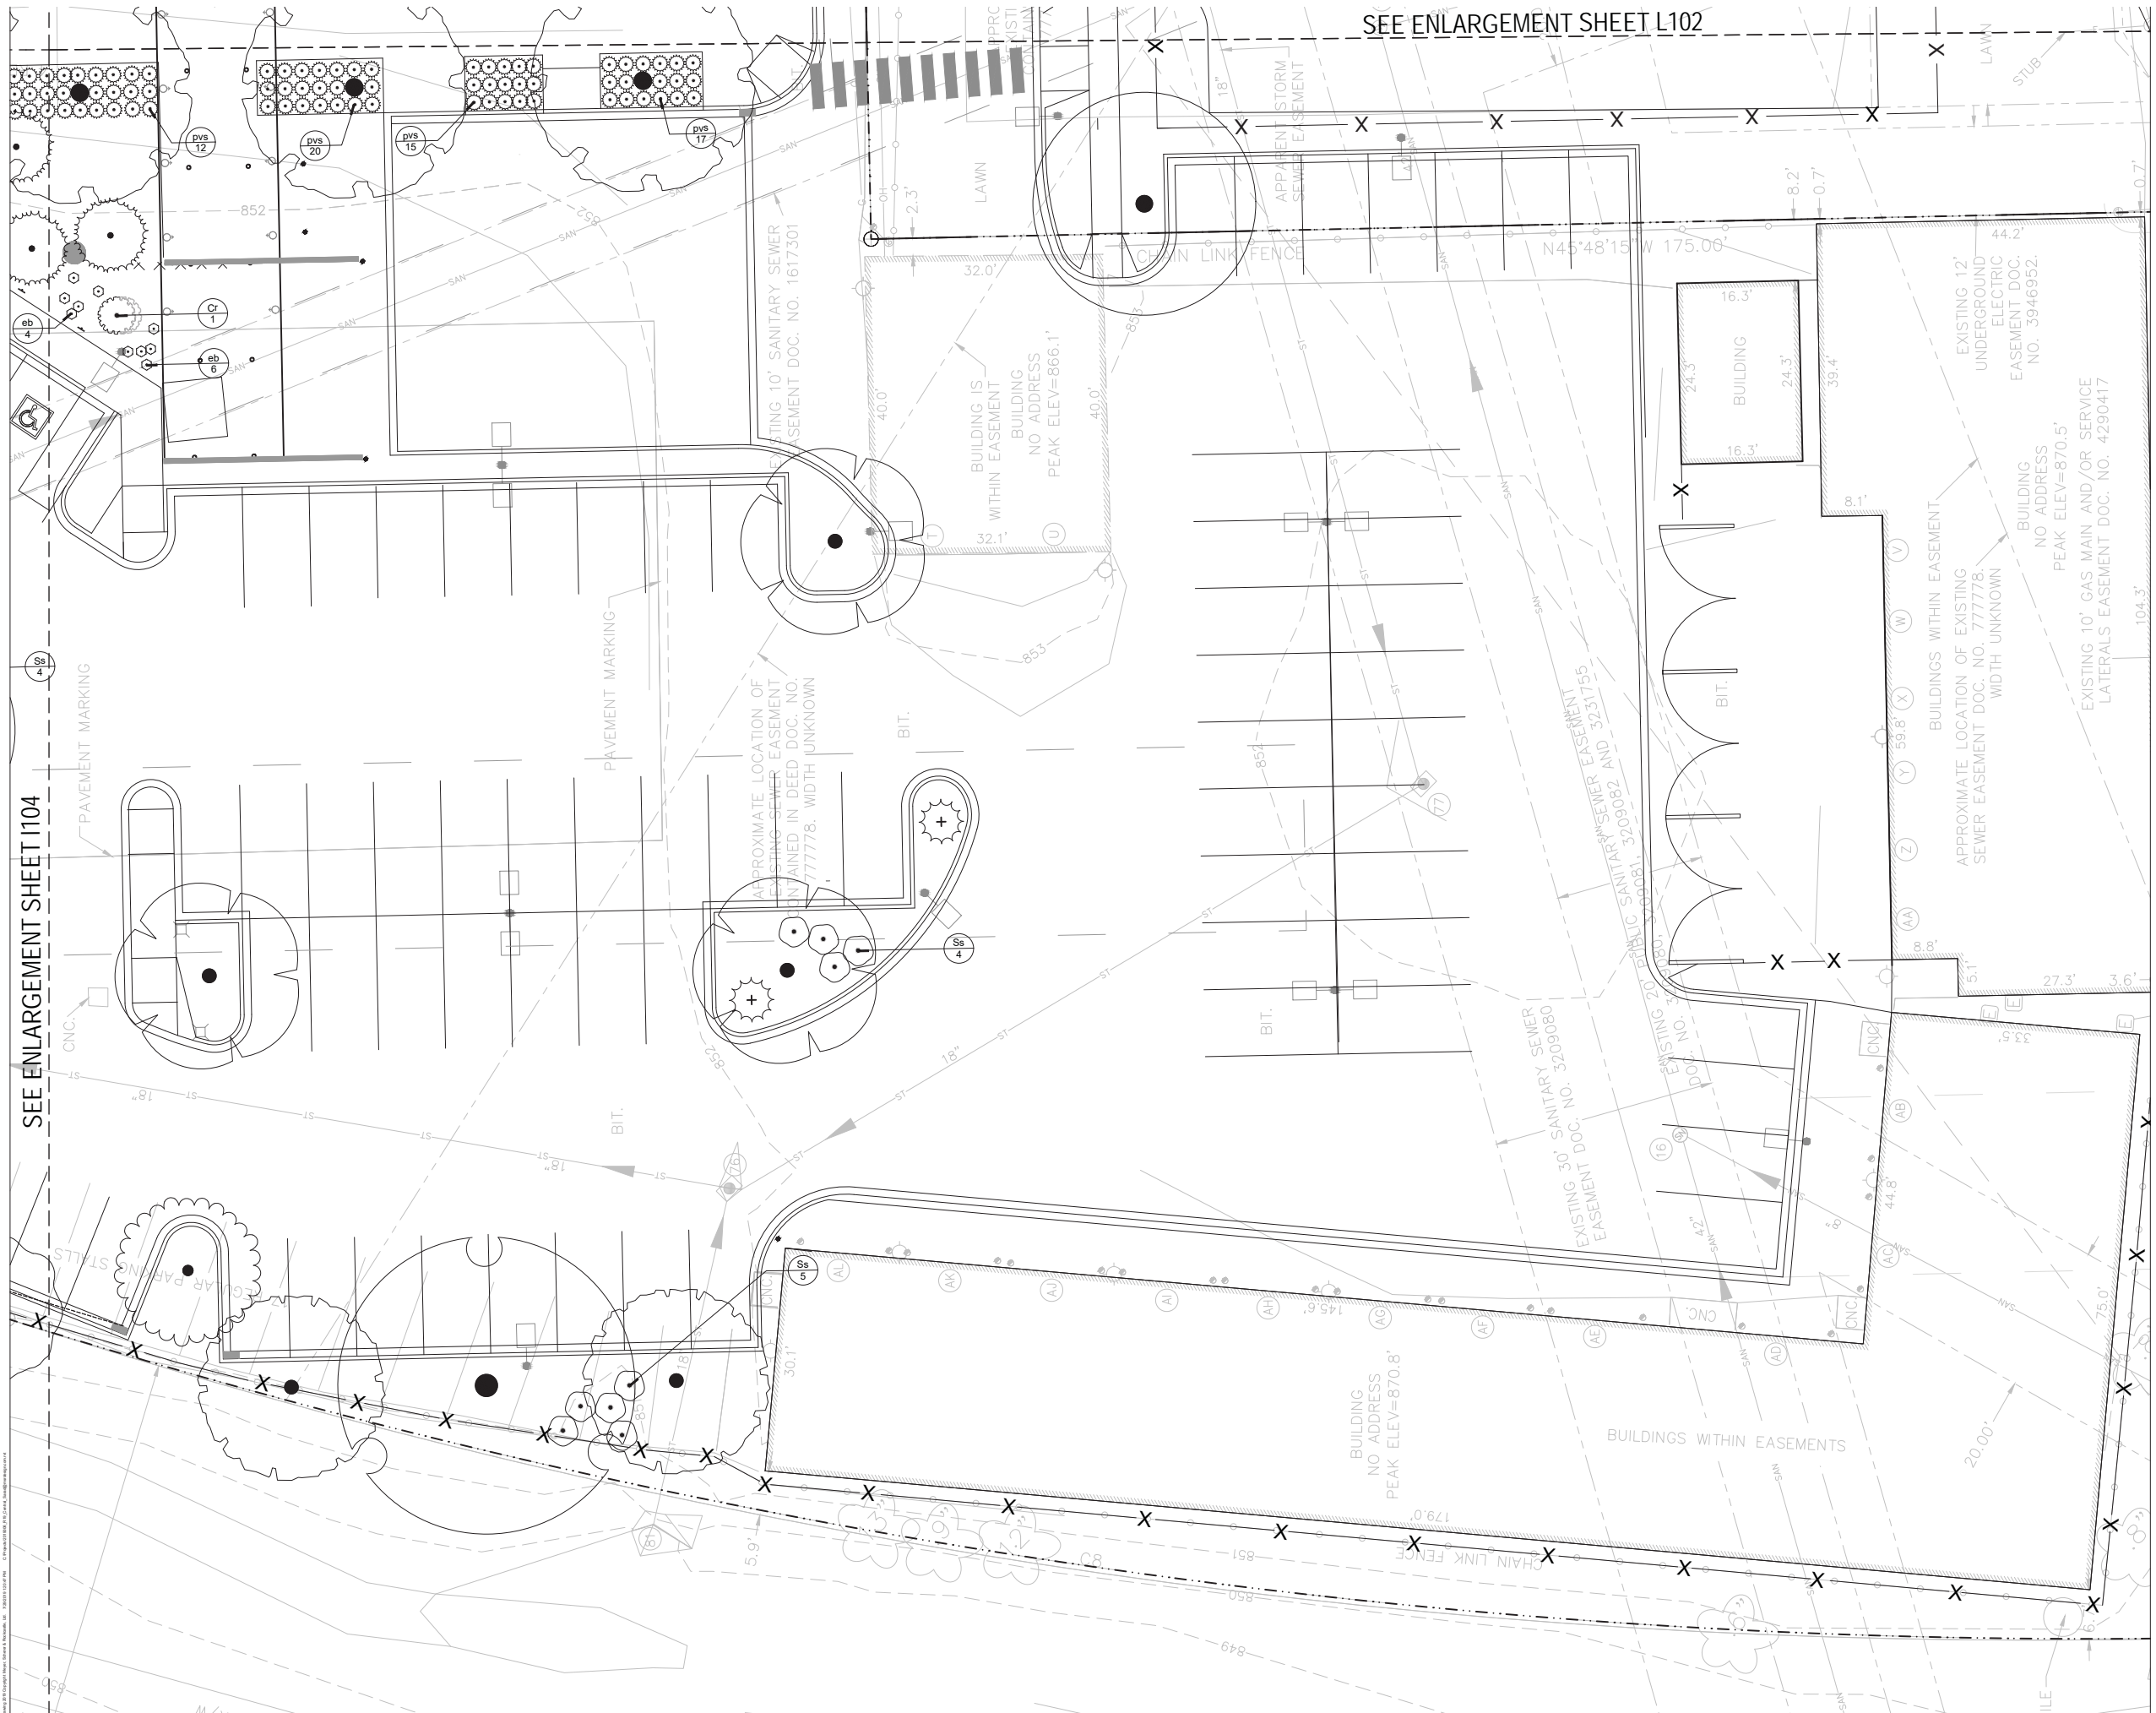
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PLANTING PLAN ENLARGEMENT
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 1/8" = 1'-0"

L-5

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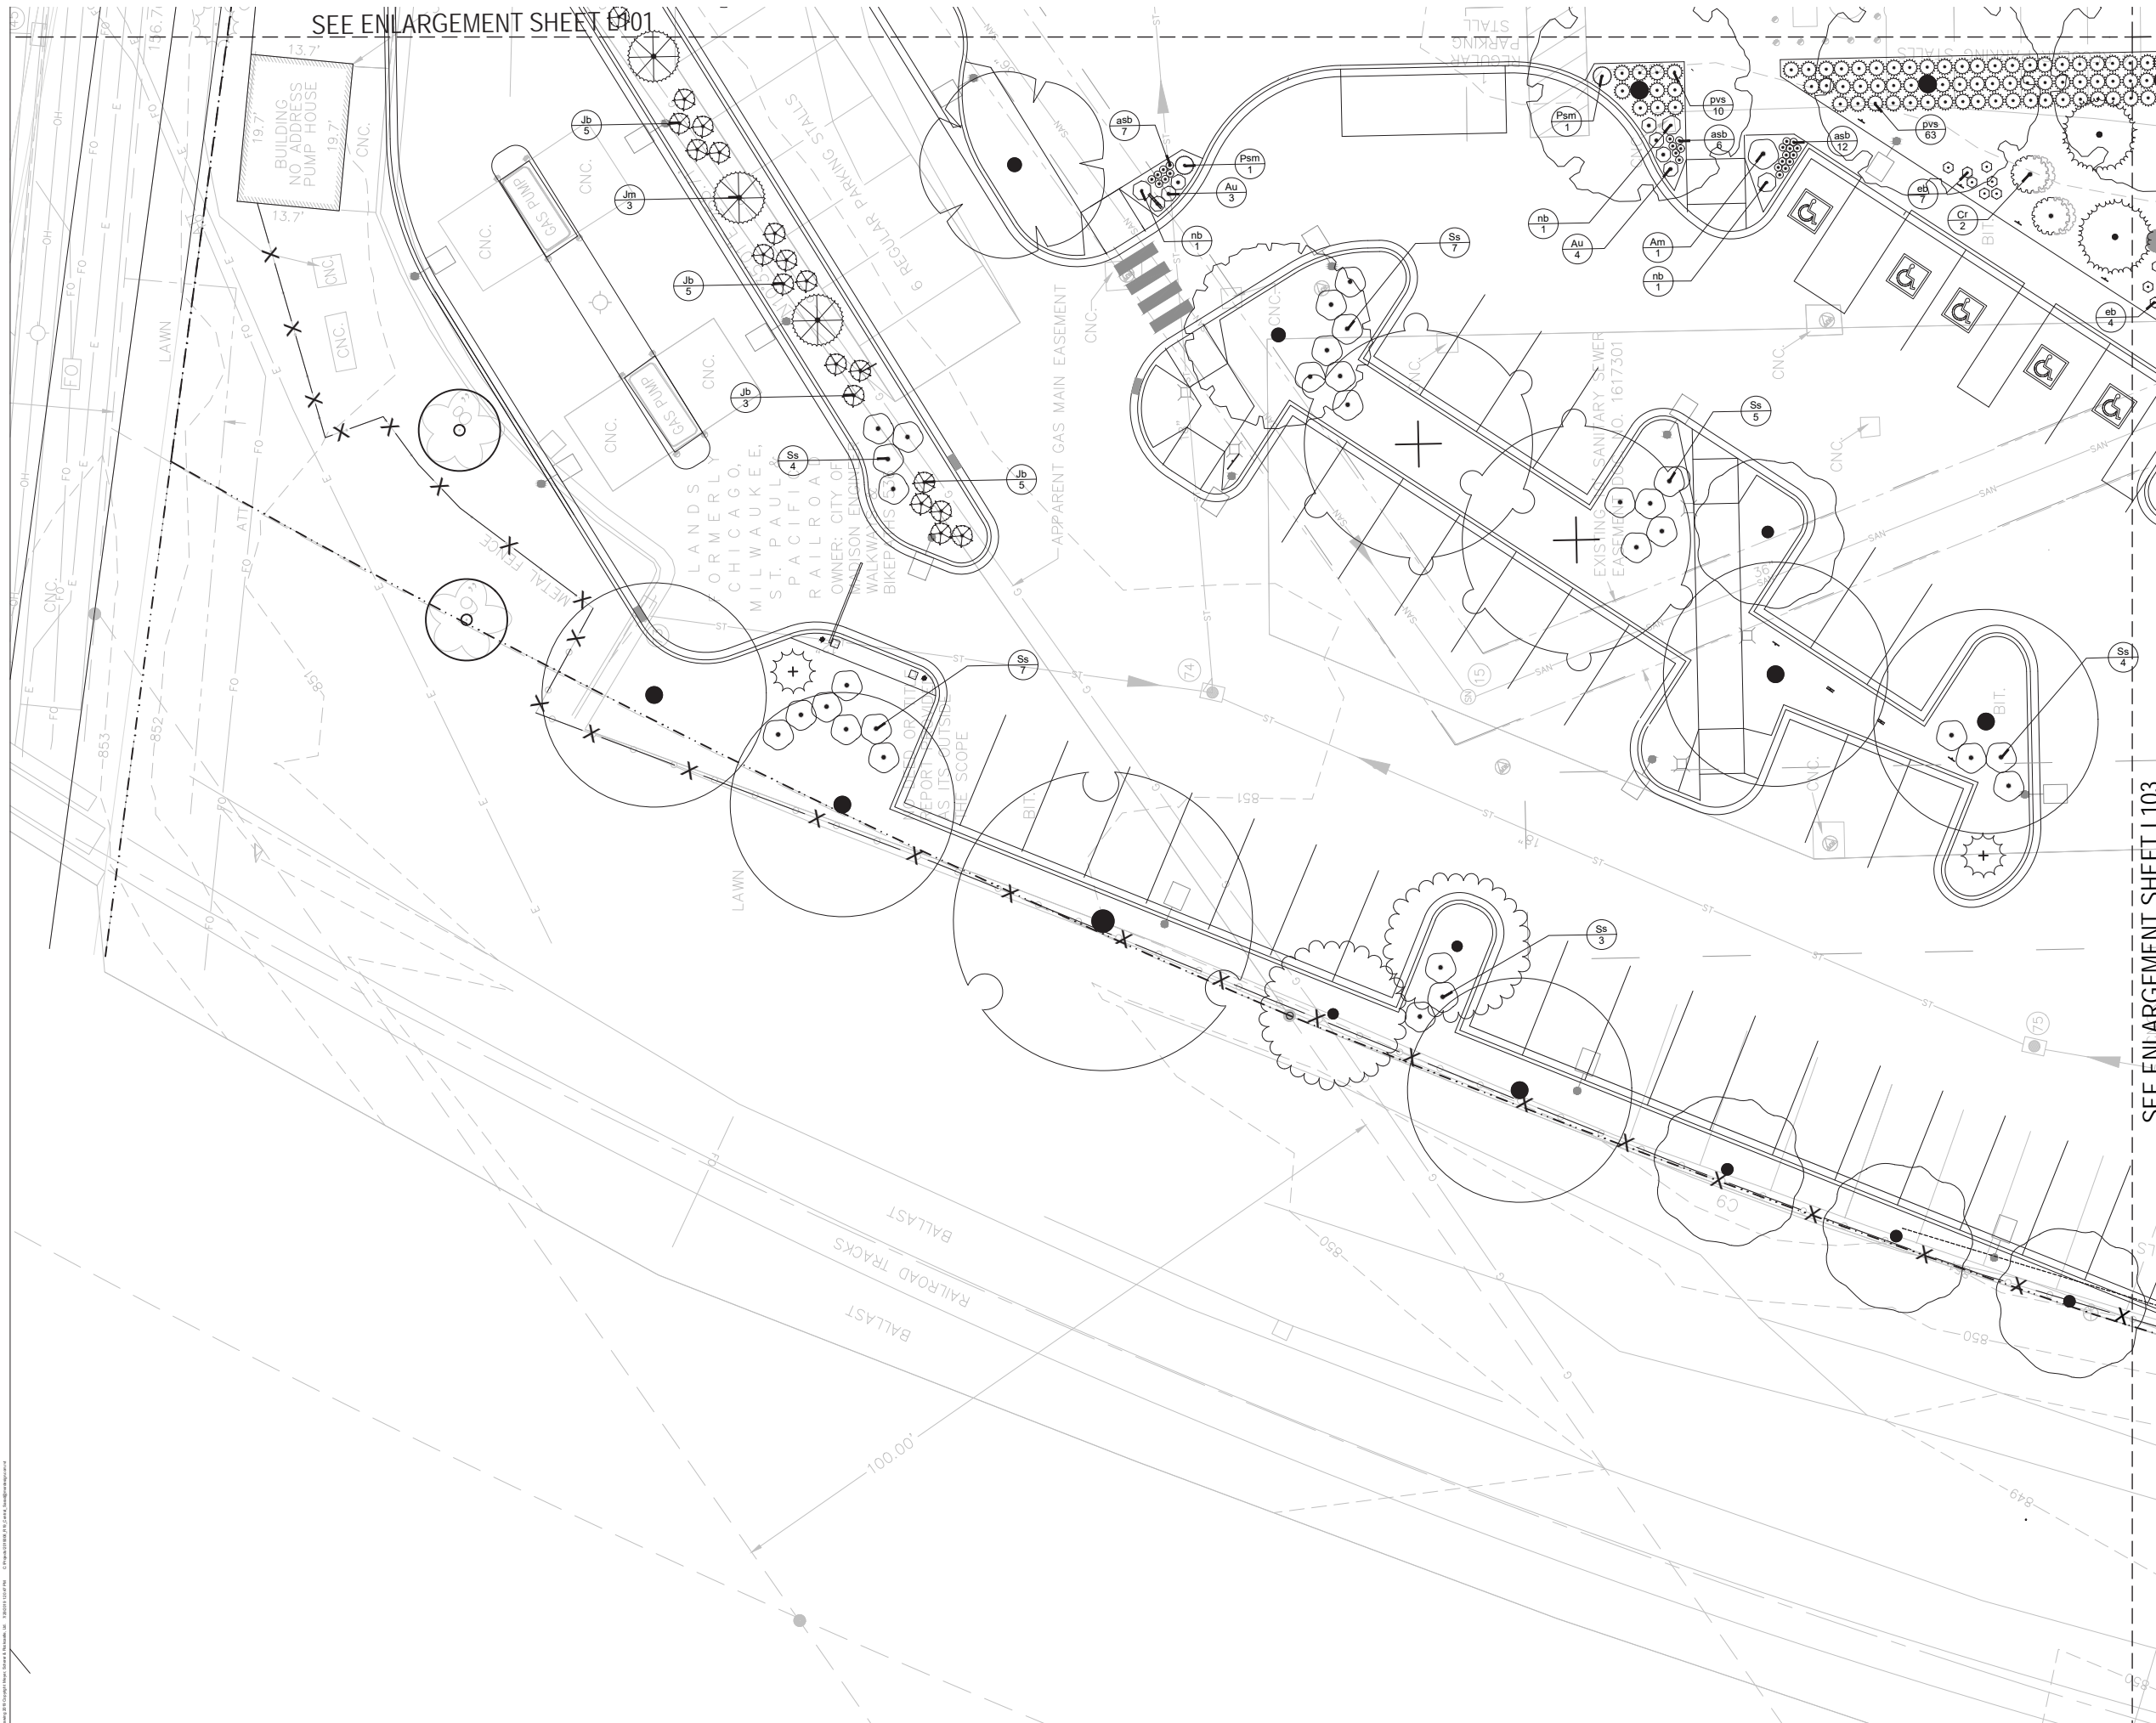
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PLANTING PLAN ENLARGEMENT
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 1/8" = 1'-0"

L-6

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SEE ENLARGEMENT SHEET L101



SEE ENLARGEMENT SHEET L103

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PLANTING PLAN ENLARGEMENT
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L-7

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PLANT SCHEDULE 1

EVERGREEN TREES	CODE	BOTANICAL / COMMON NAME	CONT	SIZE	HEIGHT	QTY
	PA	Picea abies 'Sherwood Compact' / Norway Spruce	15 gal			3
	PG	Picea glauca 'Yukon Blue' / Yukon Blue Spruce	15 gal			1
	PO	Picea omorika 'De Ruyter' / De Ruyter Serbian Spruce	15 gal			3
	PL	Pinus leucodermis 'Gnome' / Gnome Dwarf Bonoin Pine	15 gal			2
ORNAMENTAL TREES	CODE	BOTANICAL / COMMON NAME	CONT	SIZE	HEIGHT	QTY
	CCJ	Carpinus caroliniana 'J.N. Upright' / Firespine Mucedwood	15 gal	2' CAL. 8' MIN HT.	TREE FORM	2
SHADE TREES	CODE	BOTANICAL / COMMON NAME	CONT	SIZE	HEIGHT	QTY
	GM	Ginkgo biloba 'Magyar' / Magyar Ginkgo	8 & B	2 1/2-3' CAL. 14' MIN HT.		2
	GI	Gleditsia triacanthos 'Impcoke' TM / Impcoke Honeylocust	8 & B	2 1/2-3' CAL. 14' MIN HT.		3
	GD	Gymnocladus dioica 'Espresso' / Espresso Kentucky Coffeetree	8 & B	3' Cal		4
	QW	Quercus x warei 'Long' TM / Regal Pin oak	8 & B	2 1/2-3' CAL. 14' MIN HT.		5
DECIDUOUS SHRUBS	CODE	BOTANICAL / COMMON NAME	CONT	SIZE	NOTES	QTY
	Anc	Aronia melanocarpa 'Low Scape Hedge' / Low Scape Hedge Chokeberry	3 gal			6
	Au	Aronia melanocarpa 'UCONNAM165' / Lowscape Mound Chokeberry	3 gal			142
	Caf	Cornus stolonifera 'Arctic Fire' / Arctic Fire Dogwood	5 gal			13
	Hb	Hydrangea paniculata 'Bobo' / Bobo Hydrangea	5 gal			6
	Ht	Hydrangea serrata 'Tiny Tuff Stuff' / Tiny Tuff Stuff Hydrangea	3 gal			33
	Ss	Sorbaria sorbifolia 'Sem' / Sem Ash Leaf Spirea	5 gal			6
	Vl	Viburnum dentatum 'KLMeventem' TM / Little Joe	5 gal			10
EVERGREEN SHRUBS	CODE	BOTANICAL / COMMON NAME	CONT	SIZE	NOTES	QTY
	Bgm	Buxus x 'Green Mound' / Green Mound Boxwood	5 gal			18
	Jb	Juniperus scopulorum 'Blue Arrow' / Blue Arrow Juniper	5 gal	4' HT. (MN.)		6
	Pic	Pinus mugo 'Valley Cushion' / Valley Cushion Mugo Pine	3 gal			23
	Tb	Thuja occidentalis 'Bobazant' / Mr. Bowling Ball Arborvitae	5 gal			7
	Tc	Thuja occidentalis 'Congabe' / Fire Chief Arborvitae	5 gal			4
	Tdn	Thuja occidentalis 'Danica' TM / Danica Globe Cedar	3 gal			7
	Th	Thuja occidentalis 'Hetz Midgel' / Hetz Midgel Arborvitae	3 gal			13
HERBACEOUS PERENNIALS	CODE	BOTANICAL / COMMON NAME	CONT	SIZE	NOTES	QTY
	asb	Allium tanguticum 'Summer Beauty' / Summer Beauty Allium	1 gal			138
	ew	Echinacea purpurea 'PAST02917' TM / PowWow Wild Berry Coneflower	1 gal			92
	gcb	Geranium x cantabrigiense 'Blokovo' / Blokovo Cranesbill	1 gal			22
	lk	Liatris spicata 'Kobold' / Kobold Spike Gayleather	1 gal			60
	nb	Nepeta x faassenii 'Blue Wonder' / Catmint	1 gal			26
	st	Sedum x 'Thundercloud' / Thundercloud Sedum	1 gal			121
ORNAMENTAL GRASSES	CODE	BOTANICAL / COMMON NAME	CONT	SIZE	NOTES	QTY
	bc	Bouteloua curtipendula / Side Oats Grama	1 gal			77
	cr	Carex vulpinoidea / Brown Fox Sedge	1 gal			60
	pvs	Panicum virgatum 'Shenandoah' / Shenandoah Switch Grass	1 gal			21
	sa	Sceleria autumnalis / Autumn Moor Grass	1 gal			93

PLANT SCHEDULE 2

ORNAMENTAL TREES	CODE	BOTANICAL / COMMON NAME	CONT	SIZE	QTY
	AS	Amelanchier alnifolia 'Standing Ovation' TM / Serviceberry	15 gal	2' CAL. 8' MIN HT.	1
SHADE TREES	CODE	BOTANICAL / COMMON NAME	CONT	SIZE	QTY
	AFE	Acer x freemanii 'Ed Gahner' / Redhead Freeman Maple	8 & B	2 1/2-3' CAL. 14' MIN HT.	1
	GM	Ginkgo biloba 'Magyar' / Magyar Ginkgo	8 & B	2 1/2-3' CAL. 14' MIN HT.	1
	GO	Gymnocladus dioica 'Espresso' / Espresso Kentucky Coffeetree	8 & B	3' Cal	1
DECIDUOUS SHRUBS	CODE	BOTANICAL / COMMON NAME	CONT	SIZE	QTY
	Ab	Aronia melanocarpa 'Morton' / Iroquois Beauty Black Chokeberry	3 gal	18' HT. (MN.)	11
EVERGREEN SHRUBS	CODE	BOTANICAL / COMMON NAME	CONT	SIZE	QTY
	Tc	Thuja occidentalis 'Congabe' / Fire Chief Arborvitae	5 gal		1
HERBACEOUS PERENNIALS	CODE	BOTANICAL / COMMON NAME	CONT	SIZE	QTY
	asb	Allium tanguticum 'Summer Beauty' / Summer Beauty Allium	1 gal		30
	ls	Liriope muscari 'Silvery Suproof' / Silvery Suproof Blue Lilyturf	1 gal		140
	nb	Nepeta x faassenii 'Blue Wonder' / Catmint	1 gal		8

PLANT SCHEDULE 3

EVERGREEN TREES	CODE	BOTANICAL / COMMON NAME	CONT	SIZE	QTY
	LL	Larix laricina / Tamarack	15 gal		1
	PA	Picea abies 'Sherwood Compact' / Norway Spruce	15 gal		2
SHADE TREES	CODE	BOTANICAL / COMMON NAME	CONT	SIZE	QTY
	BN	Betula nigra 'Heritage' / Heritage River Birch	15 gal		2
	GM	Ginkgo biloba 'Magyar' / Magyar Ginkgo	8 & B	2 1/2-3' CAL. 14' MIN HT.	2
	GI	Gleditsia triacanthos 'Impcoke' TM / Impcoke Honeylocust	8 & B	2 1/2-3' CAL. 14' MIN HT.	1
	GD	Gymnocladus dioica 'Espresso' / Espresso Kentucky Coffeetree	8 & B	3' Cal	3
	QSC	Quercus x schuetti / Swamp Bur Oak	8 & B	2 1/2-3' CAL. 14' MIN HT.	1
	UMG	Ulmus x 'Morton Glossy' TM / Triumph Elm	8 & B	2 1/2-3' CAL. 14' MIN HT.	1
DECIDUOUS SHRUBS	CODE	BOTANICAL / COMMON NAME	CONT	SIZE	QTY
	Cr	Cephalanthus occidentalis 'Balloptica' TM / Fiber Optics Buttonbush	5 gal		1
	Ss	Sorbaria sorbifolia 'Sem' / Sem Ash Leaf Spirea	5 gal		9
HERBACEOUS PERENNIALS	CODE	BOTANICAL / COMMON NAME	CONT	SIZE	QTY
	eb	Eupatorium dubium 'Baby Joe' / Dwarf Joe-Pye Weed	1 gal		6
ORNAMENTAL GRASSES	CODE	BOTANICAL / COMMON NAME	CONT	SIZE	QTY
	pvs	Panicum virgatum 'Shenandoah' / Shenandoah Switch Grass	1 gal		64

PLANT SCHEDULE 4

EVERGREEN TREES	CODE	BOTANICAL / COMMON NAME	CONT	SIZE	QTY
	LL	Larix laricina / Tamarack	15 gal		2
	PA	Picea abies 'Sherwood Compact' / Norway Spruce	15 gal		2
SHADE TREES	CODE	BOTANICAL / COMMON NAME	CONT	SIZE	QTY
	AFE	Acer x freemanii 'Ed Gahner' / Redhead Freeman Maple	8 & B	2 1/2-3' CAL. 14' MIN HT.	4
	BN	Betula nigra 'Heritage' / Heritage River Birch	15 gal		3
	COC	Celtis occidentalis 'Chicagoland' / Common Hackberry	8 & B	2 1/2-3' CAL. 14' MIN HT.	2
	GM	Ginkgo biloba 'Magyar' / Magyar Ginkgo	8 & B	2 1/2-3' CAL. 14' MIN HT.	1
	GI	Gleditsia triacanthos 'Impcoke' TM / Impcoke Honeylocust	8 & B	2 1/2-3' CAL. 14' MIN HT.	2
	GD	Gymnocladus dioica 'Espresso' / Espresso Kentucky Coffeetree	8 & B	3' Cal	1
	QSC	Quercus x schuetti / Swamp Bur Oak	8 & B	2 1/2-3' CAL. 14' MIN HT.	1
	UMG	Ulmus x 'Morton Glossy' TM / Triumph Elm	8 & B	2 1/2-3' CAL. 14' MIN HT.	5
DECIDUOUS SHRUBS	CODE	BOTANICAL / COMMON NAME	CONT	SIZE	QTY
	Am	Aronia melanocarpa 'Morton' TM / Iroquois Beauty Black Chokeberry	5 gal		1
	Au	Aronia melanocarpa 'UCONNAM165' / Lowscape Mound Chokeberry	3 gal		7
	Cr	Cephalanthus occidentalis 'Balloptica' TM / Fiber Optics Buttonbush	5 gal		2
	Ss	Sorbaria sorbifolia 'Sem' / Sem Ash Leaf Spirea	5 gal		30
EVERGREEN SHRUBS	CODE	BOTANICAL / COMMON NAME	CONT	SIZE	QTY
	Jm	Juniperus chinensis 'Mountbatten' / Chinese Juniper	5 gal	4' HT. (MN.)	3
	Jb	Juniperus scopulorum 'Blue Arrow' / Blue Arrow Juniper	5 gal	4' HT. (MN.)	18
	Pm	Pinus mugo 'Slowmound' / Mugo Pine	5 gal		2
HERBACEOUS PERENNIALS	CODE	BOTANICAL / COMMON NAME	CONT	SIZE	QTY
	asb	Allium tanguticum 'Summer Beauty' / Summer Beauty Allium	1 gal		25
	eb	Eupatorium dubium 'Baby Joe' / Dwarf Joe-Pye Weed	1 gal		11
	nb	Nepeta x faassenii 'Blue Wonder' / Catmint	1 gal		3
ORNAMENTAL GRASSES	CODE	BOTANICAL / COMMON NAME	CONT	SIZE	QTY
	pvs	Panicum virgatum 'Shenandoah' / Shenandoah Switch Grass	1 gal		73

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PROJECT NO: 2019006.00

PROJECT PHASE: SITE AND BUILDING DESIGN 2

DRAWN BY: SAIKI DESIGN CHECKED BY: MSR

PLANTING PLAN SCHEDULES



L-8

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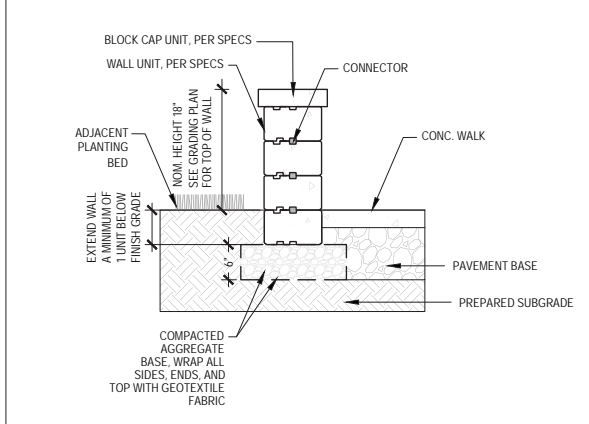
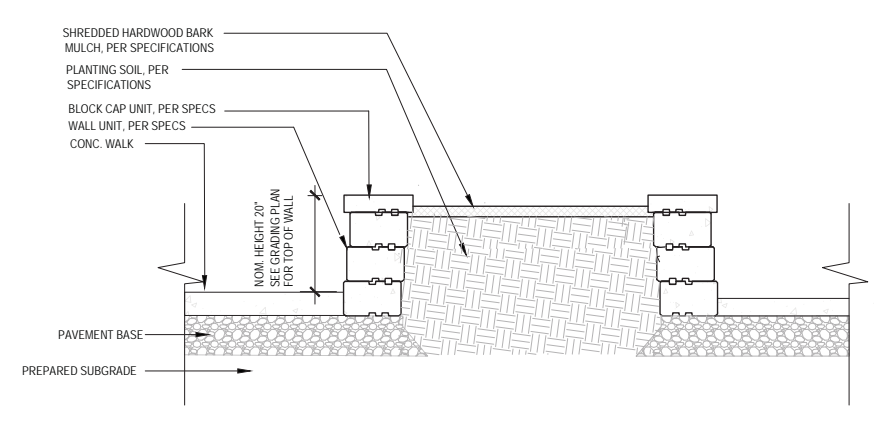
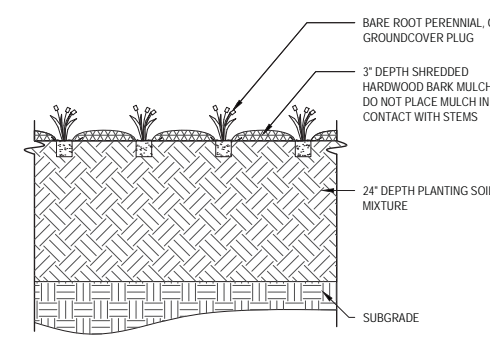
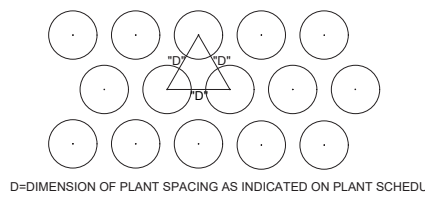
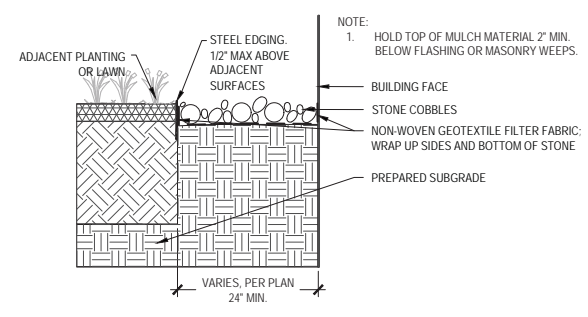
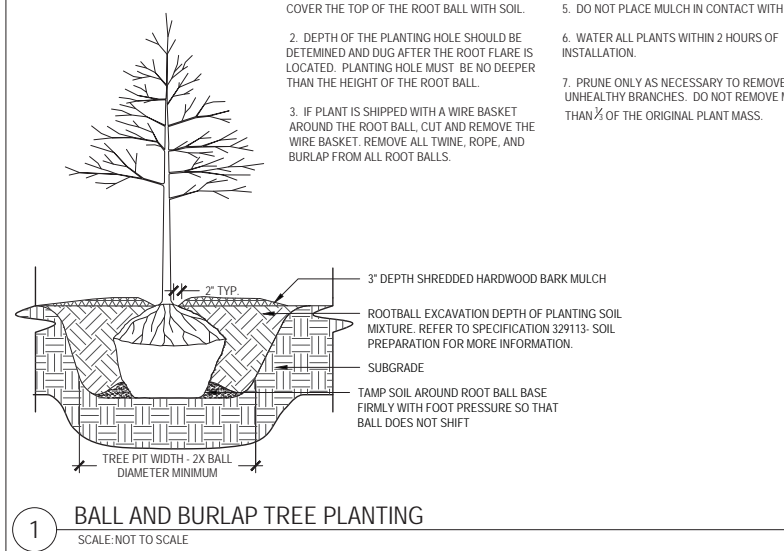
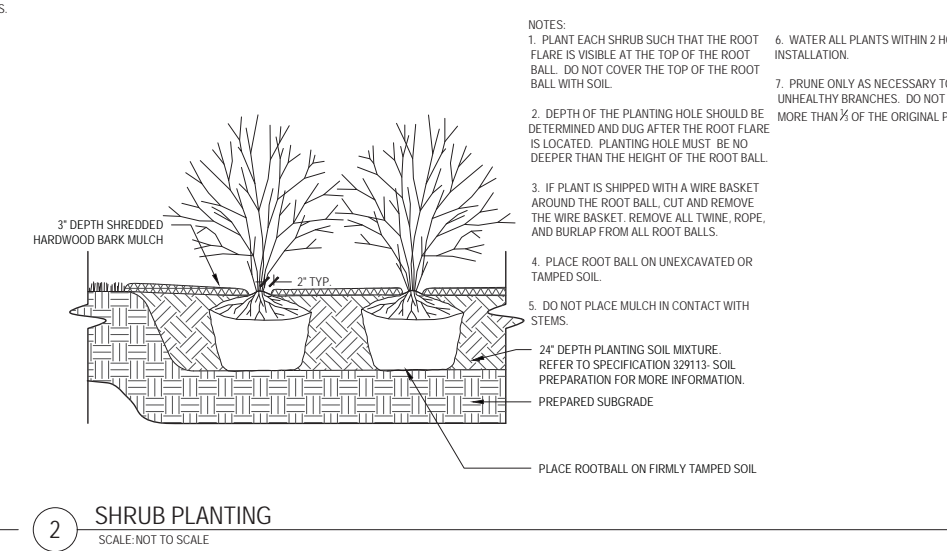
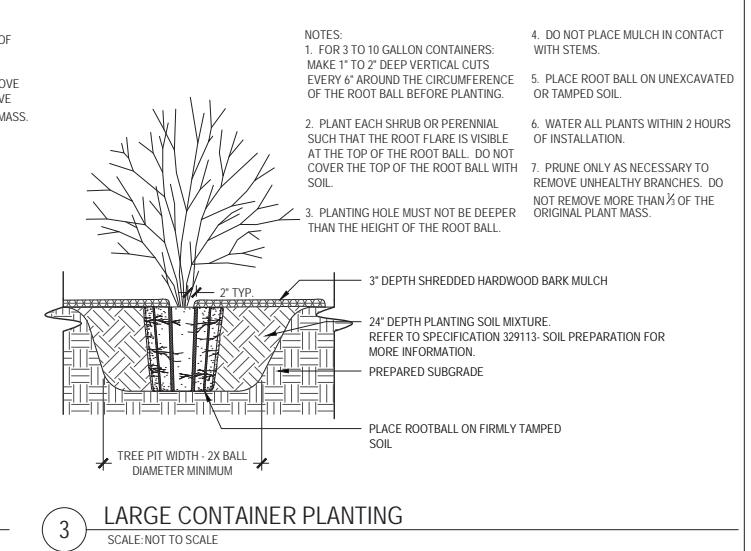
I hereby certify that this plan, specification or report was prepared by me or under my direct supervision and that I am a duly Licensed Architect under the Laws of the State of Minnesota.
 ARCHITECT SEAL

Signature: _____
 Print Name: _____
 Date: _____ License No: _____


ISSUE / REVISION	DATE	DESCRIPTION
01	06.04.2019	SITE + BUILDING DESIGN 1 PRICING ISSUE
02	12.20.2019	LOC INFORMATIONAL SUBMISSION
03	10.20.2019	SITE + BUILDING DESIGN 2 PRICING ISSUE
04	11.13.2019	100% COP DOCUMENTS

PROJECT NO: 2019006.00
 PROJECT PHASE: SITE AND BUILDING DESIGN 2
 DRAWN BY: SAIKI DESIGN CHECKED BY: MSR
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SITE DETAILS



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APPROXIMATE LOCATION OF EXISTING STREET POLE LUMINAIRE (TYP)

ARCHITECTURE AND INTERIORS
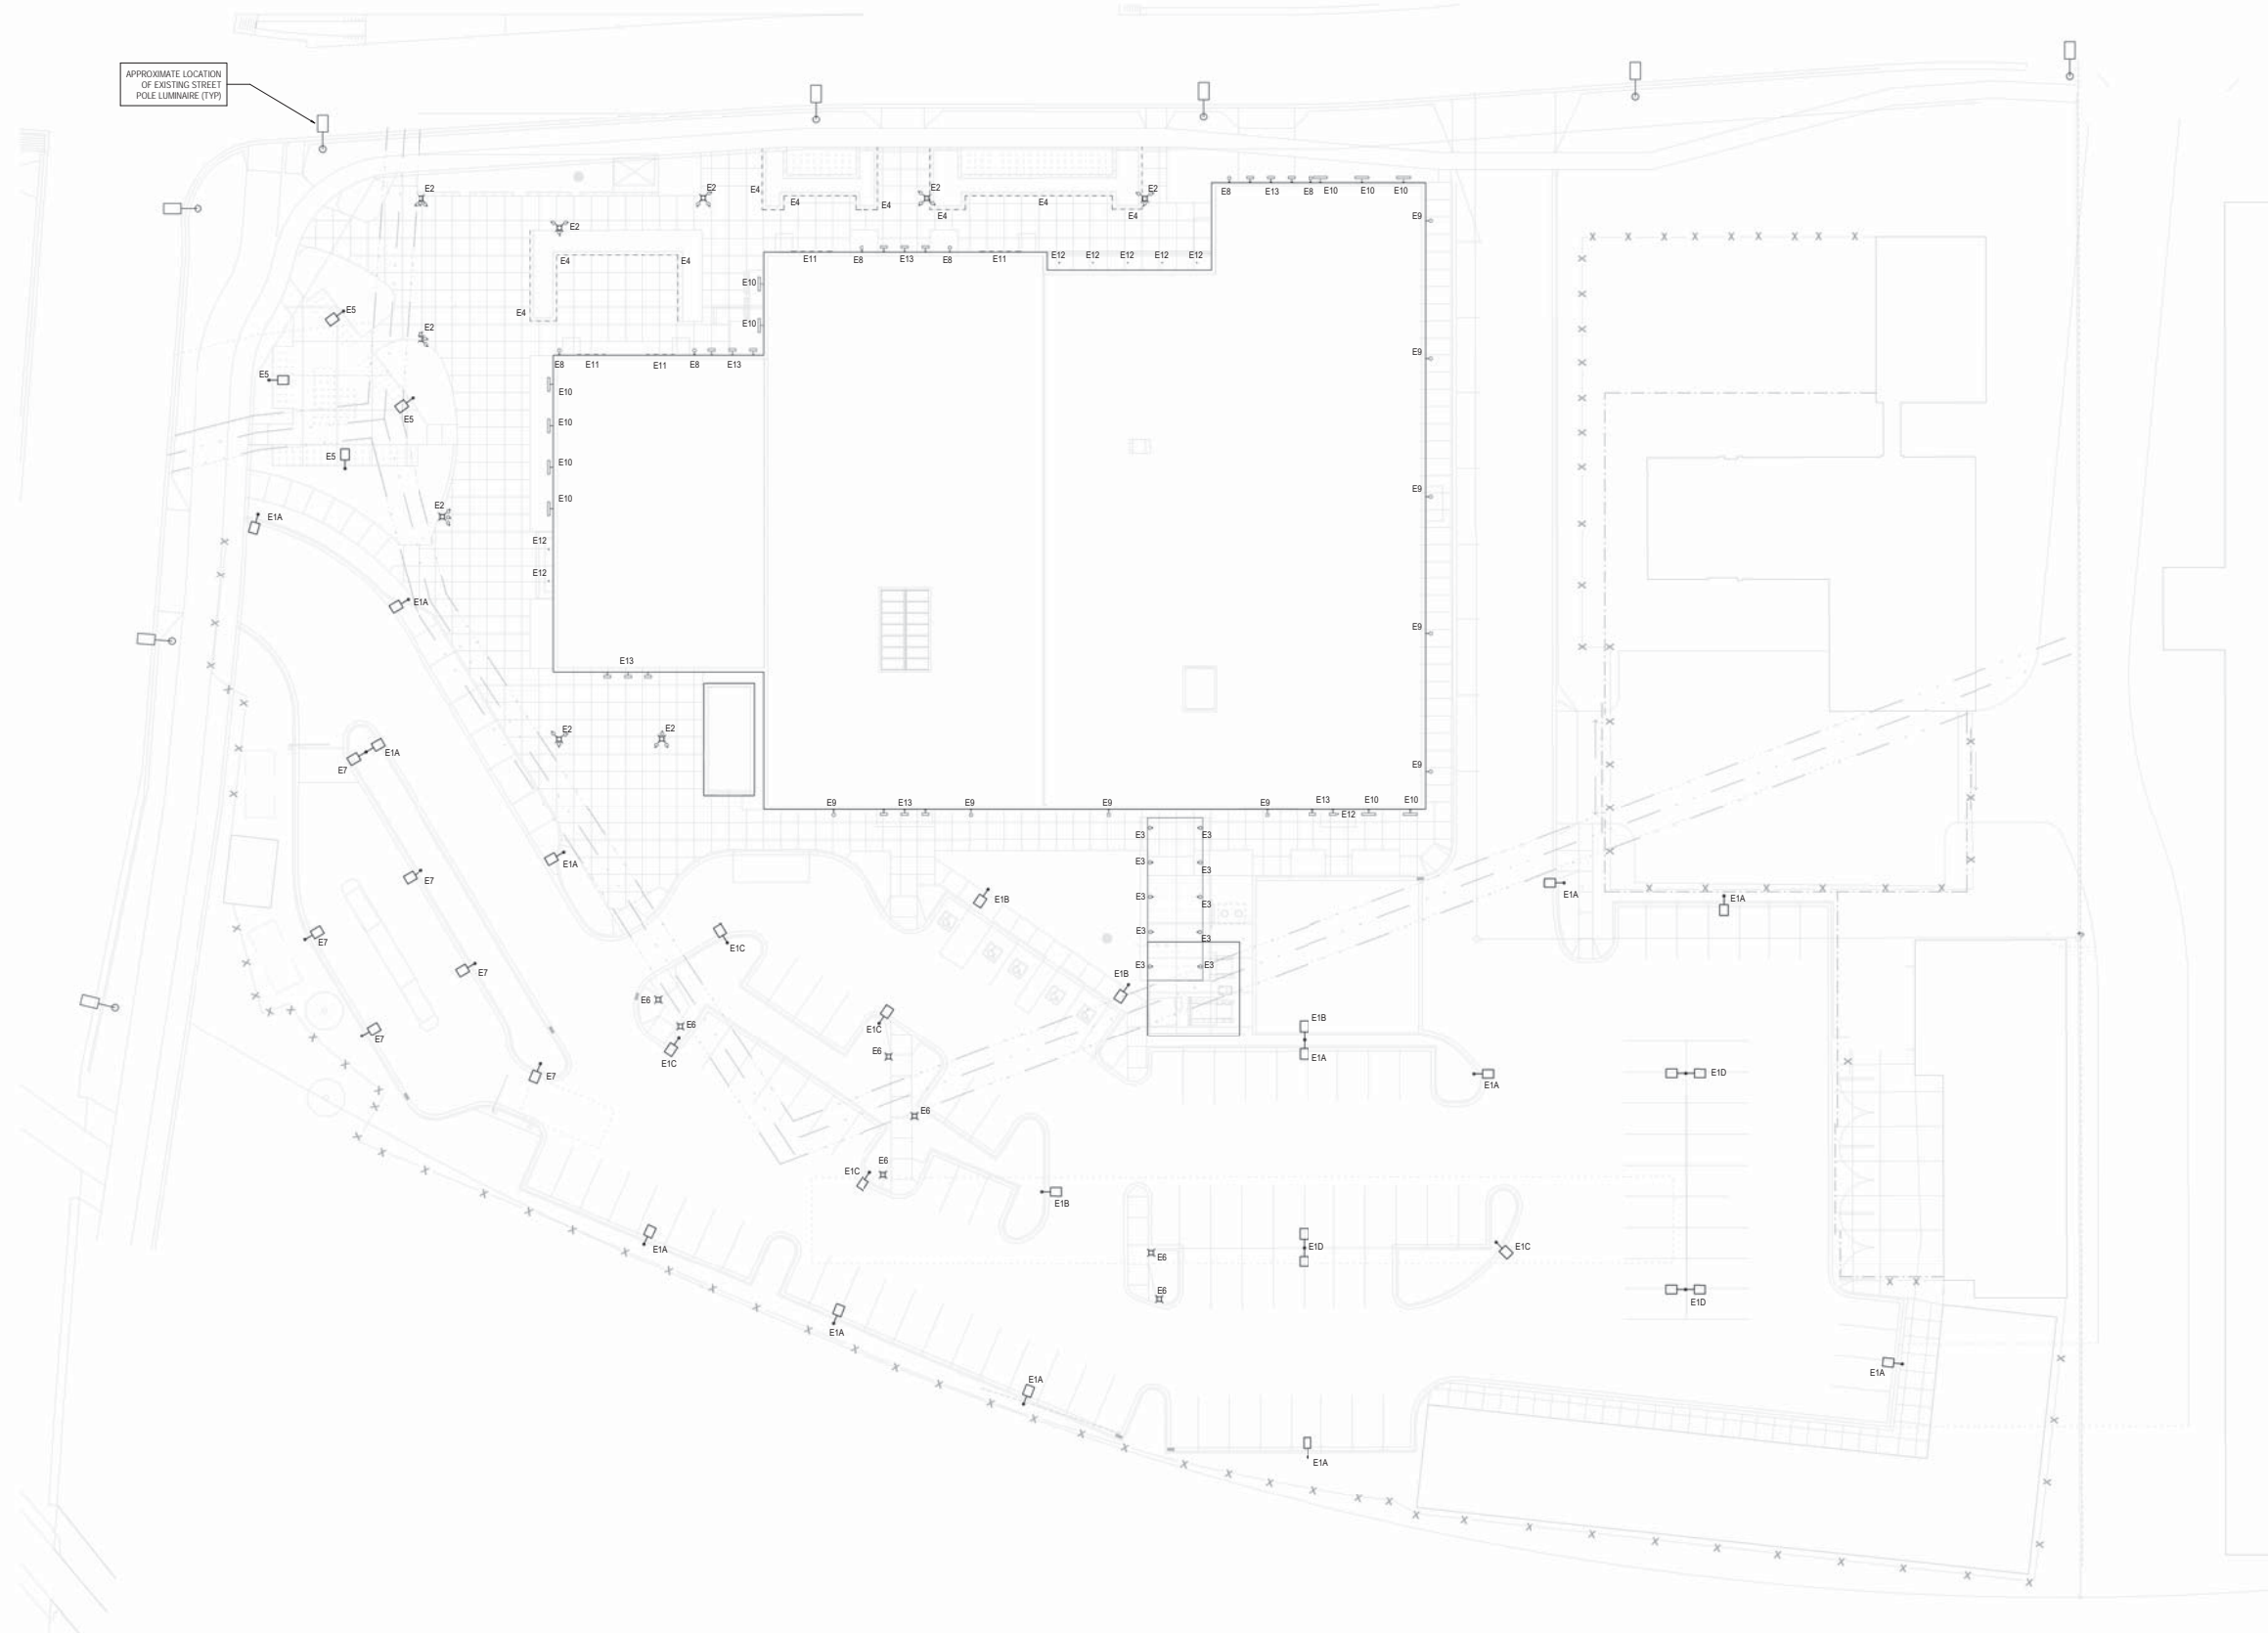
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710 South Second Street, Suite 800
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Landscape Architect

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IMEG Corporation, Inc. 
1800 Deming Way, Suite 200
Madison, WI 53762

Lighting Design

Mazzetti, Inc. 
1909 Broadway, Suite 2205
Denver, CO 80202 | 720.641.5044

Commercial Kitchen Design

Boelter Premier 
7120 Northland Terrace
Minneapolis, MN 55428 | 763.544.8800

MADISON PUBLIC MARKET
200 N First St, Madison, WI 53704

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Signature: _____
Print Name: _____
Date: 8-27-2019 License No: _____

ISSUE / REVISION	DATE	DESCRIPTION
	05.04.2019	SET - BUILDING DESIGN 1 PRICING ISSUE
	06.12.2019	LOC INFORMATIONAL SUBMISSION
	06.18.2019	SET - BUILDING DESIGN 2 PRICING ISSUE
	11.13.2019	100% CDP DOCUMENTS

PROJECT NO: 2019006.00
PROJECT PHASE: 100% CDP DOCUMENTS
DRAWN BY: MAZ
CHECKED BY: BS


SITE LIGHTING PLAN

EL100



1 SITE PLAN
EL100 1" = 20'-0"

NOT FOR CONSTRUCTION

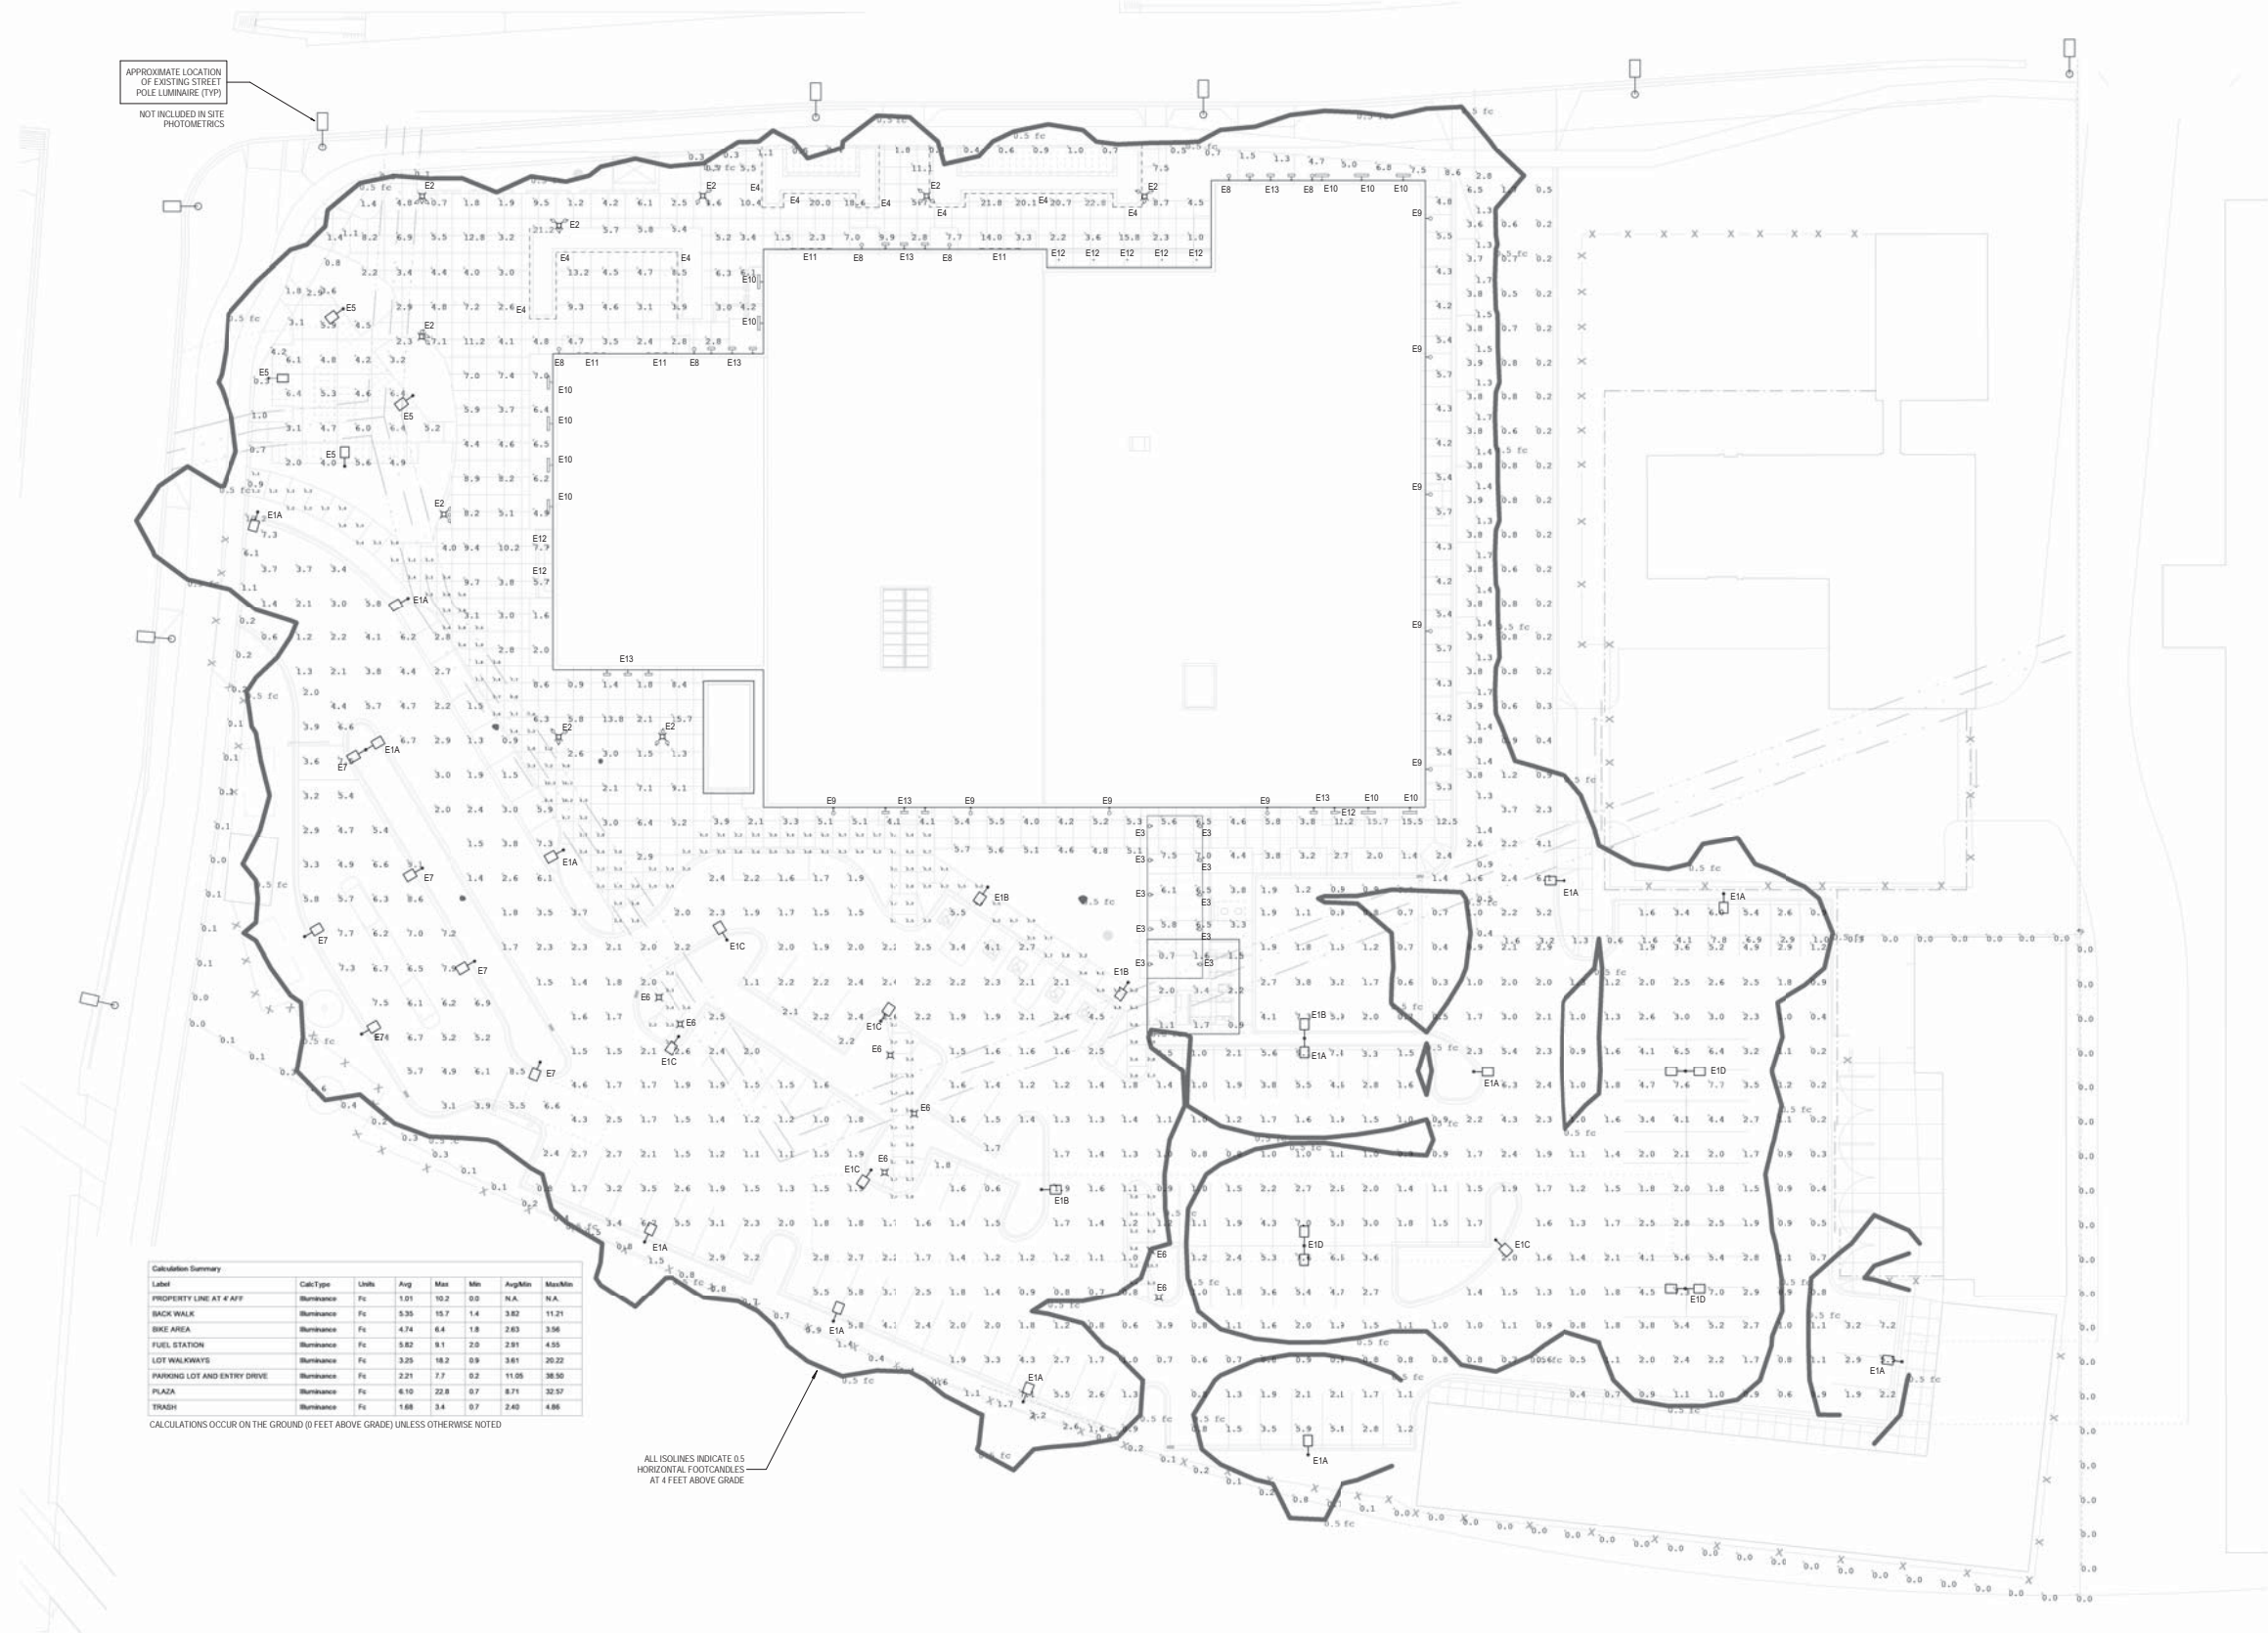

APPROXIMATE LOCATION OF EXISTING STREET POLE LUMINAIRE (TYP) NOT INCLUDED IN SITE PHOTOMETRICS

Calculation Summary

Label	Cell Type	Units	Avg	Max	Min	Avg/Min	Max/Min
PROPERTY LINE AT 4' AFF	Roofcandle	Fc	1.01	10.2	0.0	N.A.	N.A.
BACK WALK	Roofcandle	Fc	5.35	15.7	1.4	3.82	11.21
BIKE AREA	Roofcandle	Fc	4.74	8.4	1.8	2.63	3.56
FUEL STATION	Roofcandle	Fc	3.82	8.1	2.0	2.91	4.05
LOT WALKWAYS	Roofcandle	Fc	3.25	18.2	0.9	3.61	20.22
PARKING LOT AND ENTRY DRIVE	Roofcandle	Fc	2.21	7.7	0.2	11.05	38.50
PLAZA	Roofcandle	Fc	6.10	22.8	0.7	32.71	32.57
TRASH	Roofcandle	Fc	1.68	3.4	0.7	2.40	4.86

CALCULATIONS OCCUR ON THE GROUND (0 FEET ABOVE GRADE) UNLESS OTHERWISE NOTED

ALL ISOLINES INDICATE 0.5 HORIZONTAL FOOTCANDLES AT 4 FEET ABOVE GRADE



ARCHITECTURE AND INTERIORS

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Signature: _____
Print Name: _____
Date: 8/27/2019 License No: _____

DATE	DESCRIPTION
06/04/2019	SITE - BUILDING DESIGN 1 PRICING ISSUE
06/12/2019	LEDC INFORMATIONAL SUBMISSION
06/18/2019	SITE - BUILDING DESIGN 2 PRICING ISSUE
11/13/2019	100% CDP DOCUMENTS

PROJECT NO: 2019006.00


PROJECT PHASE: 100% CDP DOCUMENTS

DRAWN BY: MAZ CHECKED BY: BS

SITE PHOTOMETRIC PLAN

EL101

NOT FOR CONSTRUCTION

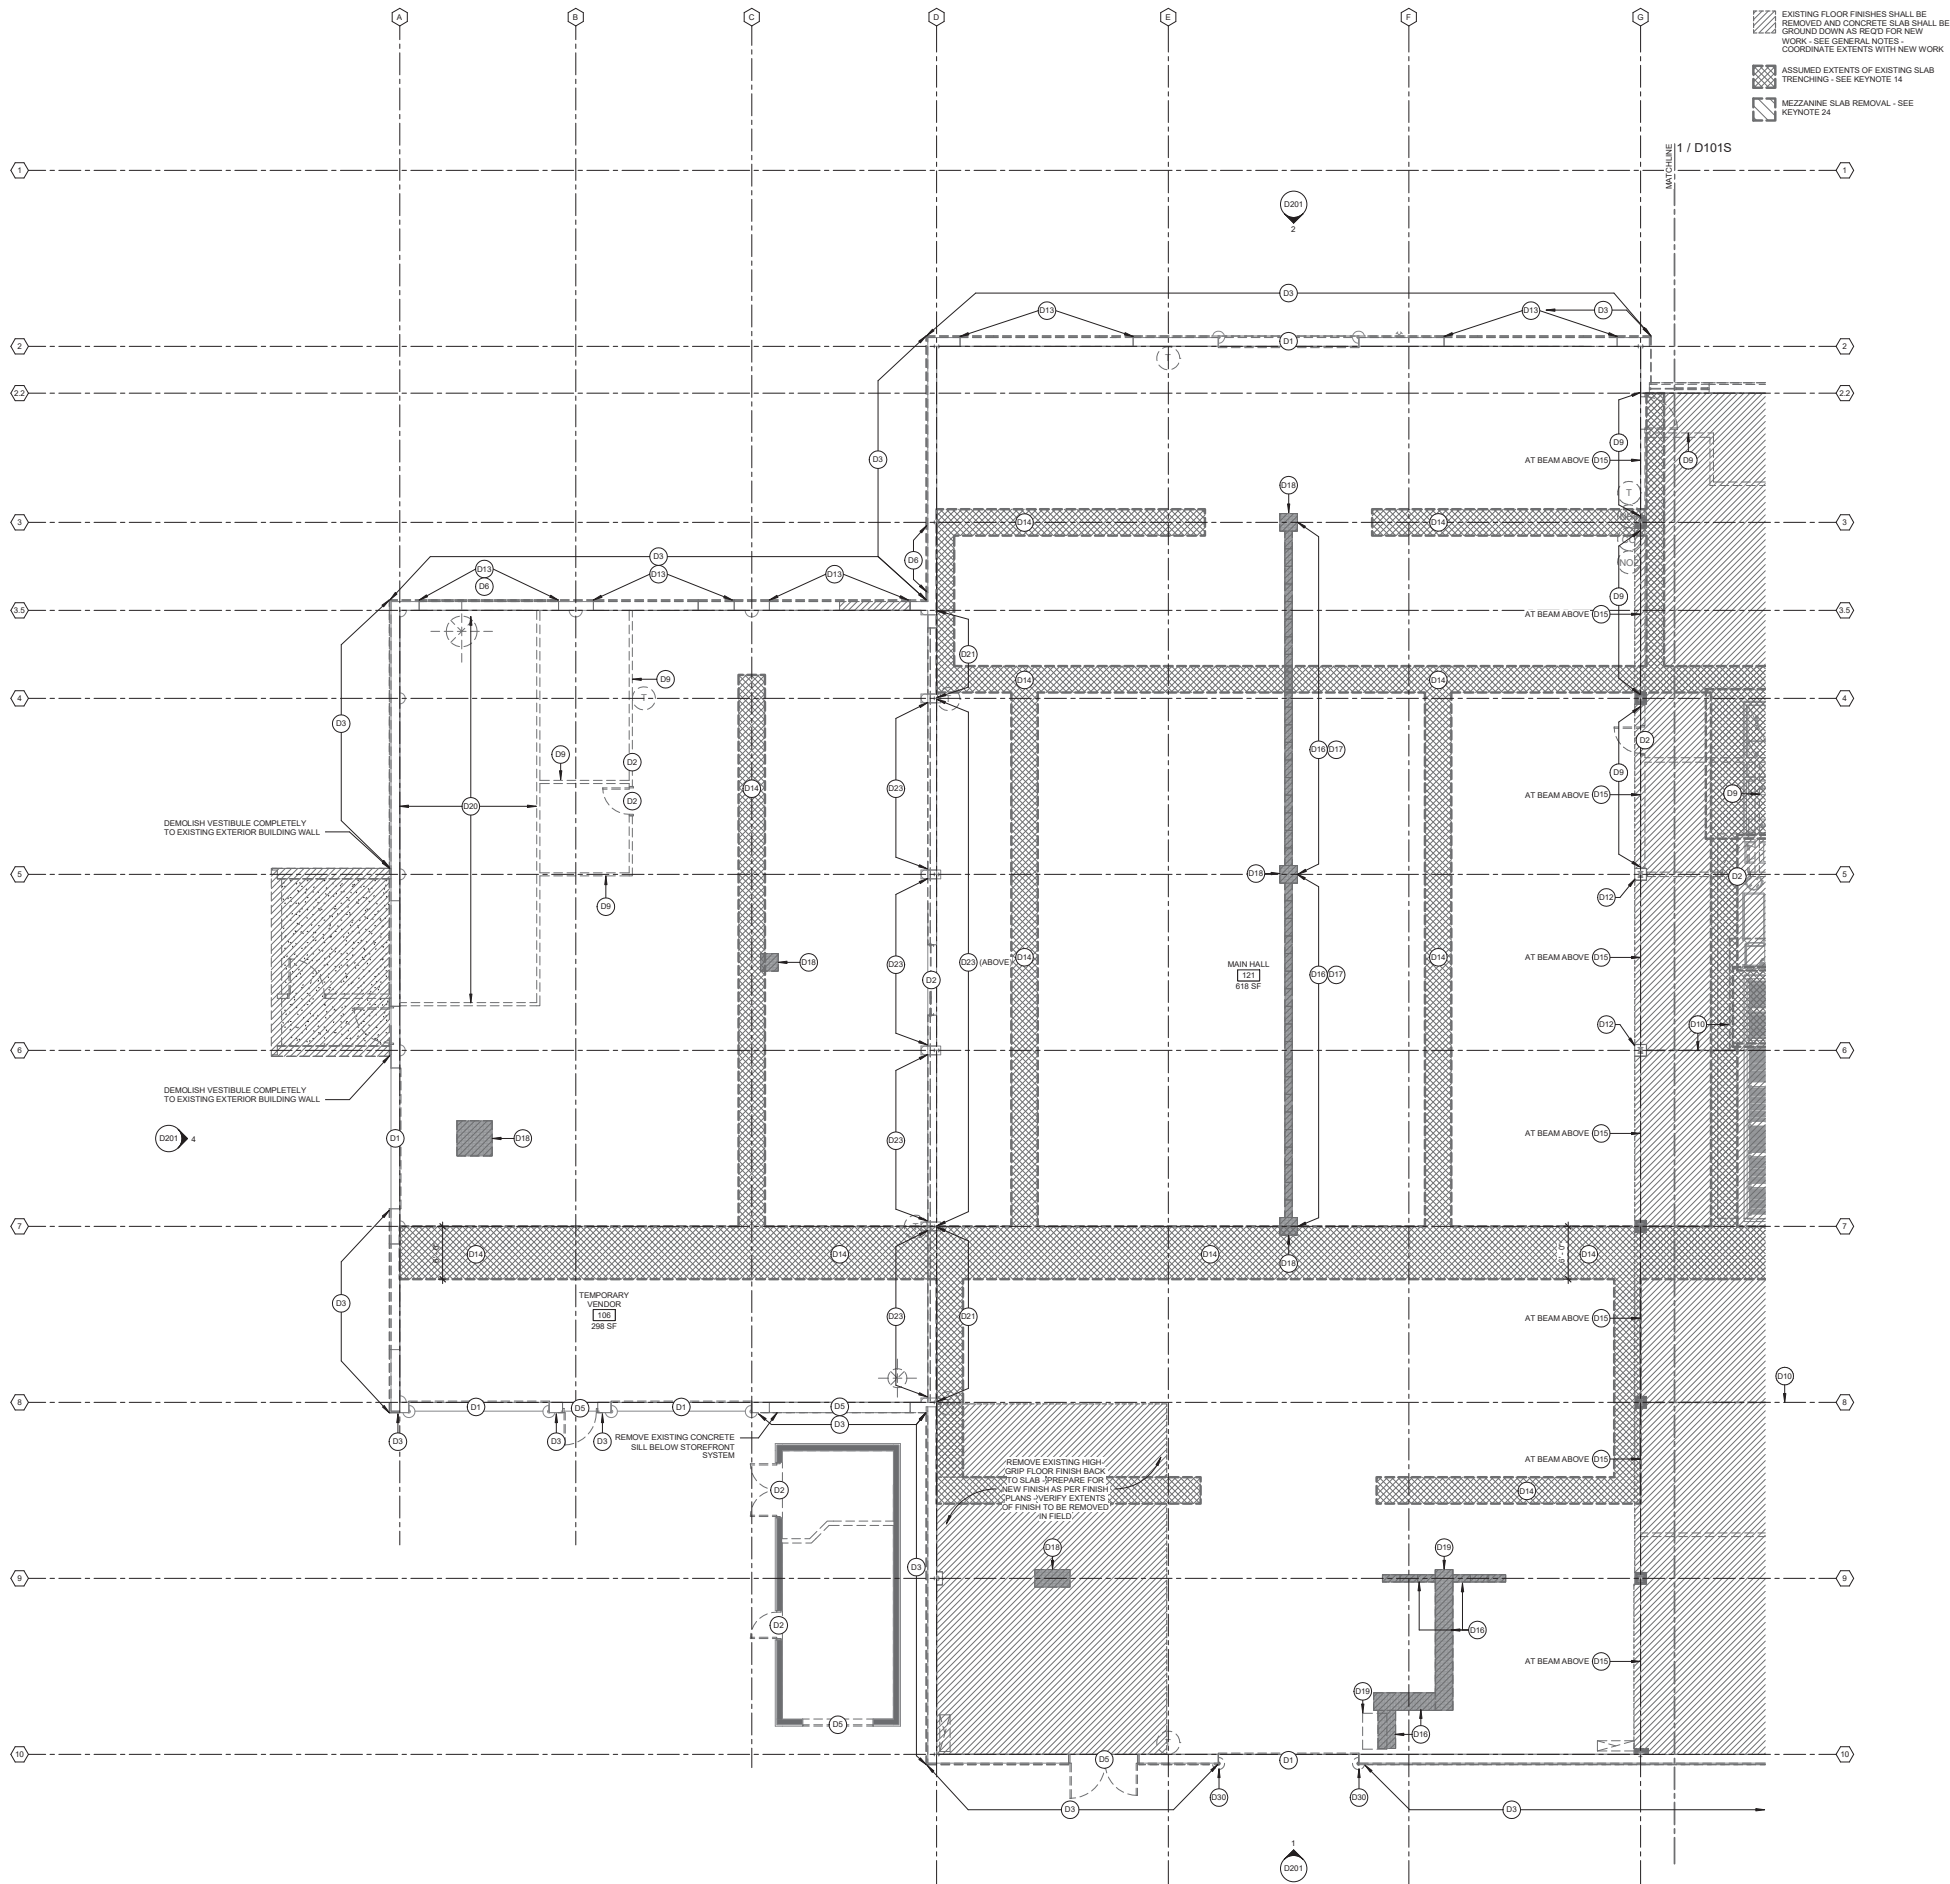

DEMOLITION PLAN LEGEND

- EXISTING FLOOR FINISHES SHALL BE REMOVED AND CONCRETE SLAB SHALL BE GROUND DOWN AS REQ'D FOR NEW WORK - SEE GENERAL NOTES - COORDINATE EXTENTS WITH NEW WORK
- ASSUMED EXTENTS OF EXISTING SLAB TRENCHING - SEE KEYNOTE 14
- MEZZANINE SLAB REMOVAL - SEE KEYNOTE 24

DEMOLITION GENERAL NOTES

1. ALL CONTRACTORS WISHING TO SUBMIT BIDS FOR WORK IN THESE DOCUMENTS SHALL VISIT PROJECT SITE PRIOR TO SUBMITTING A BID AND SHALL VERIFY EXISTING CONDITIONS AND SCOPE OF WORK.
2. ALL LOOSE DEBRIS IS TO BE REMOVED BY DEMOLITION CONTRACTOR
3. NOTIFY ARCHITECT IMMEDIATELY IF FIELD CONDITIONS ARE OTHER THAN WHAT IS SHOWN ON PLANS
4. WHERE DEMOLITION WORK ABUTS OR INTERSECTS EXISTING CONSTRUCTION WHICH IS TO REMAIN, REFER TO NEW CONSTRUCTION DOCUMENTS FOR EXTENTS OF REMOVAL. PROTECT ALL EXISTING CONSTRUCTION TO REMAIN.
5. COORDINATE REMOVAL OF ELEMENTS WHICH MAY CONTAIN HAZARDOUS MATERIALS - I.E. PIPE WRAP, CONTAMINATED SOILS, ETC WITH ABATEMENT CONTRACTOR. NOTIFY OWNER IMMEDIATELY IF HAZARDOUS MATERIALS ARE ENCOUNTERED. HAZARDOUS MATERIALS ABATEMENT IS NOT PART OF THE WORK SHOWN IN THESE DOCUMENTS.
6. FINISHES AT EXISTING INTERIOR SURFACES ARE TO REMAIN UNLESS NOTED OTHERWISE. EXISTING SURFACES TO REMAIN SHALL BE CLEANED AND TREATED AS SPECIFICATIONS. TAKE CARE NOT TO DAMAGE OR REMOVE EXISTING TEXTURES AND PATINA.
7. AT EXISTING SURFACES WHICH SHALL RECEIVE NEW FINISHES, CLEAN AND PREP EXISTING SURFACES FOR NEW FINISH AS PER SURFACE PREP REQUIREMENTS OF NEW FINISH AS PER PROJECT SPECIFICATIONS.
8. GENERAL LOCATIONS WHERE EXISTING EIFS FINISHES ARE REMOVED IN ENTIRETY FOR REPLACEMENT OR PATCH AND REPAIR ARE NOTED ON ELEVATIONS AT THESE LOCATIONS, EIFS SYSTEMS SHALL BE REMOVED IN REGULAR ORTHOGONAL SECTIONS. LINES OF REMOVAL SHALL BE PLUMB AND LEVEL. EXISTING EIFS AT THESE LOCATIONS SHALL BE REMOVED IN ITS ENTIRETY - I.E. FINISH, MESH, INSULATION AND ADHESIVE. SUBSTRATE SHALL BE PREPARED FOR NEW PATCHED EIFS SYSTEM.
9. EXTENTS OF SLAB TRENCHING SHOWN ON ARCHITECTURAL DEMOLITION DRAWINGS FOR PLACEMENT OF BELOW GRADE UTILITIES AND STRUCTURAL WORK IS APPROXIMATE AND MAY NOT REPRESENT FULL EXTENT OF THIS WORK. CONTRACTOR SHALL VERIFY SCOPE OF SLAB REMOVAL WITH REQUIREMENTS OF MEP AND STRUCTURAL AND NEW WORK CONTRACTOR. VERIFY THE EXTENTS OF ALL SLAB REMOVAL WORK WITH ARCHITECT BEFORE PERFORMING.
10. EXTENTS OF SLAB GRINDING SHOWN ON ARCHITECTURAL DEMOLITION DRAWINGS FOR REFINISHING OF EXISTING FLOORS IS APPROXIMATE AND MAY NOT REPRESENT FULL EXTENT OF THIS WORK. CONTRACTOR SHALL VERIFY FULL EXTENTS OF THIS WORK WITH FINISH PLANS AND SURFACE PREPARATION REQUIREMENTS OF SPECIFIED FLOOR FINISHES AS PER PROJECT SPECIFICATIONS.
11. WHERE FINISH FLOORING IS TO BE REMOVED, REMOVE ALL MATERIAL - I.E. FASTENERS, ADHESIVES, AND BACKING TO SLAB BELOW. PREPARE SLAB SURFACE FOR NEW FINISH AS PER REQUIREMENTS OF NEW WORK.
12. ALL OBSOLETE OR ABANDONED MECHANICAL, ELECTRICAL, AND PLUMBING EQUIPMENT - I.E. CONDIT, FITTINGS, DUCTWORK, HANGERS, CONTROLS, FIXTURES, ETC - SHALL BE REMOVED. COORDINATE WITH MEP REMOVAL DRAWINGS.
13. WHERE PARTITIONS ARE REMOVED, REMOVE ALL ITEMS CONTAINED WITHIN - INCLUDING BUT NOT LIMITED TO DOORS, HARDWARE, FRAMES, SLOTTINGS, MECHANICAL AND ELECTRICAL EQUIPMENT, ETC. TO STRUCTURE ABOVE AND BELOW. UNLESS NOTED OTHERWISE.
14. WHERE CEILINGS ARE REMOVED, REMOVE CEILING FINISH AND SUSPENSION SYSTEM ALONG WITH ALL ASSOCIATED FASTENERS, FITTINGS, AND MEP EQUIPMENT. COORDINATE WITH MEP REMOVAL DRAWINGS.
15. SEE DEMOLITION KEYNOTES FOR SPECIFIC INFORMATION ON ITEMS TO BE REMOVED BY LOCATION.

KEYED NOTES (DEMOLITION)

- D1 REMOVE EXISTING OVERHEAD DOOR AND ALL FRAME/HARDWARE/MOTOR COMPONENTS BACK TO ROUGH OPENING
- D2 REMOVE EXISTING DOOR(S) AND FRAME(S) TO ROUGH OPENING
- D3 REMOVE EIFS PANEL FROM CONCRETE FOUNDATION WALL. CLEAN CONCRETE TO PREPARE FOR NEW WATERPROOFING - COORDINATE WITH NEW WORK
- D4 CUT AND REMOVE SECTION OF DAMAGED EXISTING EIFS SYSTEM BACK TO SUBSTRATE. PREPARE SUBSTRATE FOR NEW PATCH AND REPAIR WORK AS PER EIFS MANUFACTURER'S RECOMMENDATION
- D5 REMOVE EXISTING STOREFRONT GLAZING SYSTEM AND ALL FLASHING/TRIM/SSLS BACK TO ROUGH OPENING. REFERENCE NEW WORK FOR EXISTING MISC. STEEL TO REMAIN IN OPENINGS. PATCH AND REPAIR MASONRY FOR NEW CURTAIN WALL SYSTEM
- D6 REMOVE PORTION OF EXTERIOR MASONRY WALL COMPLETELY. REMOVE EXISTING EIFS FINISH AS REQ'D TO TOOTH IN NEW CMU - REF. EXTERIOR ELEVATIONS
- D7 REMOVE PART OF EXISTING FLOOR/ROOF IN PREPARATION FOR ELEVATOR SHAFT
- D8 REMOVE EXISTING STAIR COMPLETELY
- D9 REMOVE EXISTING INTERIOR WALL COMPLETELY
- D10 REMOVE EXISTING INTERIOR WIRE PARTITION. SALVAGE, CLEAN, AND STORE FOR REUSE
- D11 REMOVE EXISTING PLUMBING FIXTURES AND PLUMBING WALL CAVITY
- D12 REMOVE EXISTING CMU COLUMN WRAP AND ANY TIE BACKS OR ANCHORS TO BLD. SLAB OR DECK ABOVE. PREPARE NEWLY EXPOSED STEEL FOR NEW FINISH - REF. FINISH PLANS
- D13 REMOVE EXISTING EXTERIOR CONCRETE WALL TO 2" BELOW F.F.E. SAW CUT CONCRETE CLEANLY, ALIGNED WITH CMU JAMBS ABOVE TO CREATE CLEAN ROUGH OPENING FOR NEW CURTAIN WALL
- D14 SAW CUT AND DEMOLISH EXISTING SLAB AS REQ'D FOR NEW WORK BELOW GRADE - WHERE HATCHED REGION IS DIMENSIONED, SLAB SHALL BE REMOVED AS PER INDICATED EXTENTS. CUTS SHALL BE STRAIGHT AND CONTINUOUS. WHERE NOT DIMENSIONED - COORDINATE REMOVAL REQUIREMENTS WITH NEW STRUCTURAL AND PLUMBING WORK
- D15 DEMOLISH EXISTING PLASTER CEILING AND SOFFIT WRAP AND ALL SUSPENSION - FRAMING, HANGERS, BOSS, DECK ETC. CUTS TO DECK. CLEAN NEWLY EXPOSED STEEL DECK, JOIST AND FRAMING - REF. ARCHITECTURAL CEILING PLANS FOR ANY NEW FINISHES
- D16 REMOVE EXISTING TRENCH GRATE. PROVIDE TEMPORARY COVER
- D17 CLEAN/REPLACE EXISTING TRENCH DRAIN LINING AS REQUIRED FOR NEW WORK - COORDINATE WITH MEP
- D18 EXISTING TRENCH BASIN TO BE ABANDONED AND FILLED - REF. PLUMBING DEMOLITION DRAWINGS FOR RELATED WORK
- D19 EXISTING OWNERS EQUIPMENT TO BE DECOMMISSIONED AND REMOVED BY OWNER - COORDINATE WITH OWNER
- D20 EXISTING PAINT BOOTH AND ALL RELATED EQUIPMENT - FANS, POWER, DUCTWORK, ETC SHALL BE DECOMMISSIONED AND REMOVED BY OWNER. ALL EXISTING OPENINGS IN SLAB, WALLS AND ROOF SHALL BE PREPARED FOR REPAIR AND PATCHING IN NEW WORK BY GC
- D21 EXISTING STEEL AND GLASS WINDOW WALL TO BE PARTIALLY DEMOLISHED. REMOVE TOGGLE BOLTS RETAINING GLAZED PANELS. GLAZED PANELS SHALL BE CLEANED AND SALVAGED FOR RE-USE IN BUILDING PARTITIONS - REF. NEW WORK. REMOVE OTHER FRAMING COMPONENTS OF GLAZED WALL AS REQ'D - REF. NEW ARCHITECTURAL ELEVATIONS FOR EXTENTS
- D22 CLEAN EXISTING STEEL AND GLASS WINDOW WALL TO REMAIN. PROVIDE TEMPORARY SUPPORT AND PROTECT IN PLACE - REFERENCE STRUCTURAL
- D23 SAW CUT STRAIGHT AND DEMOLISH CONCRETE WALL BELOW STEEL AND GLASS TO BELOW F.F.E. AS REQ'D FOR NEW WORK - REF. ARCHITECTURAL DETAILS AT THIS LOCATION. CONCRETE PIERCE AT COLUMN BASES SHALL REMAIN - REF. STRUCTURAL FOR EXTENTS OF WALL TO REMAIN.
- D24 REMOVE MEZZANINE FLOOR SLAB AND FRAMING - REFER TO STRUCTURAL
- D25 CUT HOIST AND MOUNTING BRACKETS FROM EXISTING OPENING JAMB. CLEAN AND SALVAGE FOR RE-USE
- D26 DEMOLISH EXISTING SLAB AS REQUIRED FOR NEW KITCHEN EQUIPMENT - REFERENCE STRUCTURAL
- D27 REFERENCE PLUMBING DRAWINGS FOR WORK ASSOCIATED WITH NEW COMMERCIAL KITCHEN EQUIPMENT IN THIS AREA
- D28 DEMOLISH EXTERIOR LIGHT FIXTURE. PREPARE EXISTING EIFS FOR PATCH AND REPAIR
- D29 DEMOLISH EXTERIOR SIGNAGE AND ALL RELATED FASTENERS AND HARDWARE - PREPARE EXISTING EIFS FOR PATCH AND REPAIR
- D30 REMOVE EXISTING WHEEL STOP - REPAIR CONCRETE SUBSTRATE AND PREPARE FOR NEW FINISH WORK
- D31 DEMOLISH EXISTING CANOPY FASCIA, FLASHING, EPDM MEMBRANE AND SOFFIT MATERIAL AS REQ'D TO ACCOMMODATE NEW WORK IN THIS AREA - REF. ARCHITECTURAL DETAILS
- D32 REMOVE EXISTING ROOF SYSTEM AND STRUCTURAL DECK FOR NEW ROOF PENETRATION. COORDINATE WITH ARCHITECTURAL AND M.E.P. NEW WORK. PROVIDE TEMPORARY ENCLOSURE AT ALL NEW ROOF PENETRATIONS

Architecture and Interiors

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 Project No: 20190300.00

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Architect Seal

Signature _____
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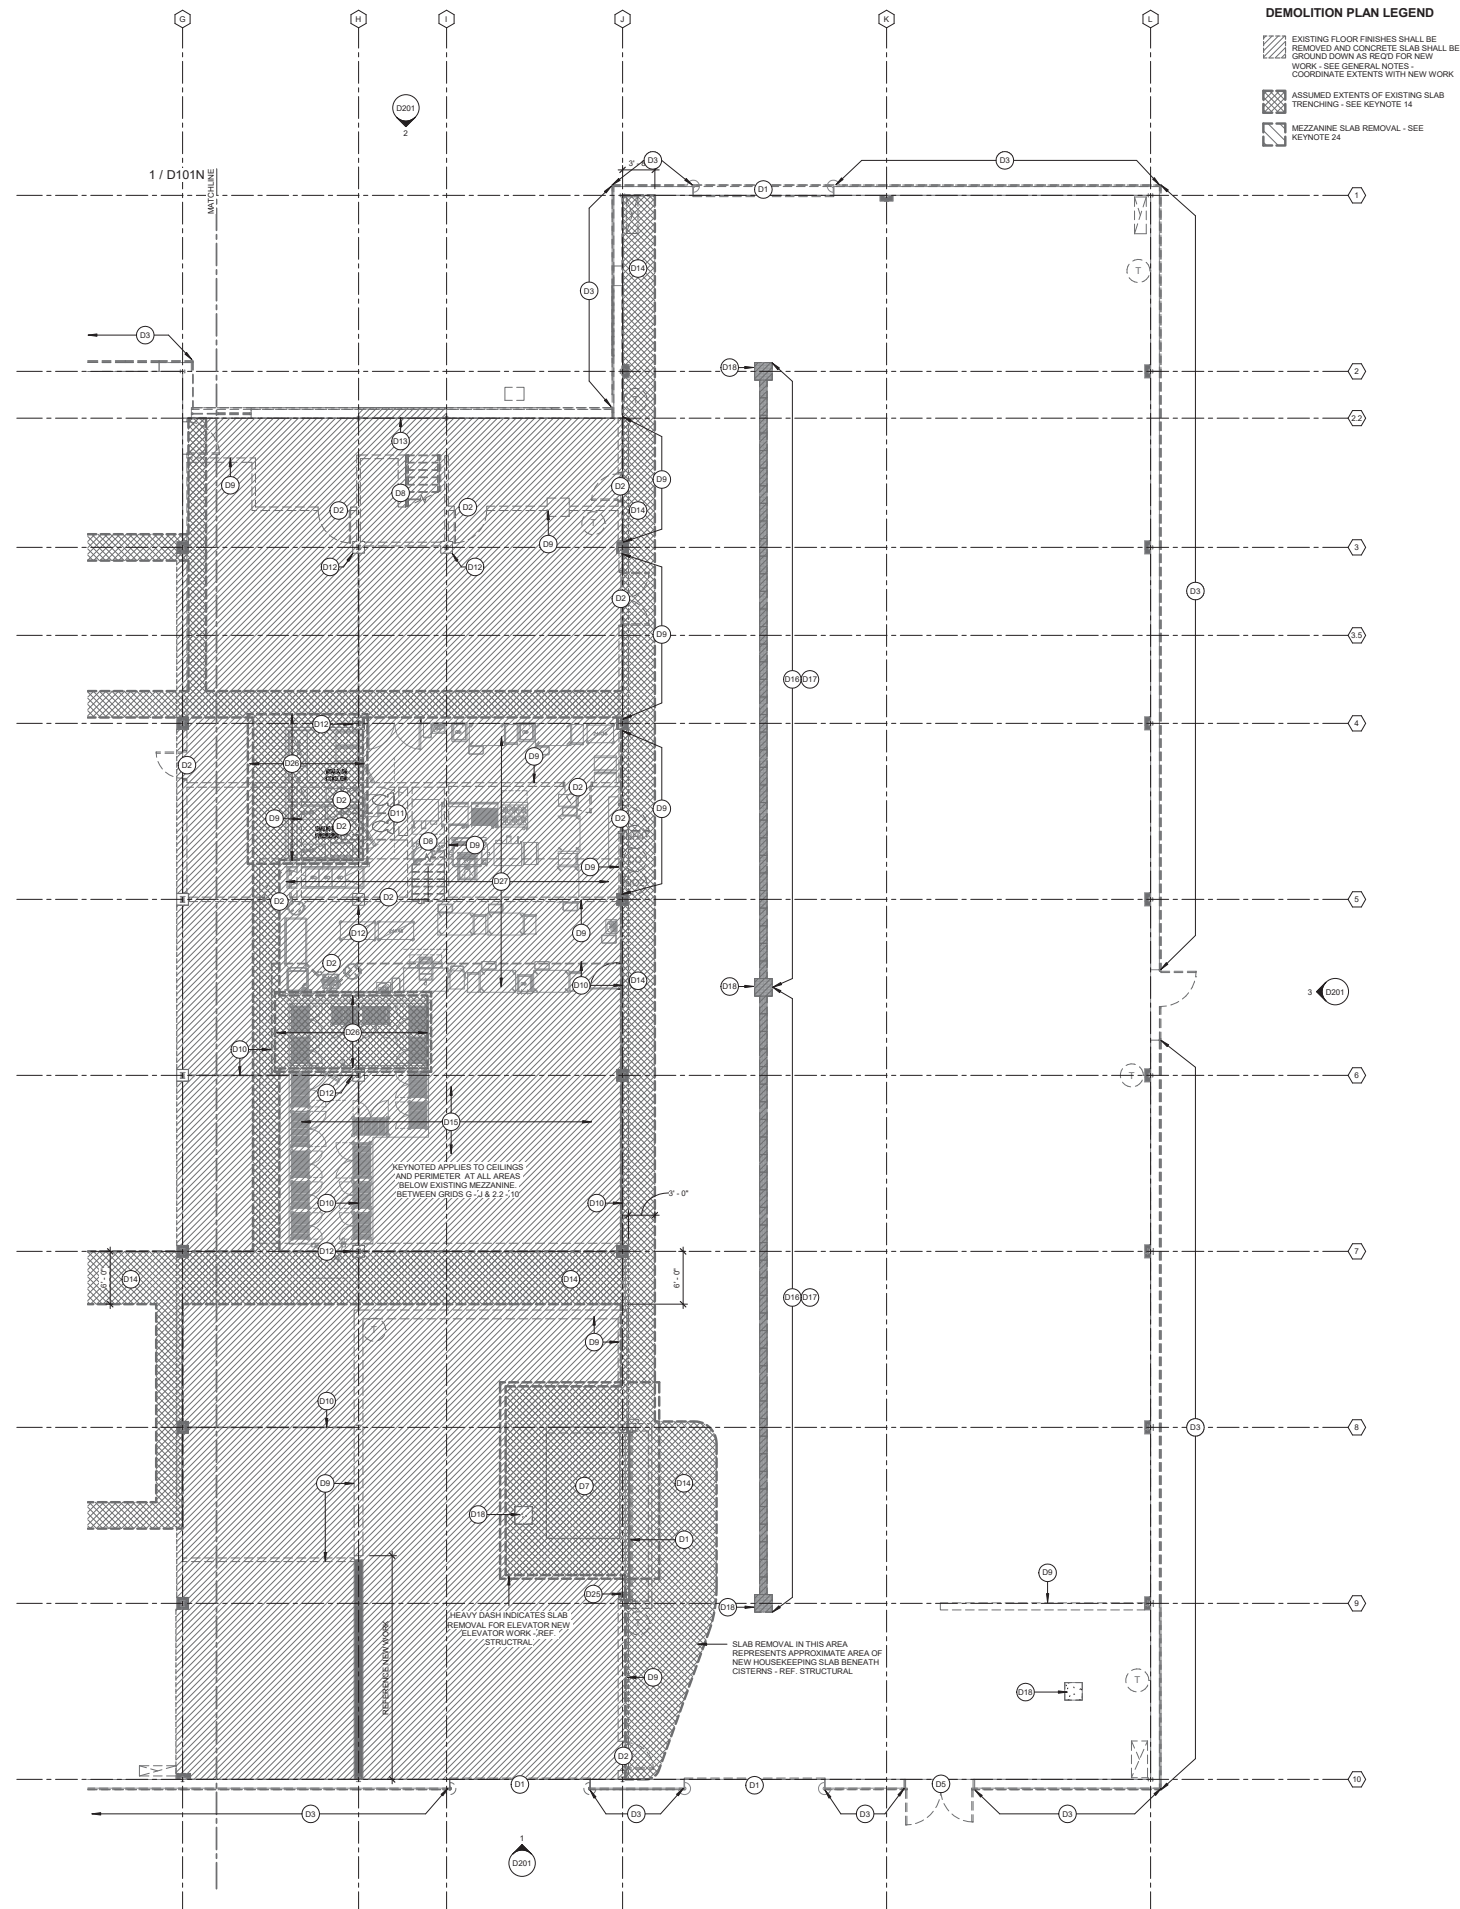
ISSUE / REVISION

Mark	Date	Description
06.04.2019	SITE + BUILDING DESIGN 1 PRICING ISSUE	
08.12.2019	LOC INFORMATIONAL SUBMISSION	
08.16.2019	SITE + BUILDING DESIGN 2 PRICING ISSUE	
11.13.2019	100% CDP DOCUMENTS	

LEVEL 1 DEMOLITION - NORTH

D101N

NOT FOR CONSTRUCTION



DEMOLITION PLAN LEGEND

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13. WHERE PARTITIONS ARE REMOVED, REMOVE ALL ITEMS CONTAINED WITHIN - INCLUDING BUT NOT LIMITED TO DOORS, HARDWARE, FRAMES, SLOTTINGS, MECHANICAL AND ELECTRICAL EQUIPMENT, ETC TO STRUCTURE ABOVE AND BELOW. UNLESS NOTED OTHERWISE.
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15. SEE DEMOLITION KEYNOTES FOR SPECIFIC INFORMATION ON ITEMS TO BE REMOVED BY LOCATION

KEYED NOTES (DEMOLITION)

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- D4 CUT AND REMOVE SECTION OF DAMAGED EXISTING EIFS SYSTEM BACK TO SUBSTRATE. PREPARE SUBSTRATE FOR NEW PATCH AND REPAIR WORK AS PER EIFS-2 MANUF'S RECOMMENDATION
- D5 REMOVE EXISTING STOREFRONT GLAZING SYSTEM AND ALL FLASHING/TRIM/SEALS BACK TO ROUGH OPENING. REFERENCE NEW WORK FOR EXISTING MISC. STEEL TO REMAIN IN OPENINGS. PATCH AND REPAIR MASONRY FOR NEW CURTAIN WALL SYSTEM
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- D12 REMOVE EXISTING CMU COLUMN WRAP AND ANY TIE BACKS OR ANCHORS TO B/D SLAB OR DECK ABOVE. PREPARE NEWLY EXPOSED STEEL FOR NEW FINISH - REF. FINISH PLANS
- D13 REMOVE EXISTING EXTERIOR CONCRETE WALL TO 2" BELOW F.F.E. SAW CUT CONCRETE CLEANLY, ALIGNED WITH CMU JAMBS ABOVE TO CREATE CLEAN ROUGH OPENING FOR NEW CURTAIN WALL
- D14 SAW CUT AND DEMOLISH EXISTING SLAB AS REQ'D FOR NEW WORK BELOW GRADE - WHERE HATCHED REGION IS DIMENSIONED, SLAB SHALL BE REMOVED AS PER INDICATED EXTENTS. CUTS SHALL BE STRAIGHT AND CONTINUOUS. WHERE NOT DIMENSIONED - COORDINATE REMOVAL REQUIREMENTS WITH NEW STRUCTURAL AND PLUMBING WORK
- D15 DEMOLISH EXISTING PLASTER CEILING AND SOFFIT WRAP AND ALL SUSPENSION - FRAMING - HANGERS, RODS, DECK CLIPS, ETC BACK TO DECK. CLEAN NEWLY EXPOSED STEEL DECK, JOIST AND FRAMING - REF. ARCHITECTURAL, CEILING PLANS FOR ANY NEW FINISHES
- D16 REMOVE EXISTING TRENCH GRATE. PROVIDE TEMPORARY COVER
- D17 CLEAN/REPLACE EXISTING TRENCH DRAIN LINING AS REQUIRED FOR NEW WORK. COORDINATE WITH MEP
- D18 EXISTING TRENCH BASIN TO BE ABANDONED AND INFILLED - REF. PLUMBING DEMOLITION DRAWINGS FOR RELATED WORK
- D19 EXISTING OWNER'S EQUIPMENT TO BE DECOMMISSIONED AND REMOVED BY OWNER - COORDINATE WITH OWNER
- D20 EXISTING PAINT BOOTH AND ALL RELATED EQUIPMENT - FANS, POWER, DUCTWORK, ETC SHALL BE DECOMMISSIONED AND REMOVED BY OWNER. ALL EXISTING OPENINGS IN SLAB, WALLS AND ROOF SHALL BE PREPARED FOR REPAIR AND PATCHING IN NEW WORK BY GC
- D21 EXISTING STEEL AND GLASS WINDOW WALL TO BE PARTIALLY DEMOLISHED. REMOVE FRAGILE BELT RETAINING GLAZED PANELS. GLAZED PANELS SHALL BE CLEANED AND SALVAGED FOR RE-USE IN SLIDING PARTITIONS - REF. NEW WORK. REMOVE OTHER FRAMING COMPONENTS OF GLAZED WALL AS REQ'D - REF. NEW ARCHITECTURAL ELEVATIONS FOR EXTENTS.
- D22 CLEAN EXISTING STEEL AND GLASS WINDOW WALL TO REMAIN. PROVIDE TEMPORARY SUPPORT AND PROTECT IN PLACE - REFERENCE STRUCTURAL
- D23 SAW CUT STRAIGHT AND DEMOLISH CONCRETE WALL BELOW STEEL AND GLASS TO BELOW F.F.E. AS REQ'D FOR NEW WORK - REF. ARCHITECTURAL DETAILS AT THIS LOCATION. CONCRETE PIERS AT COLUMN BASES SHALL REMAIN - REF. STRUCTURAL FOR EXTENTS OF WALL TO REMAIN.
- D24 REMOVE MEZZANINE FLOOR SLAB AND FRAMING - REFER TO STRUCTURAL
- D25 CUT HOIST AND MOUNTING BRACKETS FROM EXISTING OPENING JAMB. CLEAN AND SALVAGE FOR RE-USE.
- D26 DEMOLISH EXISTING SLAB AS REQUIRED FOR NEW KITCHEN EQUIPMENT - REFERENCE STRUCTURAL
- D27 REFERENCE PLUMBING DRAWINGS FOR WORK ASSOCIATED WITH NEW COMMERCIAL KITCHEN EQUIPMENT IN THIS AREA
- D28 DEMOLISH EXTERIOR LIGHT FIXTURE. PREPARE EXISTING EIFS FOR PATCH AND REPAIR
- D29 DEMOLISH EXTERIOR SIGNAGE AND ALL RELATED FASTENERS AND HARDWARE - PREPARE EXISTING EIFS FOR PATCH AND REPAIR
- D30 REMOVE EXISTING WHEEL STOP - REPAIR CONCRETE SUBSTRATE AND PREPARE FOR NEW FINISH WORK
- D31 DEMOLISH EXISTING CANOPY FASCIA, FLASHING, EPDM MEMBRANE AND SOFFIT MATERIAL AS REQ'D TO ACCOMMODATE NEW WORK IN THIS AREA - REF. ARCHITECTURAL DETAILS
- D32 REMOVE EXISTING ROOF SYSTEM AND STRUCTURAL DECK FOR NEW ROOF PENETRATION - COORDINATE WITH ARCHITECTURAL AND I.E.P. NEW WORK. PROVIDE TEMPORARY ENCLOSURE AT ALL NEW ROOF PENETRATIONS

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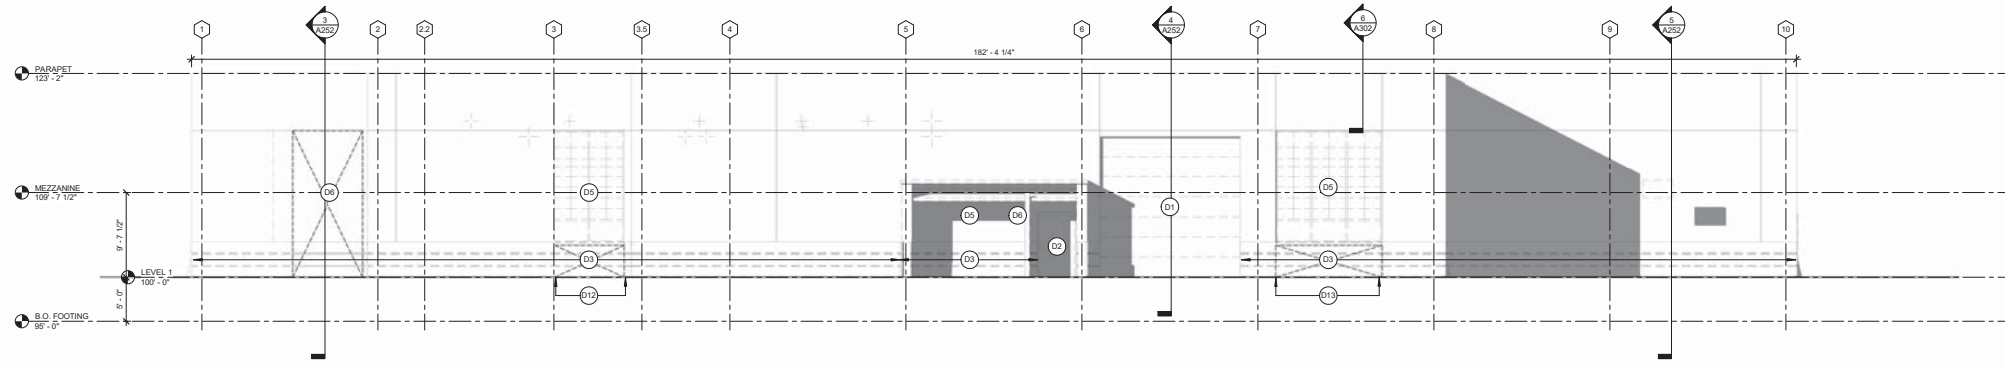
ISSUE / REVISION

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08.18.2019	SITE + BUILDING DESIGN 2 PRICING ISSUE	
11.13.2019	100% CDP DOCUMENTS	


LEVEL 1 DEMOLITION - SOUTH

D101S


NOT FOR CONSTRUCTION




4 DEMO ELEVATION - NORTH
D201 1/8" = 1'-0"

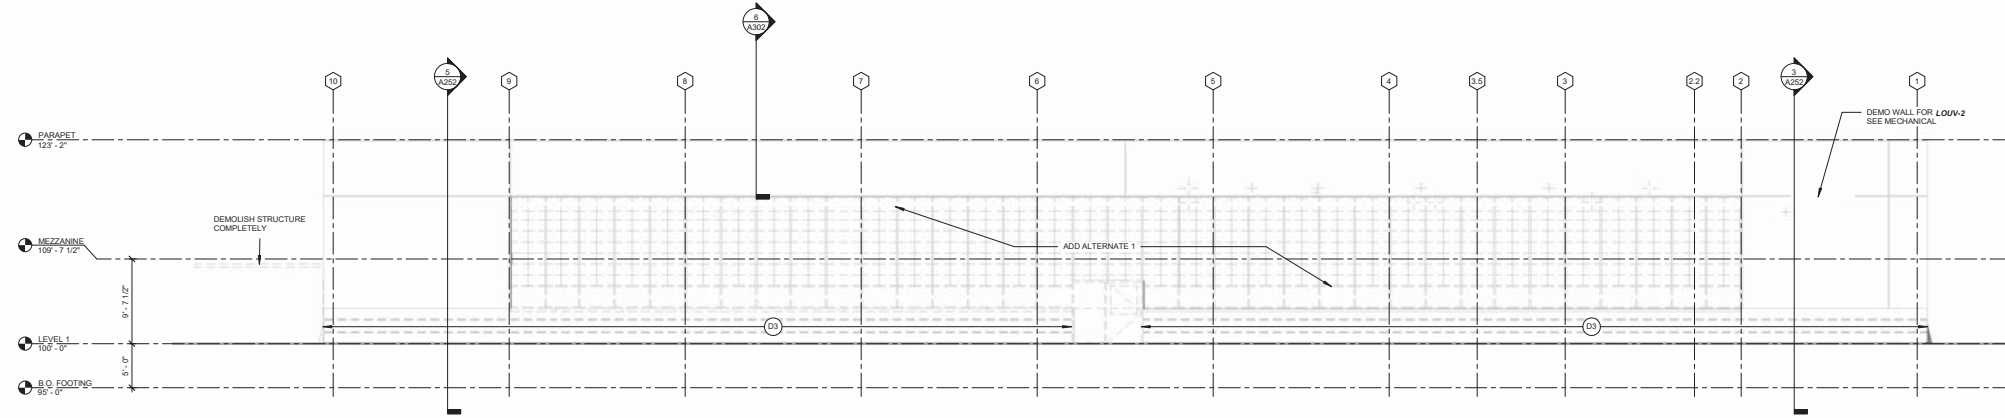

3 DEMO ELEVATION - SOUTH
D201 1/8" = 1'-0"

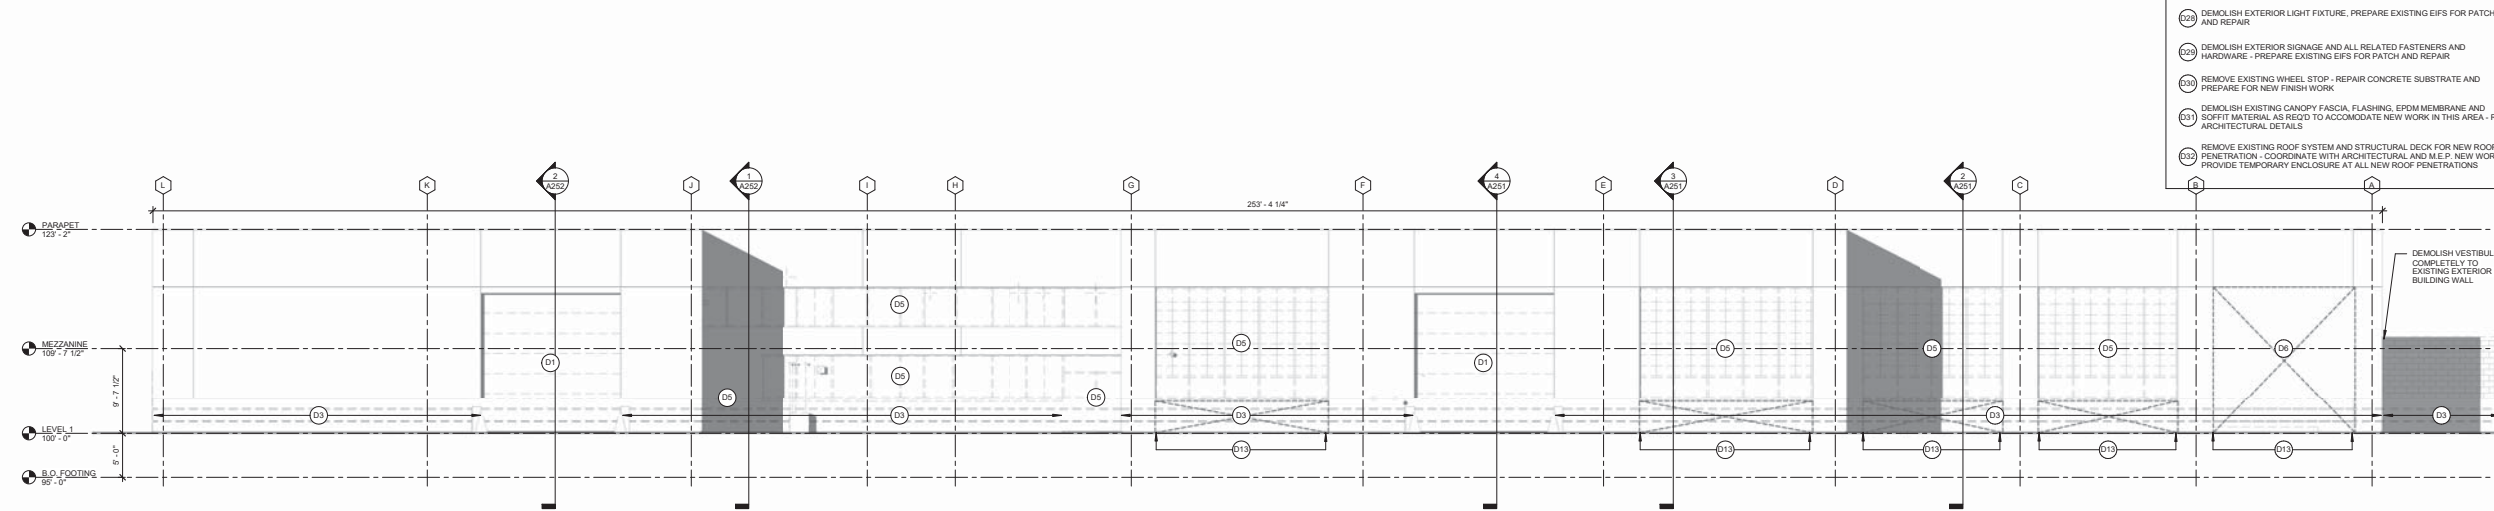

2 DEMO ELEVATION - EAST
D201 1/8" = 1'-0"

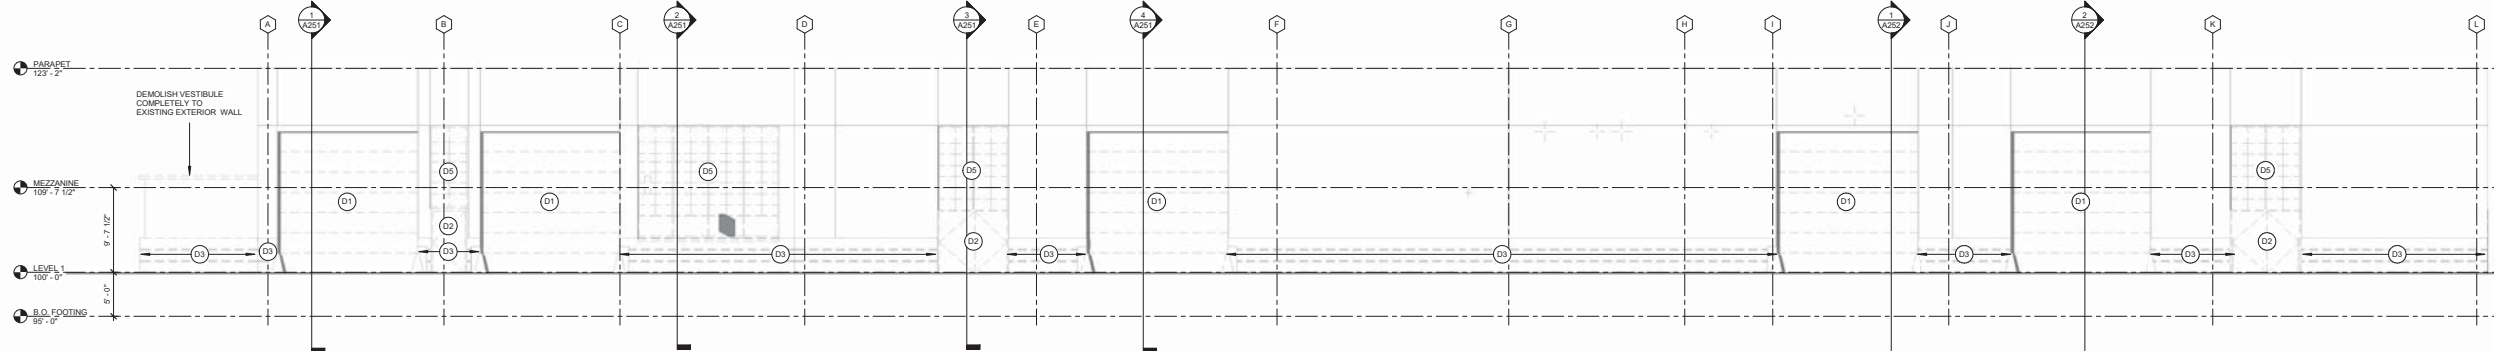

1 DEMO ELEVATION - WEST
D201 1/8" = 1'-0"

- KEYED NOTES (DEMOLITION)**
- D01 REMOVE EXISTING OVERHEAD DOOR AND ALL FRAME/HARDWARE/MOTOR COMPONENTS BACK TO ROUGH OPENING
 - D02 REMOVE EXISTING DOOR(S) AND FRAME(S) TO ROUGH OPENING
 - D03 REMOVE EIFS PANEL FROM CONCRETE FOUNDATION WALL. CLEAN CONCRETE TO PREPARE FOR NEW WATERPROOFING - COORDINATE WITH NEW WORK
 - D04 CUT AND REMOVE SECTION OF DAMAGED EXISTING EIFS SYSTEM BACK TO SUBSTRATE. PREPARE SUBSTRATE FOR NEW PATCH AND REPAIR WORK AS PER EIFS-2 MANUF'S RECOMMENDATION
 - D05 REMOVE EXISTING STOREFRONT GLAZING SYSTEM AND ALL FLASHING/TRIM/SLAB BACK TO ROUGH OPENING. REFERENCE NEW WORK FOR EXISTING MISC. STEEL TO REMAIN IN OPENINGS. PATCH AND REPAIR MASONRY FOR NEW CURTAIN WALL SYSTEM
 - D06 REMOVE PORTION OF EXTERIOR MASONRY WALL COMPLETELY. REMOVE EXISTING EIFS FINISH AS REQ'D TO TOOTH IN NEW CMU - REF. EXTERIOR ELEVATIONS
 - D07 REMOVE PART OF EXISTING FLOOR/ROOF IN PREPARATION FOR ELEVATOR SHaft
 - D08 REMOVE EXISTING STAIR COMPLETELY
 - D09 REMOVE EXISTING INTERIOR WALL COMPLETELY
 - D10 REMOVE EXISTING INTERIOR WIRE PARTITION, SALVAGE, CLEAN, AND STORE FOR REUSE
 - D11 REMOVE EXISTING PLUMBING FIXTURES AND PLUMBING WALL CAVITY
 - D12 REMOVE EXISTING CMU COLUMN WRAP AND ANY TIE BACKS OR ANCHORS TO B.O. SLAB OR DECK ABOVE. PREPARE NEWLY EXPOSED STEEL FOR NEW FINISH - REF. FINISH PLANS
 - D13 REMOVE EXISTING EXTERIOR CONCRETE WALL TO 2" BELOW F.F.E. SAW CUT CONCRETE CLEANLY, ALIGNED WITH CMU JAMBS ABOVE TO CREATE CLEAN ROUGH OPENING FOR NEW CURTAIN WALL
 - D14 SAW CUT AND DEMOLISH EXISTING SLAB AS REQ'D FOR NEW WORK BELOW GRADE - WHERE HATCHED REGION IS DIMENSIONED. SLAB SHALL BE REMOVED AS PER INDICATED EXTENTS. CUTS SHALL BE STRAIGHT AND CONTINUOUS, WHERE NOT DIMENSIONED - COORDINATE REMOVAL REQUIREMENTS WITH NEW STRUCTURAL AND PLUMBING WORK
 - D15 DEMOLISH EXISTING PLASTER CEILING AND SOFFIT WRAP AND ALL SUSPENSION - FRAMING, HANGERS, RODS, DECK CLPS, ETC BACK TO DECK. CLEAN NEWLY EXPOSED STEEL DECK, JOIST AND FRAMING - REF. ARCHITECTURAL CEILING PLANS FOR ANY NEW FINISHES
 - D16 REMOVE EXISTING TRENCH GRATE, PROVIDE TEMPORARY COVER
 - D17 CLEAN/REPLACE EXISTING TRENCH DRAIN LINING AS REQUIRED FOR NEW WORK. COORDINATE WITH MEP
 - D18 EXISTING TRENCH BASIN TO BE ABANDONED AND INFILLED - REF. PLUMBING DEMOLITION DRAWINGS FOR RELATED WORK
 - D19 EXISTING OWNERS EQUIPMENT TO BE DECOMMISSIONED AND REMOVED BY OWNER - COORDINATE WITH OWNER
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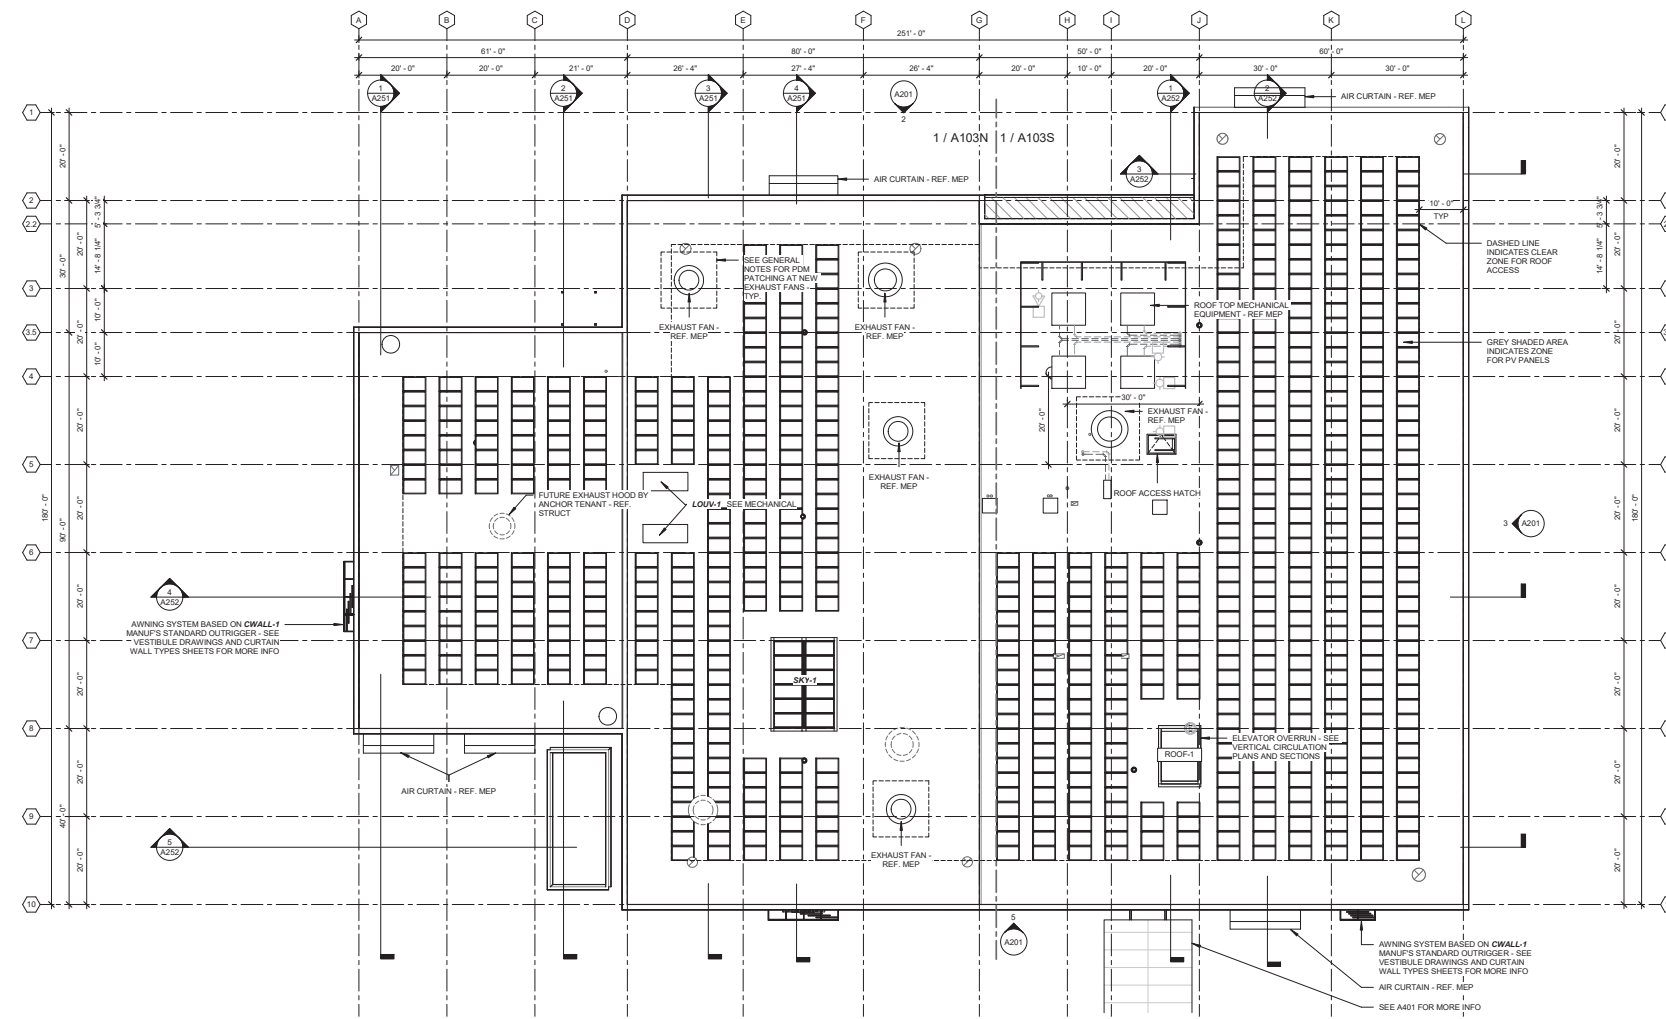
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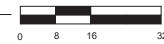
DEMOLITION ELEVATIONS

D201

NOT FOR CONSTRUCTION



1 ROOF PLAN - REFERENCE
A103 1/16" = 1'-0"



- ROOF PLAN GENERAL NOTES**
1. PROTECT ALL EXISTING ROOF MEMBRANE TO REMAIN.
 2. PROVIDE SACRIFICIAL LAYER OF EPDM AROUND EXHAUST HOODS PER EPDM MANUFACTURER RECOMMENDATIONS.
 3. ALL NEW WORK OR MODIFICATION TO EXISTING ROOF SHALL BE DONE IN ACCORDANCE WITH ROOF MANUF'S BEST PRACTICE AND SHALL NOT VOID ORIGINAL ROOF WARRANTY.
 4. PHOTOVOLTAIC ARRAY SHOWN FOR REFERENCE - SEE ELECTRICAL SHEETS FOR MORE INFO.
 5. ALL EXISTING COPING CAP TO BE PAINTED FT-3x.
 6. MECHANICAL EQUIPMENT SHOWN ON ARCHITECTURAL PLANS IS FOR REFERENCE ONLY - REFER TO MEP SHEETS FOR MORE INFORMATION.
 7. ALL ROOF DRAINS ARE EXISTING UNLESS NOTED OTHERWISE - REF PLUMBING DRAWINGS FOR MORE INFO.

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Issued with Copyright/Revised, Deleted & Resubmitted

roof plan

equipment screening and visibility 01


with equipment screen from E. Johnson and N. 1st St



without equipment screen from E. Johnson and N. 1st St



with equipment screen from N. 1st headed north

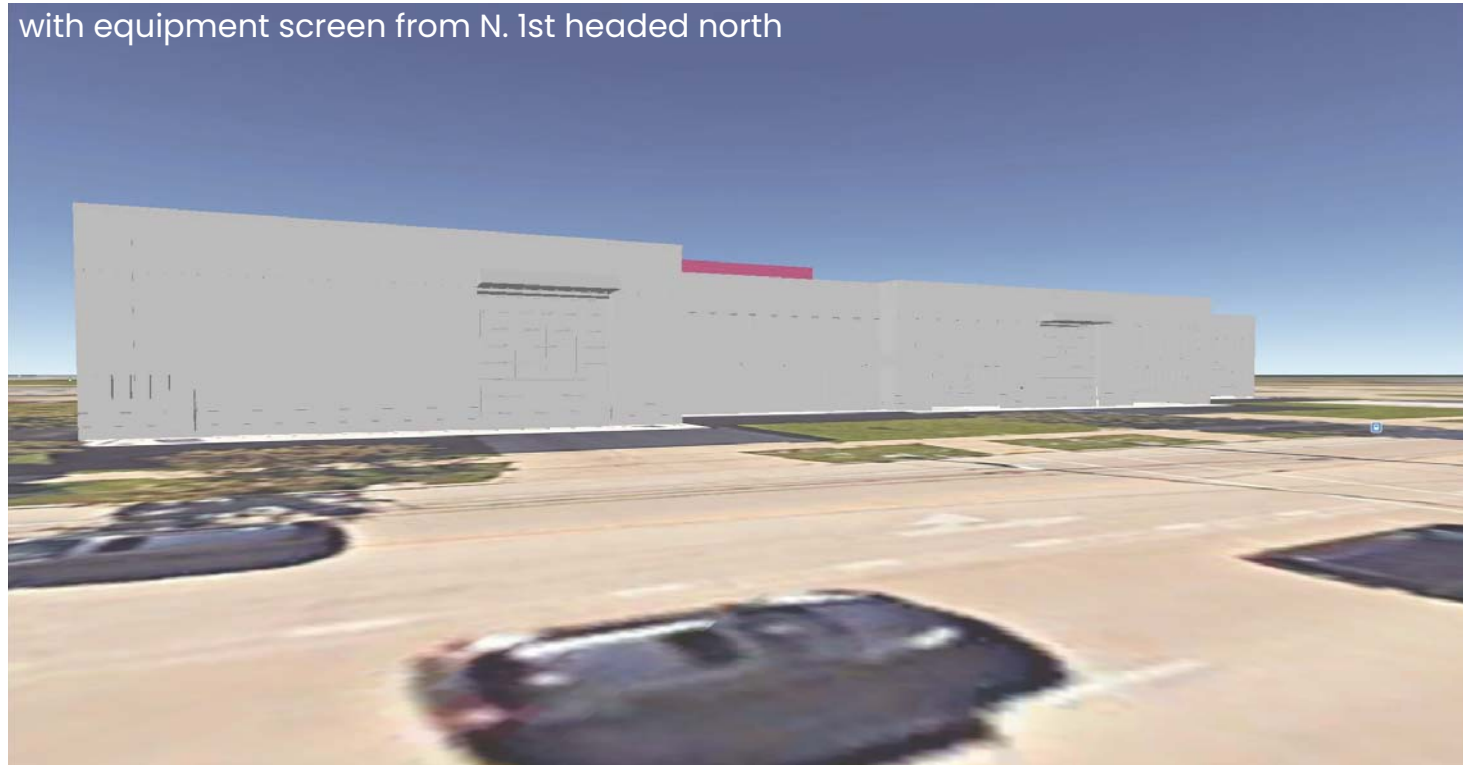


without equipment screen from N 1st headed North



roof plan

equipment screening and visibility 02

with equipment screen from E. Dayton St.

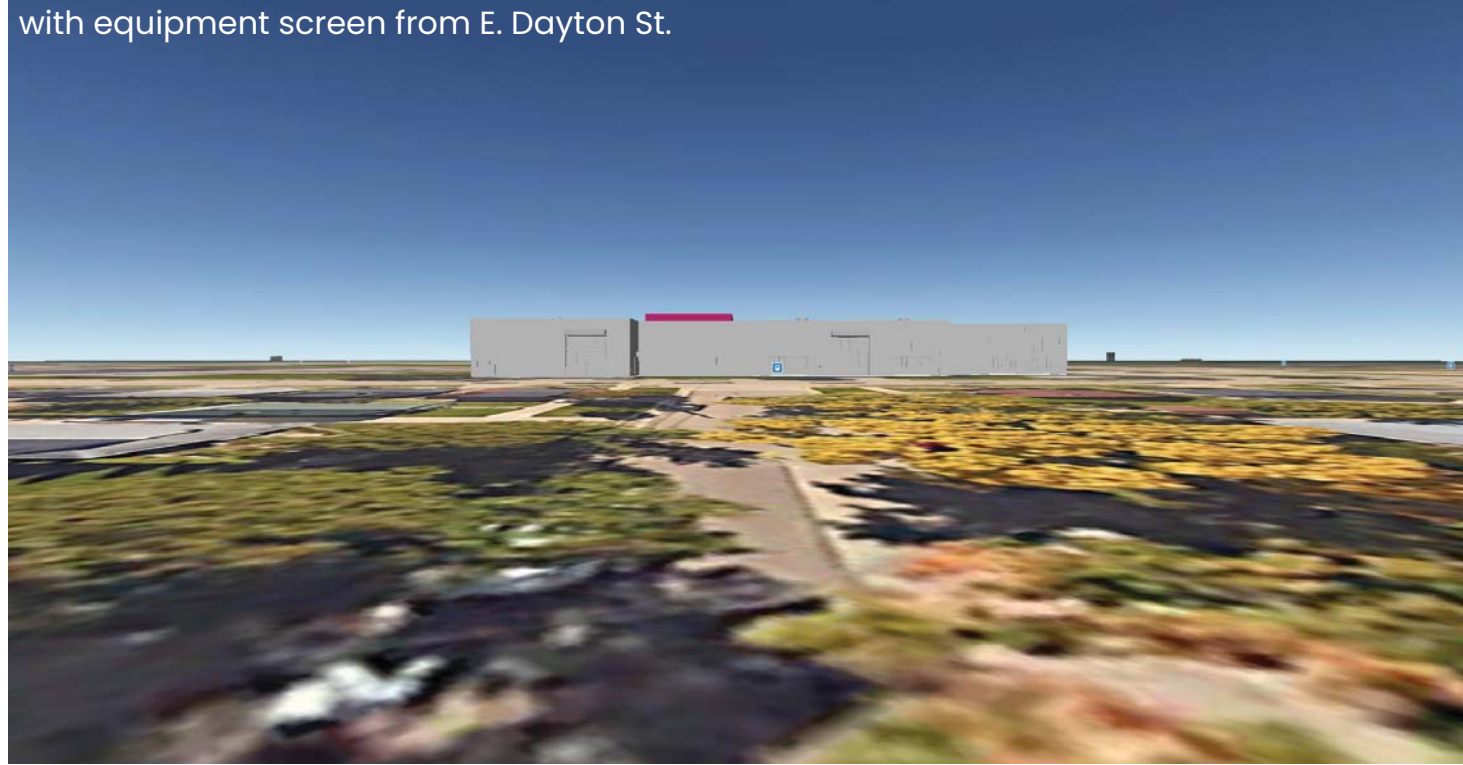

without equipment screen from E. Dayton St




with equipment screen from E Dayton St and N 1st St



without equipment screen from E Dayton St and N 1st St



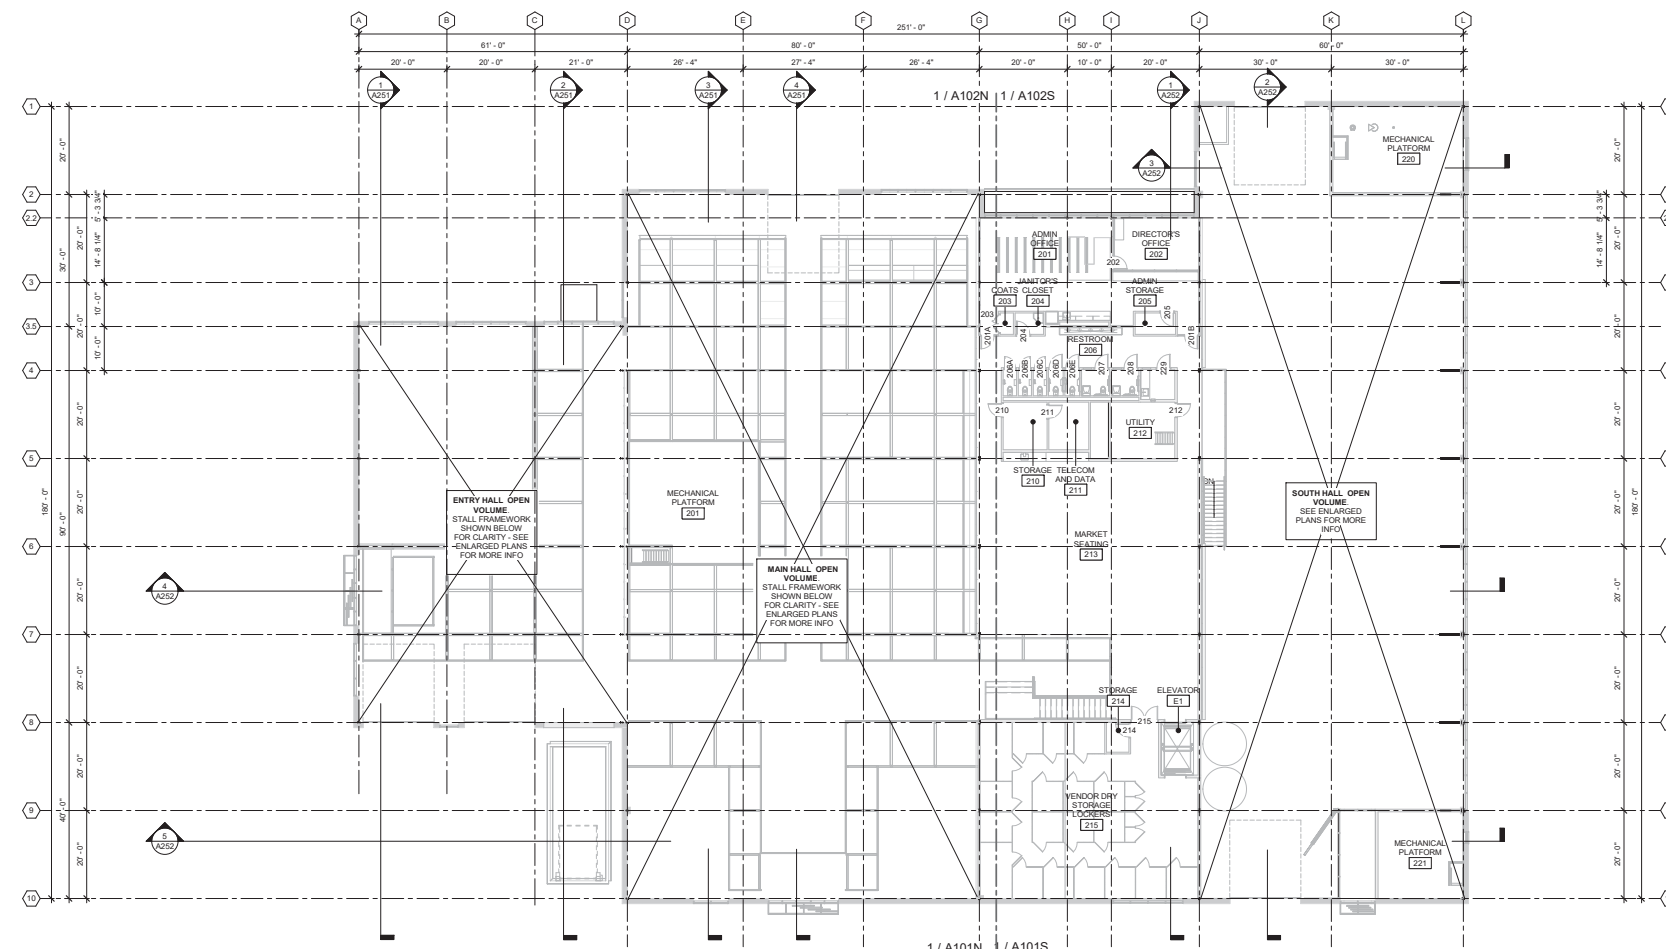


Program Plan



main level

mezzanine

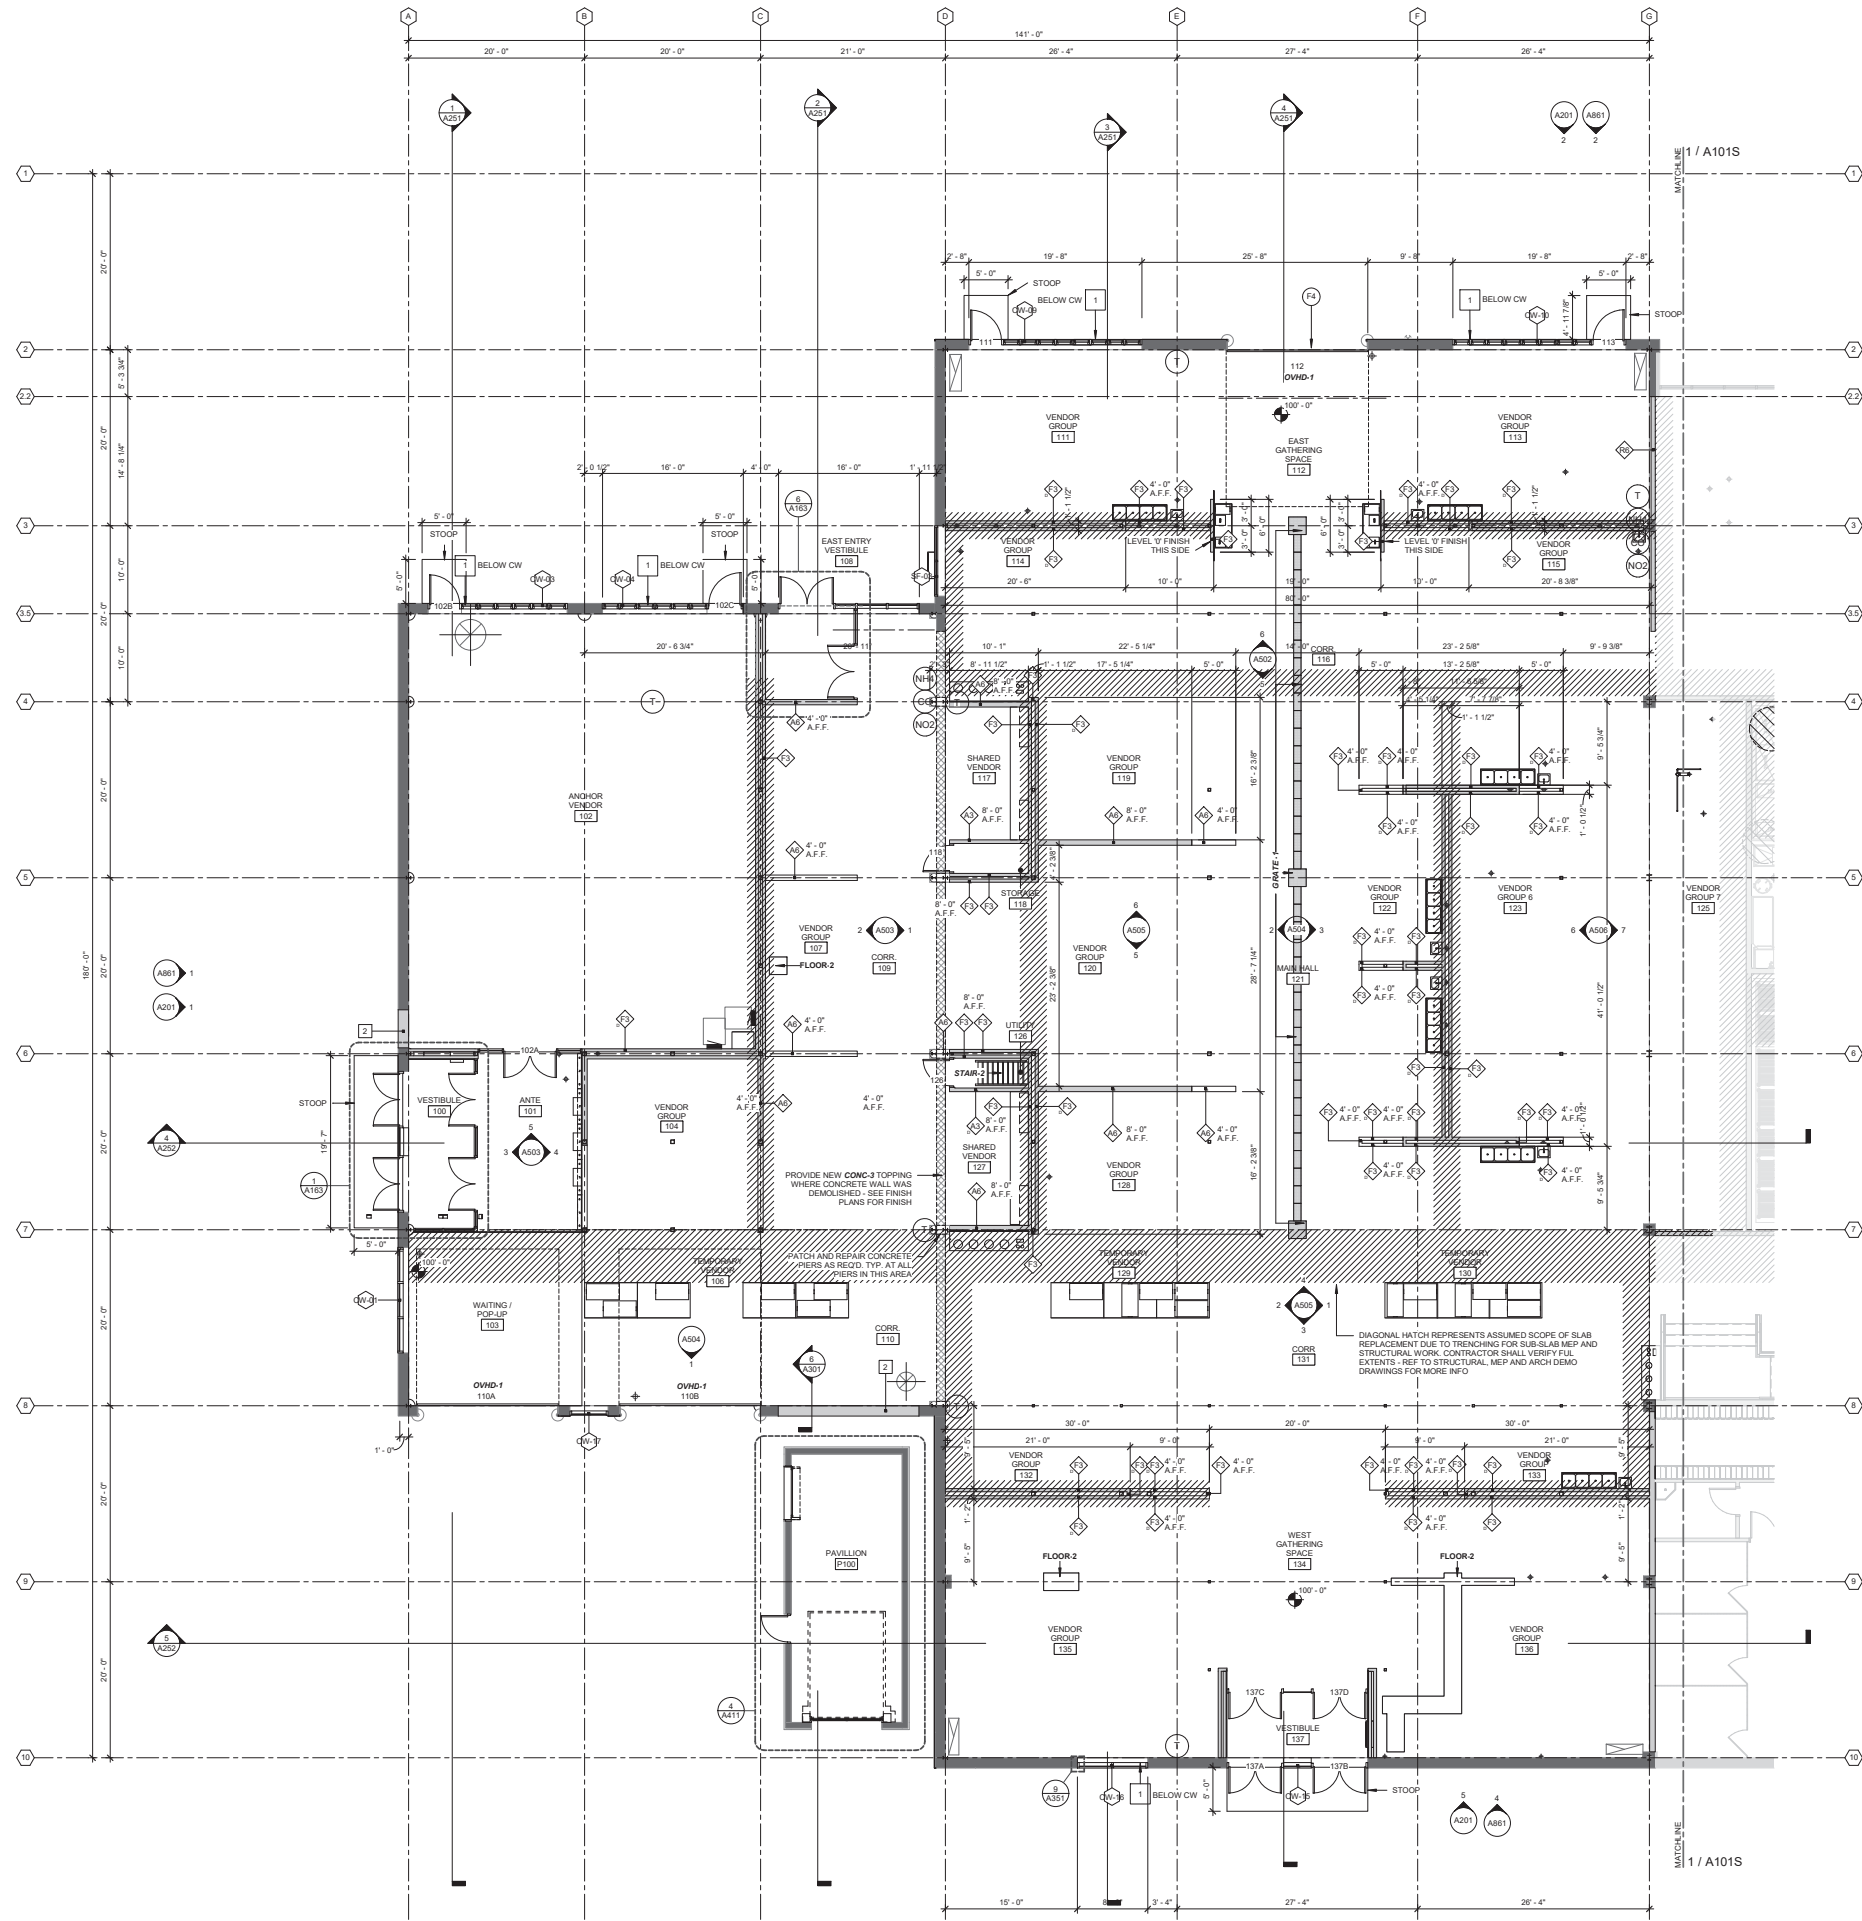

- FLOOR PLAN GENERAL NOTES**
1. ALL CONTRACTORS WISHING TO SUBMIT BIDS FOR WORK IN THESE DOCUMENTS SHALL VISIT PROJECT SITE PRIOR TO SUBMITTING A BID AND SHALL VERIFY EXISTING CONDITIONS AND SCOPE OF WORK.
 2. REFER TO FINISH PLANS FOR SPECIFIC MATERIAL FINISHES & TAGS. REFER TO PROJECT MANUAL FOR DETAILED INFORMATION ON PROJECT FINISHES.
 3. SEE LIFE SAFETY (CODE PLANS) FOR LOCATION AND RATINGS OF FIRE RATED WALL ASSEMBLIES.
 4. SEE WALL TYPES SHEETS FOR WALL ASSEMBLIES.
 5. AT ANY LOCATIONS WHERE PENETRATIONS ARE REQUIRED IN RATED WALL OR ASSEMBLIES PROVIDE FIRE CHALKING OR FIRE-STOPPING AS REQUIRED TO MAINTAIN NECESSARY RATING.
 6. ELECTRICAL FIXTURES, DEVICES, ETC SHOWN ON ARCHITECTURAL PLANS ARE FOR REFERENCE ONLY. SEE ELECTRICAL FOR INFORMATION.
 7. SITE INFORMATION SHOWN IS FOR REFERENCE ONLY. REFER TO CIVIL AND LANDSCAPE DRAWINGS FOR SITE SCOPE.
 8. REFER TO ELEVATIONS FOR GLAZING TYPES.
 9. ALL DIMENSIONS TO FACE OF WALL - STRUCTURAL GRID, UNLESS NOTE OTHERWISE.
 10. WALL TYPE TAGS REFER TO BASE WALL CONSTRUCTION. REFER TO FINISH PLANS, INTERIOR ELEVATIONS AND SYSTEMS DRAWINGS FOR WALL FINISHES ATTACHED TO BASE WALL TYPES.
 11. ALL EXISTING FLOORS, CEILINGS AND WALLS TO REMAIN SHALL BE CLEANED AND SANITIZED PRIOR TO COMMENCEMENT OF NEW WORK. REF TO CLEANING SECTIONS IN PROJECT MANUAL.
 12. ALL EXISTING FLOOR FINISHES SHALL REMAIN, UNLESS OTHERWISE NOTED. PROTECT EXISTING FINISHES DURING CONSTRUCTION. PATCHING AND REPAIRING OF SLABS TO REMAIN SHALL BE WITH FLOOR TYPE FLOOR-2, UNLESS NOTED OTHERWISE.
 13. FINISHES AT INTERIOR FACE OF ALL EXISTING PERIMETER WALLS SHALL REMAIN - NO NEW FINISHES AT THESE WALLS UNLESS NOTED OTHERWISE.
 14. ALL WORK IN VENDOR STALL AREAS NOT DESCRIBED IN THESE DOCUMENTS SHALL BE BY FUTURE TENANT INFILL PRODUCTS. REFERENCE OTHER DISCIPLINES FOR FULL SCOPE OF WORK TO BE PERFORMED IN THESE AREAS UNDER THIS PROJECT.
 15. SEE A110 SHEETS FOR ARCHITECTURAL STEEL CANOPY DRAWINGS AND GENERAL NOTES.
 16. SEE MILLWORK DRAWINGS FOR ALL CASEWORK SHOWN - FREESTANDING OR BUILT-IN.
 17. PROVIDE ACOUSTIC 'A' WALL TO DECK ABOVE ALL STFT-1 UNLESS NOTED OTHERWISE.
 18. SOME EQUIPMENT NOTED IN THESE DOCUMENTS SHALL BE OWNER FURNISHED AND OWNER INSTALLED. THESE LOCATIONS ARE NOTED IN DRAWINGS AND EQUIPMENT IS SCHEDULED IN OWNER PROVIDED EQUIPMENT IN PROJECT MANUAL. AT THESE LOCATIONS, GC SHALL PROVIDE ALL SERVICES - POWER, DATA, OPENINGS, BLOCKING, ETC FOR FUTURE OWNER INSTALLATION OF EQUIPMENT.
 19. PROVIDE IN WALL BLOCKING AT ALL WALL MOUNTED SHELVING CASEWORK, FUTURE AV EQUIPMENT BY OWNER, TOILET ACCESSORIES ETC - LOCATIONS, COORDINATE WITH INTERIOR ELEVATIONS.

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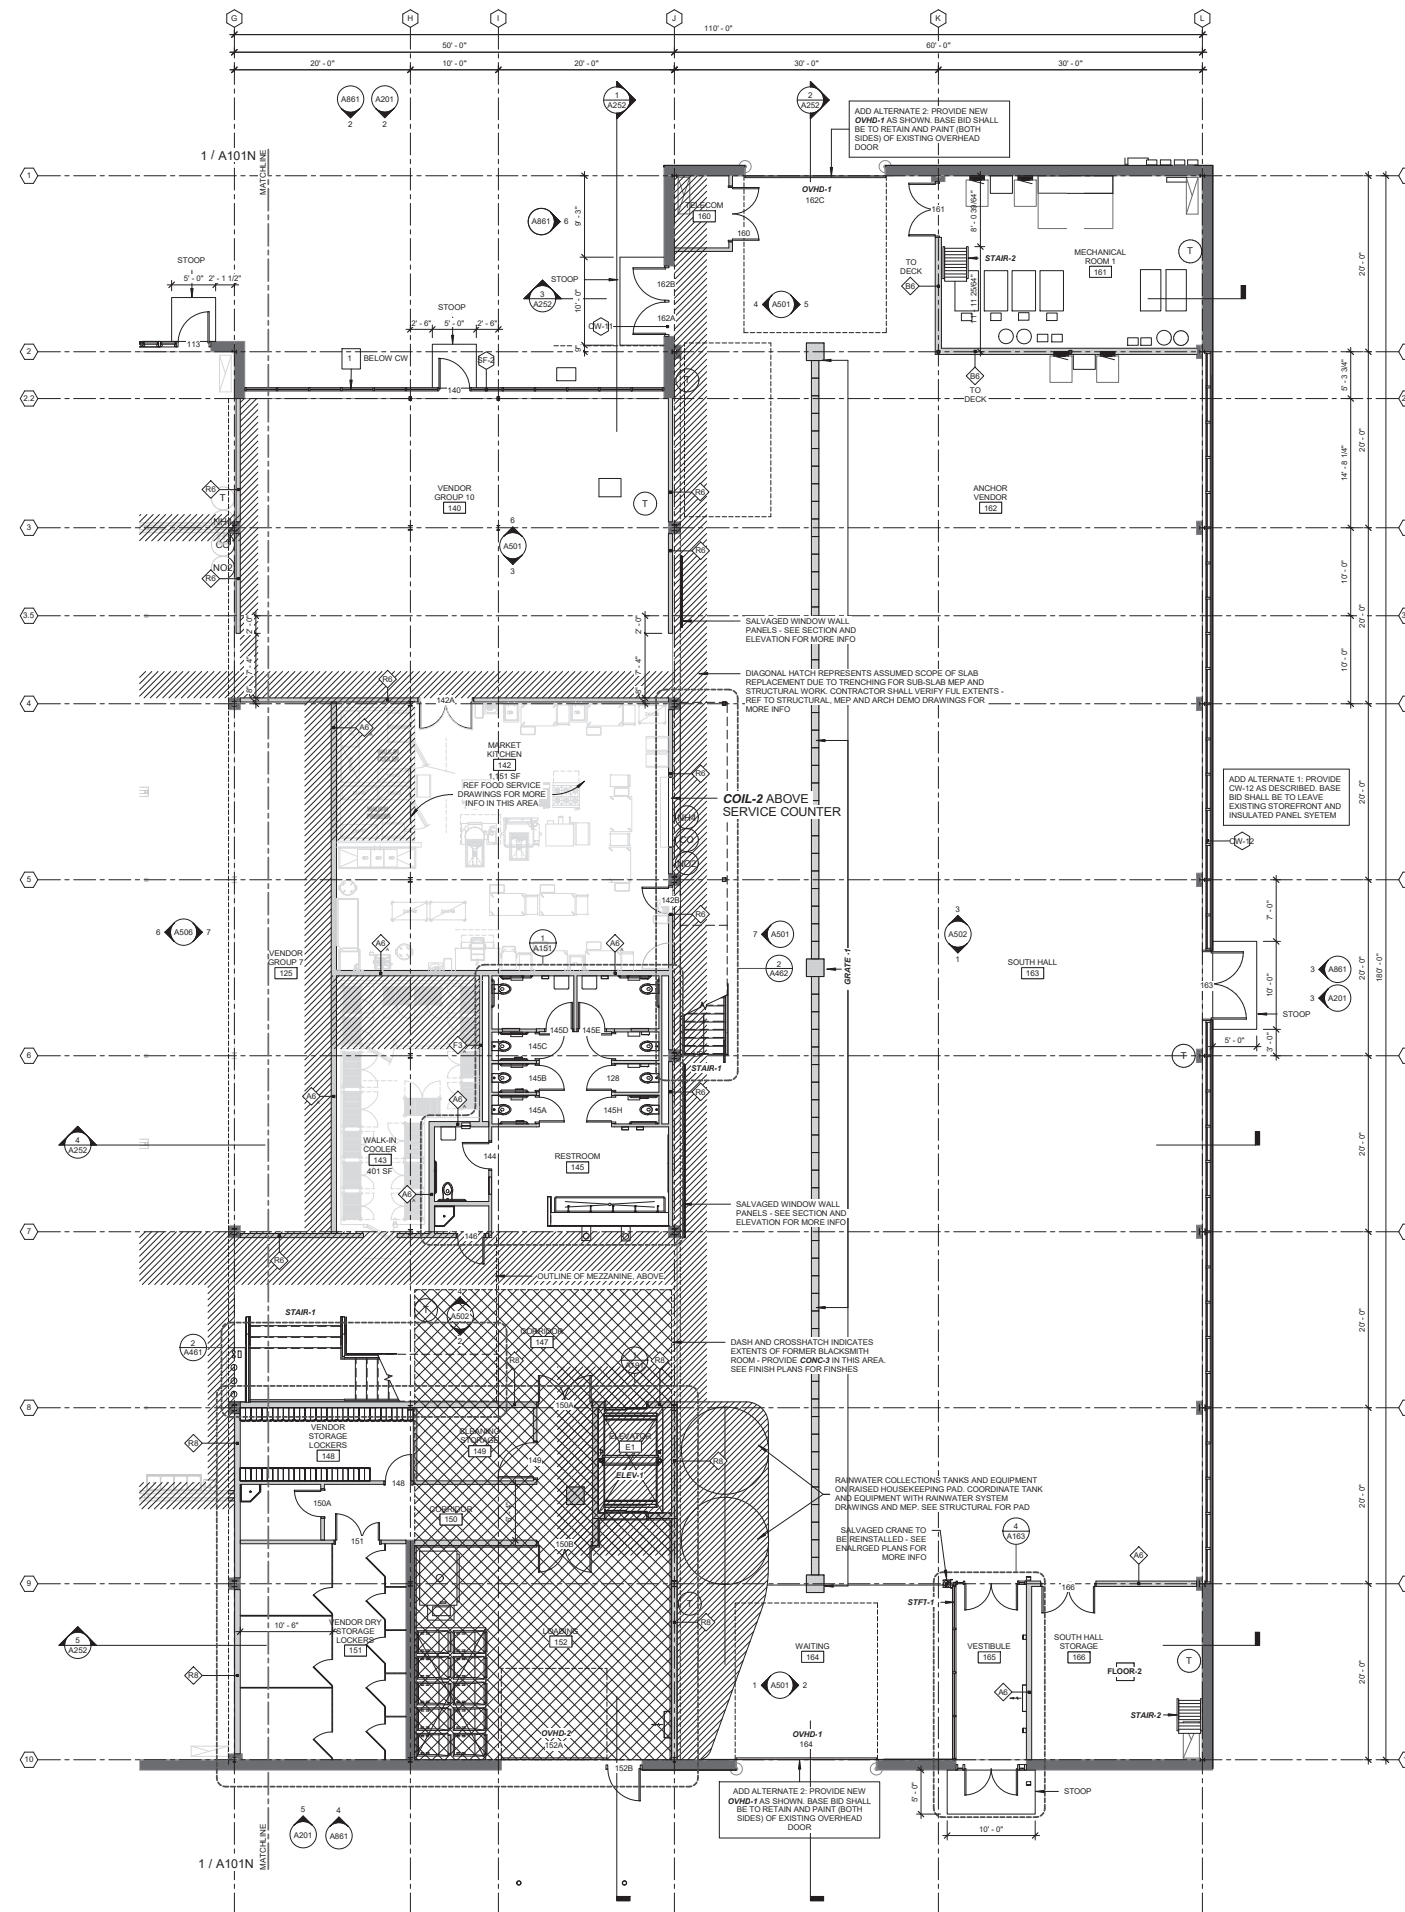
LEVEL 1 - NORTH

A101N

NOT FOR CONSTRUCTION

1 LEVEL 1 PLAN - NORTH
A101N 1/8" = 1'-0"





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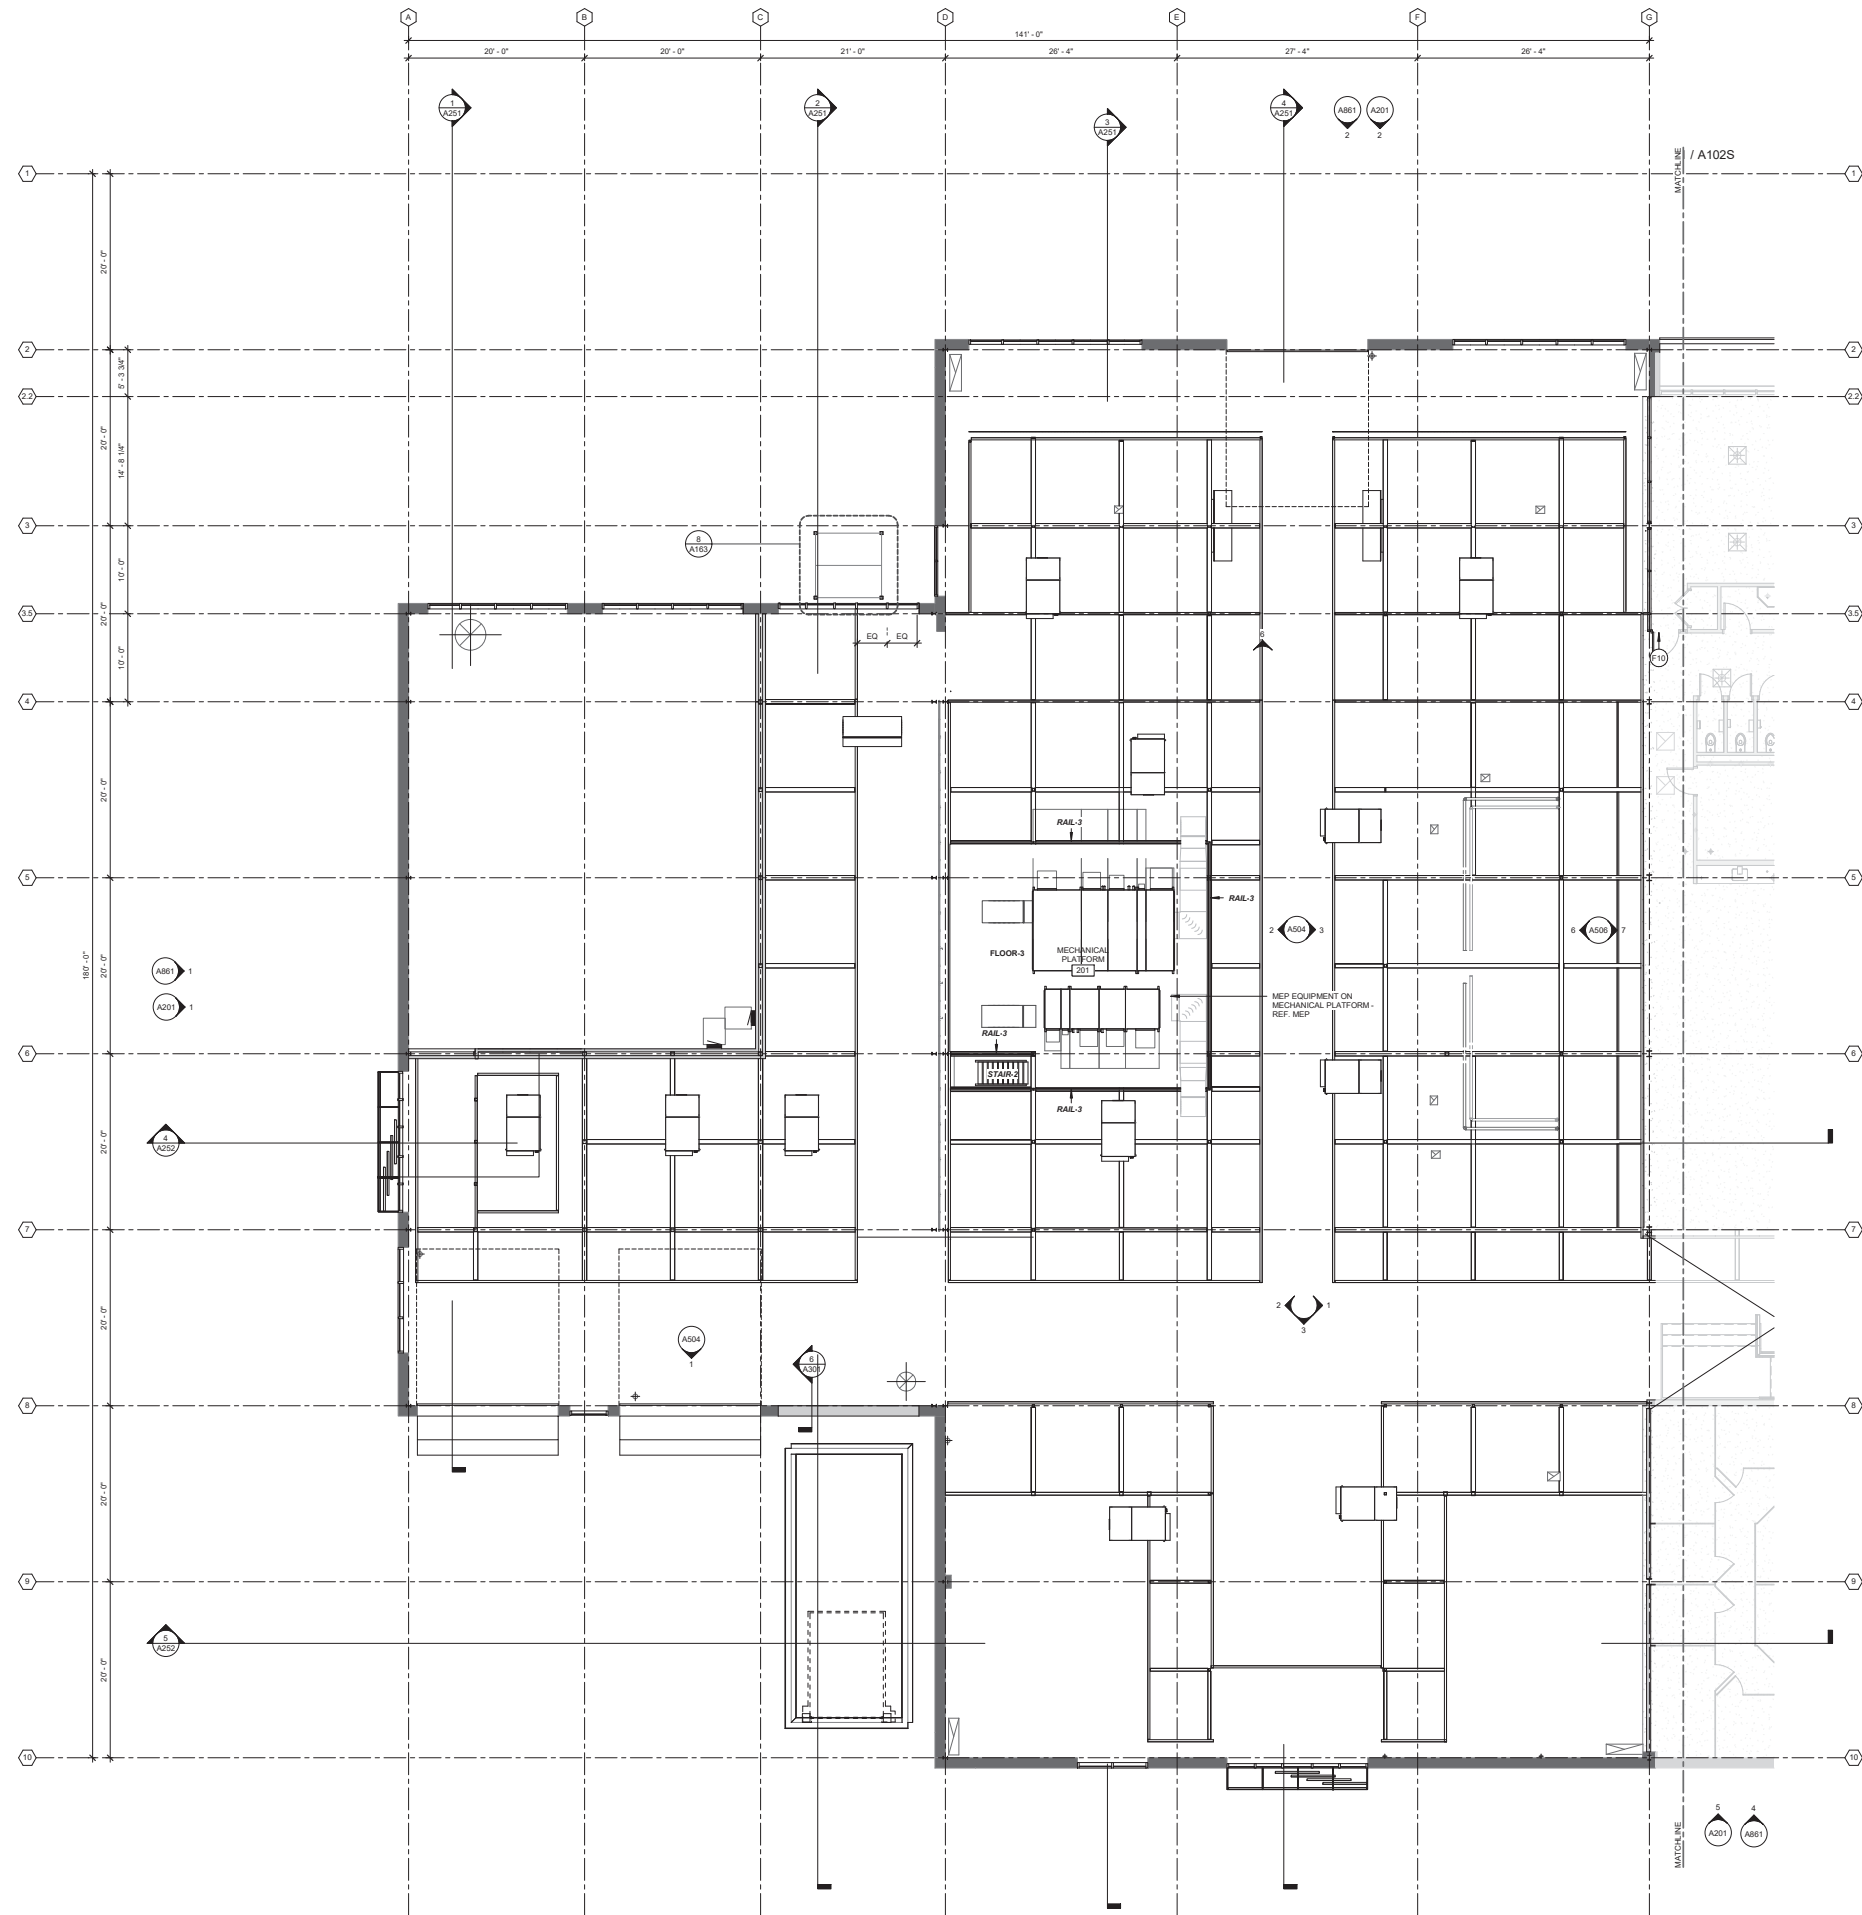
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LEVEL 1 - SOUTH

A101S

NOT FOR CONSTRUCTION

1 LEVEL 1 PLAN - SOUTH
A101S 1/8" = 1'-0"



- FLOOR PLAN GENERAL NOTES**
1. ALL CONTRACTORS WISHING TO SUBMIT BIDS FOR WORK IN THESE DOCUMENTS SHALL VISIT PROJECT SITE PRIOR TO SUBMITTING A BID AND SHALL VERIFY EXISTING CONDITIONS AND SCOPE OF WORK.
 2. REFER TO FINISH PLANS FOR SPECIFIC MATERIAL FINISHES & TAGS. REFER TO PROJECT MANUAL FOR DETAILED INFORMATION ON PROJECT FINISHES.
 3. SEE LIFE SAFETY (CODE PLANS) FOR LOCATION AND RATINGS OF FIRE RATED WALL ASSEMBLIES.
 4. SEE WALL TYPES SHEETS FOR WALL ASSEMBLIES.
 5. AT ANY LOCATIONS WHERE PENETRATIONS ARE REQUIRED IN RATED WALL OR ASSEMBLIES PROVIDE FIRE CHULUNG OR FIRE STOPPING AS REQUIRED TO MAINTAIN NECESSARY RATING.
 6. ELECTRICAL FIXTURES, DEVICES, ETC SHOWN ON ARCHITECTURAL PLANS ARE FOR REFERENCE ONLY. SEE ELECTRICAL FOR INFORMATION.
 7. SITE INFORMATION SHOWN IS FOR REFERENCE ONLY. REFER TO CIVIL AND LANDSCAPE DRAWINGS FOR SITE SCOPE.
 8. REFER TO ELEVATIONS FOR GLAZING TYPES.
 9. ALL DIMENSIONS TO FACE OF WALL + STRUCTURAL GRID, UNLESS NOTE OTHERWISE.
 10. WALL TYPE TAGS REFER TO BASE WALL CONSTRUCTION. REFER TO FINISH PLANS, INTERIOR ELEVATIONS AND SYSTEMS DRAWINGS FOR WALL FINISHES ATTACHED TO BASE WALL TYPES.
 11. ALL EXISTING FLOORS, CEILINGS AND WALLS TO REMAIN SHALL BE CLEANED AND SANITIZED PRIOR TO COMMENCEMENT OF NEW WORK. REF TO CLEANING SECTIONS IN PROJECT MANUAL.
 12. ALL EXISTING FLOOR FINISHES SHALL REMAIN, UNLESS OTHERWISE NOTED. PROTECT EXISTING FINISHES DURING CONSTRUCTION. PATCHING AND REPAIRING OF SLABS TO REMAIN SHALL BE WITH FLOOR TYPE FLOOR-2, UNLESS NOTED OTHERWISE.
 13. FINISHES AT INTERIOR FACE OF ALL EXISTING PERIMETER WALLS SHALL REMAIN - NO NEW FINISHES AT THESE WALLS UNLESS NOTED OTHERWISE.
 14. ALL WORK IN VENDOR STALL AREAS NOT DESCRIBED IN THESE DOCUMENTS SHALL BE BY FUTURE TENANT INFILL PROJECTS. REFERENCE OTHER DISCIPLINES FOR FULL SCOPE OF WORK TO BE PERFORMED IN THESE AREAS UNDER THIS PROJECT.
 15. SEE A110 SHEETS FOR ARCHITECTURAL STEEL CANOPY DRAWINGS AND GENERAL NOTES.
 16. SEE MILLWORK DRAWINGS FOR ALL CASEWORK SHOWN - FREESTANDING OR BUILT-IN.
 17. PROVIDE ACOUSTIC 'A3' WALL TO DECK ABOVE ALL STFT-1 UNLESS NOTED OTHERWISE.
 18. SOME EQUIPMENT NOTED IN THESE DOCUMENTS SHALL BE OWNER FURNISHED AND OWNER INSTALLED. THESE LOCATIONS ARE NOTED IN DRAWINGS AND EQUIPMENT IS SCHEDULED IN OWNER PROVIDED EQUIPMENT LIST IN PROJECT MANUAL. AT THESE LOCATIONS, GC SHALL PROVIDE ALL SERVICES - POWER, DATA, OPENINGS, BLOCKING, ETC FOR FUTURE OWNER INSTALLATION OF EQUIPMENT.
 19. PROVIDE IN WALL BLOCKING AT ALL WALL MOUNTED SHELVING CASEWORK, FUTURE AV EQUIPMENT BY OWNER, TOILET ACCESSORIES ETC - LOCATIONS, COORDINATE WITH INTERIOR ELEVATIONS.

Architecture and Interiors

MSRDesign
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Project No: 20190200.00

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200 N First St, Madison, WI 53704

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Architect Seal

Signature _____
Print Name _____
Date _____ License No. _____

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ISSUE / REVISION

Mark	Date	Description
06.04.2019	06.04.2019	SITE + BUILDING DESIGN 1 PRICING ISSUE
08.12.2019	08.12.2019	LOC INFORMATIONAL SUBMISSION
08.16.2019	08.16.2019	SITE + BUILDING DESIGN 2 PRICING ISSUE
11.13.2019	11.13.2019	100% CDP DOCUMENTS


MEZZANINE LEVEL - NORTH

A102N

NOT FOR CONSTRUCTION

1 LEVEL 2 PLAN - NORTH
A102N 1/8" = 1'-0"



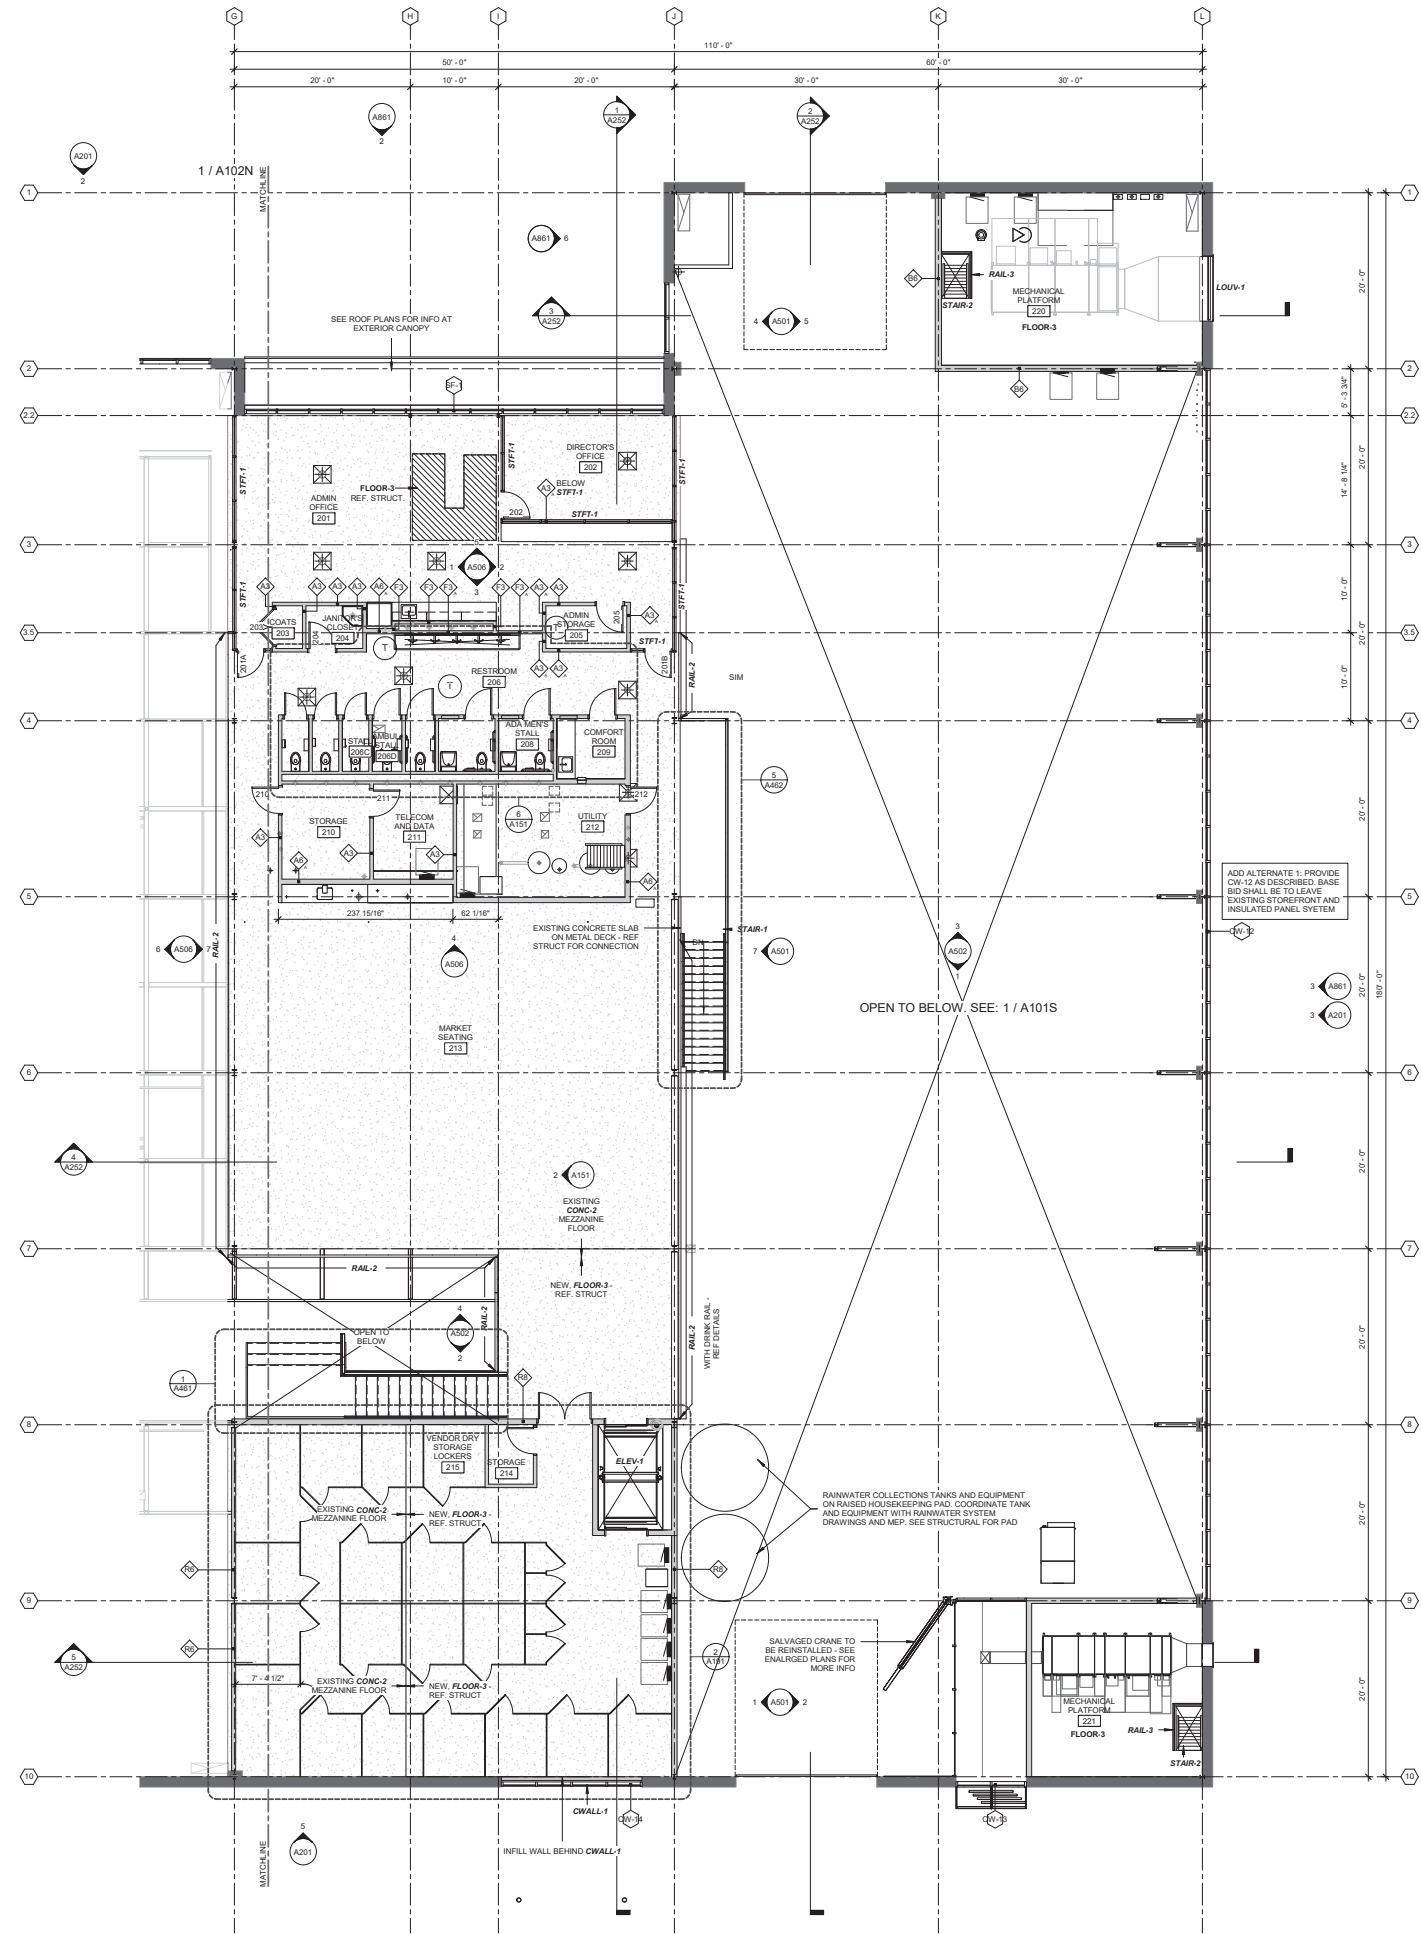

1 LEVEL 2 PLAN - SOUTH
A102S 1/8" = 1'-0"

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 19. PROVIDE IN WALL BLOCKING AT ALL WALL MOUNTED SHELVING CASEWORK. FUTURE AV EQUIPMENT BY OWNER. TOILET ACCESSORIES ETC - LOCATIONS, COORDINATE WITH INTERIOR ELEVATIONS.

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Project No: 20190200.00

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Architect Seal

Signature _____
Print Name _____
Date _____ License No. _____

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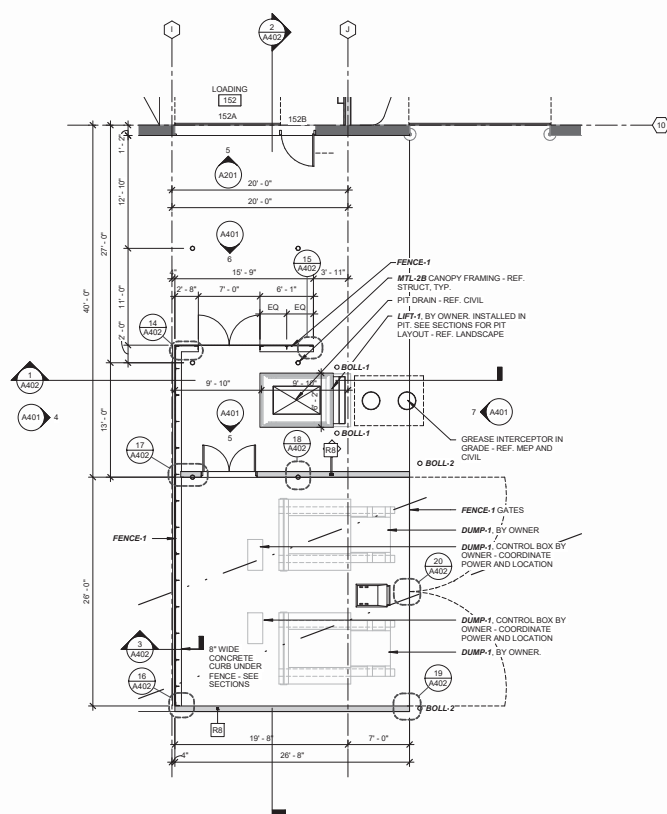
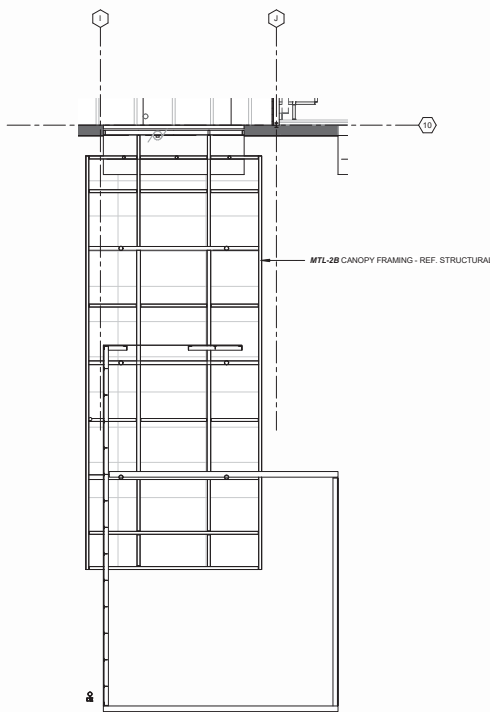
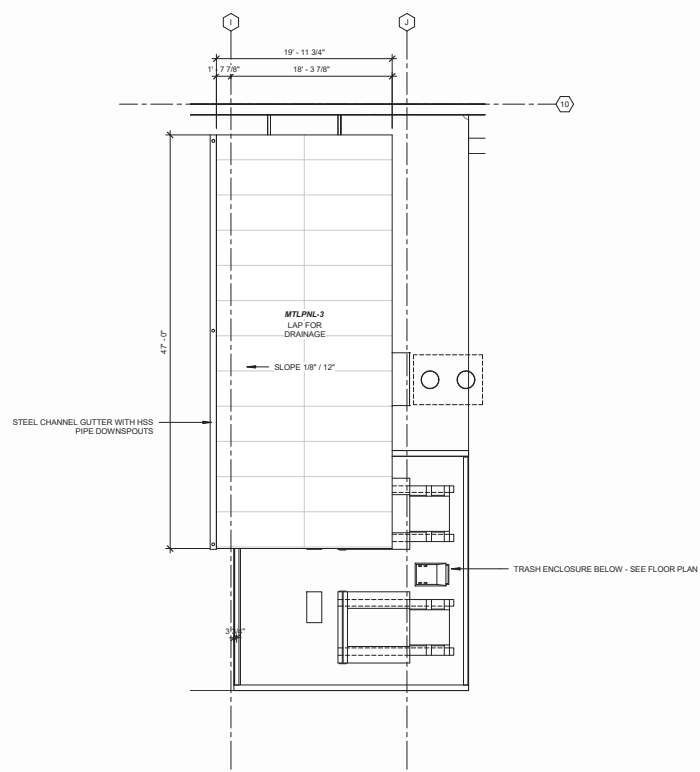
ISSUE / REVISION

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11.13.2019	11.13.2019	100% CDP DOCUMENTS

MEZZANINE LEVEL - SOUTH

A102S

NOT FOR CONSTRUCTION



CANOPIES GENERAL NOTES


- SEE STRUCTURAL DRAWINGS FOR CANOPY FRAMING SIZES AND CONNECTIONS.
- ALL CANOPY STEEL, (STRUCTURAL SHAPES, ACCESSORIES, UNSTRUT, ETC.) SHALL BE GALVANIZED WITH A MACROPOXY 646 MIDCOAT AND PIGMENTED ACRYLON TOPCOAT.
- MTLPNL-1 AT FENCE-1 SHALL BE NON-EDGE BANDED PANELS WITH PERFORATIONS CONTINUOUS TO EDGE OF PANEL.

3 ENLARGED ROOF PLAN - TRASH AND LOADING AREA
A401 1/8" = 1'-0"
0 4 8 16


2 ENLARGED RCP - TRASH AND LOADING AREA
A401 1/8" = 1'-0"
0 4 8 16

1 ENLARGED PLAN - TRASH AND LOADING AREA
A401 1/8" = 1'-0"
0 4 8 16


8 EXT DTL ELEV - FENCE - 1 - GATE LATCH
A401 1/12" = 1'-0"

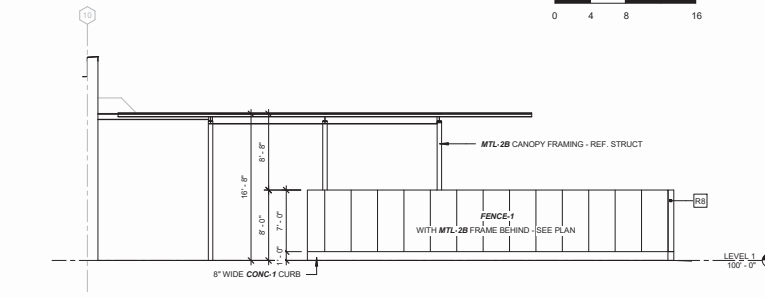


4 EXT ELEVATION - TRASH ENCLOSURE - N
A401 1/8" = 1'-0"

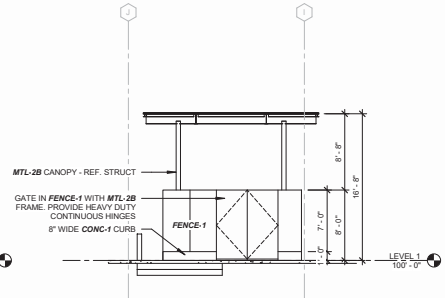


6 EXT ELEVATION - LOADING AREA GATE
A401 1/8" = 1'-0"

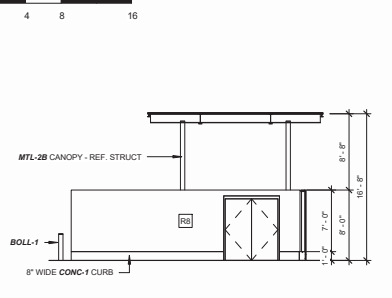


5 EXT ELEVATION - TRASH ENCLOSURE - E
A401 1/8" = 1'-0"

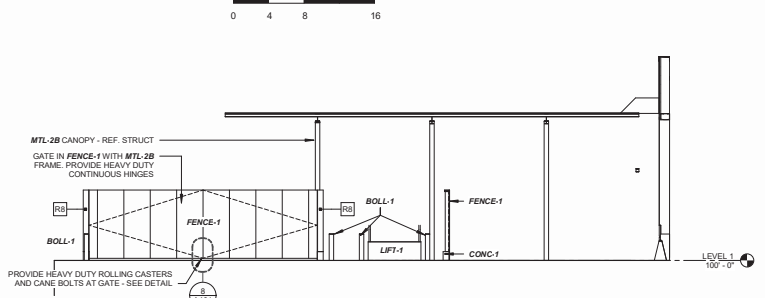

7 EXT ELEVATION - TRASH ENCLOSURE - S
A401 1/8" = 1'-0"

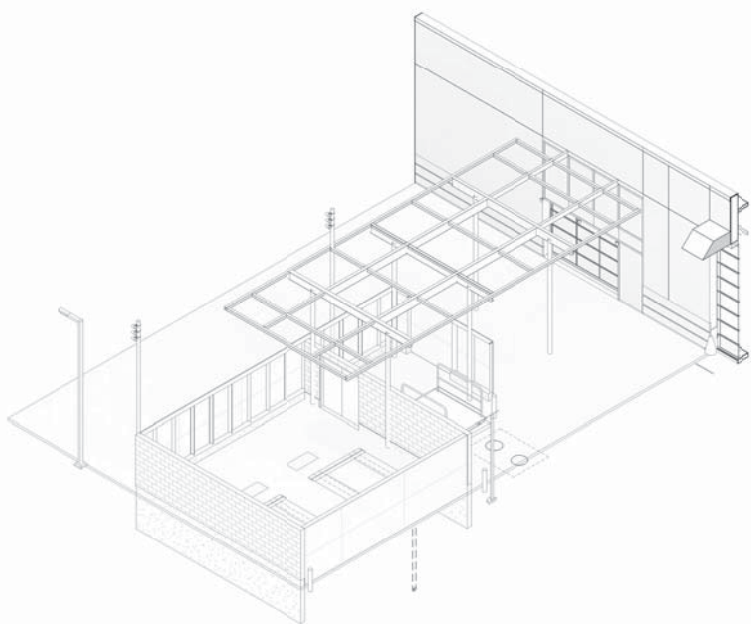

11 AXON - LOADING AND TRASH AREA SW
A401

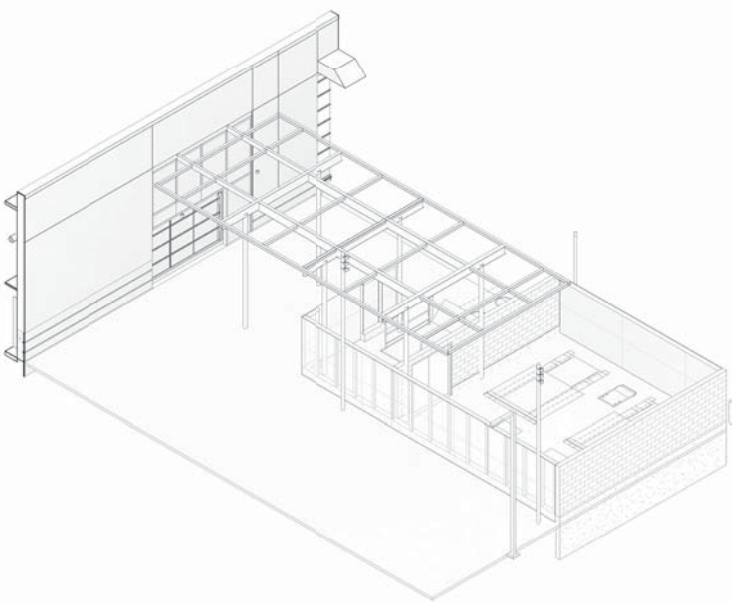

10 AXON - LOADING AND TRASH AREA NW
A401

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11.13.2019	11.13.2019	100% CDP DOCUMENTS

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TRASH AND LOADING AREA - PLANS AND ELEVATIONS

A401

NOT FOR CONSTRUCTION

building plans
interior rendering 01






building plans
interior rendering 02



MSRDesign


maison public market, urban design commission final approval application

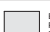BUILDING ELEVATION GENERAL NOTES


-  EXISTING EIFS SYSTEM WITH COAT-1B. SEE ELEVATIONS FOR PAINTED SIGNAGE IN THESE ZONES. SOME SIGNAGE IS REPRESENTATIVE AND NOT IN THIS CONTRACT. SEE NOTES ON ELEVATIONS AND COORDINATE WITH OWNERS BRANDING CONSULTANT.
-  NEW EIFS-2 PATCHING IN EXISTING EIFS SYSTEM DUE TO OPENING. IF FULL SUBSTANTIAL REPAIR OF EXISTING SYSTEM, OR AS REQUIRED FOR SUBSTRATE RECONSTRUCTION AT NEW OPENINGS, NOT ALL AREAS MAY BE SHOWN. SEE NOTE 2 BELOW.
-  NEW MURAL, BY OTHERS, IN THIS ZONE.

1. PROVIDE EIFS-1 FROM GRADE TO 4'-0" A.F.F. APPLY TO EXISTING FOUNDATION WALL AND TIE INTO EXISTING EIFS SYSTEM TO REMAIN. SEE EXT WALL SECTIONS FOR TYPICAL DETAILS.
2. EIFS CONTRACTOR SHALL PATCH AND REPAIR ALL DAMAGE TO EXISTING EIFS SYSTEMS WHICH ARE TO REMAIN. THIS INCLUDES BUT IS NOT LIMITED TO:
 - DENTS
 - FLAKING OR SPALLING OF FINISH AND WEATHER COAT
 - DELAMINATION OF MESH
 - DAMAGE DUE TO MOISTURE SATURATION
3. ALL EIFS TO REMAIN, AS WELL AS ALL PATCH AND REPAIR WORK PERFORMED AT EXISTING EIFS SHALL RECEIVE COAT-1A/1B. SEE ELEVATIONS.
4. EXISTING COPING CAP SHALL BE PAINTED PT-3A.
5. LIGHT FIXTURES SHOWN ARE FOR LOCATING PURPOSES ONLY. REF. LIGHTING PLANS FOR ACTUAL FIXTURES AND SCHEDULES.
6. SOME SIGNAGE IN ARCH ELEVATIONS IS FOR REFERENCE ONLY AND IS NOTED AS SUCH ON ELEVATIONS. SIGNAGE IN THESE LOCATIONS SHALL BE IN THE FORM OF COMPLIANT COAT-1 IN VARIOUS COLORS AS DESIGNED BY OWNERS BRANDING CONSULTANT. CONTRACTOR SHALL NOT APPLY COATINGS PER THESE DOCUMENTS OR OTHERS. TO EXISTING OR NEW EIFS FINISHES THAT IS NOT COMPLIANT WITH COAT-1. SPECIFICATION.
7. SEE SHEETS A401 & A402 FOR ELEVATIONS OF TRASH ENCLOSURE AND LOADING CANOPY.
8. ALL EXISTING WHEEL STOPS AT OVERHEAD DOOR OPENINGS, NOT NOTED AS DEMOLISHED, REPAINTED AND REINSTALLED. EXISTING CONCRETE WALL BENEATH SHALL BE REPAIRED IN PLACE.
9. ALL OPENINGS AT ABANDONED MECHANICAL AND OTHER EQUIPMENT SHALL BE INFILLED AND PATCHED WITH NEW EIFS-1 OR EIFS-2 TO MATCH ADJACENT SYSTEM AT SOME LOCATIONS. THRU-WALL EQUIPMENT CAN BE EVALUATED AND ABANDONED IN PLACE. SEALED AND PAINTED. CONTRACTOR SHALL NOTIFY ARCHITECT AND RECEIVE APPROVAL OF INTENT TO ABANDON IN PLACE.
10. FINISH GRADE IS SHOWN AS REFERENCE ONLY. SEE CIVIL FOR ACTUAL GRADE.


- EIFS-1** EXTERIOR INSULATION AND FINISH SYSTEMS
MFR: DRYVIT;
REINFORCING MESH: PANZER MEZH 20 cc;
WEATHER BARRIER: BACKSTOP NT-VB SPRAY;
BASE COAT: DRYLFX;
TOP COAT: WEATHERLASTIC;
COLOR: MATCH COAT-1A.
- EIFS-2** EXTERIOR INSULATION AND FINISH SYSTEMS
MFR: DRYVIT;
STYLE: NONIDENTICIOUS BASE COAT (NIBC);
COLOR: MATCH EXISTING;
TEXTURE: FREESTYLE.
- COAT-1A** ELASTOMERIC ARCHITECTURAL COATING AND RESTORATION
MFR: DRYVIT;
STYLE: WEATHERLASTIC;
COLOR: WHITE.
- COAT-1B** ELASTOMERIC ARCHITECTURAL COATING AND RESTORATION
MFR: DRYVIT;
STYLE: WEATHERLASTIC;
COLOR: DARK GRAY.
- PT-3** EXTERIOR PAINT - PARAPET AND COPING
COLOR: BLACK.
- CWALL-1** GLAZED ALUMINUM CURTAIN WALL SYSTEM
MFR: KAWNEER ALUMINUM CURTAINWALL SYSTEM;
MODEL: 1600 WALL SYSTEM;
COLOR: BLACK ANODIZED.

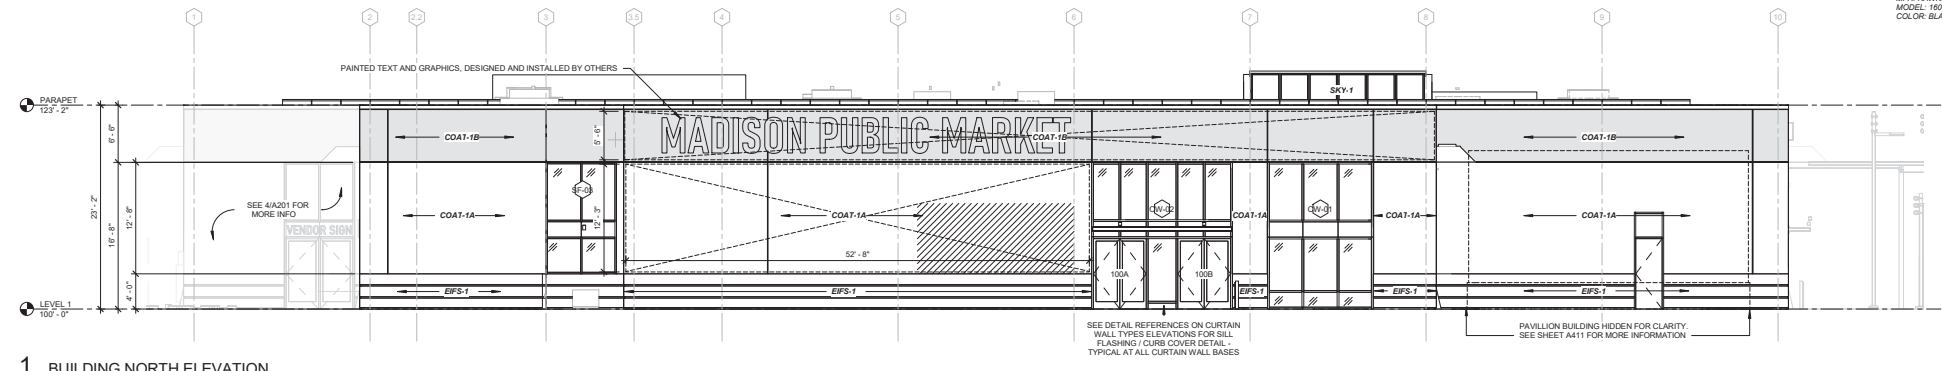


1 BUILDING NORTH ELEVATION
A201 1/8" = 1'-0"

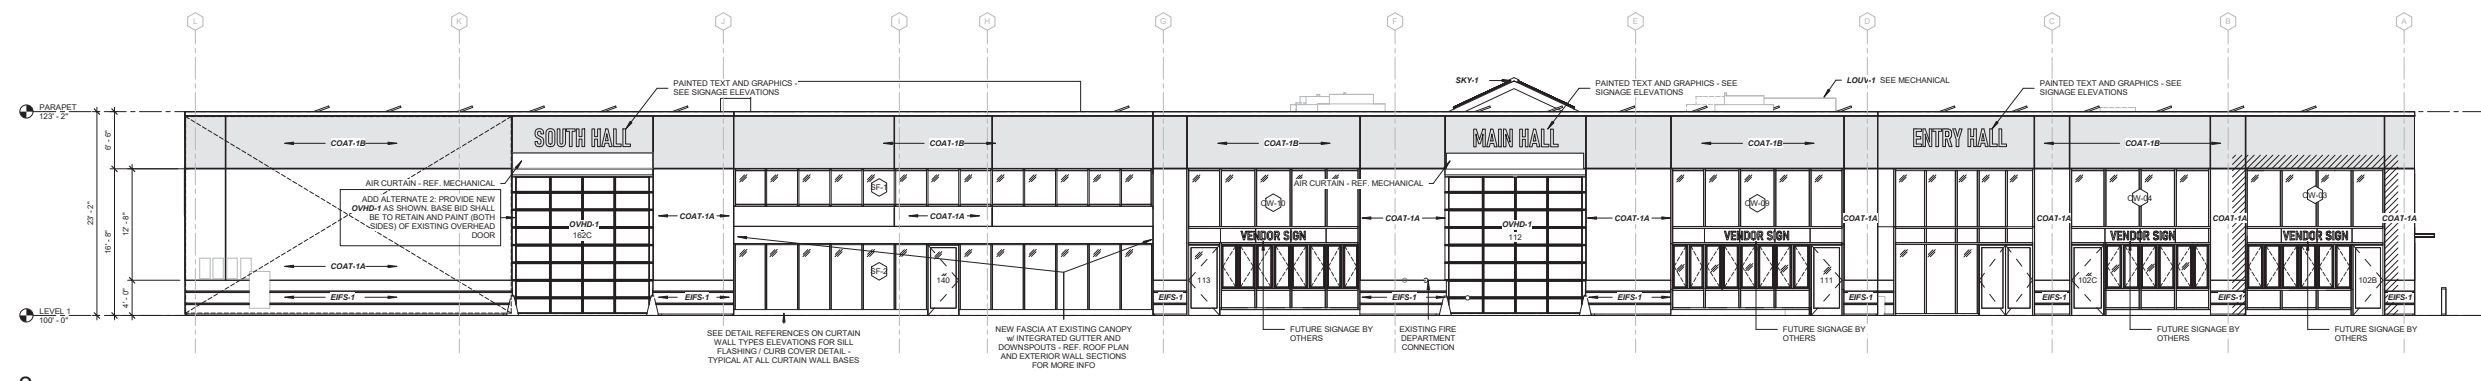


2 BUILDING EAST ELEVATION
A201 1/8" = 1'-0"

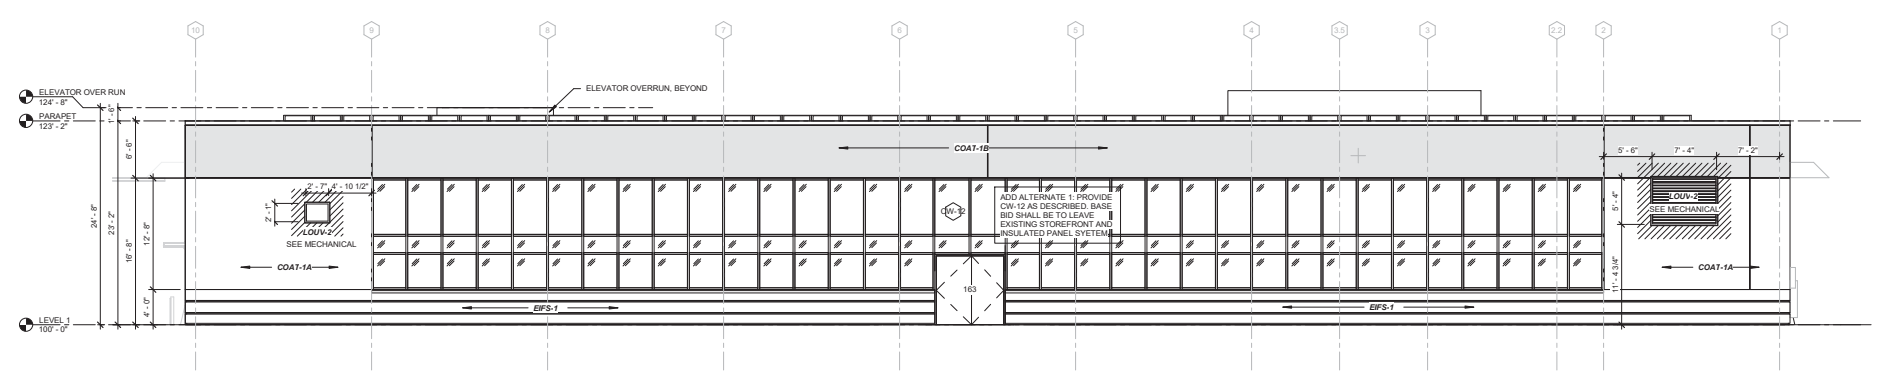

3 BUILDING SOUTH ELEVATION
A201 1/8" = 1'-0"

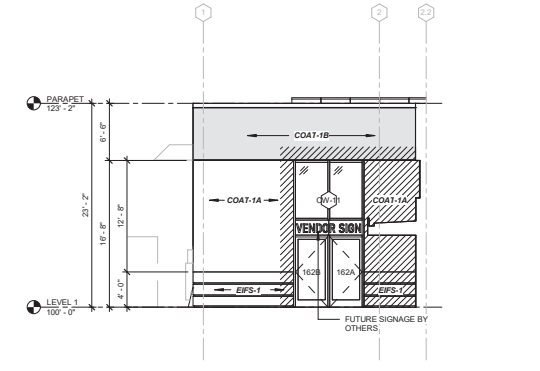

4 PARTIAL BUILDING NORTH ELEVATION - SOUTH HALL
A201 1/8" = 1'-0"

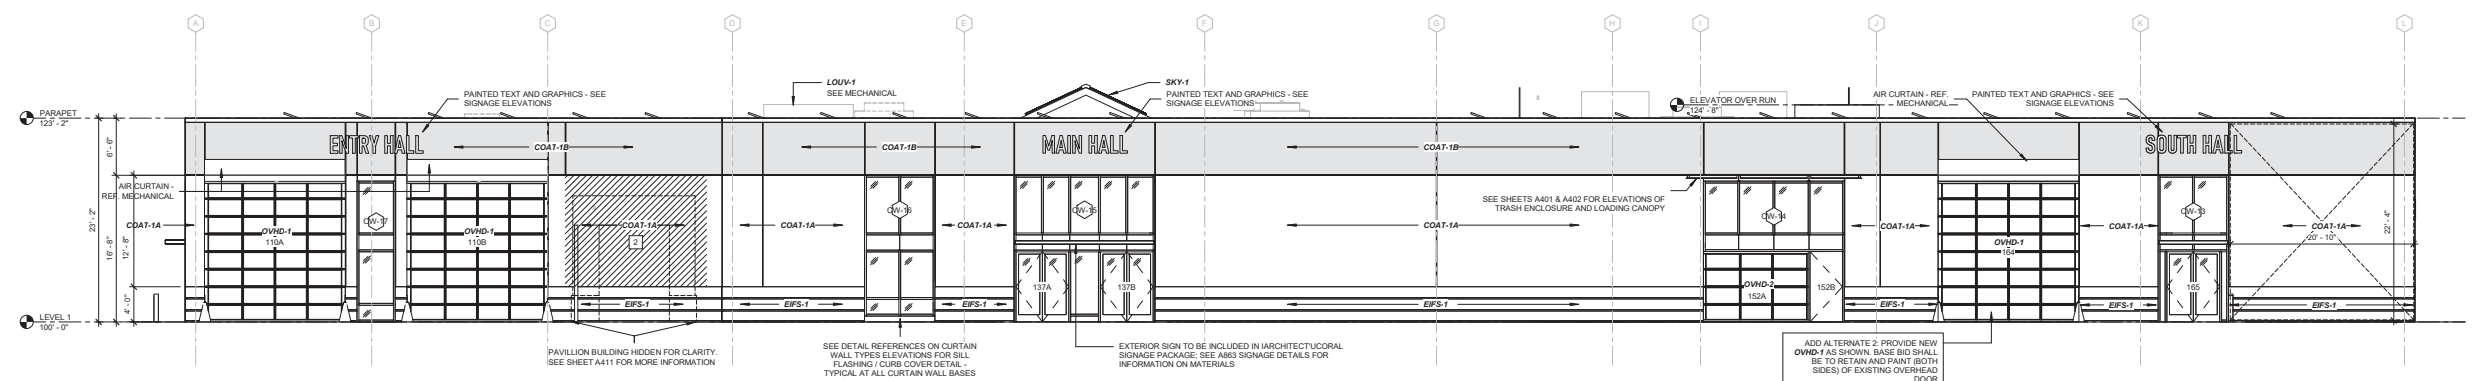

5 BUILDING WEST ELEVATION
A201 1/8" = 1'-0"

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BUILDING ELEVATIONS

A201

building signage and graphics

north elevation

primary building signage
painted typographic. building mounted downlight illumination



artist mural

local artist via art RFP. building mounted downlight illumination

- dark gray EIFS-Sto color 37101
- light gray EIFS-Sto color 37110
- black anodized aluminum

building signage and graphics

east elevation

primary building signage
painted typographic. building mounted downlight illumination



artist mural

local artist via art RFP. building mounted downlight illumination


tenant sign bands

future signage by market vendors. applied text in spandrel zone

- dark gray EIFS–Sto color 37101
- light gray EIFS–Sto color 37110
- black anodized aluminum

building signage and graphics

south elevation

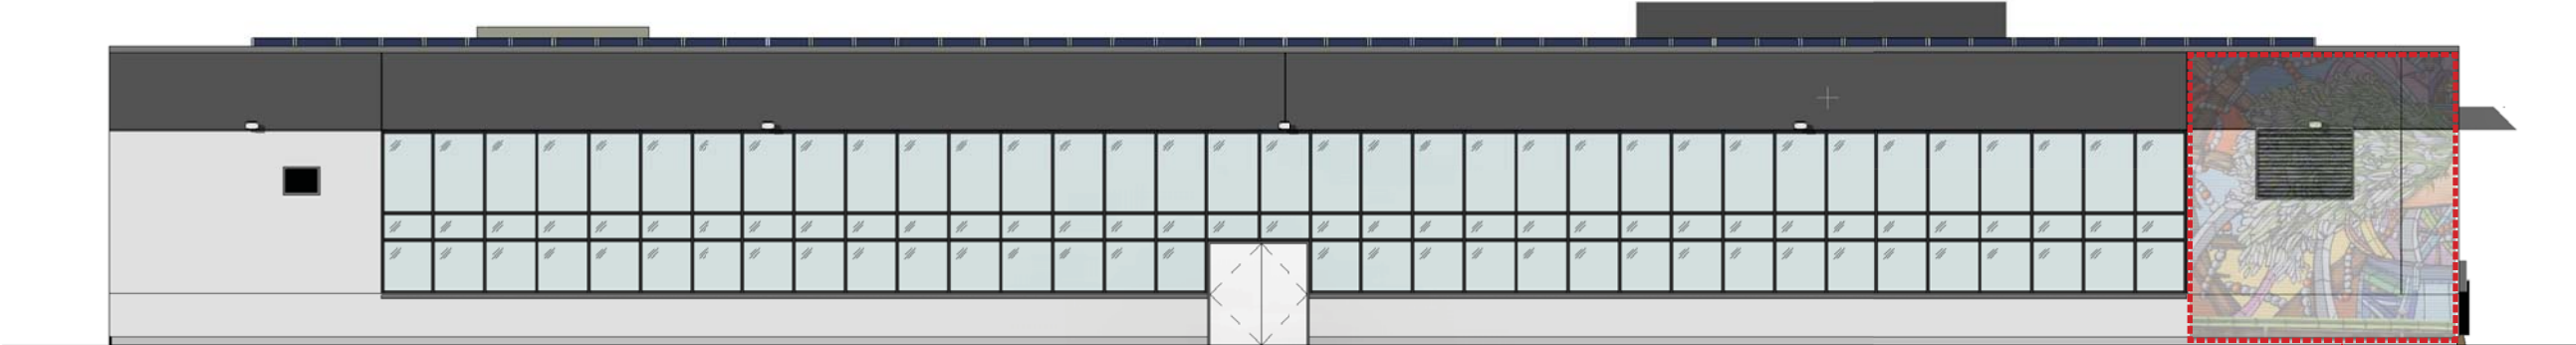

artist mural


local artist via art RFP. building mounted downlight illumination

- dark gray EIFS-Sto color 37101
- light gray EIFS-Sto color 37110
- black anodized aluminum

building signage and graphics

west elevation

primary building signage
painted typographic. building mounted downlight illumination

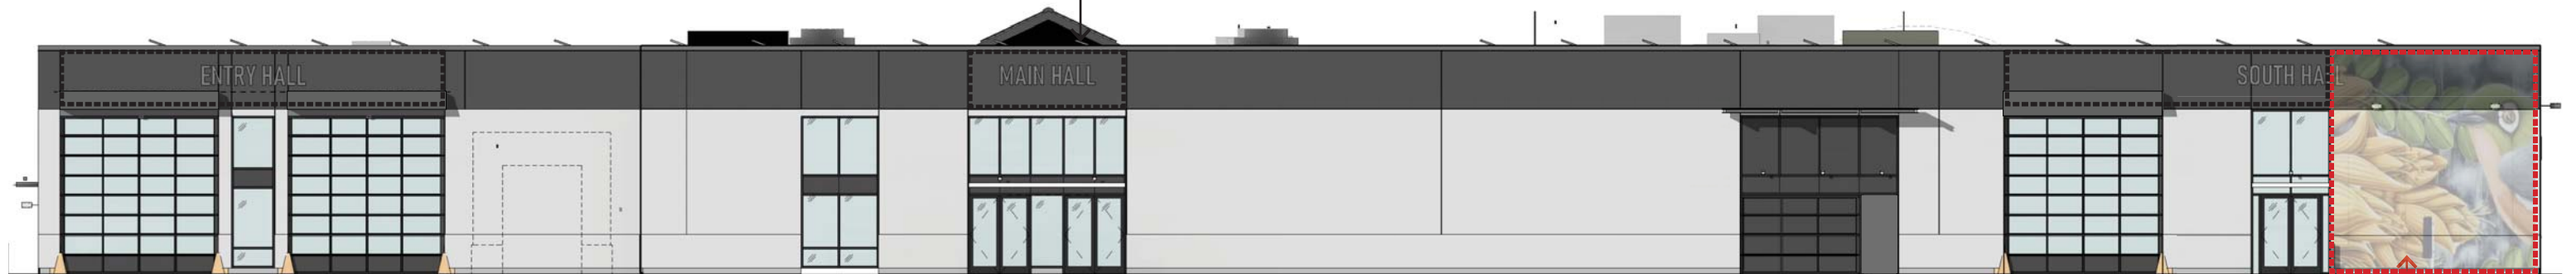


artist mural

local artist via art RFP. building mounted downlight illumination

- dark gray EIFS-Sto color 37101
- light gray EIFS-Sto color 37110
- black anodized aluminum

building elevations

proposed primary signage examples - painted typographic (final design to be determined)

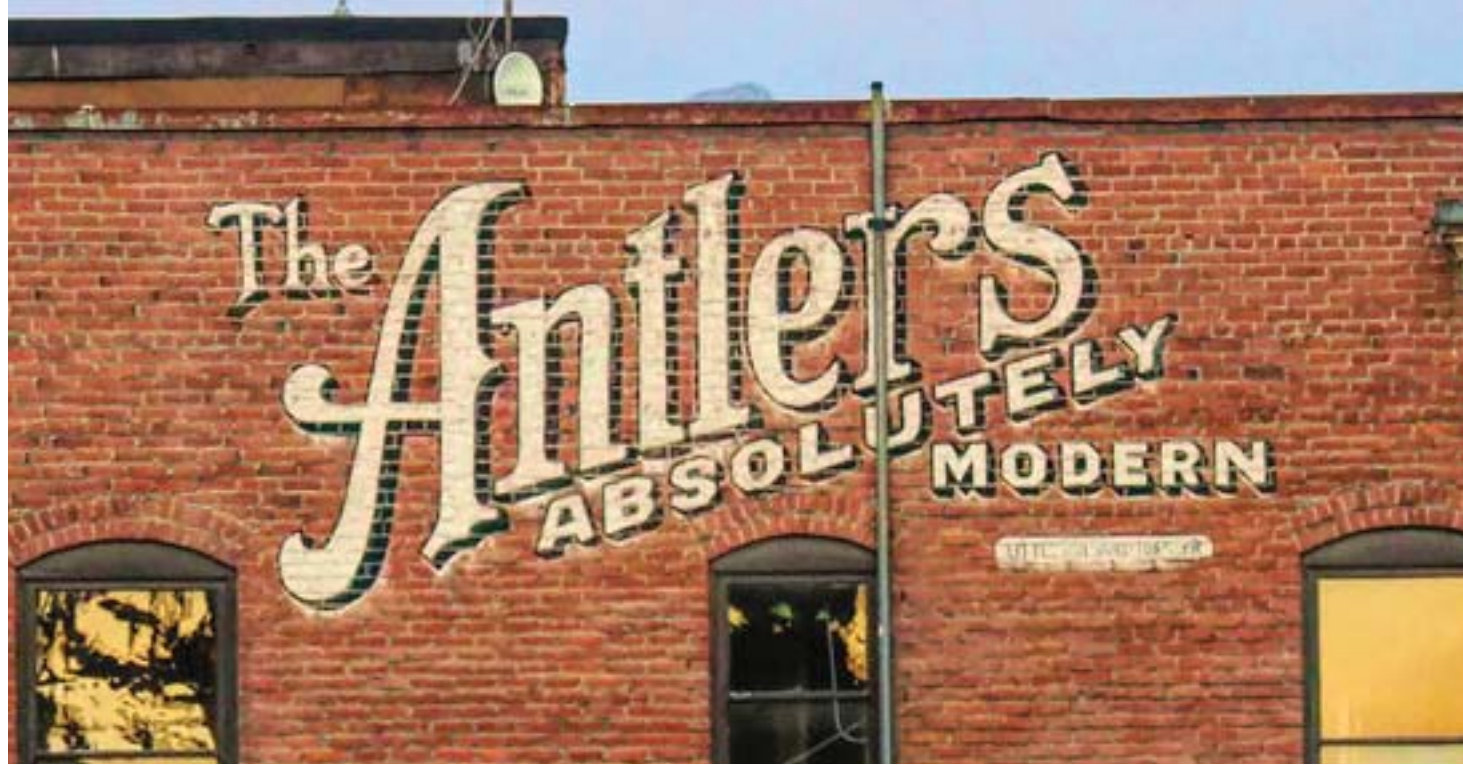

building elevations

local artist murals - identity, culture, mission



