

Community Living Arrangement CBRF


5210 Sigglekow Road
Madison, WI 53718
(608)217-6781
Contact: Fredric DeVillers

Architect


Concepts in Architecture, LLC
W125 Amidon Road
Brooklyn, WI 53521
(608)698-3196
Contact: Jeff Groenier

Civil Engineer

MARS - EOR
119 South Main Street
Cottage Grove, WI 53527
(608)839-4422

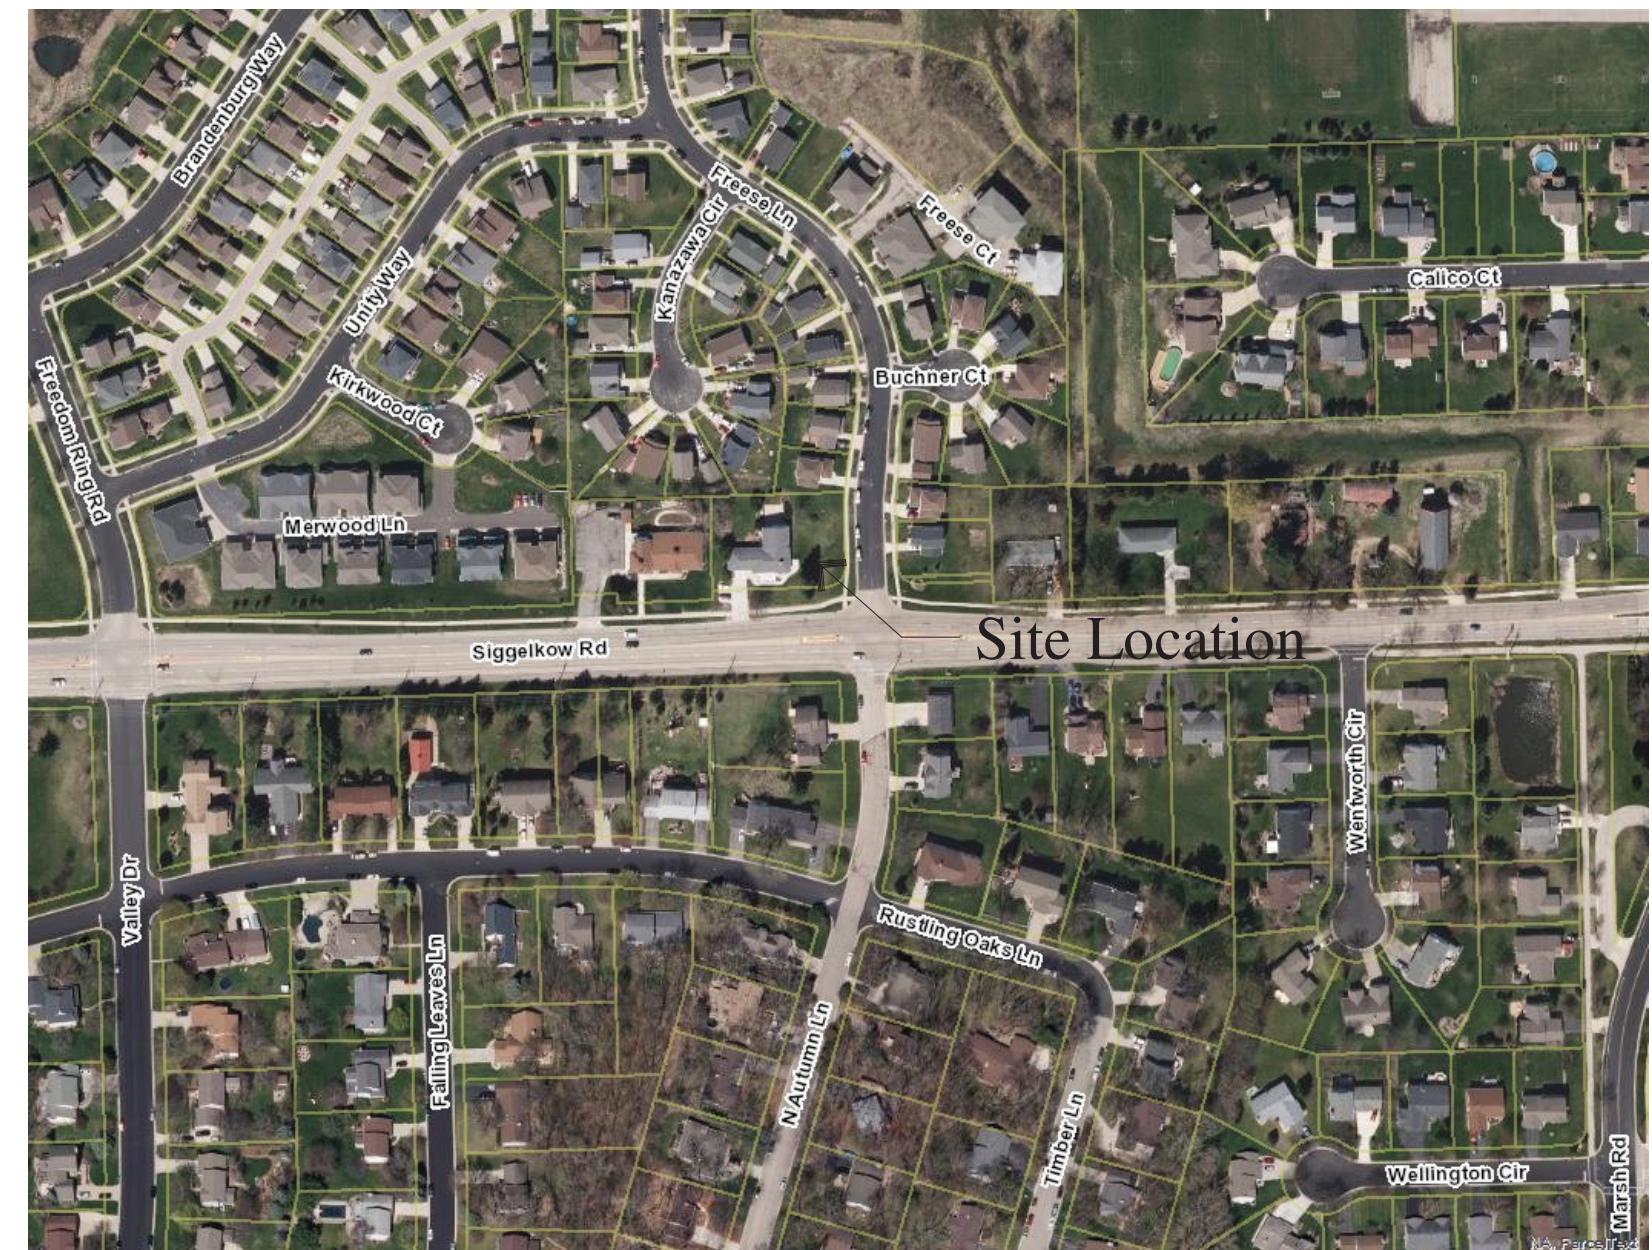

Location Plan

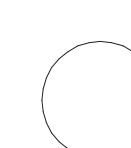

Scale = None

STATE LAW REQUIRES YOU TO NOTIFY OWNERS AND
OPERATORS OF TRANSMISSION FACILITIES AT
LEAST THREE WORKING DAYS BEFORE YOU DIG.



Sheet Index

CS - Cover Sheet

- C110 - Existing Site Plan
- C120 - New Site Plan
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- C510 - Details
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L-1.0 - New Landscape Plan

- A1 - Existing First Floor Plan
- A2 - New First Floor Plan
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- A5 - Existing Elevations
- A6 - New Elevations
- A7 - New Roof Plan

General Notes

1. Contractor to verify all dimensions.
2. Contractor shall obtain all permits needed for construction.
3. Contractor to verify location of telephone service and requirements of telephone company.
4. Plumbing contractor to verify all existing sanitary sewer and water mains. Coordinate connections with municipality.
5. HVAC contractor verify location and depth of gas main and coordinate with gas company.
6. Electrical contractor shall verify location and size of service. Coordinate with electric company.
7. Property lines and building setbacks to be located by a Registered Land Surveyor.
8. Call Diggers hot-line before digging
9. Contractor to verify smoke detection/fire detection system with electrical contractor prior to installation
10. HVAC, Plumbing, and Electrical Contractors to design, obtain state approved plans prior to installation.
11. Truss supplier to submit plans to state after approval by Architect and Owner.
12. Building to be VB construction
13. Occupancy type R2
14. Allowable building area 9,000 sf
15. Sprinklered Per NFPA 13

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C
oncepts
In
Architect, LLC

Proposed for: Fredric A DeVillers
Address: 5210 Sigglekow Road
Madison, WI 53718
608-220-6129

Project: 5210 Sigglekow Road
Address: City of Madison, WI
Sheet Title: Cover Sheet
Date: 09-09-2019
Scale: As Noted
Job #: 05-01

SHEET
CS

LEGEND

● 3/4" SOLID IRON ROD FOUND	□ TV PEDESTAL
● 1.25" SOLID IRON FOUND	□ ELECTRIC PEDESTAL
● 3/4" X 10" SOLID IRON RE-ROD SET, WT. 1.50 lbs./ft.	□ LIGHT POLE
X 20'A SPOT ELEVATION	□ TELEPHONE PEDESTAL
— G BURIED GAS LINE	□ FIRE HYDRANT
— W WATER MAIN	□ SIGN
— SAN SANITARY SEWER	□ MAILBOX
— ST STORM SEWER	□ STORM SEWER INLET
— UT BURIED TELEPHONE	□ STORM SEWER MANHOLE
— E BURIED ELECTRIC	□ STORM SEWER STRUCTURE
— FO BURIED FIBER OPTIC	□ SANITARY SEWER MANHOLE
() INDICATES RECORDED AS	
● WATER VALVE	
● GAS VALVE	
□ GAS METER	
L.S. LANDSCAPNG	
W.W. WINDOW WELL	

DISTANCES ARE MEASURED TO THE NEAREST HUNDREDTH OF A FOOT. BUILDINGS ARE MEASURED TO THE NEAREST TENTH OF A FOOT.


OUTLOT 1 AND LOT 2, TWIN OAKS, AS RECORDED IN VOLUME 58-039A OF PLATS, ON PAGES 209-211, AS DOCUMENT NUMBER 3834712, DANE COUNTY REGISTRY, LOCATED IN THE SOUTHEAST QUARTER OF THE NORTHEAST QUARTER OF SECTION 34, TOWNSHIP 07 NORTH, RANGE 10 EAST, CITY OF MADISON, DANE COUNTY, WISCONSIN

GENERAL NOTES

1. EXISTING CONDITIONS SHOWN ARE BASED ON A SURVEY CONDUCTED BY BURSE SURVEYING & ENGINEERING, INC. EMMONS & OLIVIER RESOURCES, INC TAKES NO RESPONSIBILITY FOR ACCURACY OF ANY EXISTING CONDITIONS ELEVATIONS OR BENCHMARKS.
2. ALL WORK IN THE RIGHT-OF-WAY SHALL BE IN ACCORDANCE WITH THE CITY OF MADISON STANDARD SPECIFICATIONS FOR PUBLIC WORKS CONSTRUCTION, LATEST ADDITION.
3. NO SITE GRADING SHALL BE PERFORMED OUTSIDE OF THE SILT FENCE / GRADING LIMITS EXCEPT AS NOTED.

SURVEY NOTES

1. EXCEPT AS SPECIFICALLY STATED OR SHOWN ON THIS MAP, THIS SURVEY DOES NOT PURPORT TO REFLECT ANY OF THE FOLLOWING WHICH MAY BE APPLICABLE TO THE SUBJECT REAL ESTATE: EASEMENTS; BUILDING SETBACK LINES; RESTRICTIVE COVENANTS; SUBDIVISION RESTRICTIONS; ZONING OR OTHER LAND USE REGULATIONS; AND ANY OTHER FACTS THAT AN ACCURATE AND CURRENT TITLE SEARCH MAY DISCLOSE. SURVEY WAS PERFORMED WITHOUT THE BENEFIT OF A TITLE REPORT.
2. NO ATTEMPT HAS BEEN MADE AS A PART OF THIS SURVEY TO OBTAIN OR SHOW DATA CONCERNING EXISTENCE, SIZE, DEPTH, CONDITION, CAPACITY, OR LOCATION OF ANY UTILITY OR MUNICIPAL/PUBLIC SERVICE FACILITY. FOR INFORMATION REGARDING THESE UTILITIES OR FACILITIES, PLEASE CONTACT THE APPROPRIATE AGENCIES.
3. DATE OF FIELD WORK: 12-19-18, 12-20-18, 01-02-19, 01-07-19 AND 01-09-2019.
4. SURVEYOR HAS MADE NO INVESTIGATION OR INDEPENDENT SEARCH FOR EASEMENTS OF RECORD, ENCUMBRANCES, RESTRICTIVE COVENANTS, OWNERSHIP TITLE EVIDENCE, OR ANY OTHER FACTS THAT AN ACCURATE AND CURRENT TITLE SEARCH MAY DISCLOSE.
5. ALL BUILDINGS, AND SURFACE AND SUBSURFACE IMPROVEMENTS ON AND ADJACENT TO THE SITE ARE NOT NECESSARILY SHOWN HEREON.
6. ALL TREES, HEDGES AND GROUND COVER ON THE SITE MAY NOT NECESSARILY BE SHOWN HEREON.
7. ROUTING OF PUBLIC UTILITIES IS BASED UPON DRAWINGS OBTAINED FROM THE CITY OF MADISON ENGINEERING DEPARTMENT, MARKINGS PROVIDED BY DIGGER'S HOTLINE TICKET NUMBERS 20184809775, 20184809795, 20184809800, 20184809835, 20184809837, AND VISIBLE ABOVE GROUND STRUCTURES. ADDITIONAL BURIED UTILITIES/STRUCTURES MAY BE ENCOUNTERED. NO EXCAVATIONS WERE MADE TO LOCATED UTILITIES. BEFORE EXCAVATIONS ARE PERFORMED CONTACT DIGGER'S HOTLINE.
8. TOTAL PARCEL AREA = 20,384 SQUARE FEET (LOTS COMBINED).
9. ELEVATIONS ARE BASED UPON NAVD88 DATUM. SURVEYOR TRANSFERRED ELEVATIONS TO THE SITE UTILIZING RTK GPS SURVEYING OBSERVING THE WISCONSIN NETWORK. THE TOP NUT OF THE HYDRANT ON THE EAST SIDE OF FRESE LANE HAS AN ELEVATION OF 889.27.
10. SPOT ELEVATIONS AT EACH ENTRANCE AND FINISH FLOOR NEXT TO EACH ENTRANCE WERE CALCULATED BY RUNNING A CLOSED LEVEL CIRCUIT FROM LOCAL SITE BM OF 889.27.

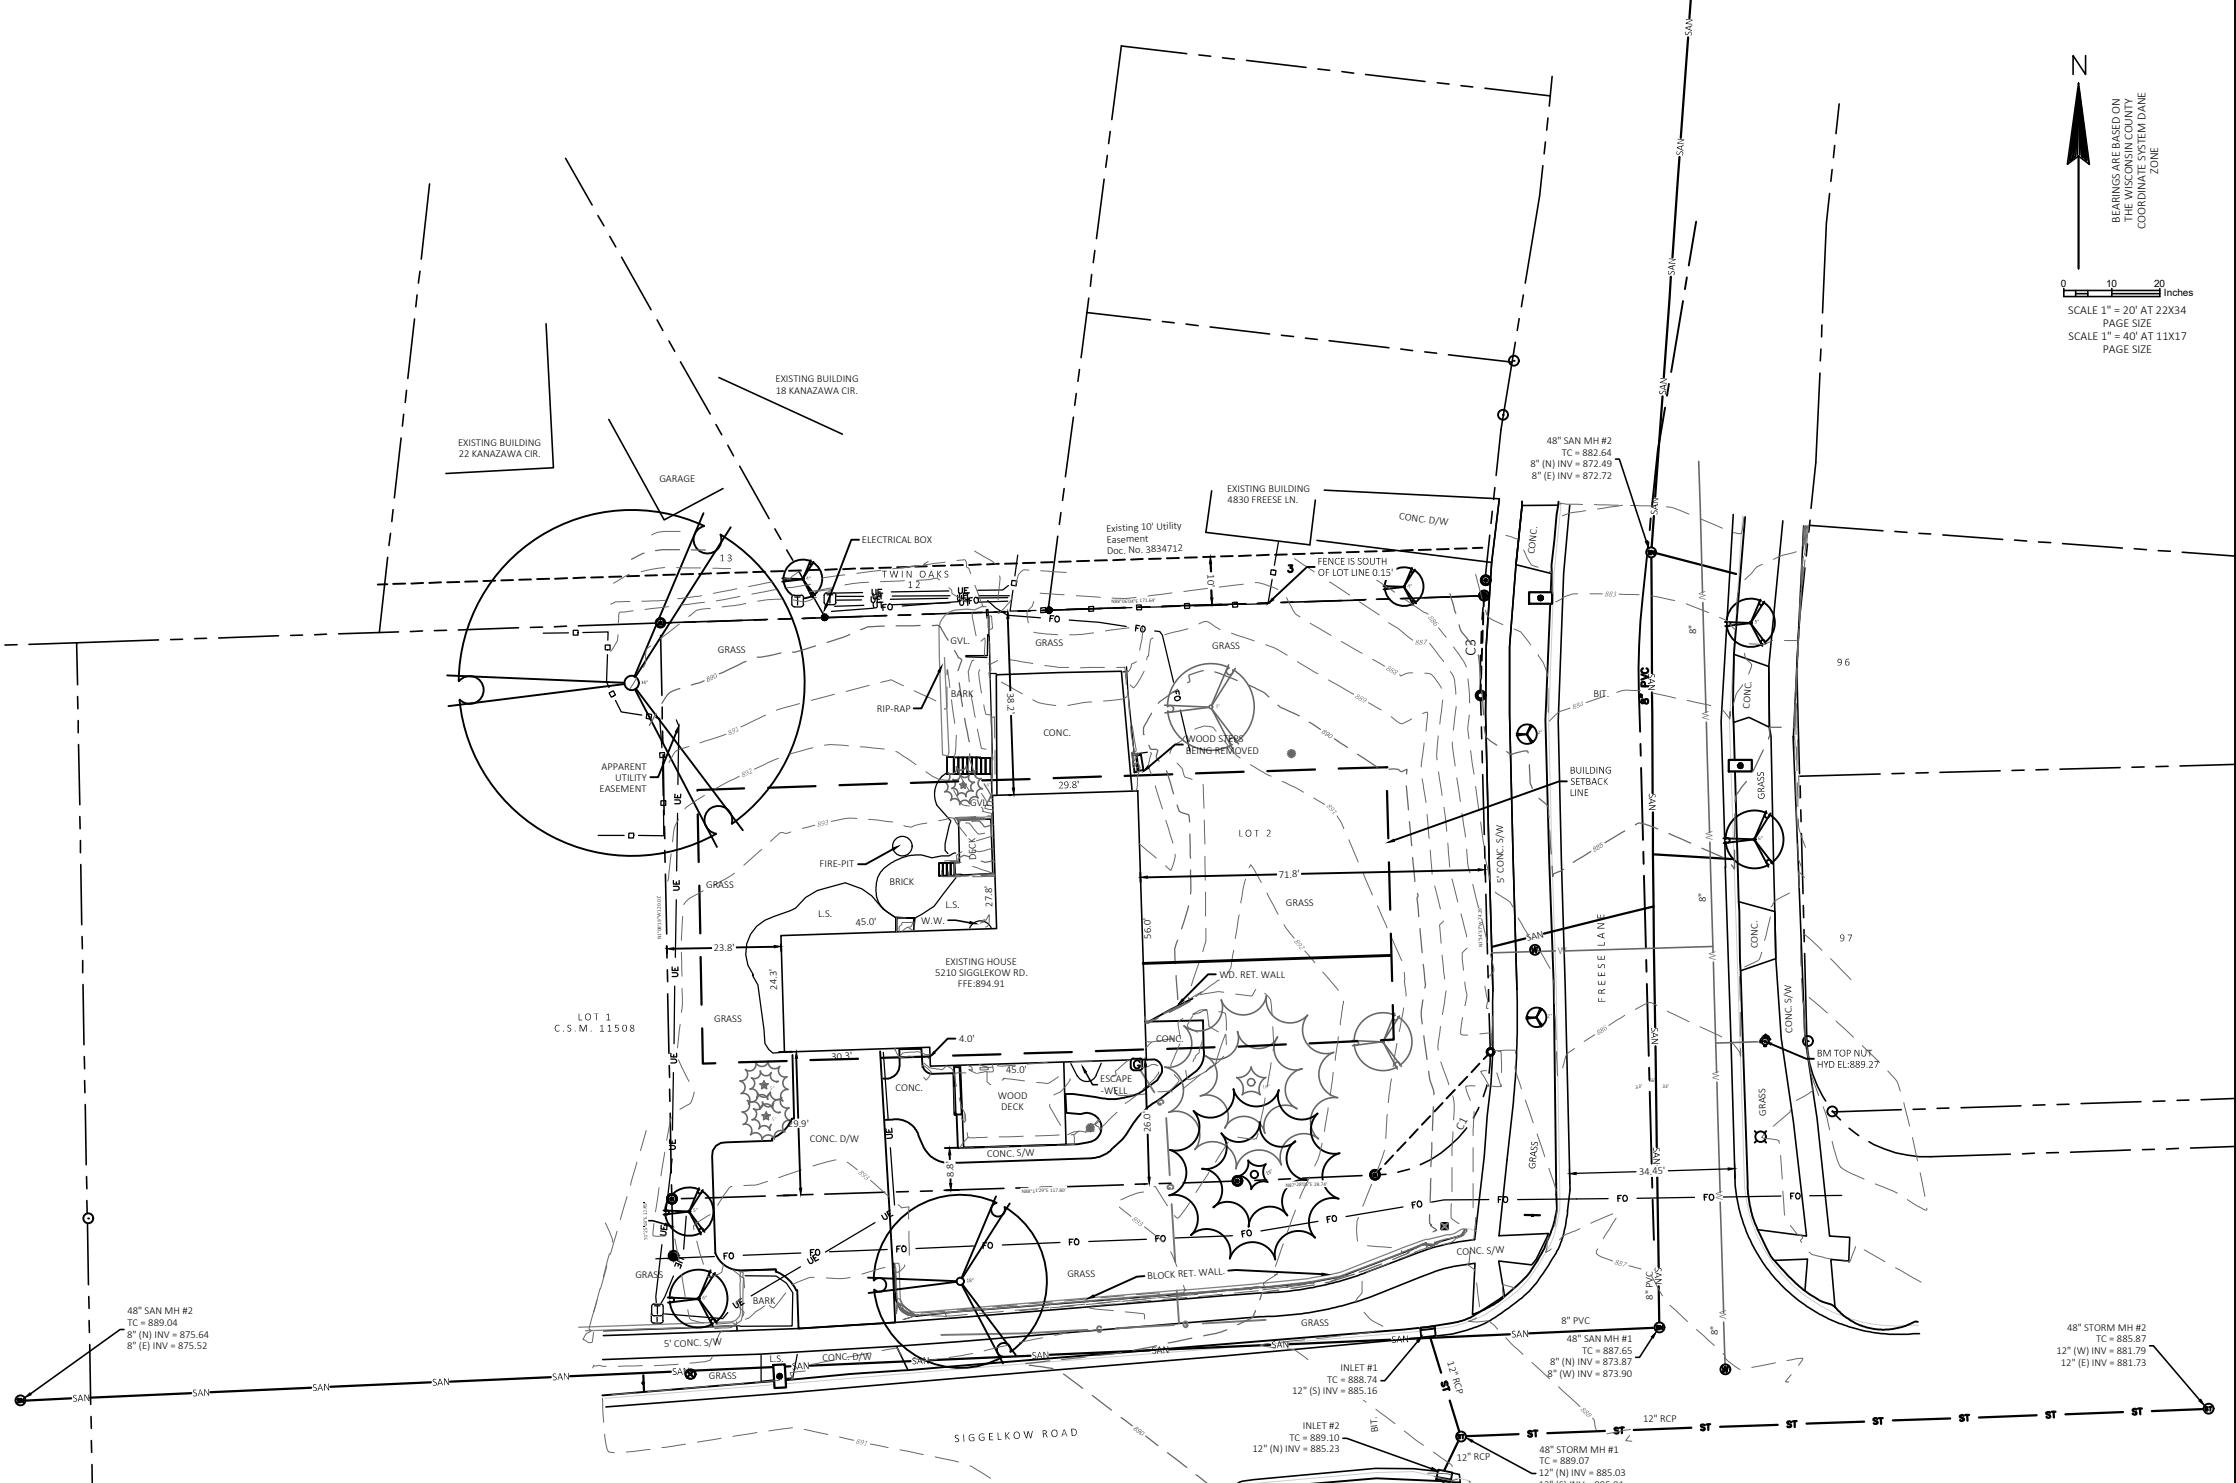

SURVEYED FOR :
FREDERIC A. DEVILLERS
5210 SIGGELKOW RD.
MADISON, WI 53718

SURVEYED BY :


Burse
Surveying & engineering Inc.
2801 International Lane, Suite 101
Madison, WI 53704 608.250.9263
Fax: 608.250.9266
email: imburse@bse-inc.net
www.burseSurveyEngr.com



CALL DIGGERS HOTLINE
1-800-242-8511 TOLL-FREE

WISCONSIN STATE STATUTE 182.21 (2013) REQUIRES A MINIMUM THREE (3) DAY ADVANCE NOTICE TO THE DIGGER'S HOTLINE.

"THE INFORMATION SHOWN ON THIS DRAWING CONCERNING THE TYPE AND LOCATION OF UNDER-GROUND UTILITIES IS NOT GUARANTEED TO BE ACCURATE. THE SURVEYOR OR ENGINEER IS RESPONSIBLE FOR MAKING HIS OWN DETERMINATION AS TO THE EXACT LOCATION AND CONDITION OF GROUND UTILITIES AS MAY BE NECESSARY TO ACCURATELY LOCATE THE PROPERTY. THE SURVEYOR OR ENGINEER IS NOT RESPONSIBLE FOR UTILITIES BEHIND THE SITE AND THE BUILDING THAT ARE NOT SHOWN. THE SURVEYOR OR ENGINEER IS NOT RESPONSIBLE FOR UTILITIES BEING IN THE PROPERTY OR OF WHICH THE SURVEYOR WOULD HAVE NO KNOWLEDGE."

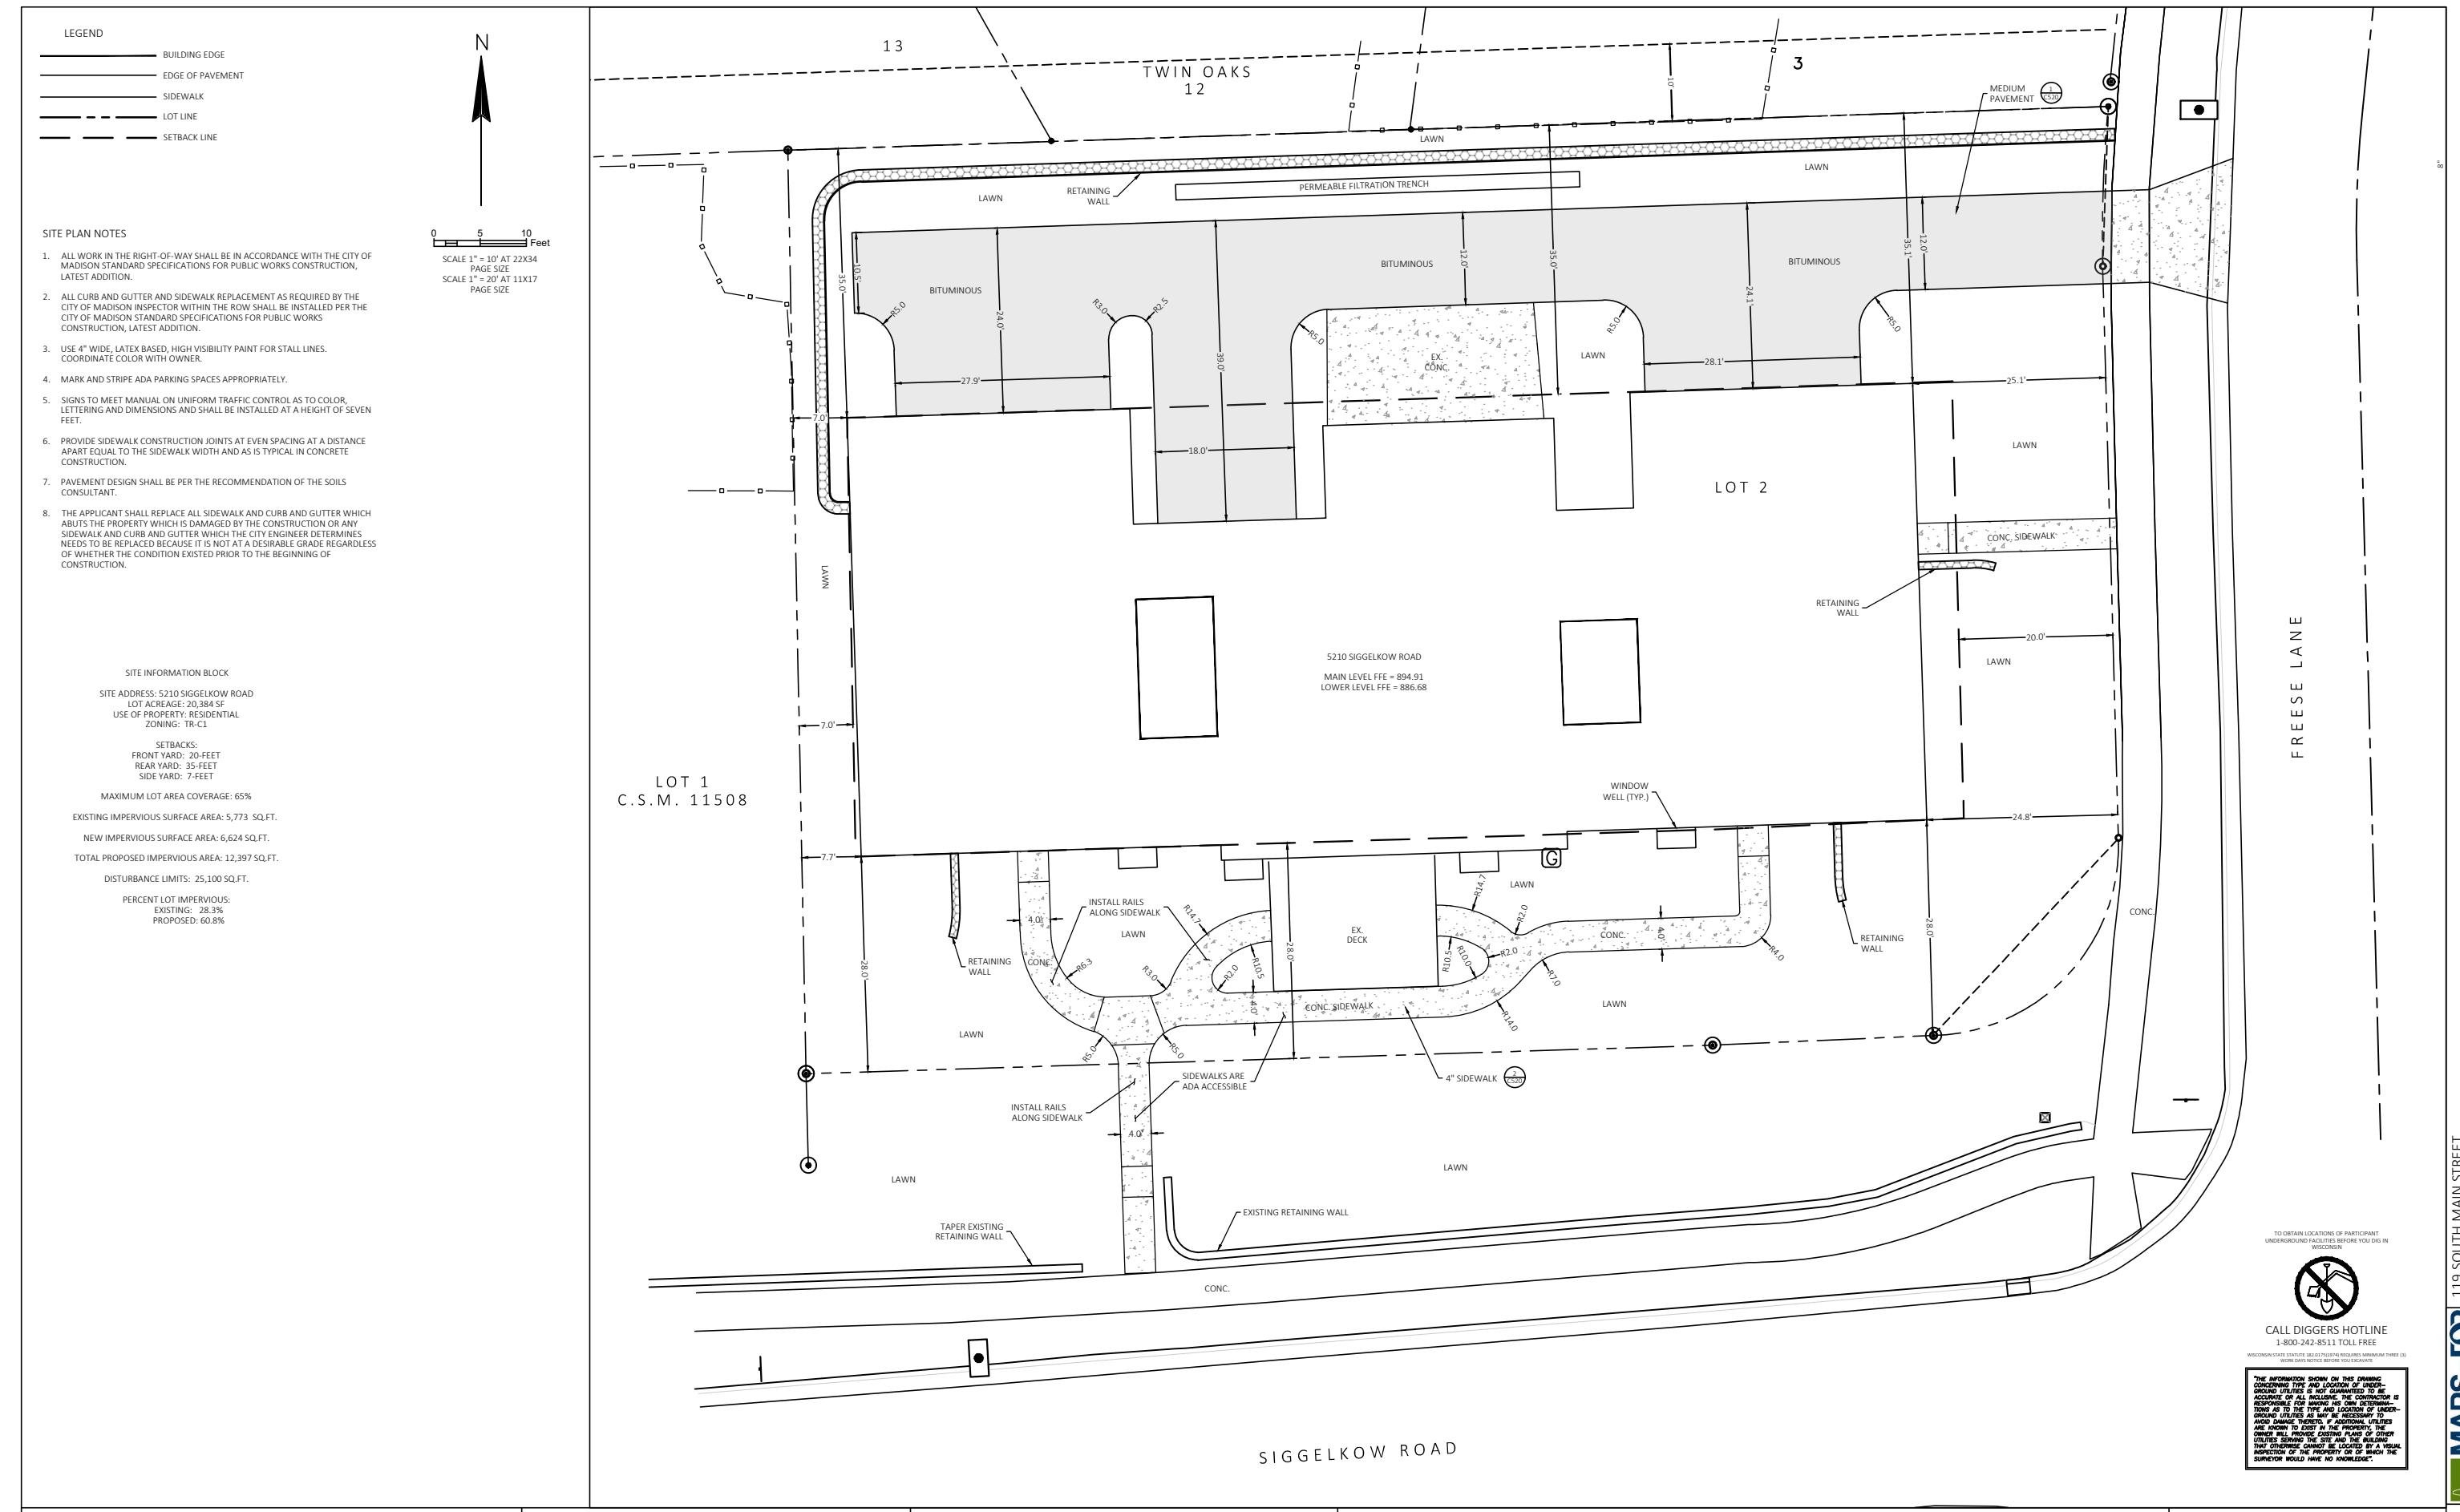

PROJECT: 5210 SIGGELKOW ROAD REDEVELOPMENT

CLIENT: FRED DeVILLERS

COUNTY: DANE

STATE PLAN

FOR REVIEW

EET C120


FILE NAME : P:\01482-0001 DEVILLERS-SIGGELKOW REDEVELOPMENT\DRAWINGS\Sheets PLAN\C120 - SITE PLAN.DWG

PLOT DATE : 9/11/2019 3:19 PM

PLOT BY : CHRISTINE PELTO

PLOT NAME : _____

LOT SCALE : 1" = 10' (22x34)

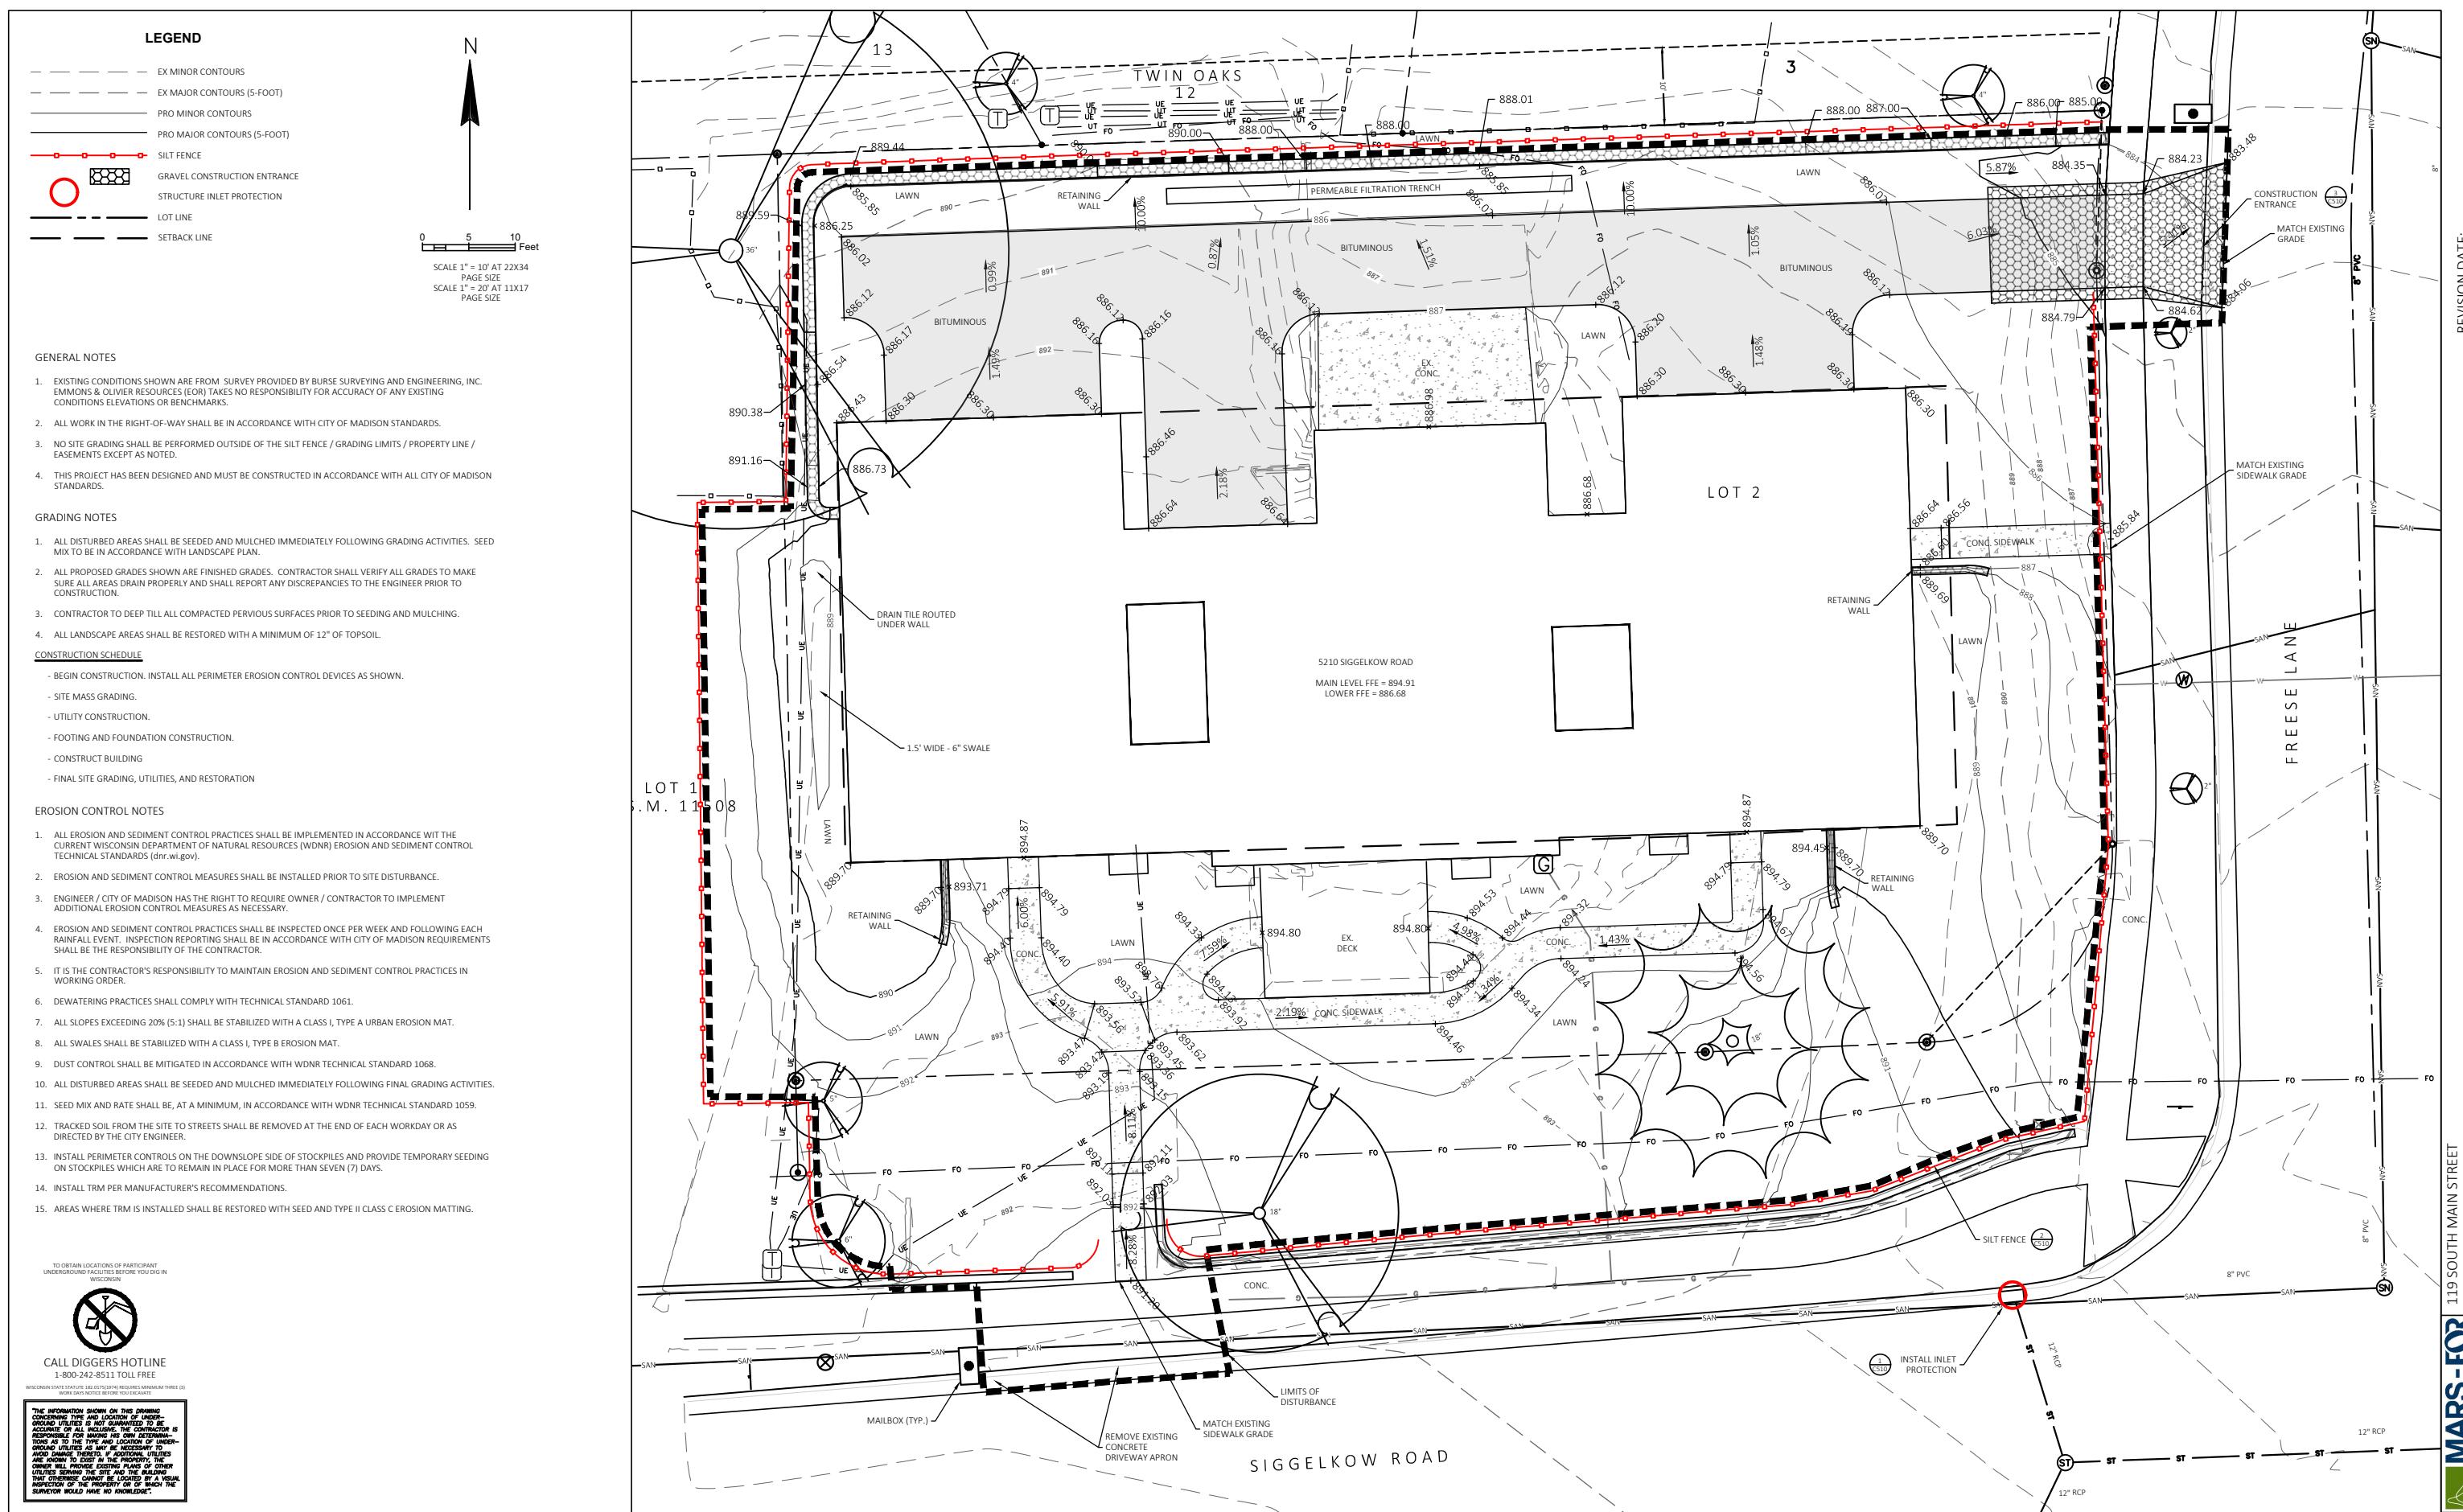

PROJECT: 5210 SIGGELKOW ROAD REDEVELOPMENT


CLIENT: FRED DeVILLERS


COUNTY: DANE

RADING AND EROSION CONTROL PLAN

FOR REVIEW

HEET C130

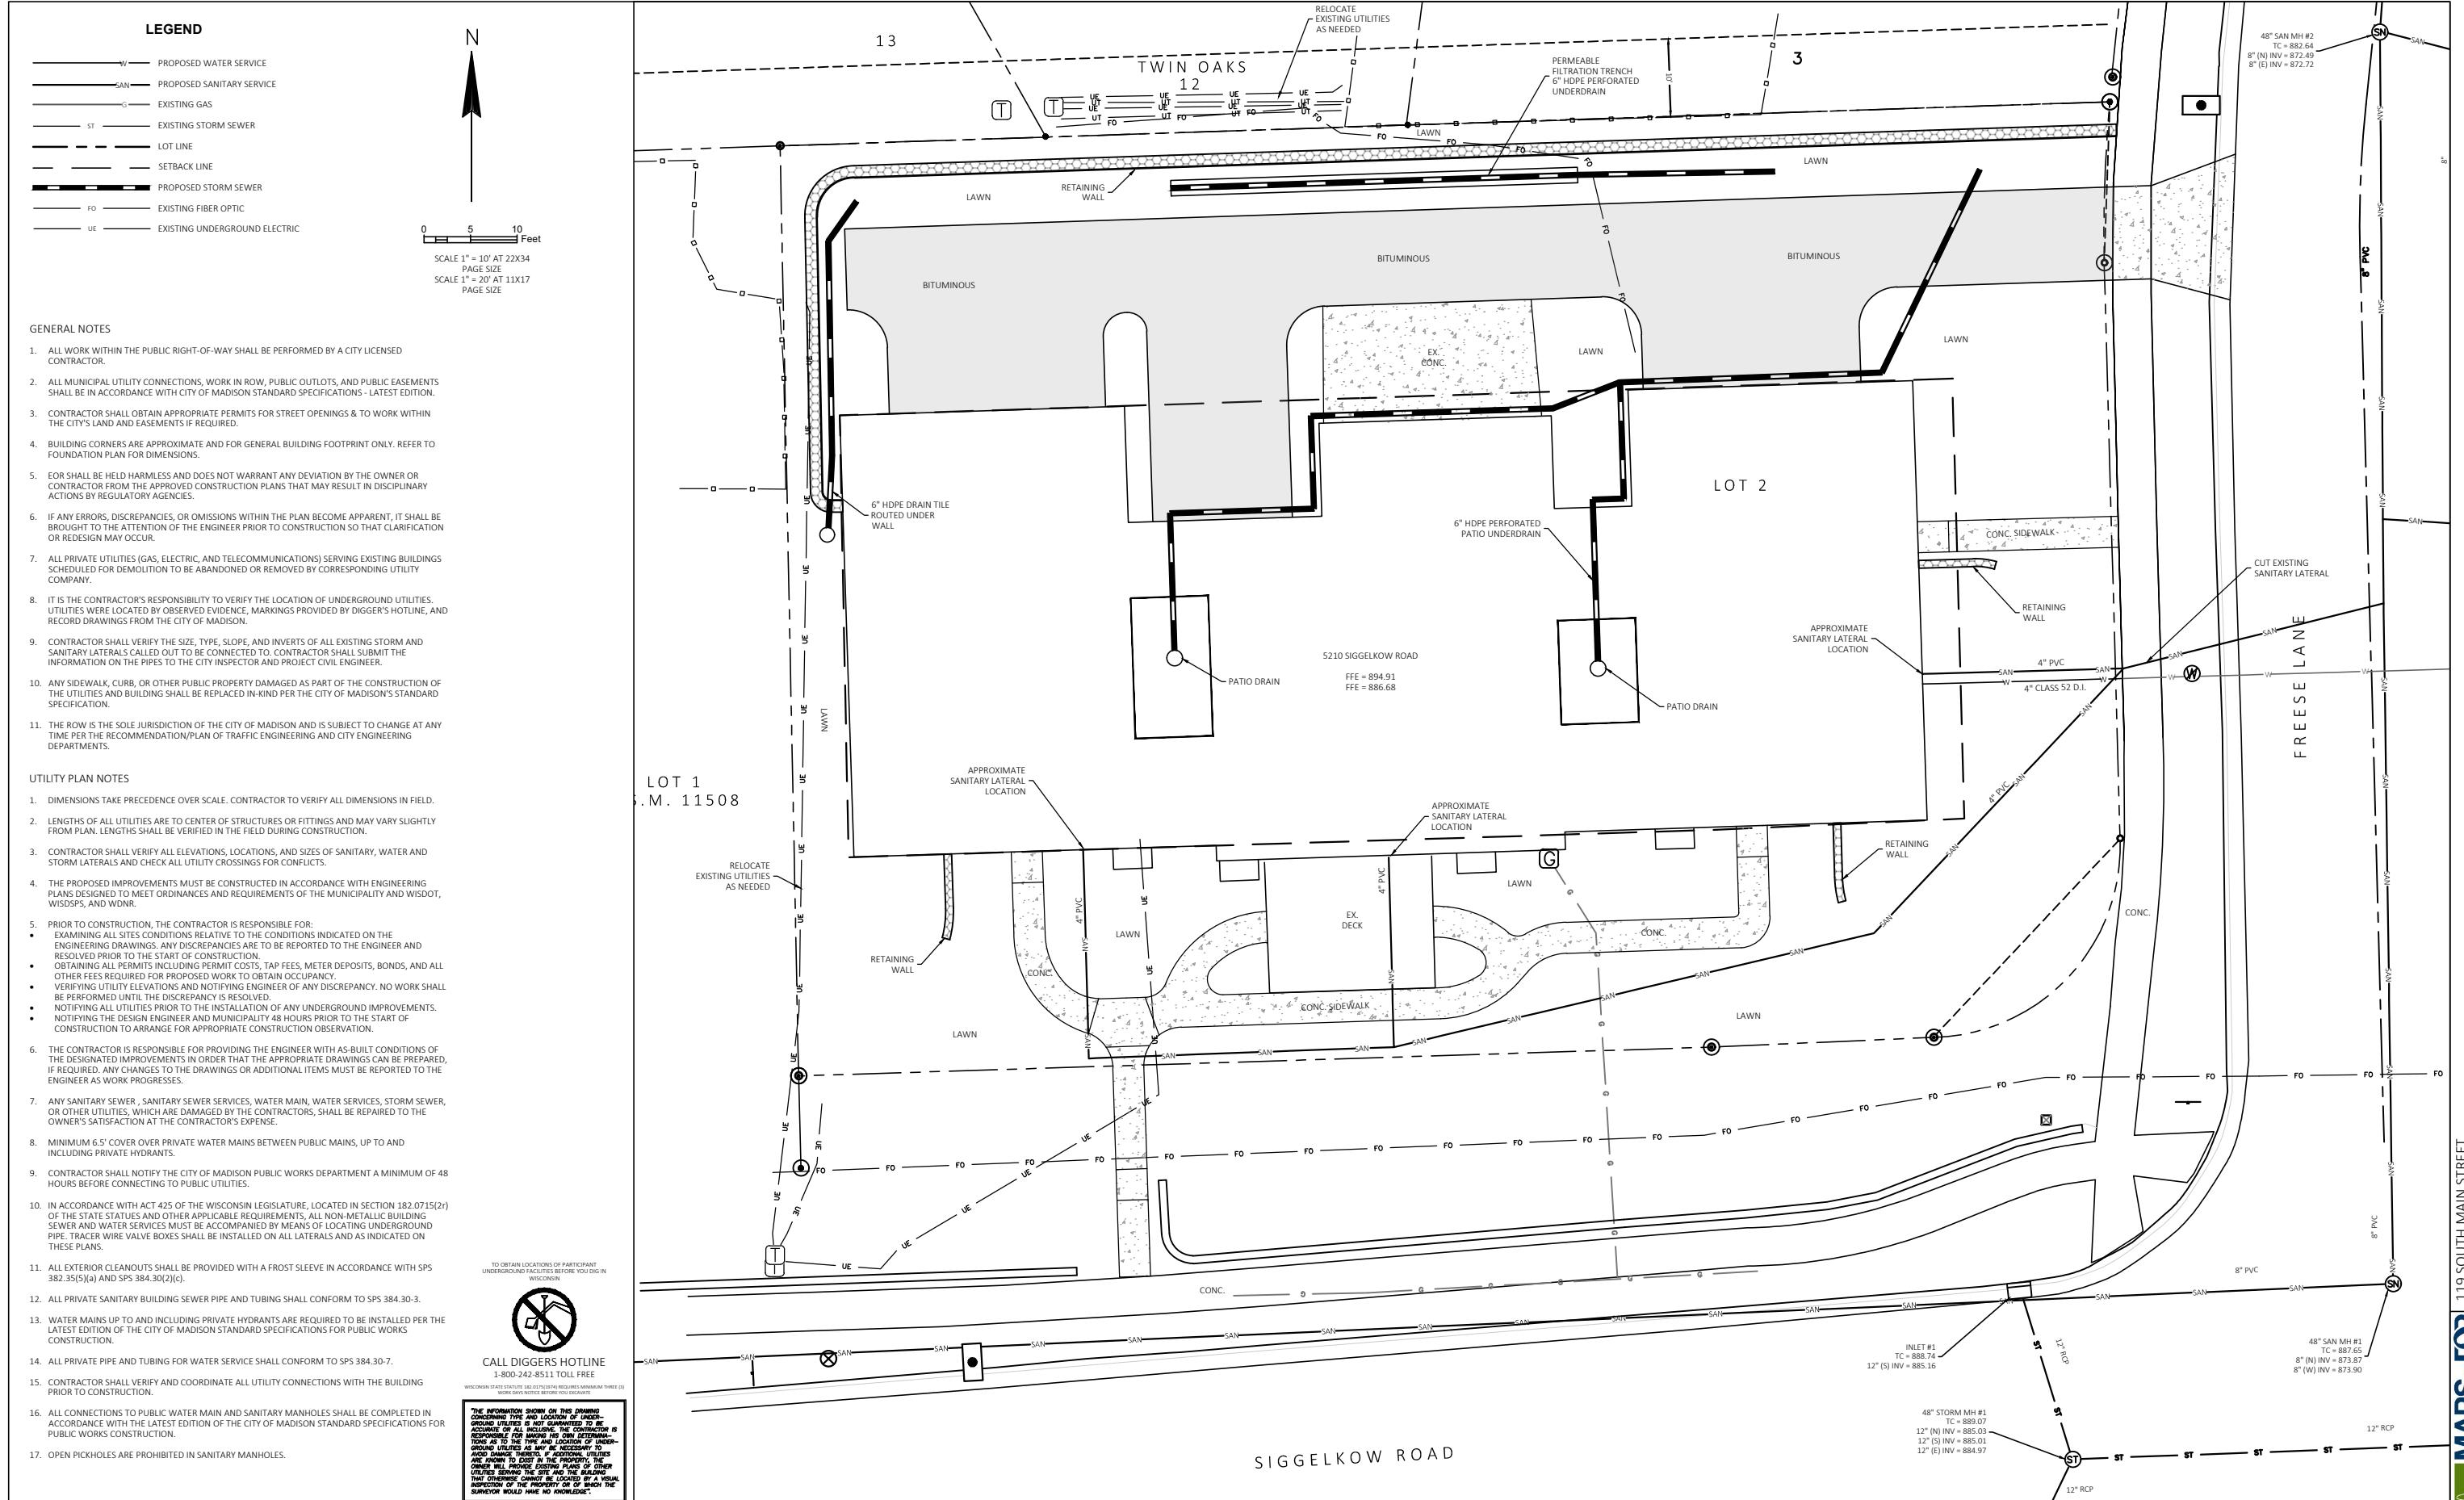

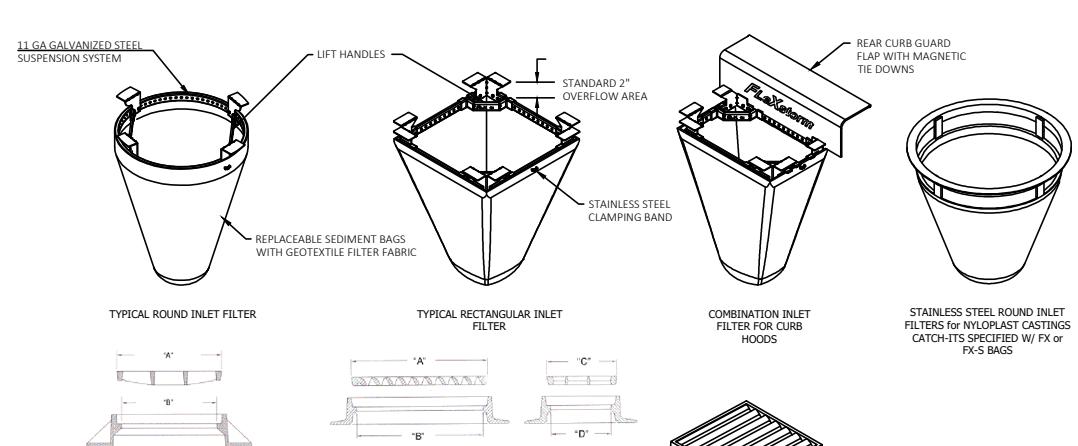


1. IDENTIFY YOUR FRAME STYLE AND SIZE		Frame P/N:
STYLE	FRAME STYLE AND SIZE	
ROUND	Small Round (up to 20" diameter) (A)	6259D
	Med Round (20.1" - 26.0" diameter) (A) up to 35" openings (B)	6259R
	Large Round (26.1" - 32.0" diameter) (A) up to 30" openings (B)	6259L
RECT/SQUARE	Small Rect / Square (up to 15" (B) x 15" (D) openings or 95" perimeter)	6255Q
	Med Rect / Square (up to 24" (B) x 24" (D) openings or 95" perimeter)	6254Q
	Large Rect / Square (up to 36" (B) x 36" (D) openings or 130" perimeter)	6254L
	XL Rect / Square (side by side bags set to fit up to 45" (B) x 36" (D) openings)	6254XL
COMBO	Med Rect / Square (Rect Casting shaped with Magnetic Curb Flap)	625CB
	Large Rect / Square (Rect Casting shaped with Magnetic Curb Flap)	625CB
	XL Rect / Square (Rect Casting shaped with Magnetic Curb Flap)	625CB
NYLOPLAST	12" diameter Nyloplast casting (Stainless Steel framing standard)	6212NY
	18" diameter Nyloplast casting (Stainless Steel framing standard)	6218NY
	24" diameter Nyloplast casting (Stainless Steel framing standard)	6224NY
	30" diameter Nyloplast casting (Stainless Steel framing standard)	6230NY

2. SELECT YOUR BAG PART NUMBER			
PLEXSTORM FILTER BAGS (12" depth)	STD Bag P/N:	12" depth)	Clean Water Flow
FX Standard Woven Bag	FX	FX-S	200 GPM (US GPM)
IL/IDOT Non-Woven Bag	IL	IL-S	145 GPM (US GPM)

3. CREATE YOUR FLEXSTORM INLET FILTER PART NUMBER			
Nominal Bag Size	Solids Storage (CuFt)	Filtered Flow Rate at 50% Max (GFS)	
Small	1.6	1.2	0.9
Medium	2.1	1.7	1.3
Large	3.8	2.7	1.9
XL	4.2	3.6	2.6

1. INLET PROTECTION, FRAMED (FLEXSTORM CATCH-IT)

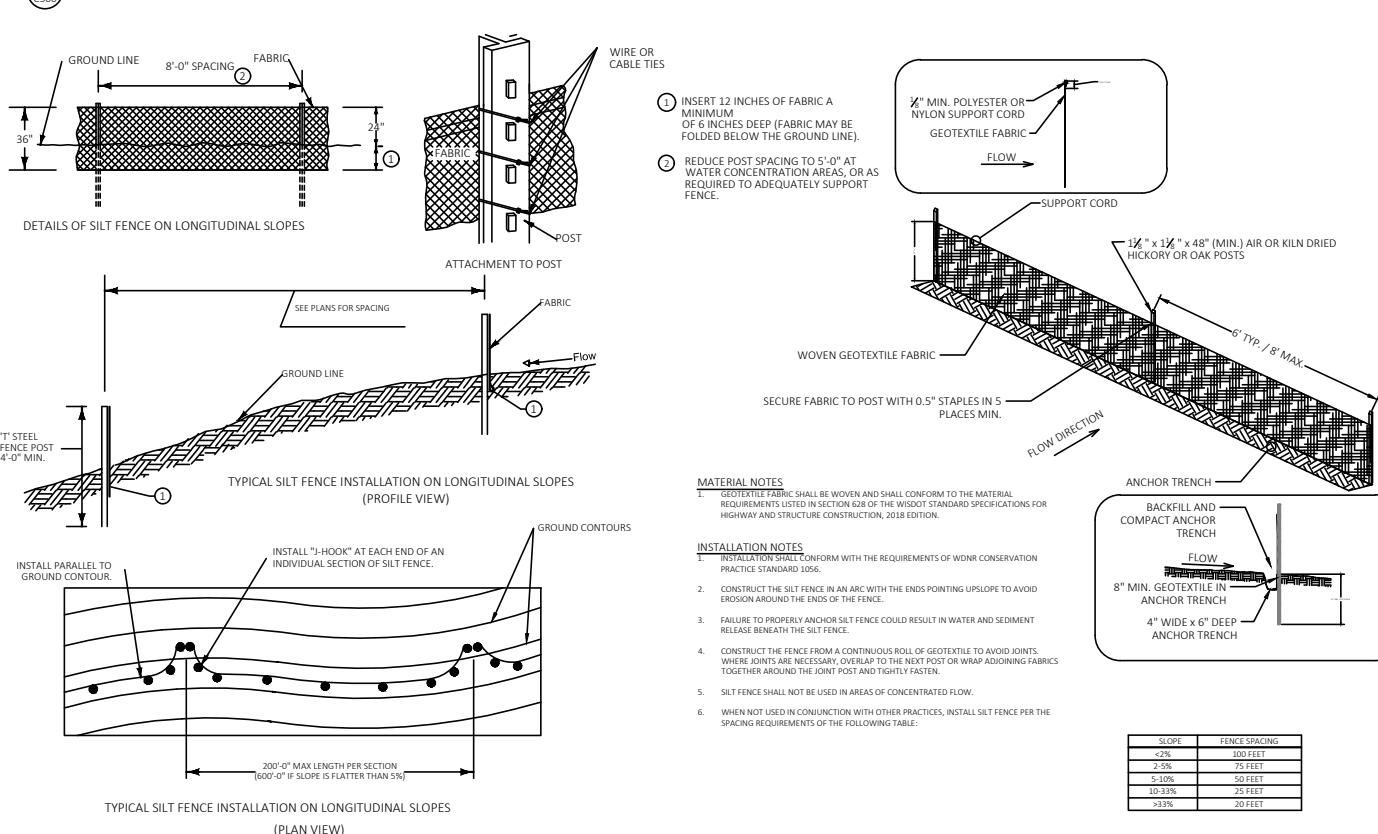

2. SILT FENCE

PROJECT: 5210 SIGGELKOW ROAD REDEVELOPMENT


CLIENT: FRED DeVILLERS

COUNTY: DANE

EROSION CONTROL DETAILS

FOR REVIEW

SHEET C510

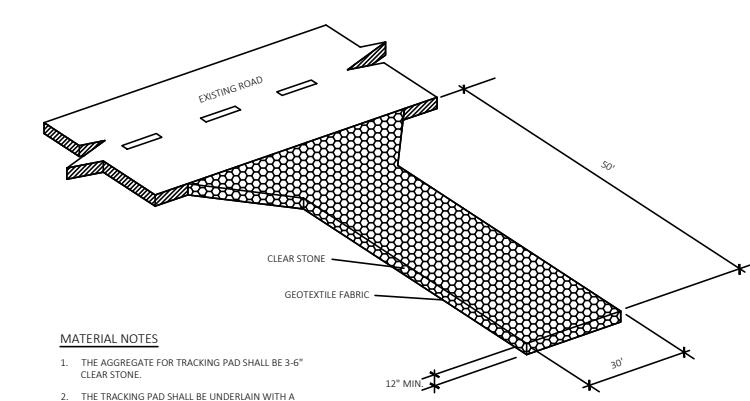


INSTALLATION NOTES

1. INSTALLATION SHALL CONFORM WITH THE REQUIREMENTS OF WDNR CONSERVATION PRACTICE STANDARD 1057.
2. THE TRACKING PAD SHALL BE INSTALLED PRIOR TO ANY TRAFFIC LEAVING THE SITE. STONE TRACKING PAD SHALL BE USED AT ALL POINTS OF CONSTRUCTION GRES.
3. DIMENSIONS OF THE TRACKING PAD SHALL BE MINIMUM AS NOTED ON THE FIGURE ABOVE.
4. SURFACE WATER SHALL BE PREVENTED FROM PASSING THROUGH THE TRACKING PAD. FLOWS SHALL BE DIVERTED AWAY FROM TRACKING PADS OR CONVEYED UNDER AND AROUND THEM USING CULVERTS OR OTHER PRACTICES.
5. TRACKING PAD SHALL BE REMOVED OR INCORPORATED INTO GRAVEL DRIVEWAY ONLY AFTER CONSTRUCTION IS COMPLETE AND THE SITE HAS BEEN STABILIZED.

INSPECTION & MAINTENANCE NOTES

1. STONE TRACKING PADS SHALL BE INSPECTED WEEKLY AND WITHIN 24 HOURS AFTER EVERY PRECIPITATION EVENT THAT PRODUCES 0.5 INCHES OF RAIN OR MORE DURING A 24 HOUR PERIOD.
2. ADDITIONAL AGGREGATE SHALL BE PLACED IF THE TRACKING PAD BECOMES BURIED OR IF SEDIMENT IS NOT BEING REMOVED EFFECTIVELY FROM THE VEHICLE TIRES.
3. A MINIMUM 30-FEET WIDE BY 10-FEET LONG BY 12-INCH THICK PAD SHALL BE MAINTAINED AT ALL TIMES.
4. THE TRACKING PAD PERFORMANCE SHALL BE MAINTAINED BY SCRAPING OR TOP-DRESSING WITH ADDITIONAL AGGREGATE.
5. ANY SEDIMENT TRACKED ONTO A PUBLIC OR PRIVATE ROAD SHOULD BE REMOVED BY STREET CLEANING AT THE END OF EACH WORKING DAY.
6. MAINTENANCE SHALL BE COMPLETED AS SOON AS POSSIBLE WITH CONSIDERATION FOR SITE CONDITIONS.

3. CONSTRUCTION ENTRANCE (TRACKING PAD)

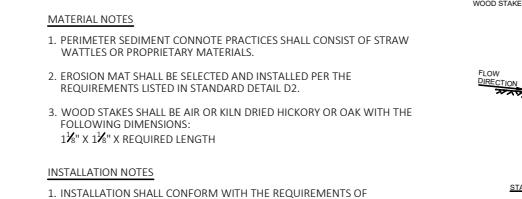

MATERIAL NOTES

1. PERIMETER SEDIMENT CONNITE PRACTICES SHALL CONSIST OF STRAW WATTERS OR PROPRIETARY MATERIALS.
2. EROSION MAT SHALL BE SELECTED AND INSTALLED PER THE REQUIREMENTS LISTED IN STANDARD DETAIL D2.
3. WOOD STAKES SHALL BE AIR OR KILN DRIED HICKORY OR OAK WITH THE FOLLOWING DIMENSIONS: 1 1/2" X 1 1/2" X REQUIRED LENGTH


INSTALLATION NOTES

1. INSTALLATION SHALL CONFORM WITH THE REQUIREMENTS OF APPLICABLE WDNR CONSERVATION PRACTICE STANDARDS.
2. PROPRIETARY MATERIALS SHALL BE INSTALLED PER MANUFACTURER'S RECOMMENDATIONS.
3. WHEN JOINTS ARE NECESSARY, OVERLAP AND SECURE TO MINIMIZE POTENTIAL FOR CONCENTRATED FLOW.
4. INSTALL ALL PERIMETER SEDIMENT CONTROL PRACTICES SUCH THAT THE ENDS TIE INTO THE SLOPE TO PREVENT EROSION FROM CONCENTRATED FLOW AROUND THE ENDS.
5. PERIMETER SEDIMENT CONTROL PRACTICES SHOULD BE USED IN CONJUNCTION WITH PERMANENT RESTORATION PRACTICES.
6. WHEN NOT USED IN CONJUNCTION WITH OTHER PRACTICES, INSTALL PERIMETER SEDIMENT CONTROL PRACTICES PER THE SPACING REQUIREMENTS (DISTURBED SLOPE LENGTH) NOTED IN THE FOLLOWING TABLE:


SLOPE	SPACING
<2%	100 FEET
2-5%	75 FEET
5 to 10%	50 FEET

STAKE DETAIL - PLACED OVER EXISTING VEGETATION

STAKE DETAIL - TRENCHED IN

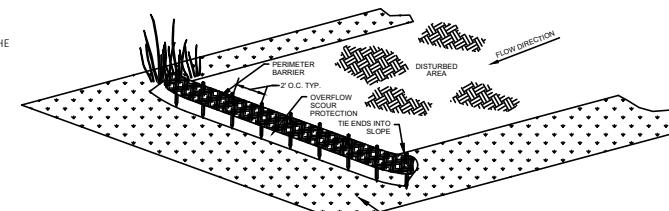

4. SILT SOCK

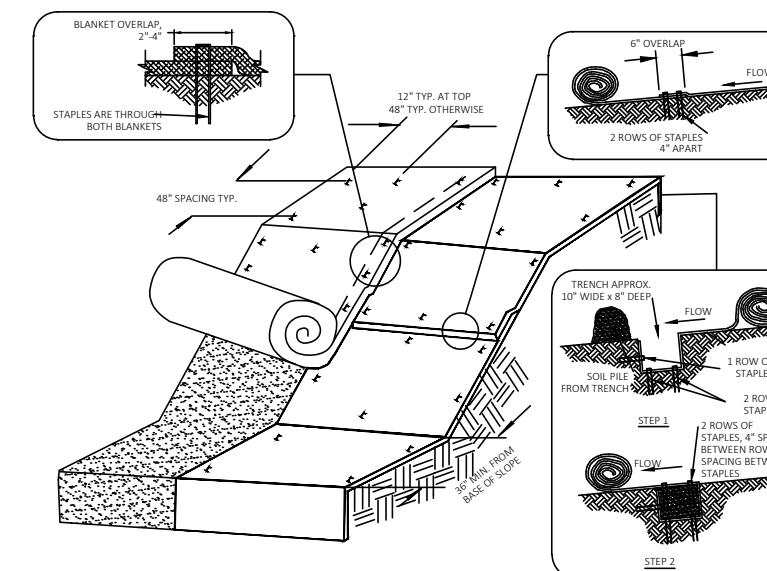

MATERIAL NOTES

1. STAPLES USED FOR CLASS I TYPES B MATS SHALL BE 1-2 INCH WIDE U-SHAPED, MADE OF NO. 11 (3.05mm) OR LARGER DIAMETER STEEL WIRE, AND NOT LESS THAN 6 INCHES LONG FOR FIRM SOILS AND 12 INCHES LONG FOR LOOSE SOILS.
2. ANCHORING DEVICES FOR URBAN MATS SHALL BE SELECTED BASED UPON THE REQUIREMENTS OF THE WISDOP PAL.

INSTALLATION NOTES

1. INSTALLATION SHALL CONFORM WITH WDNR CONSERVATION PRACTICE STANDARD 1052.
2. EROSION MAT SHALL BE IN FIRM AND CONTINUOUS CONTACT WITH THE SOIL AND EXTEND UPSLOPE ONE-FOOT FROM LAND DISTURBANCE.
3. EROSION MAT SHALL BE ANCHORED, OVERLAPPED, STAKED AND ENTRENCHED PER THE MANUFACTURER'S RECOMMENDATIONS. THIS STANDARD DETAIL IS AN EXAMPLE OF TYPICAL INSTALLATION GUIDANCE.
4. WHERE POSSIBLE, USE A SINGLE ROLL OF EROSION CONTROL MAT TO SPAN THE DISTURBED AREA.


INSPECTION & MAINTENANCE NOTES

1. AT A MINIMUM, PERFORM INSPECTIONS WEEKLY AND WITHIN 24 HOURS OF PRECIPITATION EVENTS PRODUCING 0.5 INCHES OR MORE OF RAINFALL.
2. INSTALL ADDITIONAL ANCHORING IN AREAS OF OBSERVED RILLING AND CONCENTRATED FLOW BEHIND THE EROSION MAT. IF RILLING IS SEVERE ENOUGH TO PREVENT VEGETATION ESTABLISHMENT, REMOVE EROSION MAT, REGRADE, COMPACT, RE-SEED, AND REPLACE THE SECTION OF MAT.
3. IF PRODUCTS WITH PLASTIC NETTING ARE USED, REMOVE NETTING OR REPLACE MAT IF SEPARATION OF THE NETTING FROM THE MAT IS OBSERVED.
4. ALL MAINTENANCE ACTIVITIES SHOULD OCCUR AS SOON AS POSSIBLE WITH CONSIDERATION OF SITE CONDITIONS.

5. EROSION CONTROL MAT (SLOPES)


NOTES:

1. WISCONSIN DOT STANDARD SPECIFICATIONS FOR HIGHWAY AND STRUCTURE CONSTRUCTION, LATEST EDITION, INCLUDING SUPPLEMENT SPECIFICATIONS, BUT EXCLUDING LIMITATIONS IN SECTION 460.3.2 RESTRICTING LAYER THICKNESS BY AGGREGATE SIZE.
2. COMPACTION REQUIREMENTS:
-BITUMINOUS CONCRETE: REFER TO SECTION 460-3
-BASE COURSE: REFER TO SECTION 301.3.4.2, STANDARD COMPACTION
3. MIXTURE TYPE E-0.3 BITUMINOUS PAVEMENT IS RECOMMENDED; REFER TO SECTION 460 TABLE 460-2 OF THE STANDARD SPECIFICATIONS

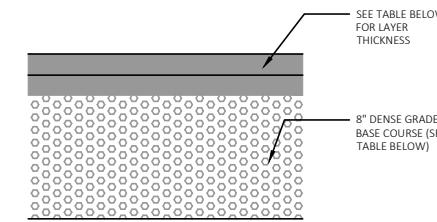


RECOMMENDED MEDIUM-DUTY PAVEMENT SECTION		
MATERIAL	LAYER THICKNESS, IN.	WDOT SPECIFICATION
BITUMINOUS UPPER LAYER (SURFACE COURSE)	2	SECTION 460, TABLE 460-1, 9.5 mm
BITUMINOUS LOWER LAYER (BINDER COURSE)	2	SECTION 460, TABLE 460-1, 12.5 mm
DENSE GRADED BASE COURSE	8	SECTIONS 301 AND 305, 75 AND 31.5 mm
GEOTEXTILE	NO	N/A
TOTAL THICKNESS	12	

12 MEDIUM PAVEMENT SECTION - PARKING LOT
C501

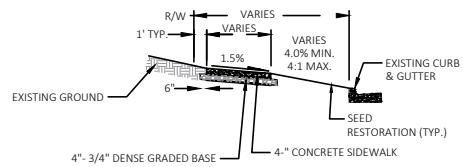


14 SIDEWALK TYPICAL SECTION
C501

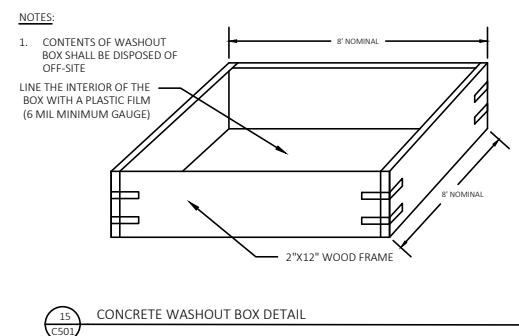

15 CONCRETE WASHOUT BOX DETAIL
C501

REVISION DATE:

119 SOUTH MAIN STREET
COTTAGE GROVE, WI 53527 (608) 839-4422

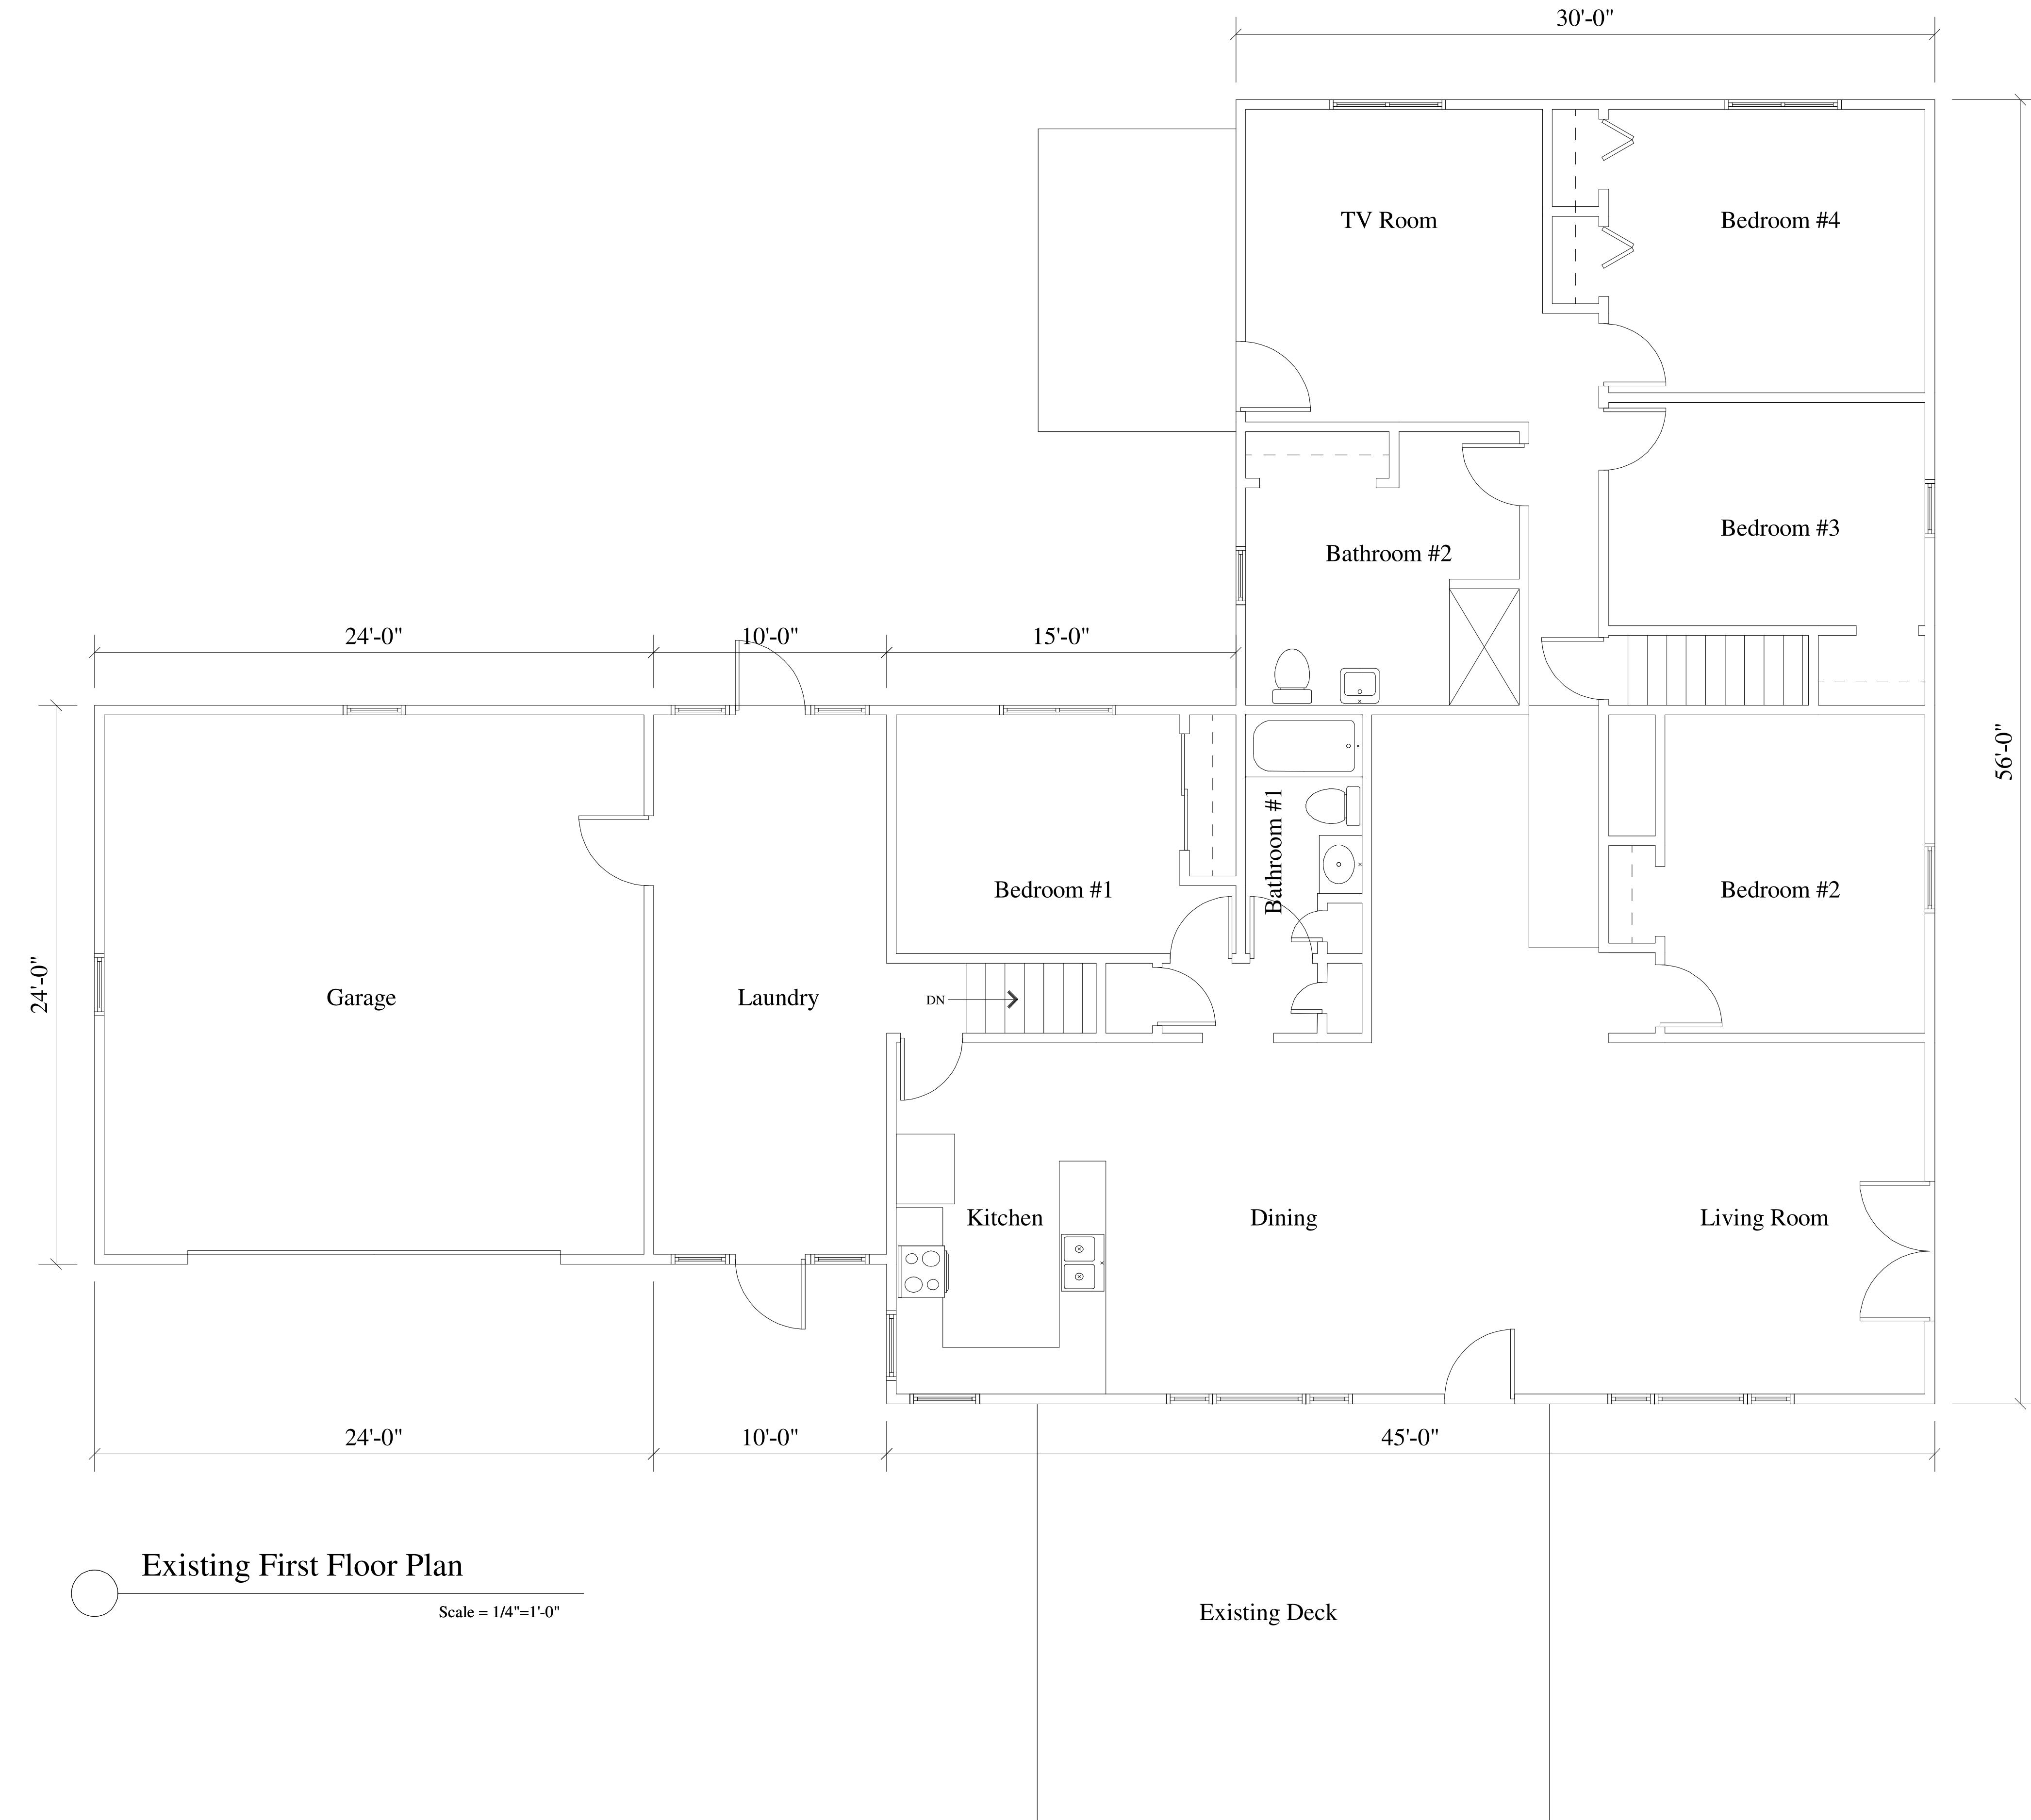

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W125 Amidon Road
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cgialc@jotmail.com
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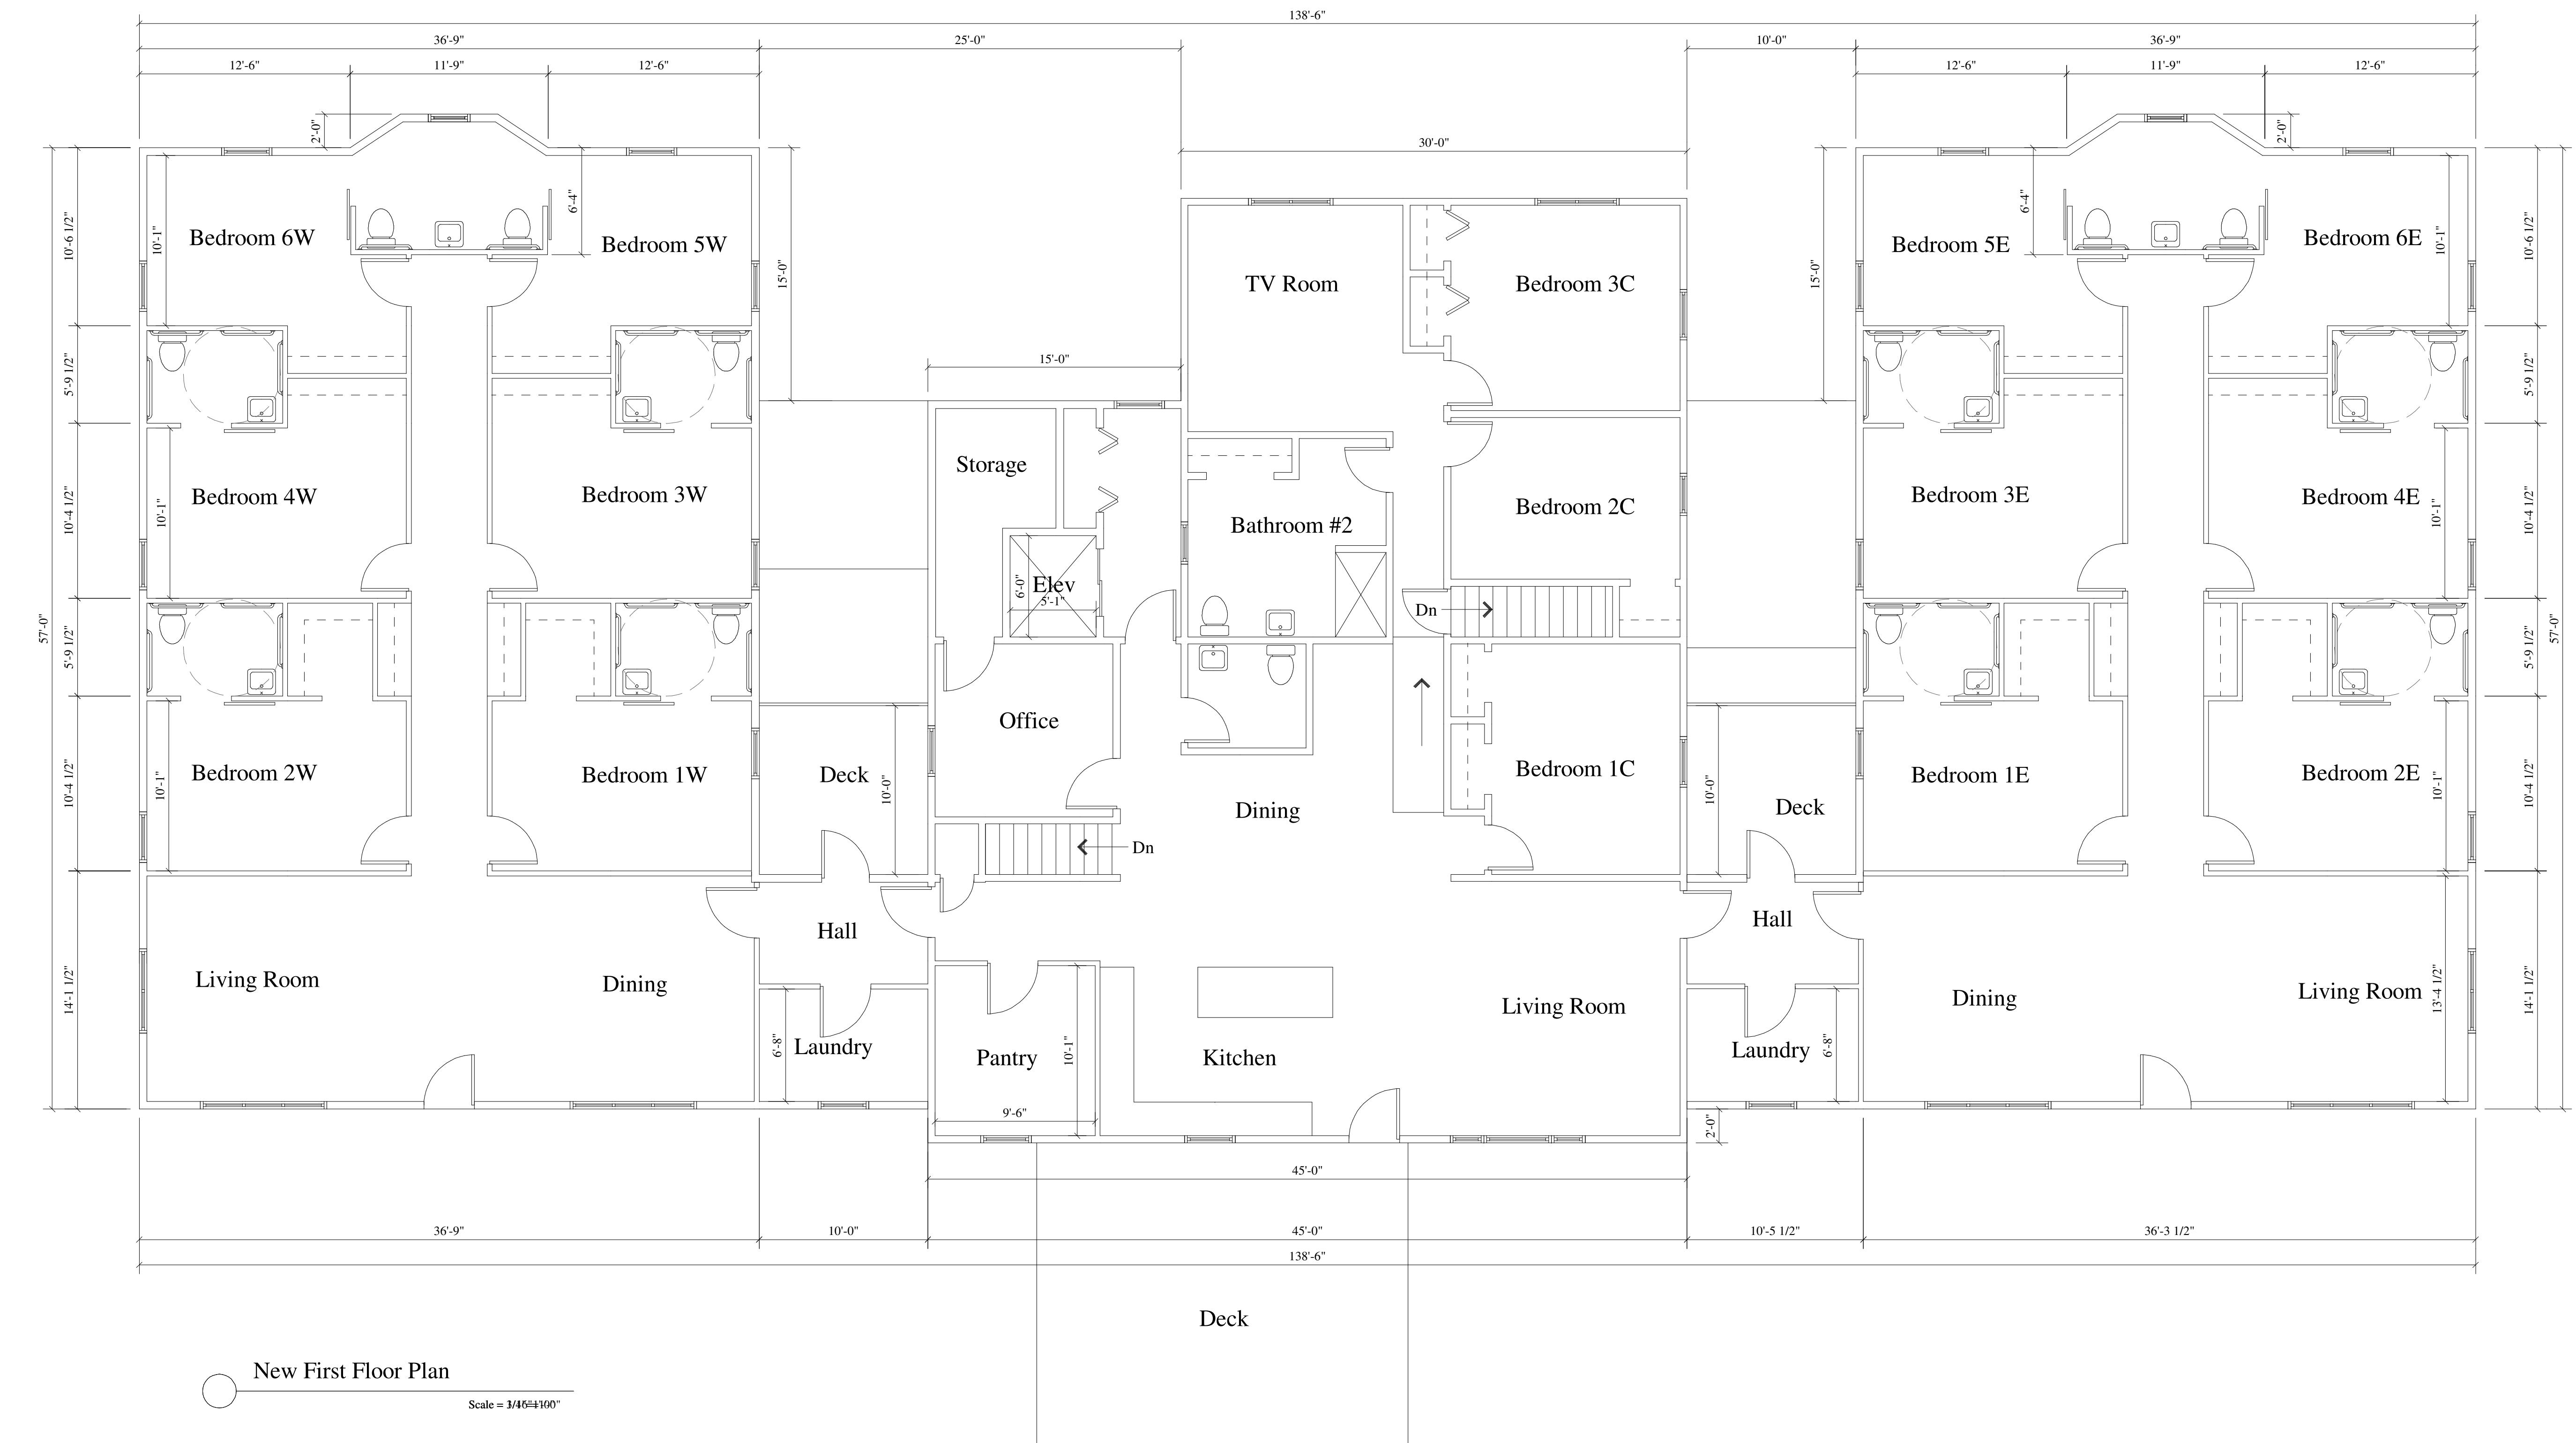
Concepts
In
Architecture, LLC

Proposed for: Fredric A DeVillers
Address: 5210 Siggelkow Road
Madison, WI 53718
608-220-6129

Project: 5210 Siggelkow Road
Address: City of Madison, WI
Sheet Title: First Floor Plan

Date: 07-16-2019
Scale: As Noted
Job #: 05-01

SHEET
A1



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jeff@homemail.com
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Concepts
In
Architecture, LLC

Proposed for: Fredric A DeVillers


Address: 5210 Siggelkow Road
Madison, WI 53718
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Project: 5210 Siggelkow Road
Address: City of Madison, WI

Date: 09-09-2019
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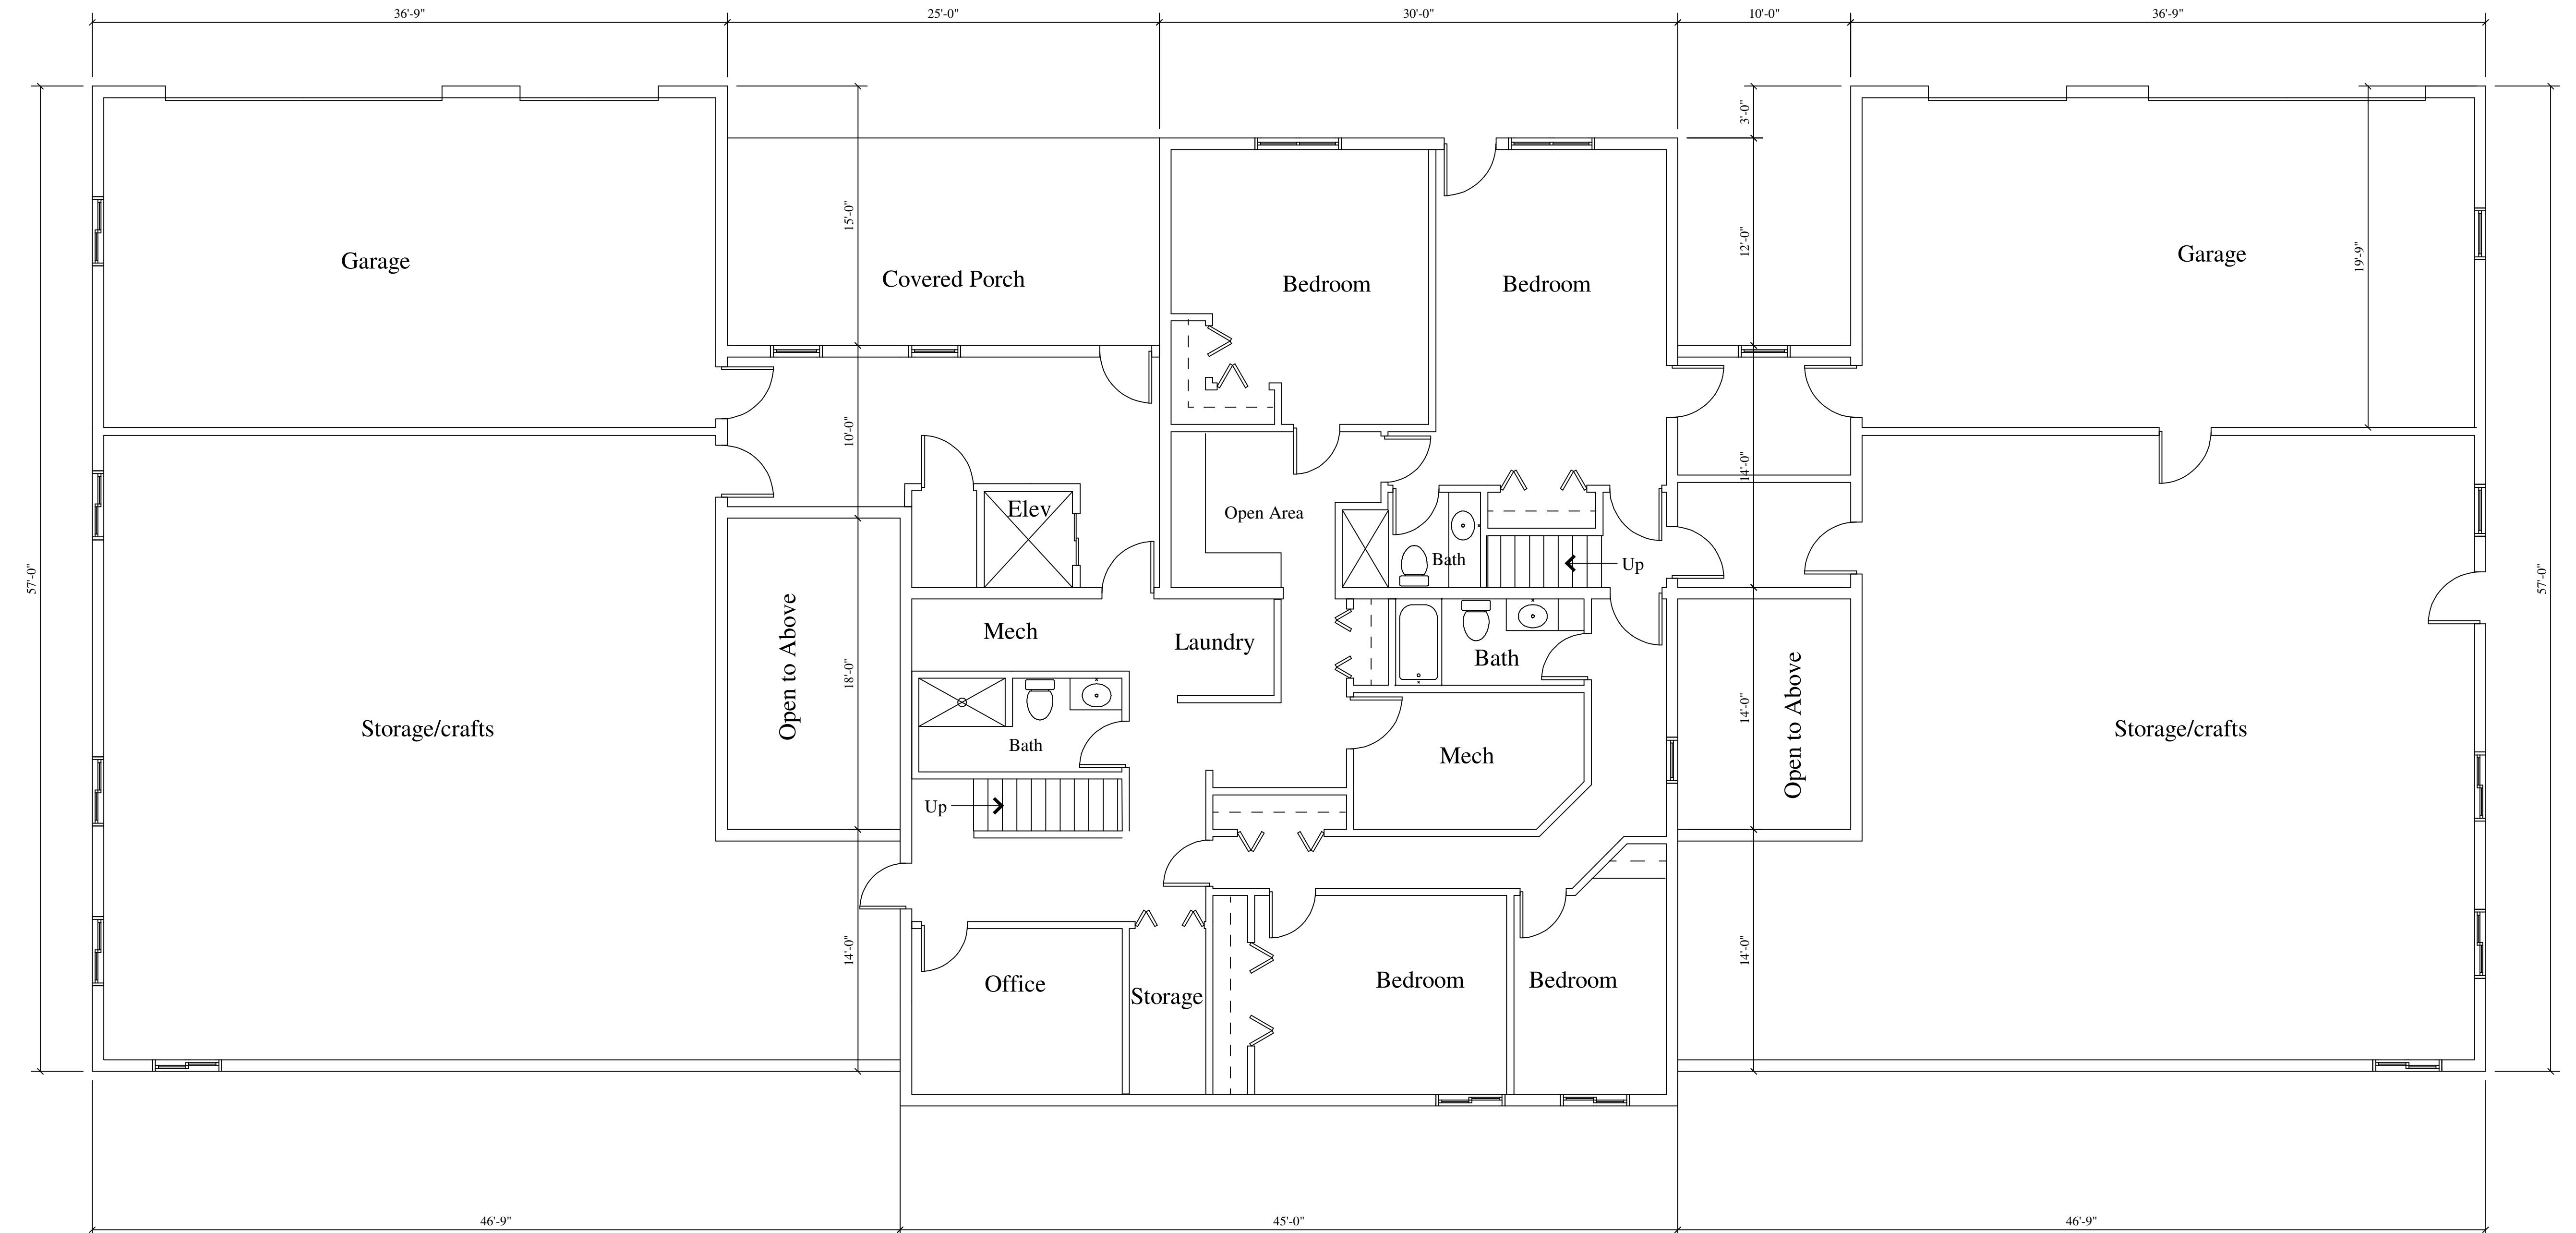
Sheet Title: New First Floor Plan

SHEET
A2



C oncepts I n A rchitecture, LLC		Jeffrey Groenier, Architect W125 Amidon Road Brooklyn, WI 53521 608-698-3196 cialec@jotmail.com
<p>Proposed for: Fredric A DeVillers</p> <p>Address: 5210 Siggelkow Road Madison, WI 53718 608-220-6129</p> <p>Sheet Title: Existing Lower Level Plan</p> <p>Date: 07-16-2019</p> <p>Scale: As Noted</p> <p>Job #: 05-01</p>		
<p>SHEET</p> <p>A3</p>		
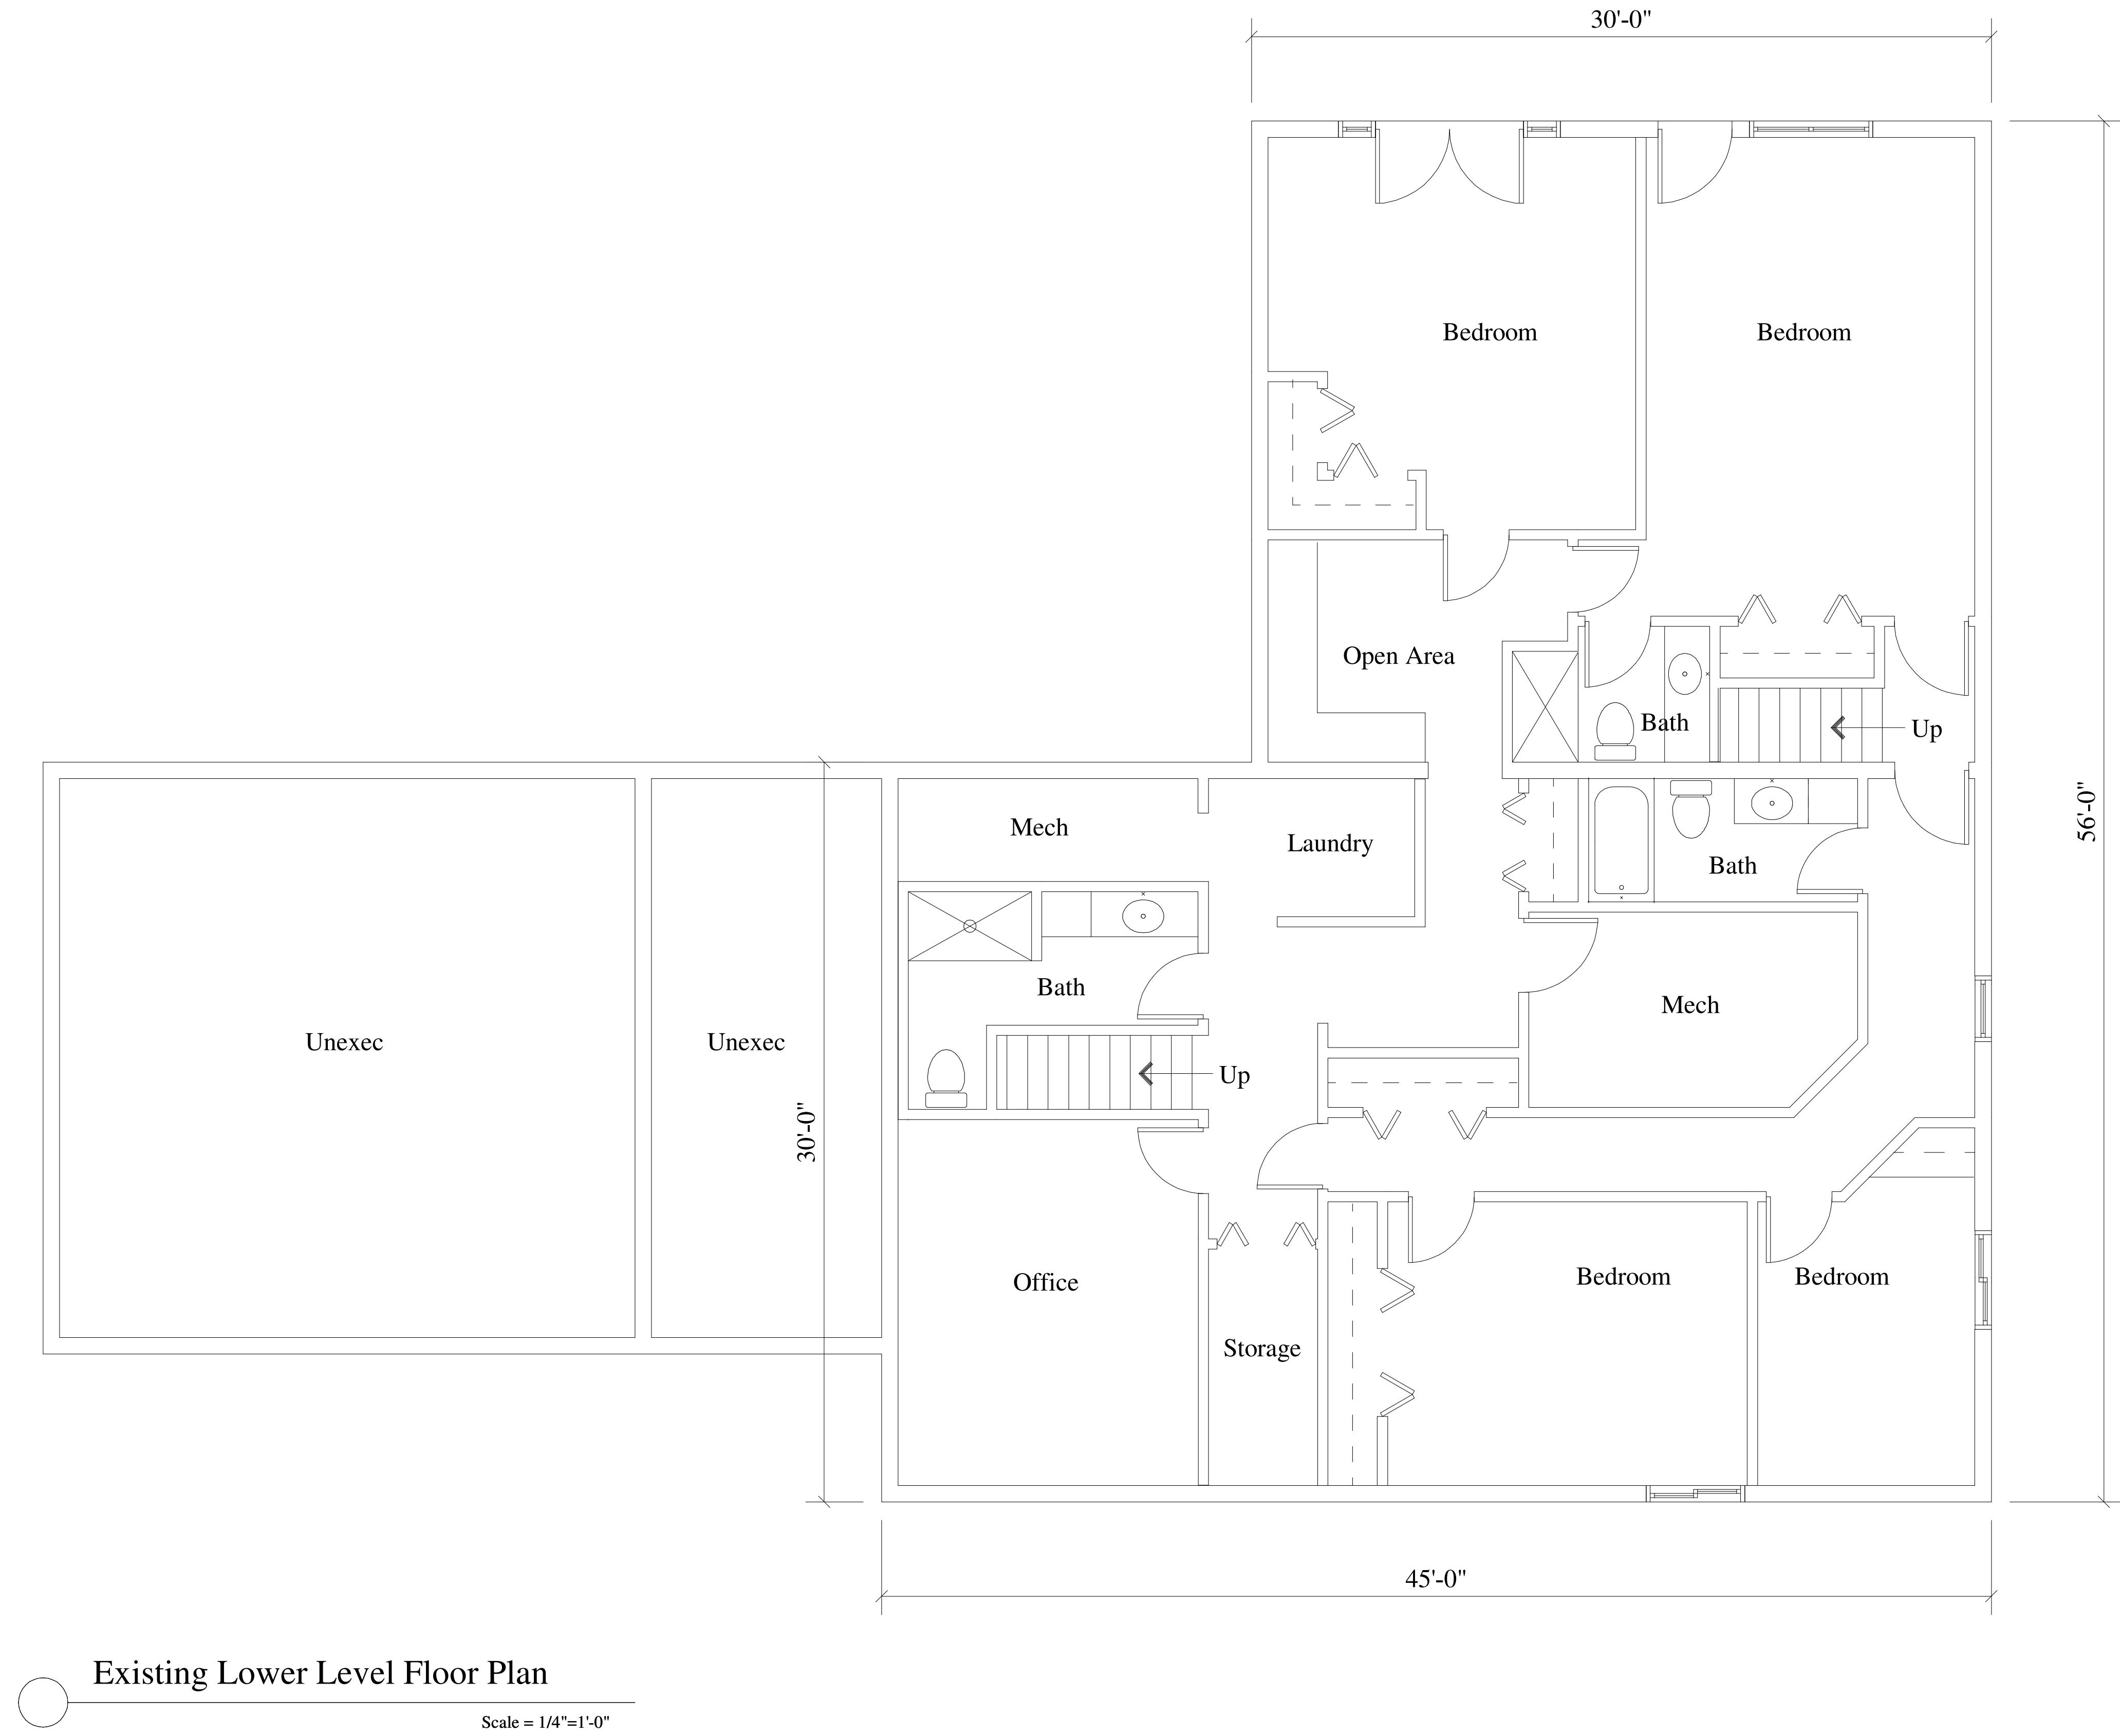
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New Lower Level Floor Plan

Scale = 1/4"=1'


Sheet Title: **New Lower Level Plan**
Project: **5210 Siggelkow Road**
Address: **City of Madison, WI**

Date: 09-09-2019

cale: As Noted


ob #: 05-01

SHEET
A4

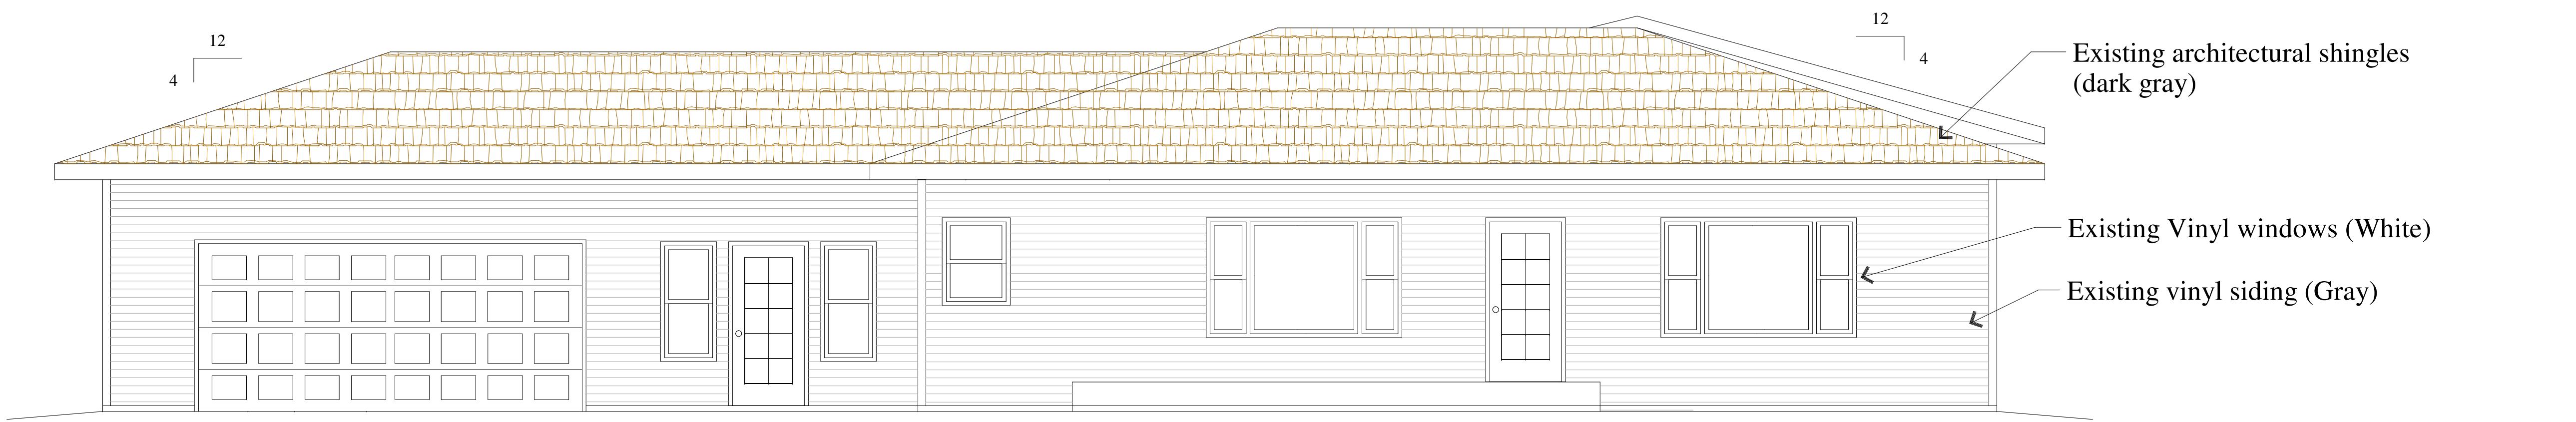

Existing Front Elevation

Scale = 3/16"=1'-0"

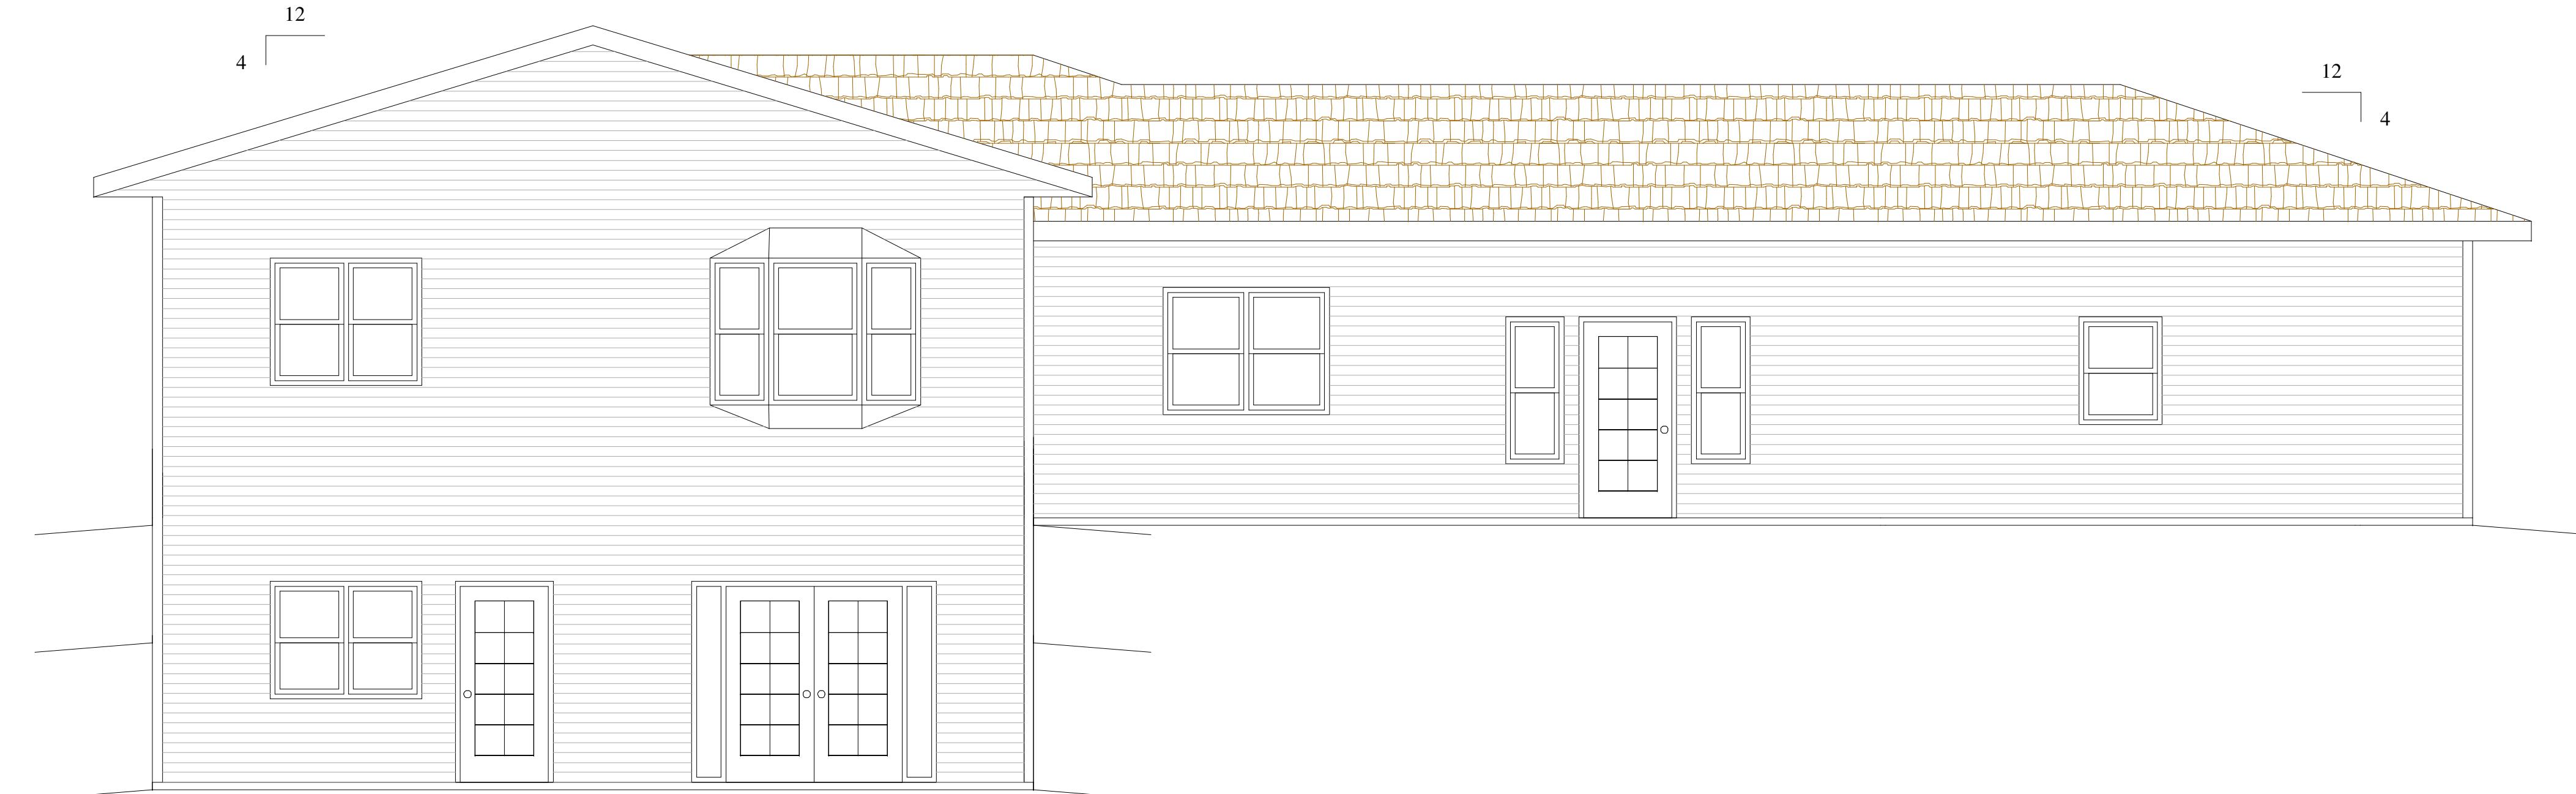

Existing Rear Elevation

Scale = 3/16"=1'-0"

Concepts
In
Architecture, LLC


Proposed for: Fredric A DeVillers
Address: 5210 Siggelkow Road
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608-220-6129

Project: 5210 Siggelkow Road
Address: City of Madison, WI
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Date: 07-16-2019
Scale: As Noted
Job #: 05-01


SHEET
A5

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cgialc@jotmail.com
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New South Elevation

Scale = 3/16"=1'-0"

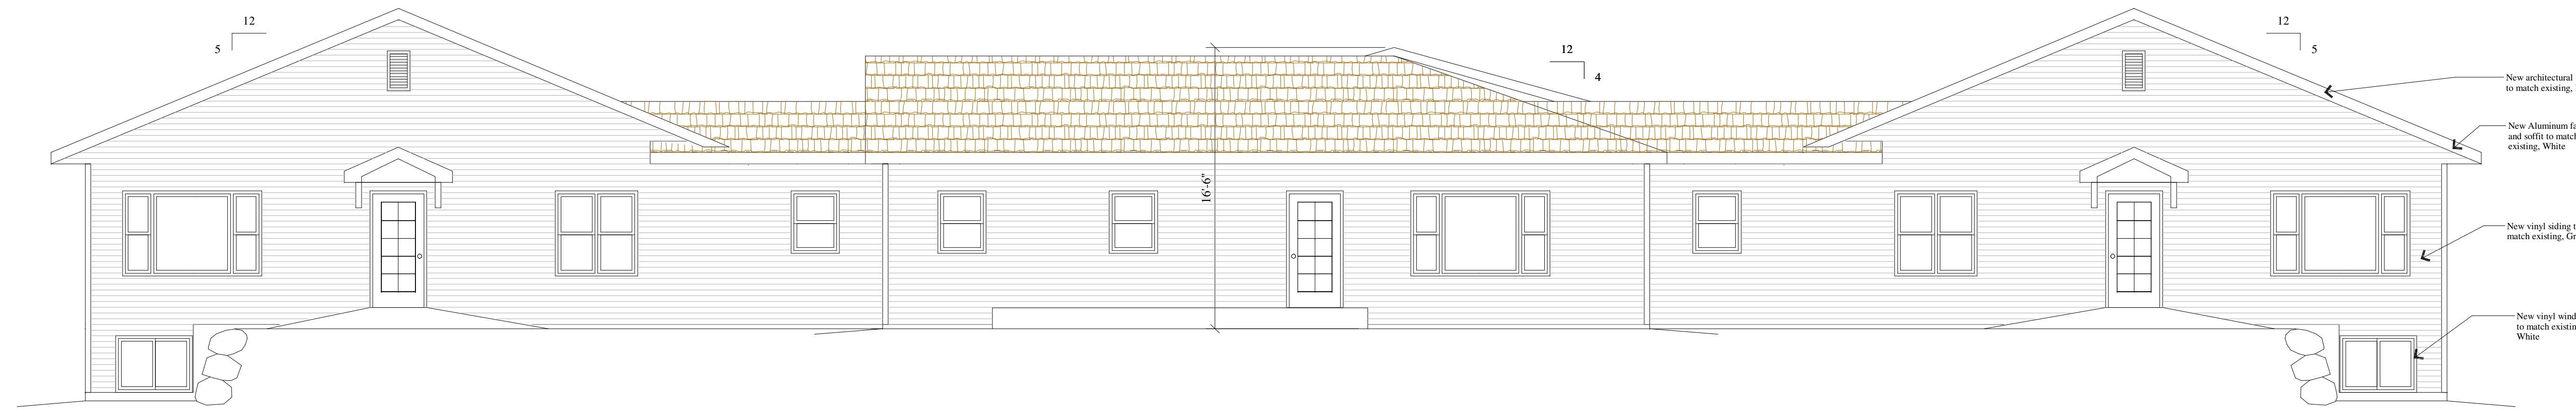


New West Elevation

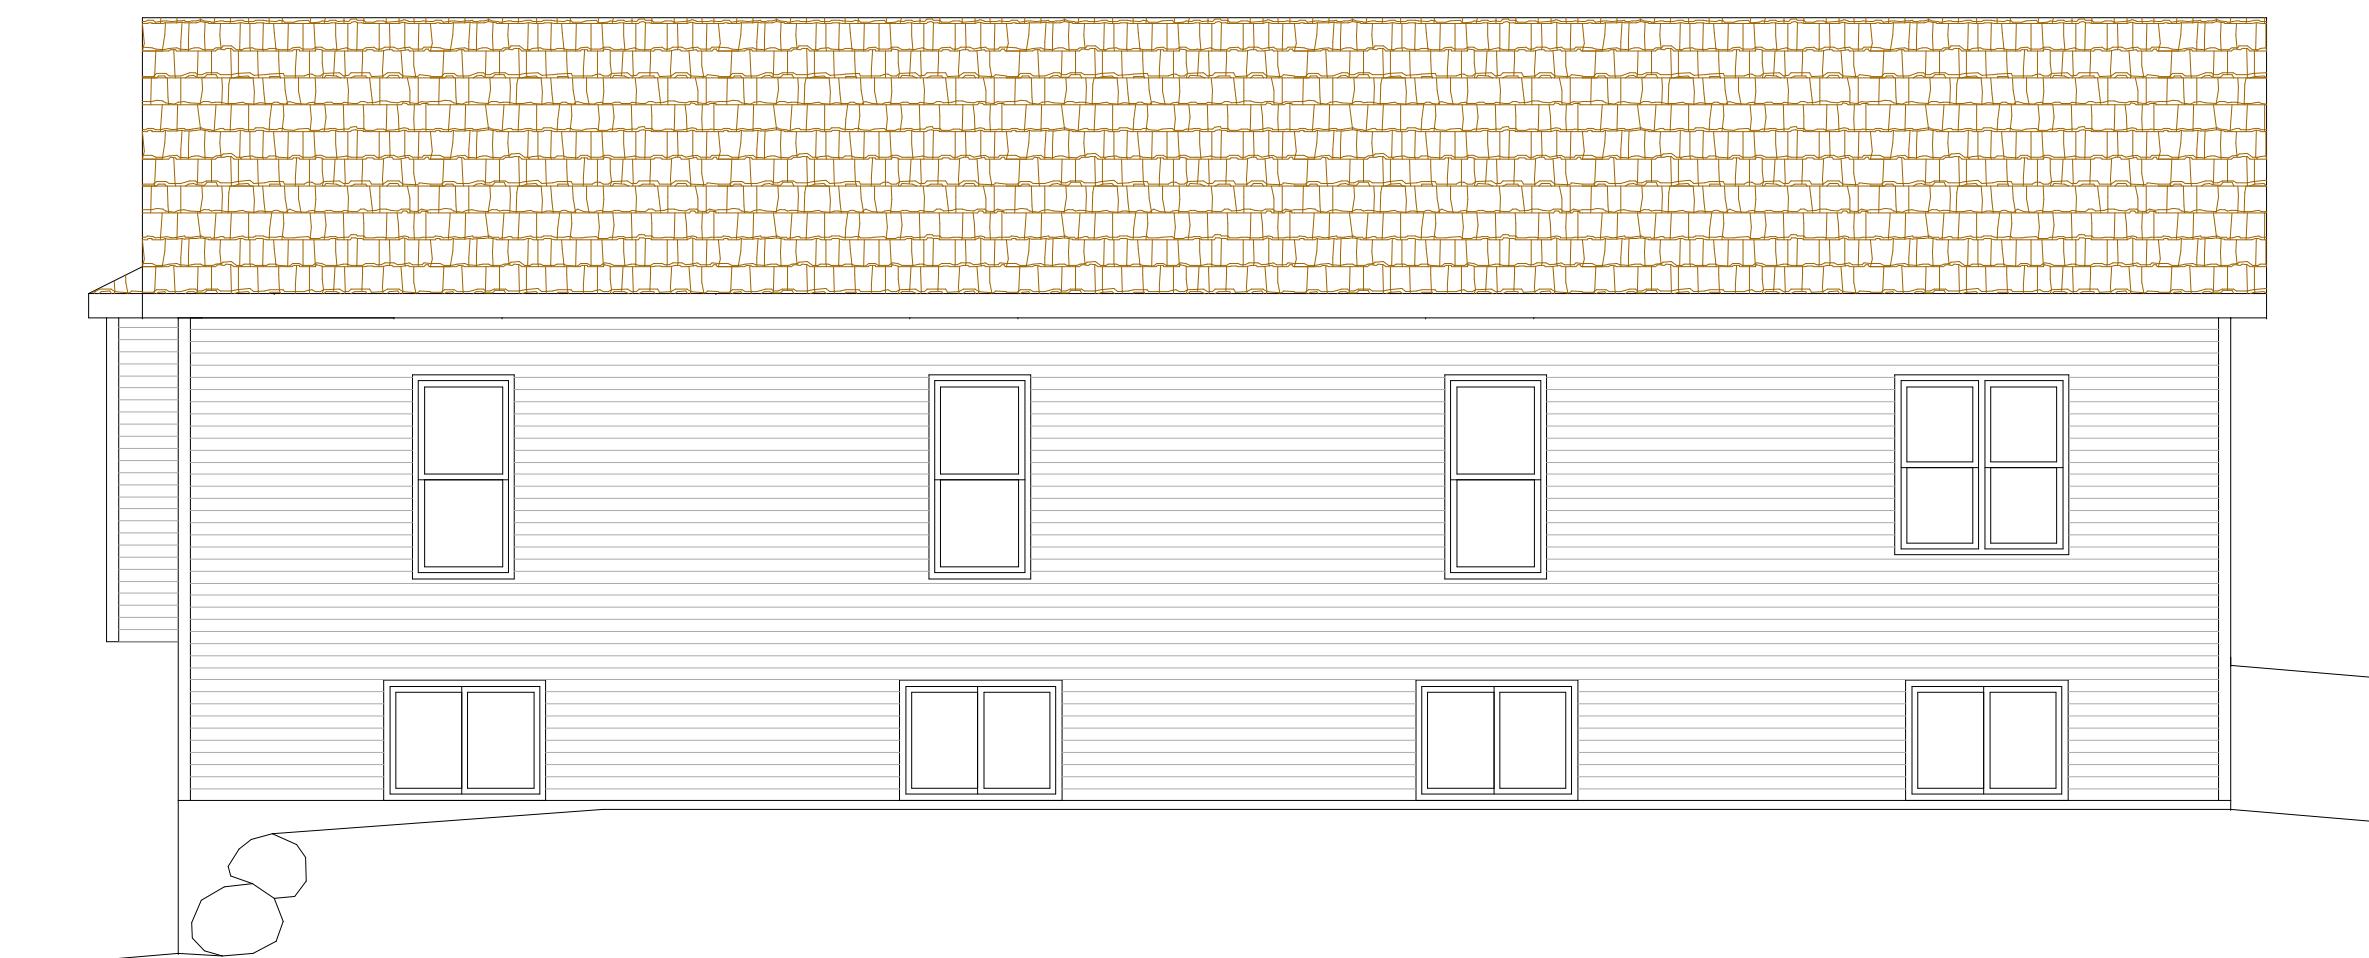Scale = 3/16"=1'-0"



New East Elevation

Scale = 3/16"=1'-0"

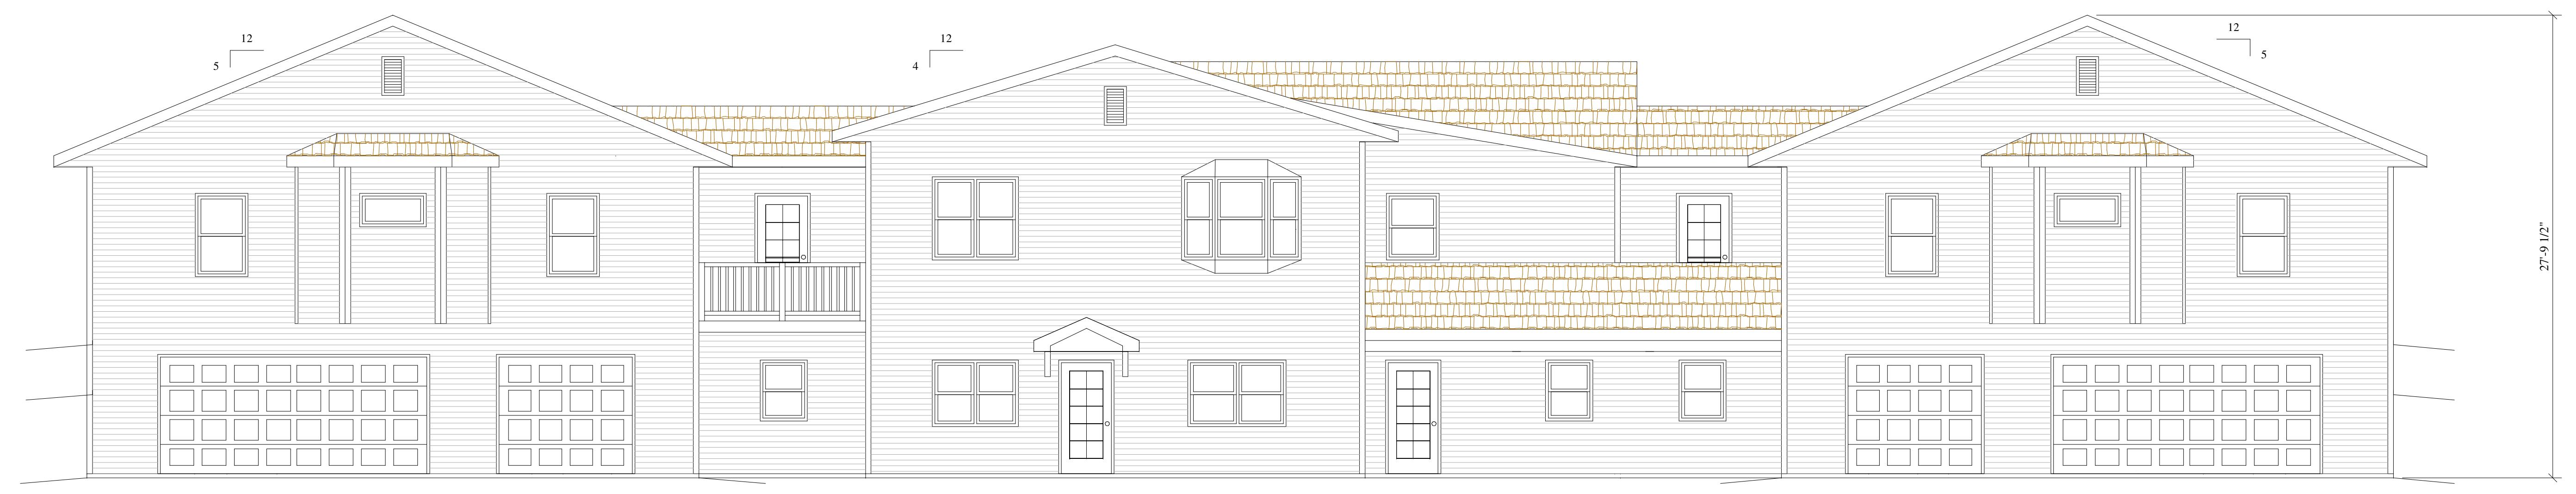

New North Elevation

**Concepts
In
Architecture, LLC**

Proposed for: **Frederic A DeVillers**


Address: 5210 Siggelkow Road
Madison, WI 53718
608-220-6129

Project: **5210 Siggelkow Road**
Address: City of Madison, WI

Date: 09-09-2019
Scale: As Noted
Job #: 05-01

SHEET
A6

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New Roof Plan

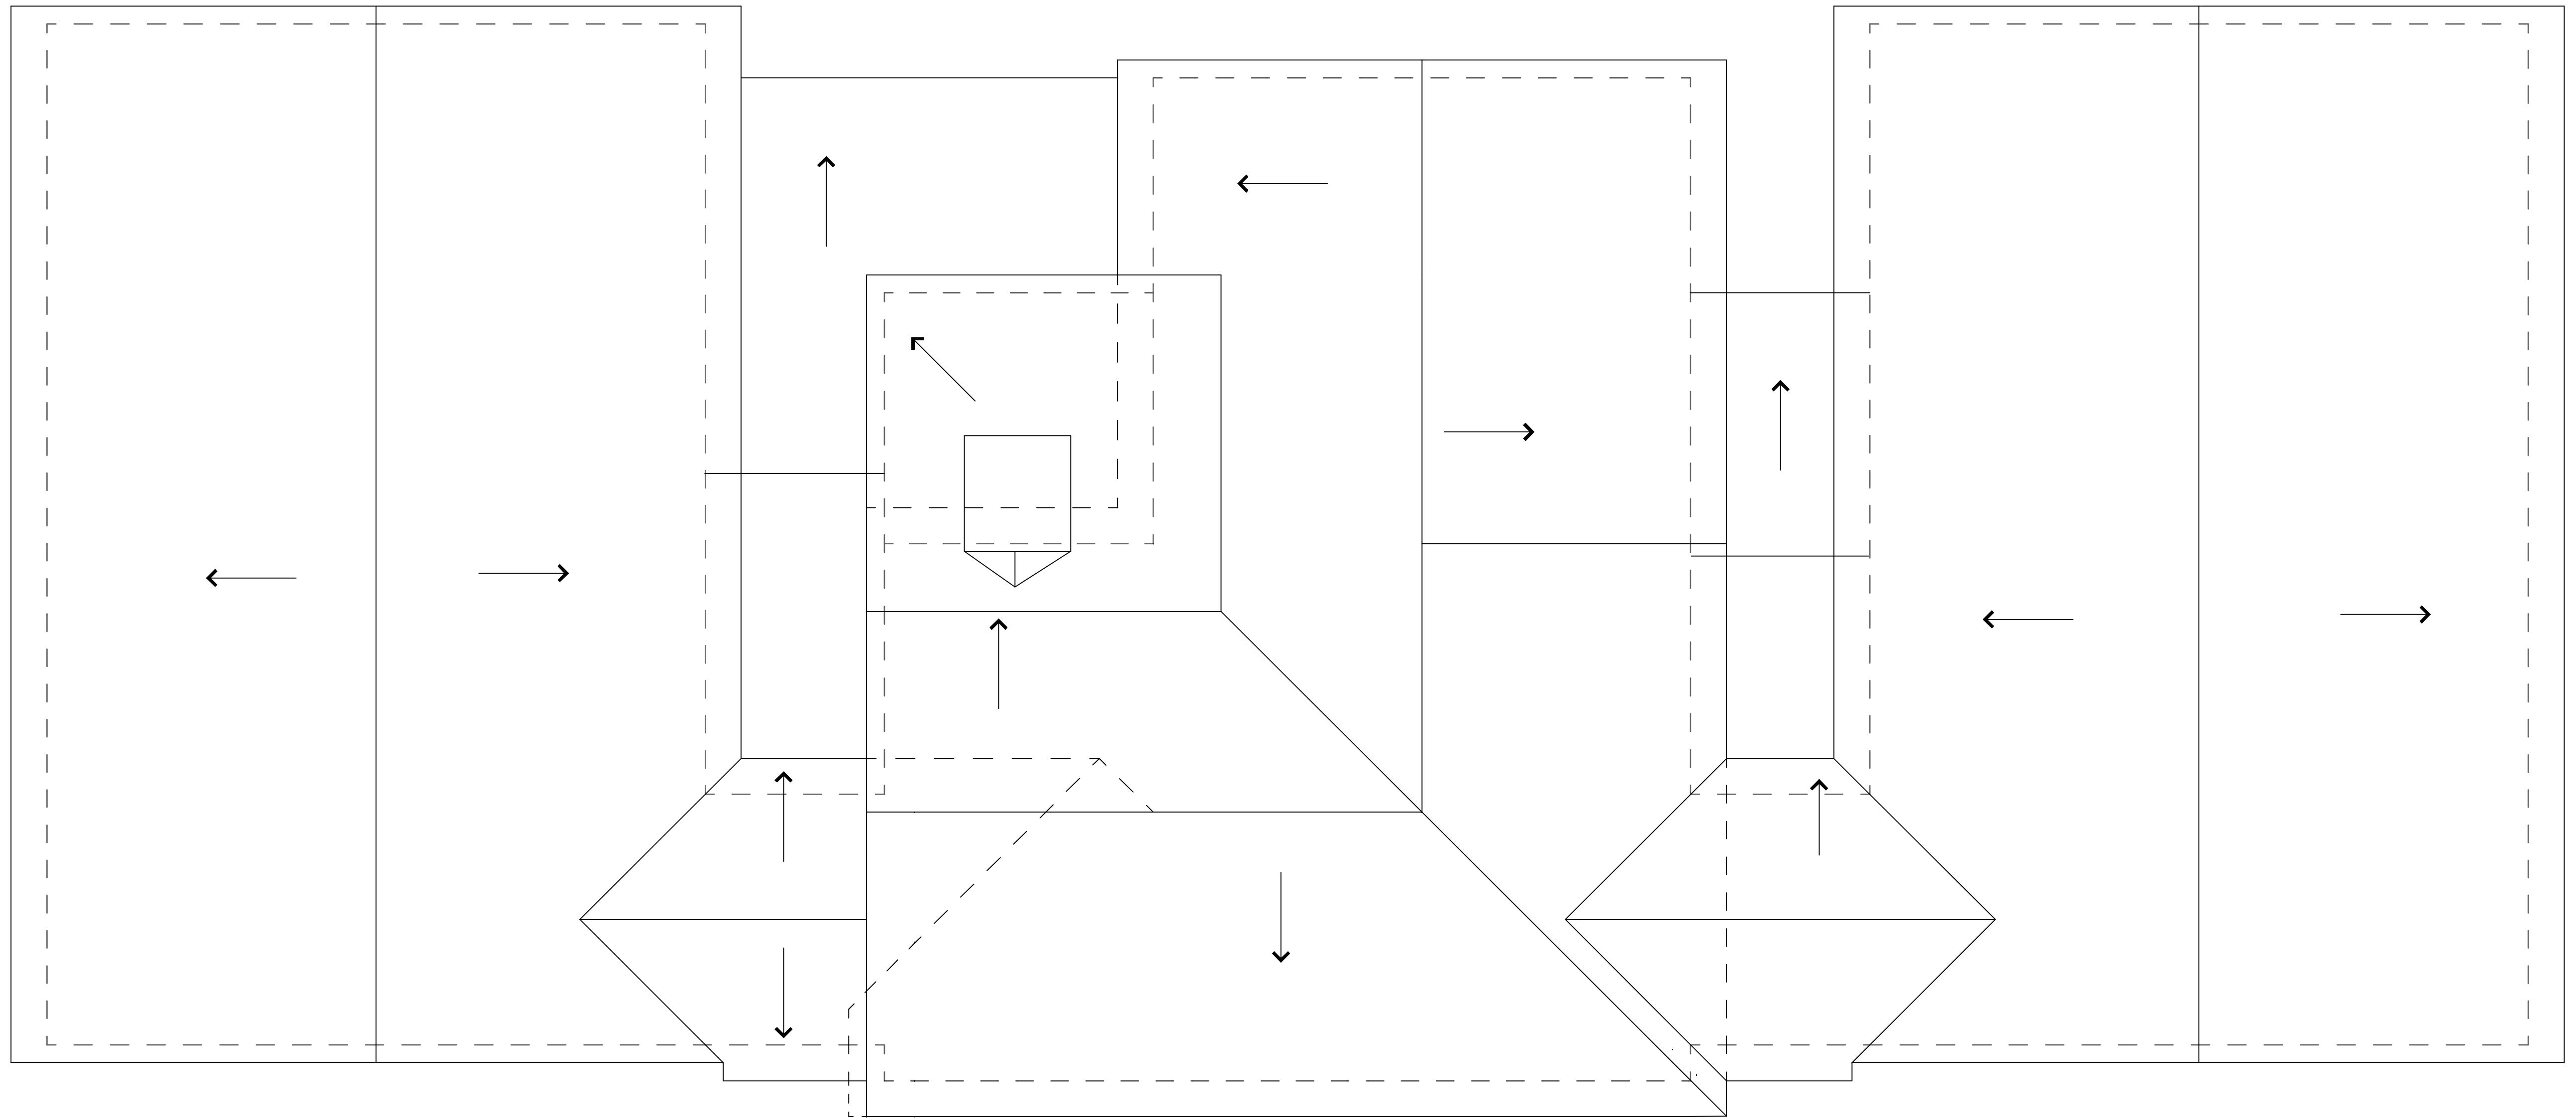Scale = 3/16"=1'-0"

Proposed for: Fredric A DeVillers
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Project: 5210 Siggelkow Road
 Address: City of Madison, WI
 Sheet Title: New Roof Plan

Date: 09-09-2019
 Scale: As Noted
 Job #: 05-01

SHEET
 A7