# APPLICATION FOR URBAN DESIGN COMMISSION

AGENDA ITEM	#	
Project #		
00968		

REVIEW AN	ND APPROVAL	02368
DATE SUBMIT UDC MEETING	TED: May 31, 2006  DATE: June 7, 2006	Action Requested Informational Presentation Initial Approval and/or Recommendation Final Approval and/or Recommendation
PROJECT ADDI	RESS: 1513 Lake Point Drive	
ALDERMANIC	DISTRICT: Tim Bruer #14	
OWNER/DEVEI	LOPER (Partners and/or Principals)	ARCHITECT/DESIGNER/OR AGENT:
Scott Norton/	Norton Building Co.	Knothe & Bruce Architects, LLC
5121 Hilltop R	oad	7601 University Avenue, Suite 201
Madison, WI 5	3711	Middleton, Wisconsin 53562
CONTACT PERSO	DN: J. Randy Bruce/Knothe & Bruce Arch	nitects, LLC
Address:	7601 University Avenue, Suite 201 Middleton, Wisconsin 53562	0293037
Phone:	608-836-3690	632120
Fax: E-mail addı TYPE OF PROJEC	ress: rbruce@knothebruce.com T:	RECEIVED STATES AND ST
General Specific Planned Commodification General Specification x Planned Residem New Construction required as well School, Public	Development (PUD) I Development Plan (GDP) I Implementation Plan (SIP) I Implementation Plan (PCD) I Development Plan (GDP) I Implementation Plan (SIP) I Implementation Plan (SIP) I Implementation Plan (PRD) I Implementation Plan (PRD) I Implementation Plan (PRD) I Implementation Plan (SIP) I Implementation Plan (PCD) I Implementation P	esign District* (A public hearing is
(See Section B for:)  New Construct	tion or Exterior Remodeling in C4 District	(Fee required)
(See Section C for:) R.P.S.M. Parki	ing Variance (Fee required)	x 960 E
	e Design Review* (Fee required) s Variance* (Fee Required)	
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ESIGNER/OR AGENT:	
Architects, LLC	
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# KBA Project #0529



# Site Locator Map 1513 Lake Point Drive Madison, WI



March 8, 2006

Revised: May 31, 2006

Mr. Brad Murphy City of Madison Planning & Development 215 Martin Luther King Jr. Blvd PO Box 2985 Madison, WI 53701-24985

Letter of Intent

A Planned Commercial & Residential Development

1513 Lake Point Drive Conditional Use Application

Dear Mr. Murphy:

The following is submitted together with plans and application for staff, plan commission and council consideration of approval of the proposed development.

Project:

Developer:

Architect:

1513 Lake Point

Civil

Roxanne Johnson

A mixed-use development

Engineer:

Calkins Engineering, LLC

1513 Lake Point Drive

P.O. Box 379 McFarland, WI 53558

Scott Norton Norton Building Company

608-838-0444 608-833-0746

5121 Hilltop Road Madison, WI 53711 rjohnson@calkinsengineering.com

608-274-9020

Landscape

Richard Strohmenger

nortonbuilding@charter.net

Architect: The Bruce Company 2830 W. Beltline Hwy

Knothe & Bruce Architects, LLC 7601 University Avenue, Ste 201

Middleton, WI 53562 608-836-7041

Middleton, WI 53562

608-836-3690 608-836-6934 cad@bruceco.com

rbruce@knothebruce.com

7601 University Ave, Ste 201 Middleton, Wisconsin 53562 p (608)836-3690 f (608) 836-6934 www.knothebruce.com

X:\0529-Simon Broadway\Project Information\Site & Zoning\letter of intent template.doc

	25
Letter of Intent - Conditional Use	
1513 Lake Point Drive March 8, 2006	
Revised: May 31, 2006	
Overview:	
This site was previously developed with multifamily housing that was razed as part of the	
Broadway-Simpson redevelopment. The neighborhood plan calls for the site to be medium-high	
density multi-family housing. This proposal is for a mixed-use development with 50 housing	
units and 20,000 square feet of commercial use. The site is currently zoned C-2 and allows for the proposed uses in a combined Planned Residential District (PRD) and Planned Commercial	
District (PCD) conditional-use.	
The project will be a phased development. Specific plans are presented for Buildings 1, 2 and 3	
at this time. Plans for Building 4 will be submitted at a later date. A Certified Survey Map will	
be submitted concurrently with this application, which will properly subdivide this property. The CSM allows for separate ownership and/or financing of the phased development.	
The Colvi anows for separate ownership and/or financing of the phased development.	
Since the site will not be rezoned, the Inclusionary Zoning ordinance does not apply. The	
housing will be developed for condominium-ownership.	
Project Description:	
The project is a planned mixed-use development with four separate buildings arranged on a site	
of approximately 3.2 acres. The buildings and uses are generally arranged to orient the	
commercial uses towards West Broadway Avenue and the residential use towards Lake Point	
Drive. The intent is to enhance the residential streetscape of Lake Point while taking advantage	
of the commercial opportunities that Broadway Avenue offers.	
Vehicular access is obtained at two locations on Lake Point and at one on Broadway. The	
Broadway Avenue access is an existing access drive with a median break to allow left turns into	
and off of the site. The easterly Lake Point Drive access is also existing and will be shared with	
the existing restaurant on the corner of Lake Point and Bridge (an easement for cross access will	
be provided). The parking areas are distributed around the site to provide adequate convenient	
parking for the commercial users. Parking for the residential use is located in the underground	
parking garages and provide 1.3 stalls/unit of covered and secure parking. Additional parking for residents and guests will be available on Lake Point Drive as well as in the surface parking areas.	
Two off-street loading spaces are provided off the main parking area.	
Buildings 1 and 2 are three story buildings with commercial-residential mixed occupancy on the	
first floor and residential use on the upper two levels. The buildings are "U"-shaped and form a	
private central courtyard for the residents. Building 3 is a 2 story building planned for a restaurant use. A future building #4 is planned on the west end of the site for a banking facility	
with drive-thru lanes. All of the buildings will be cohesively designed for a well-planned and	
attractive community.	
X:0529-Simon Broadway\Project Information\Site & Zoning\letter of intent template.doc	
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Letter of Intent – Conditional Use 1513 Lake Point Drive March 8, 2006 Revised: May 31, 2006

# Site Development Statistics:

THE REAL PROPERTY OF THE PROPE	
Lot Area:	139,262 S. F./3.2 acres
Commercial Floor Area:	19,800 S. F.
Residential Floor Area:	119,200 S. F.
Total Floor Area:	
Total Floor Alica.	139,000 S. F.
Floor Area Ratio (F.A./Lot Area):	39,000/139,262 = 1.0
Dwelling Unit Mix	
One Bedroom	12
Two Bedroom	26
Two Bedroom Town House	12
Total	50
. 0001	30
Required Lot Area	
$1,000 \times 12 \text{ one-bedrooms} =$	12,000 S. F.
$1,300 \times 38 \text{ two-bedrooms} =$	49,400 S. F.
Total 50 =	61,400 S. F.
1044 50	61,400 S. F.
Usable Open Space:	
12 one-bedrooms x 160 S. F. =	1,920 S. F.
38 two-bedrooms x 320 S. F. =	12,160 S. F.
Total Required Open Space	
rotal required open space	14,080 S. F.
Provided Open Space:	15,600 S. F.
Required Parking	
1.25 Stalls x 12 one-bedrooms =	
1.5 Stalls x 38 two-bedrooms =	57
1:300 S. F. x 15,000 S. F. comm	ercial = 50
1 stall x 30% x 150 persons resta	
Total Required Stalls	167
Social Medical Sections - Newborn Sections	
Vehicle Parking Provided:	
Surface	114 (incl. 5 accessible
Underground	62 (incl. 4 accessible
Total	176
	170
Bike Parking Provided:	
Surface	31
<u>Underground</u>	22
Total	53
7.7.	55
Loading Zones Provided:	2 (10' x 35')
0	2 (10 X 33)

Total	50	
Required Lot Area		
$1,000 \times 12 \text{ one-bedrooms} =$	12,000 S. F.	
	49,400 S. F.	
	61,400 S. F.	
Usable Open Space:		
12 one-bedrooms x 160 S. F. $=$	1,920 S. F.	
38 two-bedrooms x 320 S. F. $=$	12,160 S. F.	
Total Required Open Space	14,080 S. F.	
Provided Open Space:	15,600 S. F.	
Required Parking		
1.25 Stalls x 12 one-bedrooms =	15	
1.5 Stalls x 38 two-bedrooms =	57	
1:300 S. F. x 15,000 S. F. commercial	= 50	
1 stall x 30% x 150 persons restaurant =	= 45	
Total Required Stalls	167	
Vehicle Parking Provided:		
Surface	114 (incl. 5 accessible)	
Underground	62 (incl. 4 accessible)	
Total	176	
Bike Parking Provided:		
Surface	31	
Underground	22	
Total	53	
Loading Zones Provided:	2 (10' x 35')	
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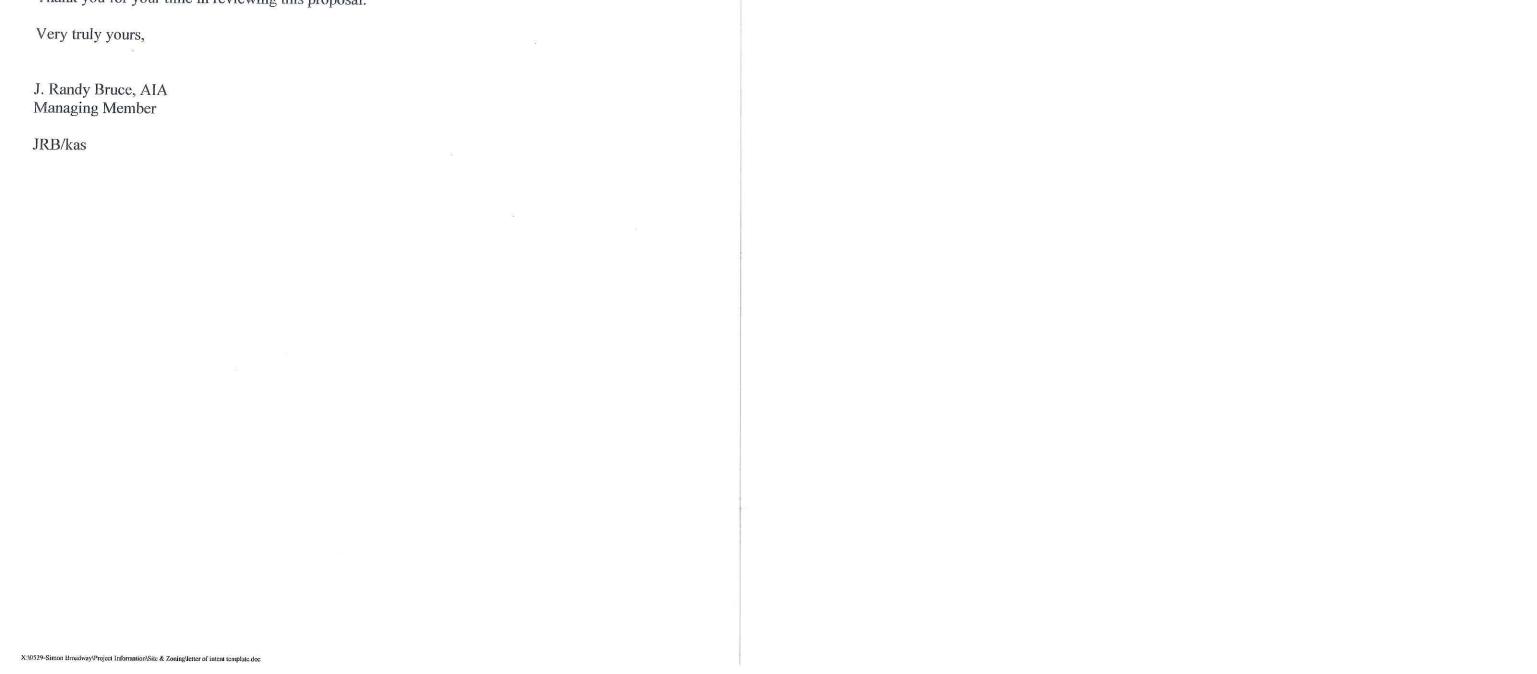
Letter of Intent - Conditional Use 1513 Lake Point Drive March 8, 2006 Revised: May 31, 2006

### **Project Schedule and Management:**

Construction of this development will be phased. Construction of Building 2 and 3 is expected to start in summer of 2006 with completion the following spring. The remaining buildings will proceed as economic conditions dictate and are expected to be completed by spring 2009.

It is planned that each lot within this development could be individually owned although a management agreement will require unified property management for the entire site. Private professional management will handle all services such as trash removal and grounds and building maintenance. A cross-access, parking and maintenance agreement will provide for joint vehicular and pedestrian circulation between the lots.

Thank you for your time in reviewing this proposal.







KIM Products
Page 1 of

KIM LIGHTING

BOUNCE

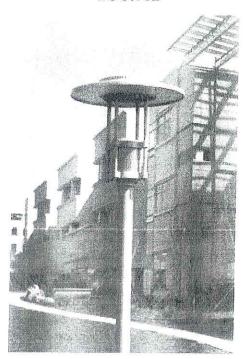

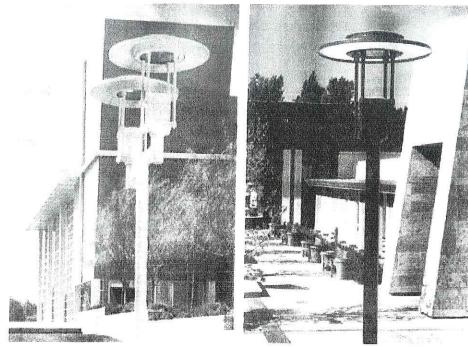

The Ultimate in Architecturally Relevant Outdoor Lighting

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http://www.kimlighting.com/kl-1581.html

5/31/200€



# Bounce®

#### **Table of Contents**

Relativity	2-3
Horizontal or Vertical Lamp	4
Design Features	5
Ordering Information	6
Proportion Guide	9
Application Engineering Services	10

#### ISO 9001:2000

# KIM LIGHTING

SITE / AREA PARKING STRUCTURE ROADWAY ARCHITECTURAL FLOOD ACCENT LANDSCAPE

MAILING ADDRESS: P.O. BOX 60080 CITY OF INDUSTRY, CA 91716-0080

BUSINESS ADDRESS: 16555 EAST GALE AVENUE CITY OF INDUSTRY, CA 91745 U.S.A.

PHONE 626 / 968-5666 FAX 626 / 369 - 2695

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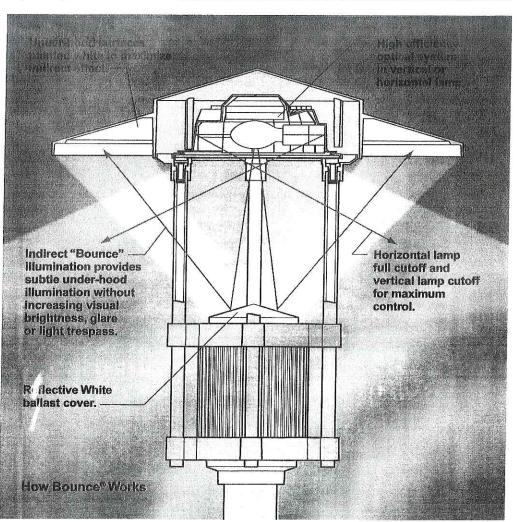



Hubbell Lighting, Inc.

Printed in U.S.A. 5506504243 Version 8/04

#### Bounce®

The Bounce® luminaire design combines the look of contemporary European lanterns with the cutoff control and optical performance provided in every Kim area lighting product. Rather than waste light by discharging it in lateral planes, the Bounce luminaire utilizes either Vertical or Horizontal lamp optical systems with cutoff lighting control. A subtle indirect component is captured from light bouncing off the reflective white ballast compartment cover, to illuminate the underside of the fixture's hood. Bounce addresses the growing concern for control of glare and light trespass, with a unique visual presence both day and night.




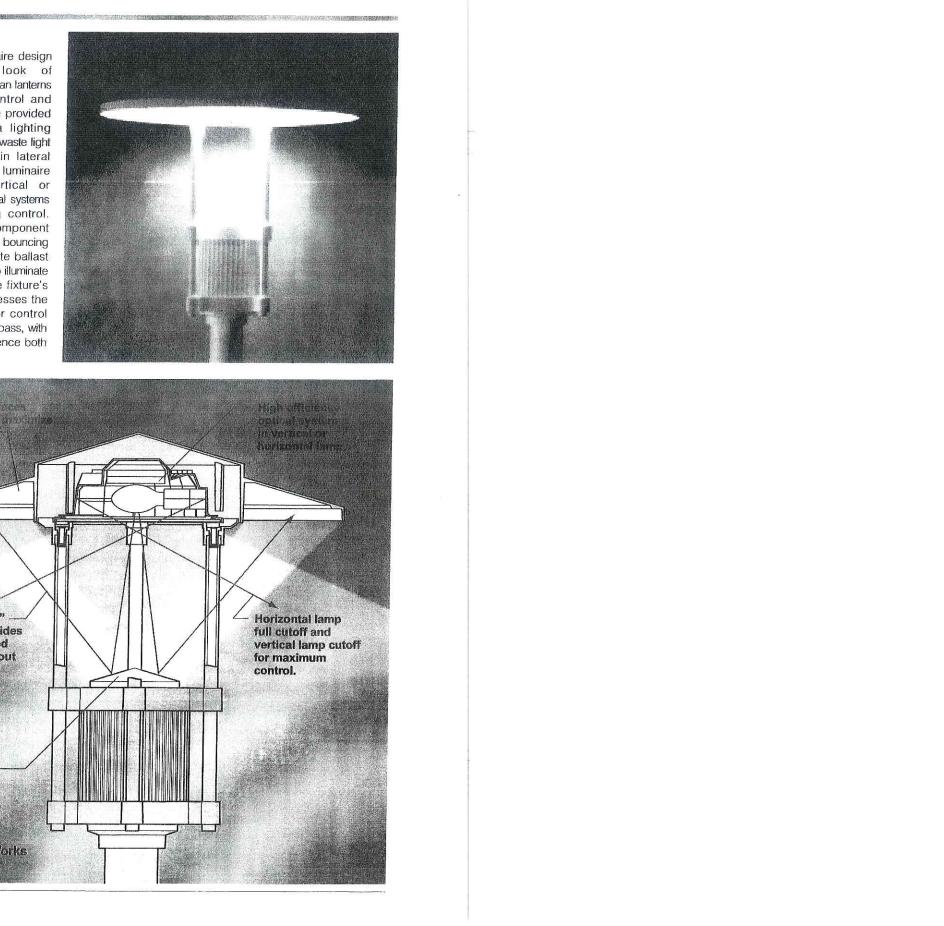

#### RECTANGULAR HID WALL MOUNT

# DEEP SHIELDED



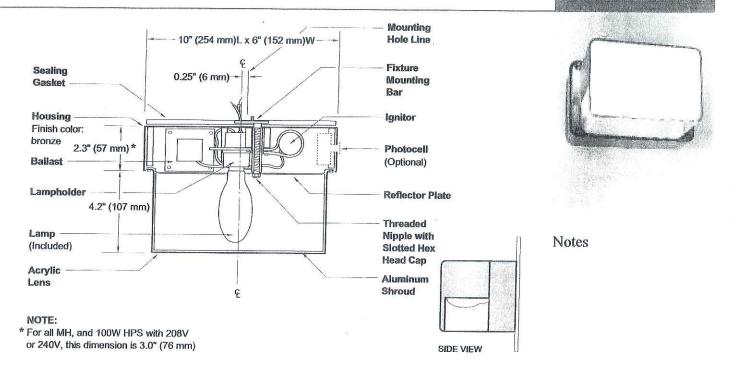

	METAL	HALIDE	
SPEC#	Wall Downlight	50W MH	E8405-(a)(b)
SPEC#	Wall Downlight	70W MH	E8407-(a)(b)
70E 1830 S	HIGH PRESS	URE SODIL	IN
SPEC#	Any	35W HPS	E8503-(a)(b)

SPEC# Any 50W HPS E8505-(a)(b) SPEC# Wall Downlight 70W HPS E8507-(a)(h) SPEC# Wall Downlight 100W HPS E8510-(a)(b)

GENERAL DESCRIPTION

Aluminum die-cast ballast housing features a

thermal air isolation chamber separating the

ballast core and coil from the other electrical

gasket for complete weatherproofing at the

mounting surface. A silicone rubber seal is

bar and threaded nipple provided for direct mounting to recessed junction box. Clear acrylic

lens is fastened to housing with phillips-head captive stainless-steel screws. Combination of

painted white and outside painted silver on 100W HPS) and diffuse reflector plate provides front brightness shielding without sacrificing wide

internal polished aluminum shroud (inside

light distribution.

components. Supplied with a neoprene sealing

furnished between housing and lens to ensure a

water- and insect-tight seal. Steel fixture mounting

Specify (a) Voltage & (b) Options.

#### 120/277V (Standard: 50 - 70W MH) 120/277/347V (Canada Only) (70W MH; 70 - 100W HPS) 120V (Standard: 35 - 100W HPS) 277V (35 - 100W HPS) 208V (35 - 100W HPS) 240V (35 - 100W HPS) 347V (Canada Only) (70 - 100W HPS

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For voltage availability outside the US and Canada, see Bulletin TD-9 or contact your Ruud Lighting authorized International Distributor.

(a) VOLTAGE SUFFIX KEY

#### ELECTRICAL

Fixture includes clear, medium-base lamp and porcelain enclosed, 4kv-rated screw-shell-type lampholder with spring-loaded center contact. Lamp ignitor included where required. All ballast assemblies are normal power factor and use the following circuit types:

Reactor (120V only) 35 - 100W HPS

Reactor/Transformer (208, 240, 277V) 35 - 100W HPS

HX --- High Reactance

50 - 70W MH; 70 - 100W HPS (347V)

#### LABELS

ANSI lamp wattage label supplied, visible during relamping. UL Listed in the US and Canada for wet locations and enclosure classified IP54 per IEC 529 and IEC 598.

BS	Bronze Color Shroud
GS	Gold Color Shroud (n/a on 100W HPS)
Н	High Power Factor Ballast
J	Tamperproof Lens Fasteners
(a)P	Photocell
1	Polycarbonate Lens
pecify (	a) Single Voltage — See Voltage Suffix Key

#### FINISH

Exclusive DeltaGuard® finish features an E-coat epoxy primer with medium bronze acrylic powder topcoat, providing excellent resistance to corrosion, ultraviolet degradation and abrasion. The finish is covered by our sevenyear limited warranty.

	ACCESSORIES
ESB-7	Surface Mounting Box
PAS-7	Pole Mounting Bracket
TPS-1	Tamperproof Screwdriver

9201 Washington Avenue Racine, Wisconsin 53406-3772 USA

PHONE (262) 886-1900

FAX (262) 884-3309




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## E8-H SERIES

# RECTANGULAR HID WALL MOUNT


# DEEP SHIELDED



Front View

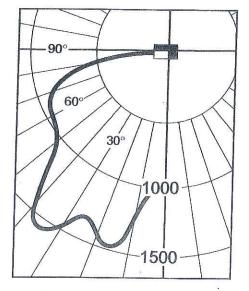Lighting Sciences Inc. Certified Test Report No. LSI 7361 Candlepower distribution curve of 70W HPS Rectangular Deep Shielded Fixture.

EFFICIENCY = 57.6%

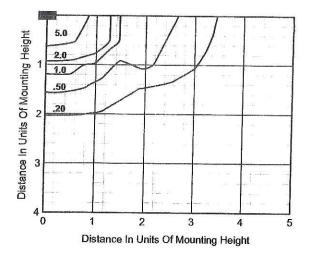

Isofootcandle plot of 70W HPS Rectangular Deep Shielded fixture at 10' (3 m) mounting height. (Plan view) Isofootcandle plots show initial footcandles at grade. (Footcandles ÷ 0.0929 = Lux)

ANGLE	MEAN CP	ANGLE	MEAN CP
0.0	853	60.0	491
5.0	1166	62.5	950
10.0 15.0	1264 1605	65.0	1197
20.0	1506	67.5	903
25.0	1610	70.0	851
30.0	1416	72.5	831
32.5	1758	75.0	783
35.0	1719	77.5	766
40.0	1540	80.0	800
45.0	1218	82.5	806
50.0	1293	OWNERS OF	
52.5	906	85.0	382
55.0	500	87.5	205
57.5	563	90.0	8

Maximum Candlepower: 1758
Plane of Maximum CP: 105.0°
Vertical Angle of Maximum Candlepower: 32.5°
Lumen Rating: 6400

#### **MOUNTING HEIGHT CONVERSION TABLE**

Footcandle readings for mounting heights other than 10' (3 m) may be obtained by multiplying fc values by the following:

HEIGHT	MULTIPLIER		
7.0' (2.1 m)	2.04		
8.0' (2.4 m)	1.56		
9.0' (2.7 m)	1.23		
12.0' (3.7 m)	0.69		
15.0' (4.6 m)	0.44		
20.0' (6.1 m)	0.25		

#### LAMP WATTAGE CONVERSION TABLE

Footcandle readings for wattages and lamp types other than 70W HPS may be obtained by multiplying fc values by the following:

LAMP/WATTAGE	MULTIPLIER
50W MH	0.48
70W MH	0.79
100W MH	1.27
35W HPS	0.35
50W HPS	0.63
100W HPS	1.49
	1.00



9201 Washington Avenue Racine, Wisconsin 53406-3772 USA


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12/11/03



KNUI HE SBRUCE ARCHITECTS

7601 University Avenue, Ste. 201 Middleton, Wisconsin 53562 608-836-3690 Fax 836-6934

Consultan

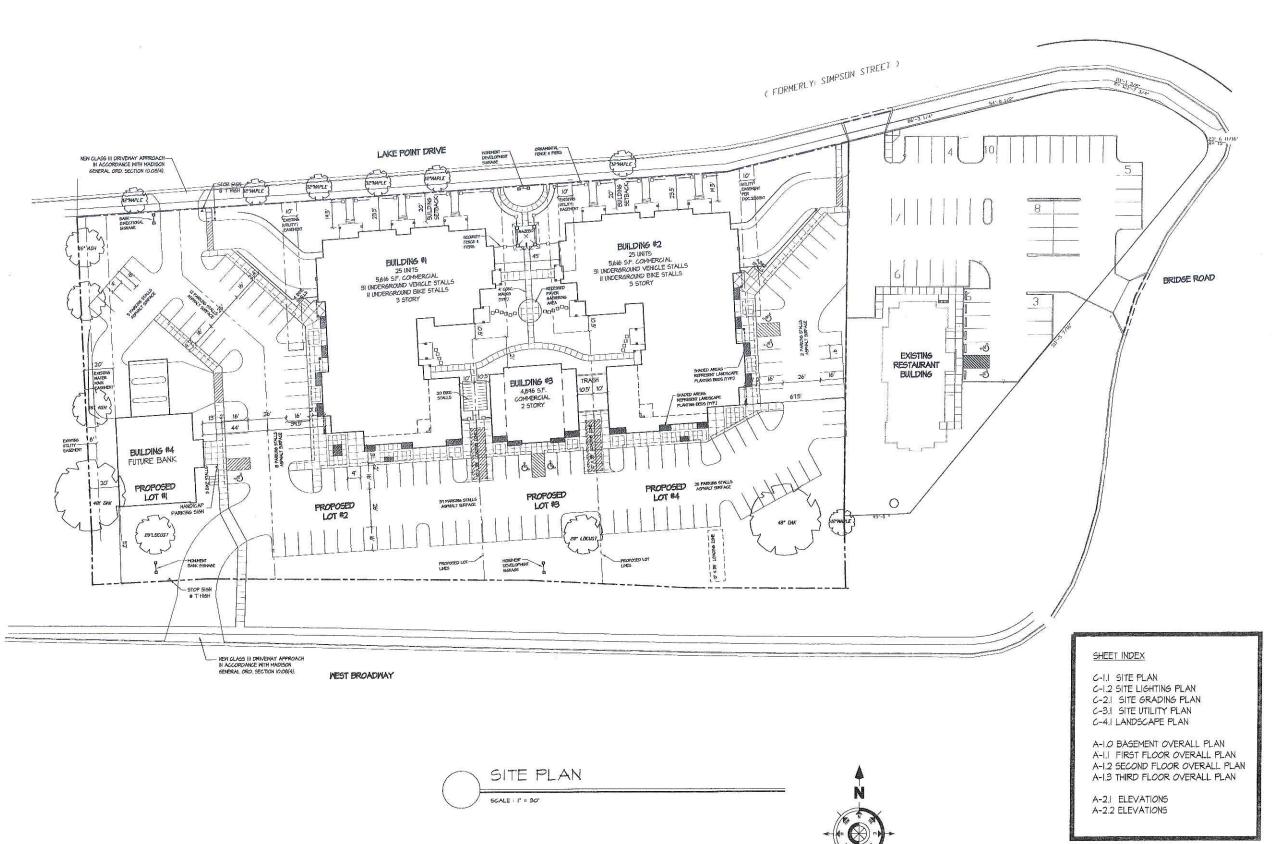Notes

I, MAXIMIM SLOPE AT ALL HANDICAP ACCESSIBLE WALKS 1:20. MAXIMIM SLOPE AT HANDICAP RAMPS 1:12. RAMPS OVERCOMING MORE THAN 6" CHANSE IN ELEVATION TO HAVE HANDRAILS ON BOTH SIDES.

2. ALL DRIVEWAYS, OURB ADJACENT TO DRIVEWAYS, AND IDEMALK CONSTRUCTION WITHIN THE PUBLIC RIGHT-OF-WAY, SHALL BE COMPLETED IN ACCORDANCE WITH CITY OF MADISON STRAIDARD SPECIFICATIONS FOR PUBLIC WORKS CONSTRUCTION BY A CONTRACTOR CURRENILLY LICENSED BY THE CITY.

3. ALL NEW DRIVES TO BE CONSTRUCTED WITH CLASS III APPROACHES IN ACCORDANCE WITH MADISON GENERAL ORDINANCE SECTION 10.08(4)

4. ALL TRASH TO BE COLLECTED IN UNDERGROUND PARKING GARAGES. RECYCLING AREAS TO BE PROVIDED IN TRASH ROOM.

SEE SITE GRADING AND UTILITY PLANS FOR ADDITIONAL INFORMATION.

6 COMM 62.0500(II)-REQUIRED FIRE LANES SHALL BE PROVIDED PRIOR TO THE PLACEMENT OF COMBISTIBLE MATERIALS AT THE BUILDING SITE, OR THE CONSTRUCTION OF ANY PORTION OF A BUILDING ABOVE THE FOOTING AND FOUNDATION.

 ALL WORK IN THE RIGHT OF WAY SHALL BE PERFORMED BY A CITY LICENSED CONTRACTOR.

8. BIKE STALLS TO BE IN ACCORDANCE TO MADISON GENERAL ORDINANCE 2811, FOR THE TYPES OF RACKS ESPECIALLY SEE SUBSECTIONS (3)(6) AND (3)(h)2d.,

Kewsic

MARCH 8, 2006 - PLAN COMMISSION SUBMITTAL MARCH 29, 2006 - INITIAL U.D.C. SUBMITTAL MARCH 31, 2006 - ISSUED FOR PRICING MAY 31, 2006 - FINAL U.D.C. SUBMITTAL

Project Title

# River Oaks Condominiums

1513 Lake Point Drive

Drawing Title Site Plan

Project No. 0529


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Drawing No.

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Symbol	Lobel	Oty	Manufacturer	Catalog Number	Dasoription	Lamp	File	Lumans	LLF	Walte	Mounting
	BN2  Arrow ledicales Brection of light, typic	4	Kim Lighting	BNS 1H2/17GMHxx x/xx	BOUNCE PEDESTRIAN SCALE LUMINAIRE DIE CAST ALUM HOUSING LENS FRAME SEMI- SPECULAR MULTI- FACETED REFL PANELS CLEAR FLAT GLASS LENS	175MH COATED ED17 HORIZONTAL POSITION TEST RATED AT 13300 INITIAL LUMENS	Bsh2f17m les	13300	0.90	175	16:0" POLE ON 2'-0" CONC. BASE
V	BN2HS	2	Kim Lighting	BNS1H2/175MHex x/xx	BOUNCE PEDESTRIAN SCALE LUMINAIRE DIE CAST ALLM HOUSING LENS FRAME SEM- SPECULAR MULTI- FACETED REFL PANELS CLEAR FLAT GLASS LENS WI HOUSESIDE SHIELD	175MH COATED ED17 HORIZONTAL POSITION TEST RATED AT 13300 INITIAL LUMENS	Bsh2f17m.ies	13300	B.90	175	16-0" POLE ON 2'-0" CONC. BASE
V	BN4HS	5	Klm Lighting	BNS1H4/175MHbxx x/xx	BOUNCE PEDESTRIAN SCALE LUMINAIRE DIE CAST ALUM HOUSING LENS FRAME SEM- SPECULAR MULTI- FACETED REFL PANELS CLEAR FLAT GLASS LENS WI HOUSESIDE SHEILD	175MH COATED ED17 HORIZONTAL POSITION TEST RATED AT 13300 INITIAL LUMENS	Bah4f17m.les	13300	0.90	175	16-0" POLE ON 2-0" CONC. BASE
	Α	Z	Ruud Lighting	E8405-D	RECTANGULAR SECURITY / DEEP SHEILDED	50W MH		3000	0.90	86	6'-0" UP ON SIDE OF BUILDING

LIGHTING	STATISTICS					
Description	Symbol	Avg	Max	Min	Max/Min	Avgavin
Parking Lots		1.6 fc	4.9 fc	0,4 fe	12.3:1	3.9:1





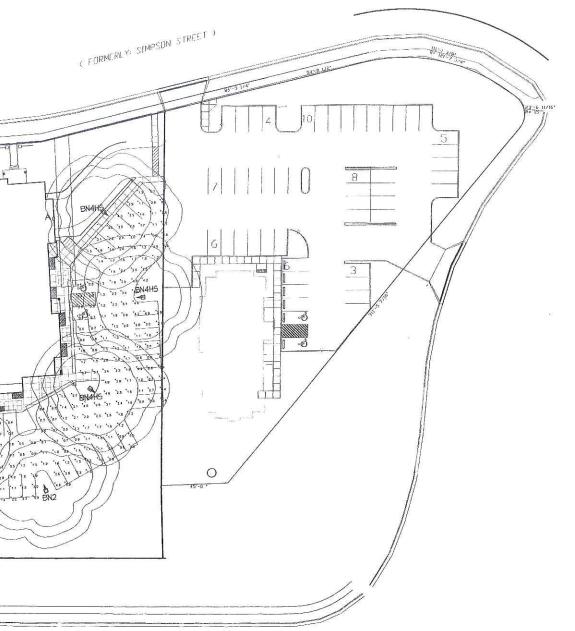



Middleton, Wisconsin 53562 608-836-3690 Fax 836-6934


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Project Tide **River Oaks Condominiums**1513 Lake Point Drive

Drawing Title
Site Lighting Plan

Project No. 0529

Drawing No. C-1.2

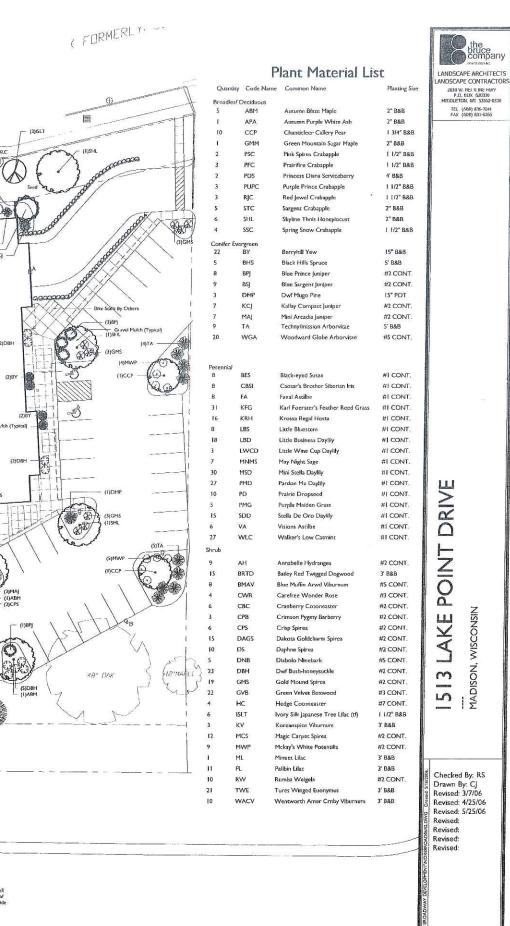

LAKE POINT DRIVE (3)VA PROPOSED PROPOSED LOT #4 (I)Ex. Locust LOT #3 PROPOSI 2 LOT #2 Stop Sign \_\_ Edging/Gravel Mulch

WEST BROADWAY

LAND:	SCAPE POINTS REQUIREMENTS	
	Number of parking Stalls	114
	Number of 2" Min, Cal. Trees Required	9
	Number of Landscape Points Required	662
OLUT	TON	
7	Canopy Trees (2"-2 1/2") @ 35 pts.	245
9	Canopy Trees or Small Ornamental Trees (1 1/2"-2"0) @ 15 pts	135
80	Deciduous Shrubs @ 2 pts.	160
26	Evergreen Shrubs @ 3 pts.	78
80 26 14	Evergreen Trees (3' Ht.) @ 15 pts.	78 210
-	Decorative Wall or Fence @ 5 pts. per 10 l.f.	14.
-	Earth Berm per 10 Lf. :	-
0.0700	Average Hr 30" @ 5 pts.	
	Average Hr 15" @ 2 prs.	12
-	TOTAL POINTS	828

#### GENERAL NOTES

B) "Edging" to be Valley View Black Diamond Edging or equivalen

C) Areas labeled "Gravel Mulch" to receive 1-1/2" washed gravel spread to a 3" depth over fabric weed barrier.


D) "Seed" areas shall be finish-graded and seeded at a rate of 4 lbs. per 1,000 sq. fc.

E) Seed shall consist of the following mixture: 40% Palmer Ryegrass 20% Baron Bluegrass 20% Natsau Bluegrass 20% Pennlawn Creeping Red Fescue



SCALE: 1"=20'-0"

C - 4.1

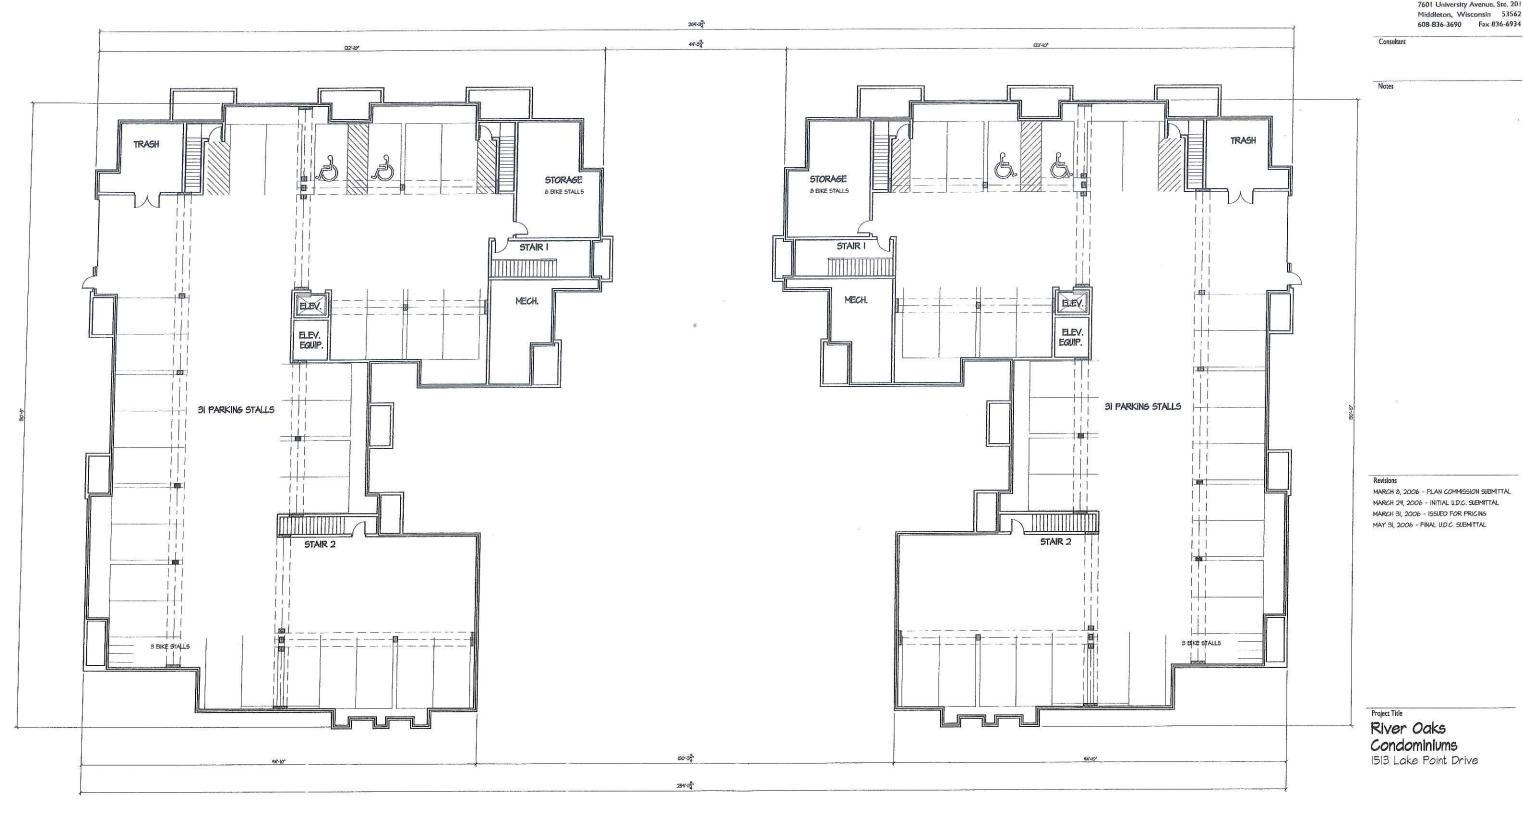






Middleton, Wisconsin 53562

Drawing Title Basement Overall Plan

25 Unit Building

Project No. 0529

A-1.0

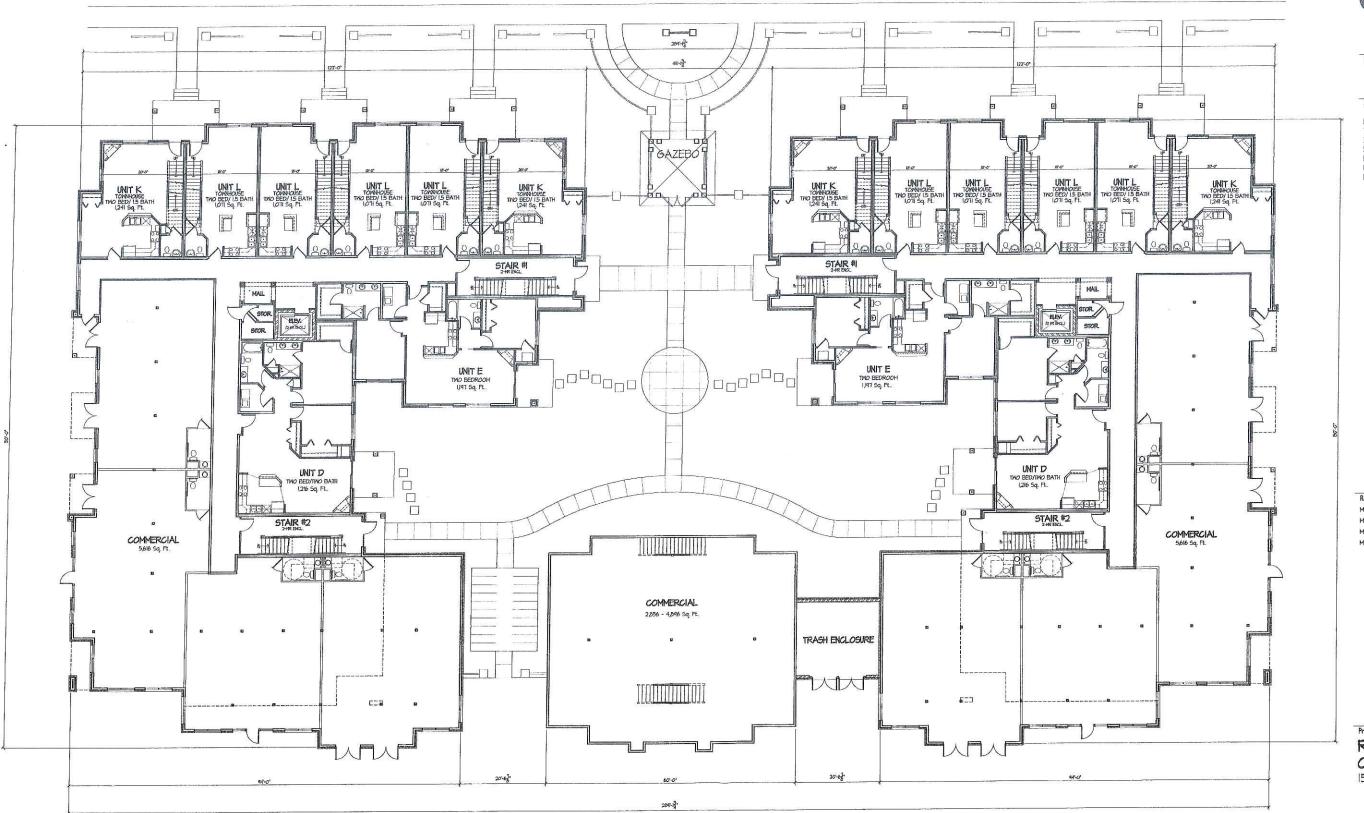



KNOTHE SBRUCE ARCHITECTS

> 7601 University Avenue, Ste. 201 Middleton, Wisconsin 53562 608-836-3690 Fax 836-6934

Consultant

Notes

I. INDICATES EXTENT OF FIREBARRIER WALL. FIRE BARRIER WALL EXTENDS FROM TOP OF FLOOR DECK TO BOTTOM OF FLOOR DECK ABOVE. GYPSUM BOARD SHEETHING MUST EXTEND THOUGH FLOOR ASSEMBLY TO UNDERSIDE OF FLOOR DECK ABOVE.

Revisio

MARCH 8, 2006 - PLAN COMMISSION SUBMITTAL MARCH 29, 2006 - INITIAL U.D.C. SUBMITTAL MARCH 31, 2006 - ISSUED FOR FRICINS MAY 31, 2006 - FINAL U.D.C. SUBMITTAL

Project Title

River Oaks Condominiums


1513 Lake Point Drive

Drawing Title
First Floor Overall Plan

25 Unit Building

Project No. 0529 Drawing No.

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SECOND FLOOR OVERALL PLAN 3/32" = 1'-0"

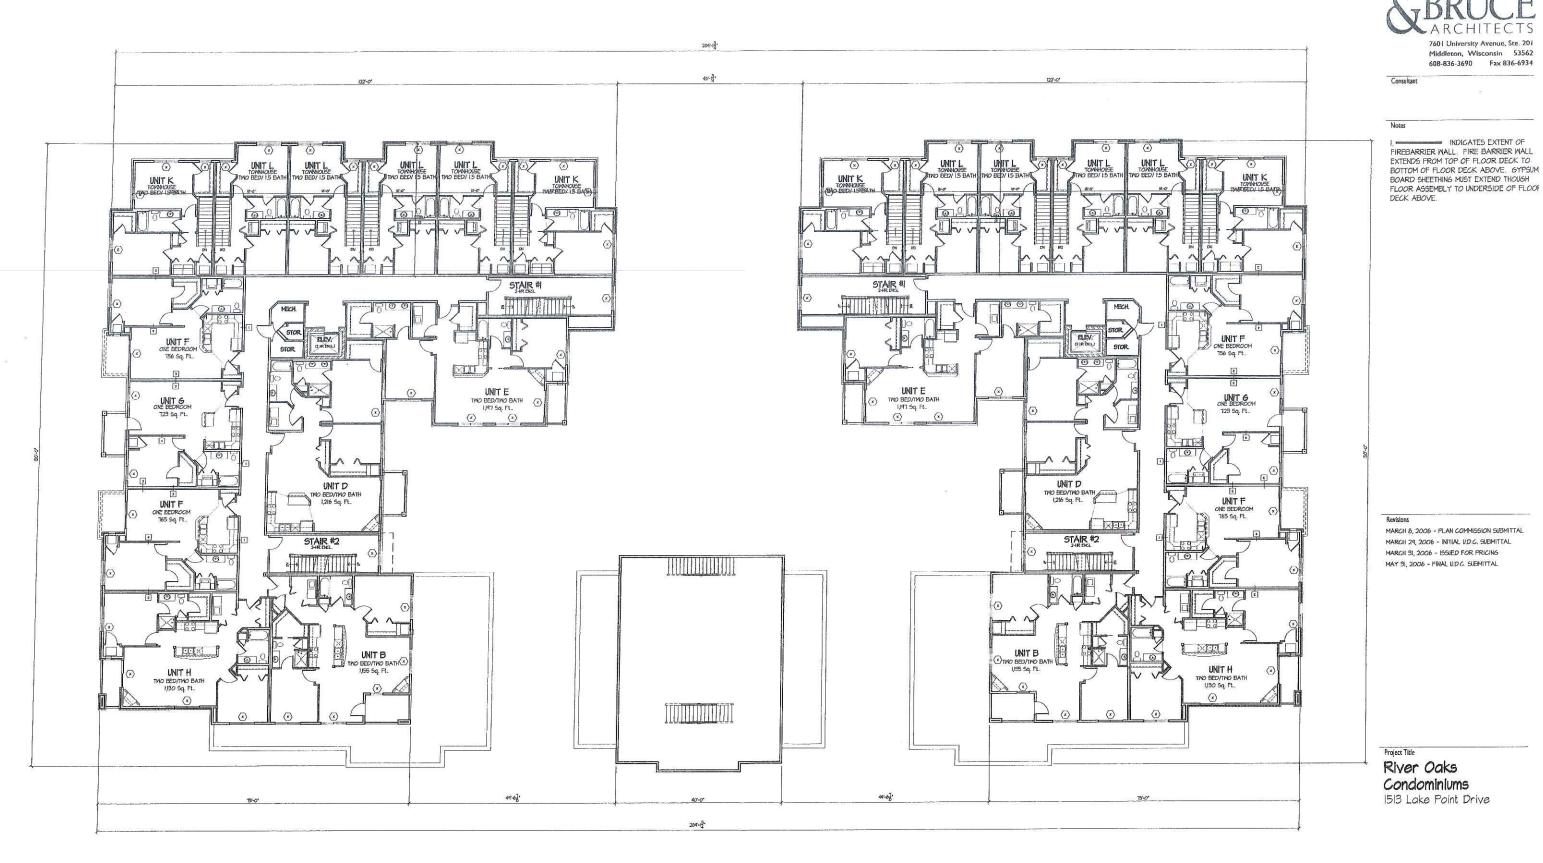Second Floor Overall Plan 25 Unit Building

Middleton, Wisconsin 53562 608-836-3690 Fax 836-6934


- INDICATES EXTENT OF

Project No.

0529

Drawing No.

A-1.2

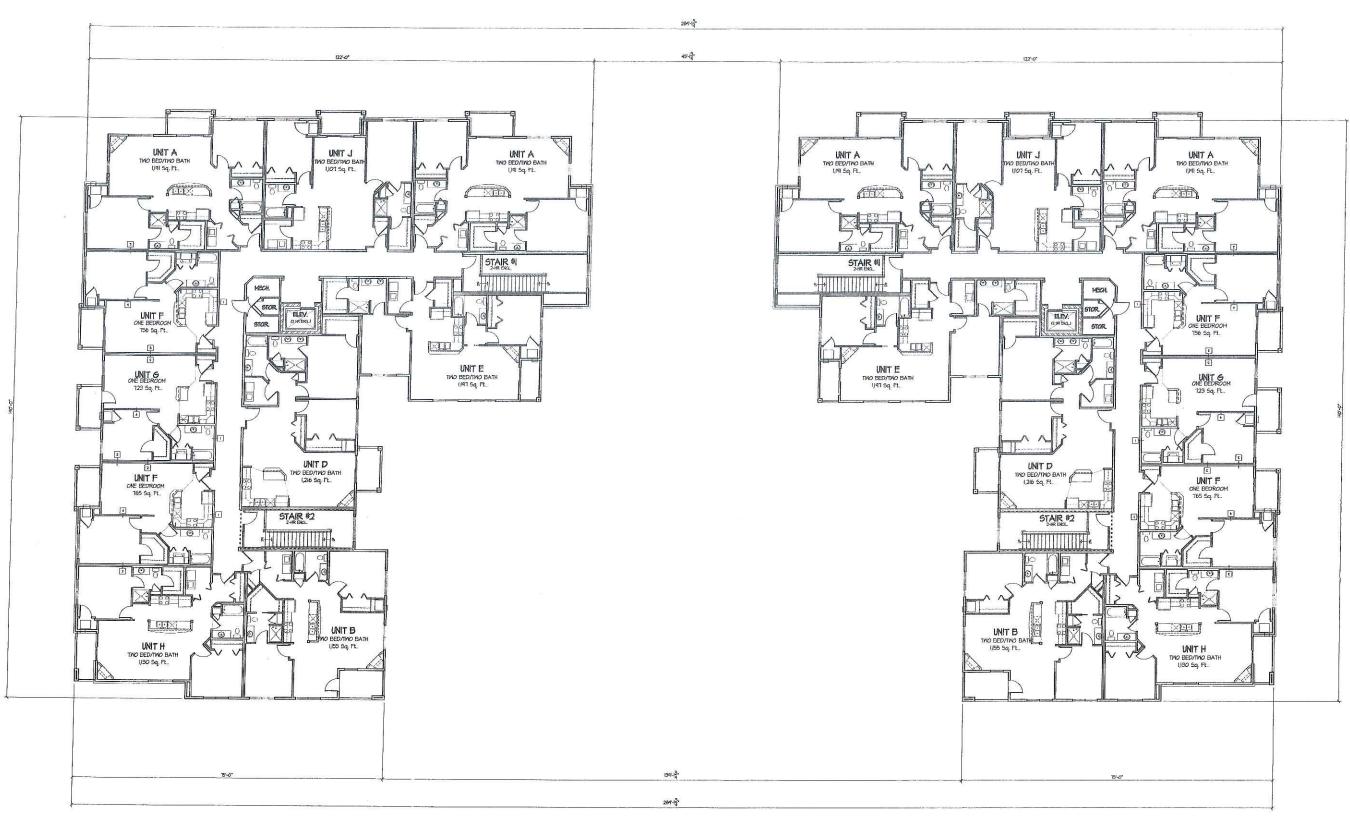

KNOTHE SBRUCE

> 7601 University Avenue, Ste. 201 Middleton, Wisconsin 53562 608-836-3690 Fax 836-6934

Consultant

Notes

INDICATES EXTENT OF FIREBARRIER WALL FIRE BARRIER WALL EXTENDS FROM TOP OF FLOOR DECK TO BOTTOM OF FLOOR DECK ABOVE. 6YPSUM BOARD SHEETHING MUST EXTEND THOUGH FLOOR ASSEMBLY TO UNDERSIDE OF FLOOT DECK ABOVE.

Revisions

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Project T

River Oaks Condominiums

1513 Lake Point Drive

Drawing Title
Third Floor Overall Plan

25 Unit Building
Project No.

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0529 A-I.3

Drawing No.

THIRD FLOOR OVERALL PLAN





Consultant

Notes



South Elevation Along Broadway



East Elevation Bldg #2 (West Elevation Bldg #1 Mirror Image)

Revisio

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Project Title

River Oaks
Condominiums
1513 Lake Point Drive

Drawing Title Elevations

Project No. 0529

Drawing No.

A-2.I


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North Elevation Along Lake Point

3/32" = 1'-0"



WEST

Side Elevations Blda # 3

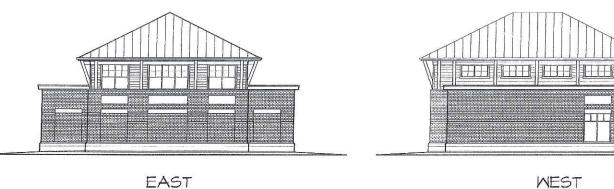3/32" = 1'-0"

River Oaks Condominiums 1513 Lake Point Drive

Drawing Title Elevations

Revisions

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Project No.

Drawing No. A-2.2

0529

West Elevation Bldg #2 (East Elevation Bldg #1 Mirror Image) 3/32" = 1'-0"