LAKESHORE NATURE PRESERVE - FRAUTSCHI CENTER

1972 UNIVERSITY BAY DRIVE MADISON, WI 53705

STAMPS


STAMP	STAMP	STAMP



Land Use Application Development Plans

03/17/2025

LOCATION MAP

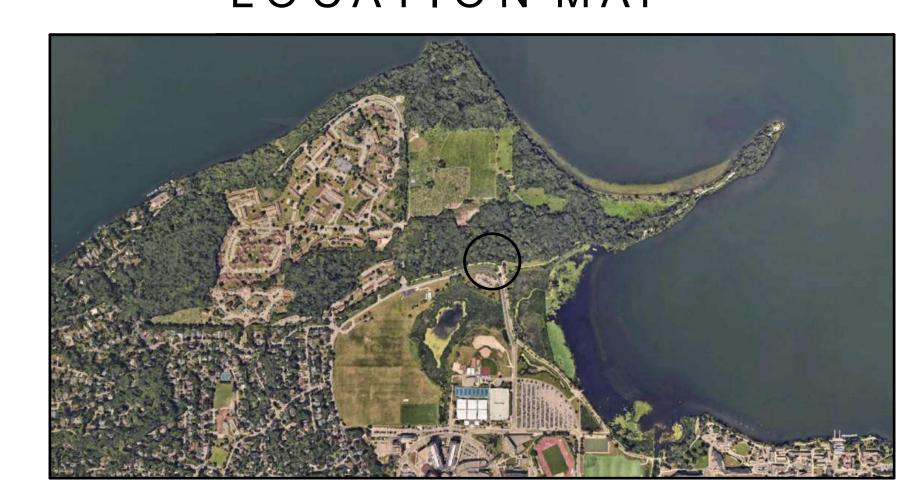

ABBREVIATIONS

@	AT	CORR	CORRIDOR	НС	HANDICAPPED	RC	ROOF CONDUCTOR
_		CRS	COURSE	HDR	HEADER	RD	ROOF DRAIN
ADJ	ADJUSTABLE	CTR	COUNTER	HM	HOLLOW METAL	REF	REFRIGERATOR
AFF	ABOVE FINISHED FLOOR			HR	HOUR	RI	ROUGH IN
AL	ALUMINUM	DS	DOWNSPOUT	HT	HEIGHT	RO	ROUGH OPENING
ACT	ACOUSTICAL CEILING TILE	DTL	DETAIL	HVAC	HEATING, VENTILATING &		
ACP	ACOUSTICAL CEILING PANEL	DWG	DRAWING		AIR CONDITIONING	SAN	SANITARY SEWER
				ΙE	INVERT ELEVATION	SDS	SOAP DISPENSER
BL	BRICK LEDGE	EL	ELEVATION	INSUL	INSULATION	SH	SHELF
BITUM	BITUMINOUS	ELEC	ELECTRIC	I.C.	IN CONTRACT	ST	STORM SEWER
BLDG	BUILDING	ELEV	ELEVATOR			STL	STEEL
BRG	BEARING	EQUIP	EQUIPMENT	LAV	LAVATORY	STR	STRUCTURAL
		EXIST	EXISTING	LL	LOWER LEVEL	SS	STAINLESS STEEL
С	CONDUIT					SUSP	SUSPENDED
CAB	CABINET	FD	FLOOR DRAIN	MFG	MANUFACTURER		
CB	CATCH BASIN	FE	FIRE EXTINGUISHER	MH	MANHOLE	T/C	TOP OF CONCRETE
CH	COAT HOOK	FEC	FIRE EXTINGUISHER	MO	MASONRY OPENING	TDS	TOWEL DISPENSER
CI	CAST IRON		CABINET W/ FE	MTD	MOUNTED	TEL	TELEPHONE
CJ	CONTROL JOINT	FIN	FINISHED	MTG	MOUNTING	T/S	TOP OF STEEL
CKT	CIRCUIT	FLR	FLOOR			TLT	TOILET
CPT	CARPET LINE	FRT	FIRE RETARDANT TREATED	N.I.C.	NOT IN CONTRACT	TYP	TYPICAL
C/L	CENTER LINE	FNDTN	FOUNDATION				
CLG	CEILING	FUT	FUTURE	O.C.	ON CENTER	UL	UNDERWRITER'S LABORATORY
CL.	CLOSET			O.D.	OUTSIDE DIAMETER	UNO	UNLESS NOTED OTHERWISE
CMU	CONCRETE MASONRY UNIT	GA	GAUGE				
COL	COLUMN	GALV	GALVANIZED	PL	POLE	VIF	VERIFY IN FIELD
CONC	CONCRETE	GB	GRAB BAR	PNT	PAINT		
CONN	CONNECTION	GYP BRD	GYPSUM BOARD	PTD	PAINTED	W/	WITH
CONTR	CONTRACTOR	GWB	GYPSUM WALL BOARD			WC	WATER CLOSET
						WM	WATER MAIN
						WWF	WELDED WIRE FABRIC

SHEETINDEX

RENDERINGS	
CIVIL	
COO1	EXISTING CONDITIONS
C200	EROSION CONTROL PLAN
C300	SITE LAYOUT
C400	GRADING PLAN
C500	UTILITY PLAN
C501	UTILITY PLAN
C502	SANITARY AND WATER UTILITY PLAN
C600	FIRE ACCESS PLAN
LANDSCAPE	
L100	SITE LANDSCAPE PLAN
L101	ENLARGEMENT LANDSCAPE PLAN
1900	LANDSCAPE NOTES AND DETAILS
L901	SITE DETAILS
2301	one be miles
ARCHITECTURA	AL
A1.1	LEVEL 01 FLOOR PLAN
A1.2	ROOF PLAN
A3.0	EXTERIOR ELEVATIONS
A3.0-1	EXTERIOR ELEVATIONS - BIRD GLASS EXHIBIT
A3.1	GARAGE EXTERIOR ELEVATIONS
A3.1-1	GARAGE EXTERIOR ELEVATIONS - BIRD GLASS EXHIBIT
A4.0	BUILDING SECTIONS - TRANSVERSE
A4.1	BUILDING SECTIONS - LONGITUDINAL
A5.0	WALL SECTIONS
A5.1	WALL SECTIONS
A5.2	WALL SECTIONS
A6.0	VESTIBULE
A6.1	INTERPRETIVE
A6.2	CORRIDOR
A6.3	MULTIPURPOSE
A6.4	RESTROOMS
A6.5	STAFF & CONFERENCE
A6.6	OFFICES
A6.7	WORK AREA
A6.8	SHOWER
A6.9	MOTHER'S
A6.10	GARAGES
A6.11	GARAGES
A6.20	STAIR PLANS & SECTIONS
A6.21	ELEVATOR PLANS & SECTIONS
A8.0	WINDOWS
A8.1	DOORS
A8.2	WALL ASSEMBLIES
A8.3	ROOF ASSEMBLIES
A9.2	FURNITURE PLANS
A9.3	PERSPECTIVES
A8.3 A9.2	ROOF ASSEMBLIES

MECHANICAL & ELECTRICAL CONSULTANTS

DESIGN ENGINEERS

215 GREENWAY BLVD. STE. 180 MIDDLETON, WI 53562 P: 608.422.4298

he Board of Regents of the University of Wisconsin on behalf of he University of Wisconsin - Madison

SHORE NATURE PRESERVE
SCHI CENTER

ING NO. - BUILDING NAME

RSITY OF WISCONSIN - MADISON

ON, WISCONSIN COVER SHEET

Revisions:

No. Date: Description:

Scale As indicated

UWM # 9950-2218

LIMS A # A-22-007

ate sued 03/17/25












Full Veneer Stone Wall Material Considerations:

- Locally sourced stone
 (within 500K)
- Create a compatible
 relationship with existing
 wall (not competing with)
- Considering returns at windows - deep jambs at this thick wall
- Stone will not be dry laid,
 and will have a mortar bed
 and tooled joint

Cladding Exploration: Full Veneer Stone

Existing 1900's Stone Wall Constructed of Canadian Glacial Erratics

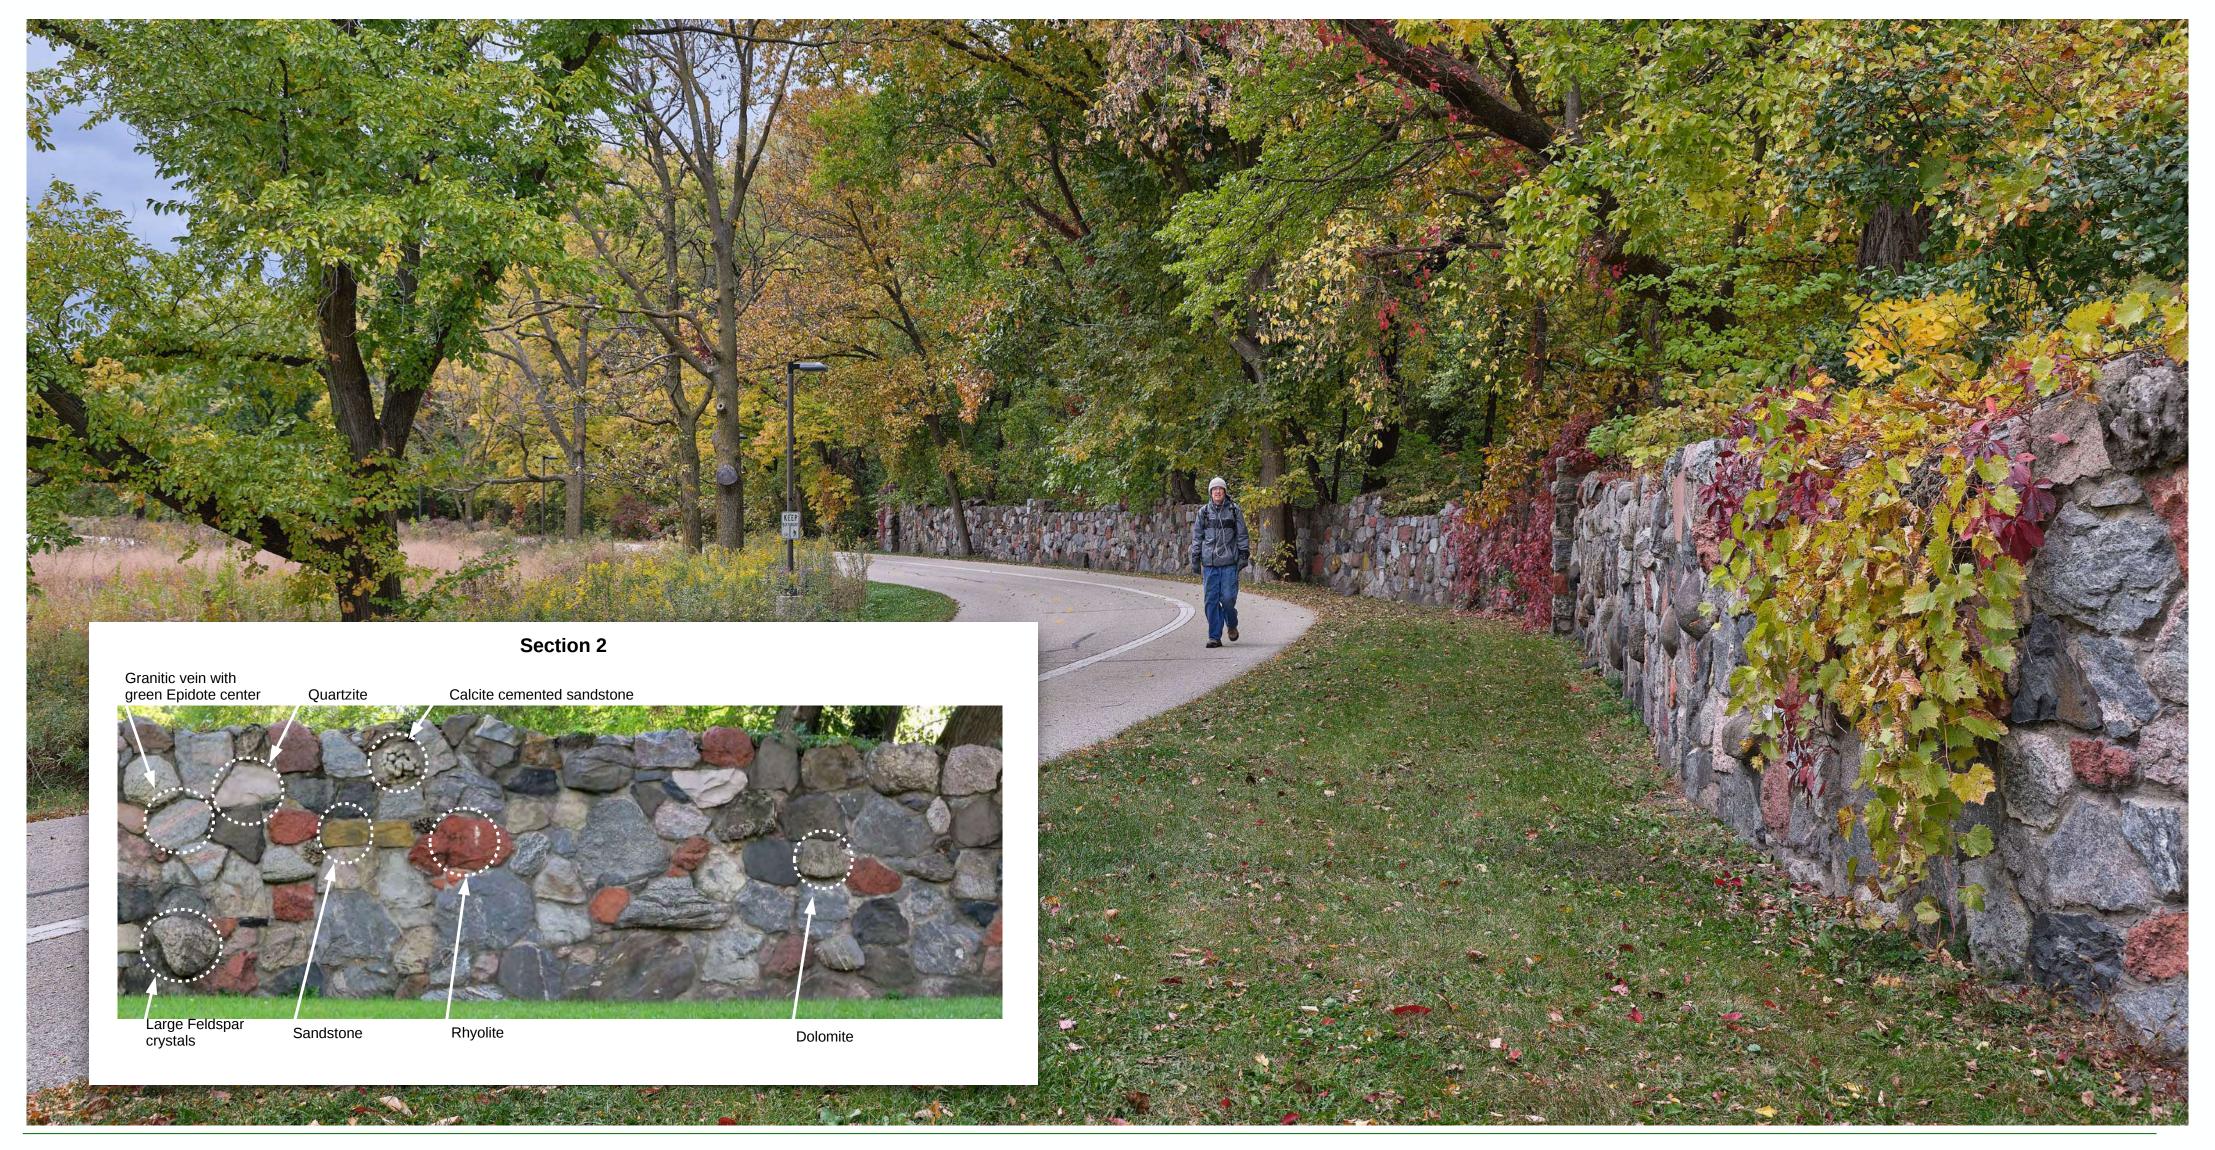

Cladding Exploration: Full Veneer Stone - Pattern Studies



Cladding Exploration: Full Veneer Stone - Pattern Studies Glacial Erratic - Small Scale Pattern



Conceptual Design Response: Frautschi Center

Design Development Update

The Kubala Washatko Architects

Cladding Exploration: Thermally Modified Wood













Conceptual Design Response: Frautschi Center

Design Development Update

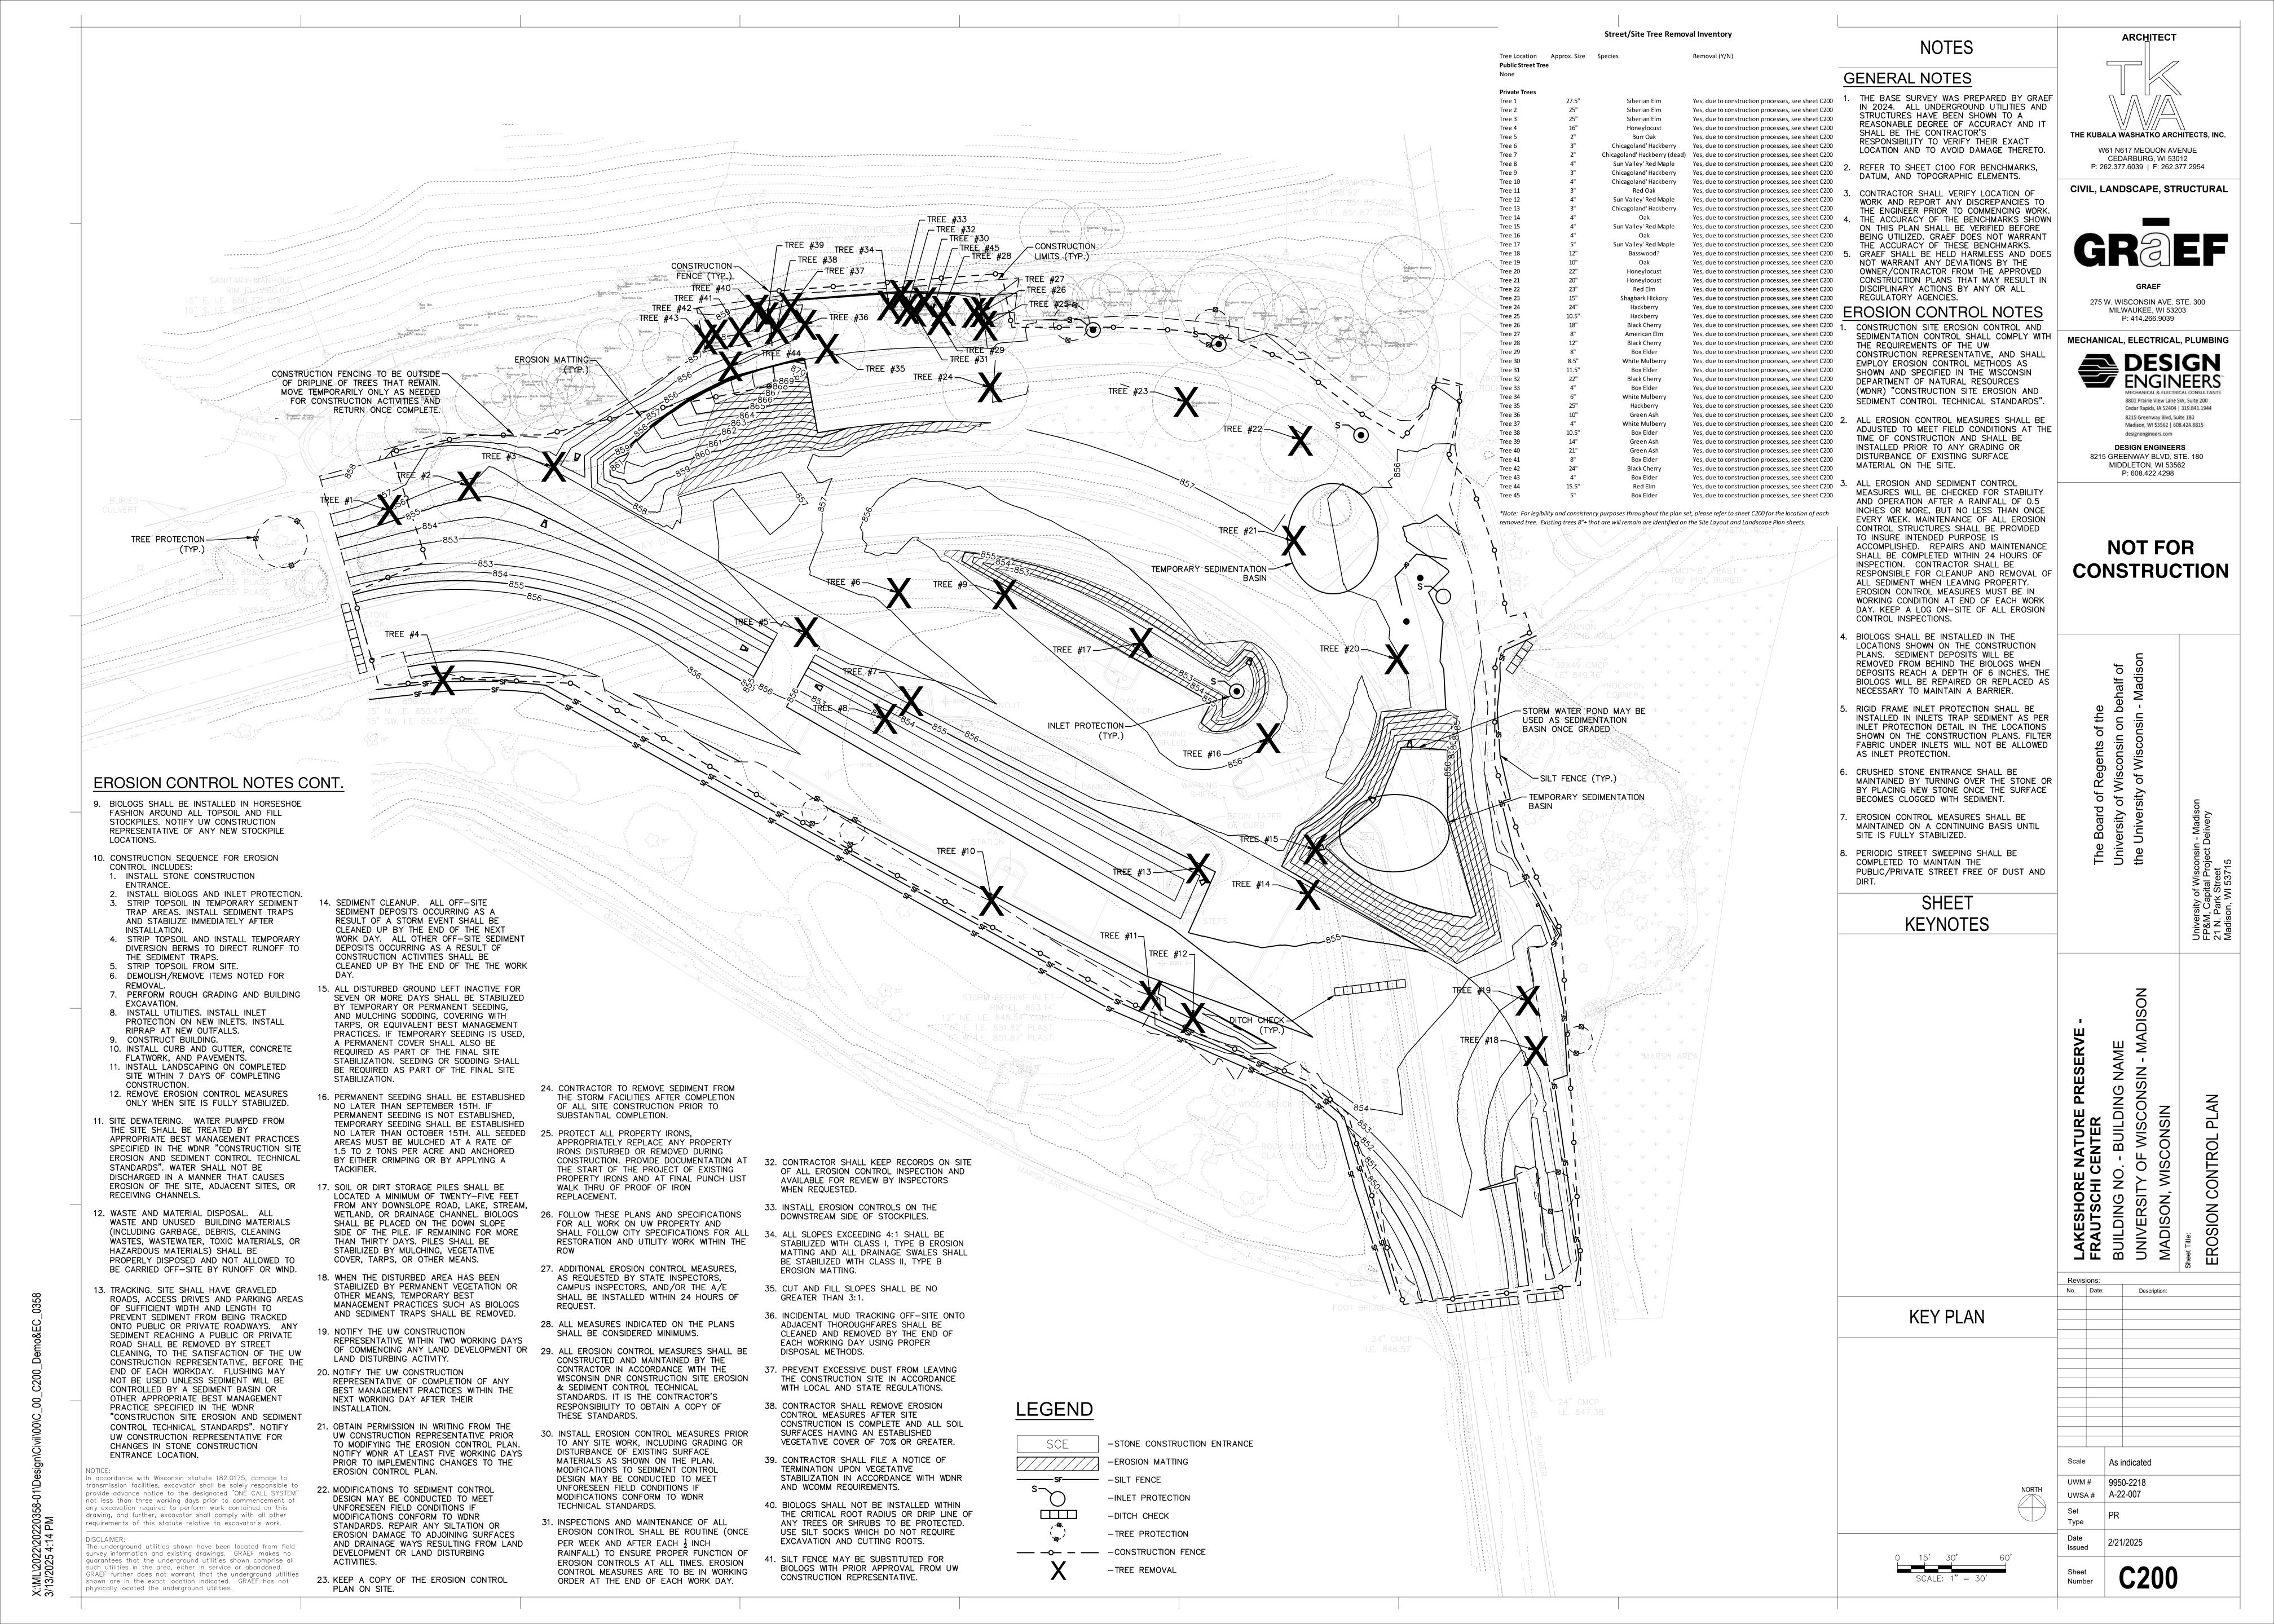



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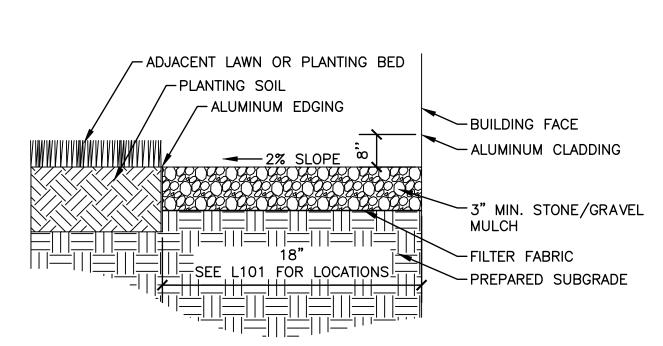
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LANDSCAPING NOTES:

- 1. VERIFY EXISTING AND PROPOSED CONDITIONS, UTILITIES, PIPES, AND STRUCTURES, ETC. PRIOR TO BIDDING AND CONSTRUCTION.
- 2. INSPECT THE SITE PRIOR TO COMMENCING WORK. DOCUMENT IN WRITING AND PHOTOGRAPH EXISTING CONDITIONS WITHIN, AND IN AREAS ADJACENT TO, THE LIMITS OF CONSTRUCTION. PROVIDE DIGITAL COPIES OF PHOTOGRAPHS TO THE LANDSCAPE ARCHITECT. THE LANDSCAPE CONTRACTOR IS RESPONSIBLE FOR ANY DAMAGES NOT DOCUMENTED IN THE SUBMITTAL PRIOR TO COMMENCEMENT OF DEMOLITION ACTIVITIES.
- 3. REFER TO GEOTECHNICAL REPORT FOR INFILTRATION RATES AND SOIL TYPES / CONDITIONS.
- 4. SEE WRITTEN SPECIFICATIONS AND DETAILS FOR PLANTING METHODS, REQUIREMENTS, TOPSOIL TESTING AMENDMENTS, & EXECUTION, PLANT PROTECTION, PLANT STAKING METHODS, PLANT PIT DIMENSIONS, BACKFILL AND OTHER RELATED REQUIREMENTS.
- 5. PLANT PLACEMENT IS REQUIRED AS SHOWN ON THE LAYOUT, PLANTING, AND OTHER DRAWINGS. ENSURE PLANT LAYOUT ADEQUATE FILLS AREAS SHOWN ON LANDSCAPE PLAN. TAKE INTO ACCOUNT PLANT SIZES WILL BE SMALL INITIALLY, BUT WILL FILL THE SPACE AS THEY MATURE. INTENT OF PLANTING DESIGN IS TO REPLICATE NATURAL PLANTINGS.
- 6. DO NOT TIGHTLY CLUMP SMALL PLANT MATERIAL. SPACE AS LAID OUT ON LANDSCAPE PLAN. GENERALLY, SPACE PERENNIALS MIN. OF 2' FROM EACH OTHER, OR AS SHOWN ON PLANS.
- 7. PLANT NAMES ARE ABBREVIATED ON THE DRAWINGS. SEE PLANT LIST FOR SYMBOLS, ABBREVIATIONS, BOTANICAL/COMMON NAMES, SIZES, ESTIMATED QUANTITIES (IF GIVEN) AND OTHER REMARKS.
- 8. MAINTAIN AND WARRANT PLANT MATERIALS AS DESCRIBED IN WRITTEN SPECIFICATIONS.
- 9. PLANT BEDS AND TREE PLANTING PITS ARE TO RECEIVE 3" DEEP LAYER OF SHREDDED HARDWOOD BARK MULCH PER WRITTEN SPECIFICATIONS AND DETAILS.
- 10. FORM 60-INCH, OR AS OTHERWISE INDICATED, WATERING BASIN AROUND TREES NOT INSTALLED IN PAVED AREAS.
- 11. MAINTAIN 60—INCH DIAMETER MINIMUM CLEAR SOIL AREA AROUND ALL TREES IN MANICURED TURF AREAS. MULCH TREE RINGS WITH SPECIFIED DEPTH OF HARDWOOD BARK MULCH. SEE PLANTING DETAILS.
- 12. FINE GRADE, RAKE, AND ENSURE POSITIVE DRAINAGE AWAY FROM STRUCTURES AND THROUGHOUT SITE WITHIN THE LIMITS OF CONSTRUCTION, WITH ACCURATELY SET FLOW LINES. LOW SPOTS OR PONDING OF SURFACE WATER WILL NOT BE ACCEPTED IN THE FINAL WORK. ROCKS OR DEBRIS WILL NOT BE ACCEPTED. FINAL GRADE TOLERANCES ARE +/-0.1 FOOT MAXIMUM.
- 13. WHERE PROVIDED, AREA TAKEOFFS AND PLANT QUANTITY ESTIMATES ARE FOR INFORMATION ONLY. LANDSCAPE CONTRACTOR IS RESPONSIBLE TO CONDUCT QUANTITY TAKE—OFFS FOR PLANT MATERIALS AND SIZES SHOWN ON PLANS. PLANT SYMBOLS INDICATED ON THE PLAN TAKE PRECEDENCE IN CASE OF DISCREPANCIES BETWEEN CALLOUTS AND THE PLANT LIST.
- 14. COORDINATE THE INSTALLATION OF PLANT MATERIAL WITH INSTALLATION OF ADJACENT PAVEMENTS, DRAINAGE, CURB AND RELATED STRUCTURES WITH OTHER TRADES.
- 15. RESTORE AREAS OF THE SITE, OR ADJACENT AREAS, WHERE DISTURBED. DAMAGE CAUSED DURING LANDSCAPE INSTALLATION TO EXISTING CONDITIONS AND IMPROVEMENTS IS THE RESPONSIBILITY OF THE LANDSCAPE CONTRACTOR.
- 16. FOLLOWING TESTING & ANALYSIS OF TOPSOIL, INCORPORATION OF RECOMMENDED AMENDMENTS, AND TOPSOIL PLACEMENT, ALL PLANT BED AREAS SHALL BE PREPARED AS DESCRIBED IN WRITTEN SPECIFICATIONS.
- 17. TAKE NECESSARY SCHEDULING AND OTHER PRECAUTIONS TO AVOID WINTER, CLIMATIC, OR OTHER DAMAGE TO PLANTS.
- 18. PLANTING BEDS ARE TO BE SEPARATED FROM ADJACENT TURF AREAS WITH SHOVEL CUT EDGING. INSTALL AT LOCATIONS INDICATED ON DRAWINGS AND PER LANDSCAPE DETAILS.
- 19. SEPARATE PLANTING BEDS AND STONE MULCH MAINTENANCE STRIP WITH 3/16" X 4" BLACK ALUMINUM EDGING

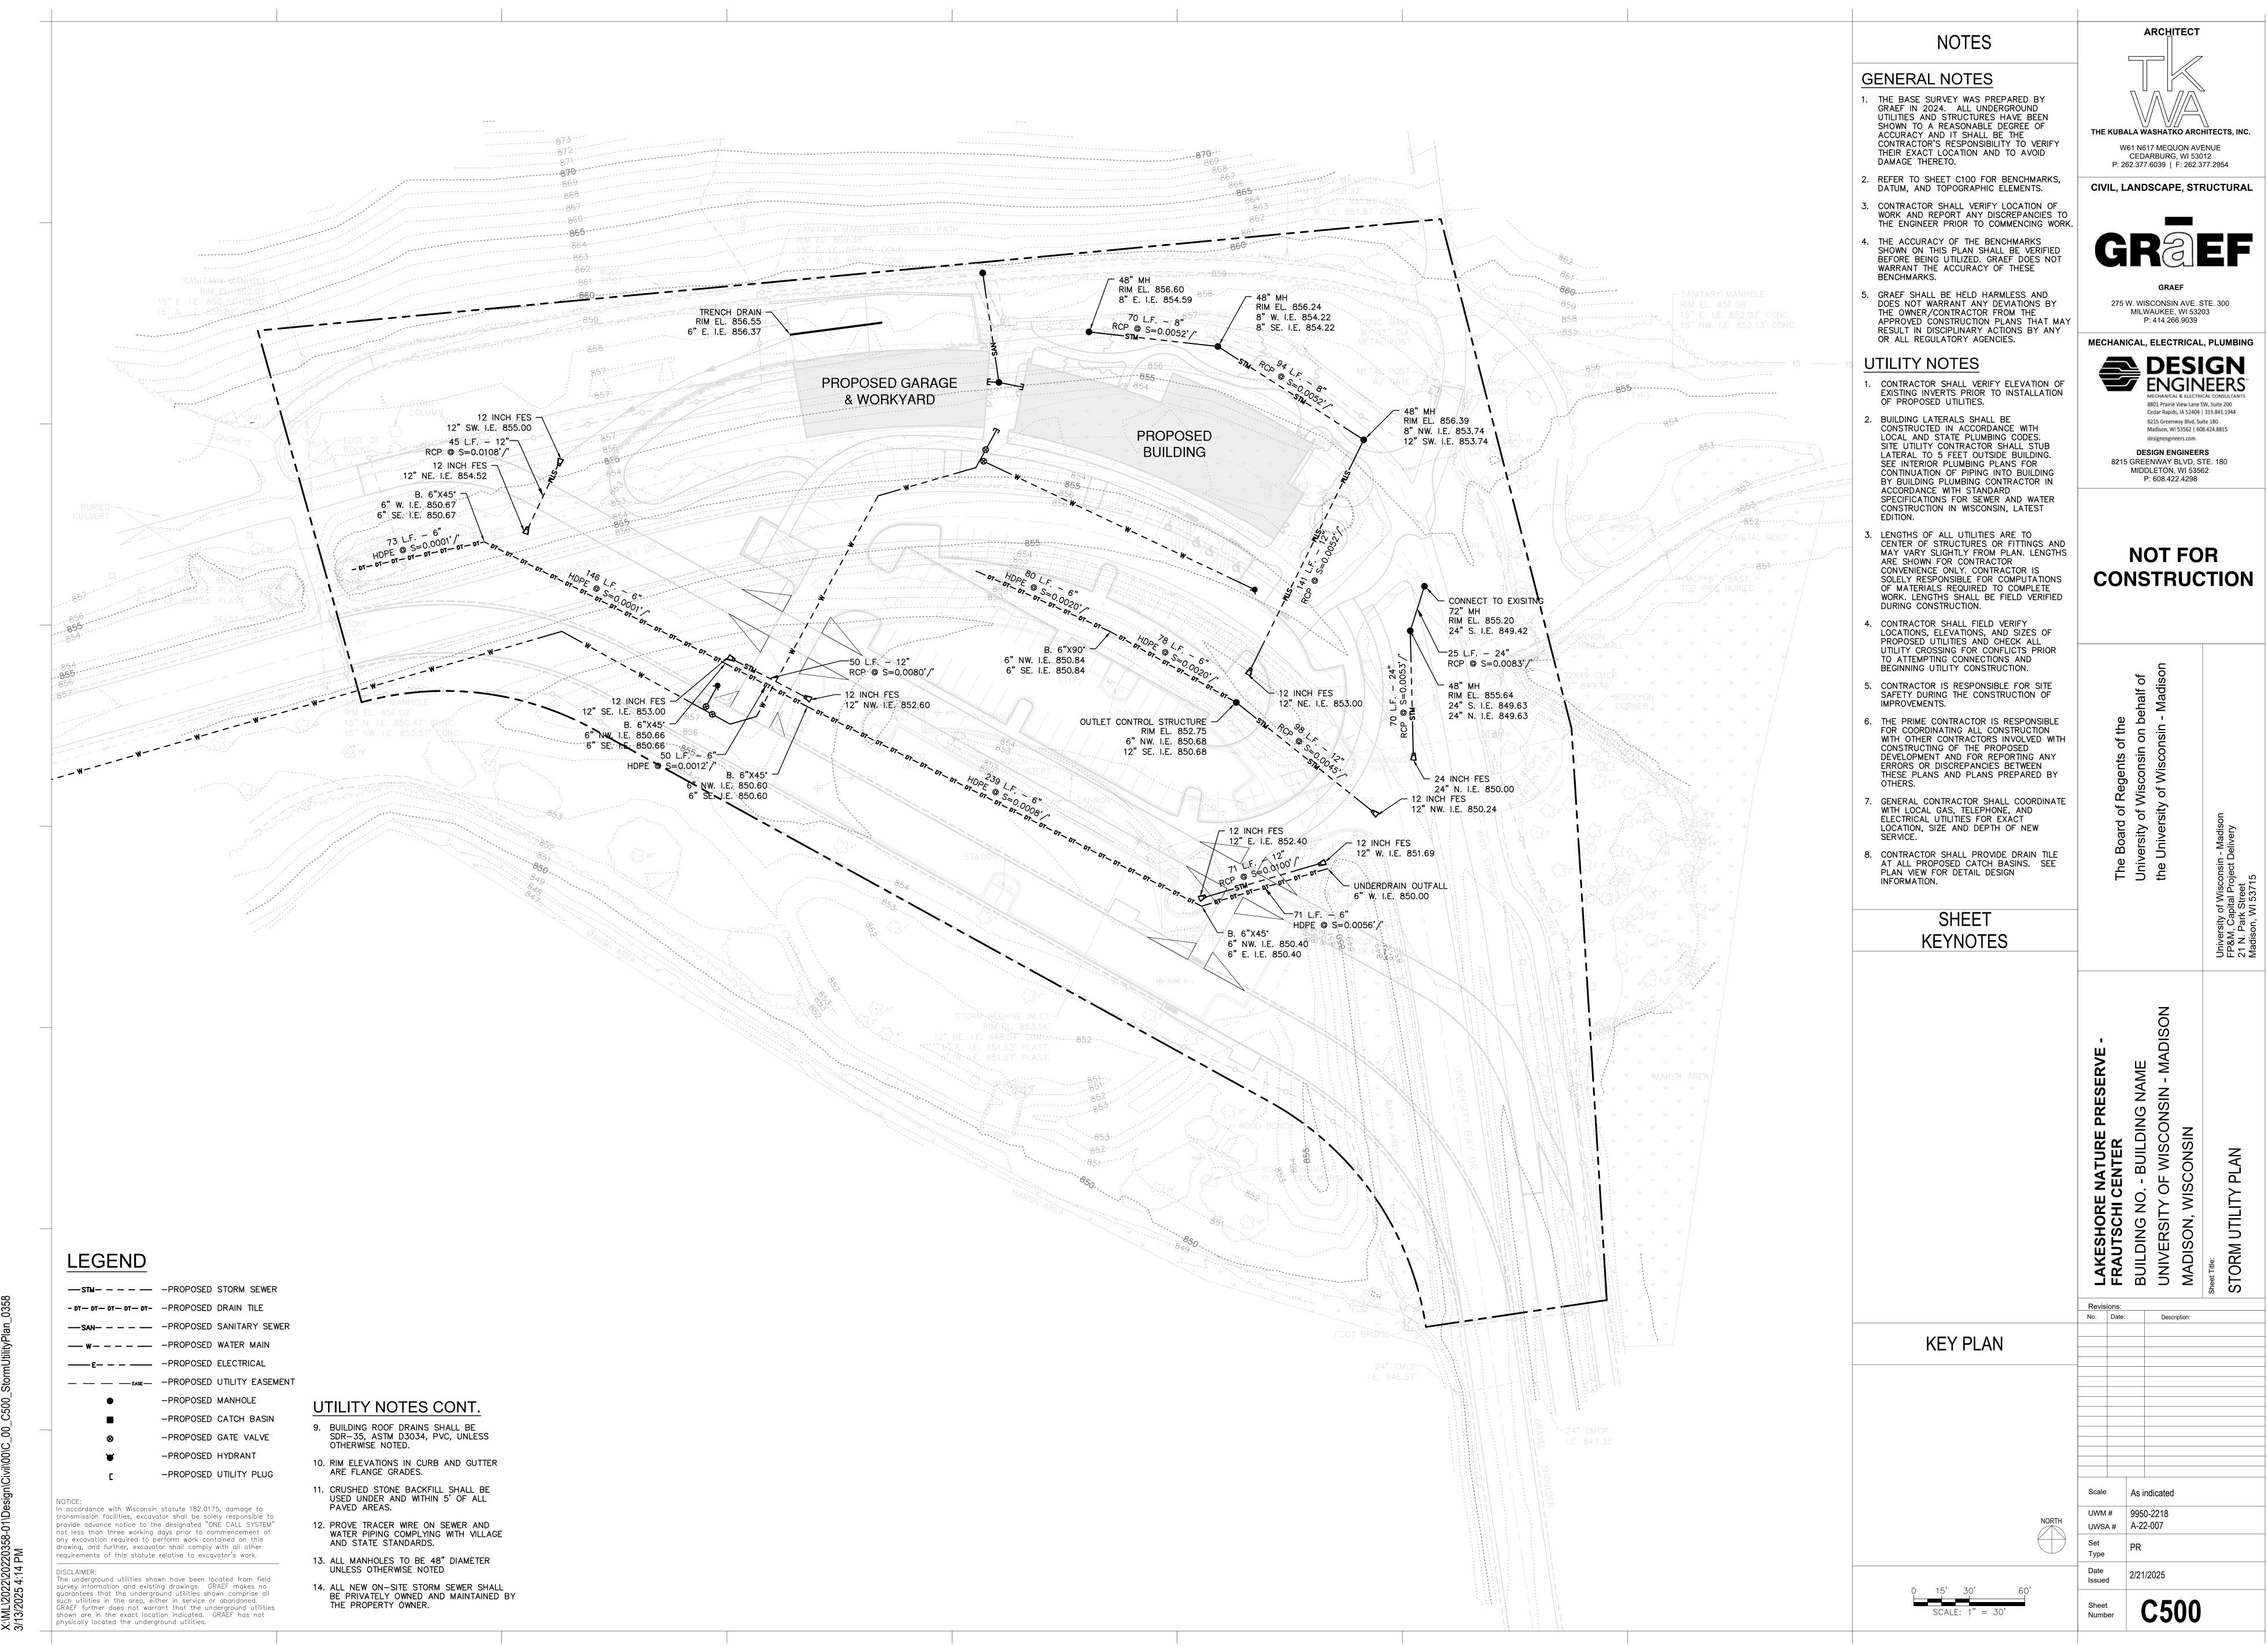
ANCHORED WITH MIN. 15" LONG STAKES AT 5' ON CENTER. SEE SHEET L101 FOR LOCATIONS.

- 20. PLANT SUBSTITUTIONS WILL NOT BE PERMITTED UNLESS THE LANDSCAPE CONTRACTOR CAN DEMONSTRATE THE PLANTS ARE NOT AVAILABLE FROM NURSERY SOURCES LOCATED WITHIN 100 MILES FROM THE PROJECT SITE. ANY PROPOSED PLANT SUBSTITUTION WILL REQUIRE PRIOR REVIEW AND WRITTEN ACCEPTANCE BY THE LANDSCAPE ARCHITECT.
- 21. CONTRACTOR SHALL DETERMINE THE NEED FOR TREE STAKING. IF DETERMINED NECESSARY, PROVIDE TREE STAKING AS DESCRIBED IN WRITTEN SPECIFICATIONS.

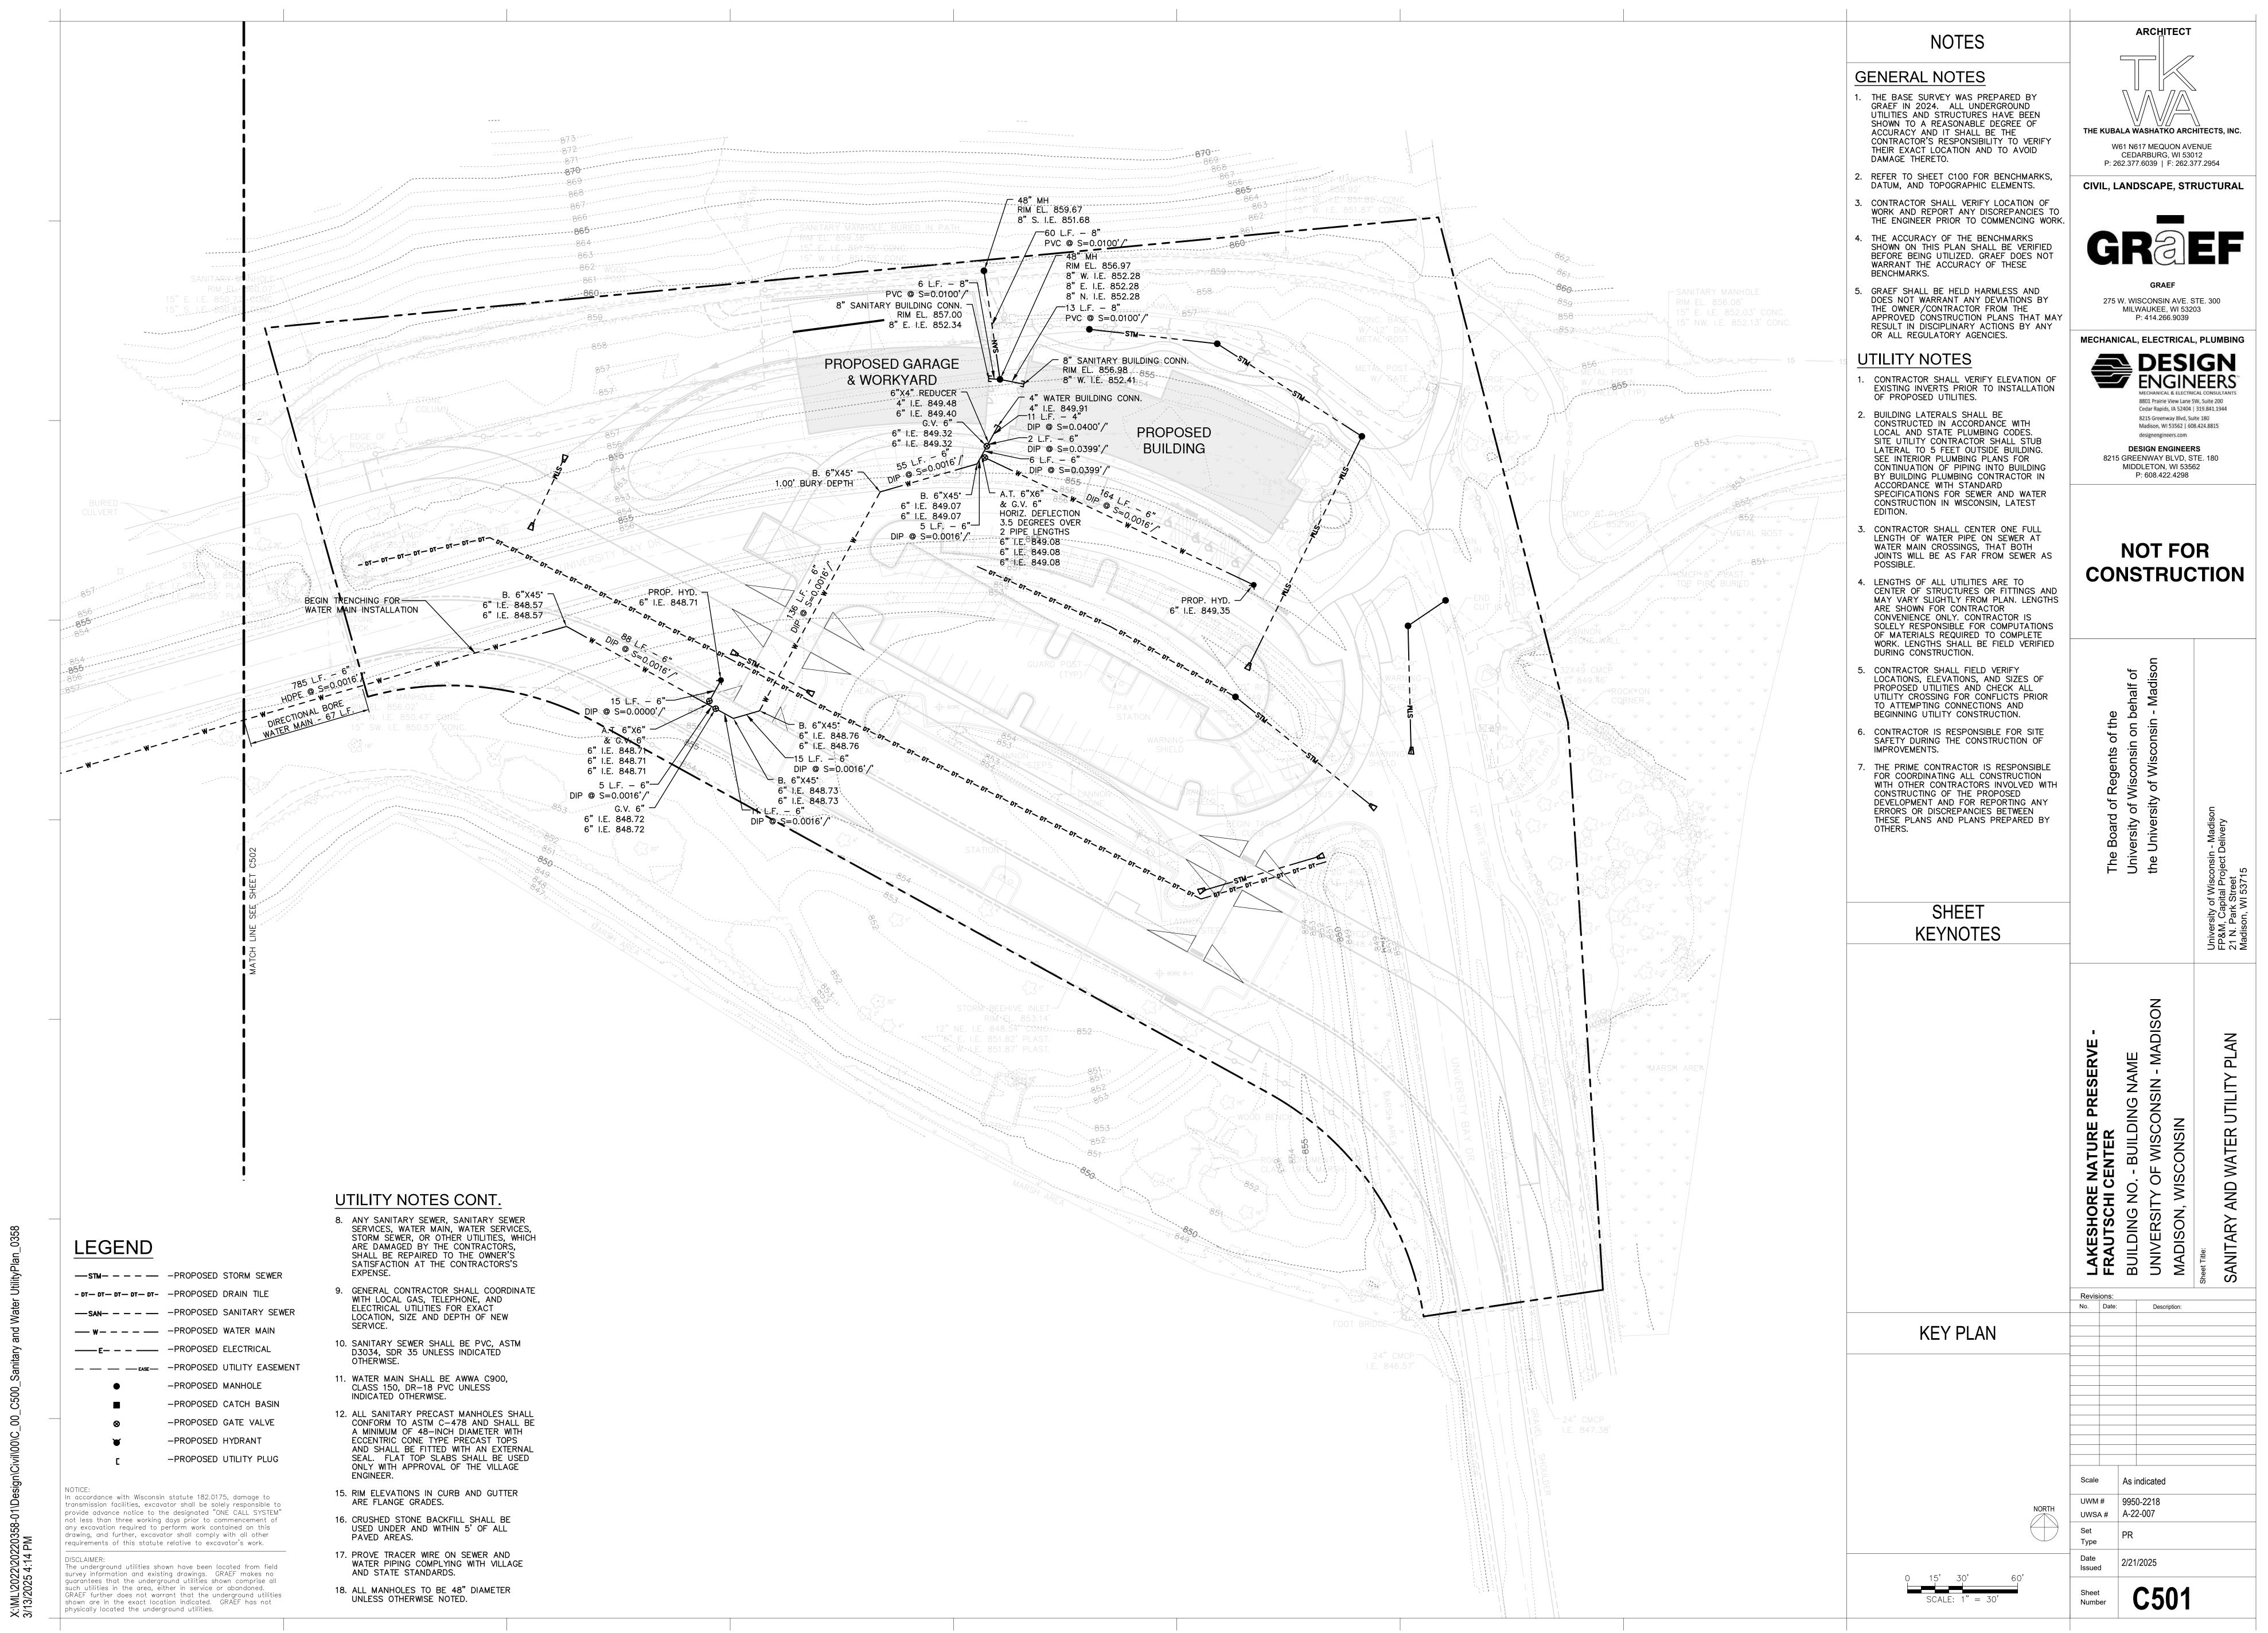


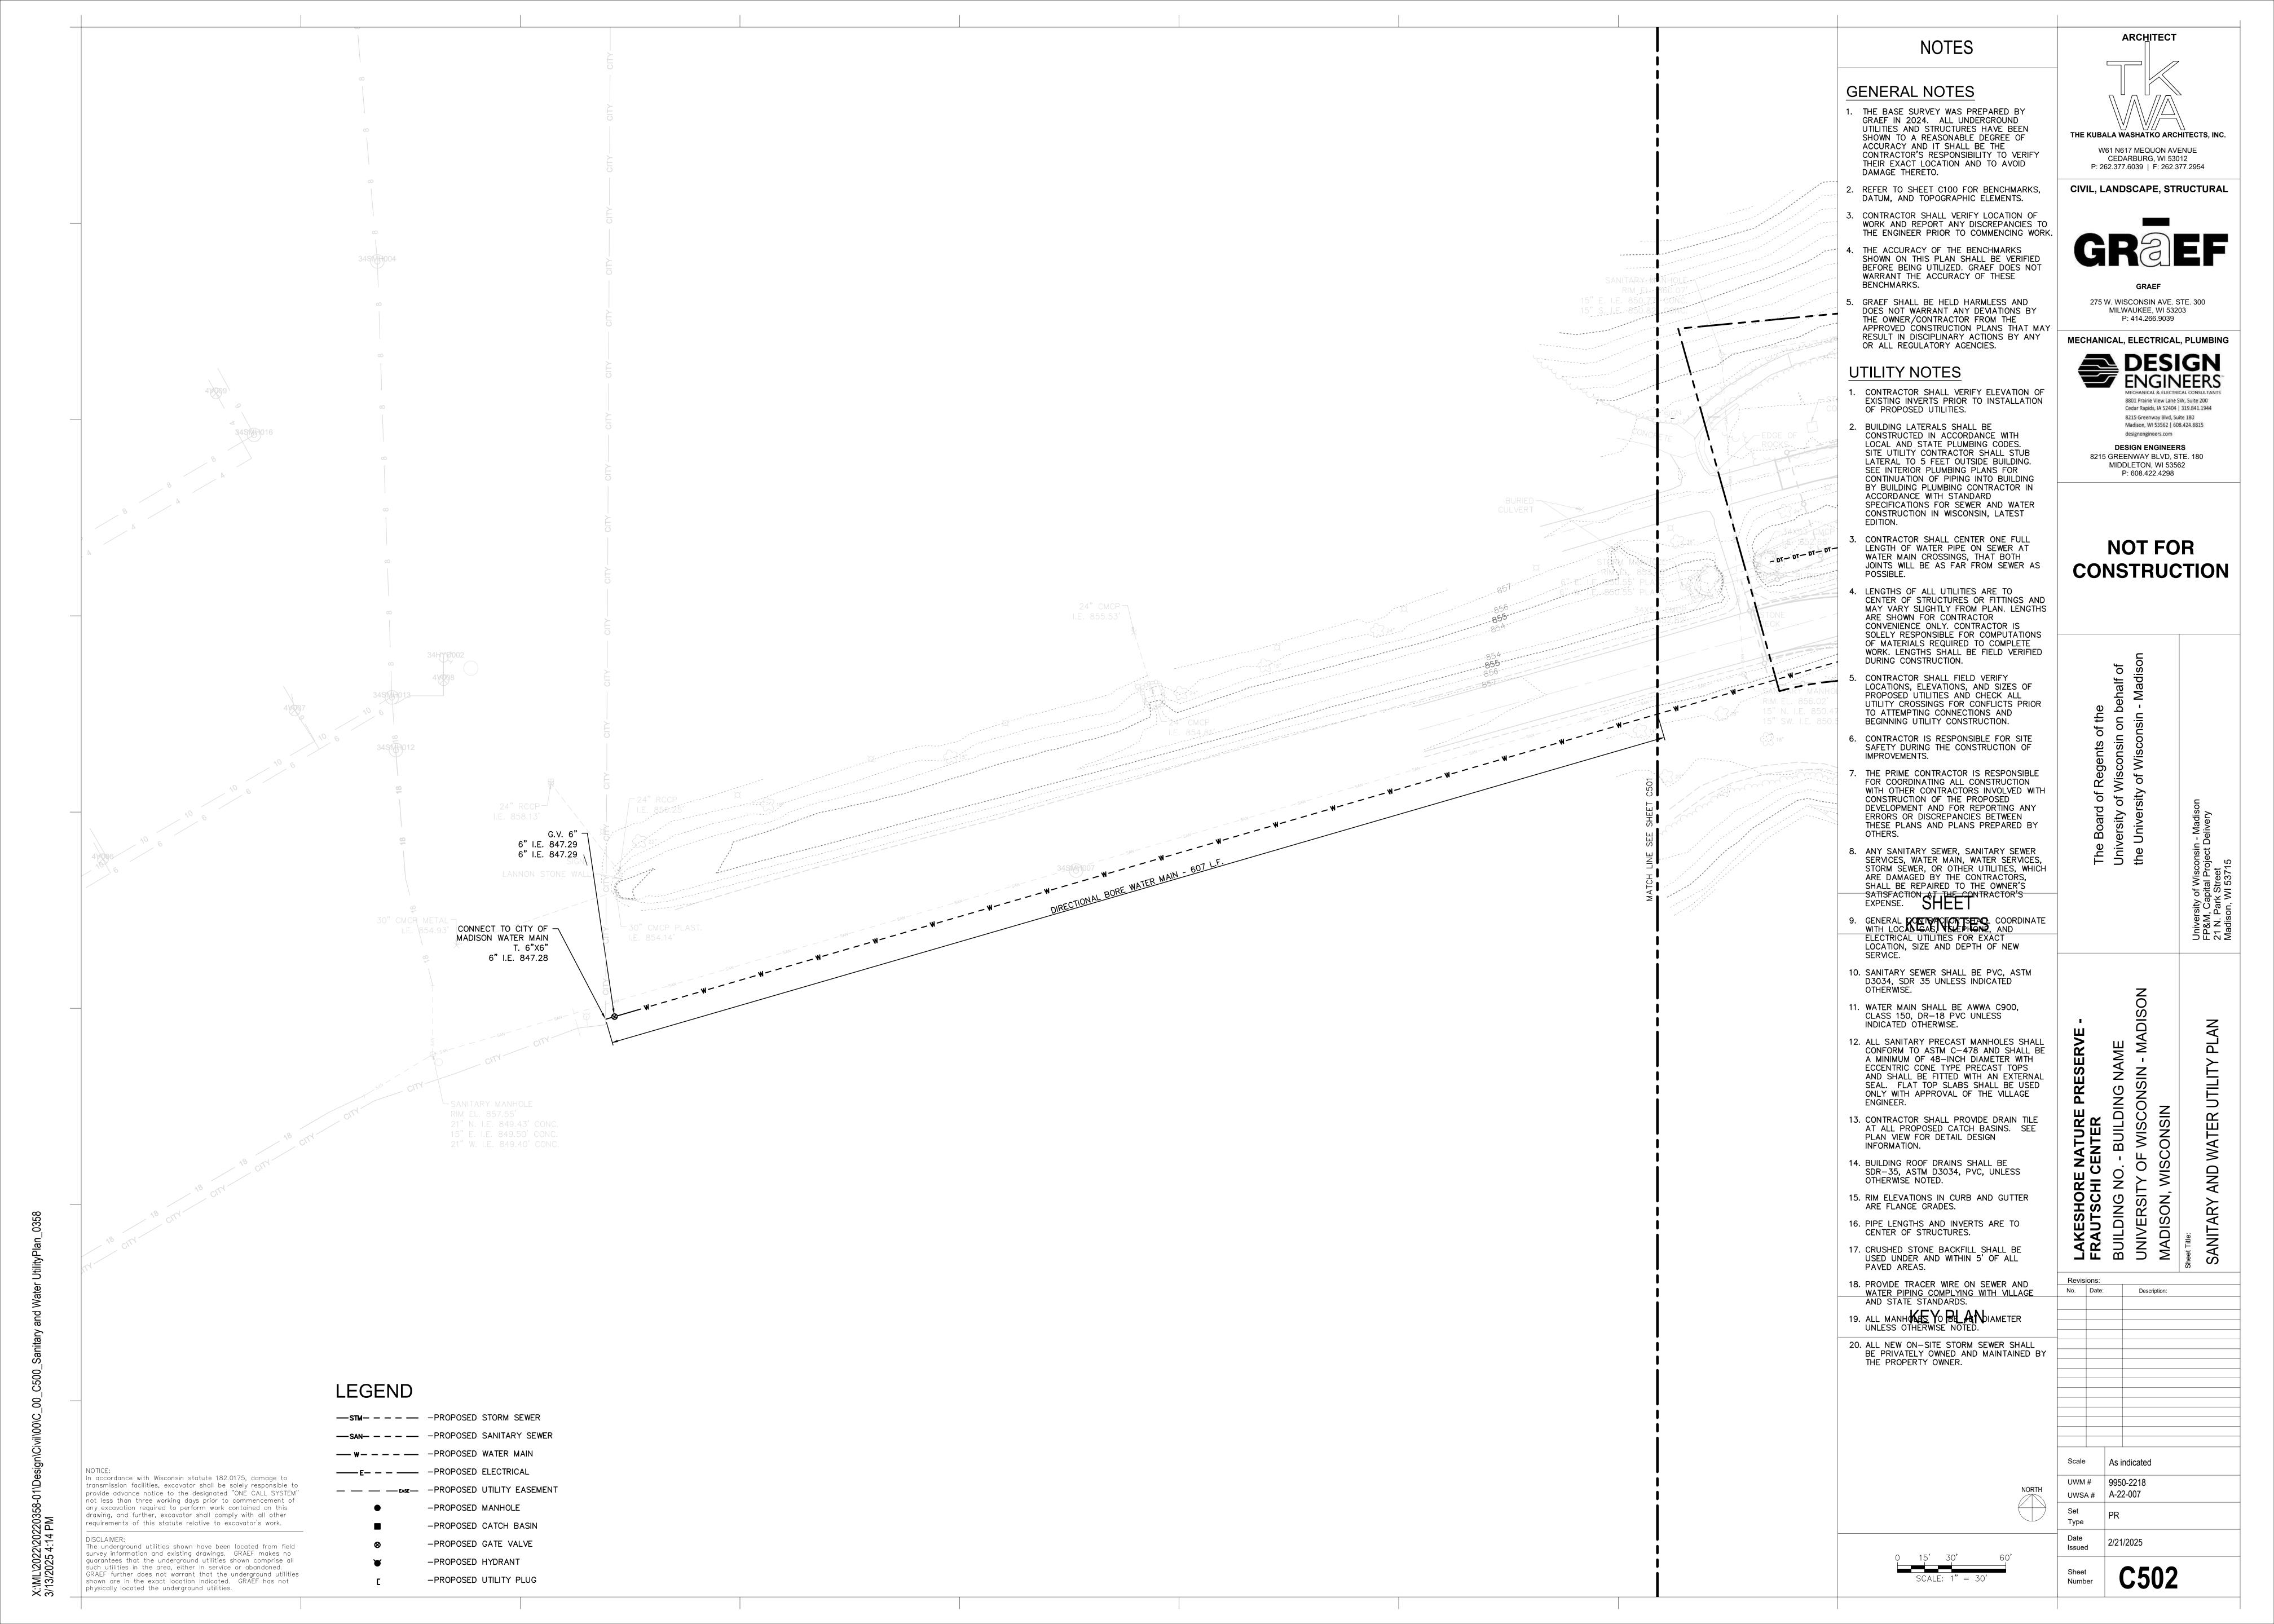9 STONE/GRAVEL MULCH MAINTENANCE STRIP


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4 LARGE CONTAINER PLANTING DETAIL

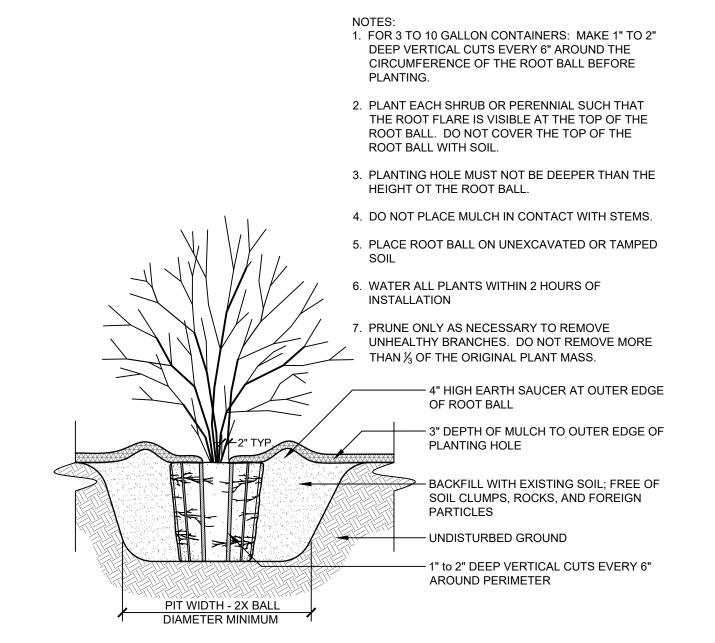

5 MULTISTEM TREE PLANTING WITH MULCH RING
SCALE: NOT TO SCALE

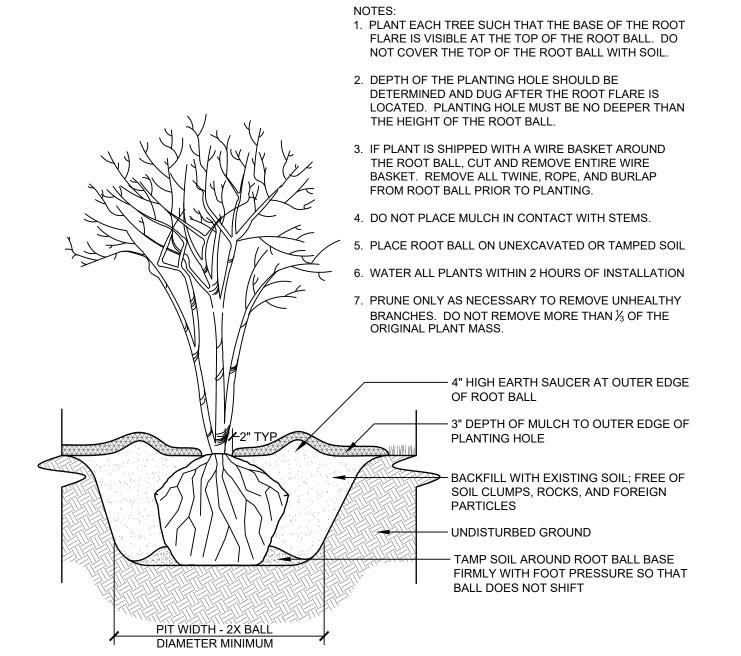


-TOPSOIL SHALL CONFORM TO PROPERTIES AS SPECIFIED.

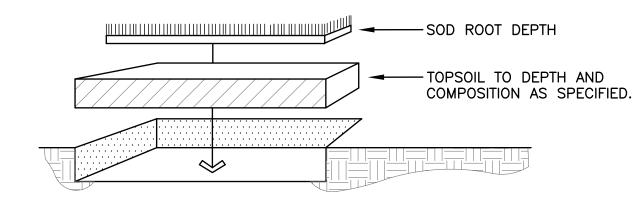-CONTRACTOR TO PROVIDE FINISHED TURF GRADE PER DRAWINGS WITH UNIFORM, NATURAL SLOPES PRIOR TO LAYING SOD. SOD BLEND & APPLICATION PROCEDURES ARE DESCRIBED IN WRITTEN SPECIFICATION

-LAY SOD IN 'RUNNING BOND' FASHION (W/ALTERNATE JOINTS), COMPRESS EACH BUTT JOINT TO REDUCE SHRINKAGE CRACKS. ANCHOR SOD APPLICATIONS ON SLOPES GREATER THAN 1:3 PER WRITTEN SPECIFICATIONS.

-LANDSCAPE CONTRACTOR SHALL ESTABLISH VIGOROUS GROWTH AND MOW & MAINTAIN AS SPECIFIED.


MANICURED TURF SOD

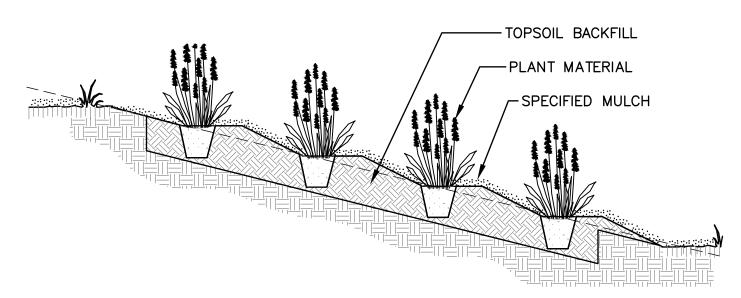

LAYOUT PLANT MATERIAL AT SPACING AS SHOWN PER PLANT MATERIALS SCHEDULE.
PLANT FOLLOWING SAME PROCESS AS TYPICAL PLANTING DETAILS
HAND BROADCAST UNIFORM 3" HARDWOOD MULCH THROUGHOUT PLANTING BED.


-FLOOD IMMEDIATELY & WATER FREQUENTLY.

PLANTING ON SLOPE DETAIL

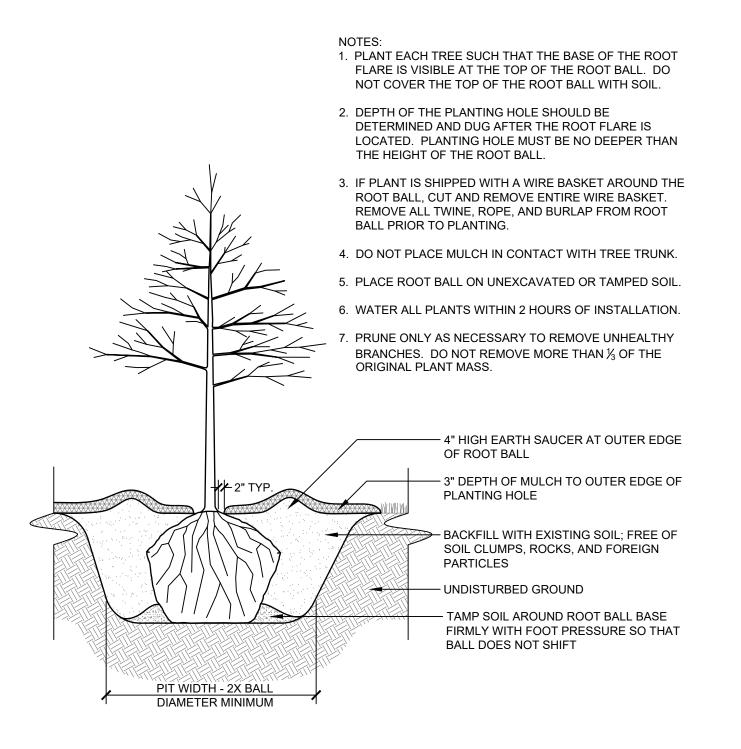


DECIDUOUS TREE PLANTING WITH MULCH RING

SCALE: NOT TO SCALE

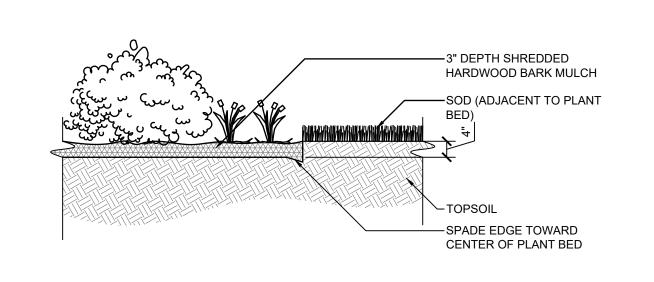

SHOVEL CUT PLANTING BED EDGE DETAIL

SCALE: NOT TO SCALE

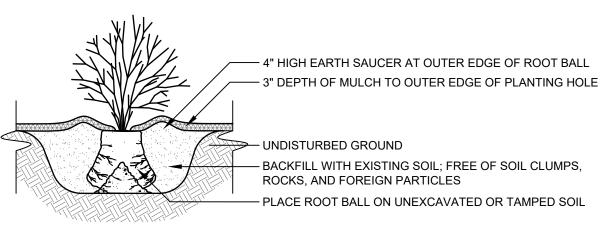

NOTES: 1. FOR 1 TO 2 GALLON CONTAINERS: BUTTERFLY ROOT BALL. SEVER LOWER $\frac{1}{3}$ TO $\frac{1}{2}$ OF ROOT BALL WITH A SINGLE CUT. SPREAD OPEN SEVERED ROOT BALL AND PLACE AGAINST BOTTOM OF THE MOUNDED PLANTING HOLE.


2. PLANT EACH SHRUB OR PERENNIAL SUCH THAT THE STEM FLARE IS VISIBLE AT THE TOP OF THE ROOT BALL. DO NOT COVER THE TOP OF THE ROOT BALL WITH SOIL.

- 3. PLANTING HOLE MUST BE NO DEEPER THAN THE HEIGHT OF THE ROOT BALL.
- 4. DO NOT PLACE MULCH IN CONTACT WITH STEMS.

 7. WATER ALL PLANTS WITHIN 2 HOLIRS OF INSTALLATION
- 7. WATER ALL PLANTS WITHIN 2 HOURS OF INSTALLATION.
- 8. PRUNE ONLY AS NECESSARY TO REMOVE UNHEALTHY BRANCHES. DO NOT REMOVE MORE THAN 1/3 OF THE ORIGINAL PLANT MASS.

SMALL CONTAINER PLANTING DETAIL

SCALE: NOT TO SCALE

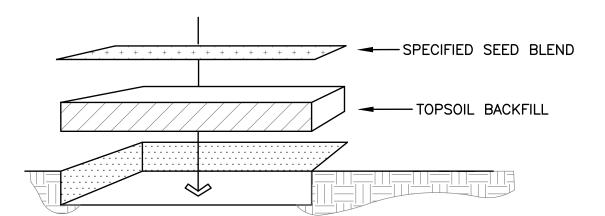

-CONTRACTOR TO PROVIDE FINISHED TURF GRADE PER DRAWINGS WITH UNIFORM, NATURAL SLOPES PRIOR TO THE SOWING OF SEED.
-INSTALL AT LOCATIONS SHOWN ON DRAWINGS AND MAINTAIN AS SPECIFIED

PRAIRIE / WILDFLOWER SEEDING



CIVIL, LANDSCAPE, STRUCTURAL



275 W. WISCONSIN AVE. STE. 300 MILWAUKEE, WI 53203 P: 414.266.9039

MECHANICAL, ELECTRICAL, PLUMBING



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P: 608.422.4298

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The Board of Regents of the University of Wisconsin on behalf the University of Wisconsin - Mac

CONSIN - MADISON

University

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MADISON, WISCONSIN
Sheet Title:

LANDSCAPE NOTES AND

Revisions:

No. Date: Description:

Scale

As indicated

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UWM # 9950-2218


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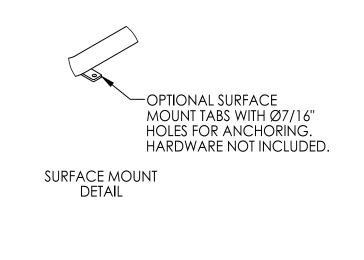
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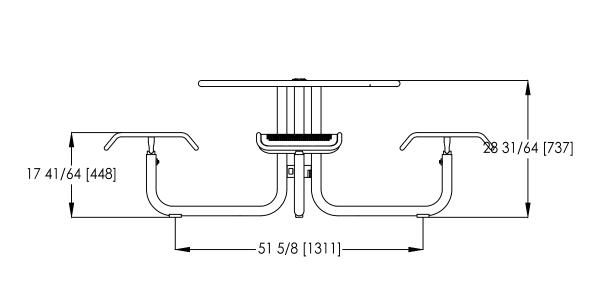
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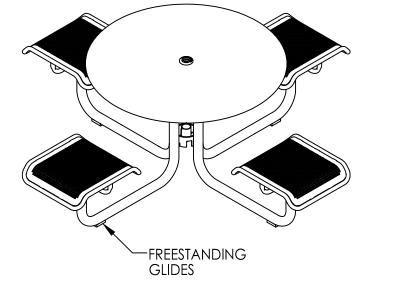
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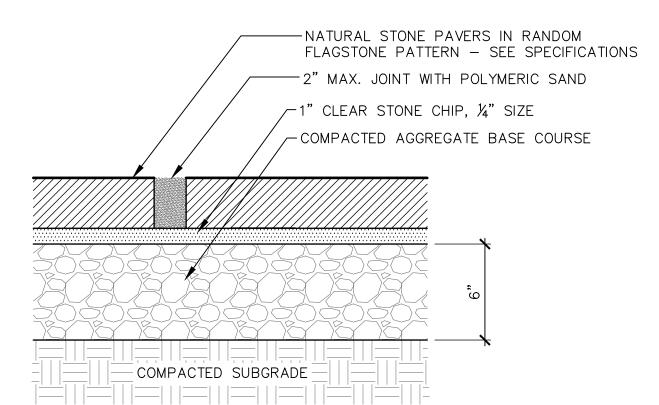








CAROUSEL BENCH - CAMPUS STANDARD


MFG: LANDSCAPE FORMS

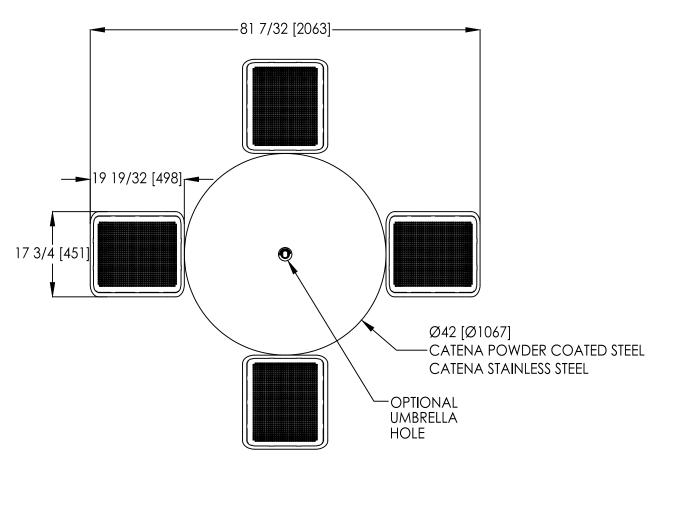


TYPICAL SECTION - NATURAL STONE PAVING OVER AGGREGATE BASE

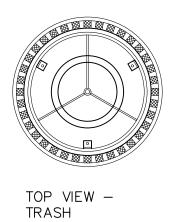

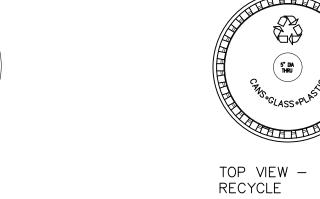

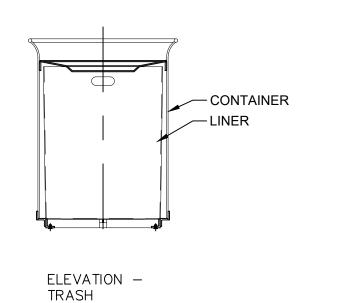

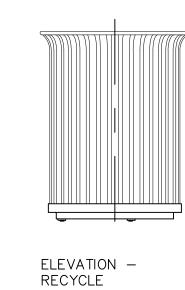


NOTES:

- SURFACE-MOUNT RECEPTACLES TO CONCRETE WITH GALVANIZED BOLTS AND SLEEVES, AND ACCORDING TO
- MANUFACTURER'S SPECIFICATIONS.
 2. SEE LANDSCAPE PLAN FOR LOCATIONS.

TRASH AND RECYCLING RECEPTACLES

SCALE: NOT TO SCALE

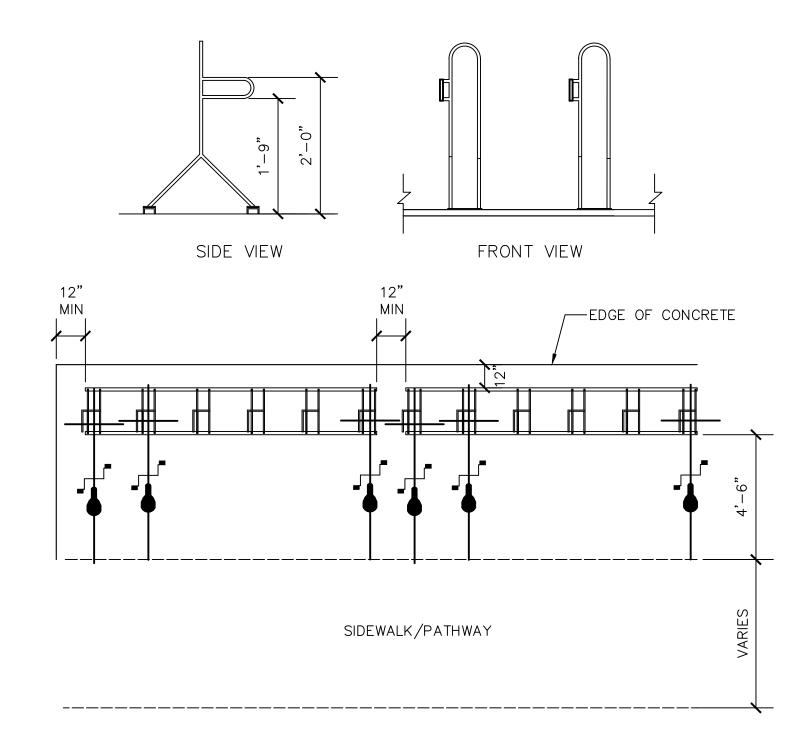

DUCK BILL BIKE RACK LAYOUT

NOTE

- Surface-mount bike racks to concrete with galvanized bolts and sleeves, and according to manufacturer's specifications.
- and sleeves, and according to manufacturer's specification
 2. See Landscape Plan for locations and quantities.
 3. Direct any layout and quantity questions to Rob Kennedy (608.263.1034) and Chuck Strawser (608.263.2969).

TYPICAL BIKE RACK LAYOUT

SCALE: NOT TO SCALE

THE KUBALA WASHATKO ARCHITECTS, INC.

W61 N617 MEQUON AVENUE
CEDARBURG, WI 53012
P: 262.377.6039 | F: 262.377.2954

CIVIL, LANDSCAPE, STRUCTURAL

GRAEF

GRAEF

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KESHORE NATURE PRESERVE AUTSCHI CENTER
IILDING NO. - BUILDING NAME
IIVERSITY OF WISCONSIN - MADISON
ADISON, WISCONSIN

Revisions:

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Scale As indicated

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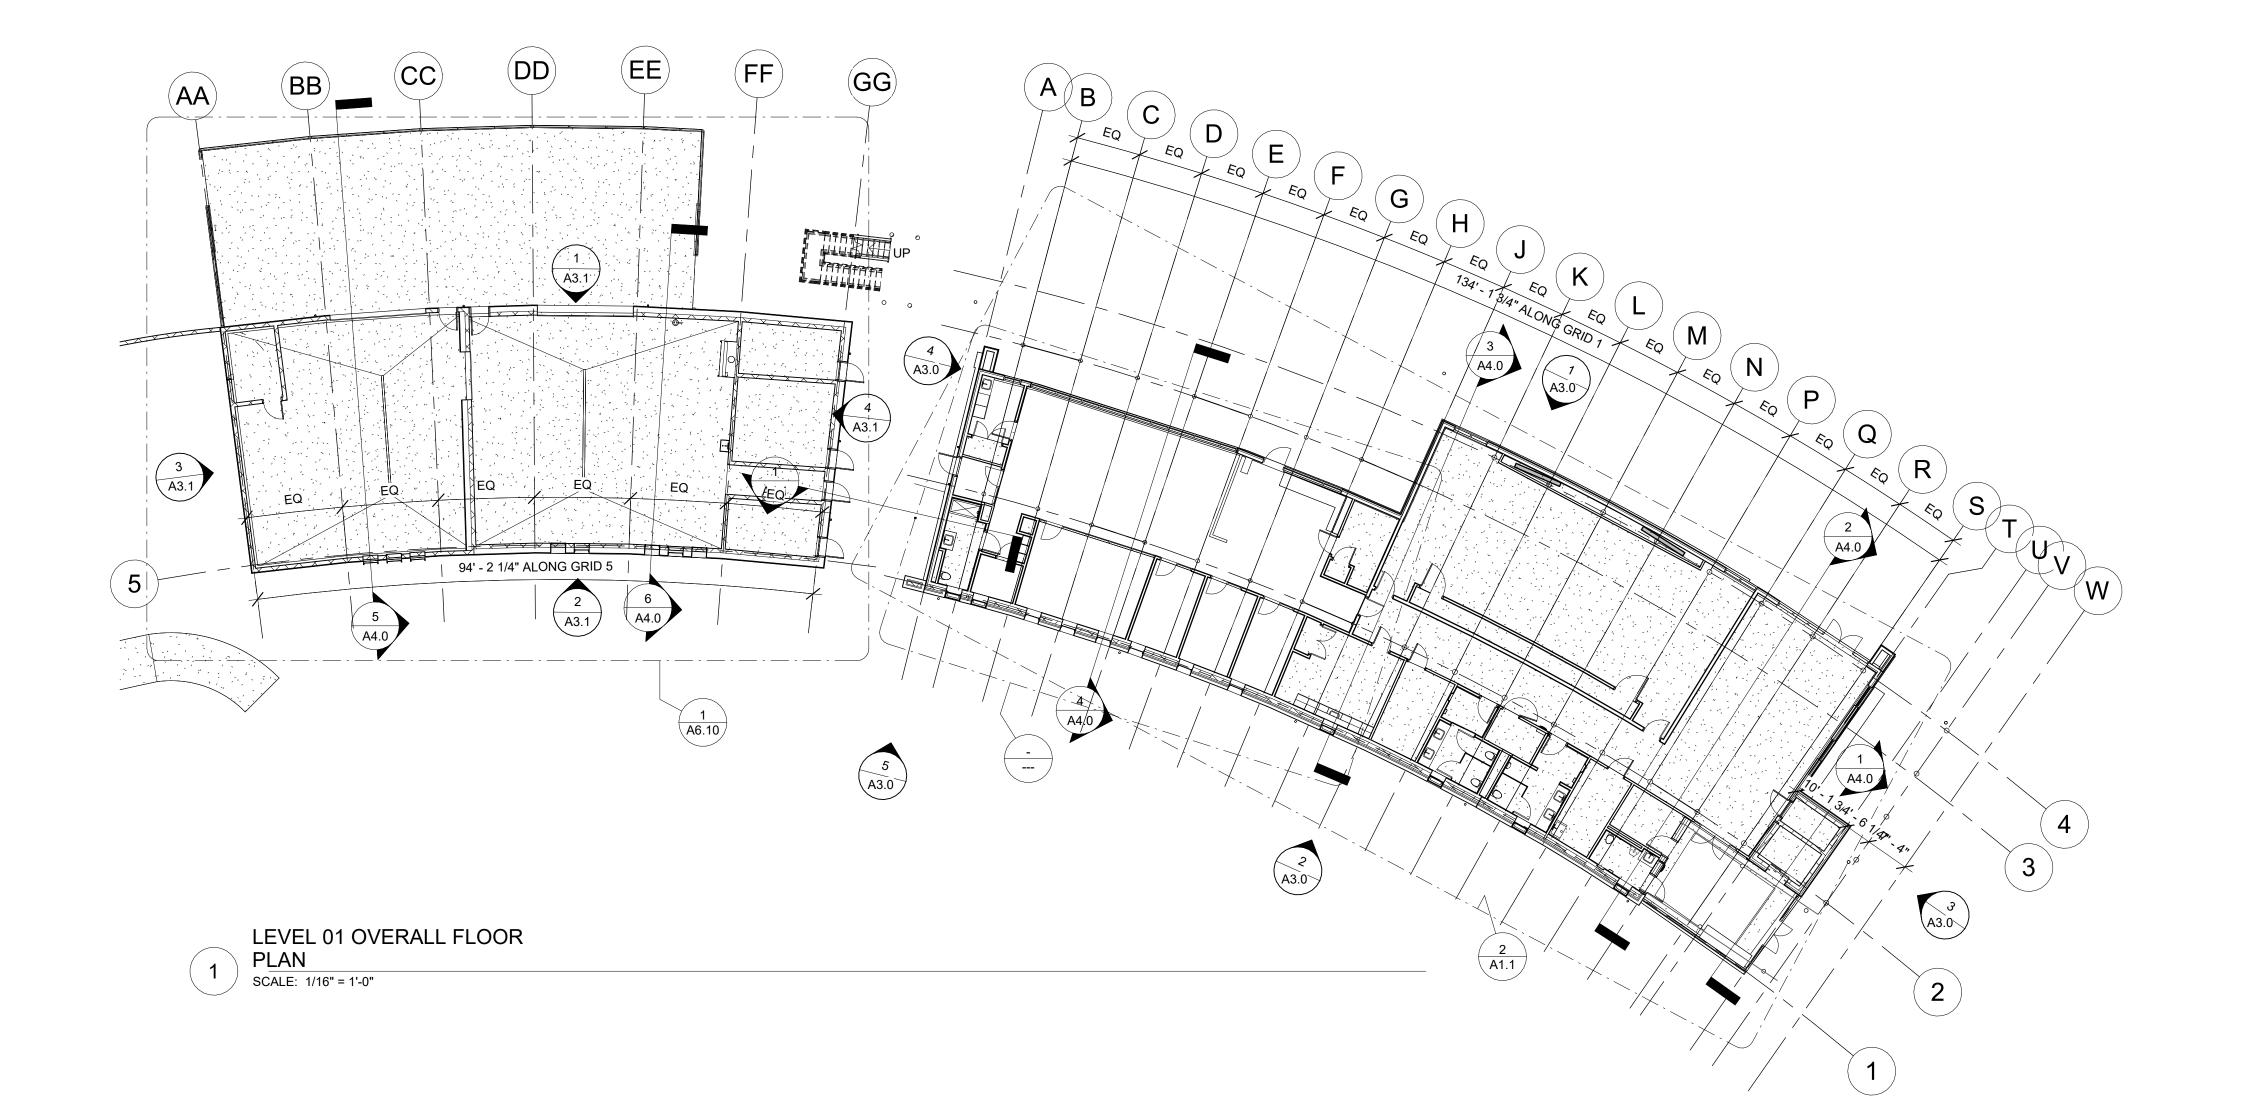
UWM # 9950-2218

UWSA # A-22-007

Set Type PR

Date | 2/21/2025

Sheet Number L901



1. BEFORE BEGINNING WORK AT THE SITE & THROUGH THE COURSE OF THE WORK, INSPECT & VERIFY THE LOCATION & CONDITION OF EVERY ITEM AFFECTED BY THE WORK UNDER THIS CONTRACT & REPORT DISCREPANCIES TO THE ARCHITECT BEFORE BEGINNING WORK RELATED TO THAT BEING INSPECTED.

2. BEFORE BEGINNING WORK AT THE SITE, CONTRACTOR SHALL INSPECT THE EXISTING BUILDING & DETERMINE THE EXTENT OF EXISTING FINISHES, SPECIALTIES, EQUIPMENT & OTHER ITEMS WHICH MUST BE REMOVED AND REINSTALLED IN ORDER TO PERFORM THE WORK UNDER THIS CONTRACT.

3. THE DRAWINGS SHOW PRINCIPAL AREAS WHERE WORK MUST BE ACCOMPLISHED UNDER THIS CONTRACT. INCIDENTAL WORK MAY ALSO BE NECESSARY IN AREAS NOT SHOWN. SUCH INCIDENTAL WORK IS ALSO PART OF THIS CONTRACT (INCLUDING REMOVAL & INSTALLATION). INSPECT THOSE AREAS & ASCERTAIN WORK NEEDED & DO THAT WORK IN ACCORDANCE W/ THE CONTRACT REQUIREMENTS, AT NO ADDITIONAL COST.

4. PROTECT EXISTING CONDITIONS TO REMAIN FROM DAMAGE. DAMAGE TO EXISTING CONDITIONS ARE TO BE REPAIRED AND/OR REPLACED AT NO ADDITIONAL COST TO THE OWNER.

5. REPAIR, PATCH, & FINISH, OR REFINISH AS APPLICABLE, TO MATCH ADJACENT EXISTING FINISHES, THOSE SURFACES DAMAGED OR NEWLY EXPOSED DURING THE PERFORMANCE OF THE WORK UNDER THIS CONTRACT.

6. WHERE MATCH EXISTING IS INDICATED, NEW CONSTRUCTION OR FINISHES, AS APPROPRIATE TO THE NOTE, SHALL MATCH EXISTING IN EVERY PARTICULAR.

7. WORK SHOWN IS NEW UNLESS SPECIFICALLY NOTED OR OTHERWISE INDICATED. ALL MATERIAL QUANTITIES, LOCATIONS, & TYPE TO BE COORDINATED W/ ARCHITECT PRIOR TO FABRICATION/INSTALLATION.

8. CONTRACTOR RESPONSIBLE FOR FIELD VERIFICATION & COORDINATION OF ALL ITEMS, DIMENSIONS, CONDITIONS, & QUANTITIES, ETC.

9. ALL INTERIOR SPACES ARE TO BE PROTECTED FROM DAMAGE, DEBRIS, DUST & MISCELLANEOUS CONSTRUCTION MATERIALS. CONTRACTOR RESPONSIBLE FOR ANY ADDITIONAL CLEANING MATERIAL & SERVICES REQUIRED.

10. PATCH ADJACENT SURFACES AFFECTED BY THE WORK W/ MATERIALS & FINISHES CONSISTENT W/ THE EXISTING CONSTRUCTION TYPE WHETHER OR NOT PATCH MATERIAL AND/OR FINISHES ARE INDICATED TO FILL. PATCH ALL HOLES AFFECTED BY REMOVAL OF EXISTING WALL MOUNTED ITEMS PRIOR TO PROVIDING WALL COATING OR PAINTING.

11. ALL AREAS OF DISTURBED EARTH, WHETHER BY CONSTRUCTION PROCESS, DEMOLITION, OR MATERIAL STORAGE, ARE TO BE RESTORED W/ BLACK TOPSOIL & SODDED PER SPECIFICATIONS (NO EXCEPTIONS). ALL LANDSCAPE WORK IS TO BE PERFORMED BY A LANDSCAPE CONTRACTOR. ALL SOD IS TO BE WATERED, MOWED & FERTILIZED UNTIL "VIGOROUS GROWTH" IS ESTABLISHED - TO BE DETERMINED BY OWNER. FOR REGULAR WATERING, CONTRACTOR IS RESPONSIBLE FOR TRUCKING IN. ANY "BROWNED" OR "BURNED OUT" SOD IS TO BE REPLACED AT NO ADDITIONAL COST TO OWNER (INCLUDING VANDALISM).

GRAPHIC LEGEND

THE KUBALA WASHATKO ARCHITECTS, INC.

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The Board of Regents of the University of Wisconsin on behalf of NSIN the University of Wisconsin - Madison

SHEET KEYNOTES

06.03 WOOD BENCH: ARCHITECTURAL GRADE GLULAM W/ LAP JOINTED TAPERED LEGS ON STL. KNIFE PLATE STANDOFFS

10.12 OPERABLE PARTITION BOD: MODERNFOLD ACOUSTISEAL ENCORE

22.05 HOSE BIB

ENTER

- BUILDING NAME


DF WISCONSIN - MADISON

SCONSIN

Revisions:

No. Date: Description:


KEY PLAN

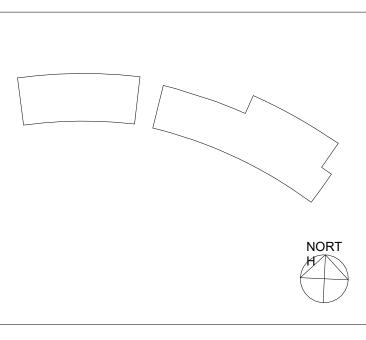


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	Scale	As indicated
ſ	UWM#	9950-2218
	UWSA#	A-22-007
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ſ	Date	02/21/20

A1.1

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1/22

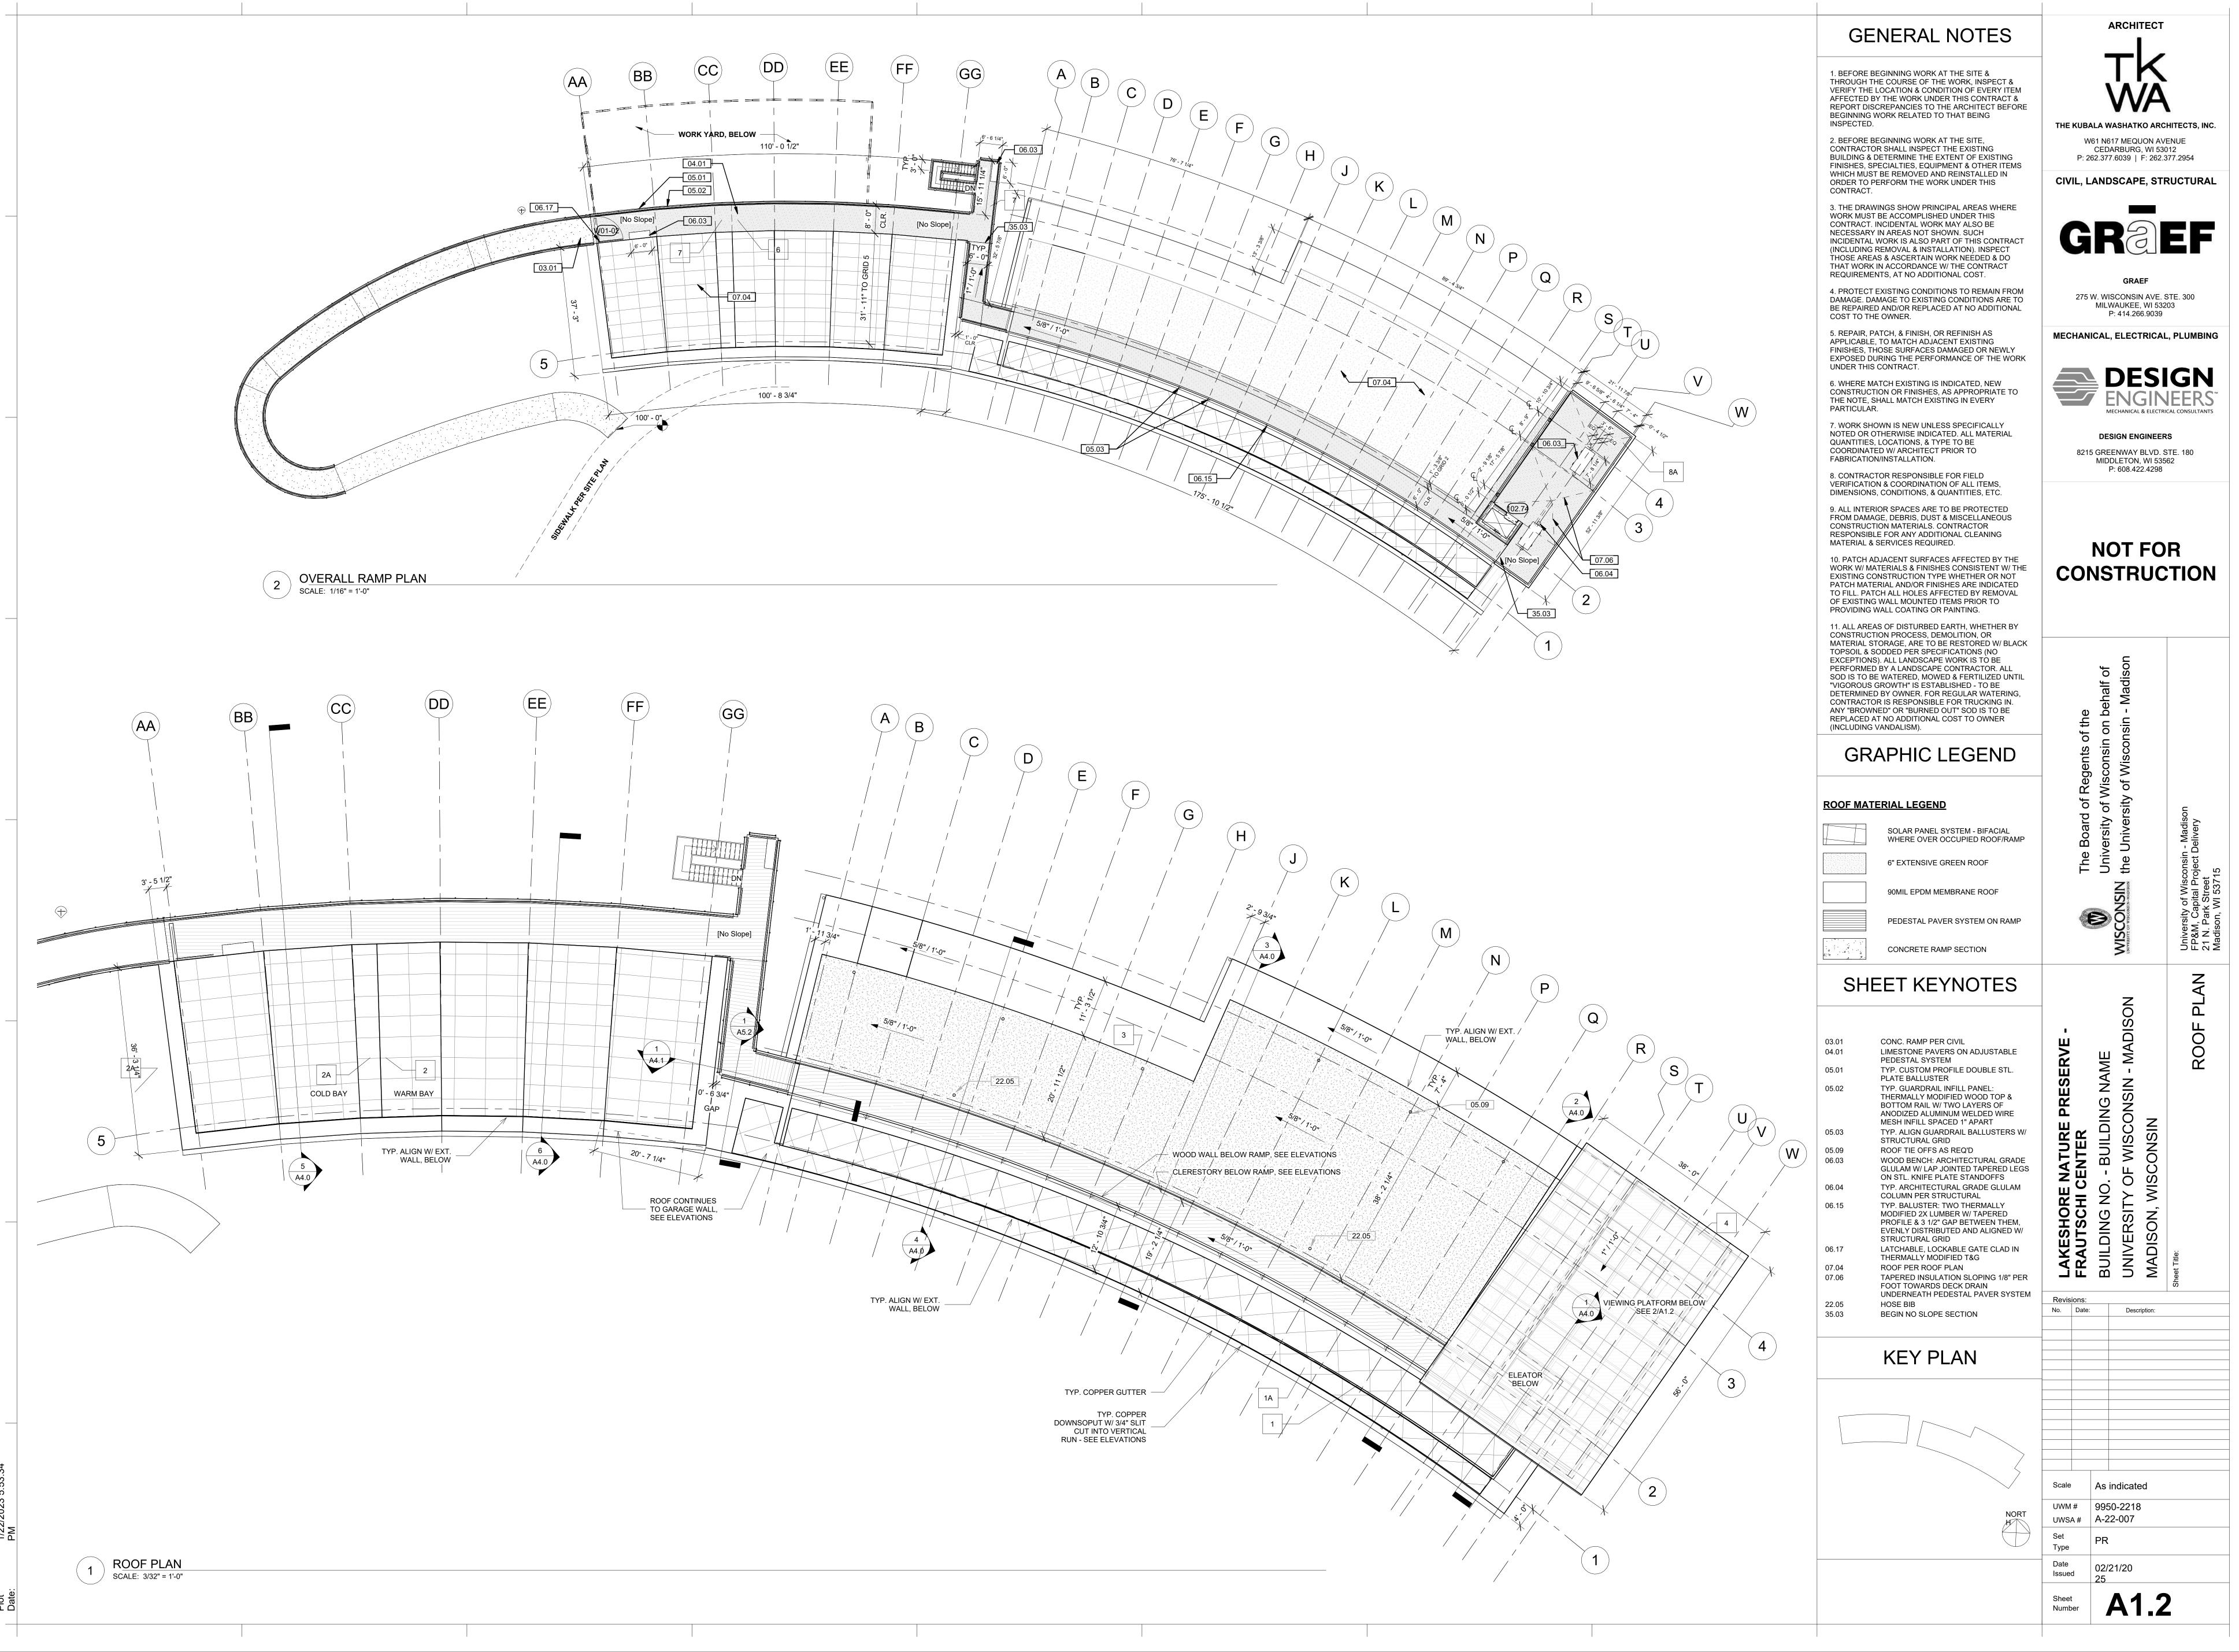

ARCHITECT

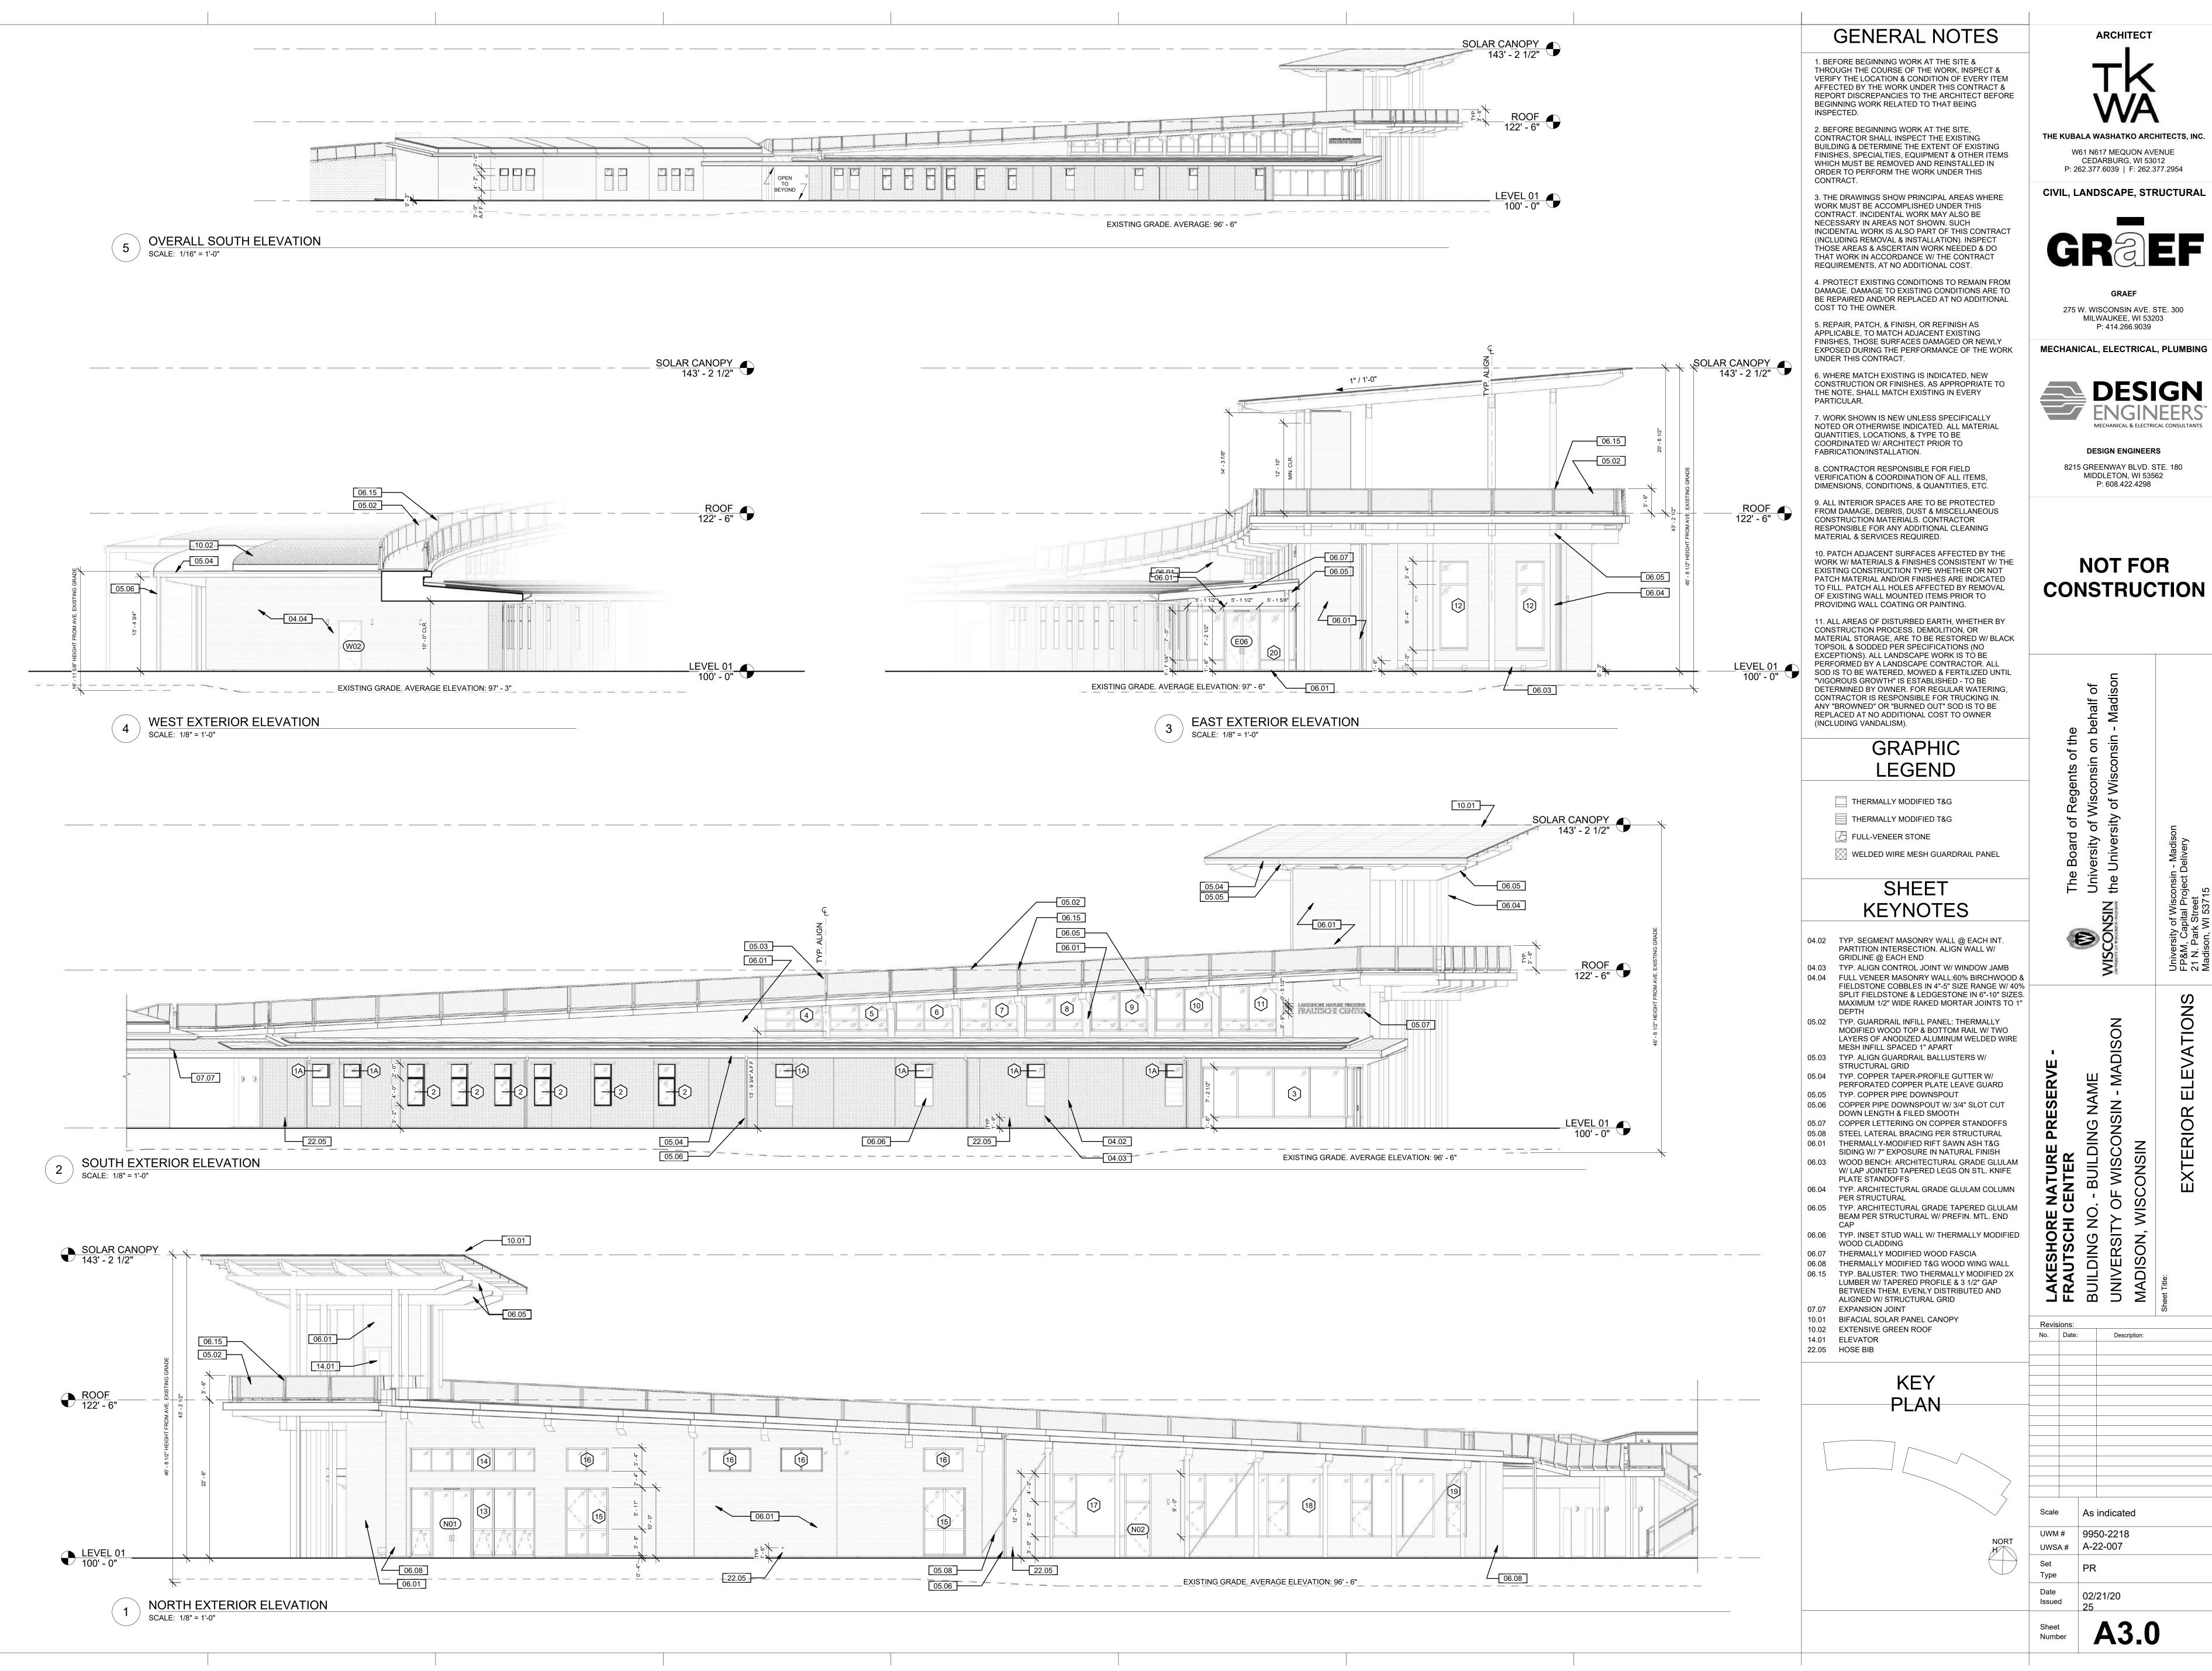THE KUBALA WASHATKO ARCHITECTS, INC.


CIVIL, LANDSCAPE, STRUCTURAL





275 W. WISCONSIN AVE. STE. 300 MILWAUKEE, WI 53203

As indicated 9950-2218 A-22-007

A3.0

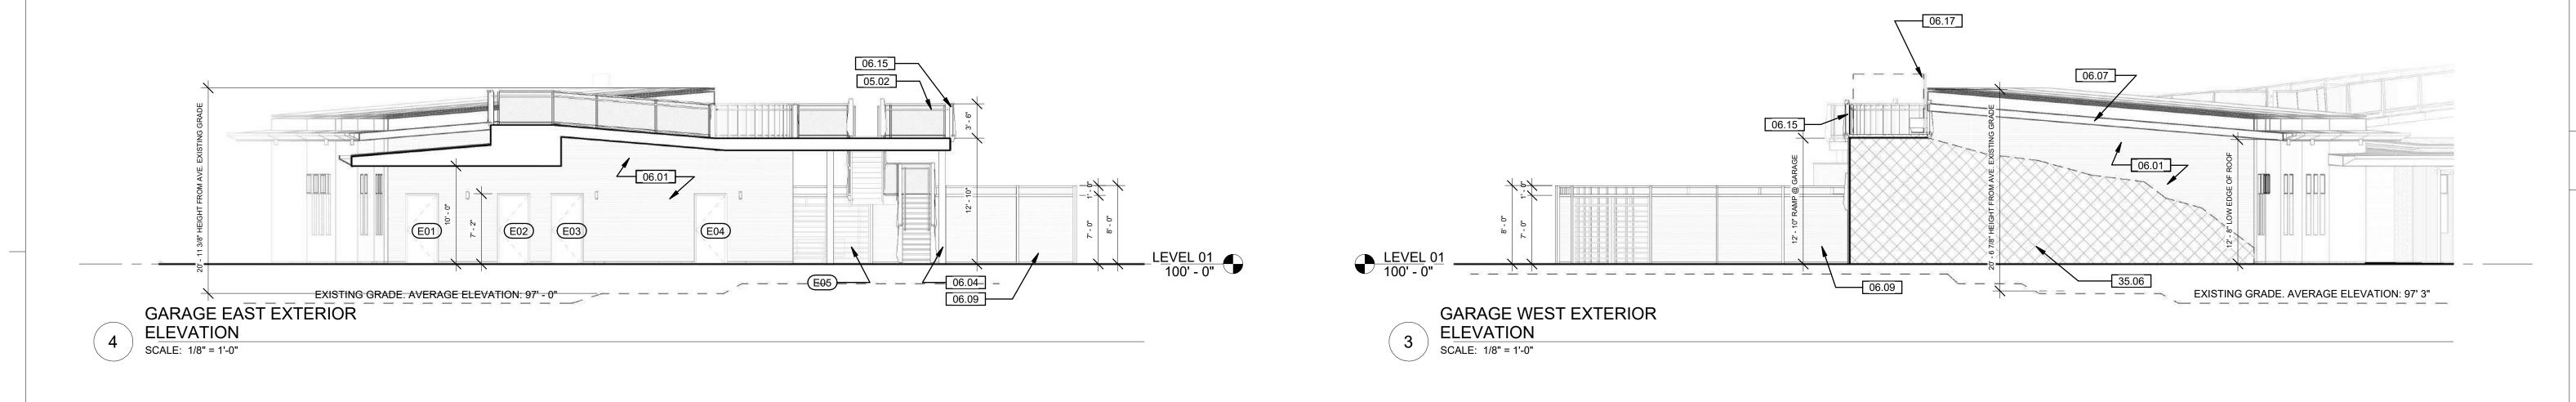

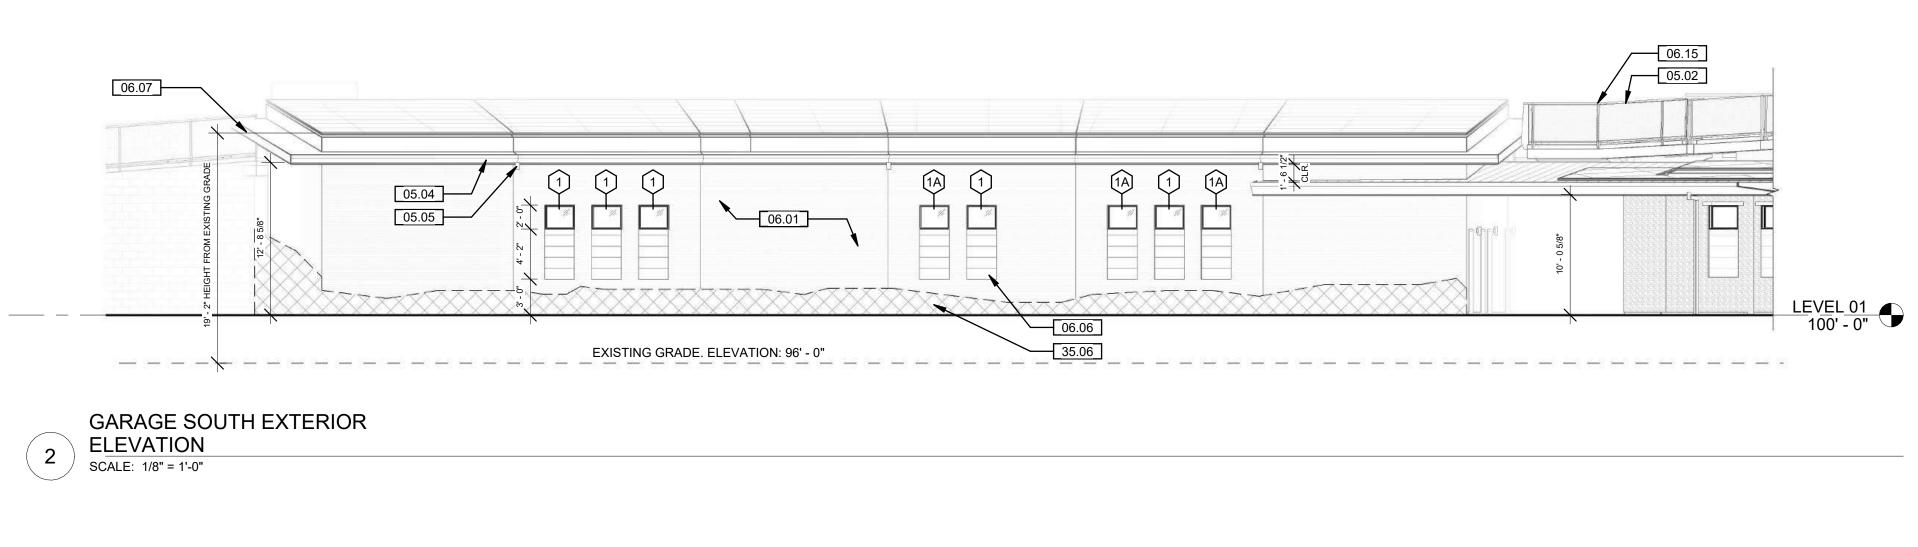

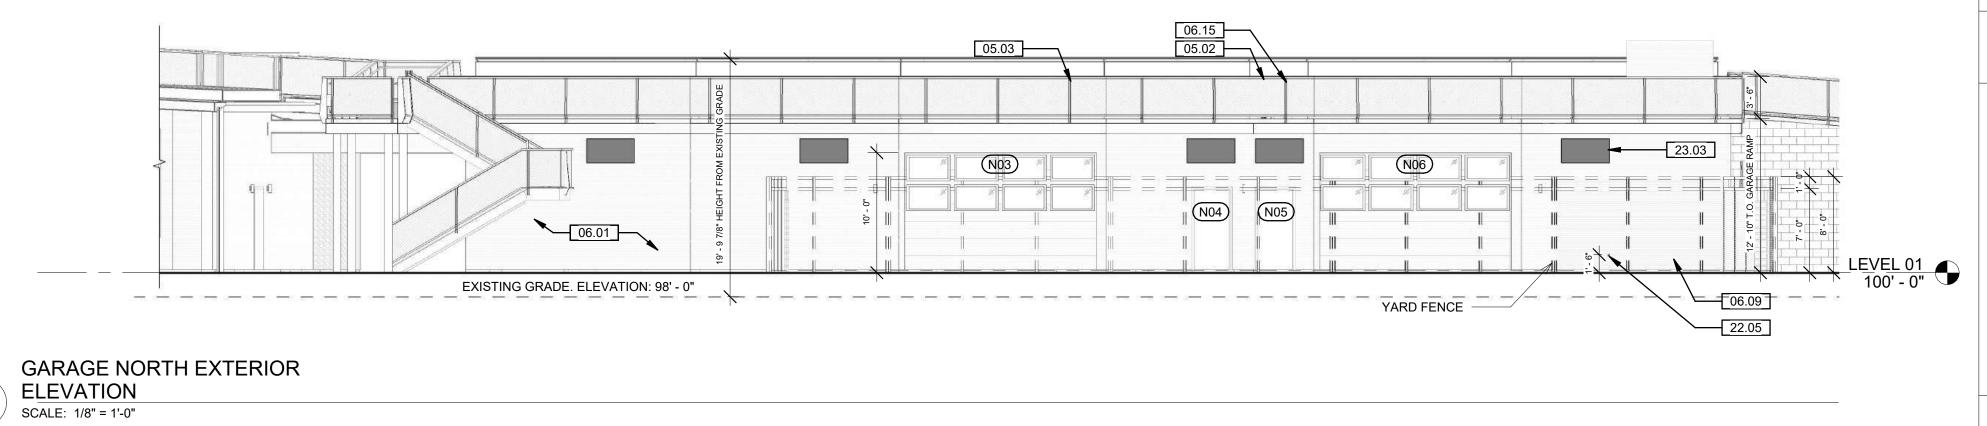

1. BEFORE BEGINNING WORK AT THE SITE & THROUGH THE COURSE OF THE WORK, INSPECT & VERIFY THE LOCATION & CONDITION OF EVERY ITEM AFFECTED BY THE WORK UNDER THIS CONTRACT & REPORT DISCREPANCIES TO THE ARCHITECT BEFORE BEGINNING WORK RELATED TO THAT BEING INSPECTED.

2. BEFORE BEGINNING WORK AT THE SITE, CONTRACTOR SHALL INSPECT THE EXISTING BUILDING & DETERMINE THE EXTENT OF EXISTING FINISHES, SPECIALTIES, EQUIPMENT & OTHER ITEMS WHICH MUST BE REMOVED AND REINSTALLED IN ORDER TO PERFORM THE WORK UNDER THIS CONTRACT.

3. THE DRAWINGS SHOW PRINCIPAL AREAS WHERE WORK MUST BE ACCOMPLISHED UNDER THIS CONTRACT. INCIDENTAL WORK MAY ALSO BE NECESSARY IN AREAS NOT SHOWN. SUCH INCIDENTAL WORK IS ALSO PART OF THIS CONTRACT (INCLUDING REMOVAL & INSTALLATION). INSPECT THOSE AREAS & ASCERTAIN WORK NEEDED & DO THAT WORK IN ACCORDANCE W/ THE CONTRACT REQUIREMENTS, AT NO ADDITIONAL COST.

4. PROTECT EXISTING CONDITIONS TO REMAIN FROM DAMAGE, DAMAGE TO EXISTING CONDITIONS ARE TO BE REPAIRED AND/OR REPLACED AT NO ADDITIONAL COST TO THE OWNER.

5. REPAIR, PATCH, & FINISH, OR REFINISH AS APPLICABLE. TO MATCH ADJACENT EXISTING FINISHES, THOSE SURFACES DAMAGED OR NEWLY EXPOSED DURING THE PERFORMANCE OF THE WORK UNDER THIS CONTRACT.

6. WHERE MATCH EXISTING IS INDICATED. NEW CONSTRUCTION OR FINISHES, AS APPROPRIATE TO THE NOTE, SHALL MATCH EXISTING IN EVERY PARTICULAR.

7. WORK SHOWN IS NEW UNLESS SPECIFICALLY NOTED OR OTHERWISE INDICATED. ALL MATERIAL QUANTITIES, LOCATIONS, & TYPE TO BE COORDINATED W/ ARCHITECT PRIOR TO FABRICATION/INSTALLATION.

8. CONTRACTOR RESPONSIBLE FOR FIELD VERIFICATION & COORDINATION OF ALL ITEMS, DIMENSIONS, CONDITIONS, & QUANTITIES, ETC.

9. ALL INTERIOR SPACES ARE TO BE PROTECTED FROM DAMAGE, DEBRIS, DUST & MISCELLANEOUS CONSTRUCTION MATERIALS. CONTRACTOR RESPONSIBLE FOR ANY ADDITIONAL CLEANING MATERIAL & SERVICES REQUIRED.

10. PATCH ADJACENT SURFACES AFFECTED BY THE WORK W/ MATERIALS & FINISHES CONSISTENT W/ THE EXISTING CONSTRUCTION TYPE WHETHER OR NOT PATCH MATERIAL AND/OR FINISHES ARE INDICATED TO FILL. PATCH ALL HOLES AFFECTED BY REMOVAL OF EXISTING WALL MOUNTED ITEMS PRIOR TO PROVIDING WALL COATING OR PAINTING.

11. ALL AREAS OF DISTURBED EARTH, WHETHER BY CONSTRUCTION PROCESS, DEMOLITION, OR MATERIAL STORAGE, ARE TO BE RESTORED W/ BLACK TOPSOIL & SODDED PER SPECIFICATIONS (NO EXCEPTIONS). ALL LANDSCAPE WORK IS TO BE PERFORMED BY A LANDSCAPE CONTRACTOR. ALL SOD IS TO BE WATERED, MOWED & FERTILIZED UNTIL "VIGOROUS GROWTH" IS ESTABLISHED - TO BE DETERMINED BY OWNER. FOR REGULAR WATERING, CONTRACTOR IS RESPONSIBLE FOR TRUCKING IN. ANY "BROWNED" OR "BURNED OUT" SOD IS TO BE REPLACED AT NO ADDITIONAL COST TO OWNER (INCLUDING VANDALISM).

GRAPHIC LEGEND

- THERMALLY MODIFIED T&G
- THERMALLY MODIFIED T&G
- FULL-VENEER STONE WELDED WIRE MESH GUARDRAIL PANEL

ARCHITECT

THE KUBALA WASHATKO ARCHITECTS, INC.

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CEDARBURG, WI 53012

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CIVIL, LANDSCAPE, STRUCTURAL

275 W. WISCONSIN AVE. STE. 300

P: 414.266.9039

MECHANICAL, ELECTRICAL, PLUMBING

DESIGN ENGINEERS

8215 GREENWAY BLVD. STE. 180

MIDDLETON, WI 53562 P: 608.422.4298

NOT FOR

CONSTRUCTION

MECHANICAL & ELECTRICAL CONSULTANTS

MILWAUKEE, WI 53203


SHEET KEYNOTES

TYP. GUARDRAIL INFILL PANEL: THERMALLY MODIFIED WOOD TOP & BOTTOM RAIL W/ TWO LAYERS OF ANODIZED ALUMINUM WELDED WIRE MESH INFILL SPACED 1" APART TYP. ALIGN GUARDRAIL BALLUSTERS W/ STRUCTURAL GRID TYP. COPPER TAPER-PROFILE GUTTER W/ PERFORATED COPPER PLATE LEAVE TYP. COPPER PIPE DOWNSPOUT 05.05 THERMALLY-MODIFIED RIFT SAWN ASH T&G SIDING W/ 7" EXPOSURE IN NATURAL 06.01 TYP. ARCHITECTURAL GRADE GLULAM COLUMN PER STRUCTURAL TYP. INSET STUD WALL W/ THERMALLY MODIFIED WOOD CLADDING THERMALLY MODIFIED WOOD FASCIA THERMALLY MODIFIED WOOD FENCE: MASS TIMBER FRAMING W/ THERMALLY

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22.05 HOSE BIB 23.03 MECHANICAL LOUVER, SEE MECH DRAWINGS TYP. CMU RETAINING WALL BELOW GRADE - SEE GRADING PLAN

KEY PLAN

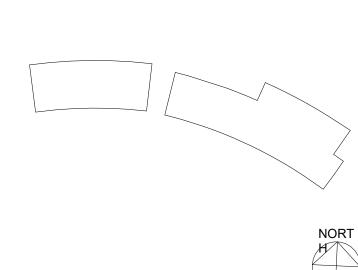

As indicated 9950-2218 UWSA# A-22-007 Type

No. Date:

Issued Sheet Number

A3.1

Description:

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WHICH MUST BE REMOVED AND REINSTALLED IN ORDER TO

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ARCHITECT

THE KUBALA WASHATKO ARCHITECTS, INC. W61 N617 MEQUON AVENUE CEDARBURG, WI 53012

P: 262.377.6039 | F: 262.377.2954

CIVIL, LANDSCAPE, STRUCTURAL



275 W. WISCONSIN AVE. STE. 300 MILWAUKEE, WI 53203


P: 414.266.9039 MECHANICAL, ELECTRICAL, PLUMBING



DESIGN ENGINEERS


MECHANICAL & ELECTRICAL CONSULTANTS

8215 GREENWAY BLVD. STE. 180 MIDDLETON, WI 53562 P: 608.422.4298

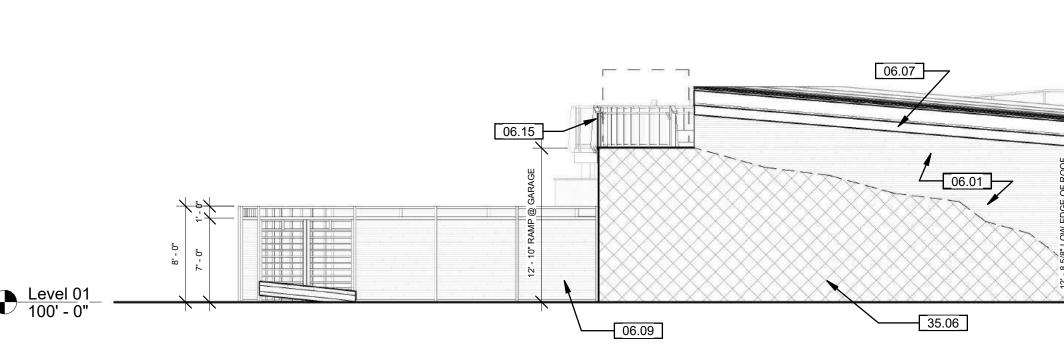


) SCALE: 1/8" = 1'-0"

GARAGE EAST EXTERIOR ELEVATION SCALE: 1/8" = 1'-0"

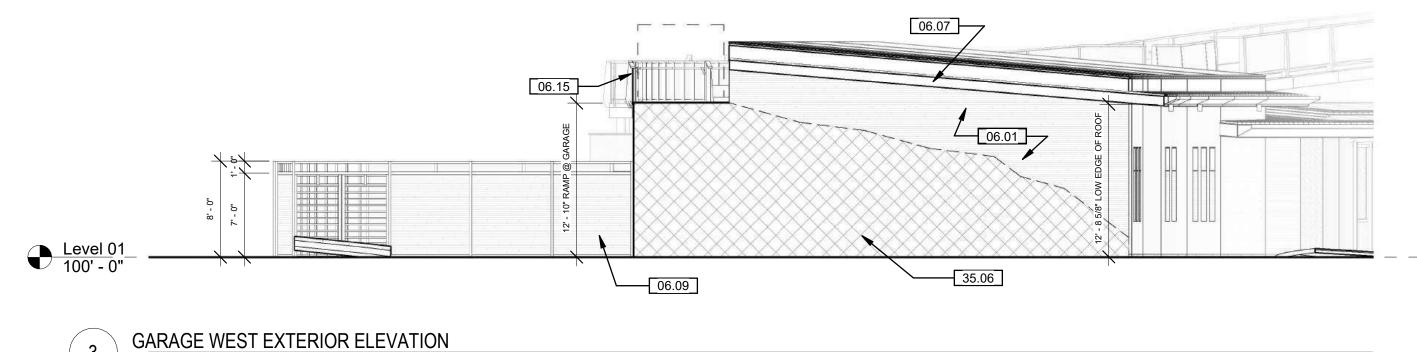

GARAGE SOUTH EXTERIOR 2 ELEVATION
SCALE: 1/8" = 1'-0"

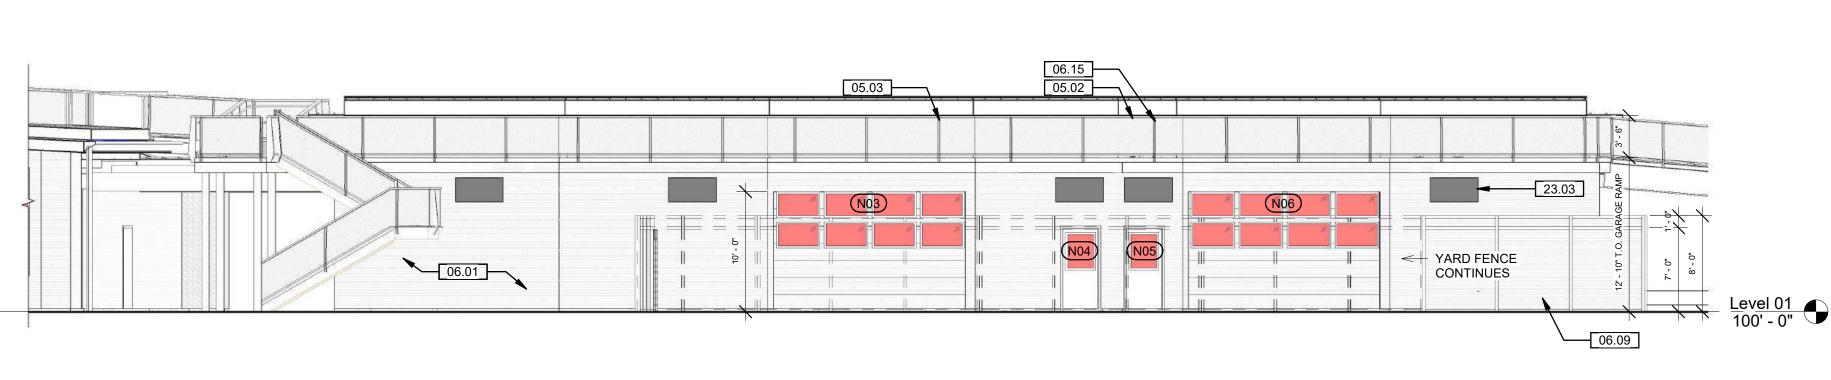

GARAGE NORTH EXTERIOR

1 ELEVATION
SCALE: 1/8" = 1'-0"

100% OF GLAZING ON PROJECT IS SUPPLIED WITH BIRD SAFE TREATMENT GLASS TREATED WITH

ORNALUX UV BIRD **COLLISION PREVENTION** GLAZING

GLASS TREATED WITH 2" X 2" GRID DOT PATTERN CERAMIC ON SURFACE #2

SHEET


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GRADE - SEE GRADING PLAN

No. Date:

KEY PLAN




Description:

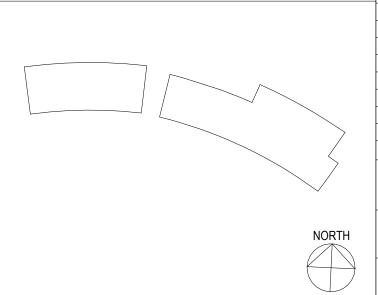EXTERIOR ELEVATIONS

Sheet Number

A3.1-1

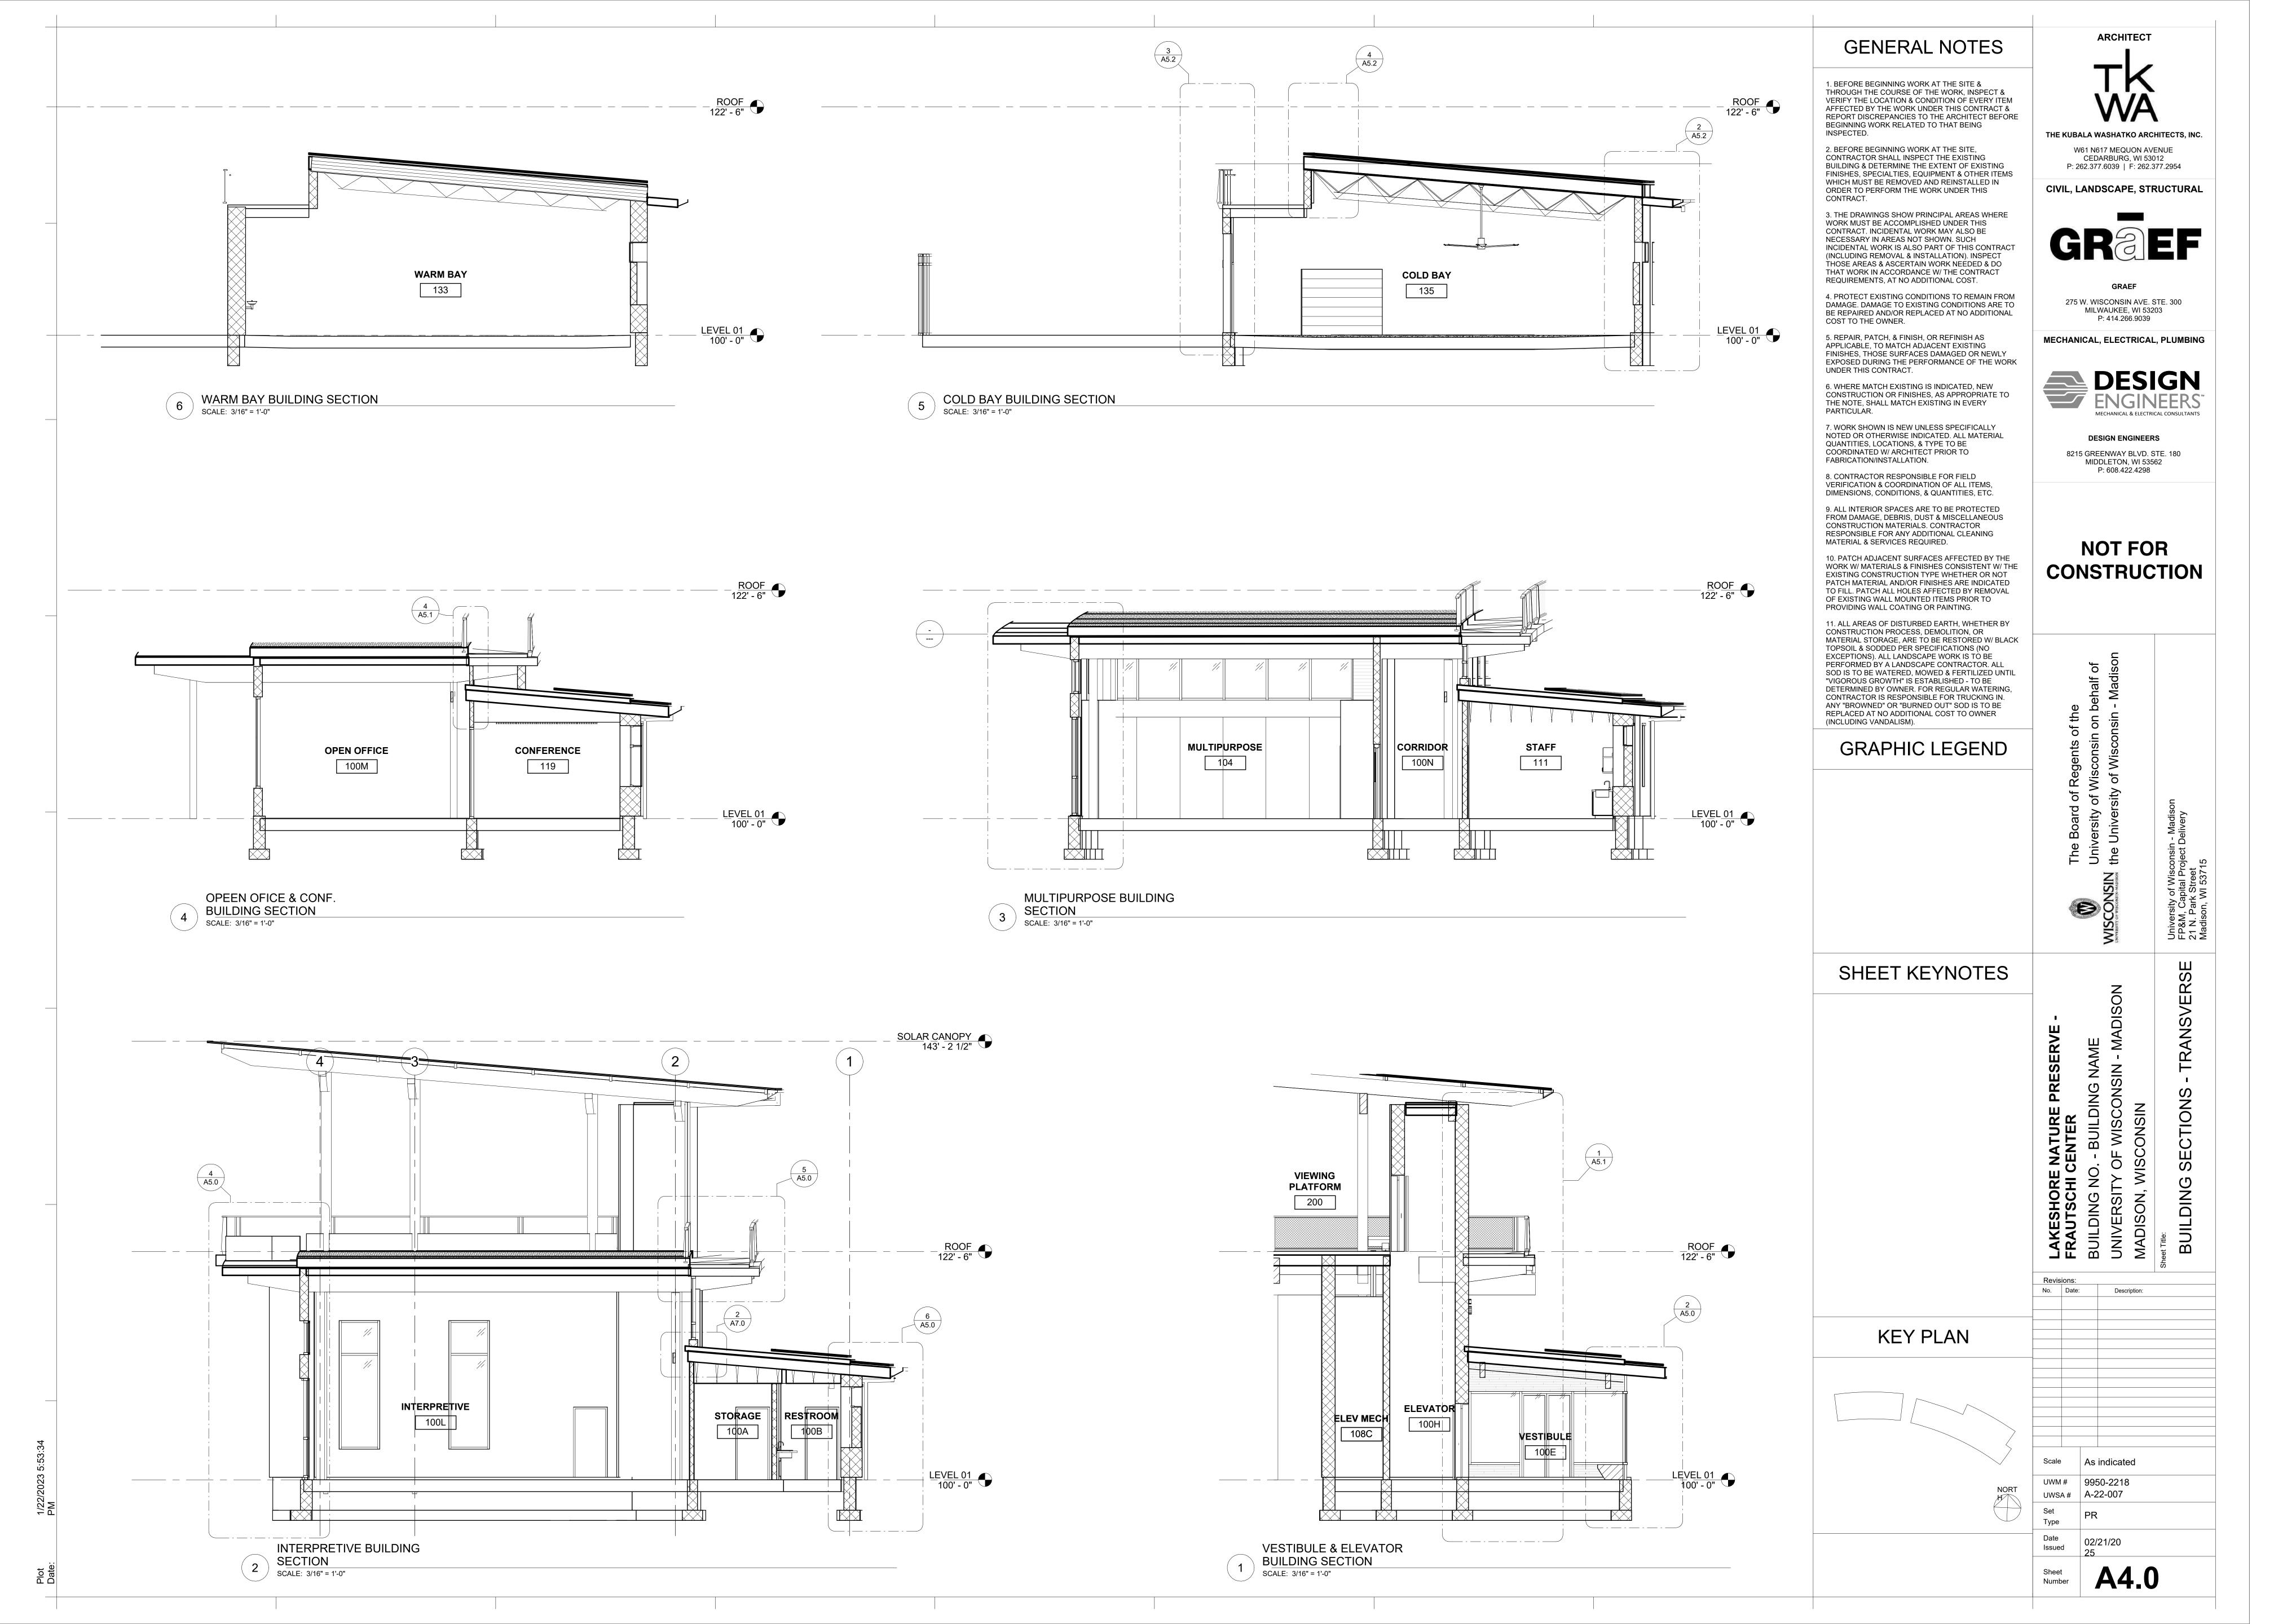

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ARCHITECT

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MECHANICAL, ELECTRICAL, PLUMBING




DESIGN ENGINEERS 8215 GREENWAY BLVD. STE. 180

MIDDLETON, WI 53562 P: 608.422.4298

> **NOT FOR** CONSTRUCTION

No. Date:

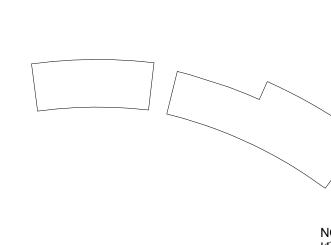

WARM BAY

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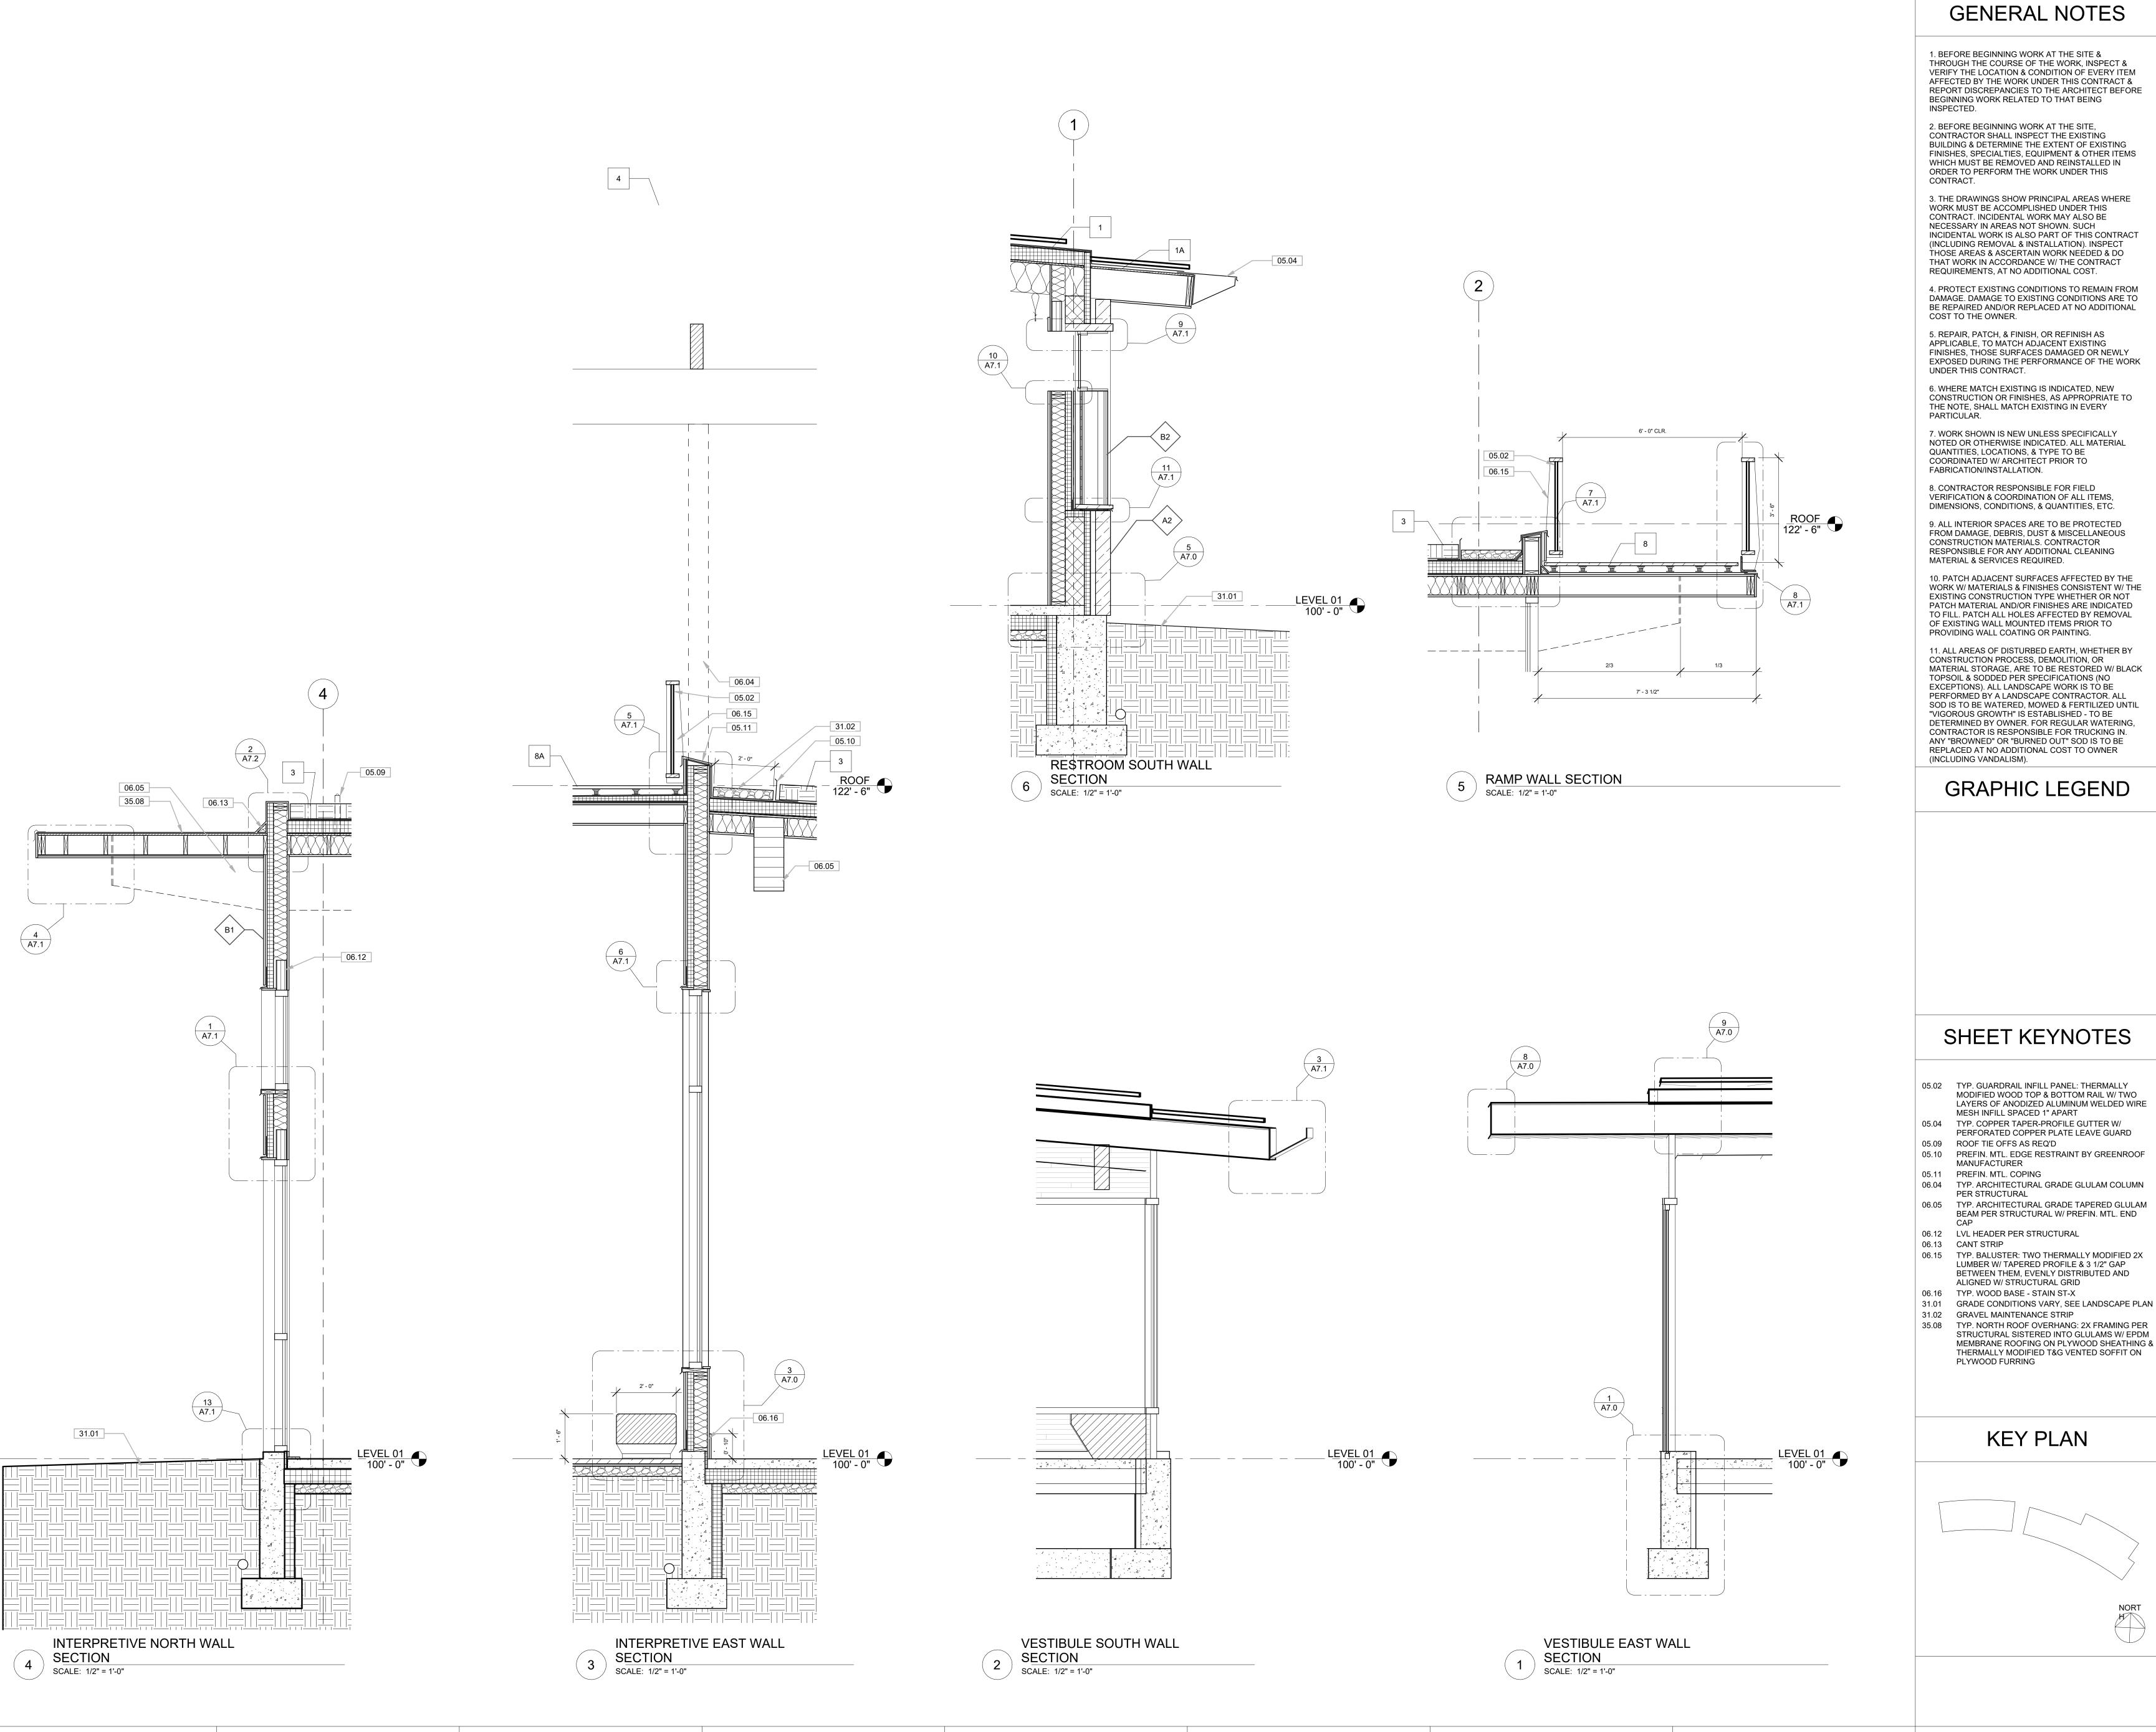
MECHANICAL CHASE BUILDING
SECTION
SCALE: 3/16" = 1'-0"

UWM# 9950-2218

Sheet Number

Date Issued

A4.1



1. BEFORE BEGINNING WORK AT THE SITE & THROUGH THE COURSE OF THE WORK, INSPECT & VERIFY THE LOCATION & CONDITION OF EVERY ITEM AFFECTED BY THE WORK UNDER THIS CONTRACT & REPORT DISCREPANCIES TO THE ARCHITECT BEFORE BEGINNING WORK RELATED TO THAT BEING

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P: 414.266.9039 MECHANICAL, ELECTRICAL, PLUMBING



MECHANICAL & ELECTRICAL CONSULTANTS **DESIGN ENGINEERS**

8215 GREENWAY BLVD. STE. 180 MIDDLETON, WI 53562 P: 608.422.4298

NOT FOR CONSTRUCTION


05.02 TYP. GUARDRAIL INFILL PANEL: THERMALLY MODIFIED WOOD TOP & BOTTOM RAIL W/ TWO LAYERS OF ANODIZED ALUMINUM WELDED WIRE

05.04 TYP. COPPER TAPER-PROFILE GUTTER W/ PERFORATED COPPER PLATE LEAVE GUARD

06.04 TYP. ARCHITECTURAL GRADE GLULAM COLUMN

35.08 TYP. NORTH ROOF OVERHANG: 2X FRAMING PER STRUCTURAL SISTERED INTO GLULAMS W/ EPDM MEMBRANE ROOFING ON PLYWOOD SHEATHING & THERMALLY MODIFIED T&G VENTED SOFFIT ON

No. Date: Description:

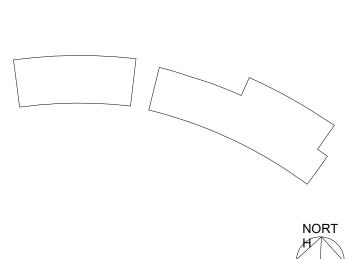



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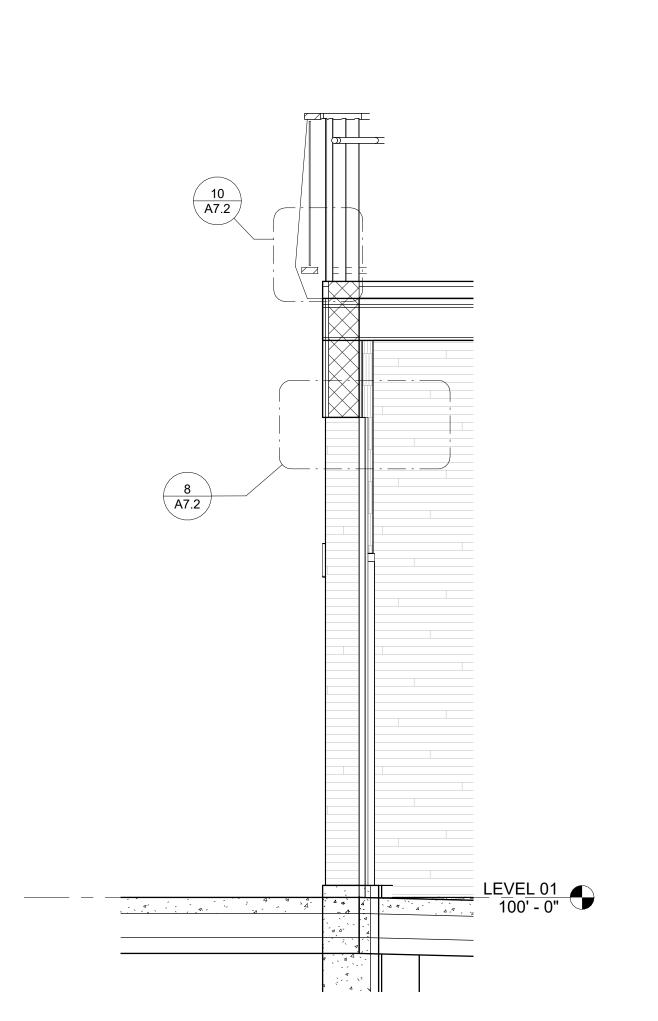
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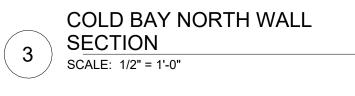
Sheet Number


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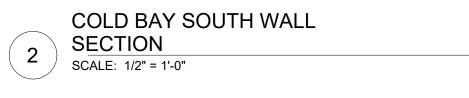







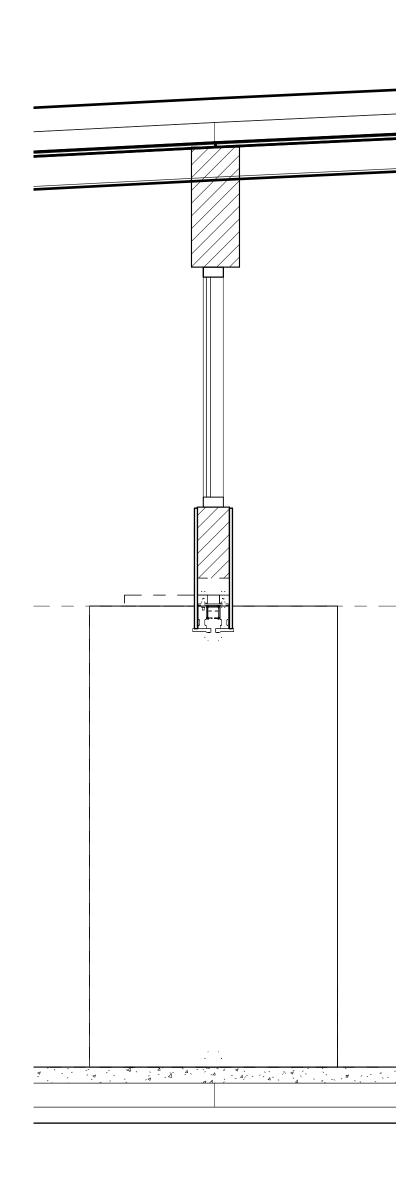


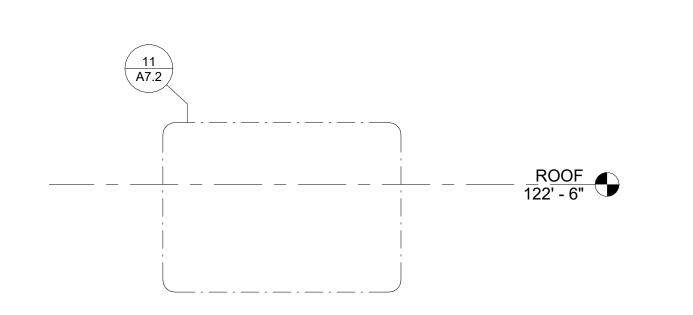

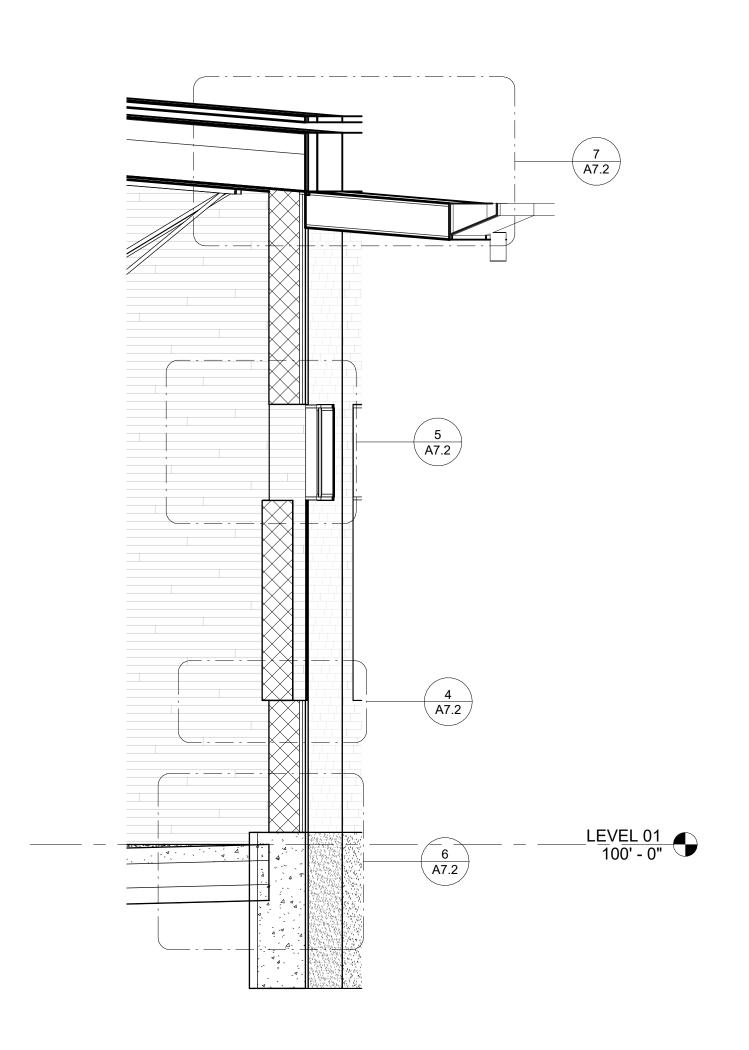

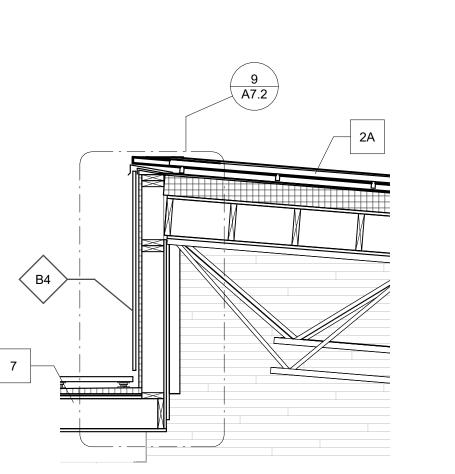

GARAGE RAMP SOUTH WALL SECTION
SCALE: 1/2" = 1'-0"

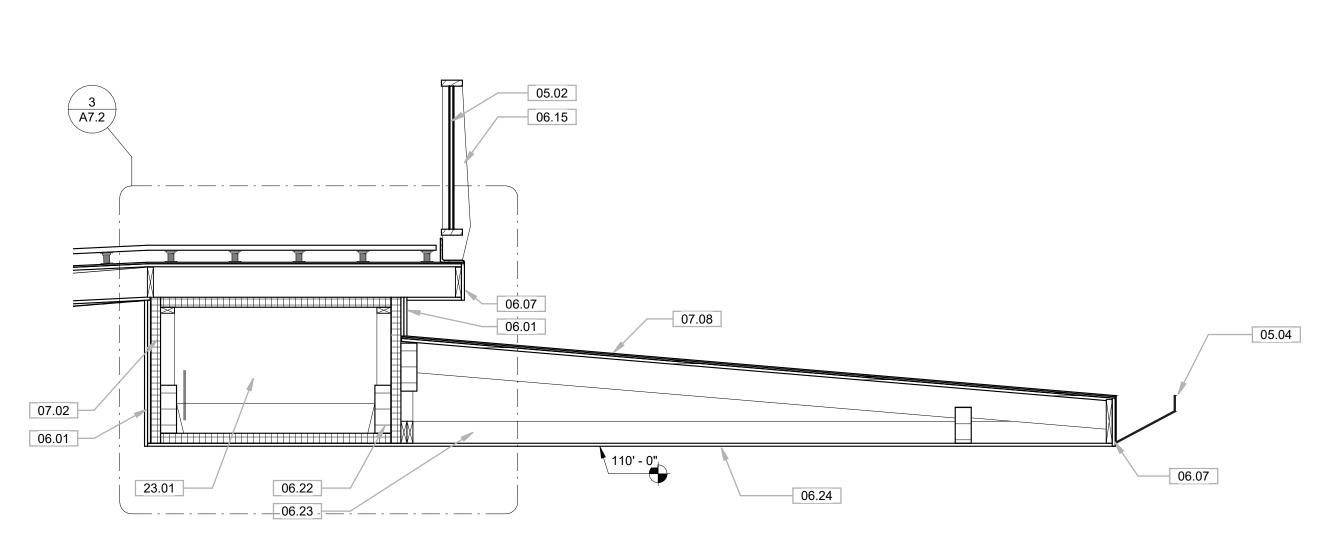

MECANICAL CHASE WALL
SECTION
SCALE: 1/2" = 1'-0"

GENERAL NOTES

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GRAPHIC LEGEND

ARCHITECT THE KUBALA WASHATKO ARCHITECTS, INC. W61 N617 MEQUON AVENUE

CEDARBURG, WI 53012 P: 262.377.6039 | F: 262.377.2954 CIVIL, LANDSCAPE, STRUCTURAL

275 W. WISCONSIN AVE. STE. 300 MILWAUKEE, WI 53203 P: 414.266.9039

MECHANICAL, ELECTRICAL, PLUMBING



MECHANICAL & ELECTRICAL CONSULTANTS **DESIGN ENGINEERS**

8215 GREENWAY BLVD. STE. 180

MIDDLETON, WI 53562 P: 608.422.4298

NOT FOR CONSTRUCTION

SHEET KEYNOTES

05.02 TYP. GUARDRAIL INFILL PANEL: THERMALLY MODIFIED WOOD TOP & BOTTOM RAIL W/TWO LAYERS OF ANODIZED ALUMINUM WELDED WIRE MESH INFILL SPACED 1" APART

05.04 TYP. COPPER TAPER-PROFILE GUTTER W/ PERFORATED COPPER PLATE LEAVE GUARD 06.01 THERMALLY-MODIFIED RIFT SAWN ASH T&G SIDING W/ 7" EXPOSURE IN NATURAL FINISH LUMBER W/ TAPERED PROFILE & 3 1/2" GAP


BETWEEN THEM, EVENLY DISTRIBUTED AND ALIGNED W/ STRUCTURAL GRID 06.22 INDUSTRIAL GLULAM PER STRUCTURAL 06.23 2X FRAMING AS REQ'D 06.24 ARCHITECTURAL T&G FULLY VENTED SOFFIT STAIN ST-X

07.02 AIR & WATER RESISTANT INSULATED SHEATHING 07.08 FULLY ADHERED 90 MIL EPDM ROOF MEMBRANE ON GYPSUM COVER BOARD & PLYWOOD SHEATHING

23.01 INSULATED MECHANICAL CHASE

No. Date: Description:

KEY PLAN

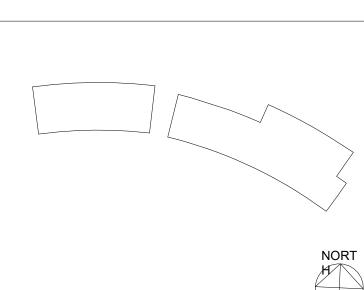


As indicated 9950-2218 UWSA# A-22-007

Issued

Sheet Number


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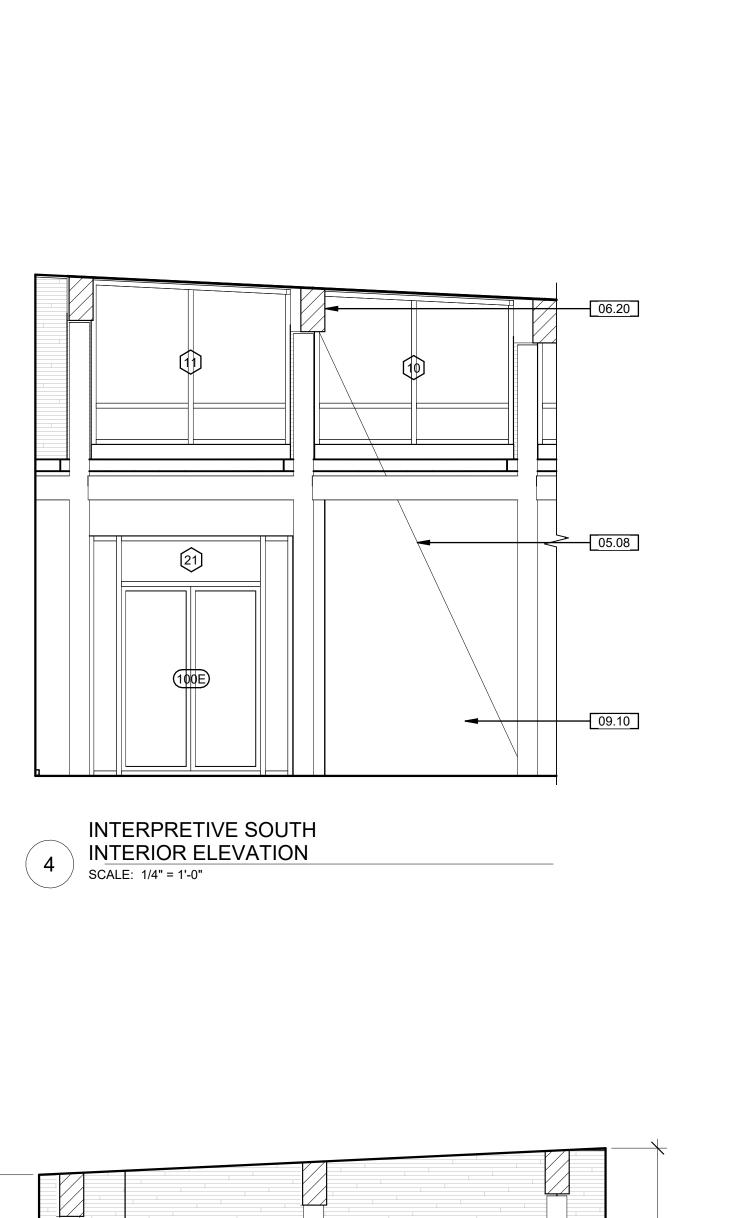
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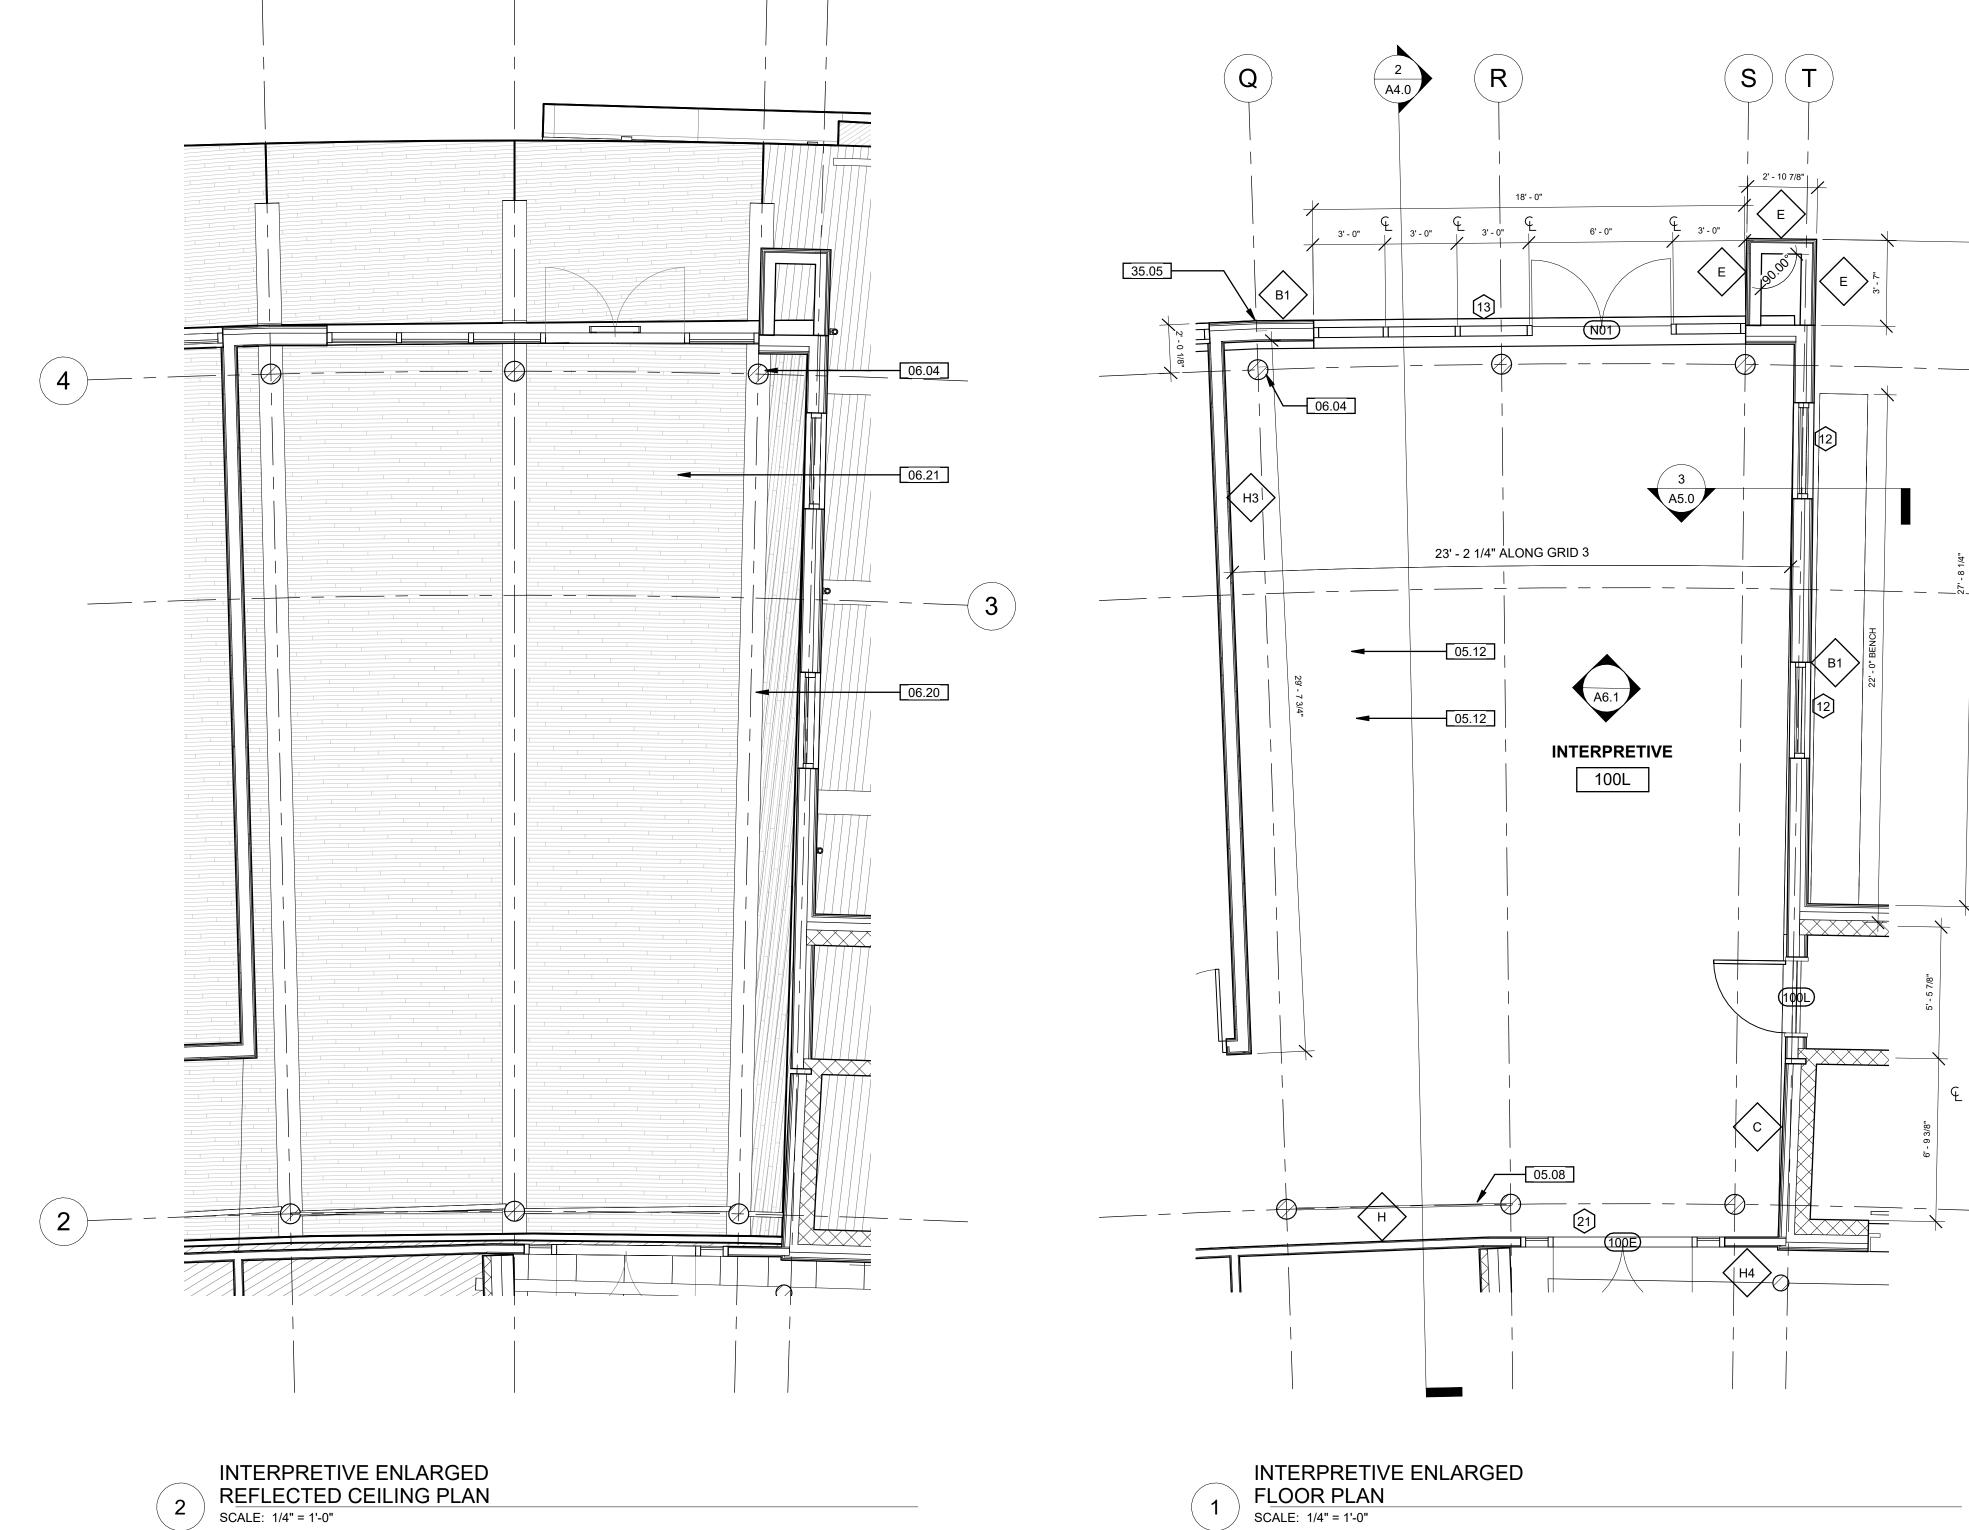


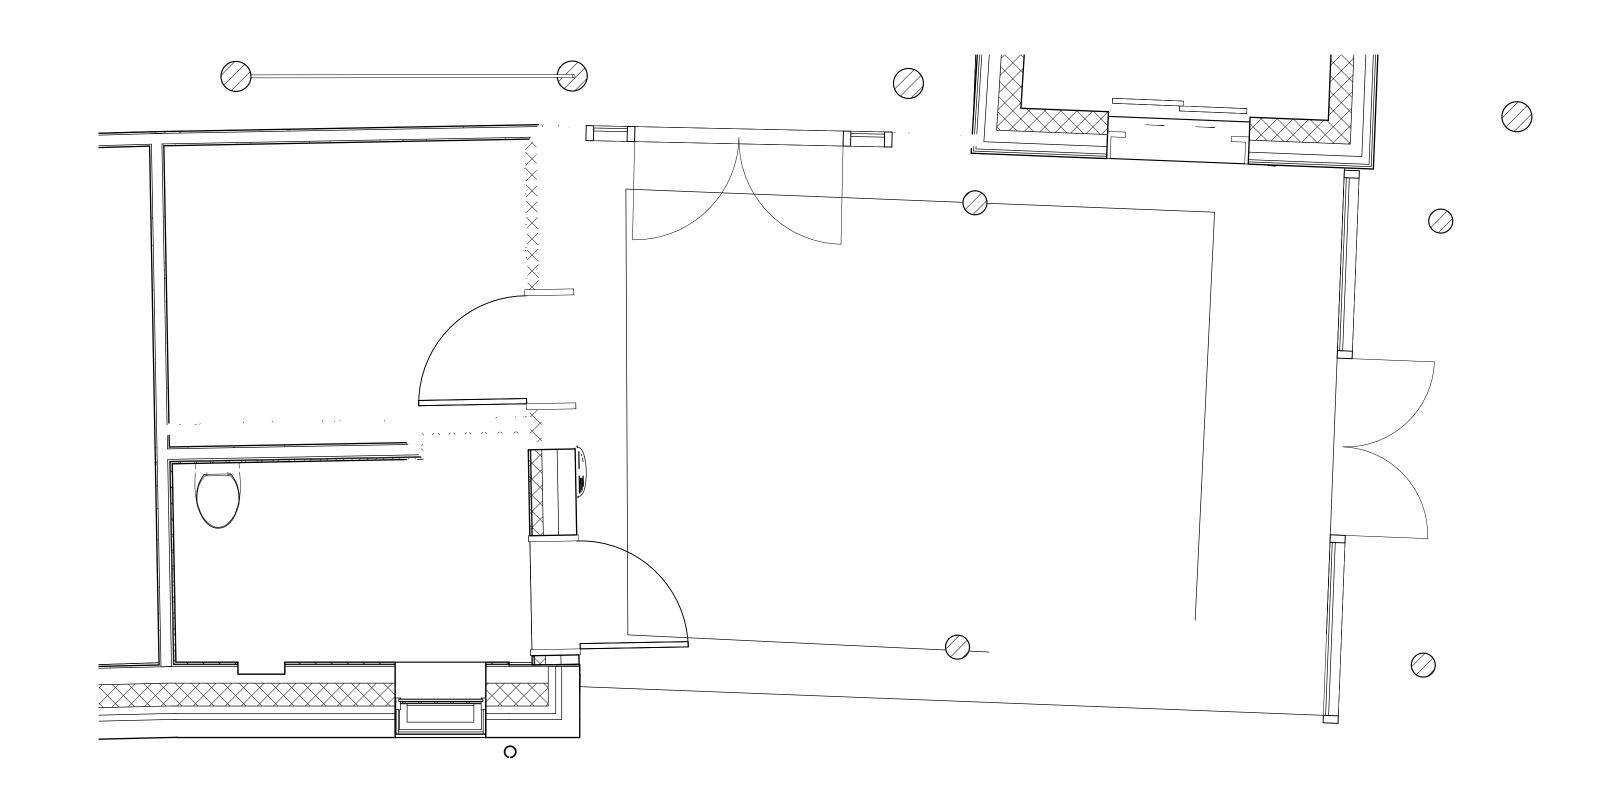



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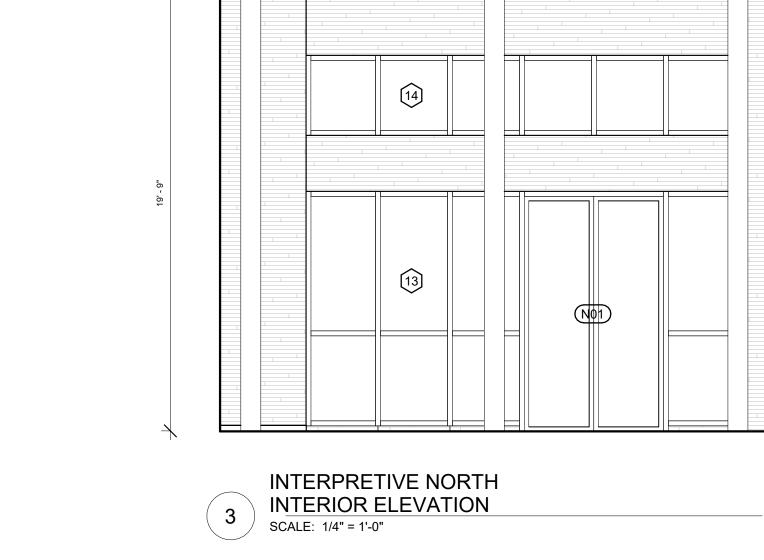



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Sheet Number

A6.1

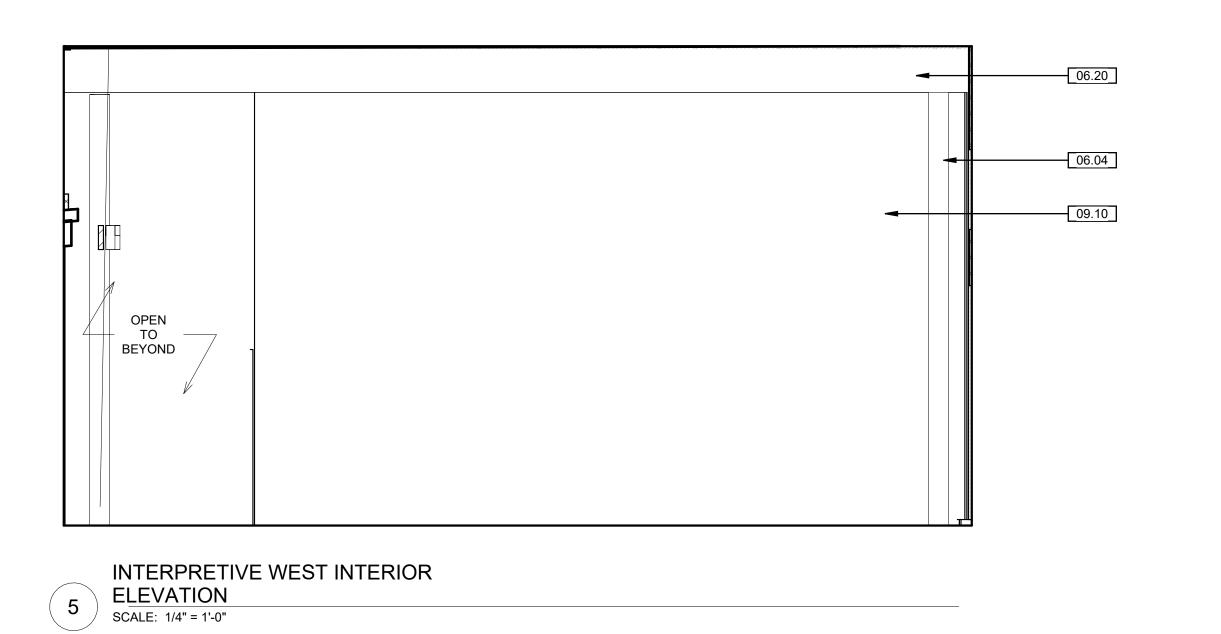ARCHITECT

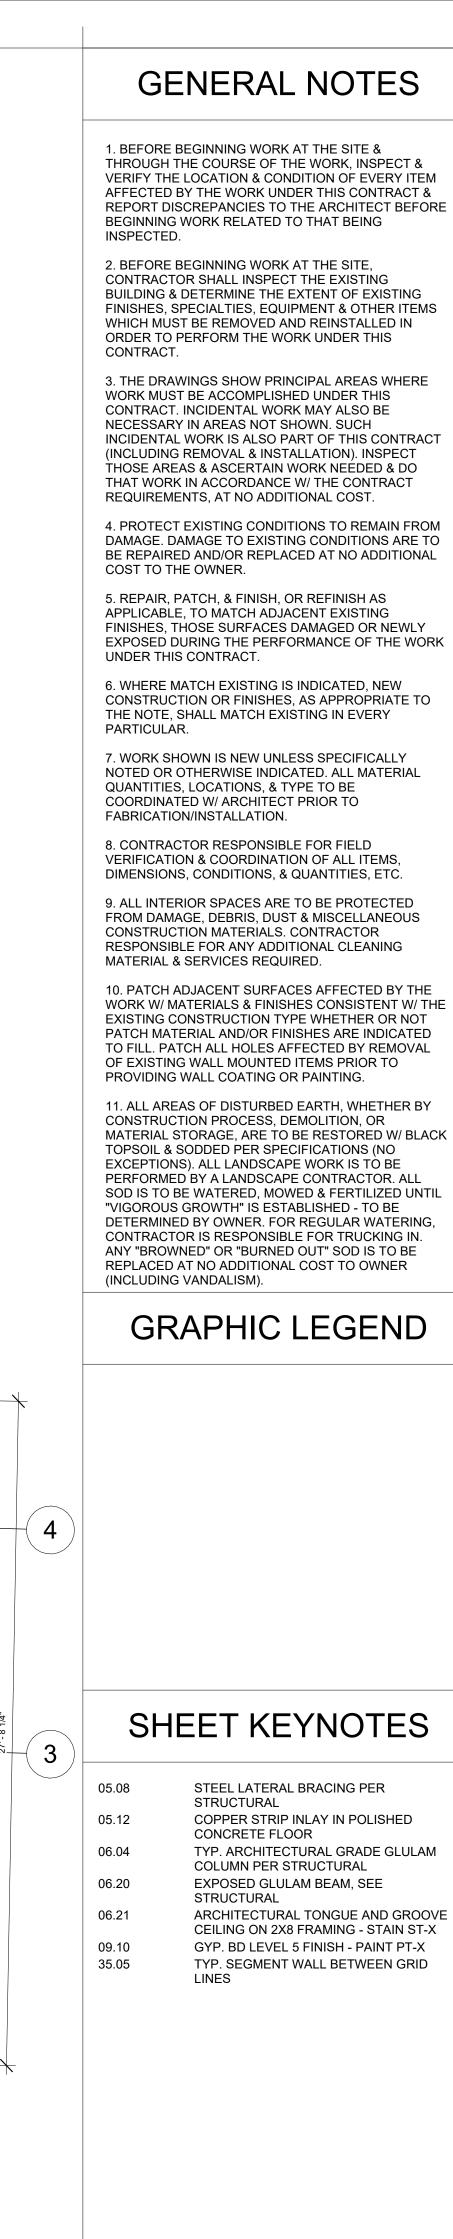

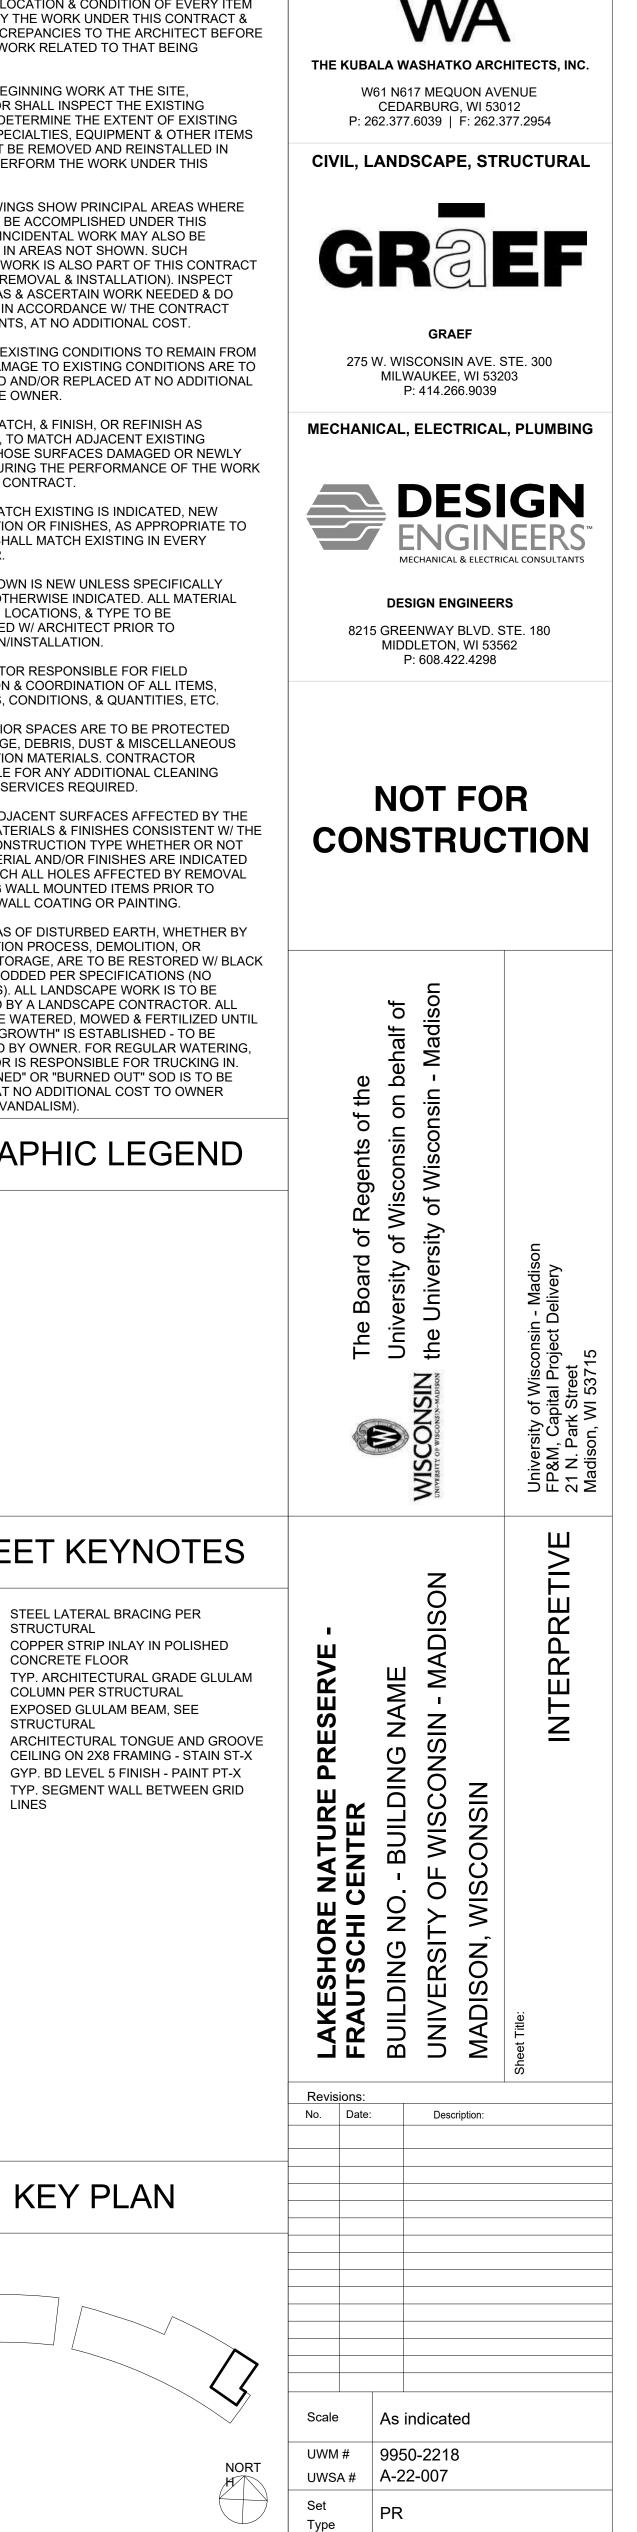
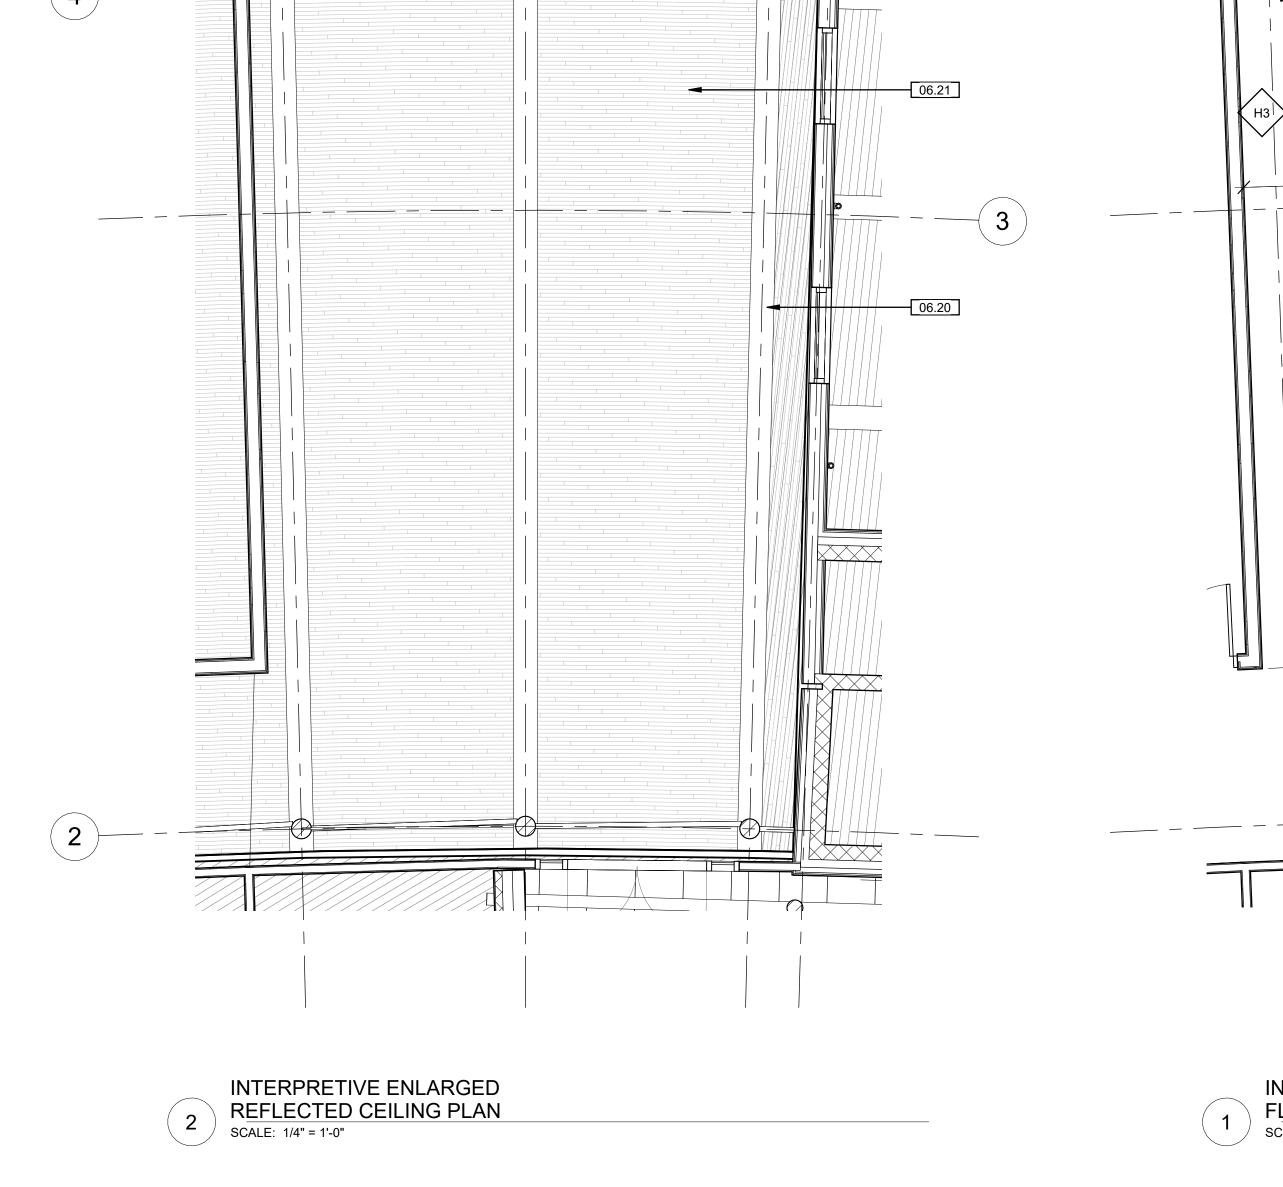
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THE KUBALA WASHATKO ARCHITE

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W61 N617 MEQUON AVENUE
CEDARBURG, WI 53012

CIVIL, LANDSCAPE, STRUCTURAL

P: 262.377.6039 | F: 262.377.2954



GRAEF

275 W. WISCONSIN AVE. STE. 300

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MECHANICAL, ELECTRICAL, PLUMBING



DESIGN ENGINEERS

8215 GREENWAY BLVD. STE. 180 MIDDLETON, WI 53562 P: 608.422.4298


NOT FOR CONSTRUCTION

The Board of Regents of the University of Wisconsin on behalf of ONSIN the University of Wisconsin - Madisor

SHEET KEYNOTES

LAKESHORE NATURE PRESERVE FRAUTSCHI CENTER
BUILDING NO. - BUILDING NAME
UNIVERSITY OF WISCONSIN - MADISO
MADISON, WISCONSIN
Sheet Title:

KEY PLAN

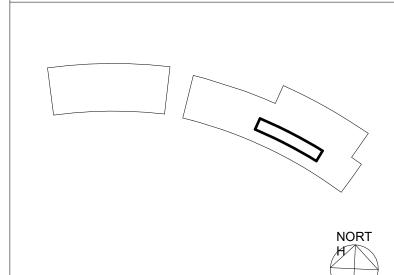

Scale As indicated

UWM # 9950-2218

UWSA # A-22-007

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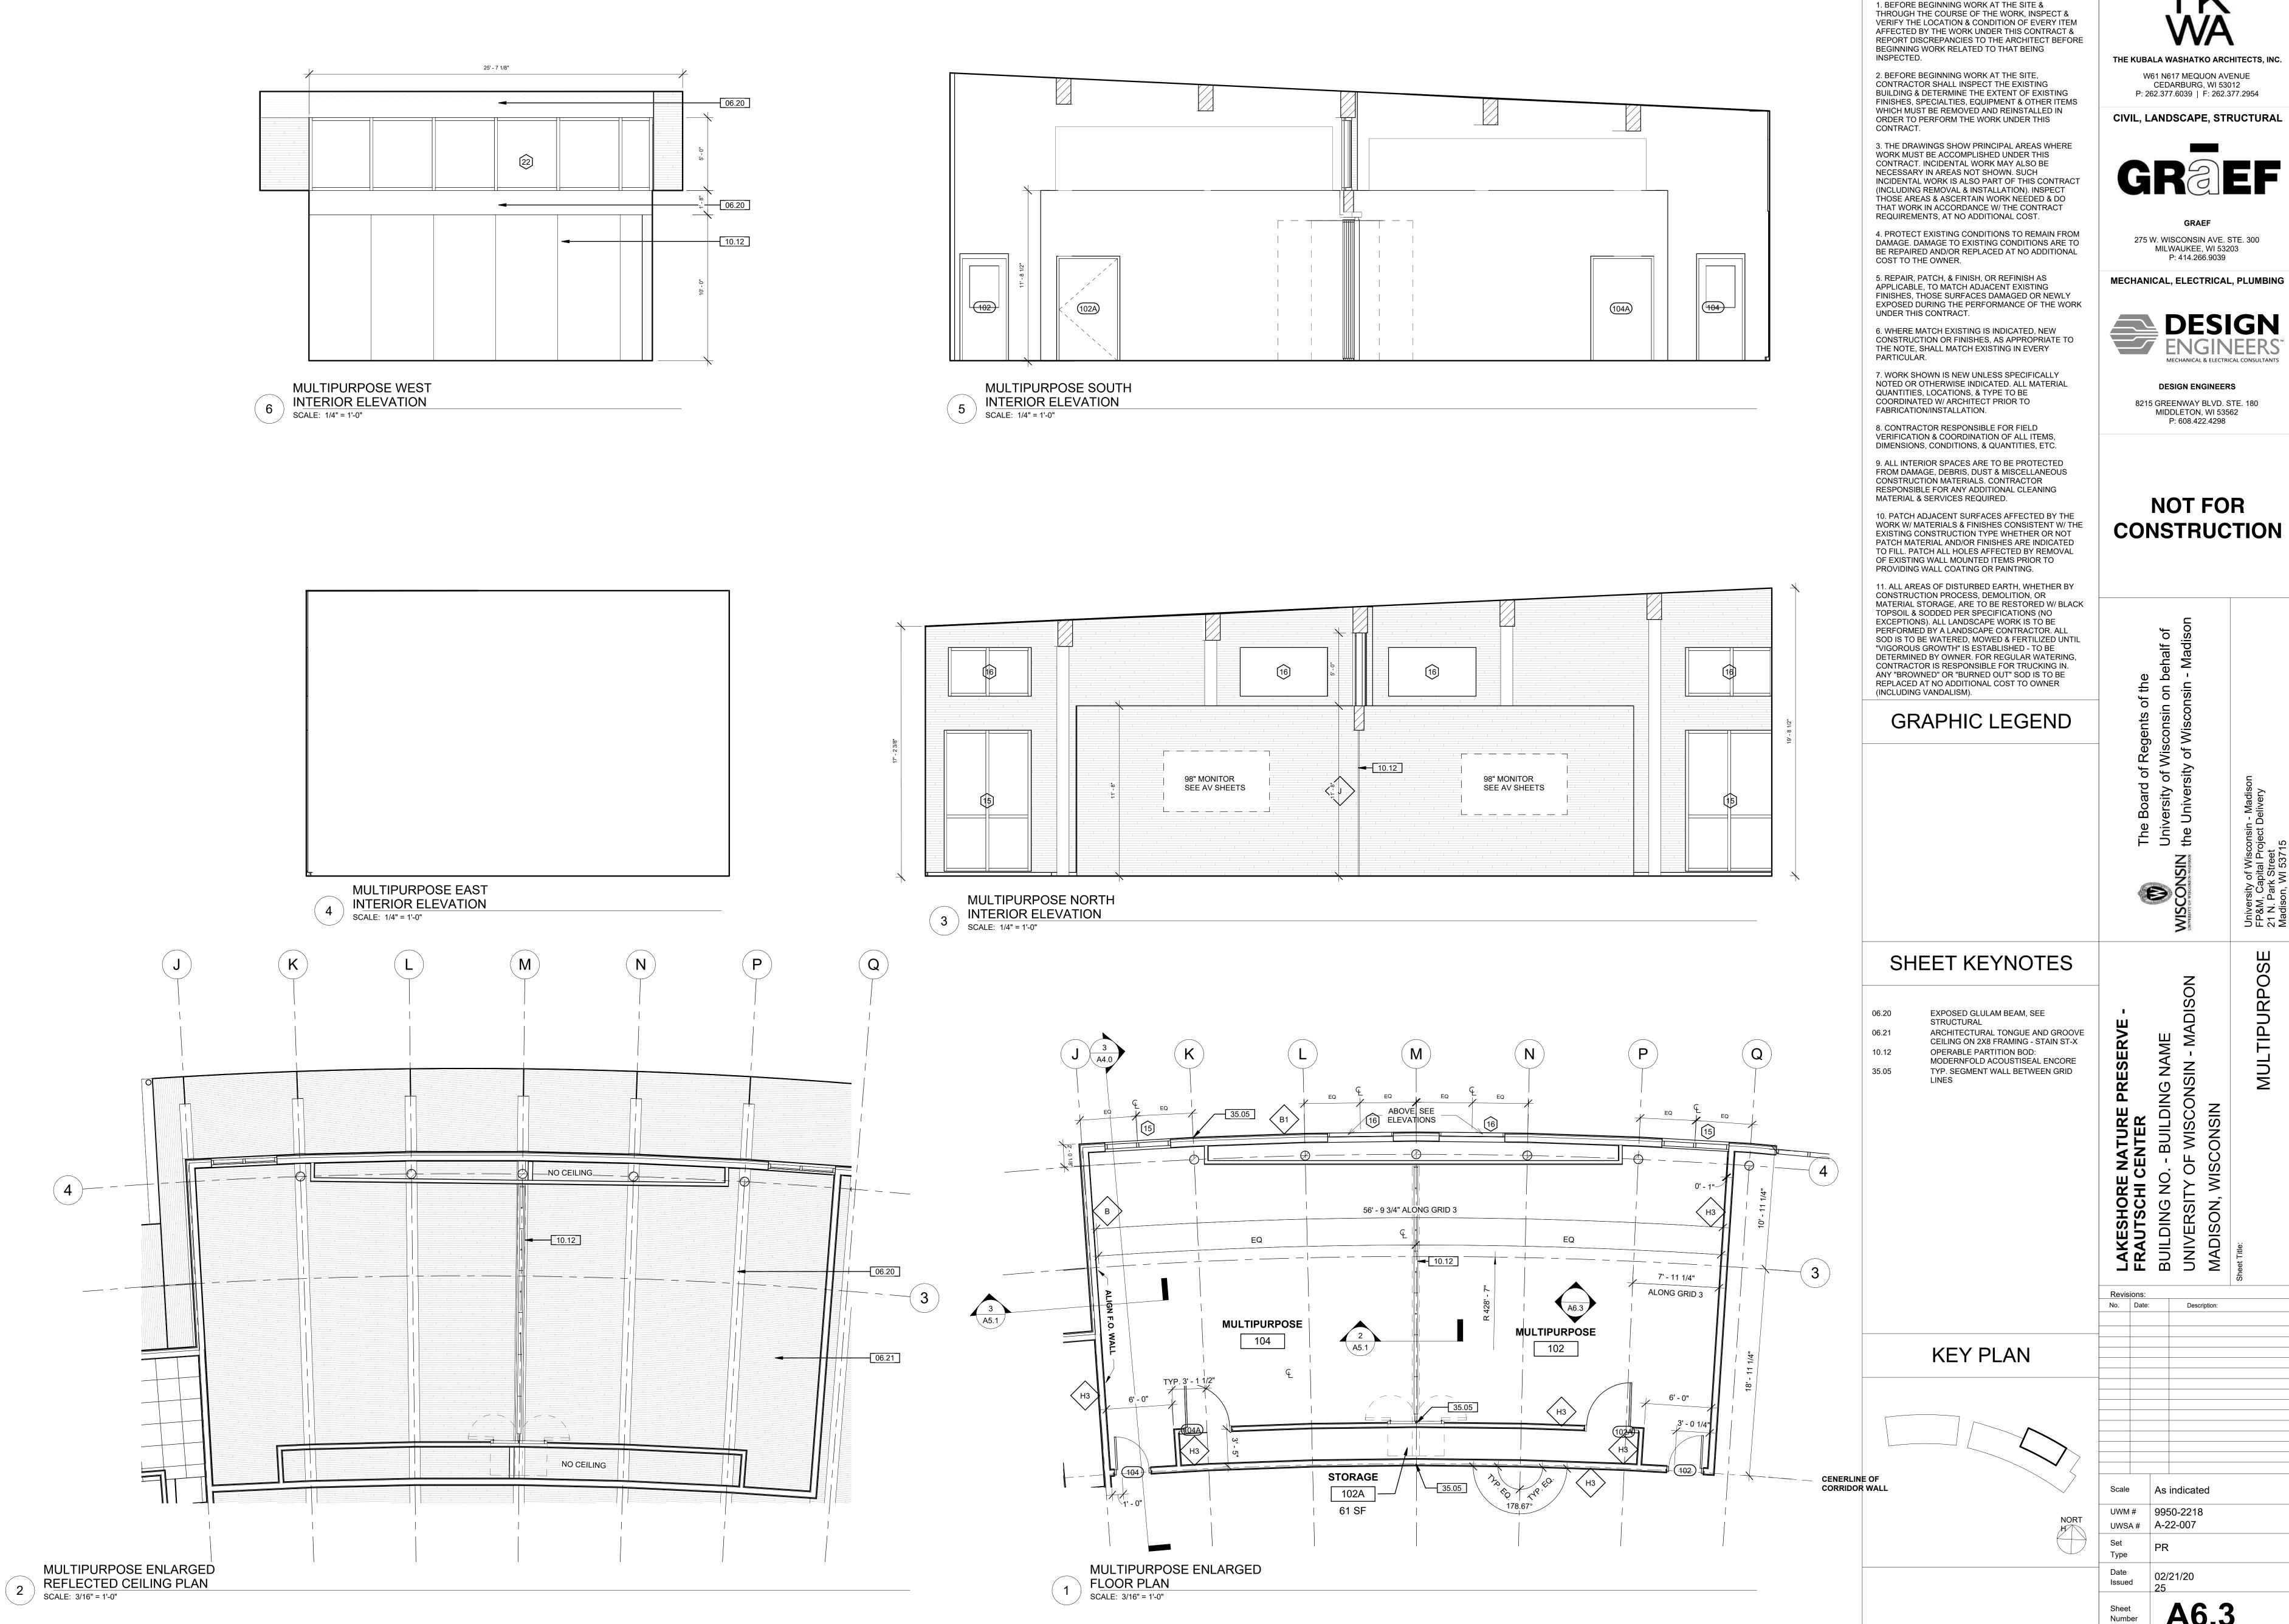
Date Issued 02/21/20

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No. Date:

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ot ate: 2 CORRIDOR WEST INTERIOR ELEVATION
SCALE: 1/4" = 1'-0"



ARCHITECT

GENERAL NOTES

THE KUBALA WASHATKO ARCHITECTS, INC. W61 N617 MEQUON AVENUE CEDARBURG, WI 53012 P: 262.377.6039 | F: 262.377.2954 CIVIL, LANDSCAPE, STRUCTURAL

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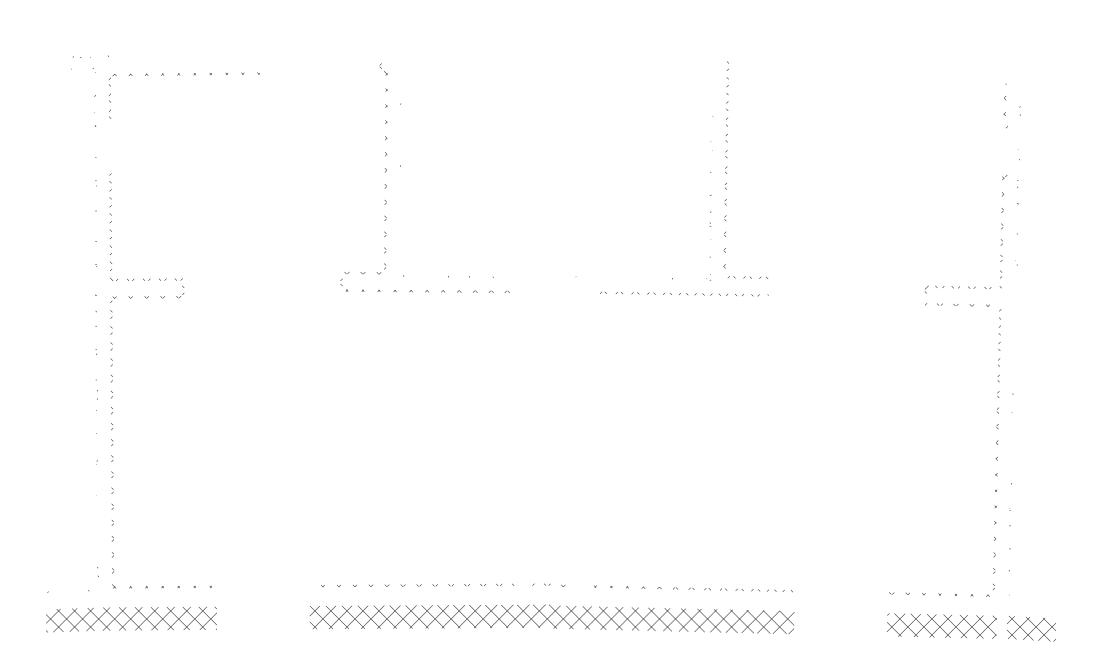
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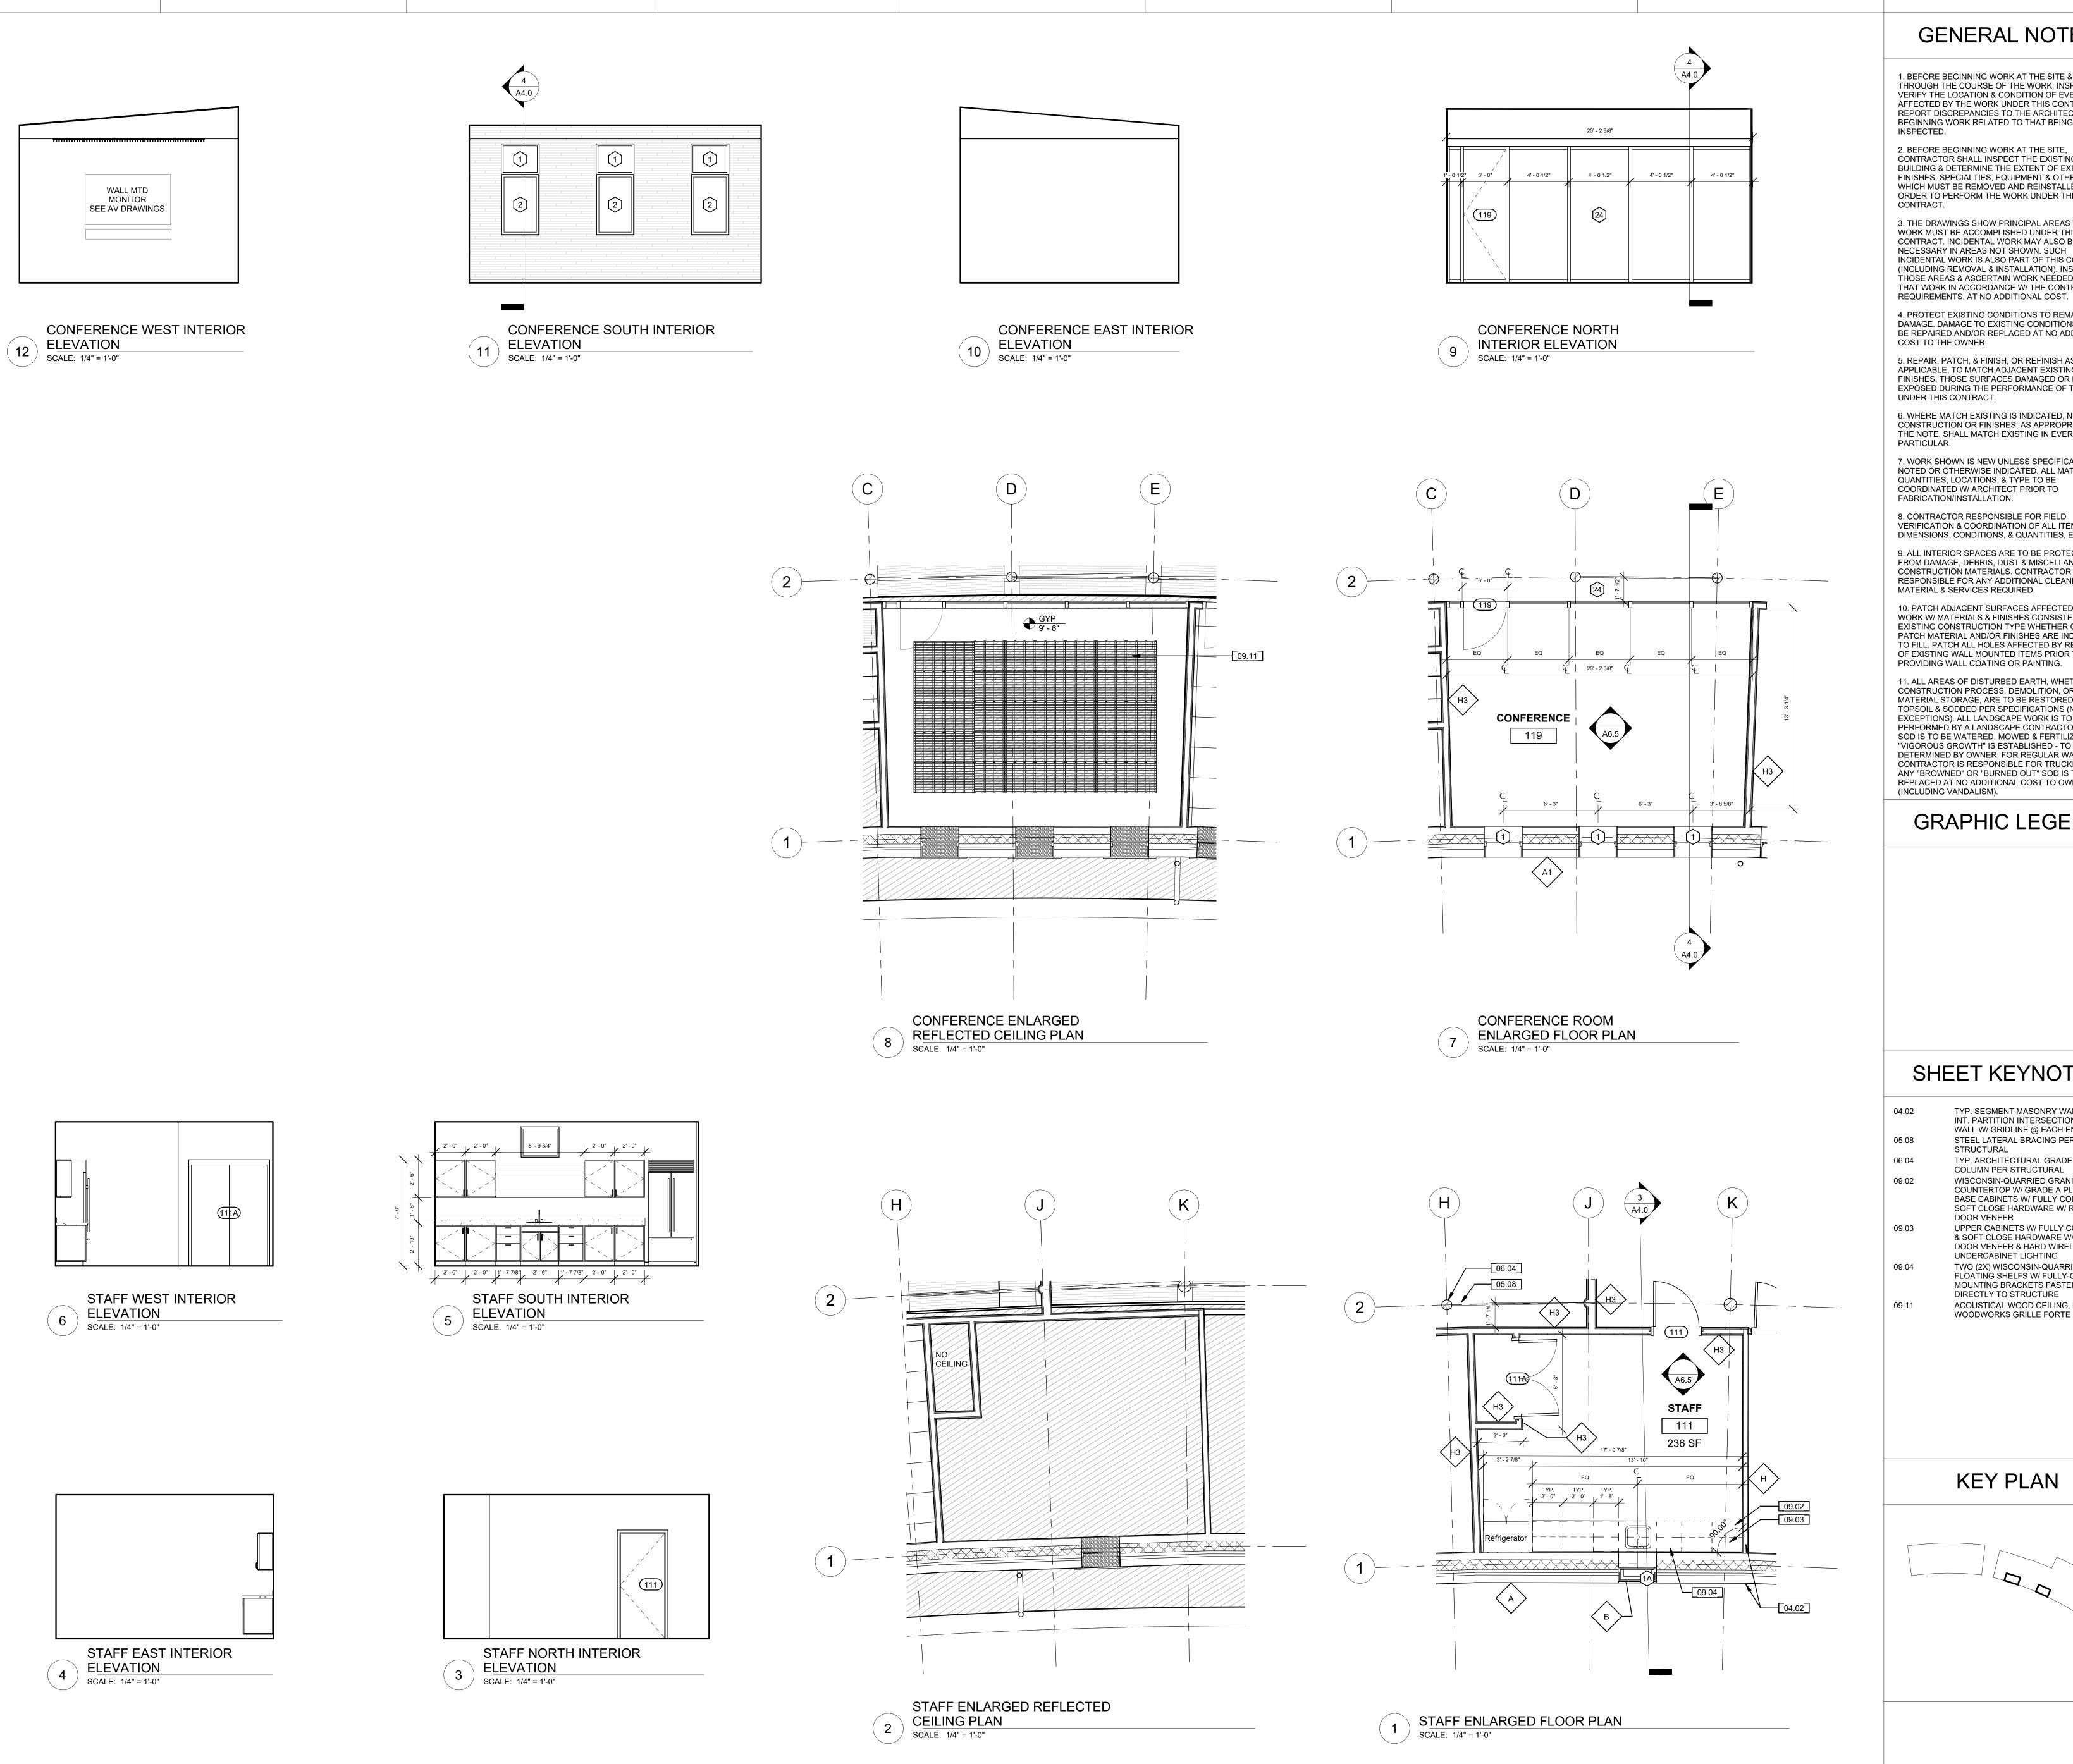
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As indicated 9950-2218 UWSA# A-22-007

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NOT FOR CONSTRUCTION





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DESIGN ENGINEERS 8215 GREENWAY BLVD. STE. 180 MIDDLETON, WI 53562 P: 608.422.4298

NOT FOR CONSTRUCTION

SHEET KEYNOTES

TYP. SEGMENT MASONRY WALL @ EACH INT. PARTITION INTERSECTION. ALIGN WALL W/ GRIDLINE @ EACH END STEEL LATERAL BRACING PER STRUCTURAL TYP. ARCHITECTURAL GRADE GLULAM COLUMN PER STRUCTURAL


WISCONSIN-QUARRIED GRANITE COUNTERTOP W/ GRADE A PLYWOOD BASE CABINETS W/ FULLY CONCEALED & SOFT CLOSE HARDWARE W/ RIFT-SAWN DOOR VENEER UPPER CABINETS W/ FULLY CONCEALED & SOFT CLOSE HARDWARE W/ RIFT-SAWN DOOR VENEER & HARD WIRED

UNDERCABINET LIGHTING TWO (2X) WISCONSIN-QUARRIED GRANITE FLOATING SHELFS W/ FULLY-CONCEALED MOUNTING BRACKETS FASTENED DIRECTLY TO STRUCTURE ACOUSTICAL WOOD CEILING, BOD: WOODWORKS GRILLE FORTE

Description:

No. Date:


KEY PLAN

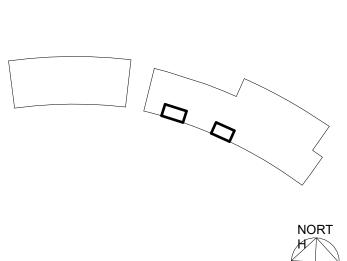

As indicated 9950-2218 UWSA# A-22-007 Issued

A6.5

Sheet Number

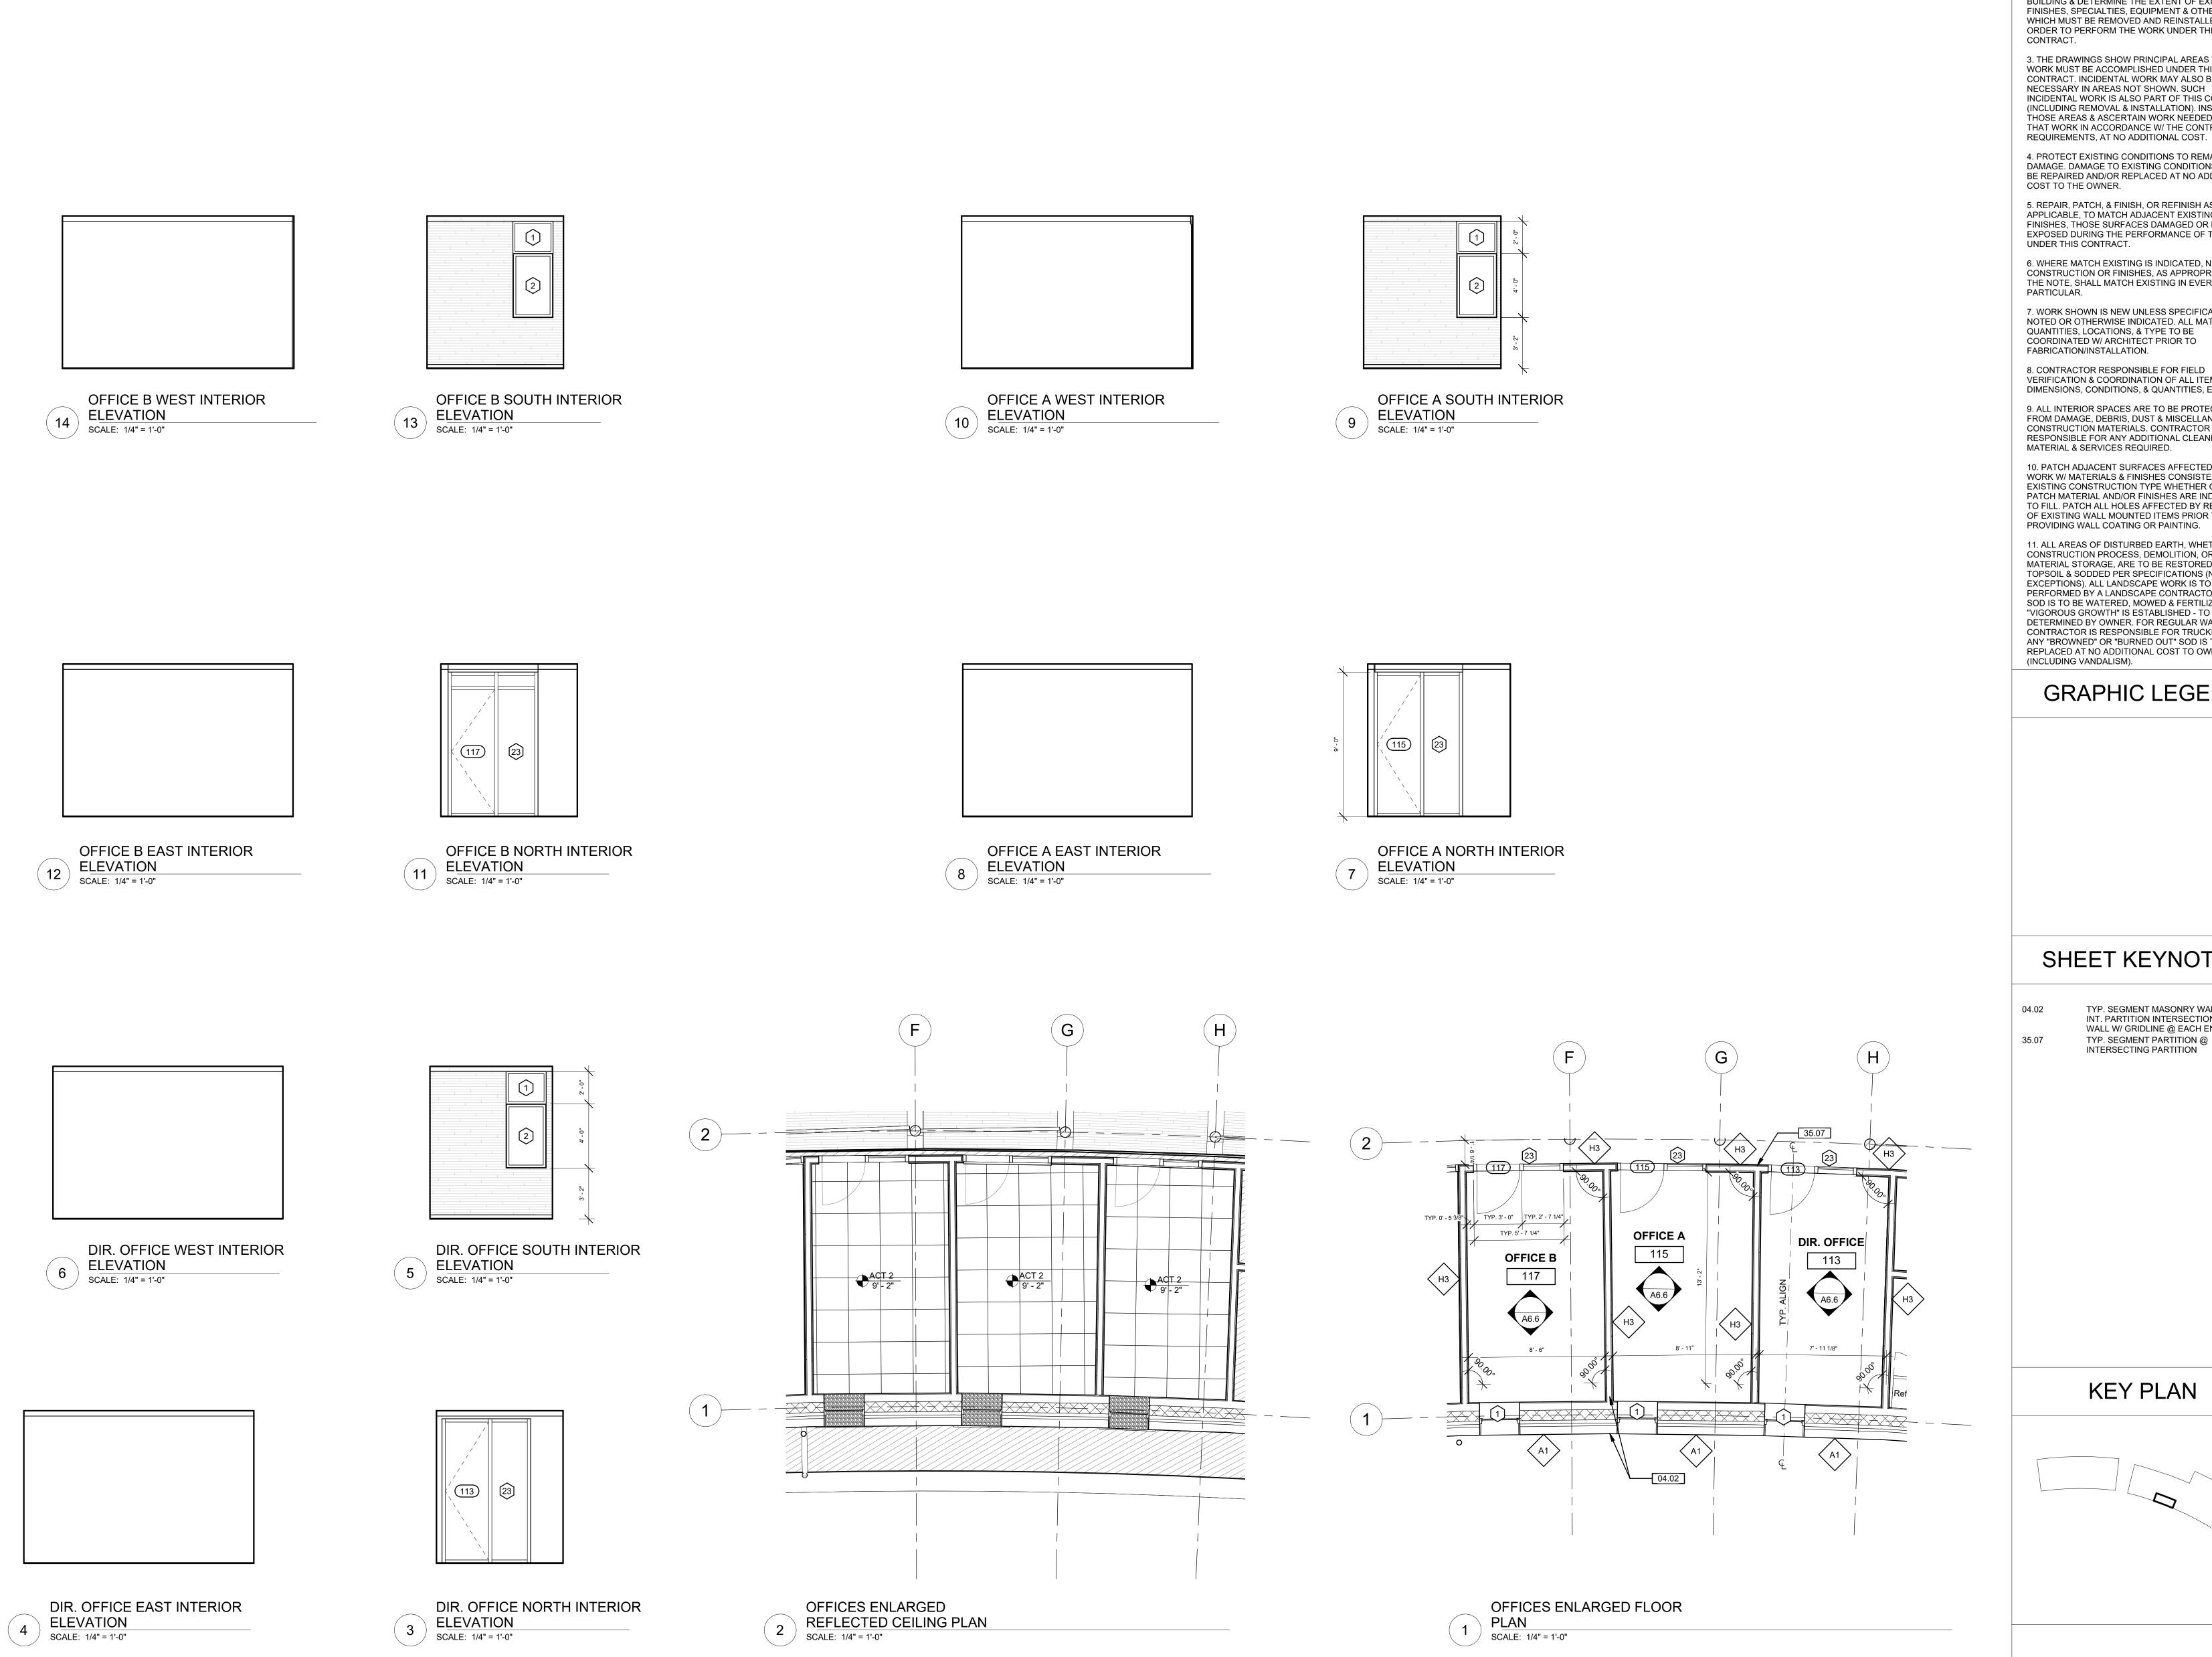

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ARCHITECT

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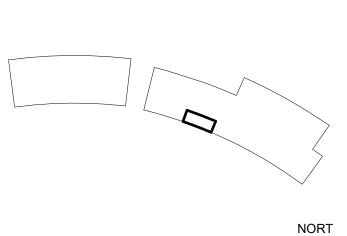
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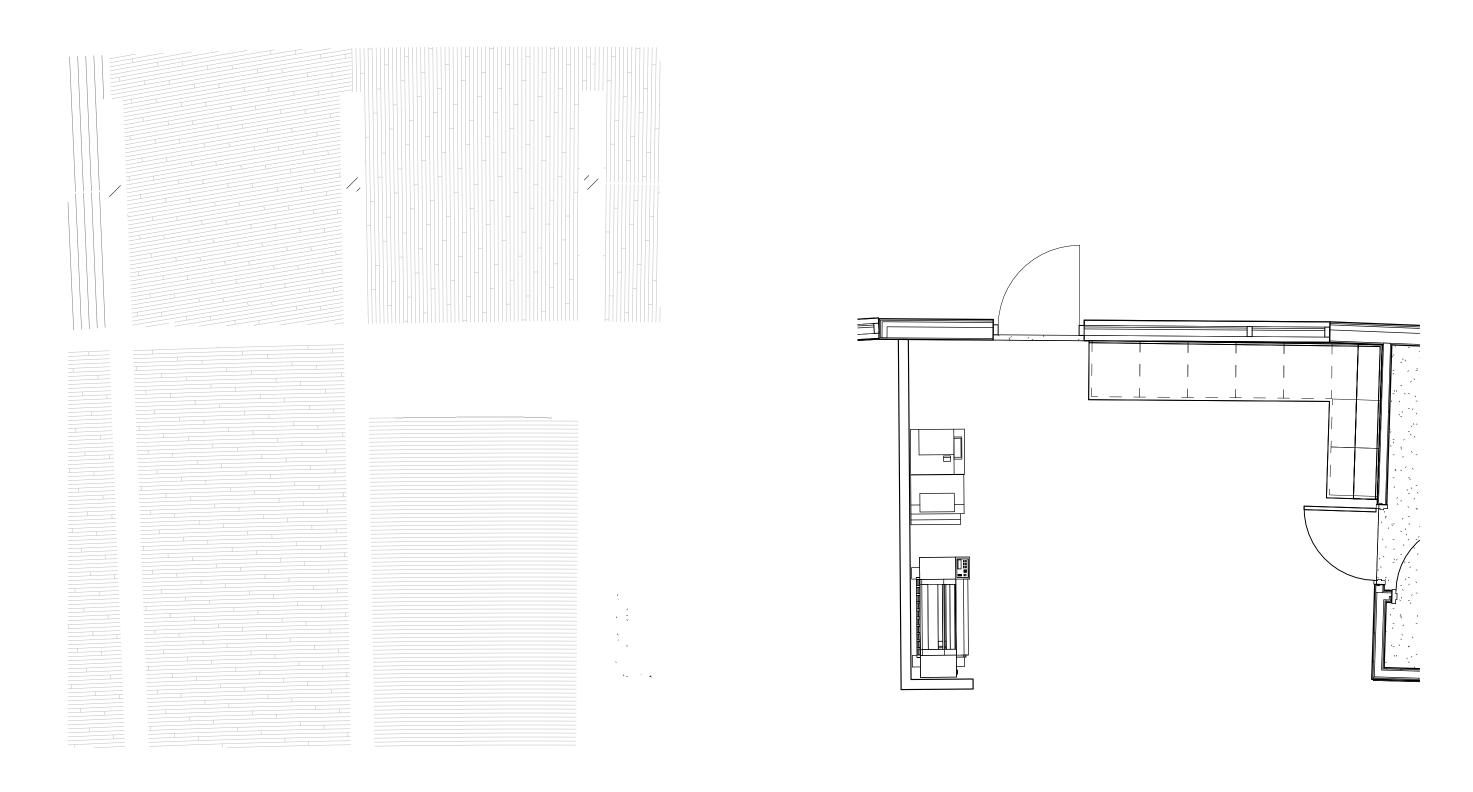


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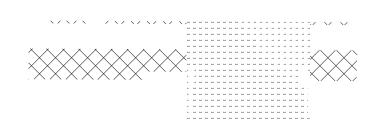
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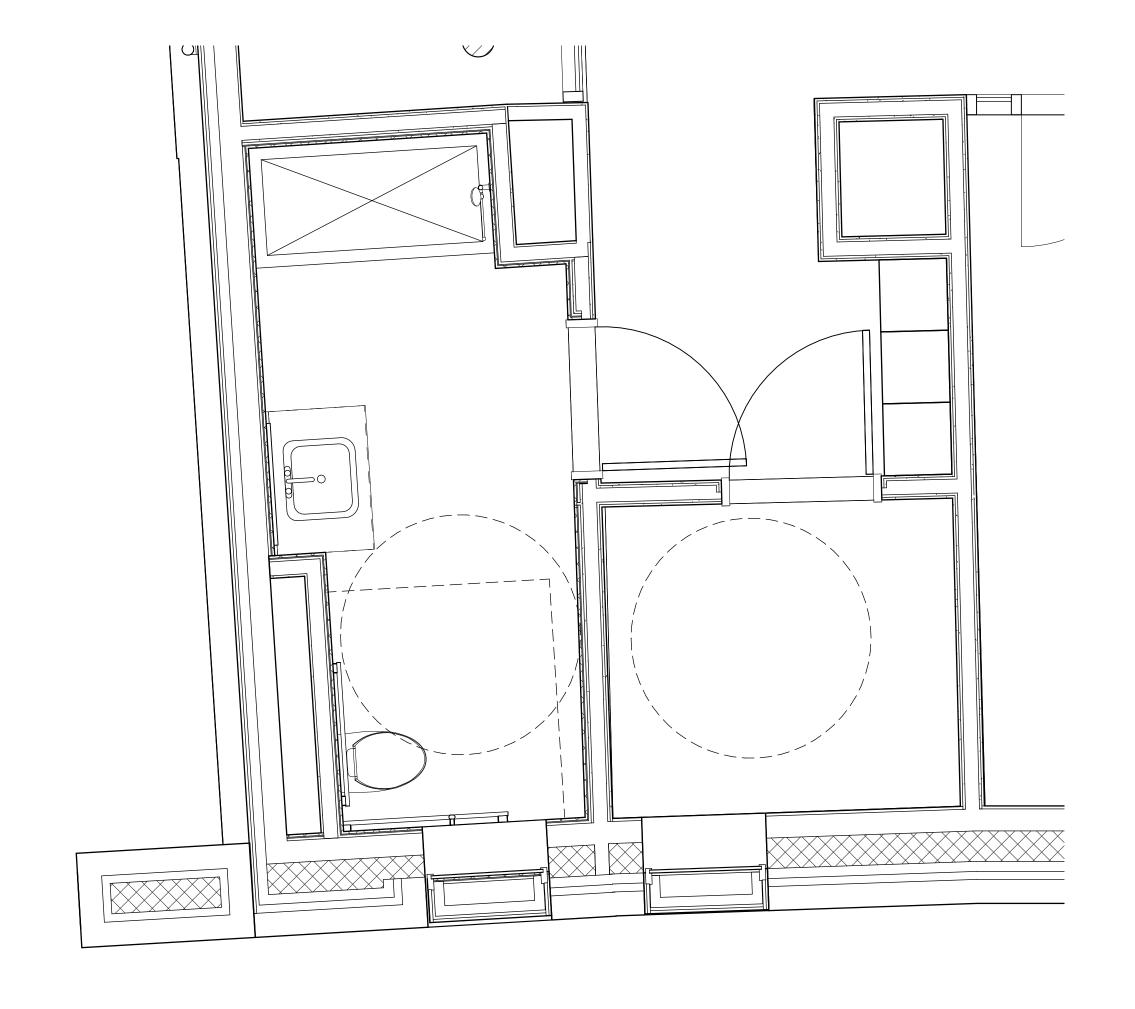
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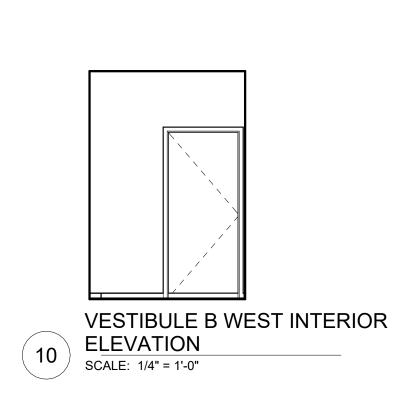
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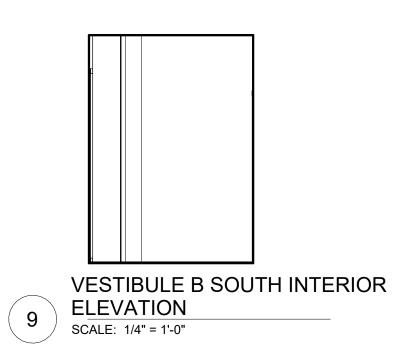



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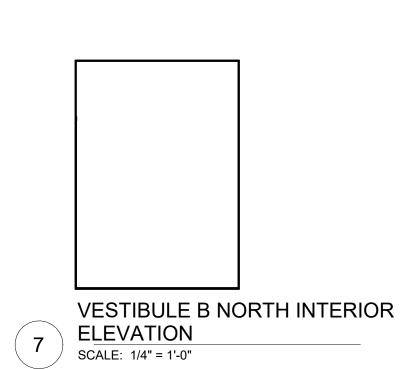













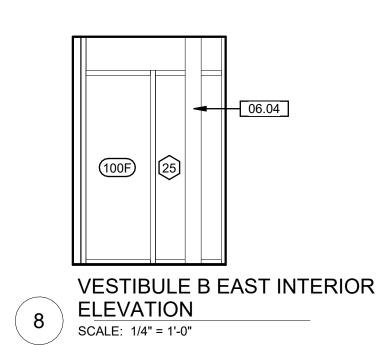

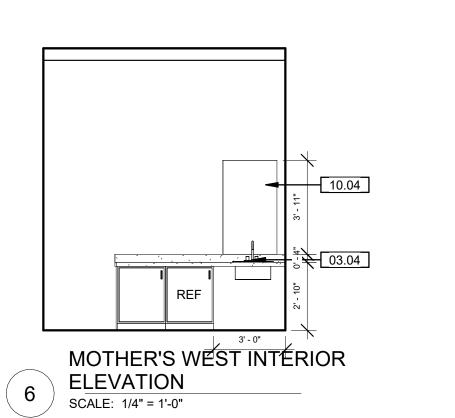




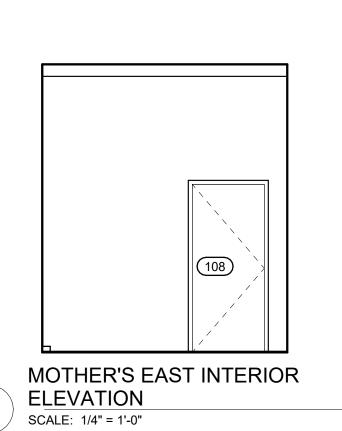

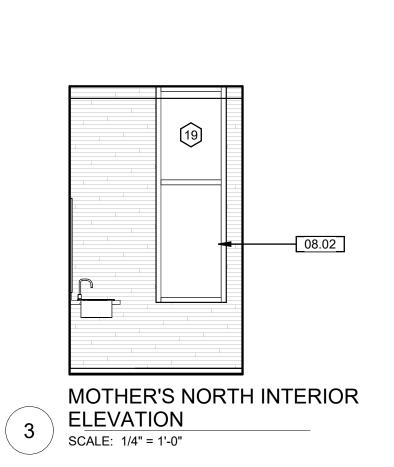



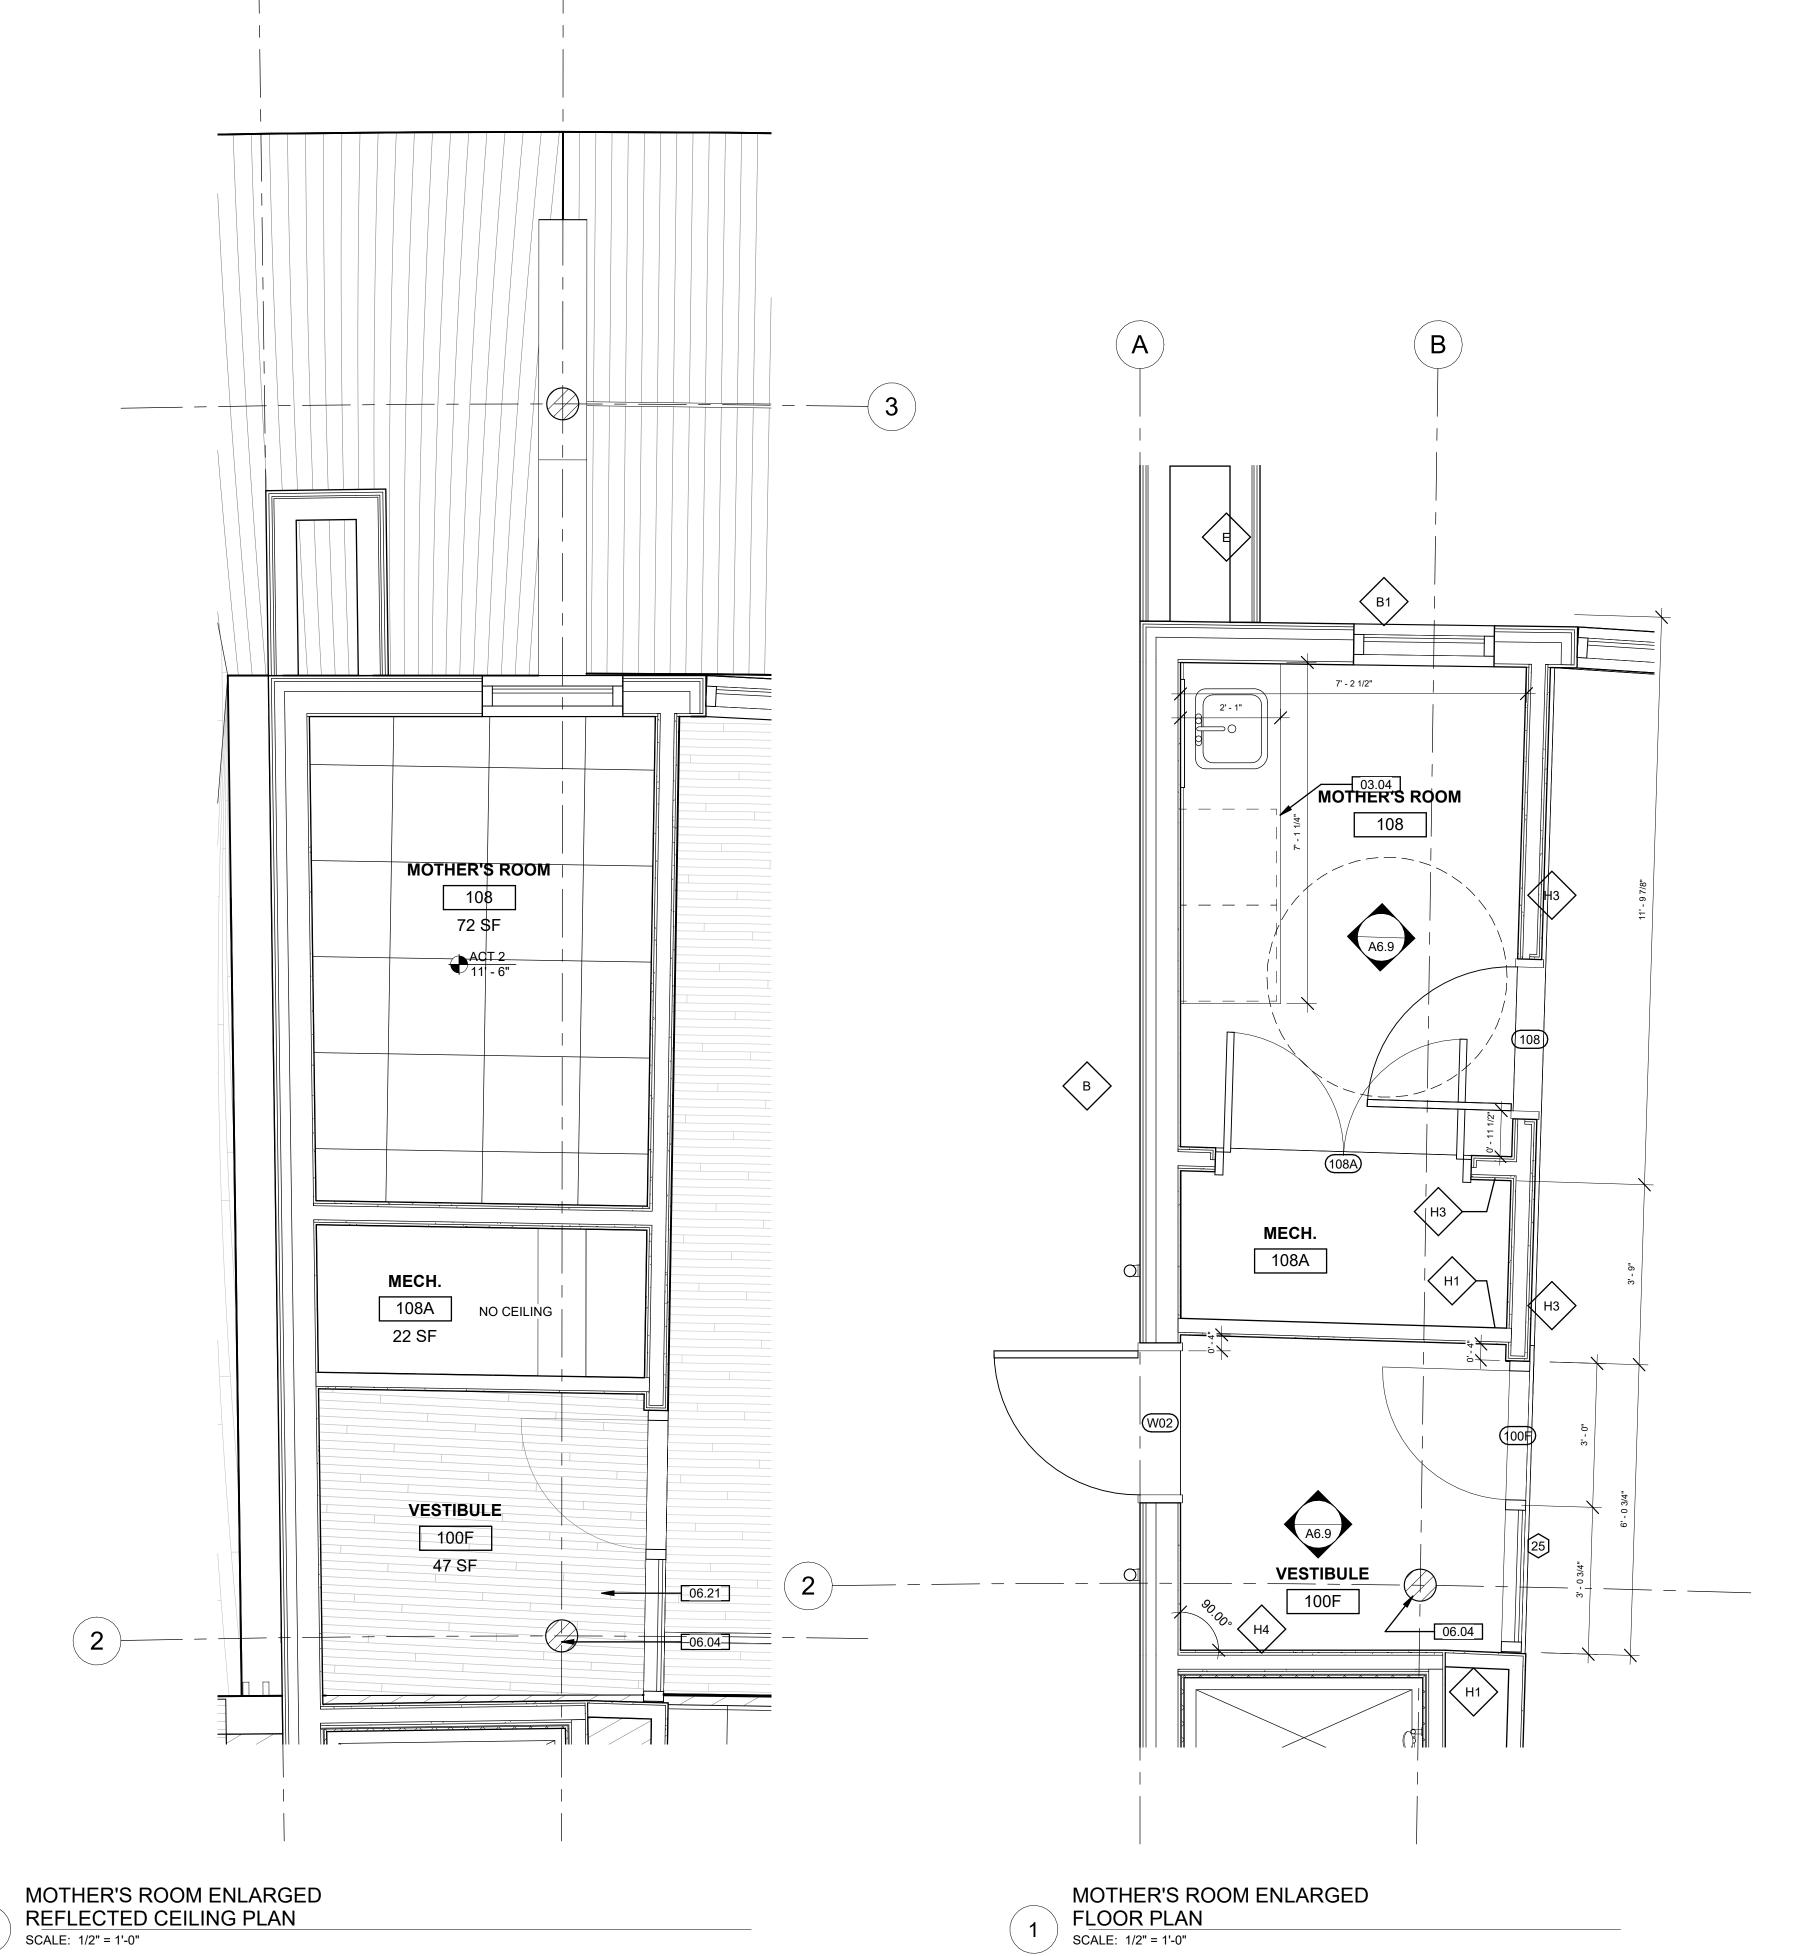

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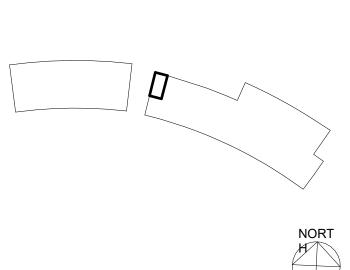
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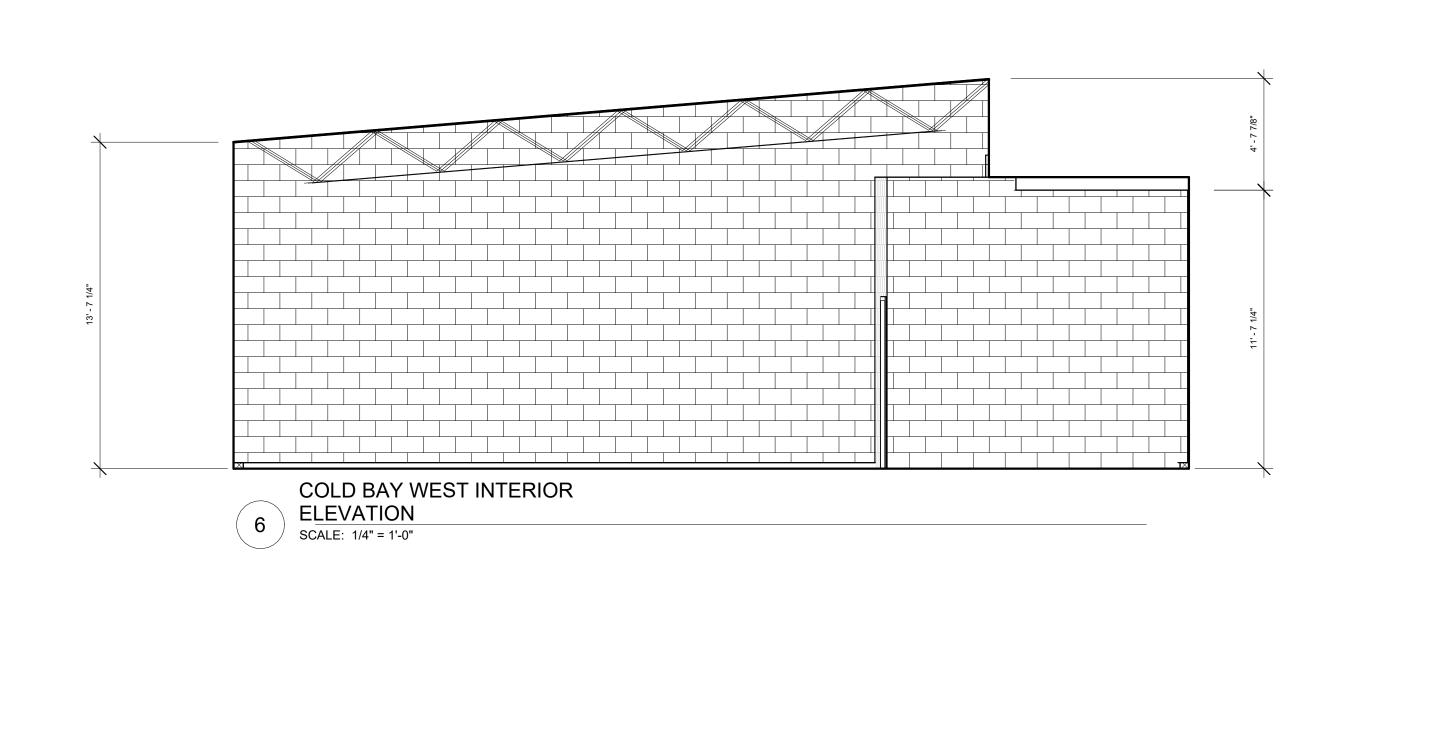
CONCRETE COUNTERTOP
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COLUMN PER STRUCTURAL
ARCHITECTURAL TONGUE AND GROOVE
CEILING ON 2X8 FRAMING - STAIN ST-X
PRIVACY FILM ON WINDOW GLAZING UNIT 06.04 METAL FRAME MIRROR


Description: No. Date:

KEY PLAN



Scale	As indicated					
UWM#	9950-2218					
UWSA#	A-22-007					
Set Type	PR					
Date Issued	02/21/20 25					
Sheet Number	A6.9					



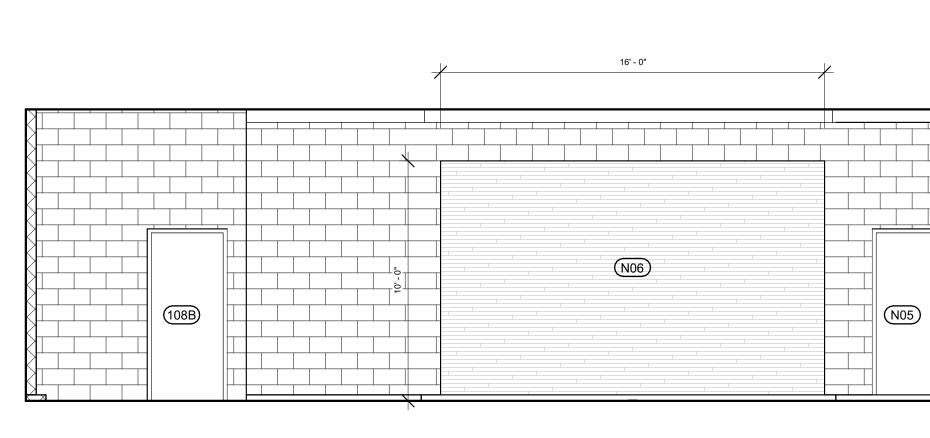


7' - 11 7/8"

COLD BAY EAST INTERIOR

SCALE: 1/4" = 1'-0"


3 COLD BAY NORTH INTERIOR ELEVATION
SCALE: 1/4" = 1'-0"

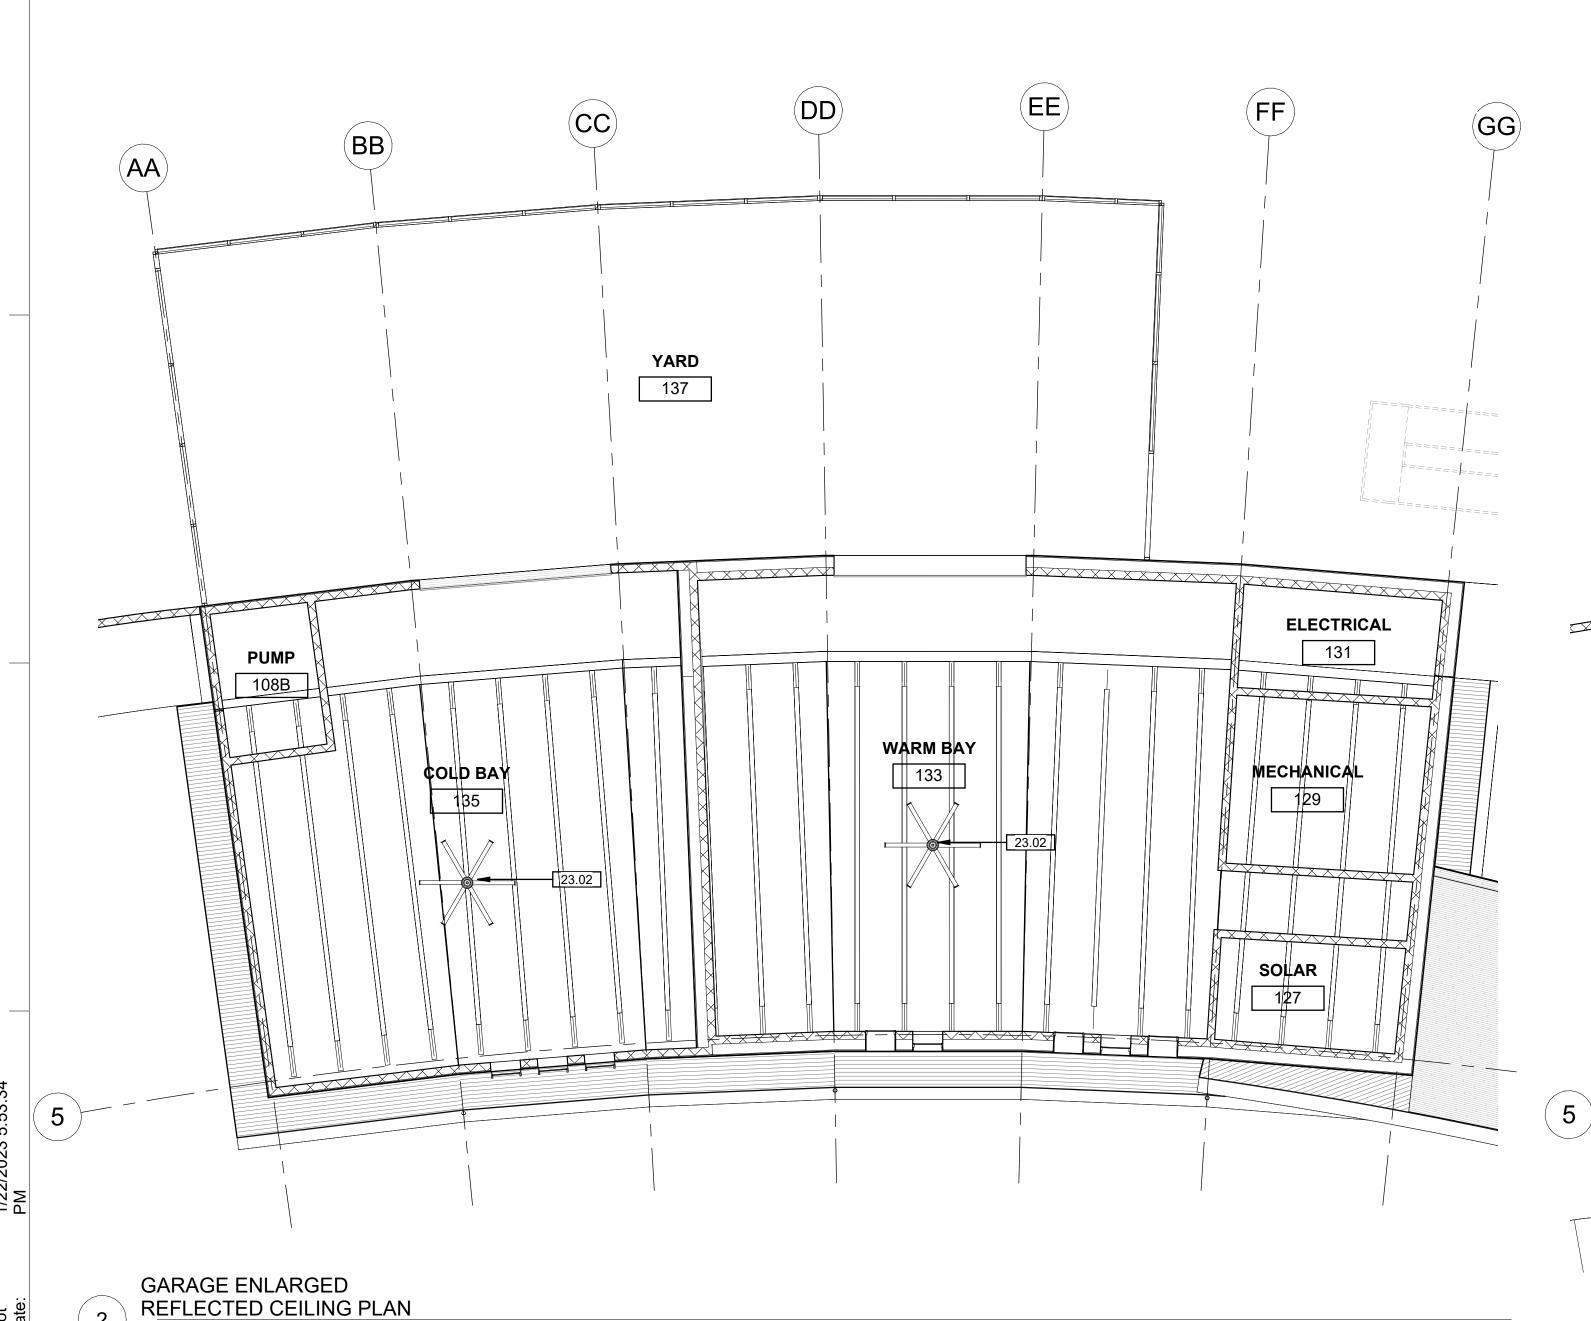

COLD BAY SOUTH INTERIOR

4 ELEVATION SCALE: 1/4" = 1'-0"

SCALE: 1/8" = 1'-0"

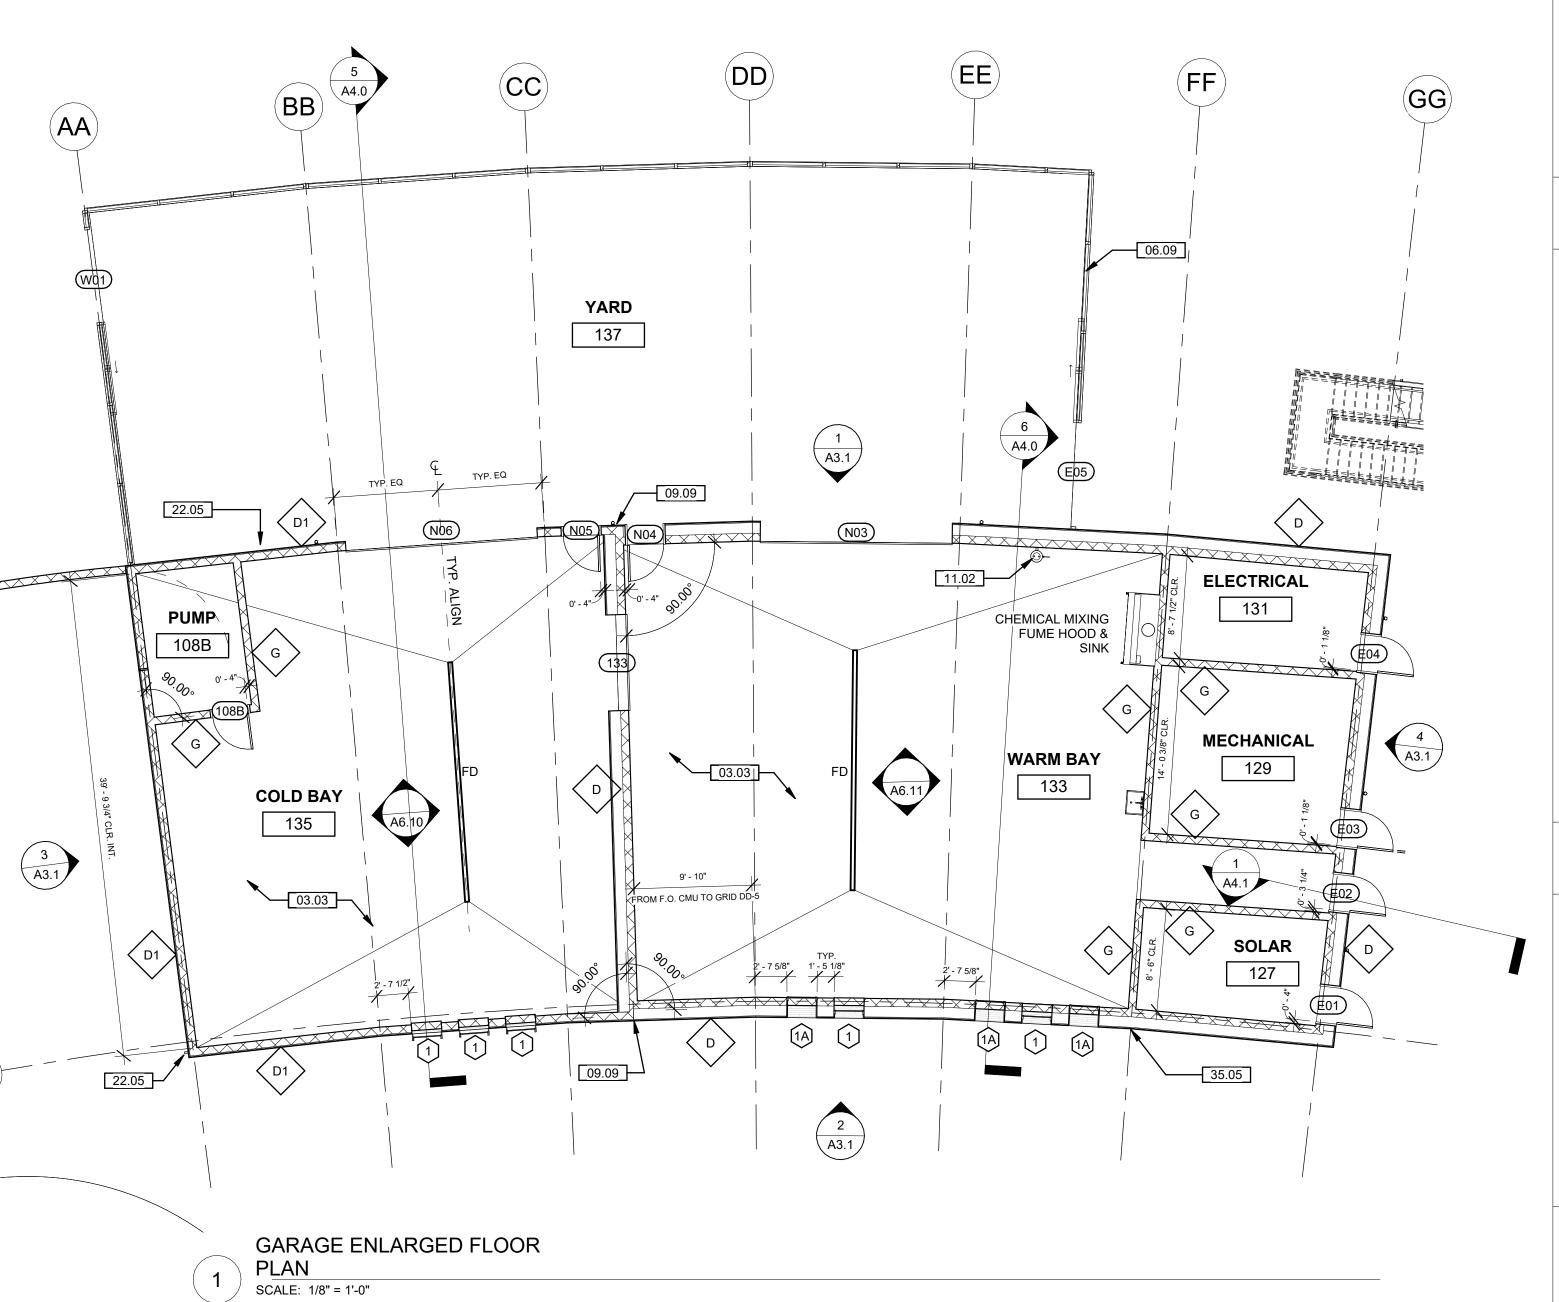

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06.01

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GRAPHIC LEGEND

THE KUBALA WASHATKO ARCHITECTS, INC.
W61 N617 MEQUON AVENUE

CIVIL, LANDSCAPE, STRUCTURAL

CEDARBURG, WI 53012

P: 262.377.6039 | F: 262.377.2954



275 W. WISCONSIN AVE. STE. 300 MILWAUKEE, WI 53203

P: 414.266.9039

MECHANICAL, ELECTRICAL, PLUMBING



DESIGN ENGINEERS 215 GREENWAY BLVD. STE. 180

8215 GREENWAY BLVD. STE. 180 MIDDLETON, WI 53562 P: 608.422.4298

NOT FOR CONSTRUCTION

The Board of Regents of the University of Wisconsin on behalf of NSIN the University of Wisconsin - Madison

SHEET KEYNOTES

SLOPE FLOOR SLAB 1/8" PER FOOT
TOWARDS FLOOR DRAIN

THERMALLY-MODIFIED RIFT SAWN ASH
T&G SIDING W/ 7" EXPOSURE IN NATURAL
FINISH

THERMALLY MODIFIED WOOD FENCE:
MASS TIMBER FRAMING W/ THERMALLY
MODIFIED WOOD INFILL & SLATTED
GATES


09.09 ALIGN EXTERIOR F.O. CLADDING
11.02 EYE WASH STATION
22.05 HOSE BIB
23.02 HVLS FAN SEE MECHANICAL
35.05 TYP. SEGMENT WALL BETWEEN GRID LINES

SHORE NATURE PRESEITSCHI CENTER
ING NO. - BUILDING NANERSITY OF WISCONSIN - SON, WISCONSIN

Description:

No. Date:



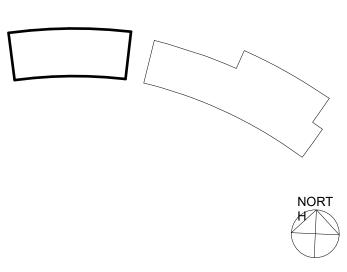


Scale As indicated

UWM # 9950-2218

UWSA # A-22-007

Date | 02/21/20 | 25

A6.10

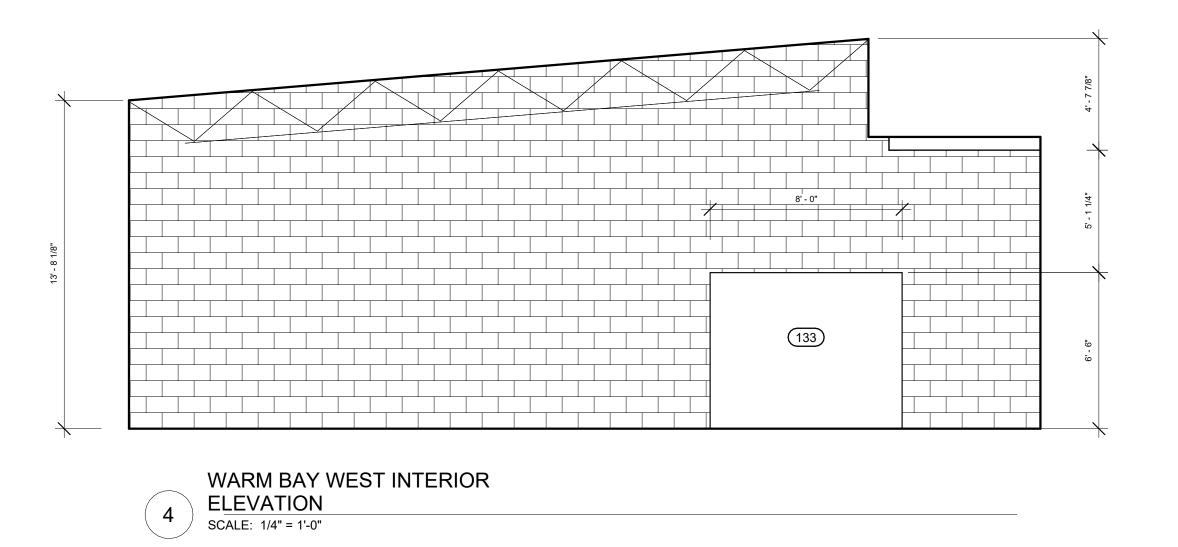


2-6 1-456 2-6 1-4


WARM BAY SOUTH INTERIOR

ELEVATION

SCALE: 1/4" = 1'-0"

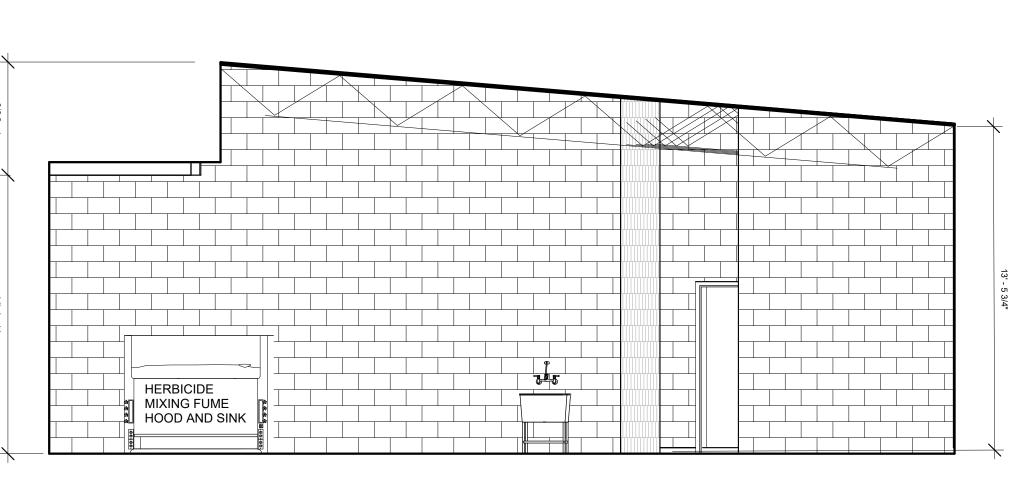

WARM BAY EAST INTERIOR
ELEVATION
SCALE: 1/4" = 1'-0"

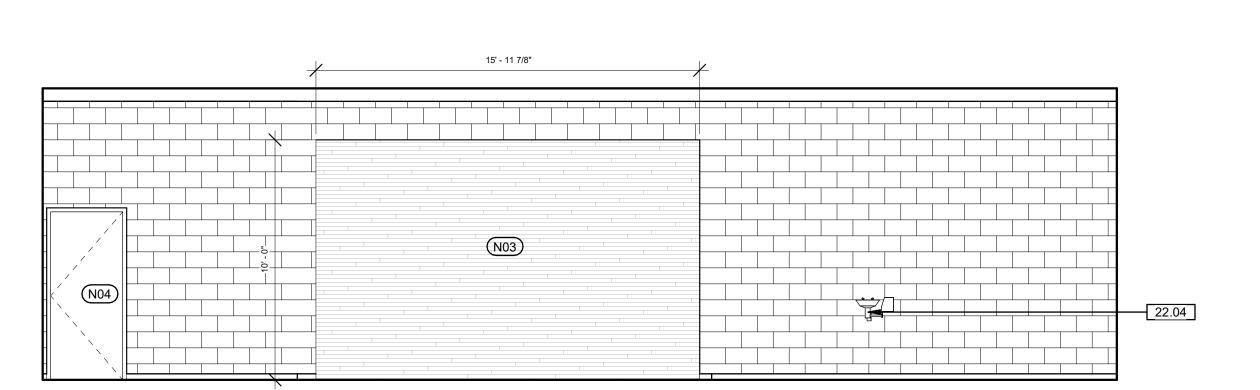

WARM BAY NORTH INTERIOR

ELEVATION

SCALE: 1/4" = 1'-0"

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MECHANICAL & ELECTRICAL CONSULTANTS

DESIGN ENGINEERS

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MIDDLETON, WI 53562 P: 608.422.4298

NOT FOR

CONSTRUCTION

nts of the nsin on behalf of sconsin - Madison

University of Wisconsi

WISCON UNIVERSITY OF WISCON

SHEET KEYNOTES

EMERGENCY EYE WASH


22.04

AKESHORE NATURE PRESERVE RAUTSCHI CENTER
UILDING NO. - BUILDING NAME
INIVERSITY OF WISCONSIN - MAD

Revisions:

No. Date: Description:

KEY PLAN

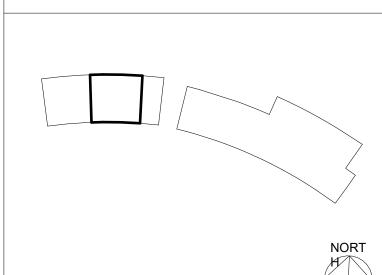

Scale As indicated


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UWSA# A-22-007

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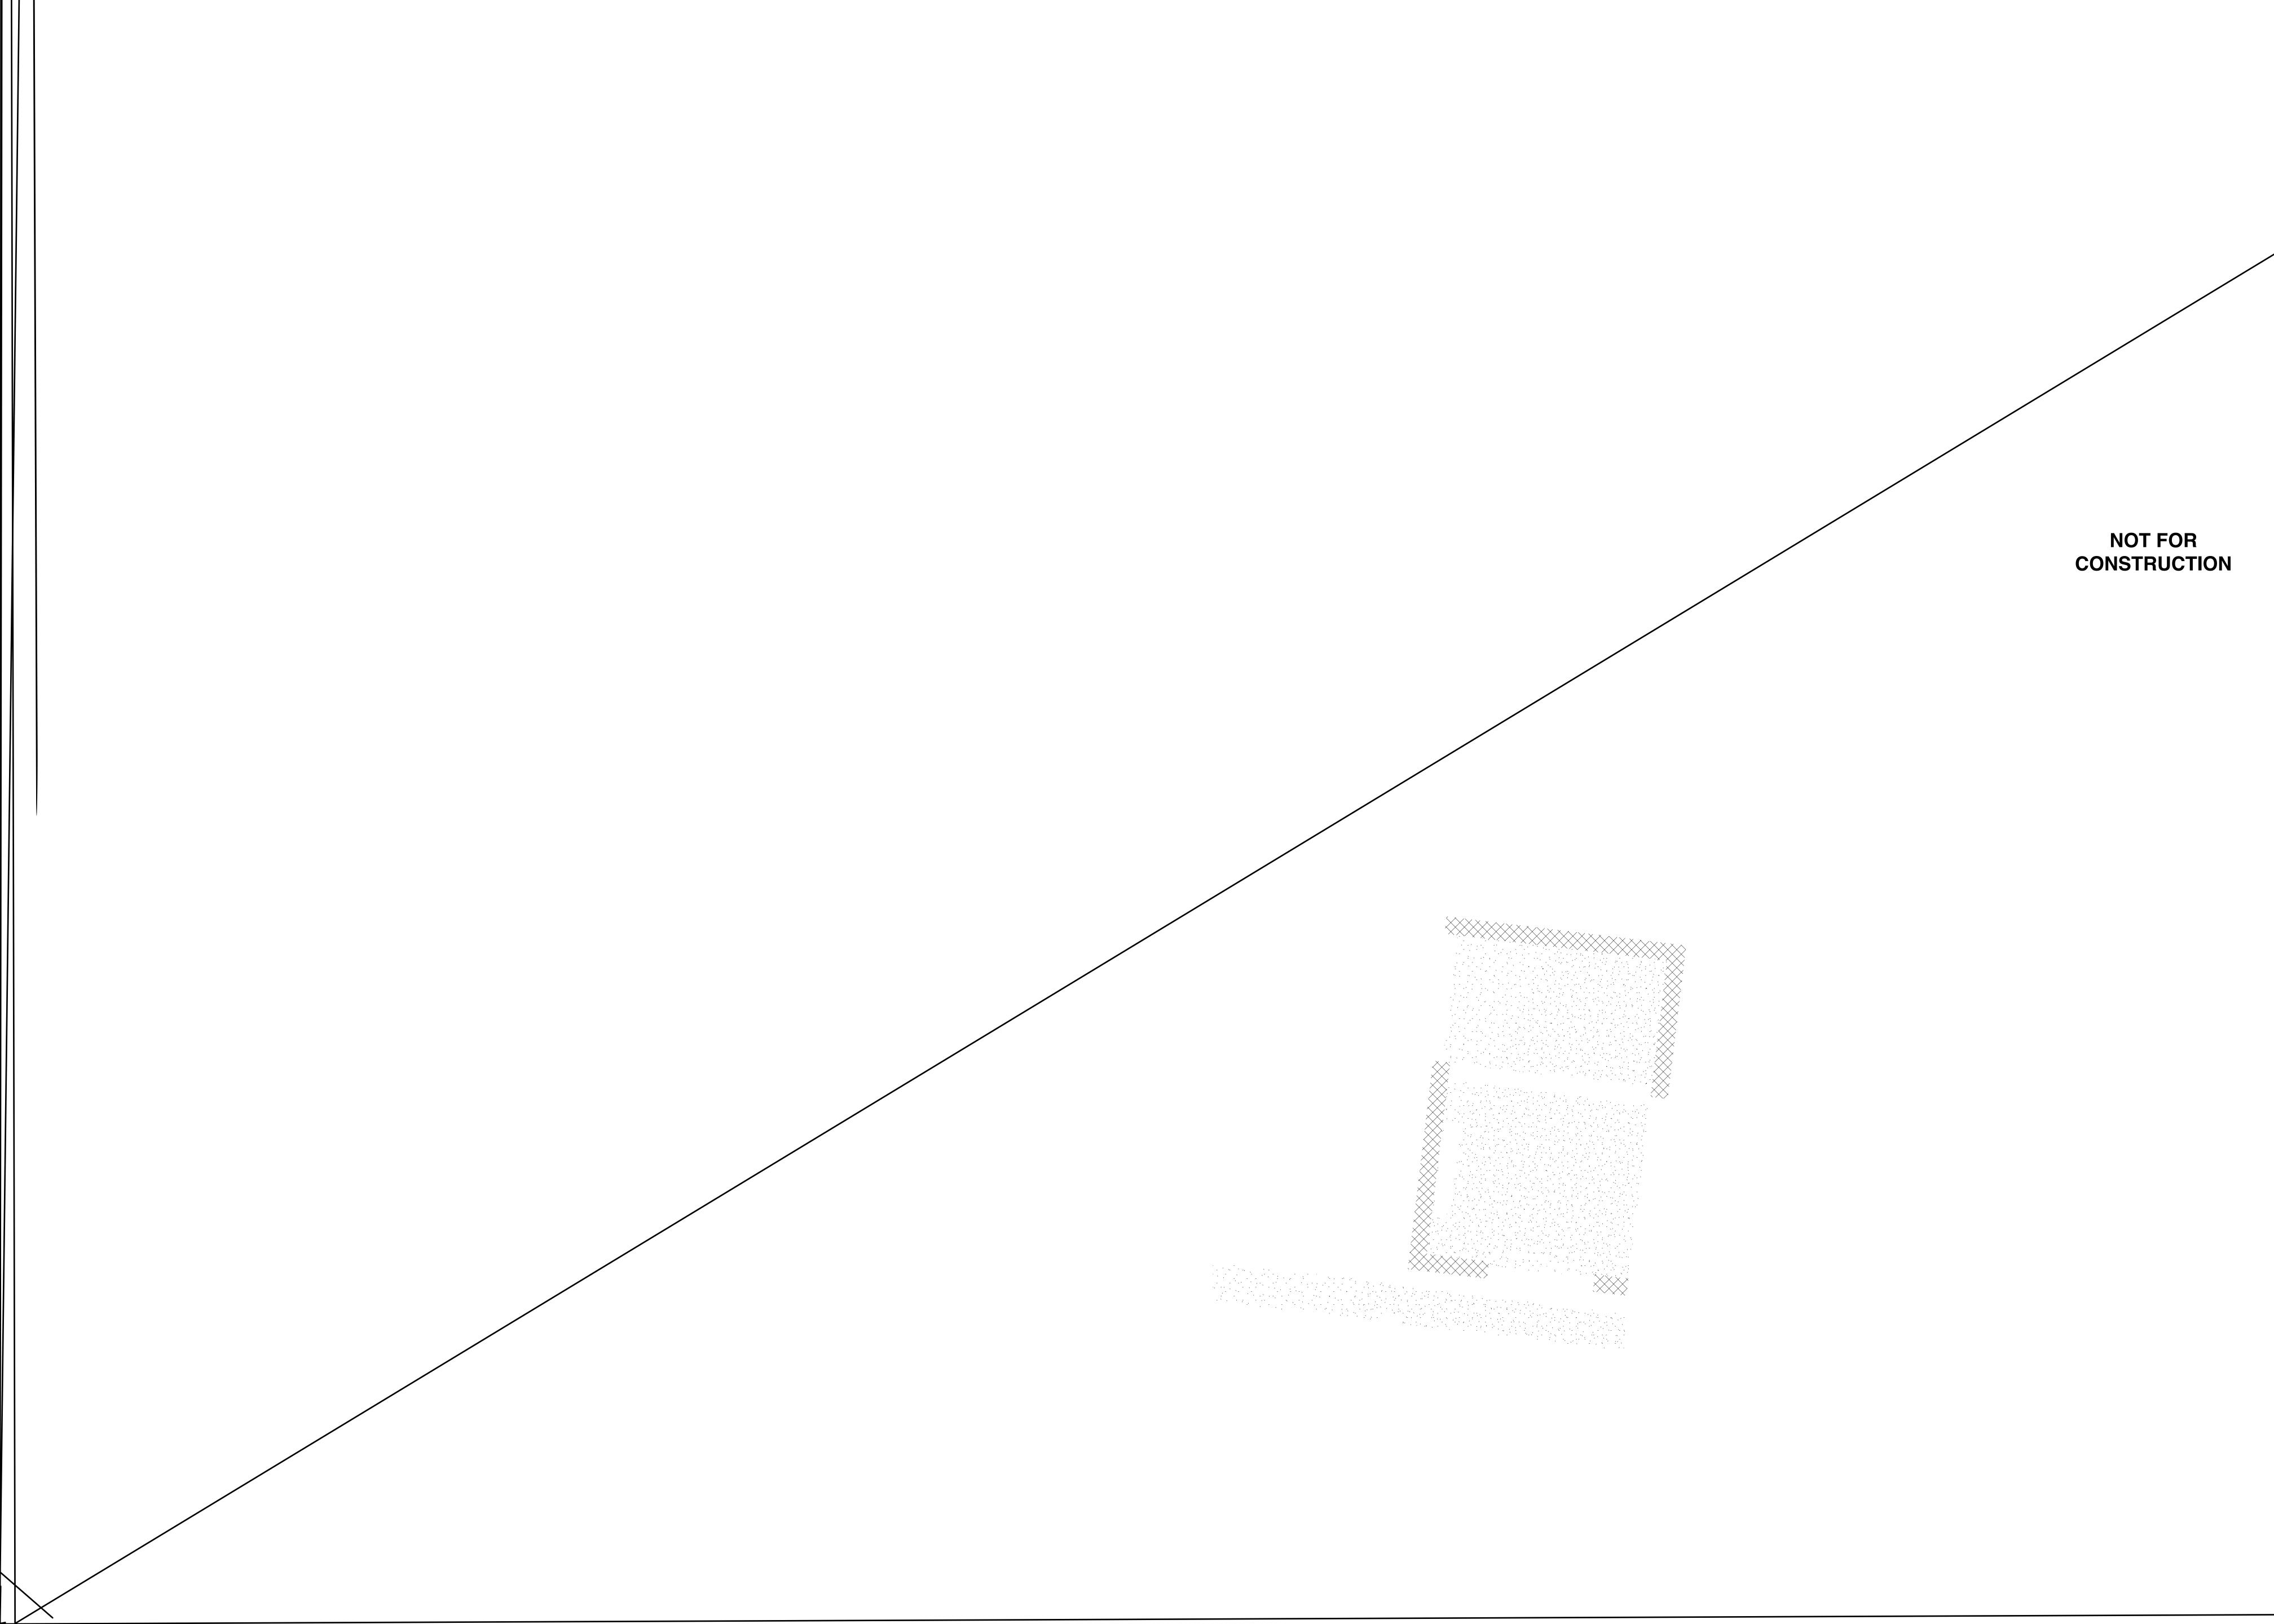
Date | 02/21/20 | 25

A6.11

Plot Date:

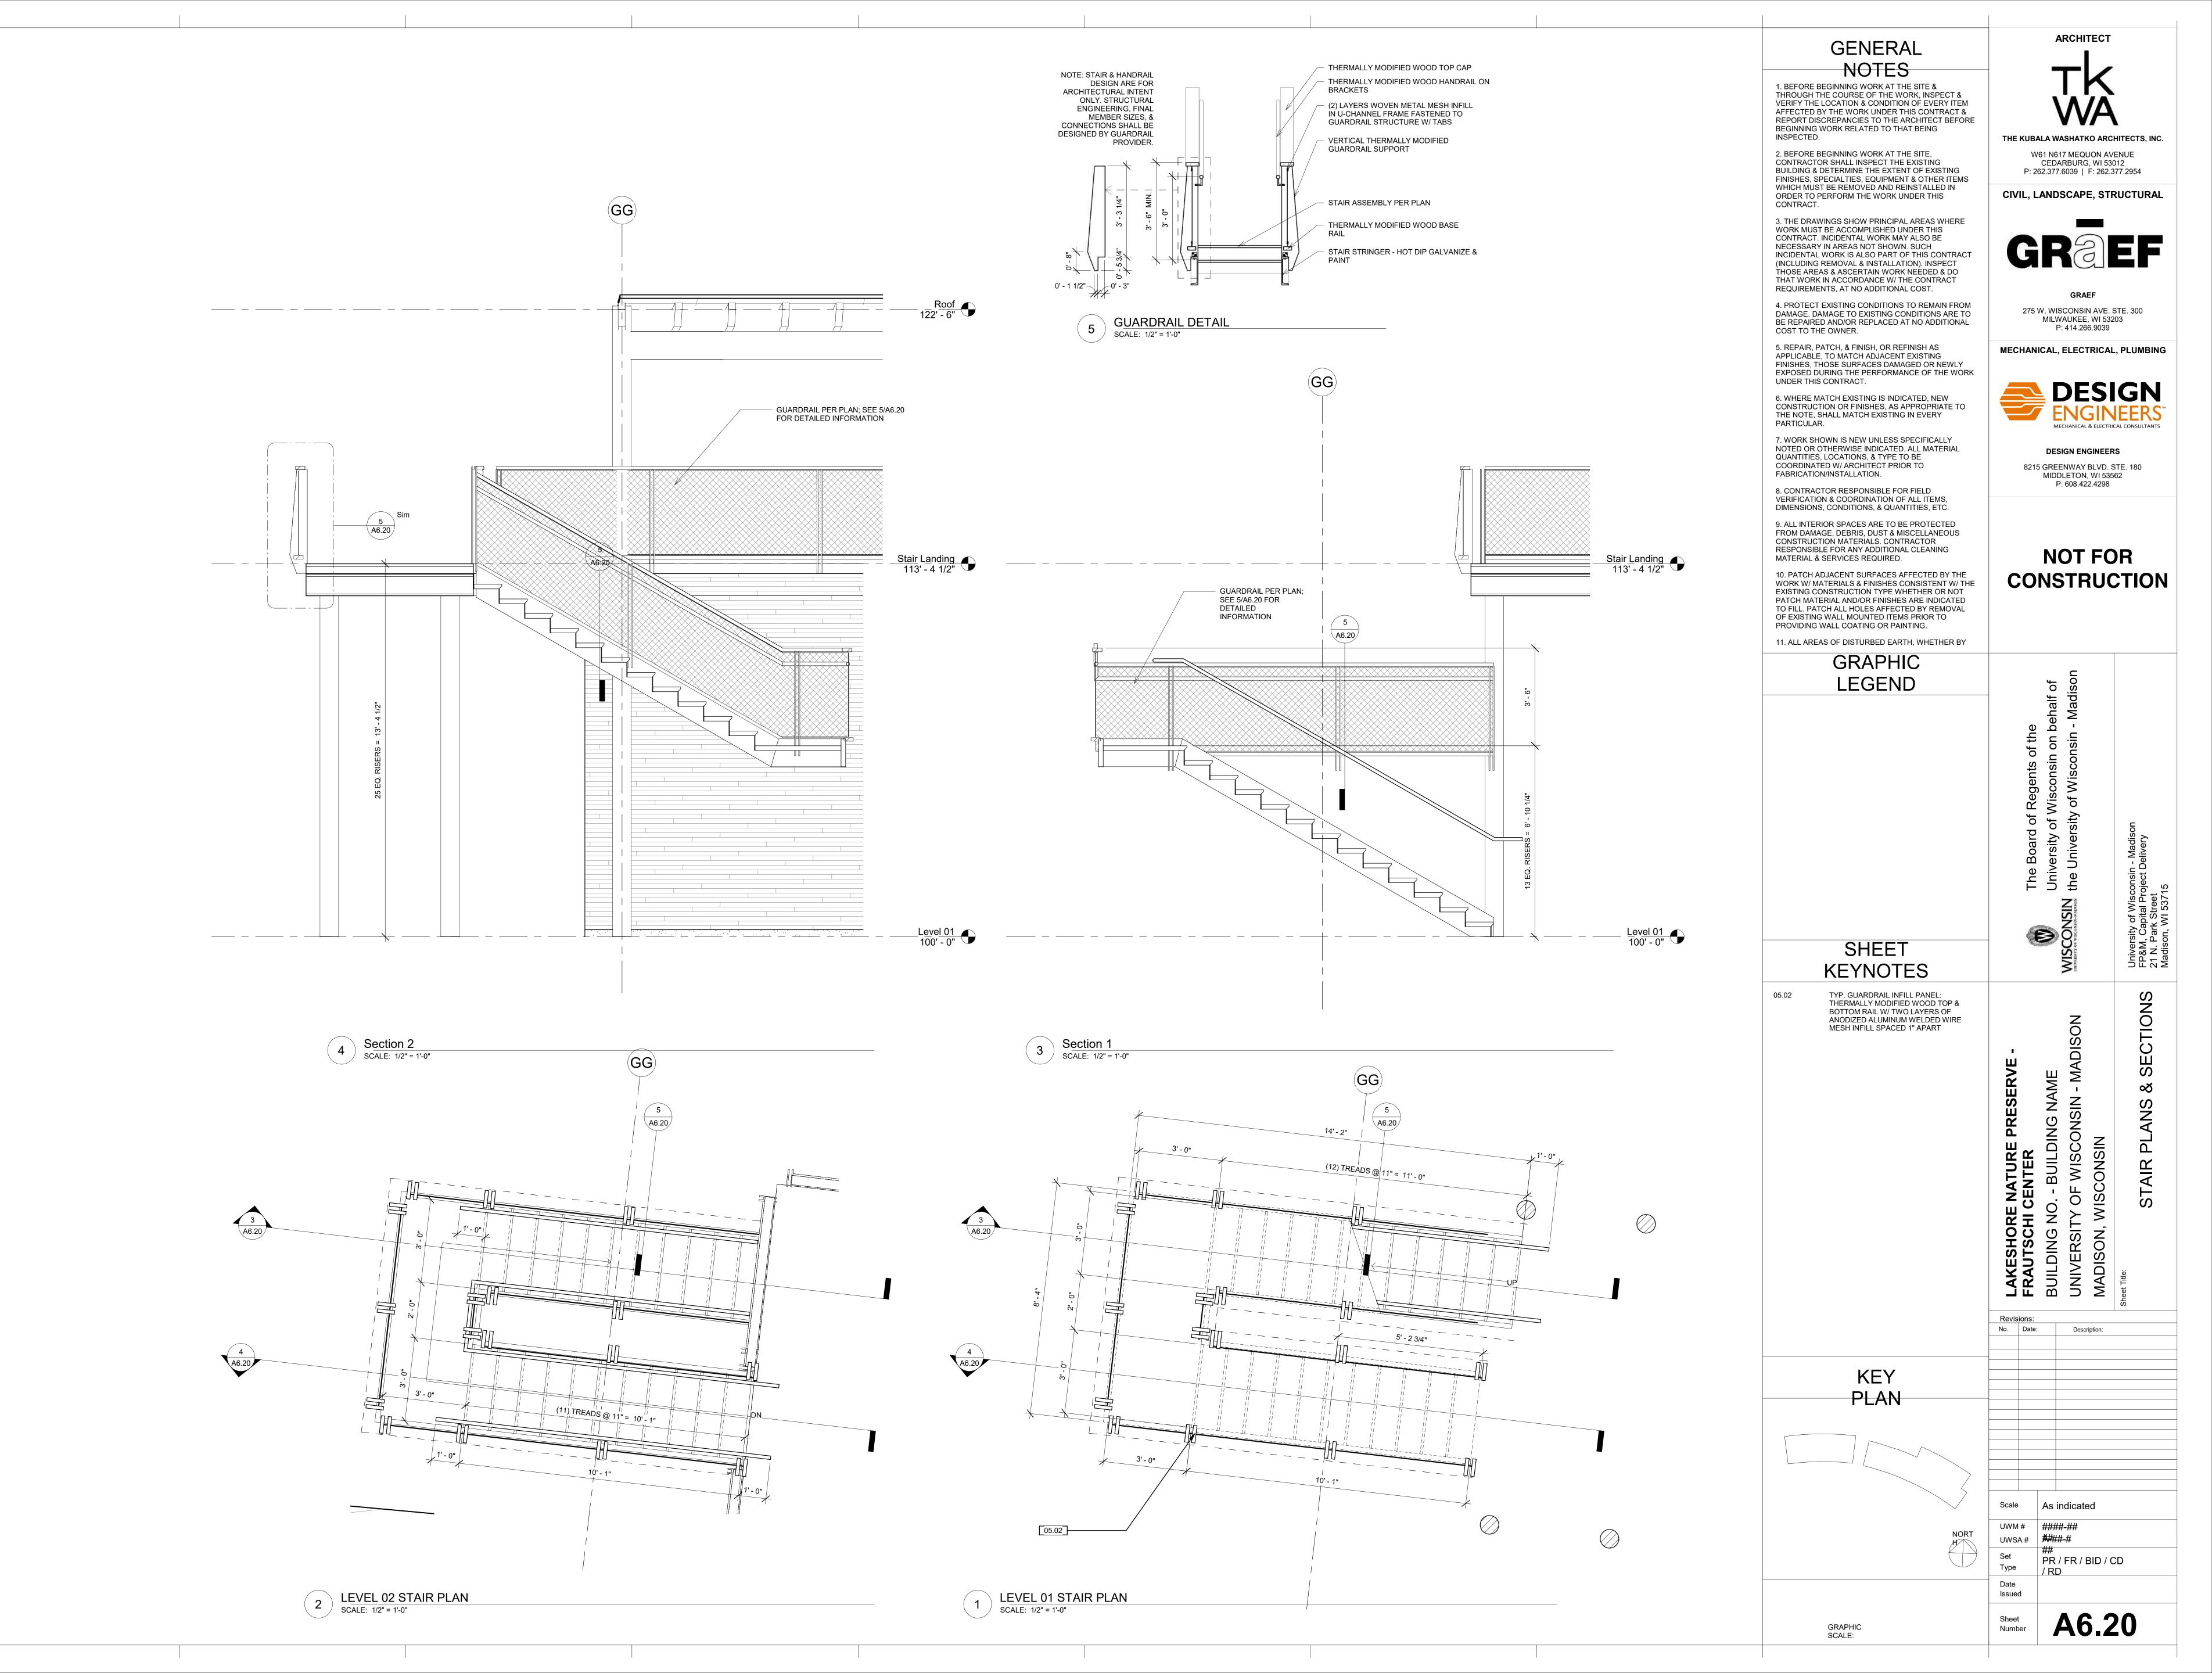


1/22/2023 5:53:34



					WINE	ow sc	HEDULE					
						Y OPENING / OPENING				DETAILS		
YPE MARK	COUNT	TYPE	MATERIAL	COLOR	HEIGHT	WIDTH	AREA (EA.)	GLAZING	WINDOW HEAD	WINDOW JAMB	WINDOW SILL	SCHEDULE NOTES
1(A)	9(5)	A(B)	-	-	2' - 0"	2' - 6"	5 SF	-	-	-	-	-
2	6	С	-	-	6' - 0"	2' - 6"	15 SF	-	-	-	-	-
3	1	D	-	-	7' - 6"	20' - 6 1/8"	153.83 SF	-	-	-	-	-
4	1	E	-	-	VARIES	8' - 3 1/8"	28.32 SF	-	-	-	-	-
5	1	F	-	-	VARIES	8' - 3 1/8"	32.25 SF	-	-	-	-	-
6	1	E	-	-	VARIES	8' - 3 1/8"	36.12 SF	-	-	-	-	-
7	1	F	-	-	VARIES	8' - 3 1/8"	39.95 SF	-	-	-	-	-
8	1	E	-	-	VARIES	8' - 3 1/8"	43.75 SF	-	-	-	-	-
9	1	F	-	-	VARIES	8' - 3 1/8"	47.6 SF	-	-	-	-	-
10	1	E	-	-	VARIES	8' - 3 1/8"	51.45 SF	-	-	-	-	-
11	1	F	-	-	VARIES	8' - 3 1/8"	55.25 SF	-	-	-	-	-
12	2	G	-	-	12' - 8"	4' - 6"	50.67 SF	TRIPLE PANE, LOW-E, W/ ORNALUX UV BIRD COLLISION PREVENTION GLAZING	-	-	-	-
13	1	Н	-	-	10' - 0"	17' - 9 1/2"	180 SF	TRIPLE PANE, LOW-E, W/ ORNALUX UV BIRD COLLISION PREVENTION GLAZING	-	-	-	-
14	1	J	-	-	3' - 4"	17' - 9 1/2"	60.04 SF	TRIPLE PANE, LOW-E, W/ ORNALUX UV BIRD COLLISION PREVENTION GLAZING	-	-	-	-
15	2	K	-	-	10' - 0"	6' - 0"	60 SF	-	-	-	-	-
16	4	L	-	-	3' - 4"	6' - 0"	20 SF	-	-	-	-	-
17	1	М	-	-	12' - 0"	14' - 0"	136.67 SF	-	-	-	-	-
18	1	N	-	-	9' - 0"	35' - 6 3/8"	323.63 SF	-	-	-	-	-
19	1	Р	-	-	9' - 0"	3' - 1 1/8"	26.34 SF	-	-	-	-	-
20	1	Q	-	-	8' - 8 1/2"	16' - 3"	126.39 SF	-	-	-	-	-
21	1	R	-	-	10' - 0"	8' - 6"	85 SF	<u>-</u>	-	-	-	-
22	1	S	-	-	6' - 9 3/8"	25' - 7 3/8"	173.7 SF	-	-	-	-	SILICONE-JOINTED VERTICAL SEAMS
23	3	Т	-	-	9' - 0"	5' - 6"	49.5 SF	-	-	-	-	-
24	1	U	-	-	9' - 0"	20' - 1 5/8"	181.22 SF	-	-	-	-	-
25	1	V	-	-	10' - 0"	6' - 0"	60 SF	-	-	-	-	-

ALL GLAZING TO BE TRIPLE PANE, LOW-E, W/ 2" x 2' GRID DOT-PATTERN BIRD COLLISION PREVENTION CERAMIC FRIT ON SURFACE 2 U.N.O.

ALL OPERABLE WINDOWS TO INCLUDE INSECT SCREENS & OPEN/CONTACT SENSORS ALUMINUM FRAMED WINDOWS TO HAVE CUSTOM COLOR ALUMINUM EXTERIOR AND EXPOSED WOOD INTERIOR, BOD: KOLBE VISTALUXE WD

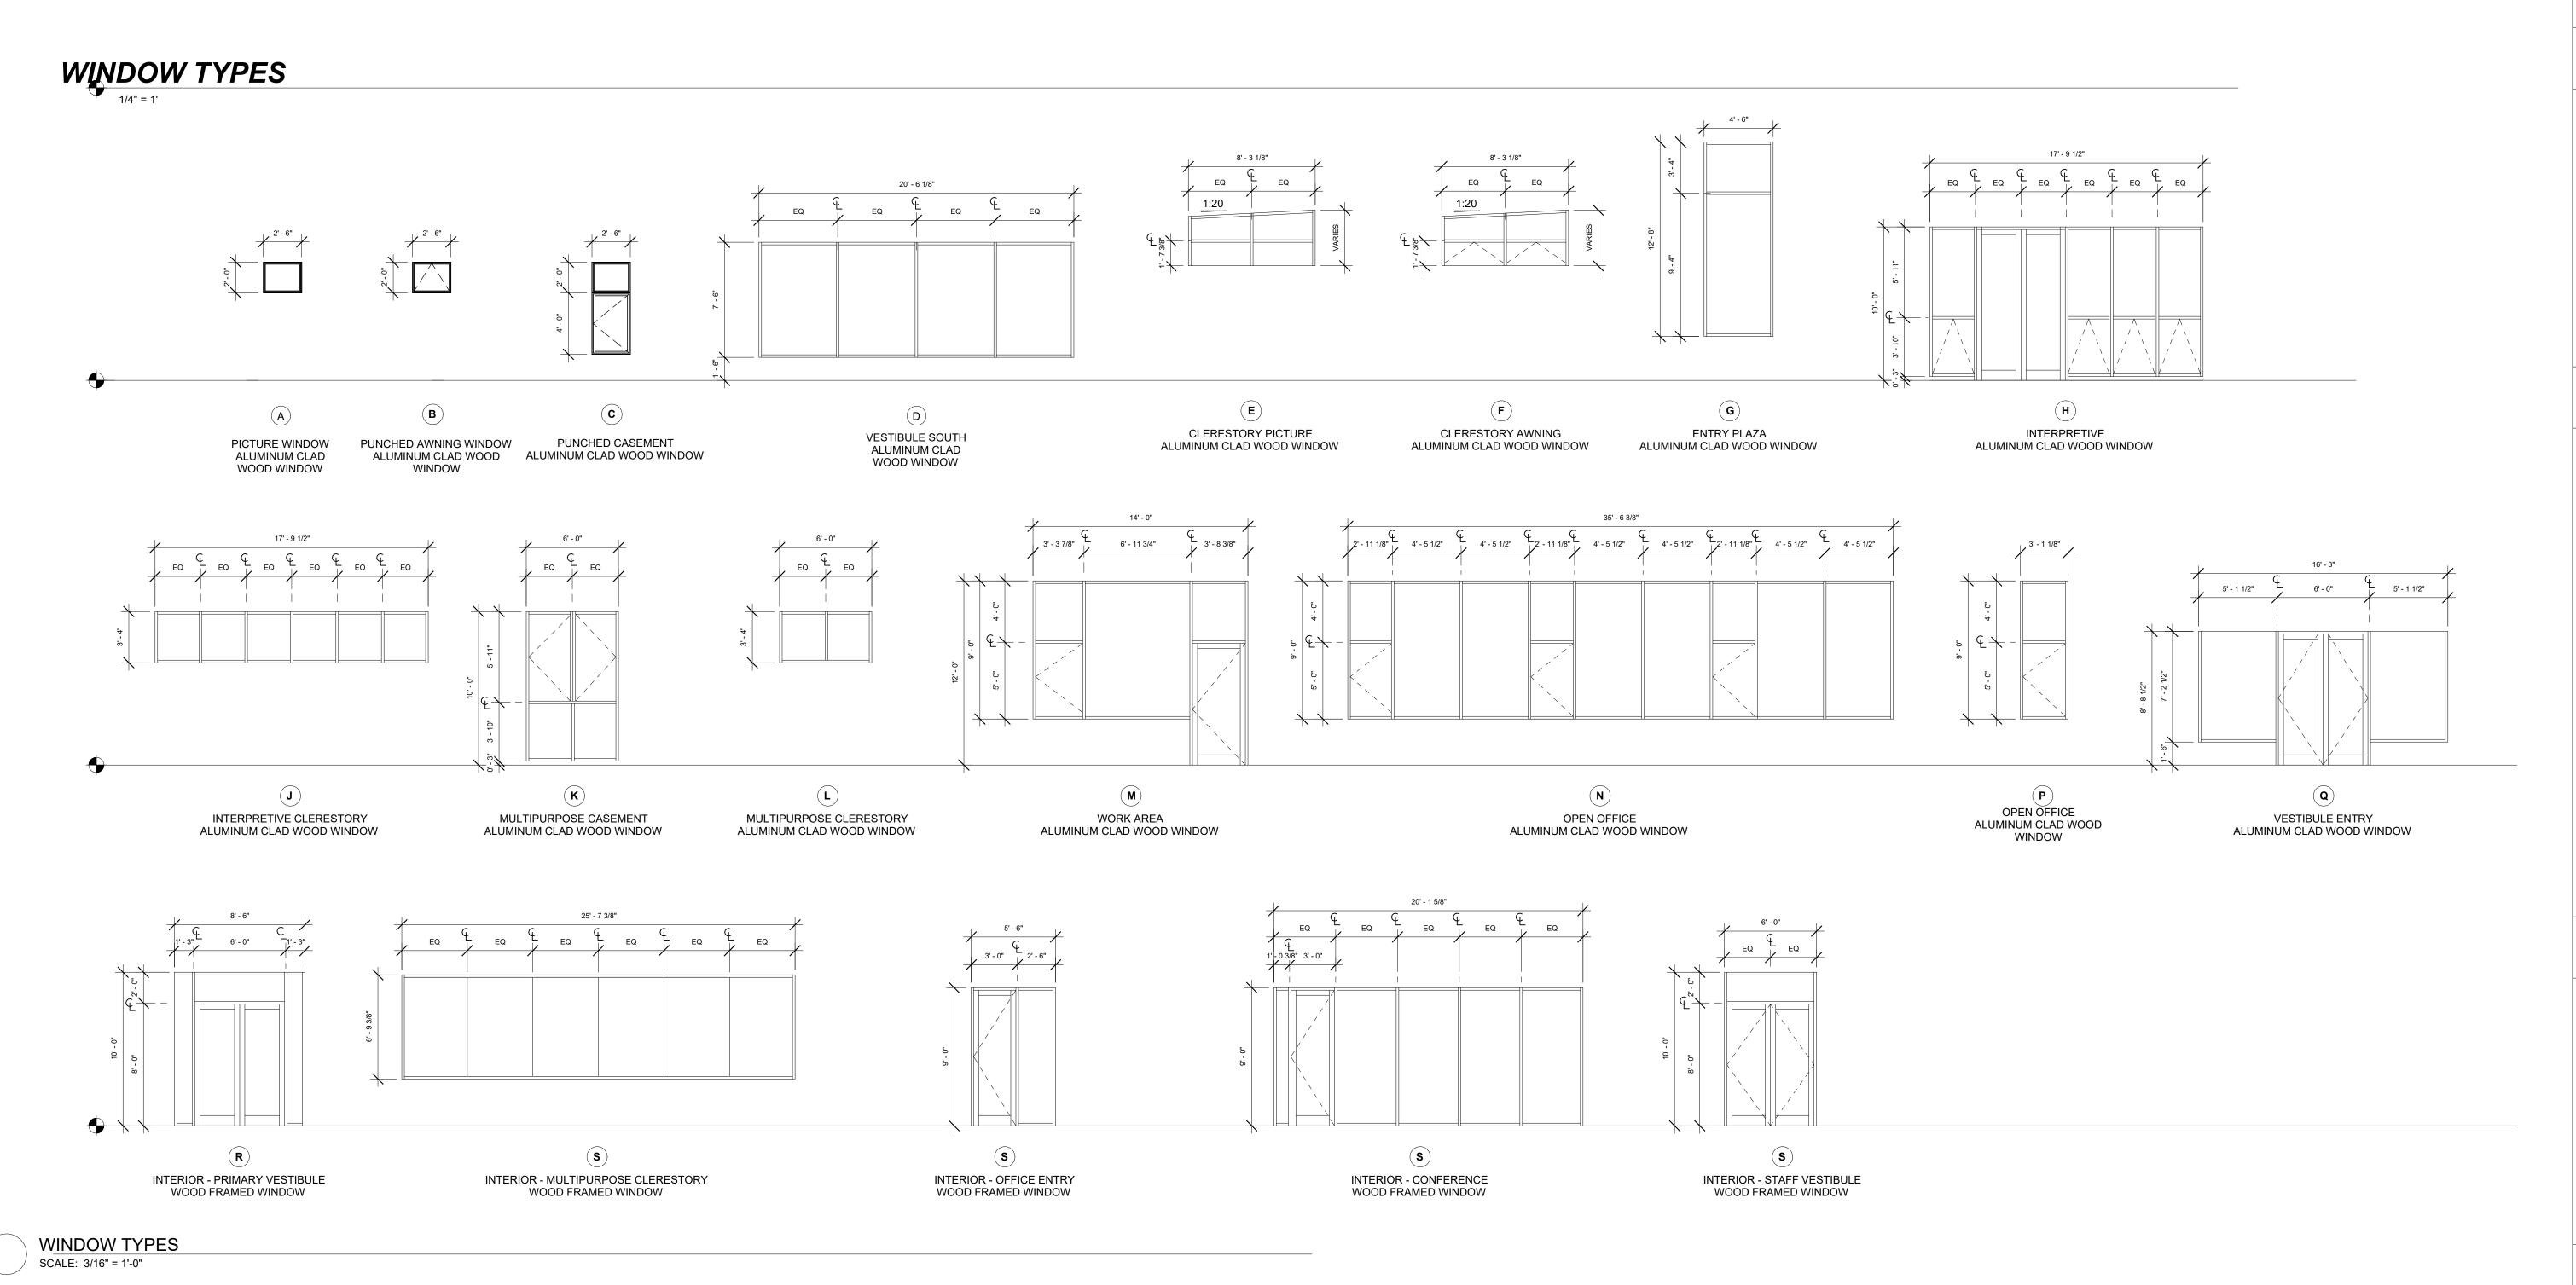

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ARCHITECT THE KUBALA WASHATKO ARCHITECTS, INC.

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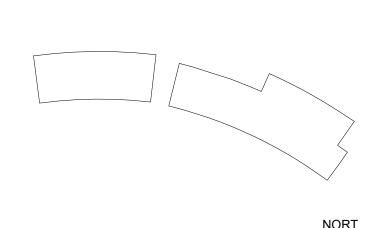
NOT FOR

SHEET KEYNOTES

Description:

No. Date:

KEY PLAN



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UWM#		950-2218 -22-007	
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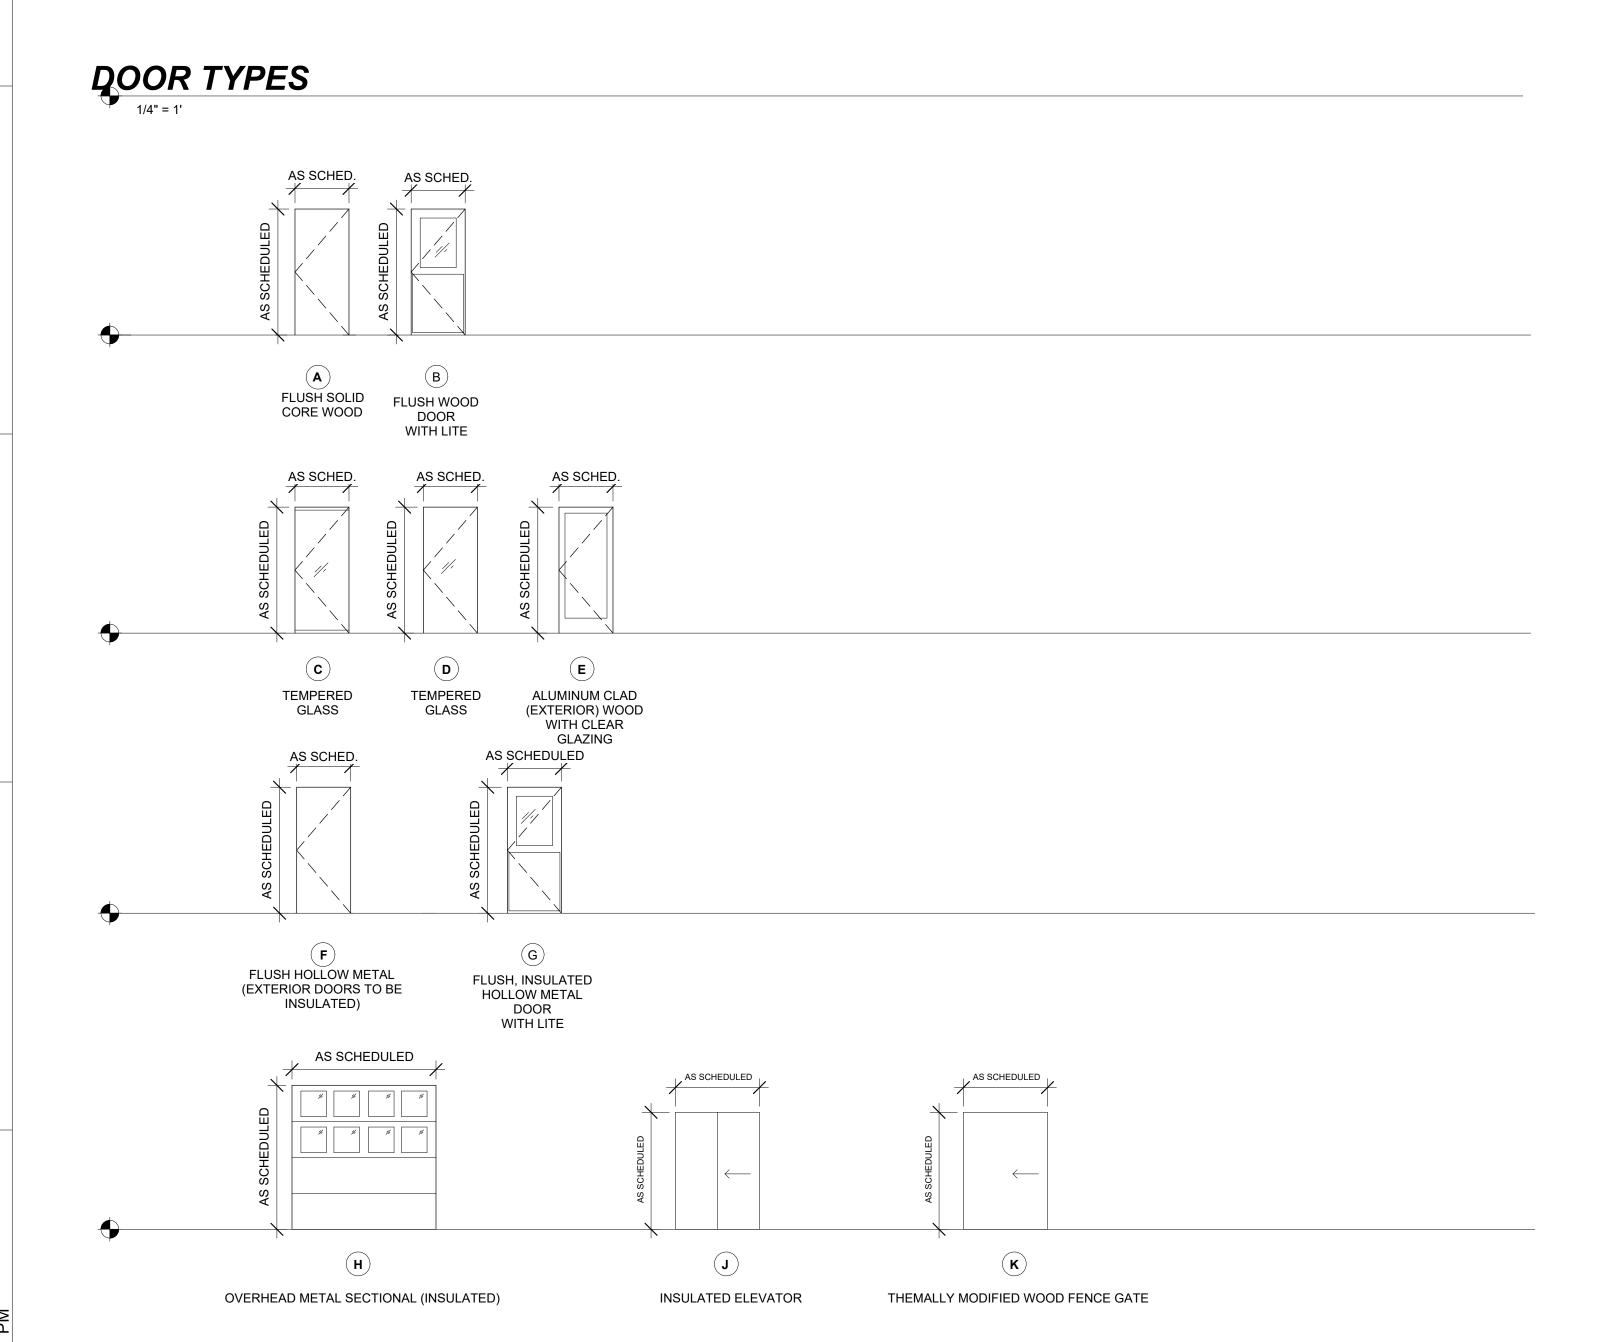
										<u> </u>	_						
	DOOR SCHEDULE																
LOCATION DOOR									FRAME					INFORMATION			
				SIZE	1 3/4" THICK	-							DETAIL NO.				
DOOR NO.	ROOM NAME OR DESCRIPTION	ROOM NO.	WIDTH	HEIGHT	UNLESS	DOOR TYPE	MATERIAL	FINISH	GLAZING	FRAME TYPE	FRAME MATERIAL	HEAD	JAMB	SILL	LABEL	HDWR GROUP	SCHEDULE NOTES
						1						1					
100A	VESTIBULE	100E	3' - 0"	7' - 0"		F		PNT		A	STL						
100B	VESTIBULE	100E	3' - 0"	7' - 0"		F		PNT		A	STL						
100E	INTERPRETIVE	100L	5' - 9 1/2"	7' - 8 1/4"		E		STN	TEMPERED, LOW-E	D	WD						
100F	OPEN OFFICE	100M	2' - 8 1/4"	7' - 8 1/4"	1	<u> E</u>		STN STAINLESS	TEMPERED, LOW-E	D	WD_						
100H 100L	VESTIBULE INTERPRETIVE	100E 100L	2' - 11 1/2" 3' - 0"	7' - 6 1/4" 7' - 0"	+	J		STAINLESS STN		- G	- WD						
100L 100N	CORRIDOR	100L 100P	3' - 0"	7 - 0"		B		STN	TEMPERED, LOW-E	G	WD						
101	CORRIDOR	100N	3' - 0"	7' - 0"		F		PNT	=	A	STL						
102	MULTIPURPOSE	102	3' - 0"	7' - 0"	1	В		STN		G	WD						
102.74	VIEWING PLATFORM	200	2' - 11 1/2"	7' - 6 1/4"	<u> </u>	J _		STAINLESS		-							
102A	MULTIPURPOSE	102	4' - 0"	7' - 0"		А	WD	STN		G	WD						
103	MENS	103	3' - 0"	7' - 0"		Α		STN		G	WD						
104	MULTIPURPOSE	104	3' - 0"	7' - 0"		В		STN		G	WD						
104A	MULTIPURPOSE	104 100N	4' - 0"	7' - 0"		A		STN		G	WD						DOOR TO OPEN 190 DECREES
105 106	CORRIDOR WORK AREA	100N 106	3' - 0" 3' - 0"	7' - 0" 7' - 0"		Γ		PNT STN		A G	STL WD						DOOR TO OPEN 180 DEGREES
106A	STORAGE	106A	2' - 10"	7 - 0 7' - 0"		F		PNT		Δ	STL						
1007	WOMENS	1007	3' - 0"	7' - 0"		A		STN		G	WD						
108	MOTHER'S ROOM	108	3' - 0"	7' - 0"	1	А		STN		G	WD						
108A	MOTHER'S ROOM	108	5' - 0"	6' - 8"		F		PNT		В	STL						
108B	COLD BAY	135	3' - 0"	7' - 0"		F		PNT		A	STL						
109	CORRIDOR	100N	3' - 0"	7' - 0"		В		STN		G	WD						
111	STAFF	111	3' - 0"	7' - 0"	1	A		STN		G	WD						
111A	STAFF	111	5' - 0"	6' - 8"		F		PNT	TEMPERED LOW E	R	STL						
113	DIR. OFFICE	113	2' - 8 1/4"	8' - 7"		ח	GLASS	-	TEMPERED LOW E	<u> </u>	STL						
115 117	OFFICE A OFFICE B	115 117	2' - 8 1/4" 2' - 8 1/4"	8' - 7" 7' - 8 1/4"		ח	GLASS GLASS		TEMPERED, LOW-E TEMPERED, LOW-E	<u> </u>	STL STL						
117	OPEN OFFICE	100M	2' - 9 1/2"	8' - 7"		ח	GLASS	_	TEMPERED, LOW-E		STL						
123	LOCKERS	121	3' - 0"	7' - 0"		A		STN	=	G	WD						
125	SHOWER	125	3' - 0"	7' - 0"		А		STN		G	WD						
133	COLD BAY	135	8' - 0"	6' - 6"		Н		PNT	TEMPERED, INSULATED, LOW-E	-	-						PROVIDE AIR LOCK BETWEEN DOOR AND BUILDING
E01			3' - 0"	7' - 0"		F		PNT		Α	STL						
E02	-		3' - 0"	7' - 0"		F		PNT		Α	STL						
E03			3' - 0"	7' - 0"		F		PNT		A	STL						
E04			3' - 0"	7' - 0"		F		PNT		A	STL	ļ					OFF FVT FLEVATIONS
E05	\/E07!D! '' E	4005	8' - 8"	6' - 10 3/4"		K		NATURAL	TEMPEDED INCHIATED LOWE	-	-						SEE EXT. ELEVATIONS
E06	VESTIBULE	100E	4' - 11"	8' - 6"		<u>E</u>		ANO/STN	TEMPERED, INSULATED, LOW-E TEMPERED, INSULATED, LOW-E	<u>D</u>	WD WD	<u> </u>					
N01 N02			5' - 9 1/2" 3' - 4 1/2"	9' - 9 1/2" 7' - 7 3/4"	+	F		ANO/STN ANO/STN	TEMPERED, INSULATED, LOW-E	F	WD	1			+		
N02			16' - 0"	10' - 0"		Н		PNT	TEMPERED, INSULATED, LOW-E		-						PROVIDE AIR LOCK BETWEEN DOOR AND BUILDING
N04	WARM BAY	133	3' - 0"	7' - 0"	+	G		PNT	TEMPERED, INSULATED, LOW-E	A	STL						TROVIDE AIR LOOK BETWEEN DOOK AND BUILDING
N05	COLD BAY	135	3' - 0"	7' - 0"		G	НМ	PNT	TEMPERED, INSULATED, LOW-E	A	STL						
N06			16' - 0"	10' - 0"		Н		PNT	TEMPERED, INSULATED, LOW-E	-	-						PROVIDE AIR LOCK BETWEEN DOOR AND BUILDING
W01			7' - 9 1/2"	6' - 10 3/4"		K		NATURAL		-	-						SEE EXT. ELEVATIONS
W01-02						K		NATURAL		-	-						
W02			3' - 0"	7' - 0"		<u> </u> E	AL/WD	PNT/STN	TEMPERED, INSULATED, LOW-E	F	WD						

ALL EXTERIOR DOORS TO RECEIVE CARD READER & DOOR CONTACT SENSOR


ALL DOORS TO BE RIFT-SAWN, SPECIES TO BE COORD. W/ ARCHITECT PRIOR TO PROCUREMENT

ALL METAL DOORS & FRAMES TO BE REINF. FOR CLOSERS ALL METAL DOOR FRAMES TO HAVE 2" FACE TRIM - STAIN ST-X

ALL METAL DOOR FRAMES TO BE 16 GA. EXCEPT EXTERIOR DOORS (14 GA.) & FRAMES >48" (14GA.)



FRAME TYPES 1/4" = 1'

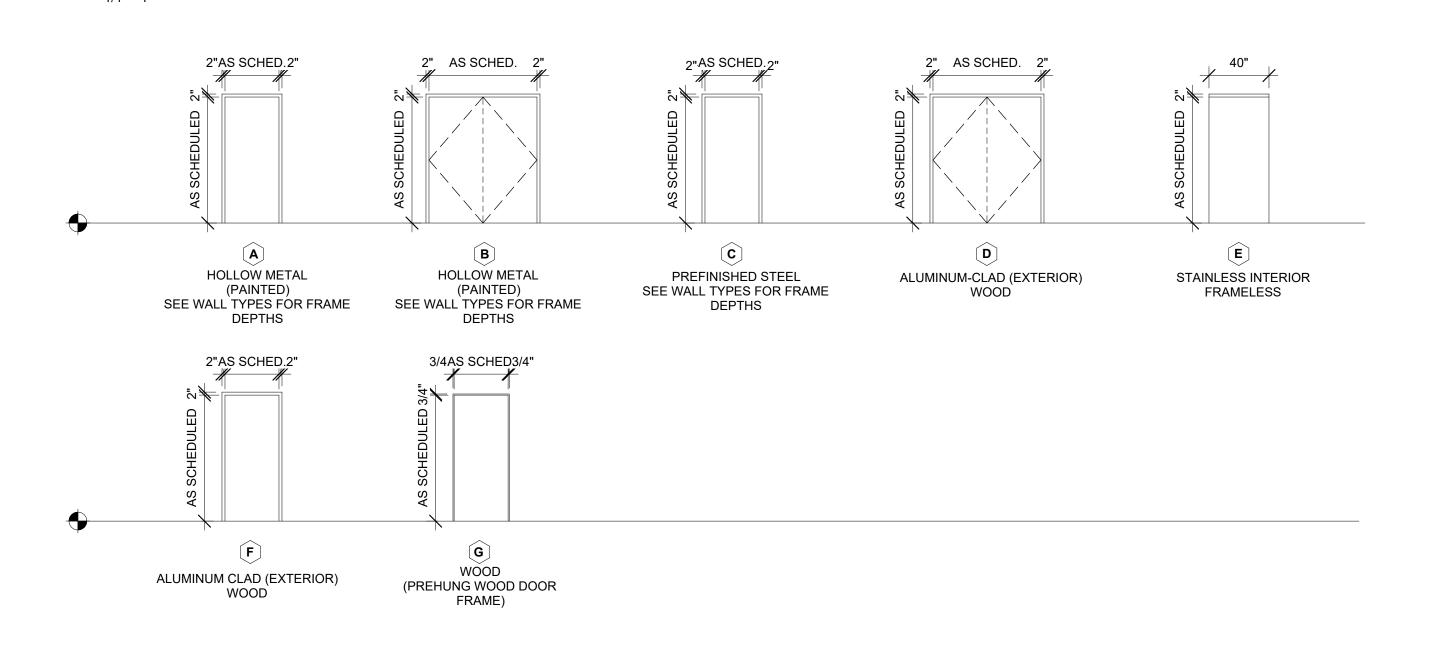

GENERAL NOTES

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2. BEFORE BEGINNING WORK AT THE SITE, CONTRACTOR SHALL INSPECT THE EXISTING BUILDING & DETERMINE THE EXTENT OF EXISTING FINISHES, SPECIALTIES, EQUIPMENT & OTHER ITEMS WHICH MUST BE REMOVED AND REINSTALLED IN ORDER TO PERFORM THE WORK UNDER THIS CONTRACT.

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4. PROTECT EXISTING CONDITIONS TO REMAIN FROM DAMAGE. DAMAGE TO EXISTING CONDITIONS ARE TO BE REPAIRED AND/OR REPLACED AT NO ADDITIONAL COST TO THE OWNER.

5. REPAIR, PATCH, & FINISH, OR REFINISH AS APPLICABLE, TO MATCH ADJACENT EXISTING FINISHES, THOSE SURFACES DAMAGED OR NEWLY EXPOSED DURING THE PERFORMANCE OF THE WORK UNDER THIS CONTRACT.

6. WHERE MATCH EXISTING IS INDICATED, NEW

CONSTRUCTION OR FINISHES, AS APPROPRIATE TO THE NOTE, SHALL MATCH EXISTING IN EVERY PARTICULAR. 7. WORK SHOWN IS NEW UNLESS SPECIFICALLY

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8. CONTRACTOR RESPONSIBLE FOR FIELD VERIFICATION & COORDINATION OF ALL ITEMS, DIMENSIONS, CONDITIONS, & QUANTITIES, ETC. 9. ALL INTERIOR SPACES ARE TO BE PROTECTED

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GRAPHIC LEGEND

ARCHITECT THE KUBALA WASHATKO ARCHITECTS, INC. W61 N617 MEQUON AVENUE

CEDARBURG, WI 53012

P: 262.377.6039 | F: 262.377.2954

CIVIL, LANDSCAPE, STRUCTURAL

275 W. WISCONSIN AVE. STE. 300 MILWAUKEE, WI 53203

P: 414.266.9039 MECHANICAL, ELECTRICAL, PLUMBING



DESIGN ENGINEERS

MECHANICAL & ELECTRICAL CONSULTANTS

8215 GREENWAY BLVD. STE. 180 MIDDLETON, WI 53562 P: 608.422.4298


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SHEET KEYNOTES

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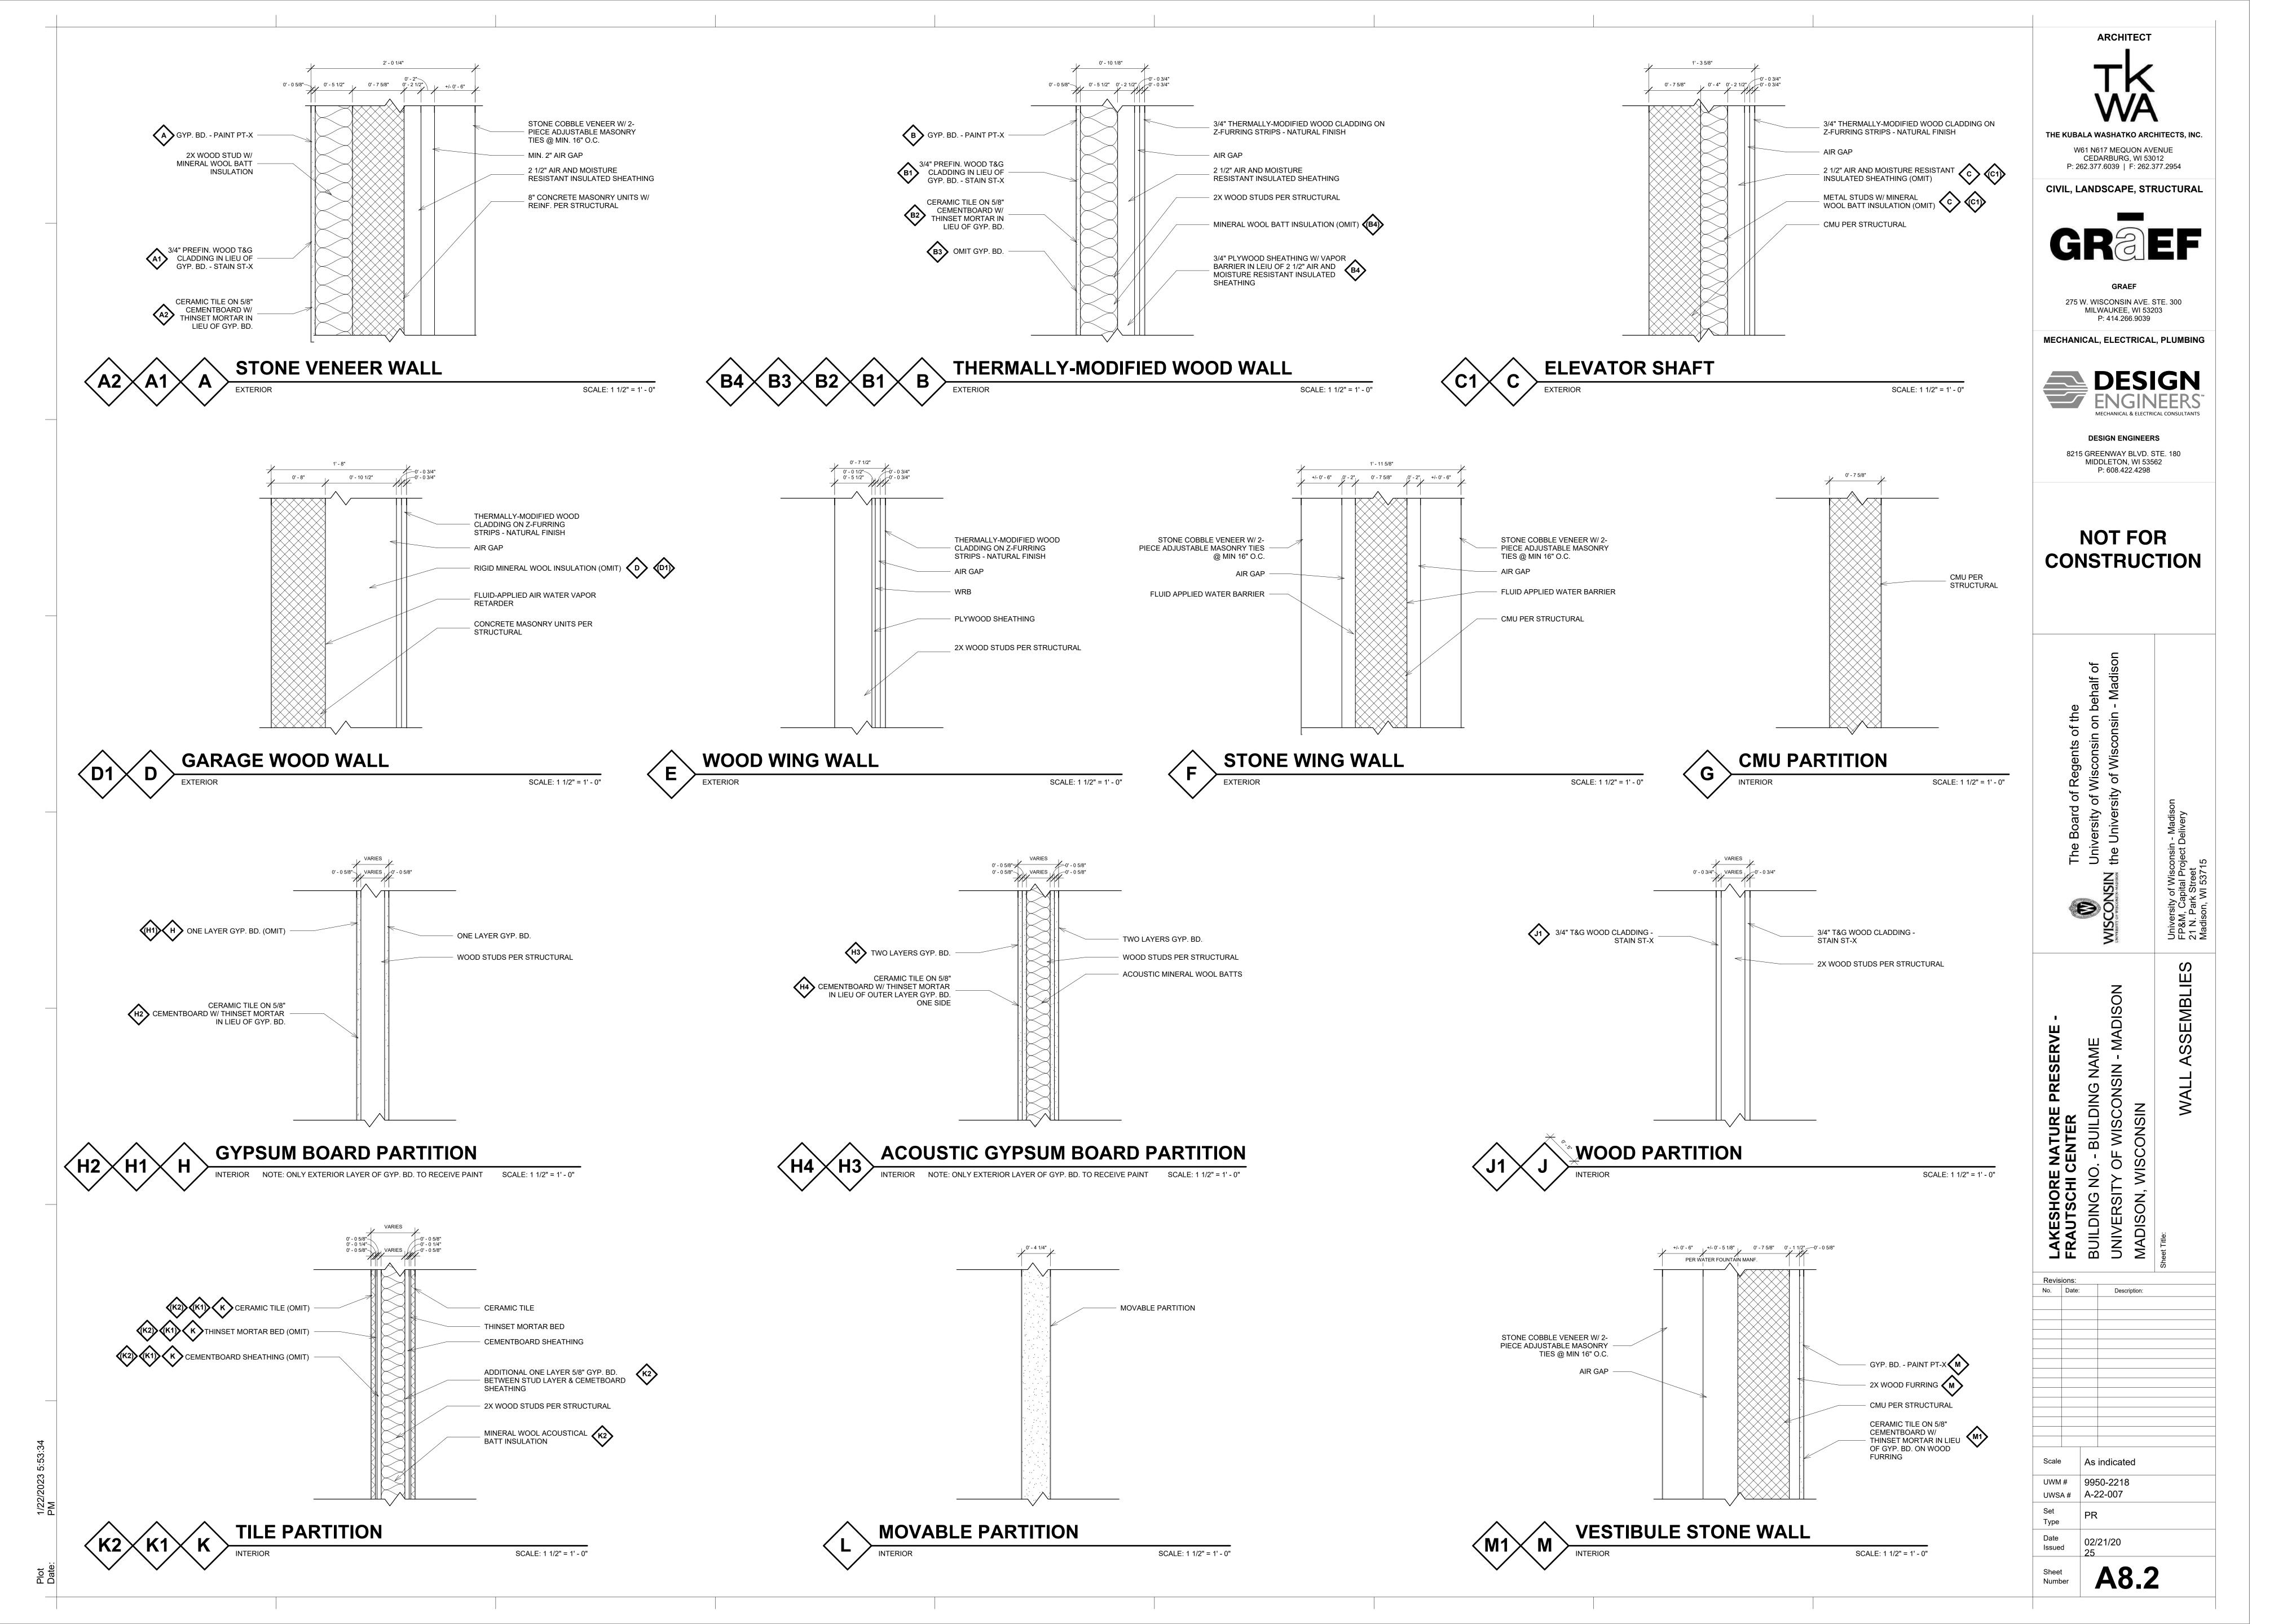
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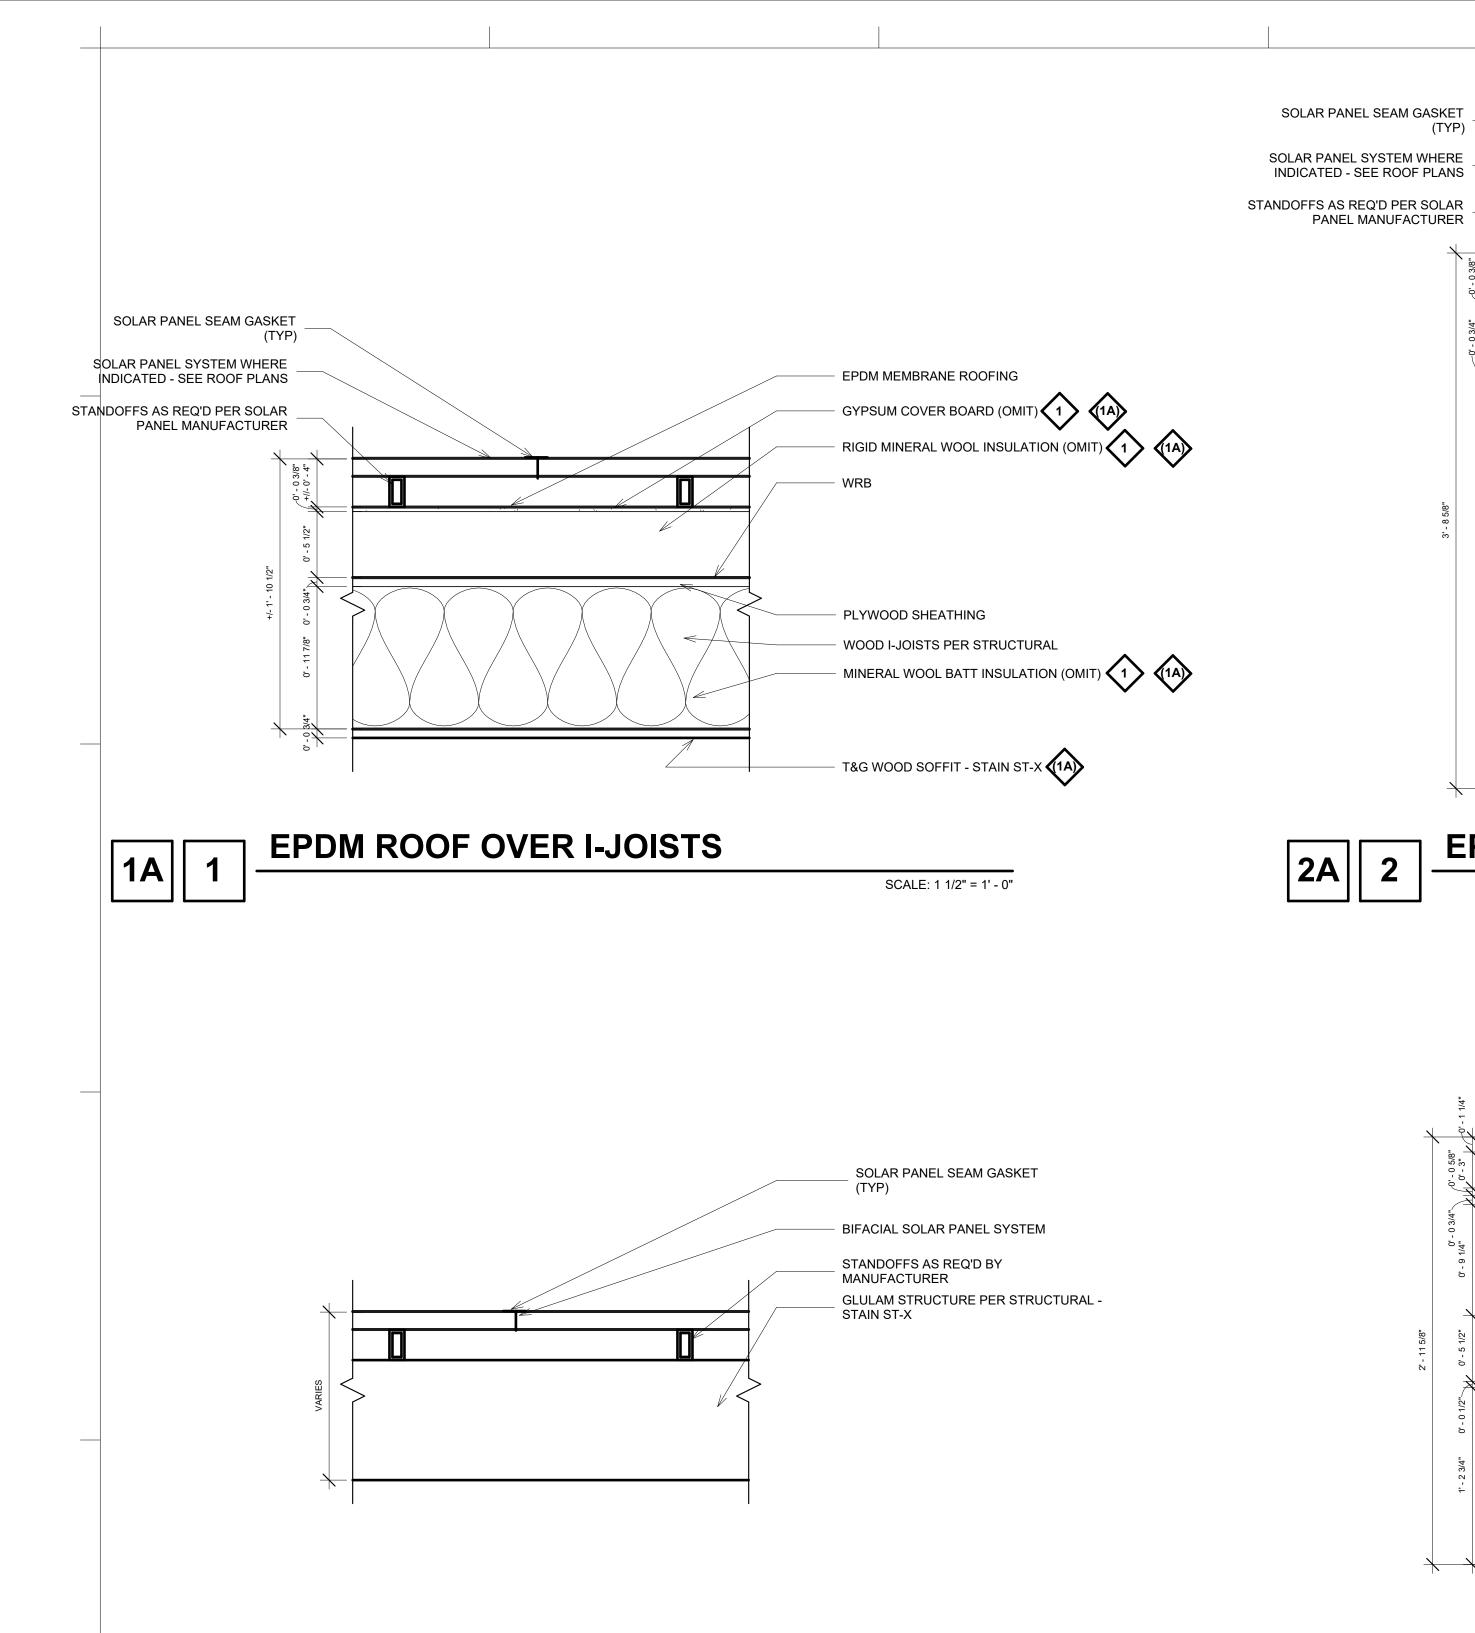
KEY PLAN




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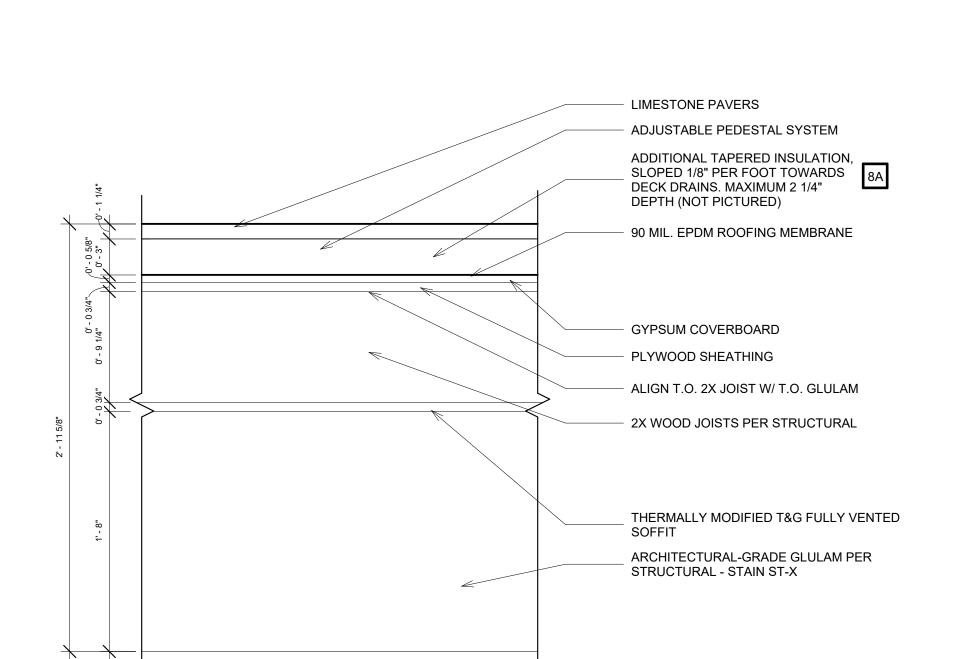
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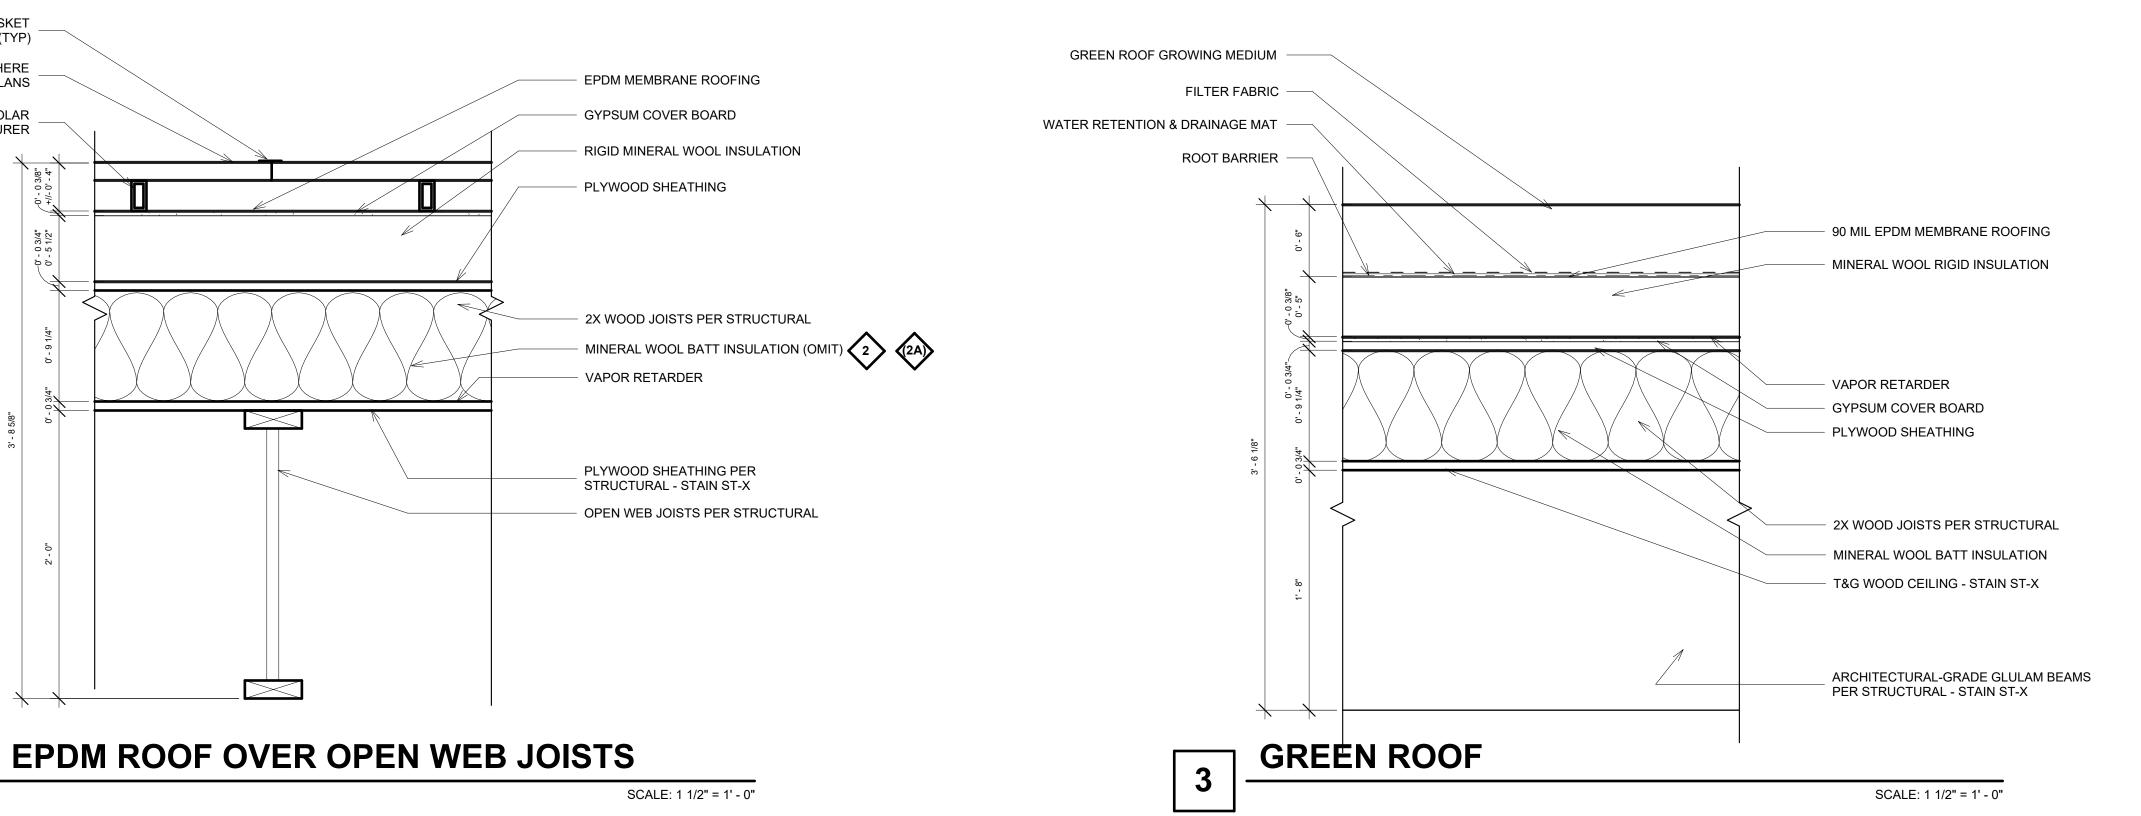



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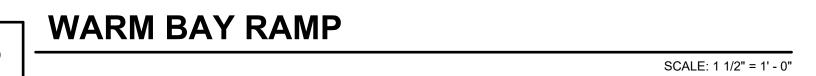


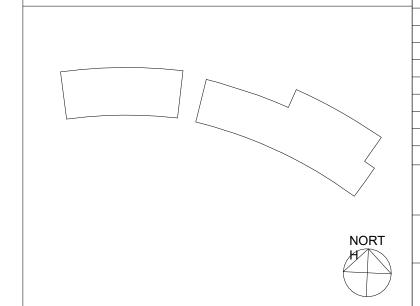
SCALE: 1 1/2" = 1' - 0"



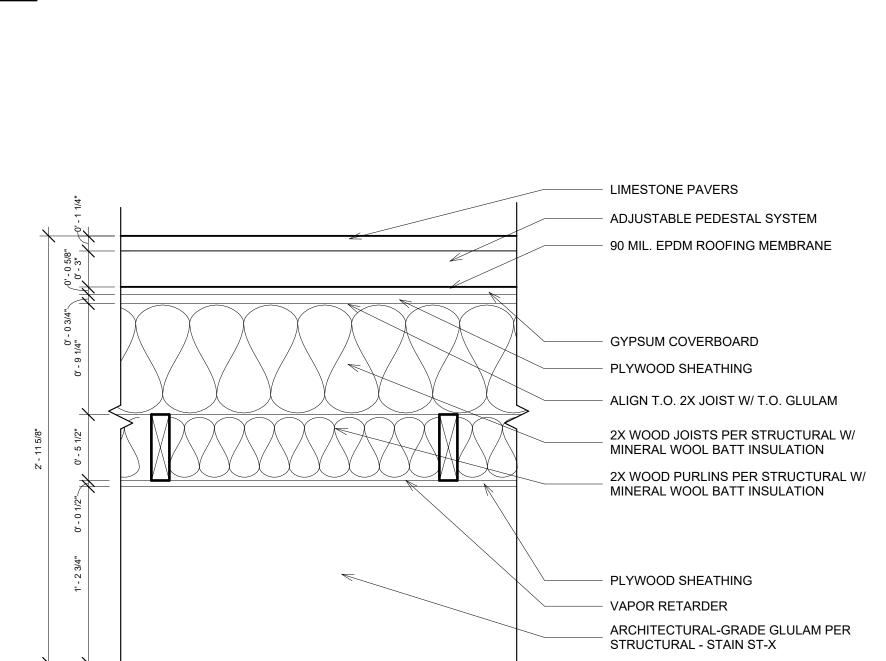



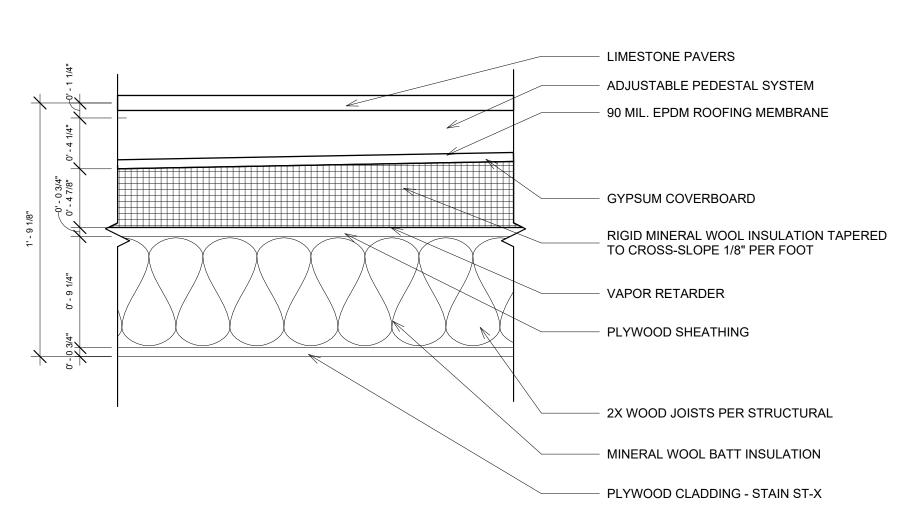

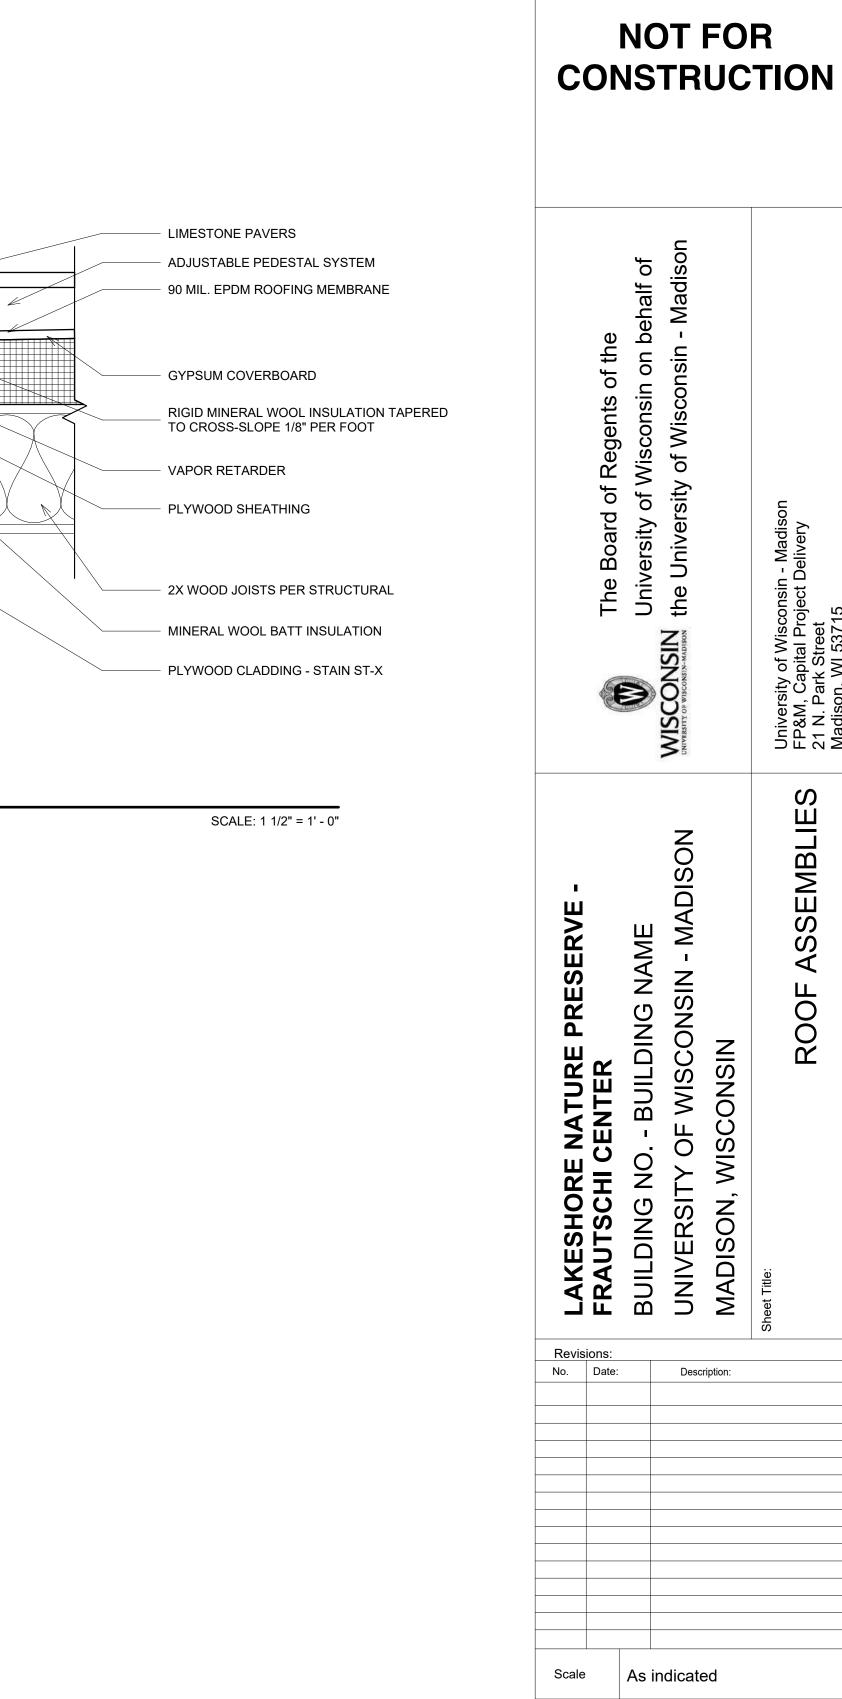

ARCHITECT

THE KUBALA WASHATKO ARCHITECTS, INC.

W61 N617 MEQUON AVENUE

CEDARBURG, WI 53012 P: 262.377.6039 | F: 262.377.2954

CIVIL, LANDSCAPE, STRUCTURAL

GRaEF

275 W. WISCONSIN AVE. STE. 300 MILWAUKEE, WI 53203

P: 414.266.9039

MECHANICAL, ELECTRICAL, PLUMBING

DESIGN ENGINEERS

8215 GREENWAY BLVD. STE. 180 MIDDLETON, WI 53562 P: 608.422.4298

Description:


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A8.3

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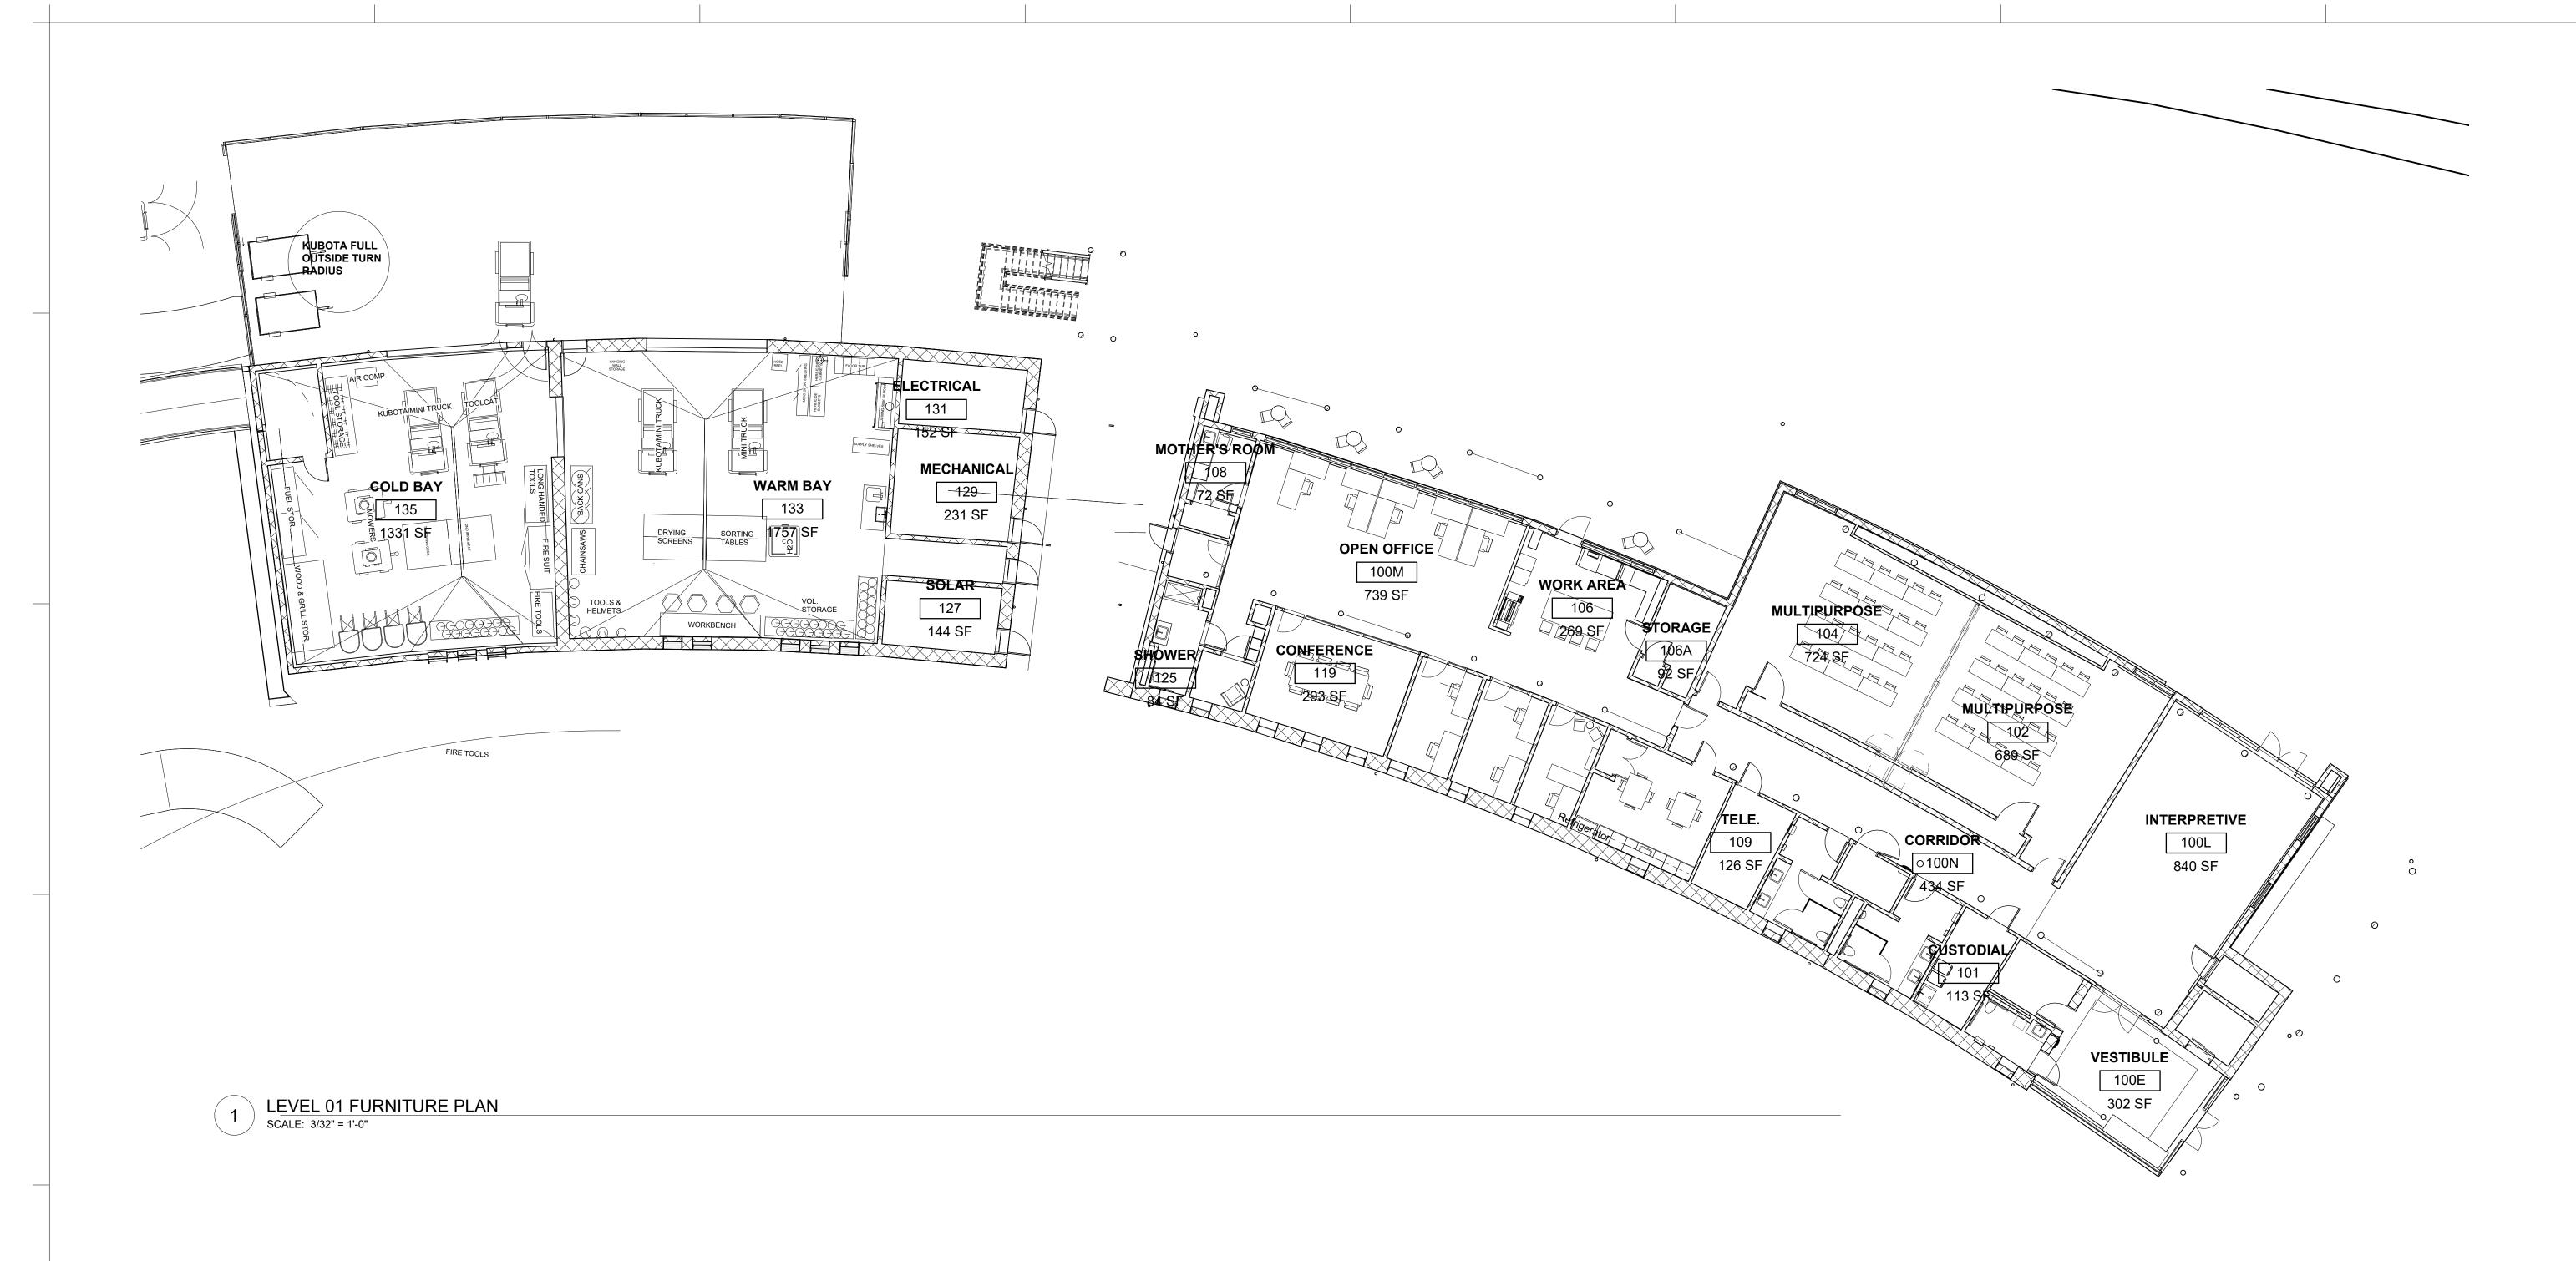
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SCALE: 1 1/2" = 1' - 0"

SCALE: 1 1/2" = 1' - 0"

BIFACIAL SOLAR CANOPY

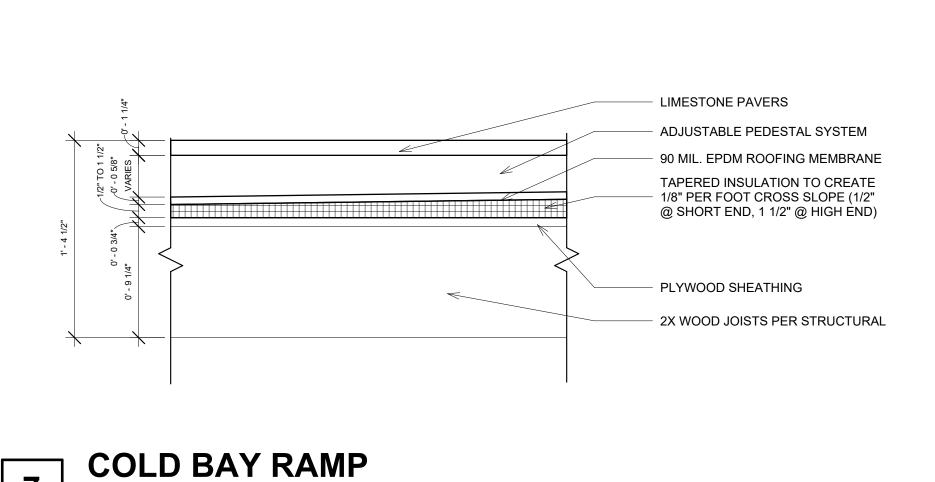

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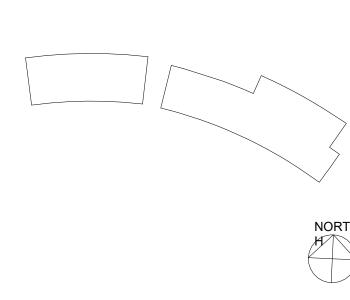
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SHEET KEYNOTES


Description:

No. Date:

KEY PLAN



A9.2

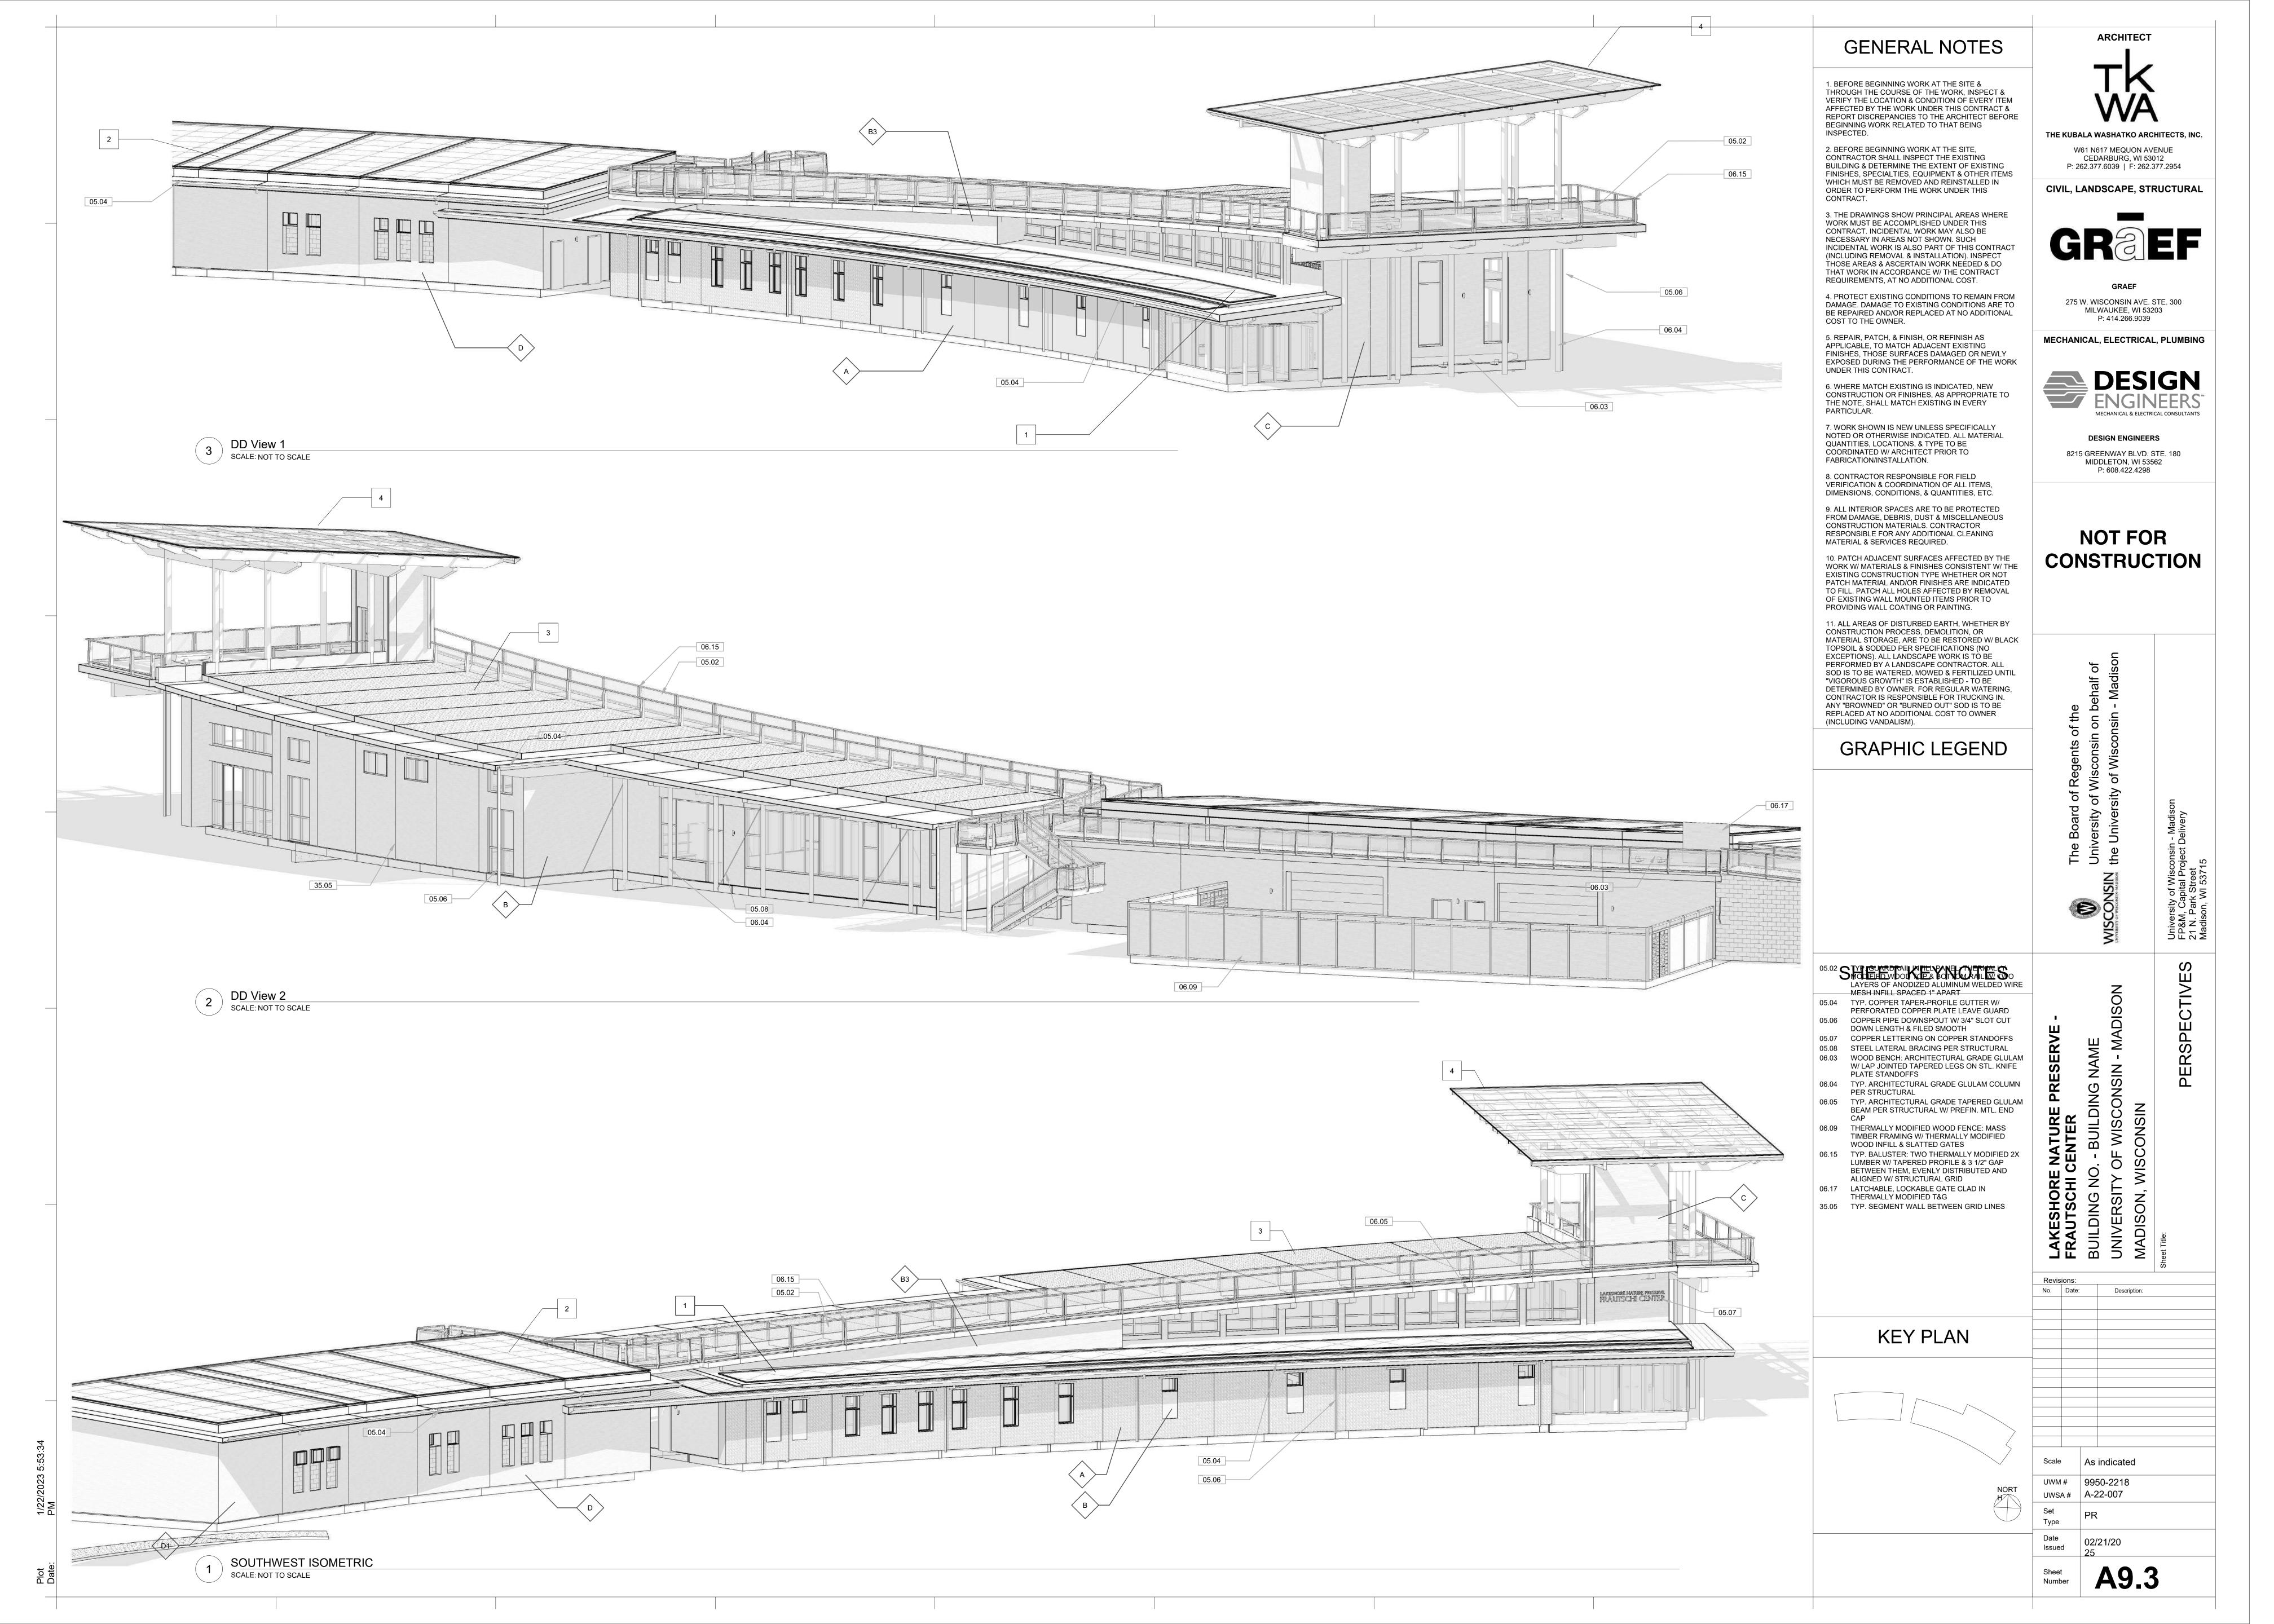



City of Madison Fire Department

314 W Dayton Street, Madison, WI 53703

Phone: 608-266-4420 • Fax: 608-267-1100 • E-mail: fire@cityofmadison.com

Project Address: 1972 University Bay Dr., Madison, WI	
Contact Name & Phone #: Patti Chin, (414) 266-9129	

FIRE APPARATUS ACCESS AND FIRE HYDRANT WORKSHEET

1. Is the building completely protected by an NFPA 13 or 13R automatic fire sprinkler system? If non-sprinklered, fire lanes extend to within 150-feet of all portions of the exterior wall? If sprinklered, fire lanes are within 250-feet of all portions of the exterior wall?	X Yes Yes Yes	☐ No ☐ No ☐ No	□ N/A ▼ N/A □ N/A
 2. Is the fire lane constructed of concrete or asphalt, designed to support a minimum load of 85,000 lbs? a) Is the fire lane a minimum unobstructed width of at least 20-feet? b) Is the fire lane unobstructed with a vertical clearance of at least 13½-feet? c) Is the minimum inside turning radius of the fire lane at least 28-feet? d) Is the grade of the fire lane not more than a slope of 8%? e) Is the fire lane posted as fire lane? (Provide detail of signage.) f) Is a roll-able curb used as part of the fire lane? (Provide detail of curb.) g) Is part of a sidewalk used as part of the required fire lane? (Must support +85,000 lbs.) 	X Yes X Yes X Yes Yes Yes Yes Yes Yes Yes Yes X Yes	No No No No No No No No	 N/A N/A N/A N/A N/A N/A N/A N/A N/A
3. Is the fire lane obstructed by security gates or barricades? If yes:a) Is the gate a minimum of 20-feet clear opening?b) Is an approved means of emergency operations installed, key vault, padlock or key switch?	Yes Yes Yes	X No☐ No☐ No	□ N/A □ N/A □ N/A
4. Is the Fire lane dead-ended with a length greater than 150-feet? If yes, does the area for turning around fire apparatus comply with IFC D103?	☐ Yes ☐ Yes	X No □ No	□ N/A ▼ N/A
5. Is any portion of the building to be used for high-piled storage in accordance with IFC Chapter 3206.6 If yes, see IFC 3206.6 for further requirements.	Yes	No No	□ N/A
6. Is any part of the building greater than 30-feet above the grade plane?	X Yes	☐ No	□ N/A
If yes, answer the following questions: a) Is the aerial apparatus fire lane parallel to one entire side of the building and covering at least 25% of the perimeter? b) Is the near edge of the aerial apparatus fire lane between 15' and 30' from the building? c) Are there any overhead power or utility lines located across the aerial apparatus fire lane? d) Are there any tree canopies expected to grow across the aerial fire lane? (Based on mature canopy width of tree species)	X Yes X Yes Yes Yes Yes	☐ No ☐ No ☐ No ☐ No ☐ No	N/AN/AN/AN/A
e) Does the aerial apparatus fire lane have a minimum unobstructed width of 26-feet? f) Is the space between the aerial lane and the building free of trees exceeding 20' in heights?	X Yes	□ No No	□ N/A □ N/A
7. Are all portions of the required fire lanes within 500-feet of at least (2) hydrants?	X Yes	□ No	□ N/A
Note: Distances shall be measured along the path of the hose lay as it comes off the fire apparatus. a) Is the fire lane at least 26' wide for at least 20-feet on each side of the hydrants? b) Is there at least 40' between a hydrant and the building?	☐ Yes X Yes	X No □ No	□ N/A □ N/A
c) Are the hydrant(s) setback no less than 5-feet nor more than 10-feet from the curb or edge of the street or fire lane?	X Yes	□ No	□ N/A

Attach an additional sheet if further explanation is required for any answers.

This worksheet is based on MGO 34.503 and IFC 2021 Edition Chapter 5 and Appendix D; please see the codes for further information.



CITY OF MADISON LANDSCAPE WORKSHEET

Section 28.142 Madison General Ordinance

Project Loca	ation / Address 1972 Offiversity Bay Drive, Madison Wi
Name of Pro	oject Lakeshore Nature Preserve Frautschi Center
Owner / Co	ntact UW Madison
Contact Pho	one Contact Email
	** Landscape plans for zoning lots greater than ten thousand (10,000) square feet in size MUST be prepared by a registered landscape architect. **
Applicabili	<u>ty</u>
ouildings, s heir access	ing standards apply to all exterior construction and development activity, including the expansion of existing tructures and parking lots, except the construction of detached single-family and two-family dwellings and ory structures. The entire development site must be brought up to compliance with this section unless all of the onditions apply, in which case only the affected areas need to be brought up to compliance:
(a)	The area of site disturbance is less than ten percent (10%) of the entire development site during any ten-(10)
	year period.
(b)	Gross floor area is only increased by ten percent (10%) during any ten-(10) year period.
(c)]	No demolition of a principal building is involved.
(d)	Any displaced landscaping elements must be replaced on the site and shown on a revised landscaping plan.
such as ath andscape p	ding facilities, but excluding the area of any building footprint at grade, land designated for open space uses letic fields, and undeveloped land area on the same zoning lot. There are three methods for calculating oints depending on the size of the lot and Zoning District. For all lots except those described in (b) and (c) below, five (5) landscape points shall be provided for each three hundred (300) square feet of developed area.
	Total square footage of developed area83,809 sq. ft
	Total landscape points required 1397 points
	Total failuscape points required
	For lots larger than five (5) acres, points shall be provided at five (5) points per three hundred (300) square feet for the first five (5) developed acres, and one (1) point per one hundred (100) square feet for all additional acres.
	Total square footage of developed area
	Five (5) acres = $\underline{217,800}$ square feet
	First five (5) developed acres = $3,630 \text{ points}$
	Remainder of developed area
	Total landscape points required
	For the Industrial – Limited (IL) and Industrial – General (IG) districts, one (1) point shall be provided per one hundred (100) square feet of developed area.
	Total square footage of developed area
	Total landscape points required

10/2013

Tabulation of Points and Credits

Use the table to indicate the quantity and points for all existing and proposed landscape elements.

Plant Type/Floment	Minimum Size at	Points		Existing caping	New/ Proposed Landscaping		
Plant Type/ Element	Installation	Fomts	Quantity	Points Achieved	Quantity	Points Achieved	
Overstory deciduous tree	2½ inch caliper measured diameter at breast height (dbh)	35			44	1540	
Tall evergreen tree (i.e. pine, spruce)	5-6 feet tall	35			0	0	
Ornamental tree	1 1/2 inch caliper	15			14	210	
Upright evergreen shrub (i.e. arborvitae)	3-4 feet tall	10			0	0	
Shrub, deciduous	#3 gallon container size, Min. 12"-24"	3			164	492	
Shrub, evergreen	#3 gallon container size, Min. 12"-24"	4			0	0	
Ornamental grasses/ perennials	#1 gallon container size, Min. 8"-18"	2			2032	4064	
Ornamental/ decorative fencing or wall	n/a	4 per 10 lineal ft.			0	0	
Existing significant specimen tree	Minimum size: 2 ½ inch caliper dbh. *Trees must be within developed area and cannot comprise more than 30% of total required points.	14 per caliper inch dbh. Maximum points per tree: 200			0	0	
Landscape furniture for public seating and/or transit connections	* Furniture must be within developed area, publically accessible, and cannot comprise more than 5% of total required points.	5 points per "seat"			0	0	
Sub Totals				0		6306	

Total Number of Points Provided	6306

10/2013

^{*} As determined by ANSI, ANLA- American standards for nursery stock. For each size, minimum plant sizes shall conform to the specifications as stated in the current American Standard for Nursery Stock.

Landscaping shall be distributed throughout the property along street frontages, within parking lot interiors, as foundation plantings, or as general site landscaping. The total number of landscape points provided shall be distributed on the property as follows.

Total Developed Area

Required landscaped areas shall be calculated based upon the total developed area of the property. Developed area is defined as that area within a single contiguous boundary which is made up of structures, parking, driveways and docking/loading facilities, but excluding the area of any building footprint at grade, land designated for open space uses such as athletic fields, and undeveloped land area on the same zoning lot.

Development Frontage Landscaping

Landscaping and/or ornamental fencing shall be provided between buildings or parking areas and the adjacent street(s), except where buildings are placed at the sidewalk. Landscape material shall include a mix of plant materials.

Interior Parking Lot Landscaping

The purpose of interior parking lot landscaping is to improve the appearance of parking lots, provide shade, and improve stormwater infiltration. **All parking lots with twenty (20) or more parking spaces** shall be landscaped in accordance with the interior parking lot standards.

Foundation Plantings


Foundation plantings shall be installed along building facades, except where building facades directly abut the sidewalk, plaza, or other hardscape features. Foundation plantings shall consist primarily of shrubs, perennials, and native grasses.

Screening Along District Boundaries

Screening shall be provided along side and rear property boundaries between commercial, mixed use or industrial districts and residential districts.

Screening of Other Site Elements

The following site elements shall be screened in compatibility with the design elements, materials and colors used elsewhere on the site: refuse disposal areas, outdoor storage areas, loading areas, and mechanical equipment.

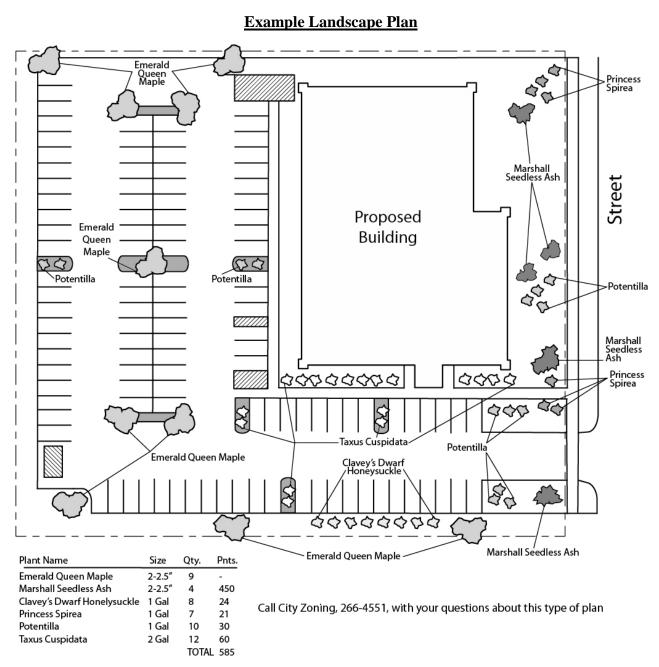

10/2013

3

LANDSCAPE PLAN AND LANDSCAPE WORKSHEET INSTRUCTIONS

Refer to Zoning Code Section 28.142 LANDSCAPING AND SCREENING REQUIREMENTS for the complete requirements for preparing and submitting a Landscape Plan and Landscape Worksheet.

Applicability.

The following standards apply to all exterior construction and development activity, including the expansion of existing buildings, structures and parking lots, except the construction of detached single-family and two-family dwellings and their accessory structures. The entire development site must be brought up to compliance with this section unless all of the following conditions apply, in which case only the affected areas need to be brought up to compliance:

- (a) The area of site disturbance is less than ten percent (10%) of the entire development site during any ten-(10) year period.
- (b) Gross floor area is only increased by ten percent (10%) during any ten-(10) year period.
- (c) No demolition of a principal building is involved.
- (d) Any displaced landscaping elements must be replaced on the site and shown on a revised landscaping plan.

Landscape Plan and Design Standards.

Landscape plans shall be submitted as a component of a site plan, where required, or as a component of applications for other actions, including zoning permits, where applicable. Landscape plans for zoning lots greater than ten thousand (10,000) square feet in size must be prepared by a registered landscape architect.

- (a) Elements of the landscape plan shall include the following:
 - 1. Plant list including common and Latin names, size and root condition (i.e. container or ball & burlap).
 - 2. Site amenities, including bike racks, benches, trash receptacles, etc.
 - 3. Storage areas including trash and loading.
 - 4. Lighting (landscape, pedestrian or parking area).
 - 5. Irrigation.
 - 6. Hard surface materials.
 - 7. Labeling of mulching, edging and curbing.
 - 8. Areas of seeding or sodding.
 - 9. Areas to remain undisturbed and limits of land disturbance.
 - 10. Plants shall be depicted at their size at sixty percent (60%) of growth.
 - 11. Existing trees eight (8) inches or more in diameter.
 - 12. Site grading plan, including stormwater management, if applicable.
- (b) Plant Selection. Plant materials provided in conformance with the provisions of this section shall be nursery quality and tolerant of individual site microclimates.
- (c) Mulch shall consist of shredded bark, chipped wood or other organic material installed at a minimum depth of two (2) inches.

Landscape Calculations and Distribution.

Required landscaped areas shall be calculated based upon the total developed area of the property. Developed area, for the purpose of this requirement, is defined as that area within a single contiguous boundary which is made up of structures, parking driveways and docking/loading facilities, but **excluding** the area of any building footprint at grade, land designated for open space uses such as athletic fields, and undeveloped land area on the same zoning lot.

- (a) Landscaping shall be distributed throughout the property along street frontages, within parking lot interiors, and as foundation plantings, or as general site landscaping.
- (b) Planting beds or planted areas must have at least seventy-five percent (75%) vegetative cover.
- (c) Canopy tree diversity requirements for new trees:
 - 1. If the development site has fewer than 5 canopy trees, no tree diversity is required.
 - 2. If the development site has between 5 and 50 canopy trees, no single species may comprise more than 33% of trees.
 - 3. If the development site has more than 50 canopy trees, no single species may comprise more than 20% of trees.

Development Frontage Landscaping.

Landscaping and/or ornamental fencing shall be provided between buildings or parking areas and the adjacent street(s), except where buildings are placed at the sidewalk. Landscape material shall include a mix of plant material meeting the following minimum requirements:

10/2013 4

- (a) One (1) overstory deciduous tree and five (5) shrubs shall be planted for each thirty (30) lineal feet of lot frontage. Two (2) ornamental trees or two (2) evergreen trees may be used in place of one (1) overstory deciduous tree.
- (b) In cases where building facades directly abut the sidewalk, required frontage landscaping shall be deducted from the required point total.
- (c) In cases where development frontage landscaping cannot be provided due to site constraints, the zoning administrator may waive the requirement or substitute alternative screening methods for the required landscaping.
- (d) Fencing shall be a minimum of three (3) feet in height, and shall be constructed of metal, masonry, stone or equivalent material. Chain link or temporary fencing is prohibited.

Interior Parking Lot Landscaping.

The purpose of interior parking lot landscaping is to improve the appearance of parking lots, provide shade, and improve stormwater infiltration. All parking lots with twenty (20) or more parking spaces shall be landscaped in accordance with the following interior parking lot standards.

- (a) For new development on sites previously undeveloped or where all improvements have been removed, a minimum of eight percent (8%) of the asphalt or concrete area of the parking lot shall be devoted to interior planting islands, peninsulas, or landscaped strips. For changes to a developed site, a minimum of five percent (5%) of the asphalt or concrete area shall be interior planting islands, peninsulas, or landscaped strips. A planting island shall be located at least every twelve (12) contiguous stalls with no break or alternatively, landscaped strips at least seven (7) feet wide between parking bays.
- (b) The primary plant materials shall be shade trees with at least one (1) deciduous canopy tree for every one hundred sixty (160) square feet of required landscaped area. Two (2) ornamental deciduous trees may be substituted for one (1) canopy tree, but ornamental trees shall constitute no more than twenty-five percent (25%) of the required trees. No light poles shall be located within the area of sixty percent (60%) of mature growth from the center of any tree.
- (c) Islands may be curbed or may be designed as uncurbed bio-retention areas as part of an approved low impact stormwater management design approved by the Director of Public Works. The ability to maintain these areas over time must be demonstrated. (See Chapter 37, Madison General Ordinances, Erosion and Stormwater Runoff Control.)

Foundation Plantings.

Foundation plantings shall be installed along building facades, except where building facades directly abut the sidewalk, plaza, or other hardscape features. Foundation plantings shall consist primarily of shrubs, perennials, and native grasses. The Zoning Administrator may modify this requirement for development existing prior to the effective date of this ordinance, as long as improvements achieve an equivalent or greater level of landscaping for the site.

Screening Along District Boundaries.

Screening shall be provided along side and rear property boundaries between commercial, mixed use or industrial districts and residential districts. Screening shall consist of a solid wall, solid fence, or hedge with year-round foliage, between six (6) and eight (8) feet in height, except that within the front yard setback area, screening shall not exceed four (4) feet in height. Height of screening shall be measured from natural or approved grade. Berms and retaining walls shall not be used to increase grade relative to screening height.

Screening of Other Site Elements.

The following site elements shall be screened in compatibility with the design elements, materials and colors used elsewhere on the site, as follows:

- (a) <u>Refuse Disposal Areas.</u> All developments, except single family and two family developments, shall provide a refuse disposal area. Such area shall be screened on four (4) sides (including a gate for access) by a solid, commercial-grade wood fence, wall, or equivalent material with a minimum height of six (6) feet and not greater than seven (7) feet.
- (b) <u>Outdoor Storage Areas.</u> Outdoor storage areas shall be screened from abutting residential uses with a by a building wall or solid, commercial-grade wood fence, wall, year-round hedge, or equivalent material, with a minimum height of six (6) feet and not greater than seven (7) feet. Screening along district boundaries, where present, may provide all or part of the required screening.
- (c) <u>Loading Areas.</u> Loading areas shall be screened from abutting residential uses and from street view to the extent feasible by a building wall or solid, commercial-grade wood fence, or equivalent material, with a minimum height of six (6) feet and not greater than seven (7) feet. Screening along district boundaries, where present, may provide all or part of the required screening.
- (d) <u>Mechanical Equipment.</u> All rooftop and ground level mechanical equipment and utilities shall be fully screened from view from any street or residential district, as viewed from six (6) feet above ground level. Screening may consist of a building wall or fence and/or landscaping as approved by the Zoning Administrator.

Maintenance.

The owner of the premises is responsible for the watering, maintenance, repair and replacement of all landscaping, fences, and other landscape architectural features on the site. All planting beds shall be kept weed free. Plant material that has died shall be replaced no later than the upcoming June 1.

10/2013