

URBAN DESIGN COMMISSION APPLICATION CITY OF MADISON

This form may also be completed online at: http://www.cityofmadison.com/planning/documents/UDCapplication.pdf

215 Martin Luther King Jr. Blvd; Room LL-100 PO Box 2985; Madison, Wisconsin 53701-2985 Phone: 608.266.4635 | Facsimile: 608.267.8739

Please complete all sections of the application, including the desired meeting date and the type of action requested.

Date Submitted: December 21, 2016 UDC Meeting Date: January 11, 2017 Combined Schedule Plan Commission Date (if app	☐ Informational Presentation ☑ Initial Approval ☑ Final Approval		
1. Project Address: 801 E. Washington A			
Project Title (if any): The Cosmos			
2. This is an application for (Check all that apply to		N= 1	
New Development Alteration to a	in Existing or Previously-Approv	ved Development	
A. Project Type: Project in an Urban Design District* (put Project in the Downtown Core District (Suburban Employment Center (SEC) or Planned Development (PD) General Development Plan (GDP) Specific Implementation Plan (SIP) Planned Multi-Use Site or Planned Resi	(DC) or Urban Mixed-Use Distri Campus Institutional District (C		
B. Signage: Comprehensive Design Review* (public h Signage Exception(s) in an Urban Desig C. Other:		phics Variance* (public hearing-\$300 fee)	
Please specify:			
3. Applicant, Agent & Property Owner Info	rmation:		
Applicant Name: Otto C. Gebhardt III		ardt Development LLC	
Street Address: 222 North Street	City/State: Madi:		
Telephone:(<u>608</u>) 245-0753 Fax:()	E _{mail} : gebhardt	tdevelopment@tds.net	
Project Contact Person: Lee Christensen	Company: Gebh	ardt Development LLC	
Street Address: 222 North Street	City/State: Madi	son, WI z _{ip:} 53704	
Telephone:(608) 209-7568 Fax:()		Email: lee@gebhardtdevelopment.com	
Project Owner (if not applicant) : City of Madison	Madi	oon WI - 53703	
Street Address: 126 South Hamilton Street	City/State: Madi Email:	son, WI z _{ip:} 53703	
Telephone:() Fax:()	Elliali		
4. Applicant Declarations: A. Prior to submitting this application, the applicant is req application was discussed with Al Martin (name of staff person) B. The applicant attests that all required materials are included the application deadline, the application will not be placed.	on <u>August 5, 2016</u> (date of meeting) luded in this submittal and understand	Is that if any required information is not provided by	
Name of Applicant Otto C. Gebhardt III		roperty Applicant	
Authorized Signature	Date Decem	ber 21, 2016	



December 21, 2016

Via Email and Hand Delivery

Plan Commission and Urban Design Commission City of Madison 126 South Hamilton Street Madison, WI 53703

Re: Letter of Intent for Proposed Development
The Cosmos Project – 801 East Washington Avenue

Dear Commission Members:

Gebhardt Development, LLC is pleased to present the enclosed materials as part of a Land Use and Design Review submittal to the Plan Commission and the Urban Design Commission for the third project in Gebhardt's redevelopment of the former Don Miller car dealership parcels on East Washington Avenue, including The Constellation on the 700 North Block and The Galaxie on the 800 North Block.

This letter of intent is for a resubmittal of the Land Use and Urban Design Commission applications for the eight-story version of The Cosmos Project at 801 East Washington Avenue. The Urban Design Commission previously reviewed and granted Initial Approval for the four-story version of the project on November 30, 2016. The Plan Commission reviewed and approved the four-story version on December 12, 2016.

Project Summary

The Cosmos Project includes 4 stories / approximately 43,400 square feet of retail and office space at the corner of East Washington Avenue and South Livingston Street, 2 stories (with a total height of approximately 32 feet) / approximately 9,500 square feet of retail and office space at the corner of East Main Street and South Livingston Street, 2 stories / approximately 40,025 square feet for an entertainment venue on South Livingston Street, and an additional 4 stories / approximately 60,000 square feet of office space above the entertainment venue.

The entertainment venue will be owned and operated by Frank Productions and will include a capacity of up to 2,500 people for live music and other types of entertainment. The Cosmos and The Spark will share a landscaped mid-block plaza, and The Cosmos will also include rooftop outdoor landscaped areas for use by tenants and guests. Gebhardt is seeking conditional use

approval for general retail, food and related goods sales, restaurant, tavern, outdoor eating/drinking areas, concert hall, and height exceeding district standards for The Cosmos.

Existing Site Conditions

This site currently includes 2.01 acres of vacant surface parking area bounded by East Washington Avenue, South Livingston Street and East Main Street extending 264.74 feet to the northeast. The internal site boundaries will be reorganized via a certified survey map (CSM) to divide the site into two parcels, one owned by Gebhardt Development and one owned by American Family Insurance. On the East Washington Capitol Gateway Corridor Plan, the site is shown as part of Block 12, sub blocks A and B. This site is currently zoned TE Traditional Employment. With conditional use approval under this zoning designation, The Cosmos will comply with current zoning.

Access to the site is provided by East Washington Avenue, South Livingston Street and East Main Street. The site is also served by Madison Metro routes 6, 14, 15, 25, 27, 29, 37, 56 and 57.

Project Layout

The project is located within Urban Design District No. 8 along the East Washington Capitol Gateway Corridor in Sub Blocks 12a & b. The project as currently designed meets established requirements or permissible variations for building height, façade height, minimum/maximum setback, and minimum stepback.

The South Livingston Street setback varies between 5 and 15 feet (the District standard is 0-10 feet, but the Commission can allow for a greater setback to allow for the articulation of long building facades or the development of additional usable open public spaces). The Livingston Street setbacks are proposed to allow for articulation of the long building façade, allow for the development of additional usable open space and accommodate an existing utility easement.

The building is two stories along East Main Street (3-5 stories are required unless greater floor heights are provided). The proposed minimum 18' ground floor and minimum 14' second floor height exceed average required story heights and have an overall height meeting the three-story height requirements.

Proposed trash areas are enclosed or screened and bike parking is shown dispersed through the site. Selections related to exterior materials, landscaping, lighting and other elements are intended to comply with design district guidelines. The project design is intended to be consistent with design district guidelines, as provided below.

Project Objectives and Benefits

The Project will benefit the City of Madison in the following ways:

 Revitalizing the western half of the 800 South Block of East Washington Avenue and providing a catalyst for further redevelopment on the south side of the street.

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- Providing additional employment opportunities to the area by activating unused commercial property and adding substantial amounts of office, retail and other commercial space to the employment corridor.
- Improving pedestrian access to and circulation around the site by upgrading existing sidewalks and adding landscaping areas.
- Substantially increasing the property tax base on the block by placing currently exempt property on the tax rolls and constructing substantial improvements on the property.

Project Data

Location: 801 East Washington Avenue

Building Sq. Ft.: Approximately 161,750 sq. ft.

<u>Start Construction:</u> Approximately February 2017

Complete Construction: Approximately February 2018

<u>Type of Building:</u> Commercial (retail, restaurant, office and concert venue)

<u>Land Area:</u> Approximately 1.17 acres (51,123 sq. ft.)

Vehicle Parking: Approximately 275 vehicle parking spaces to be provided in

the parking ramp to be constructed by the City pursuant to a Development Agreement between the City, Gebhardt and

American Family.

Bicycle Parking: Approximately 226 bicycle spaces distributed throughout the

site in traditional racks, vertical racks adjacent to the plaza area, shared racks with The Spark, and an interior bike room. The bicycle parking requirement is further reduced by the availability of public bicycle parking in the new parking ramp, the proximity of the site to a primary transit corridor, and

different times of peak use for the concert venue.

<u>Site Access:</u> East Washington Ave., South Livingston St., East Main St.

Lot Coverage: 43,454 sq. ft. (85.0%)

<u>Usable Open Space:</u> 7,669 sq. ft. (15.0%)

Hours of Operation: Approximately 10:00 a.m.-10:00 p.m. Monday through

Sunday (retail/restaurant) / approximately 7:00 a.m.-6:00 p.m. Monday through Friday (office) / approximately 5:00

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p.m.-Midnight (concert venue), subject to variations based on tenant requirements or venue requirements.

Project Financial Information

Value of Land: The land is currently assessed as commercial exempt property.

Estimated Project Cost: Approximately \$12 million

Number of Construction & Full-time Equivalent Jobs on Site: Approximately 200 construction jobs and 200 full-time equivalent office, retail and restaurant jobs.

Public Subsidy Requested: None.

Urban Design District Standards

1. Building Height

- a. The proposed street level facade height of 4 stories/60 feet complies with the District requirements along East Washington Avenue of a minimum/maximum height of 3-5 stories/29-63 feet.
- b. The proposed street level facade height of 2 stories/32 feet complies with the District requirements along East Main Street of a minimum/maximum height of 3-5 stories/29-63 feet.
- c. The proposed building height of 8 stories/116 feet complies with the maximum building height of 12 stories/147 feet along East Washington Avenue and 8 stories/99 feet along East Main Street (with the potential for 2 bonus stories for a total of 10 stories/123 feet).

2. Building Location and Orientation

- a. The Project addresses East Washington Avenue, East Main Street and South Livingston Street with commercial entrances facing these primary streets.
- b. Project entrances adequately connect to public sidewalks.
- c. The primary building entrances will be visually enhanced with features to increase pedestrian interaction with the project.

3. Setback and Stepback

- a. Proposed setbacks of 15 feet along East Washington Avenue and East Main Street are in compliance with District requirements. The proposed setback along South Livingston Street varies between 5-15 feet (the District standard is 0-10 feet, but the Commission can allow for a greater setback to allow for the articulation of long building facades or the development of additional usable open public spaces).
- b. Proposed building stepbacks on East Washington Avenue, East Main Street and South Livingston Street meet the District minimum requirement of 15 feet.

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4. Parking and Service Areas; Circulation

- a. Off-street parking for the project will be provided through an agreement with the City for the new city ramp to be constructed directly across from the project on East Main Street and South Livingston Street.
- b. Service entries such as the loading docks for the concert venue are primarily located at the back of the project along East Main Street and will not be visible from the primary building facades along East Washington Avenue, South Livingston Street and the southwest corner of East Main Street.
- c. The entry drive is perpendicular to the respective connecting street.
- d. A loading zone is being provided off-street at the East Main Street driveway. This loading zone does not impede pedestrian movement along East Main Street and will allow trucks to completely park on the project site and not encroach on the sidewalk or terrace.

5. Landscaping and Open Space

- Landscaping along East Washington Avenue, East Main Street and South Livingston Street will contain canopy trees and plantings appropriate for an urban project.
 Street furniture such as benches, bike racks and trash receptacles will be provided.
- b. The shared plaza with The Spark building will be extensively landscaped to provide a unique experience for occupants and visitors of the two projects.
- c. Rooftop features will be partially landscaped to provide a comfortable and attractive rooftop setting for building occupants.

6. Site Lighting and Furnishings

- a. The Project will have adequate but not excessive pedestrian-level lighting and accent lighting where appropriate, designed to complement the character of the building. Building signage will include appropriate lighting to provide proper direction to building users.
- b. Full cut-off light fixtures will be used to illuminate the site.

7. Building Massing and Articulation

- a. The building mass respects and compliments views identified on the Views and Vista Map in the Downtown Plan.
- b. The Project will have unique, primary design elements on the first floor facing East Washington Avenue, South Livingston Street and East Main Street. Secondary design elements from levels two through four will define the office and concert venue portions of the project. The office tower above the fourth floor will include compatible yet distinct design features.
- c. The ground level of the commercial areas facing East Washington Avenue, South Livingston Street and East Main Street will have increased visual interest by way of storefront glazing, canopies, signage and landscape features.
- d. Rooftop equipment will be screened with parapet walls or vegetation, or located inside the building below the tower element.

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8. Materials and Colors

- a. High-quality, durable, low-maintenance exterior building materials will be used including brick, cementitous siding, metal wall panel and/or storefront glazing.
- b. Colors and building textures will be consistent with surrounding properties and are typical for urban projects.

9. Windows and Entrances

- a. No clear existing window and door pattern exists around the Project. The rhythm shown in the commercial and residential uses will be typical and appropriate for an urban project.
- b. At least 40-60% of the ground floor exterior of the commercial spaces will be dedicated to windows. All windows on the ground floor of the Project will be transparent and unobstructed.
- c. The commercial entrances will be uniquely defined and clearly discernible the public from the street.

10. Signage

Signage will be integrated with the Project's architecture. Colors and low-level lighting will be selected to coordinate with the building façade and enhance the character of the Project.

Project Team

Developer: Gebhardt Development, LLC

222 North Street Madison, WI 53704

Project Representative: Lee Christensen

Phone: (608) 209-7568

Email: lee@gebhardtdevelopment.com

Architect: Strang, Inc.

6411 Mineral Point Road Madison, WI 53705

Project Representative: Rick Gilbertsen

Phone: (608) 276-9201

Email: rgilbertsen@strang-inc.com

Civil: Professional Engineering

818 North Meadowbrook Lane

Waunakee, WI 53597

Project Representative: Roxanne Johnson

Phone: (608) 849-9378 Email: rjohnson@pe-wi.com

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Landscape: VierbicherAssociates

999 Fourier Drive, Suite 201

Madison, WI 53717

Project Representative: Suzanne Vincent

Phone: (608) 826-0532 Email: svin@vierbicher.com

Land Use: Husch Blackwell LLP

33 East Main Street, Suite 300

Madison, WI 53703

Project Representative: Angela Black

Phone: (608) 255-4440

Email: angela.black@huschblackwell.com

We look forward to presenting these materials to you and seeking your approval of this proposal to revitalize and enhance this portion of the Capitol East District corridor.

Sincerely

Otto C. Gebhardt, III

cc: (all via email)

Marsha Rummel, District 6 Alderperson

Natalie Erdman, Director of Planning, Community and Economic Development


Heather Stouder, Planning Division Director

Tim Parks, Planning Division Al Martin, Planning Division

Matt Tucker, Zoning Administrator


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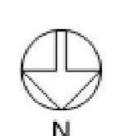
ARCHITECTURE
ENGINEERING
INTERIOR DESIGN

STRANG, INC. 6411 MINERAL POINT ROAD MADISON, WI 53705-4395

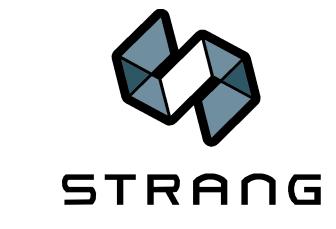

THE COSMOS PROJECT

SITE LOCATOR SCALE: NTS

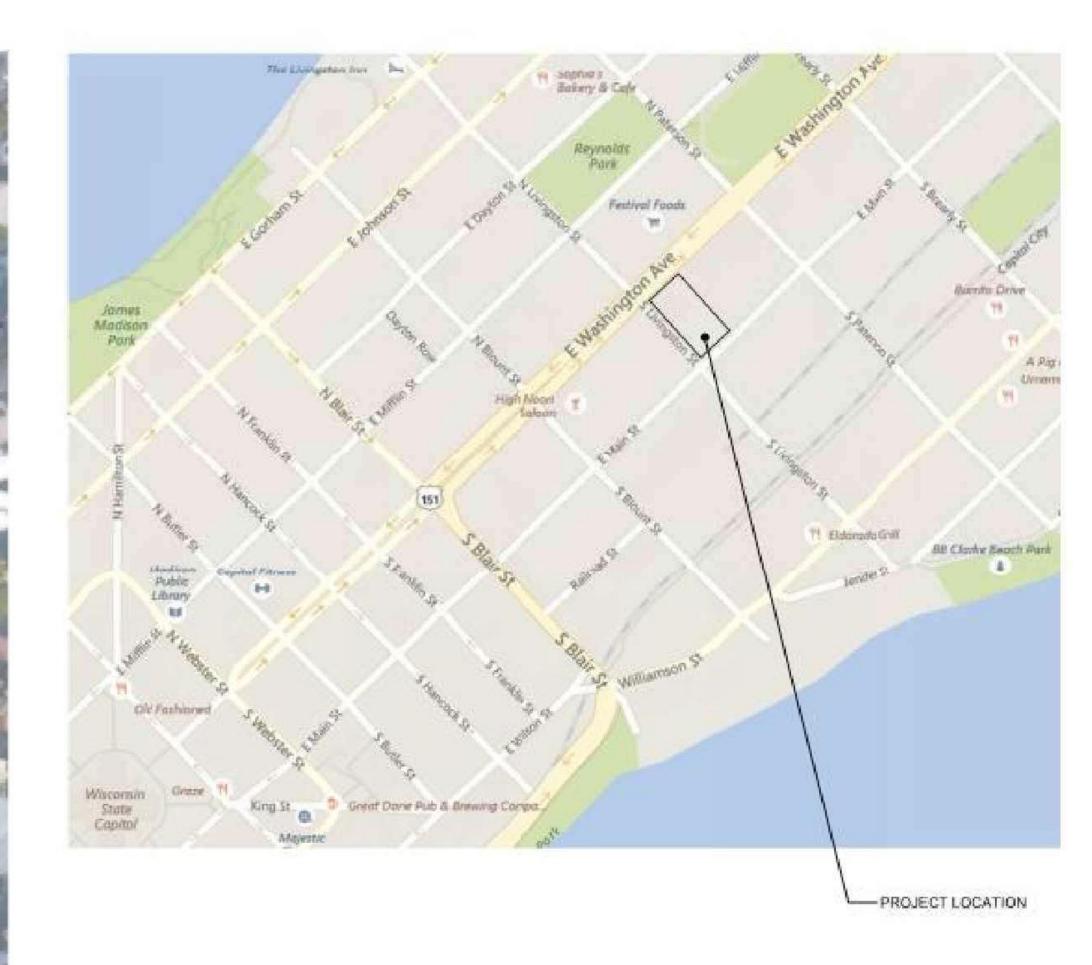





BREESE STEVEN FIELD COSMOS

GALAXIE DEVELOPMENT 14 STORIES









SITE PHOTOS

 COPYRIGHT STRANG, INC.
 2016

 DATE
 12-21-2016

 PROJECT NO.
 2016090

PROJECT TITLE

GEBHARDT DEVELOPMENT -THE COSMOS PROJECT

801 E. WASHINGTON AVENUE MADISON, WISCONSIN 53703

STORM INLET-FLOW LINE=849.57 INV 15" RCP=847.0 EXISTING BUILDING EXISTING BUILDING -STORM INLET FLOW LINE=849.94 INV 12" RCP=847.70 STORM MANHOLE RIM=849.54 SANITARY MANHOLE RIM ELEV=850.45' STORM MANHOLE RIM=849.82 INV 12" RCP=845.3 330.39' INVERT 8" PVC=844.35' STORM INLET FLOW LINE=850.10 INV 12" RCP=847.90 LEGEND STORM INLET FLOW LINE=849.91 INV 12" RCP SW=847.7 SET CHISELED '+' IN CONCRETE 0.75" DIAMETER SOLID IRON ROD FOUND (WITH PLASTIC CAP) INDICATES RECORDED AS DISTANCES ARE MEASURED TO THE NEAREST HUNDREDTH OF A FOOT. TRANSMISSION POWER POLE LIGHT POLE OR STOP LIGHT POLE VENU WATER VALVE ∢i⊾ FIBER OPTIC VAULT SANITARY MANHOLE RIM=849.03 HYDRANT 0 INV 8" PVC SE-NE=842.43 BENCH ELEV=843.23 MISC. MANHOLE -TREE-DECIDUOUS RIM ELEV=850.93' DEPTH APPROX. 3 FEET _____ GAS UNDERGROUND _____ STORM SEWER ___ FIBER OPTIC CABLE ≥| ____ SANITARY SEWER _____ WATER Parcel Contains _____ UNDERGROUND ELECTRIC 87,471 S.F. OVERHEAD ELECTRIC 2.01 Acres ATC (UNDERGROUND **ELECTRIC TRANSMISSION)** ORIGINAL PLAT ... TE TE TE TRAFFIC ENGINEERING FLOW LINE=848.57 INV 12" RCP=846.30 EX CONCRETE Exception 10: 35'x85' Perpetual Right and Easement for Underground Electric Transmission EX PAVEMENT and distribution in Doc. No. 2070527. *INV 18" RCP=843.90 EX GRAVEL INV 24" RCP=843.30 STORM CATCH BASIN FLOW LINE=850.01 RIM=849.57 STORM INLET FLOW LINE=849.43 INV 12" RCP=847.2 NV 8" PVE=848.00 INV 8" PVC=840.70 STORM INLET BENCH ELEV=841.37 STORM INLET FLOW LINE=848.36 FLOW LINE=848.25 STORM INLET—
FLOW LINE=849.31 INV 18" RCP=845.20 INV 15" RCP=846.10 PVC STORM INV 12" RCP=847.60 🔆 INV 12" RCP=847.2 INV 15" RCP=847.0 [^]∖N43°56′13″W 3/30.58' ____OHW____OHW___ SANITARY MANHOLE RIM ELEV S. LIVINGSTON STREET -SANITARY MH RIM=850.25 INV 8" PVC=842.97 L₁₅"
RCP STORM SCALE : $1'' = 20' (30 \times 42)$ SCALE : $1" = 40' (11 \times 17)$



eppstein uhen : architects

milwaukee 3 3 3 East Chicago Street
Milwaukee, Wisconsin 53202
telephone 414.271.5350
madison 309 West Johnson Street, Suite 202
Madison, Wisconsin 53703
telephone 608.442.5350



6411 Mineral Point Road Madison, WI 53705 (608) 276 - 9200





818 N Meadowbrook Ln Waunakee, WI 53597 (608) 849-9378

PROJECT INFORMATION

COSMOS -THE SPARK PROJECTS

800 E WASHINGTON AVE MADISON, WI





ISSUANCE AND REVISIONS

UDC Submittal (Revised)

DATE DESCRIPTION

SHEET INFORMATION

PROGRESS DOCUMENTS NOT FOR CONSTRUCTION

These documents reflect progress and intent and may be subject to change, including additional detail. These are not final construction documents and should not be used for final bidding or construction-related purposes.

PROJECT MANAGER
PROJECT NUMBER

DATE 12-21-16

EXISTING CONDITIONS

eppstein uhen : architects milwaukee 3 3 3 East Chicago Street Milwaukee, Wisconsin 53202 telephone 414 . 271 . 5350

309 West Johnson Street, Suite 202 Madison, Wisconsin 53703 telephone 608.442.5350



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608 . 358 . 6344 PROFESSIONAL ENGINEERING

818 N Meadowbrook Ln Waunakee, WI 53597 (608) 849-9378

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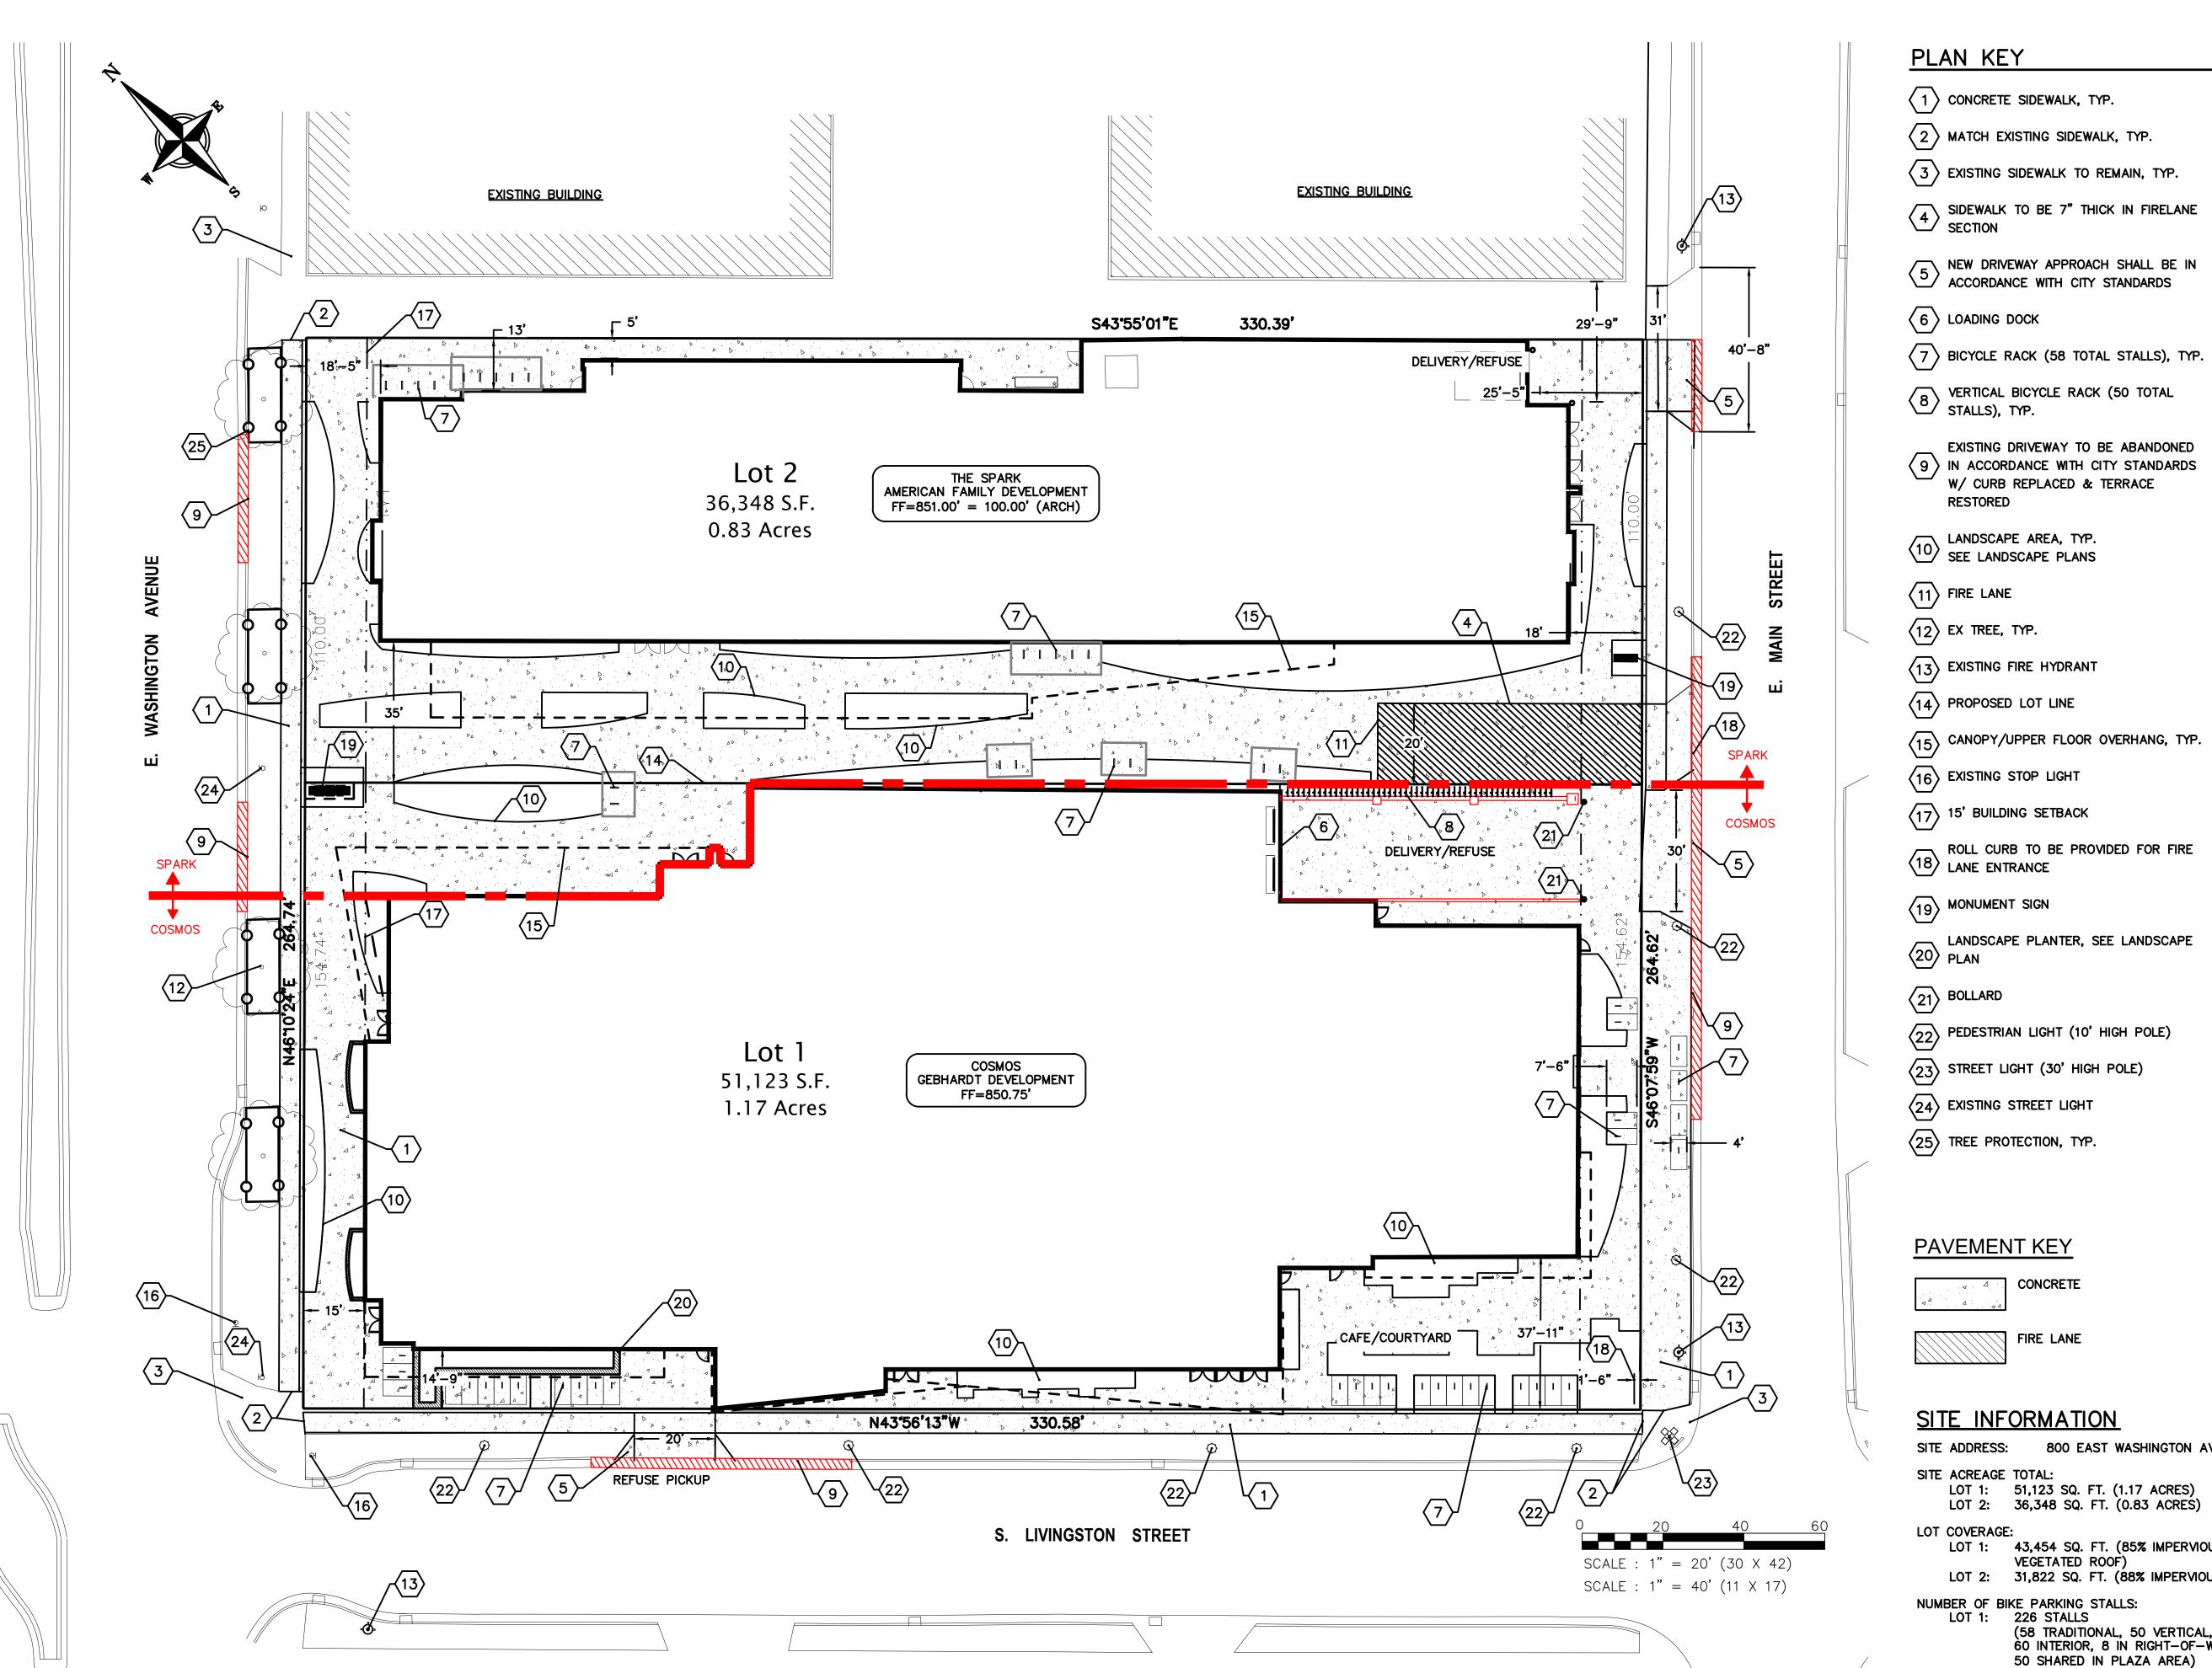
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PROJECT MANAGER PROJECT NUMBER 12-21-16

SITE PLAN



PLAN KEY

- 1 CONCRETE SIDEWALK, TYP.
- 2 MATCH EXISTING SIDEWALK, TYP.
- 3 EXISTING SIDEWALK TO REMAIN, TYP.
- SIDEWALK TO BE 7" THICK IN FIRELANE SECTION
- NEW DRIVEWAY APPROACH SHALL BE IN ACCORDANCE WITH CITY STANDARDS
- $\overline{7}$ BICYCLE RACK (58 TOTAL STALLS), TYP.
- 8 VERTICAL BICYCLE RACK (50 TOTAL STALLS), TYP.
- EXISTING DRIVEWAY TO BE ABANDONED 9 IN ACCORDANCE WITH CITY STANDARDS
 W/ CURB REPLACED & TERRACE
- LANDSCAPE AREA, TYP.
 SEE LANDSCAPE PLANS

- (13) EXISTING FIRE HYDRANT
- 14 PROPOSED LOT LINE
- (15) CANOPY/UPPER FLOOR OVERHANG, TYP.
- 16 EXISTING STOP LIGHT
- 17 15' BUILDING SETBACK
- ROLL CURB TO BE PROVIDED FOR FIRE LANE ENTRANCE

- PEDESTRIAN LIGHT (10' HIGH POLE)
- 23 STREET LIGHT (30' HIGH POLE)
- 24 EXISTING STREET LIGHT
- 25 TREE PROTECTION, TYP.

PAVEMENT KEY

CONCRETE



SITE INFORMATION

SITE ADDRESS: 800 EAST WASHINGTON AVENUE

SITE ACREAGE TOTAL: LOT 1: 51,123 SQ. FT. (1.17 ACRES) LOT 2: 36,348 SQ. FT. (0.83 ACRES)

LOT 1: 43,454 SQ. FT. (85% IMPERVIOUS, INCLUDES VEGETATED ROOF)
LOT 2: 31,822 SQ. FT. (88% IMPERVIOUS)

NUMBER OF BIKE PARKING STALLS: LOT 1: 226 STALLS (58 TRADITIONAL, 50 VERTICAL, 60 INTERIOR, 8 IN RIGHT-OF-WAY, &

50 SHARED IN PLAZA AREA)
LOT 2: 43 STALLS

euic

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PROFESSIONAL ENGINEERING

818 N Meadowbrook Ln Waunakee, WI 53597 (608) 849-9378

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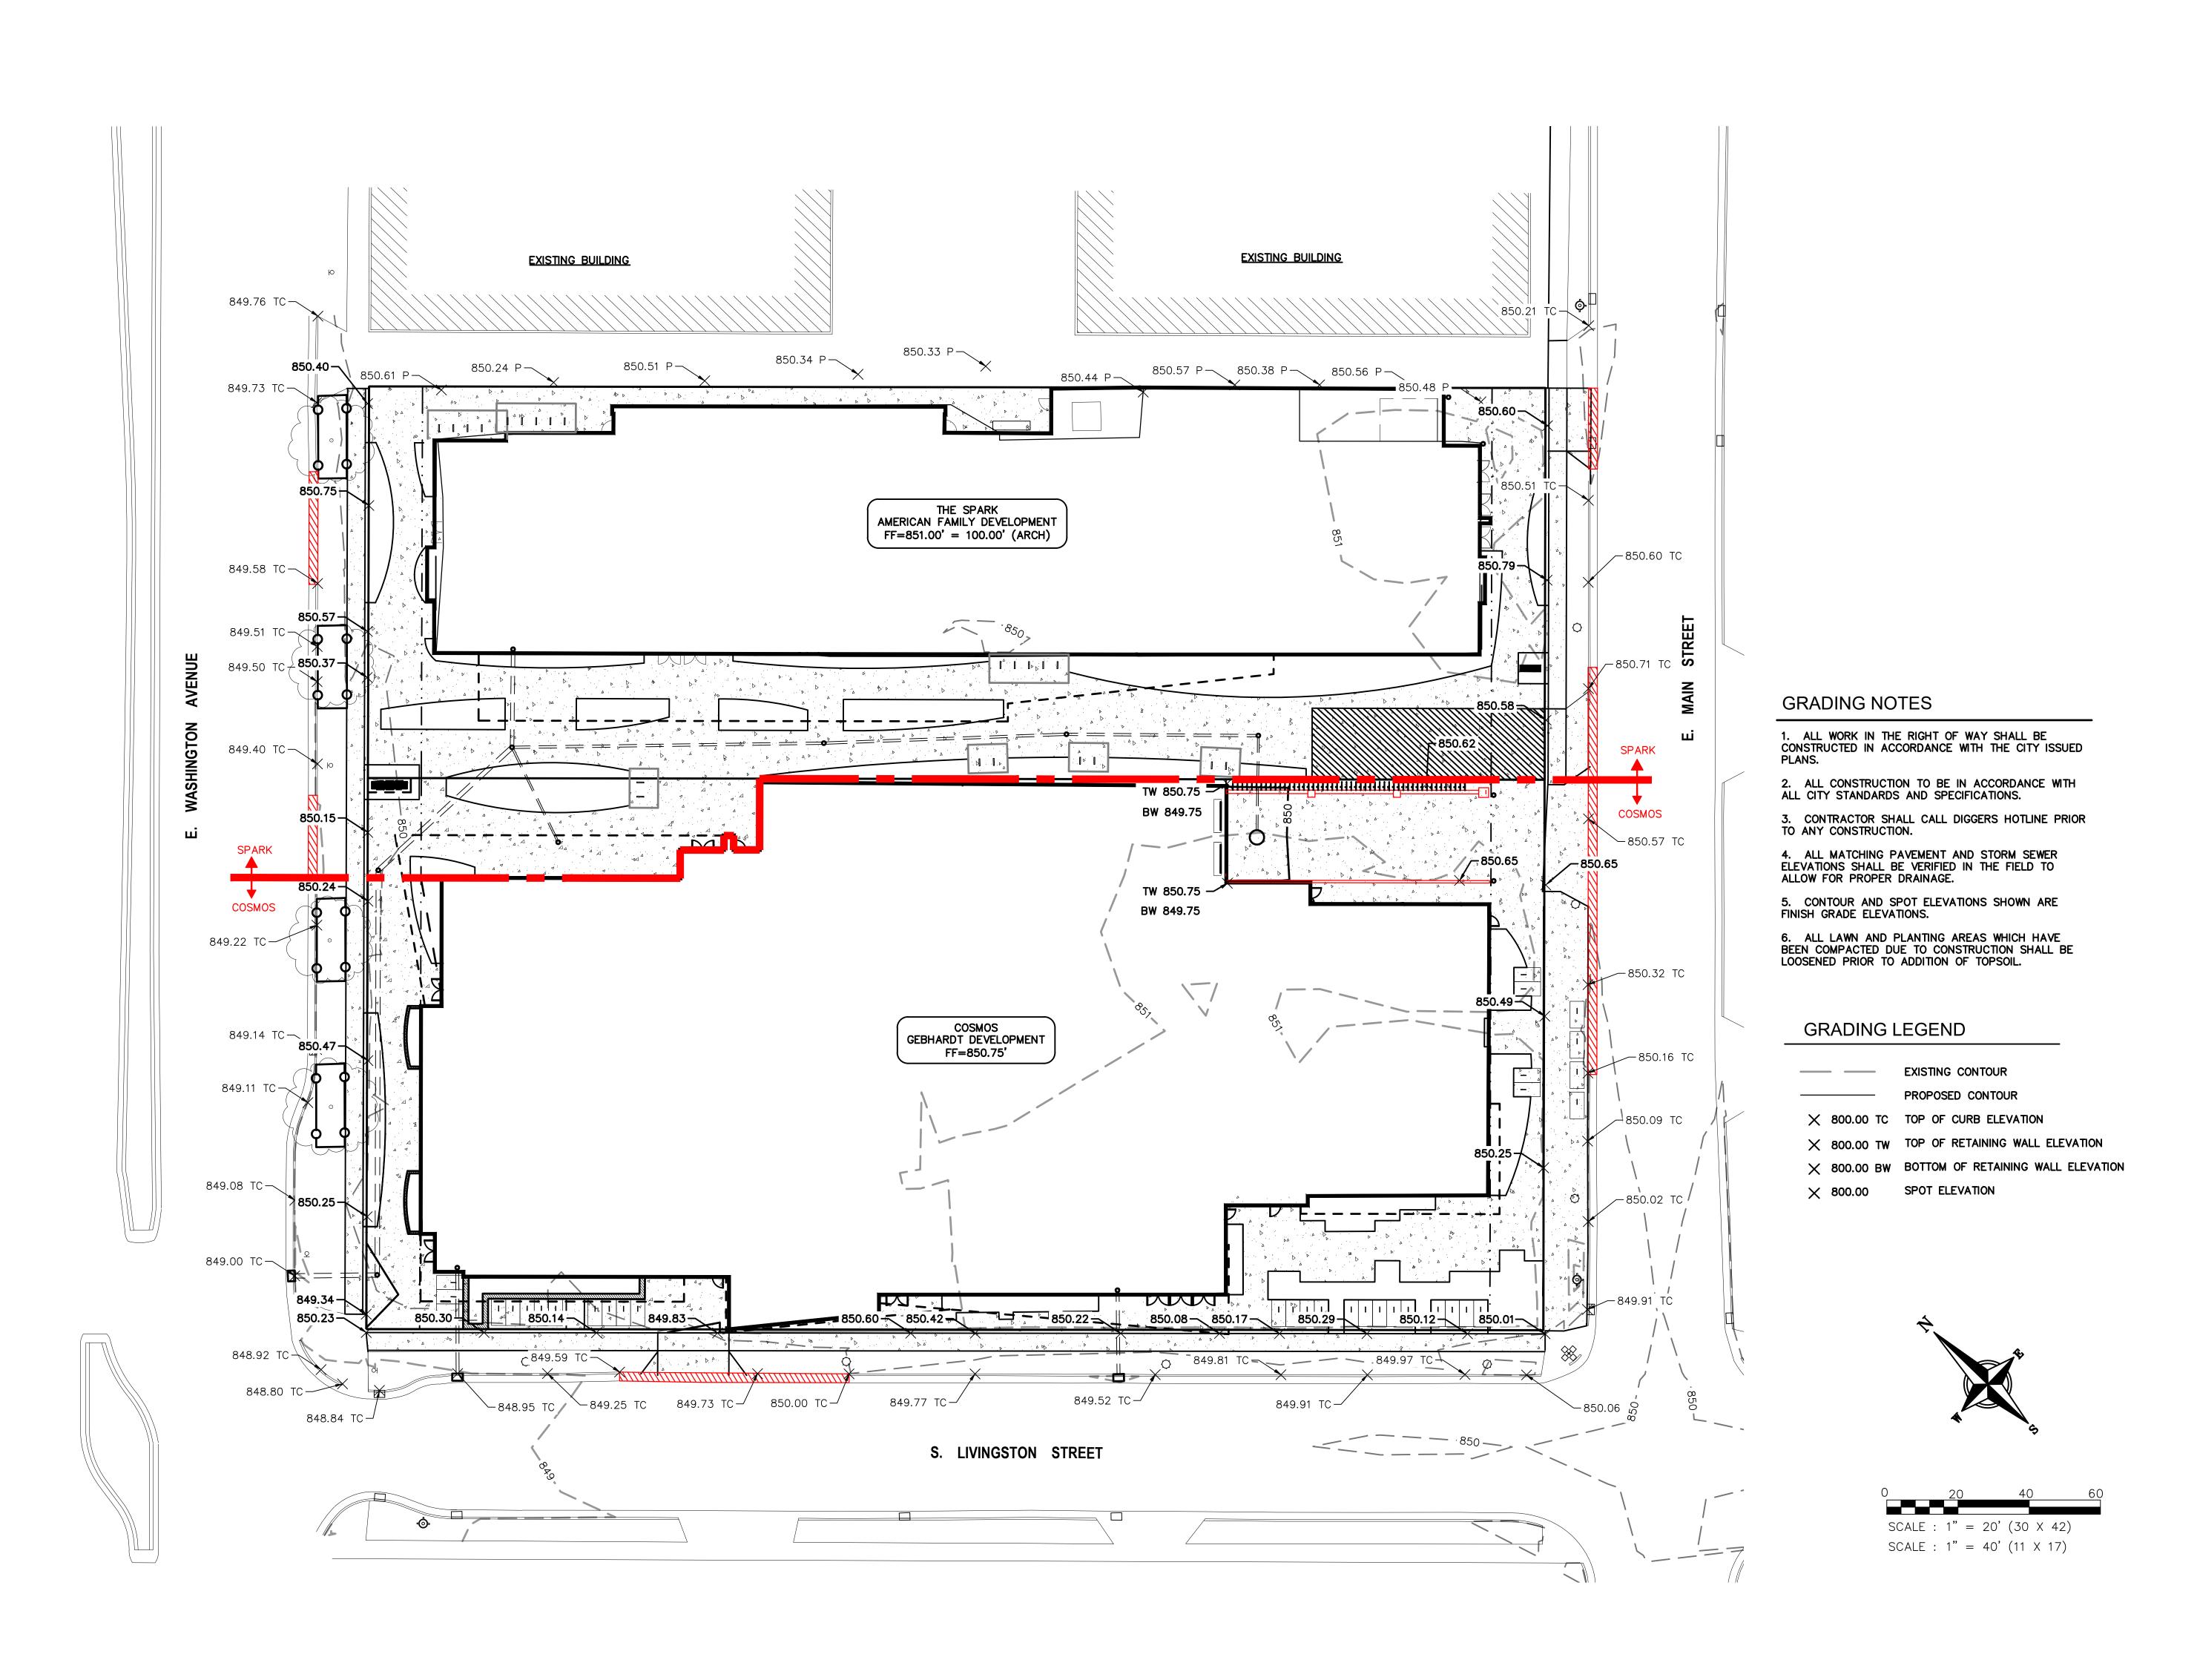
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PROJECT MANAGER RJ
PROJECT NUMBER 1249
DATE 12-21-16

GRADING PLAN



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telephone 414.271.5350 3 0 9 West Johnson Street, Suite 202 Madison, Wisconsin 53703 telephone 608.442.5350



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608.358.6344

PROFESSIONAL ENGINEERING

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PROJECT INFORMATION

COSMOS -THE SPARK PROJECTS

800 E WASHINGTON AVE MADISON, WI





ISSUANCE AND REVISIONS

UDC Submittal (Revised)

DATE DESCRIPTION


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PROJECT MANAGER PROJECT NUMBER

12-21-16



PLAN KEY

- CONNECT TO EXISTING WATER MAIN WITH 8"X8"X8" CUT-IN TEE. COORDINATE INSTALLATION WITH MADISON WATER UTILITY
- 2 8" WATER SERVICE
- 3 8" VALVE
- 4 8" SANITARY LATERAL @ 0.52% MIN. SLOPE
- $\langle 5 \rangle$ 8" SANITARY INV=844.50'. EXTEND 5 FEET INTO BUILDING
- SANITARY MANHOLE PER CITY REQUIREMENTS, RIM=850.45, INVERT=844.13
- 7 RAINWATER HOLDING TANK
- 8 SEE PLUMBING PLANS FOR CLEAN OUT LOCATION
- 9 UTILITY PATCH PER CITY REQUIREMENTS
- (10) CONNECT TO EXISTING STORM SEWER INLET PER CITY STANDARDS
- CONNECT TO ROOF DRAIN. COORDINATE WORK WITH PLUMBING CONTRACTOR.
- EXISTING 1" WATER SERVICE TO BE ABANDONED
- (13) EXISTING LIGHT POLE
- (14) EXISTING OVERHEAD ELECTRICAL TO BE RELOCATED
- (15) EXISTING POWER POLE TO BE REMOVED
- (16) FOOTING CAP OR FOUNDATIONS
- (17) GAS SERVICE, COORDINATE LOCATION WITH MG&E
- 18 ELECTRIC SERVICE, COORDINATE LOCATION WITH MG&E
- EXCEPTION 10: 35'X85' PERPETUAL RIGHT AND EASEMENT FOR UNDERGROUND ELECTRIC TRANSMISSION AND DISTRIBUTION IN DOC. NO. 2070527.
- TELECOM 4" FIBER/COPPER CONDUIT, COORDINATE LOCATION WITH AT&T
- 21 SANITARY MANHOLE, RIM=850.53, INVERT=843.63
- 22 GEO-EXCHANGE WELL, TYP
- (23) INSTALL STORM UNDER TRAFFIC ENGINEERING VAULT

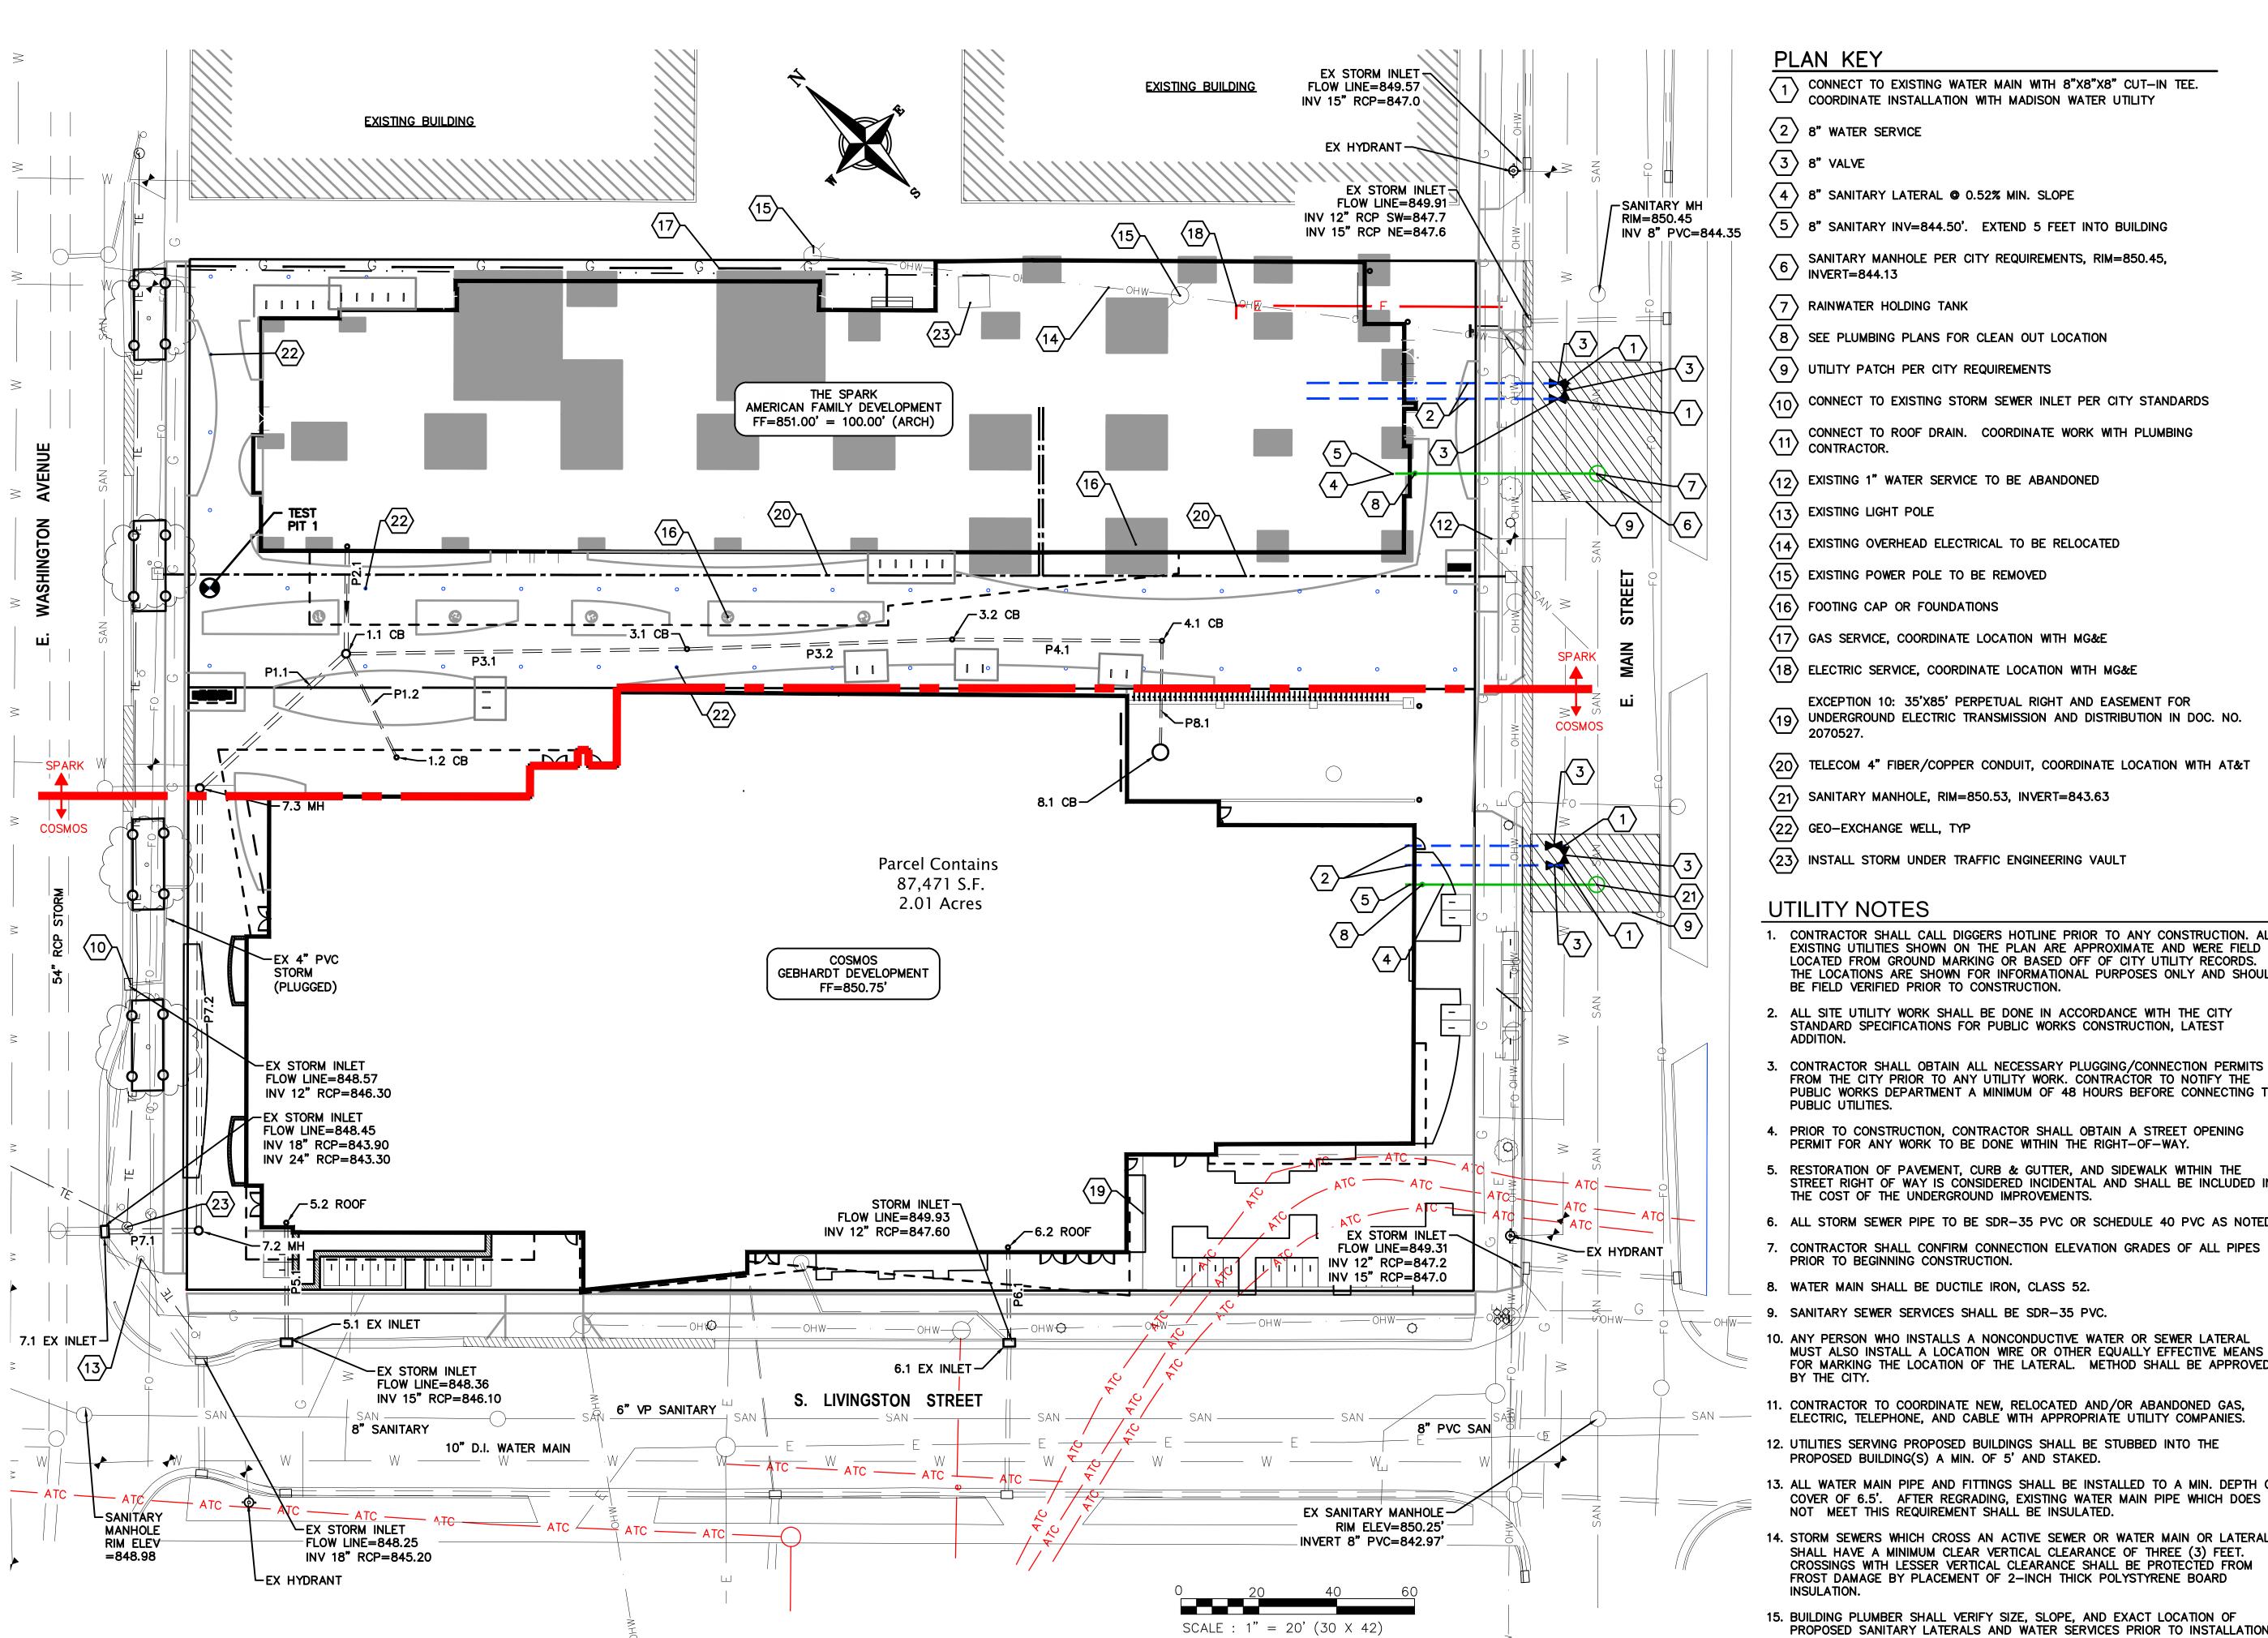UTILITY NOTES

- CONTRACTOR SHALL CALL DIGGERS HOTLINE PRIOR TO ANY CONSTRUCTION. ALL EXISTING UTILITIES SHOWN ON THE PLAN ARE APPROXIMATE AND WERE FIELD LOCATED FROM GROUND MARKING OR BASED OFF OF CITY UTILITY RECORDS. THE LOCATIONS ARE SHOWN FOR INFORMATIONAL PURPOSES ONLY AND SHOULD BE FIELD VERIFIED PRIOR TO CONSTRUCTION.
- 2. ALL SITE UTILITY WORK SHALL BE DONE IN ACCORDANCE WITH THE CITY STANDARD SPECIFICATIONS FOR PUBLIC WORKS CONSTRUCTION, LATEST
- 3. CONTRACTOR SHALL OBTAIN ALL NECESSARY PLUGGING/CONNECTION PERMITS FROM THE CITY PRIOR TO ANY UTILITY WORK. CONTRACTOR TO NOTIFY THE PUBLIC WORKS DEPARTMENT A MINIMUM OF 48 HOURS BEFORE CONNECTING TO PUBLIC UTILITIES.
- 4. PRIOR TO CONSTRUCTION, CONTRACTOR SHALL OBTAIN A STREET OPENING PERMIT FOR ANY WORK TO BE DONE WITHIN THE RIGHT-OF-WAY.
- 5. RESTORATION OF PAVEMENT, CURB & GUTTER, AND SIDEWALK WITHIN THE STREET RIGHT OF WAY IS CONSIDERED INCIDENTAL AND SHALL BE INCLUDED IN THE COST OF THE UNDERGROUND IMPROVEMENTS.
- 6. ALL STORM SEWER PIPE TO BE SDR-35 PVC OR SCHEDULE 40 PVC AS NOTED.
- 7. CONTRACTOR SHALL CONFIRM CONNECTION ELEVATION GRADES OF ALL PIPES PRIOR TO BEGINNING CONSTRUCTION.
- 8. WATER MAIN SHALL BE DUCTILE IRON, CLASS 52.
- 9. SANITARY SEWER SERVICES SHALL BE SDR-35 PVC.
- 10. ANY PERSON WHO INSTALLS A NONCONDUCTIVE WATER OR SEWER LATERAL MUST ALSO INSTALL A LOCATION WIRE OR OTHER EQUALLY EFFECTIVE MEANS FOR MARKING THE LOCATION OF THE LATERAL. METHOD SHALL BE APPROVED BY THE CITY.
- 11. CONTRACTOR TO COORDINATE NEW, RELOCATED AND/OR ABANDONED GAS, ELECTRIC, TELEPHONE, AND CABLE WITH APPROPRIATE UTILITY COMPANIES.
- 12. UTILITIES SERVING PROPOSED BUILDINGS SHALL BE STUBBED INTO THE
- PROPOSED BUILDING(S) A MIN. OF 5' AND STAKED. 13. ALL WATER MAIN PIPE AND FITTINGS SHALL BE INSTALLED TO A MIN. DEPTH OF
- NOT MEET THIS REQUIREMENT SHALL BE INSULATED. 14. STORM SEWERS WHICH CROSS AN ACTIVE SEWER OR WATER MAIN OR LATERAL
- SHALL HAVE A MINIMUM CLEAR VERTICAL CLEARANCE OF THREE (3) FEET. CROSSINGS WITH LESSER VERTICAL CLEARANCE SHALL BE PROTECTED FROM FROST DAMAGE BY PLACEMENT OF 2-INCH THICK POLYSTYRENE BOARD INSULATION.
- 15. BUILDING PLUMBER SHALL VERIFY SIZE, SLOPE, AND EXACT LOCATION OF PROPOSED SANITARY LATERALS AND WATER SERVICES PRIOR TO INSTALLATION.

UTILITY PLAN

euic

eppstein uhen : architects

milwaukee 3 3 3 East Chicago Street
Milwaukee, Wisconsin 53202

Milwaukee, Wisconsin 53202 telephone 414.271.5350

madison
309 West Johnson Street, Suite 202 Madison, Wisconsin 53703 telephone 608.442.5350

STRANG

6411 Mineral Point Road Madison, WI 53705 (608) 276 - 9200



PROFESSIONAL ENGINEERING

818 N Meadowbrook Ln Waunakee, WI 53597 (608) 849-9378

PROJECT INFORMATION

COSMOS -THE SPARK PROJECTS

800 E WASHINGTON AVE MADISON, WI





ISSUANCE AND REVISIONS

UDC Submittal (Revised)

DATE DESCRIPTION

SHEET INFORMATION

PROGRESS DOCUMENTS
NOT FOR CONSTRUCTION

These documents reflect progress and intent and may

These documents reflect progress and intent and may be subject to change, including additional detail. These are not final construction documents and should not be used for final bidding or construction-related purposes.

PROJECT MANAGER RJ
PROJECT NUMBER 1249
DATE 12-21-16

SCHEDULES

C500

			STRU	CTURE TABLE		
	STRUCTURE NAME	SIZE	TOP OF CASTING	PIPES IN	PIPES OUT	CASTING
	1.1 CB	4' DIA. CB	850.48	P3.1, 8" INV IN =845.46 P2.1, 12" INV IN =844.88 P1.2, 6" INV IN =845.63	P1.1, 15" INV OUT =844.88	NEENAH R-2050
	1.2 CB	12" DIA YARD DRAIN	850.57		P1.2, 6" INV OUT =845.92	12" GRATE
	2.1 ROOF	CONNECT TO INTERIOR ROOF DRAIN	851.00		P2.1, 12" INV OUT =845.03	
	3.1 CB	12" DIA YARD DRAIN	850.26	P3.2, 8" INV IN =845.92	P3.1, 8" INV OUT =845.92	12" GRATE
	3.2 CB	12" DIA YARD DRAIN	850.26	P4.1, 8" INV IN =846.27	P3.2, 8" INV OUT =846.27	12" GRATE
PARK	4.1 CB	12" DIA YARD DRAIN	850.44	P8.1, 6" INV IN =846.55	P4.1, 8" INV OUT =846.55	12" GRATE
SMOS	5.1 EX INLET	CONNECT TO EX INLET	847.38	P5.1, 10" INV IN =846.50		
	5.2 ROOF	CONNECT TO INTERIOR ROOF DRAIN	850.75		P5.1, 10" INV OUT =846.80	
	6.1 EX INLET	CONNECT TO EX INLET	848.58	P6.1, 10" INV IN =847.70		
	6.2 ROOF	CONNECT TO INTERIOR ROOF DRAIN	850.75		P6.1, 10" INV OUT =847.82	
	7.1 EX INLET	CONNECT TO EX INLET	849.16	P7.1, 15" INV IN =843.90		
	7.2 MH	4' DIA. CB	849.87	P7.2, 15" INV IN =844.03	P7.1, 15" INV OUT =844.03	NEENAH R-1550
	7.3 MH	4' DIA. CB	850.28	P1.1, 15" INV IN =844.62	P7.2, 15" INV OUT =844.62	NEENAH R-1550
	8.1 CB	3' DIA. CB	849.88		P8.1, 6" INV OUT =846.84	NEENAH R-2050

NAME SIZE

P1.1 15"

P1.2 6"

P2.1 12"

P3.1 8"

P3.2 8"

P4.1 8"

P5.1 10"

P6.1 10"

P7.1 15"

P7.2 15"

P8.1 6"

PIPE TABLE

ADS N12

0.52% ADS N12

LENGTH | SLOPE | MATERIAL

0.53%

0.52%

0.50%

0.52%

0.52%

1.00%

54' 0.52% ADS N12

31' 0.98% ADS N12

52' 0.52%

30' 0.98%

28'

88'

69'

25'

25'

114'

29'

START INVERT END INVERT

ELEVATION

844.62'

845.63

844.88'

845.46'

845.92'

846.27

846.50'

847.70'

843.90'

844.03'

846.55'

COSMOS

ELEVATION

844.88'

845.92'

845.03'

845.92'

846.27

846.55

846.80'

847.82'

844.03'


844.62'

846.84'

В

Α

2

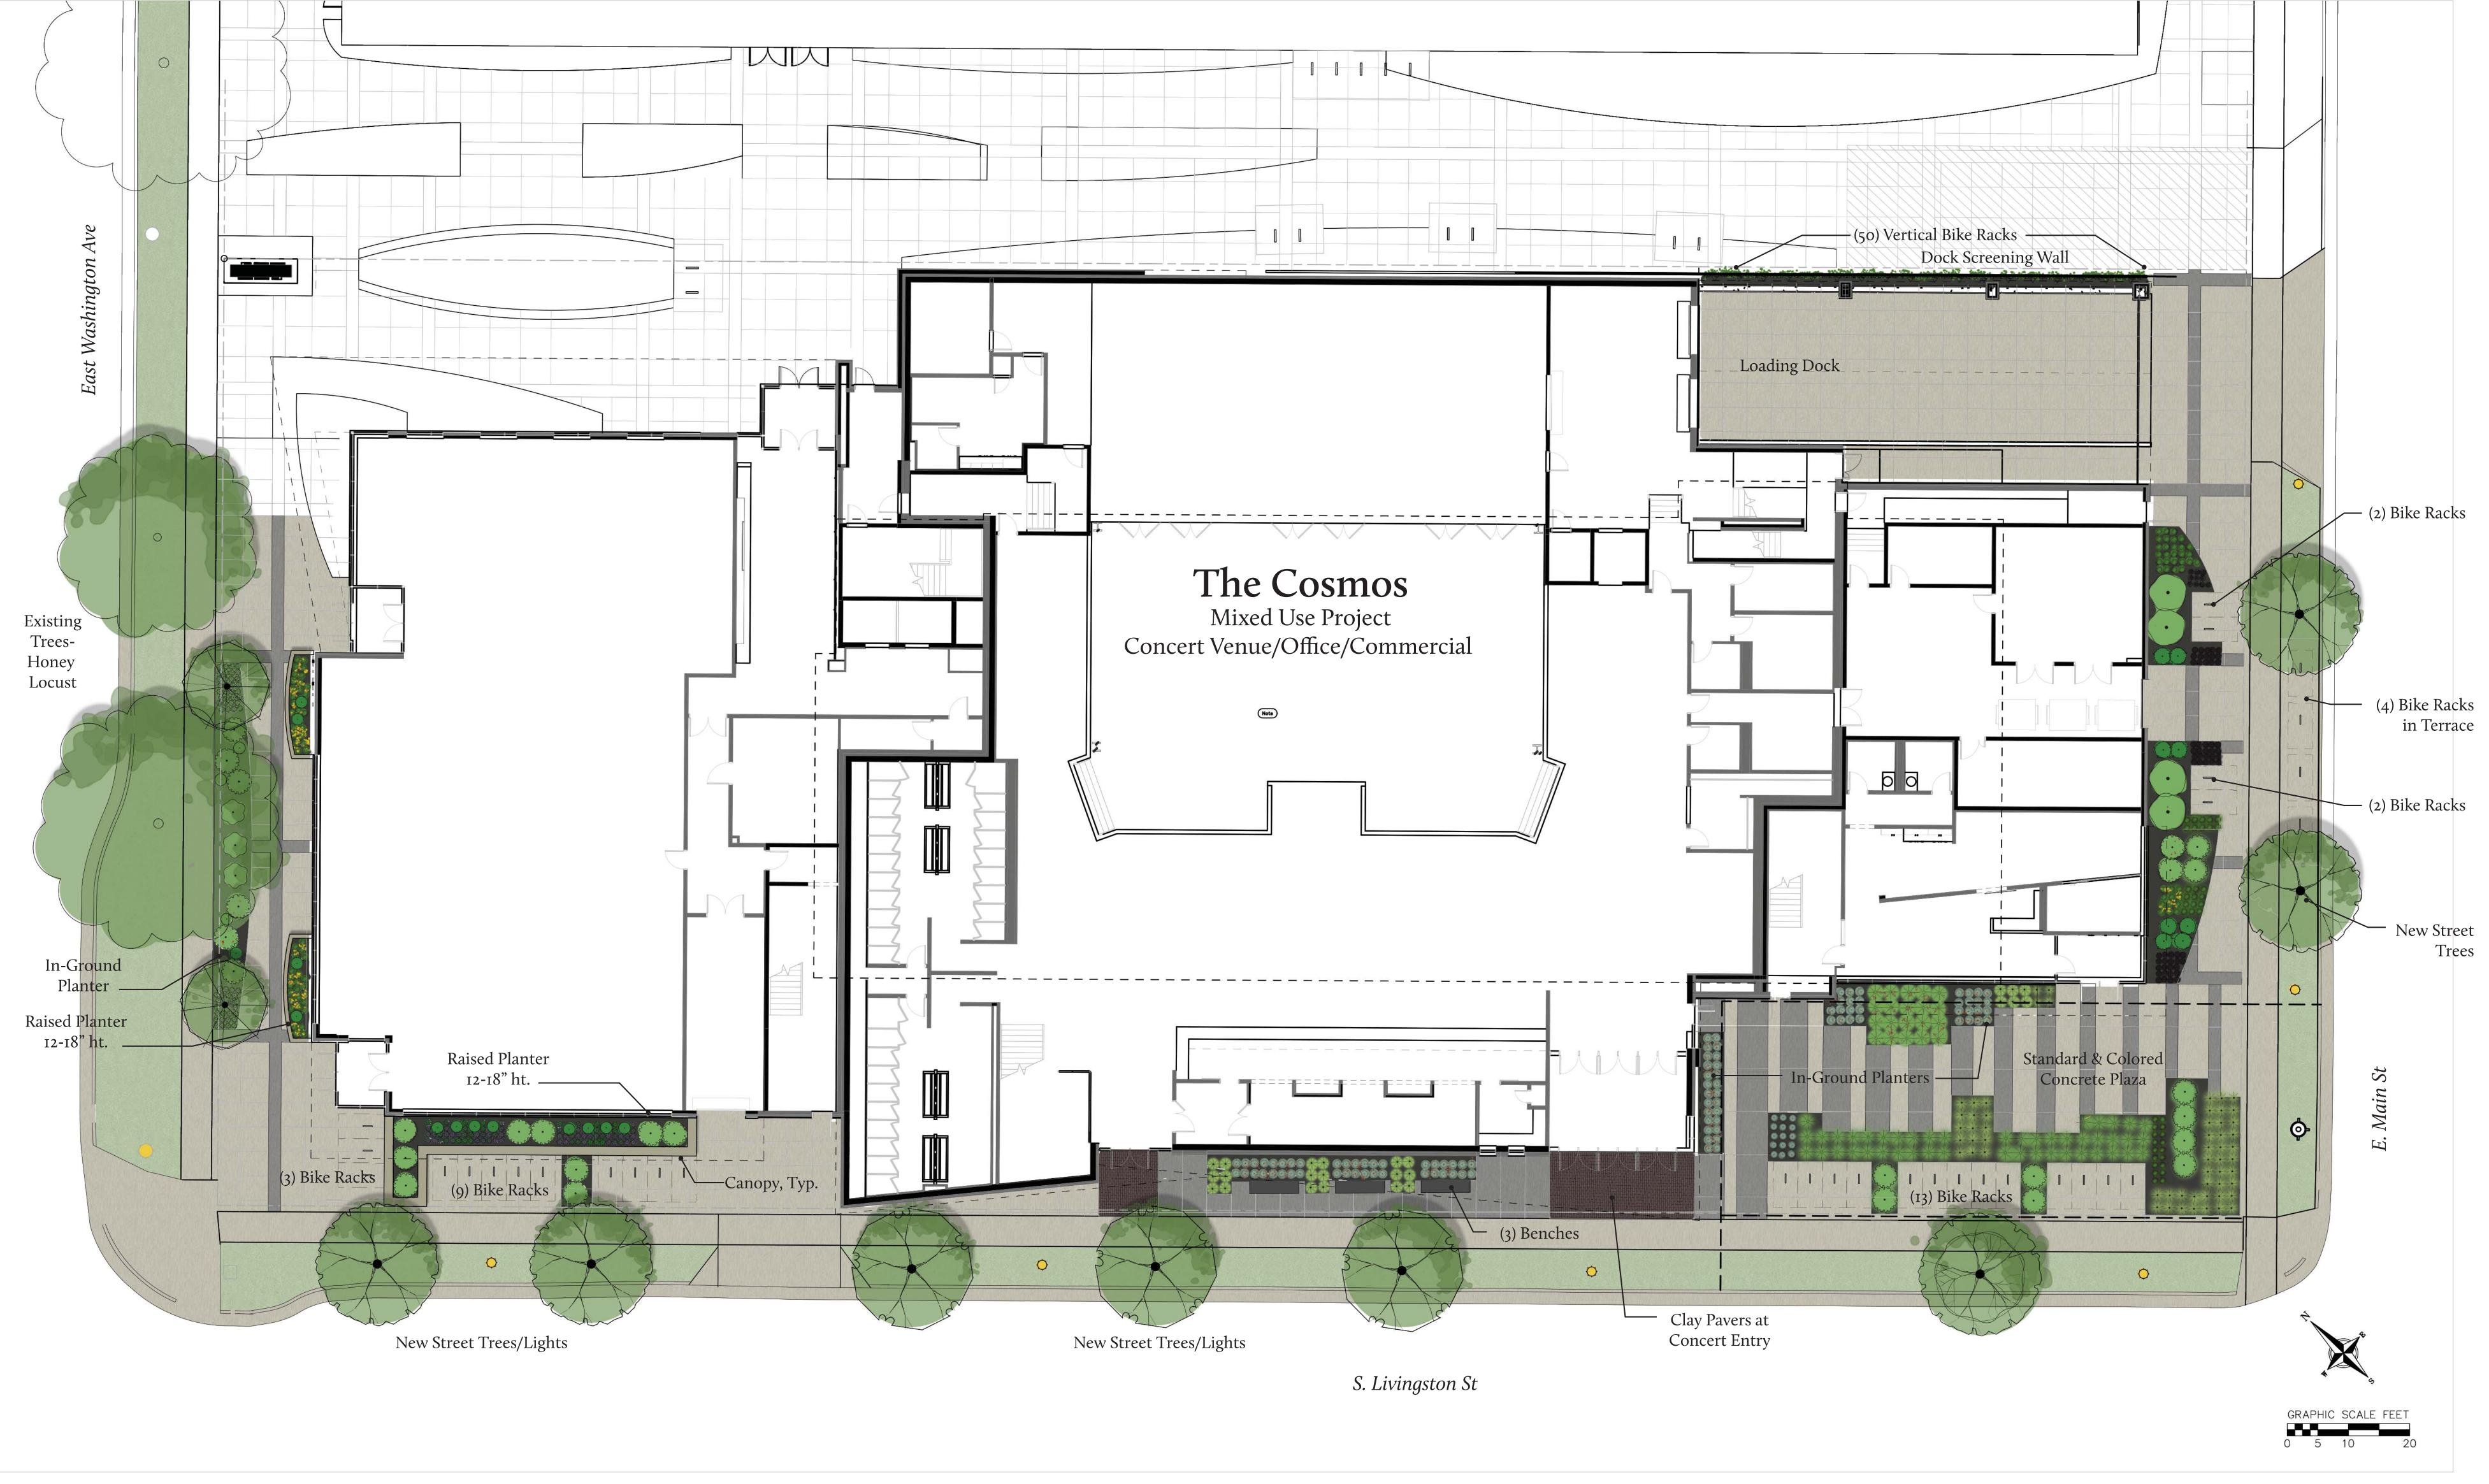

SITE PLAN Urban Design Commission 12.21.2016













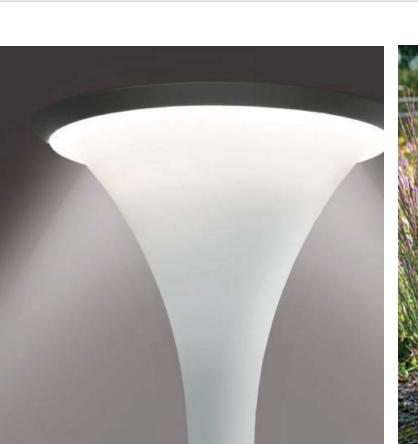







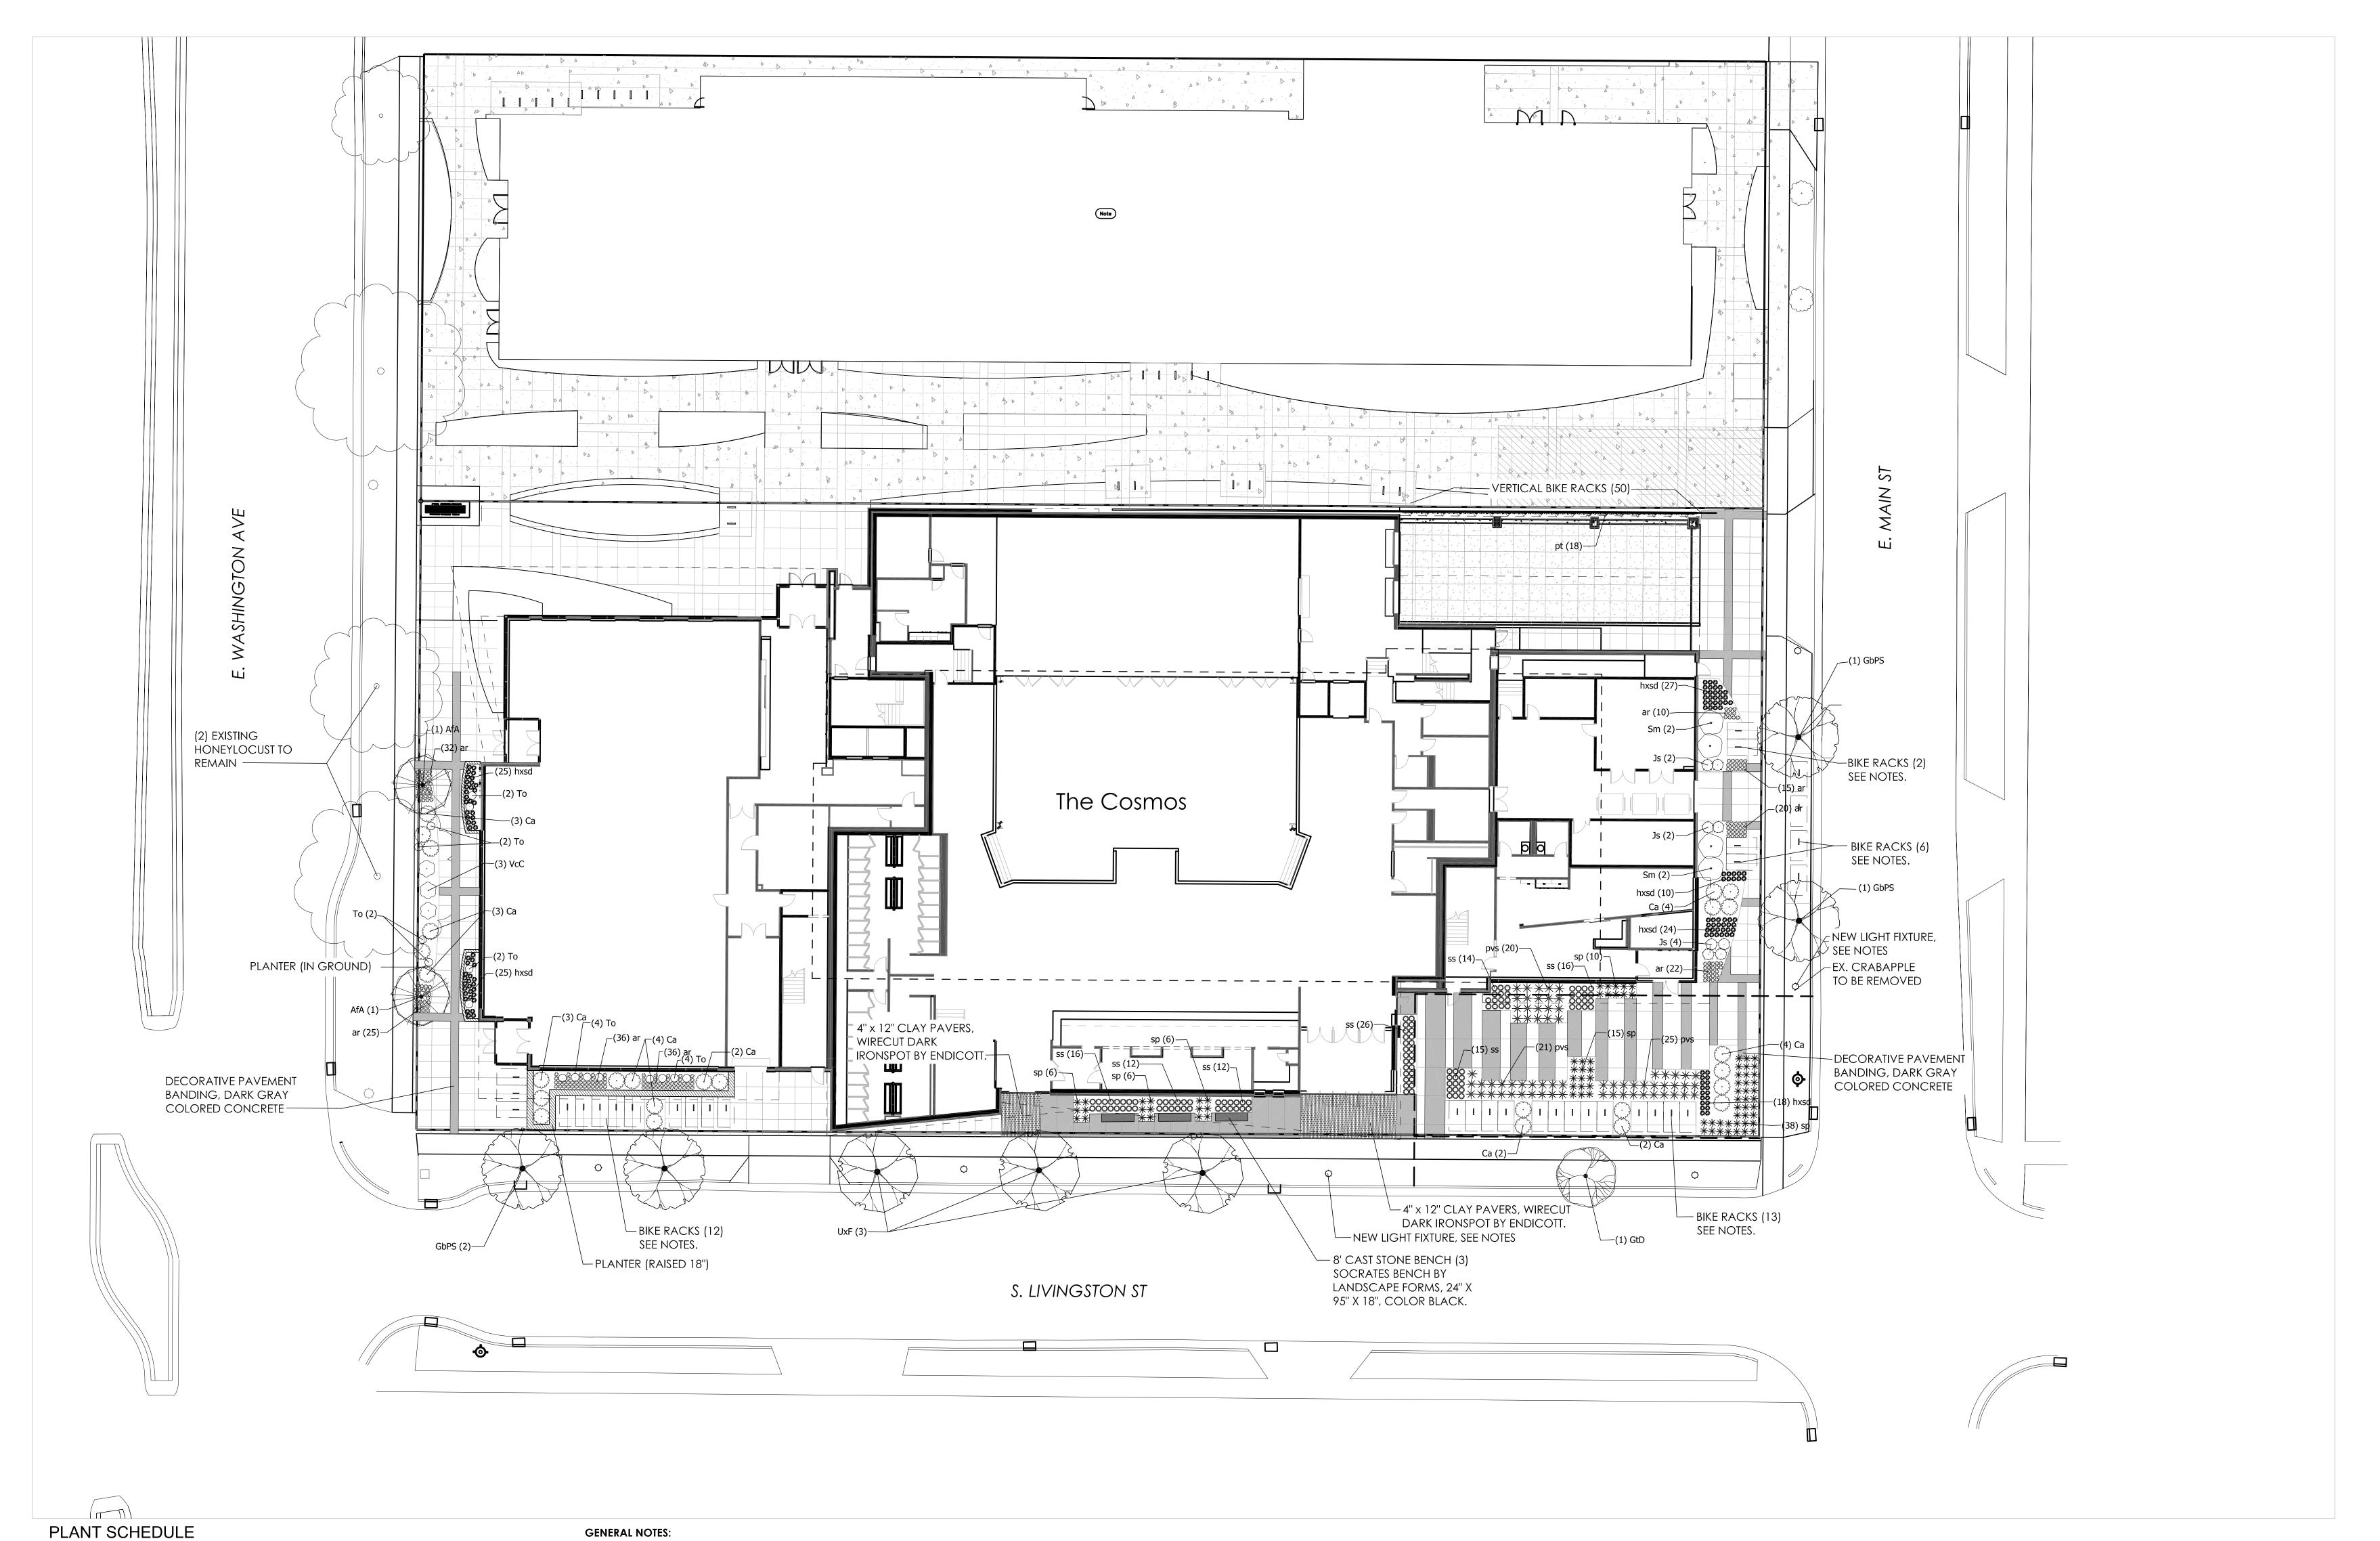

1. FINAL STREET TREE SPECIES SELECTION AND PLACEMENT TO BE DETERMINED IN

3. NEW STREET LIGHTING TO MATCH ESTABLISHED CITY DESIGN. FINAL LIGHT

QUANTITIES AND PLACEMENT TO BE DETERMINED BY CITY PUBLIC WORKS STAFF.

4. SITE PAVING TO BE STANDARD COLOR, BROOM FINISHED CONCRETE UNLESS

5. ALL GROUND MOUNTED BIKE RACKS TO BE POST AND RING RACK (PAR) BY

MADRAX/GRABER MANUFACTURING, IN GROUND MOUNT, WITHOUT BALL CAP,

GALVANIZED FINISH. INSTALL PER CITY OF MADISON RACK SPACING GUIDELINES

(AS SHOWN ON PLAN). VERTICAL BIKE RACKS TO BE SPORTWORKS VERTICAL WALL

2. UNPAVED STREET TERRACES TO BE SODDED WITH TURF SOD.

COORDINATION WITH CITY FORESTER.

OTHERWISE SPECIFIED.

MOUNT RACK OR SIMILAR.

BOTANICAL NAME / COMMON NAME

Acer x freemanii `Armstrong` / Armstrong Freeman Maple

Ginkgo biloba `Princeton Sentry` / Princeton Sentry Ginkgo

Gleditsia triacanthos `Draves` / Street Keeper Honey Locust

Ajuga reptans `Bronze Beauty` / Bronze Beauty Bugleweed

Panicum virgatum `Shenandoah` / Shenandoah Red Switch Grass 1 gal

Hemerocallis x `Stella de Oro` / Stella de Oro Daylily

Schizachyrium scoparium / Little Bluestem Grass

Cotoneaster apiculatus / Cranberry Cotoneaster Syringa meyeri `Palibin` / Dwarf Korean Lilac

Viburnum carlesii `Compactum` / Korean Spice Viburnum

Juniperus sabina `Blue Forest` / Blue Forest Juniper Thuja occidentalis `Danica` TM / Danica Globe Cedar

Ulmus x `Frontier` / American Elm

Parthenocissus tricuspidata / Boston Ivy

Sporobolus heterolepis / Prairie Dropseed

BOTANICAL NAME / COMMON NAME

BOTANICAL NAME / COMMON NAME

ANNUALS/PERENNIALS BOTANICAL NAME / COMMON NAME

<u>CONT</u> <u>CAL</u> B & B 2.5"Cal

B & B 2.5"Cal

B & B 2.5"Cal

SIZE FIELD2 4" pot

4" pot

1 gal

4" pot

5 gal

3 gal

SIZE 3 gal

B & B 2.5"Cal 4

129

18

111





ARCHITECTURE ENGINEERING INTERIOR DESIGN

STRANG, INC. 6411 MINERAL POINT ROAD MADISON, WI 53705-4395

UDC Submittal (Revised)

NOT FOR CONSTRUCTION

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CHECKED	RG
DATE	12-21-2016
PROJECT NO.	2016090
PROJECT TITLE	


GEBHARDT DEVELOPMENT -THE COSMOS PROJECT

801 E. WASHINGTON AVENUE MADISON, WISCONSIN 53703


SHEET NAME

LANDSCAPE PLAN

GRAPHIC SCALE FEET 0 4 8

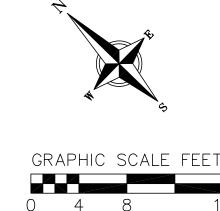


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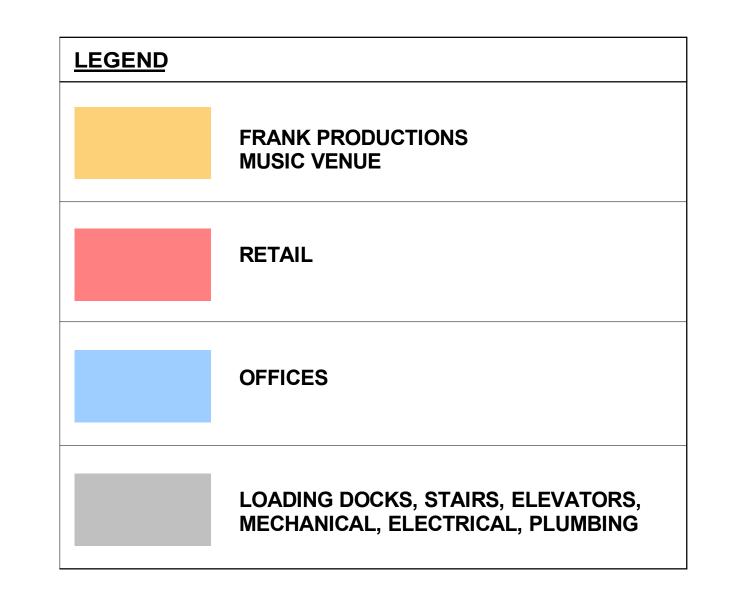


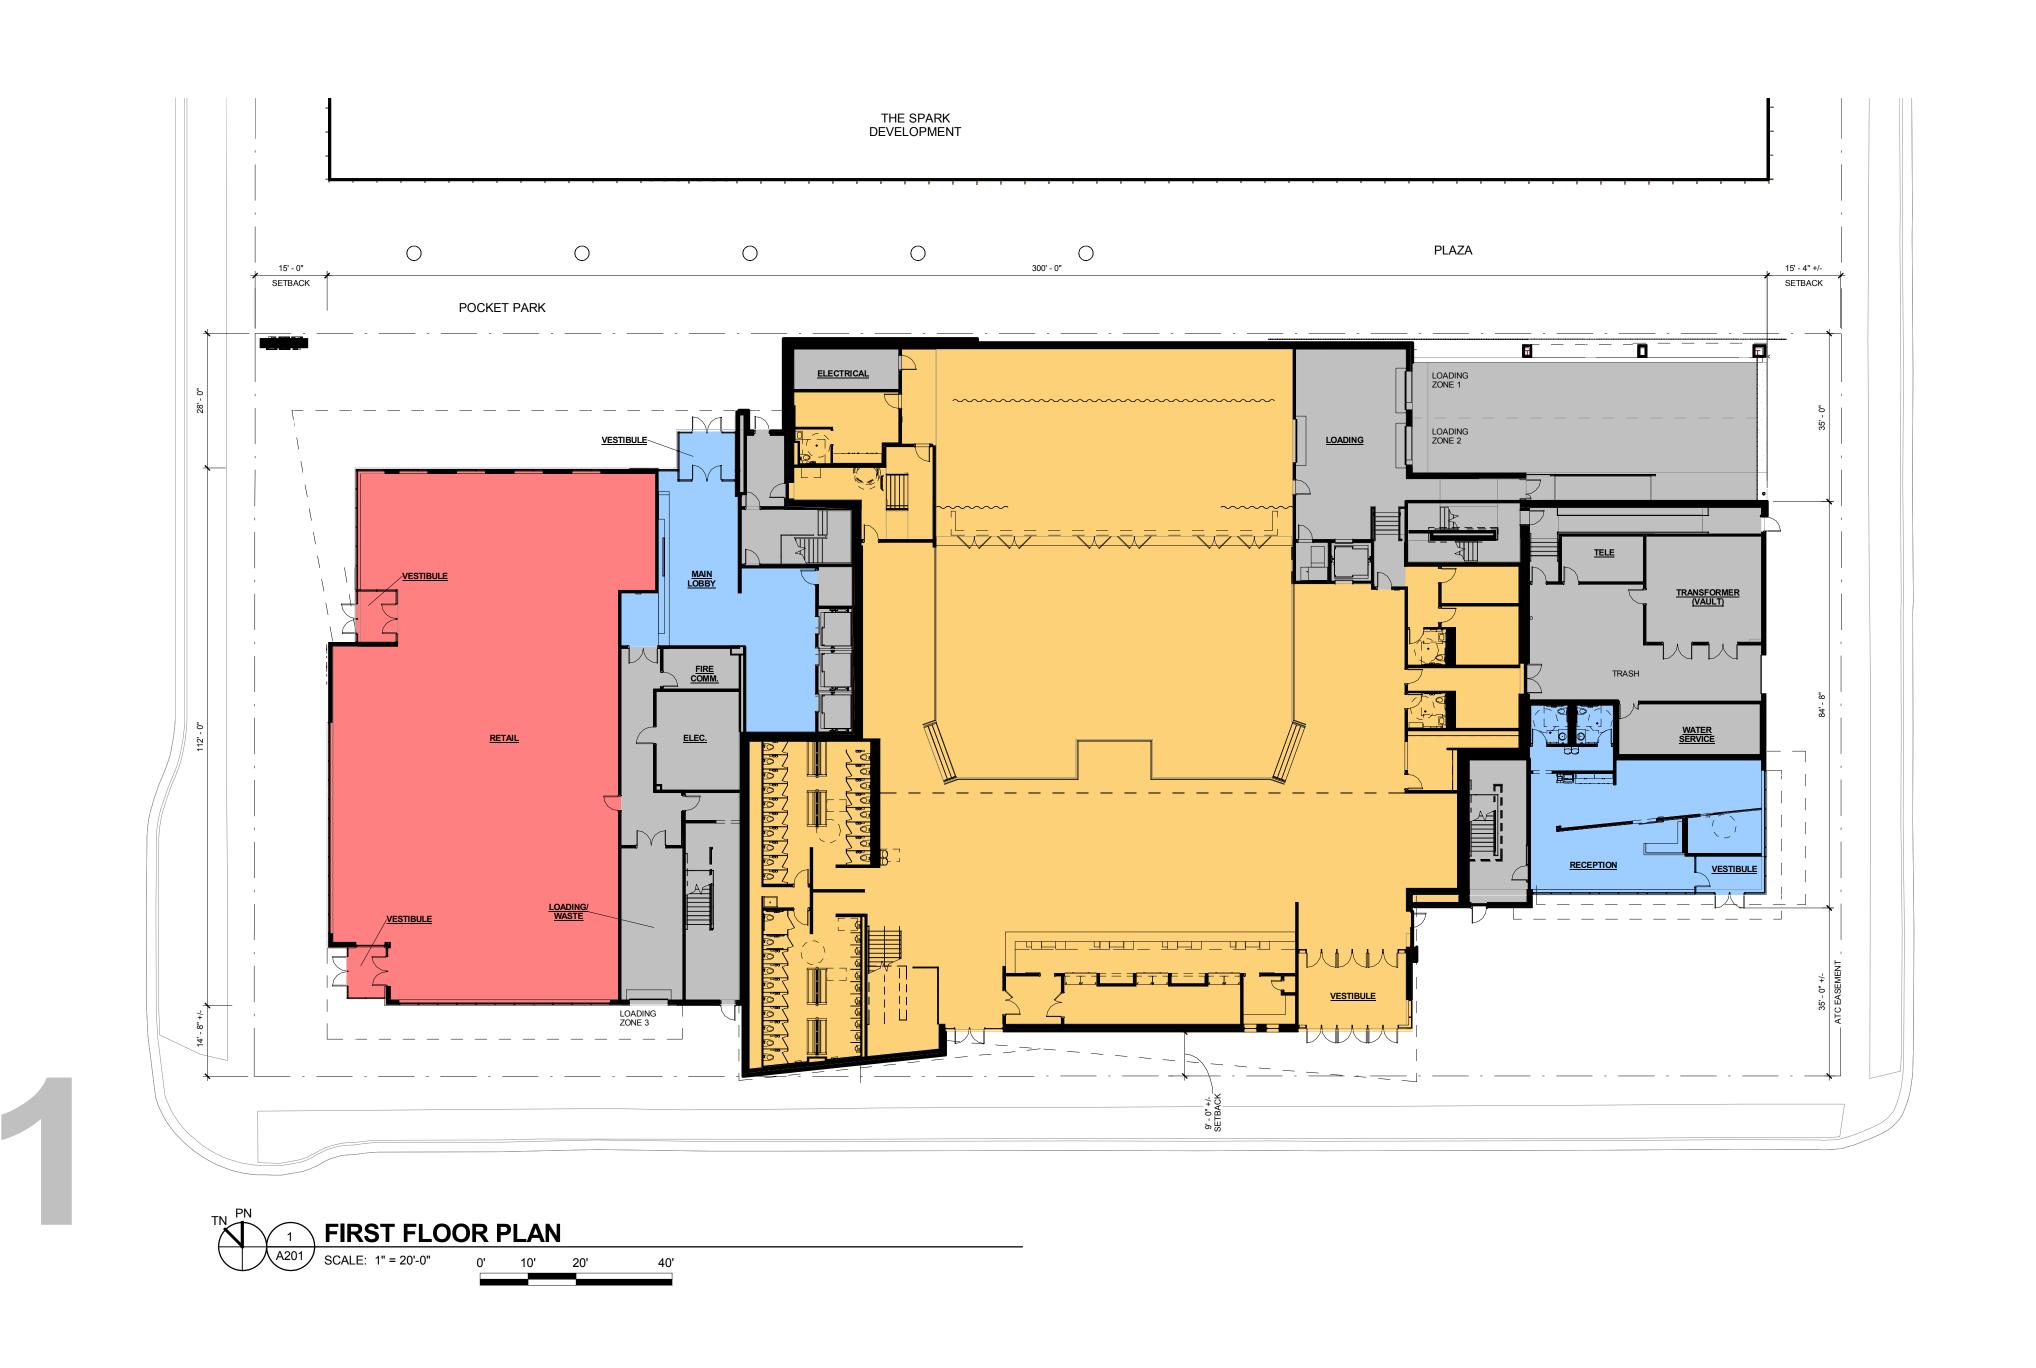

ARCHITECTURE ENGINEERING INTERIOR DESIGN

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DESIGN DEVELOPMENT

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PROJECT TITLE

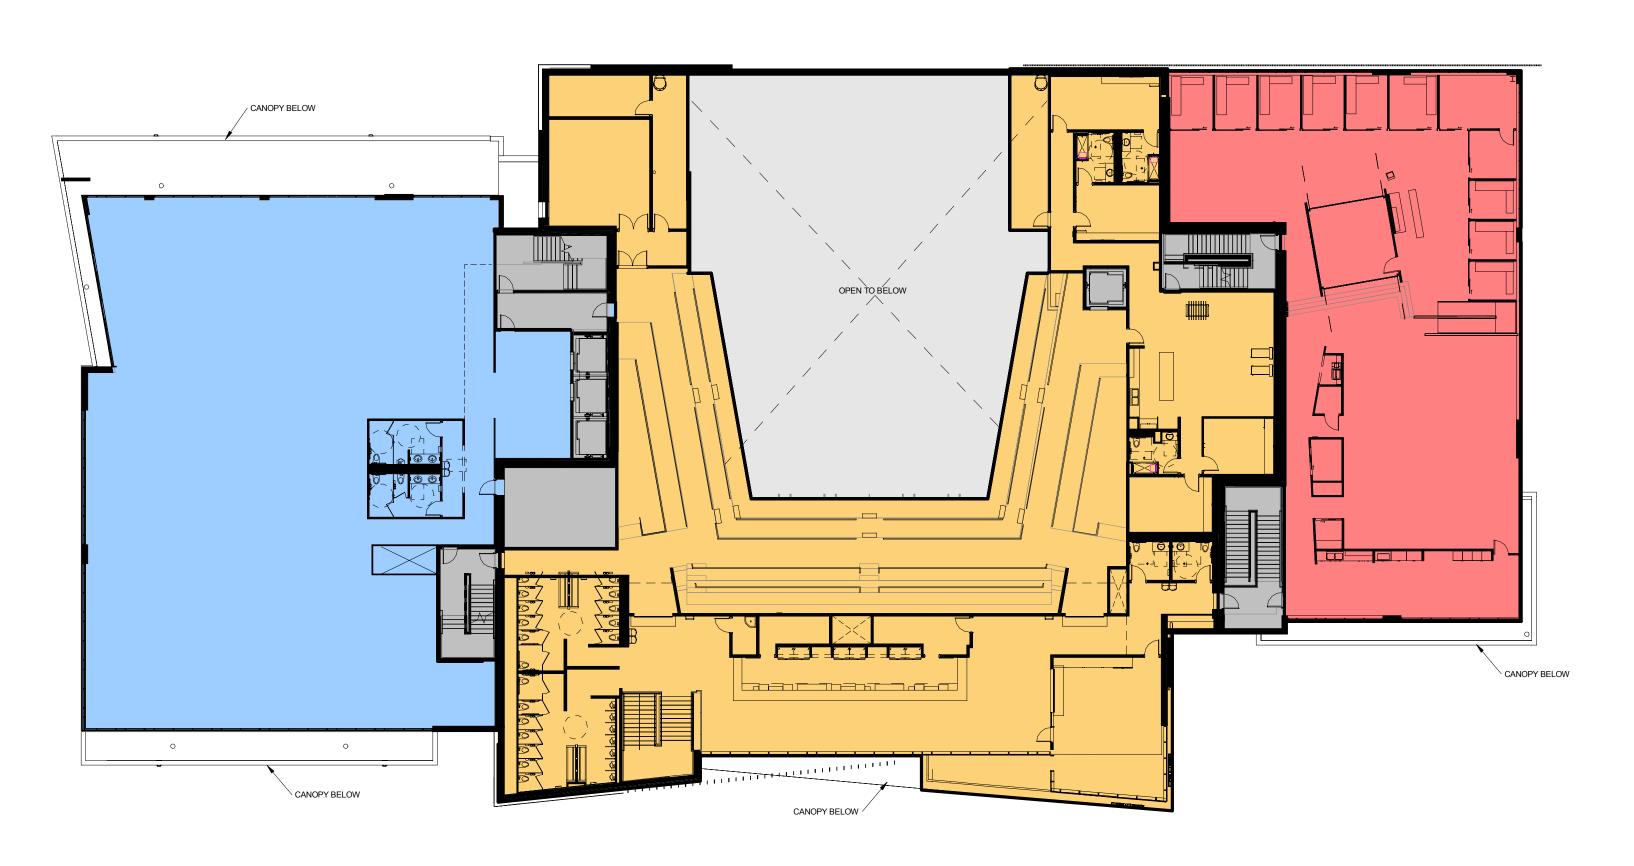GEBHARDT DEVELOPMENT -THE COSMOS PROJECT

801 E. WASHINGTON AVENUE MADISON, WISCONSIN 53703

SHEET NAME FLOOR PLANS

SHEET NO.





ARCHITECTURE ENGINEERING INTERIOR DESIGN

STRANG, INC. 6411 MINERAL POINT ROAD MADISON, WI 53705-4395

OFFICE OF THE STATE OF THE STAT

3

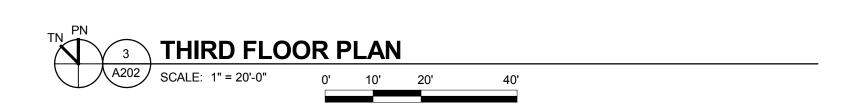

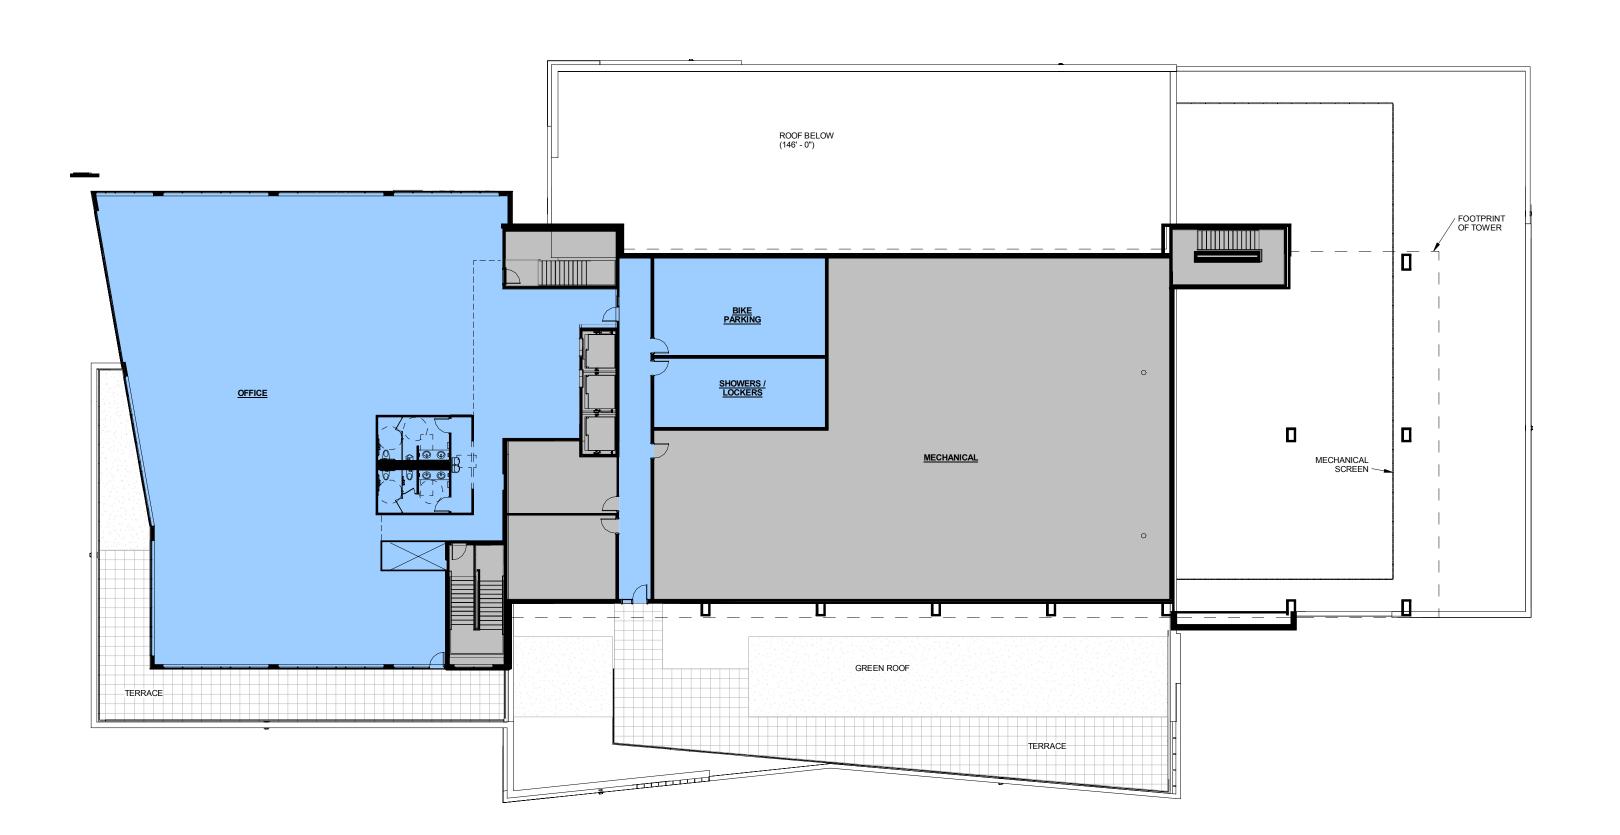

FRANK PRODUCTIONS
MUSIC VENUE

RETAIL

OFFICES

LOADING DOCKS, STAIRS, ELEVATORS,
MECHANICAL, ELECTRICAL, PLUMBING

DESIGN DEVELOPMENT

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DRAWING SET CD

DRAWN JZ

CHECKED RG

DATE 12-21-2016

PROJECT NO. 2016090

PROJECT TITLE

GEBHARDT DEVELOPMENT -THE COSMOS PROJECT

801 E. WASHINGTON AVENUE MADISON, WISCONSIN 53703

SHEET NAME
FLOOR PLANS

SHEET NO.


^ ^ ^


FOURTH FLOOR PLAN


A202 SCALE: 1" = 20'-0" 0' 10' 20' 4



STRANG, INC. 6411 MINERAL POINT ROAD MADISON, WI 53705-4395

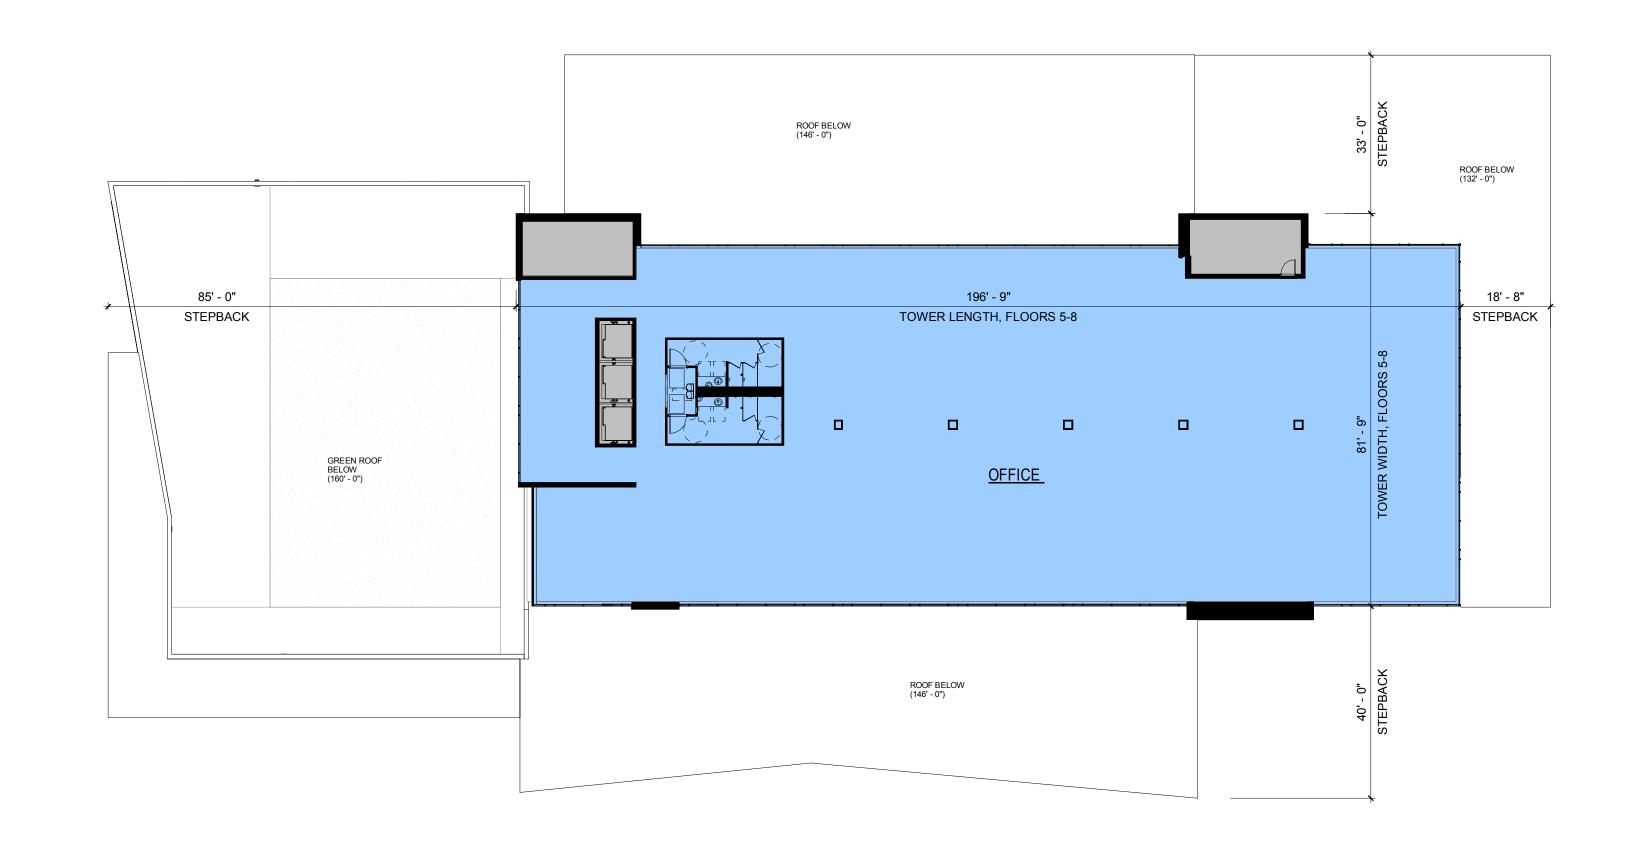

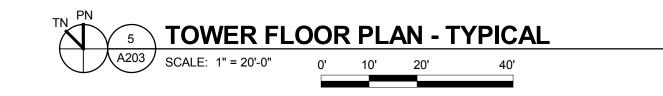

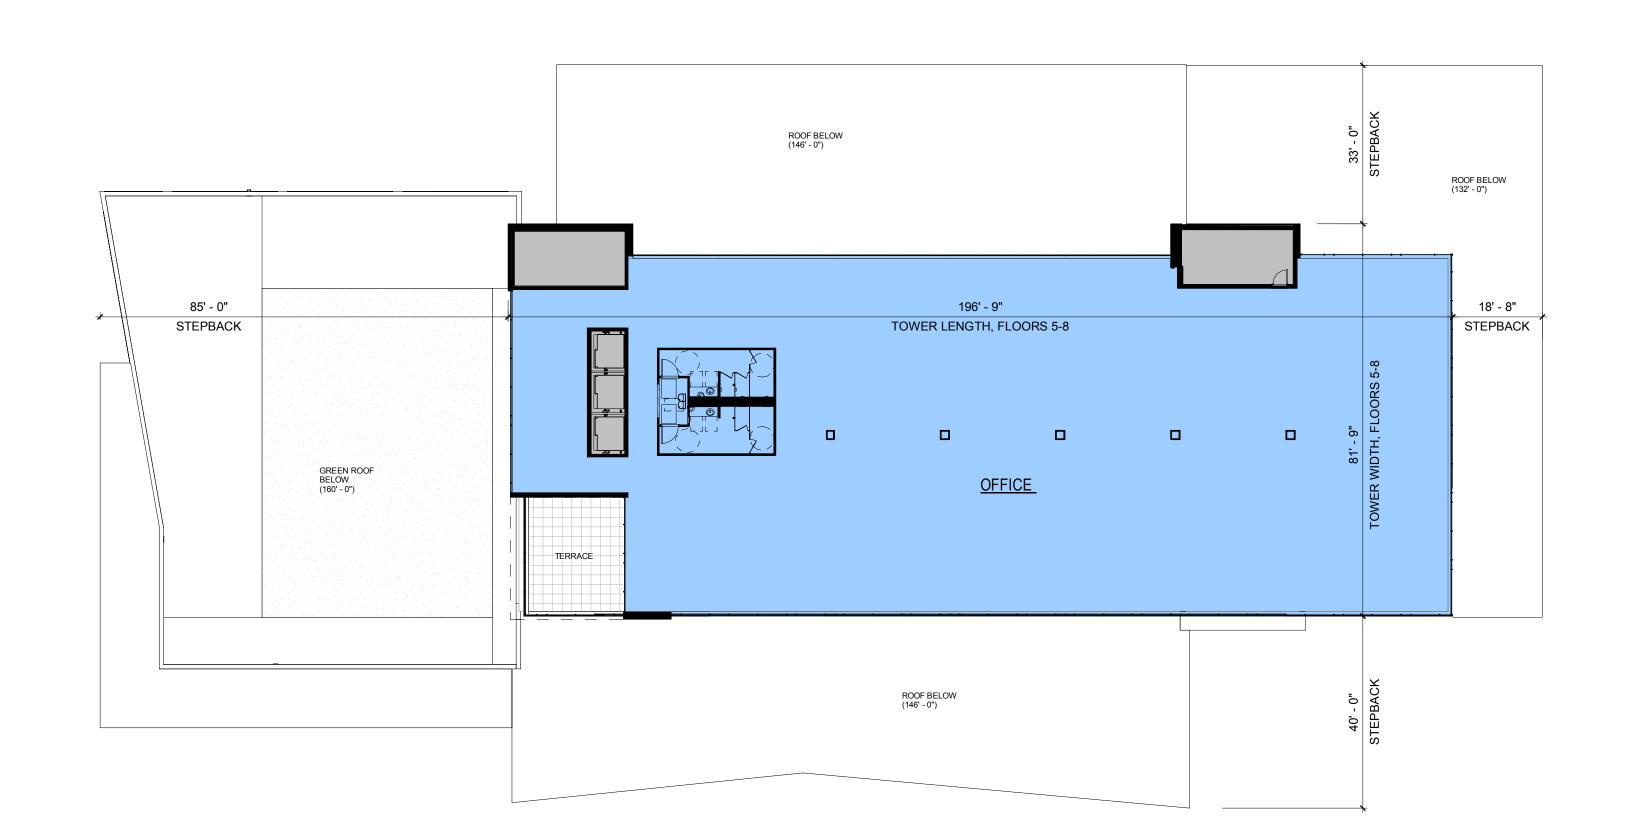

<u>LEGEND</u> FRANK PRODUCTIONS MUSIC VENUE **RETAIL OFFICES** LOADING DOCKS, STAIRS, ELEVATORS, MECHANICAL, ELECTRICAL, PLUMBING

DESIGN DEVELOPMENT NOT FOR

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CONSTRUCTION

GEBHARDT DEVELOPMENT -THE COSMOS PROJECT

801 E. WASHINGTON AVENUE MADISON, WISCONSIN 53703

SHEET NAME FLOOR PLANS

SHEET NO.

TN PN 6 TOWER FLOOR PLAN - 8

A203 SCALE: 1" = 20'-0" 0' 10' 20' 40'







VIEW FROM N. LIVINGSTON / E. WASHINGTON AVE. (LOOKING SOUTH)



STRANG

ARCHITECTURE ENGINEERING INTERIOR DESIGN

STRANG, INC. 6411 MINERAL POINT ROAD MADISON, WI 53705-4395

DATE 12-21-2016
PROJECT NO. 2016090

PROJECT TITLE

GEBHARDT DEVELOPMENT -THE COSMOS PROJECT

MADISON, WISCONSIN 53703

SHEET NAME


EXTERIOR

VIEWS



VIEW FROM S. LIVINGSTON (LOOKING NORTH)



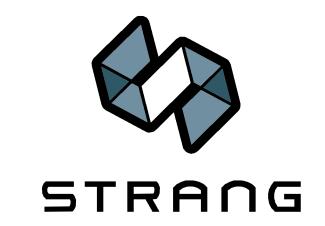

ARCHITECTURE ENGINEERING INTERIOR DESIGN

STRANG, INC. 6411 MINERAL POINT ROAD MADISON, WI 53705-4395

DATE 12-21-2016
PROJECT NO. 2016090
PROJECT TITLE


GEBHARDT DEVELOPMENT -THE COSMOS PROJECT


MADISON, WISCONSIN 5370

SHEET NAME

EXTERIOR

VIEWS

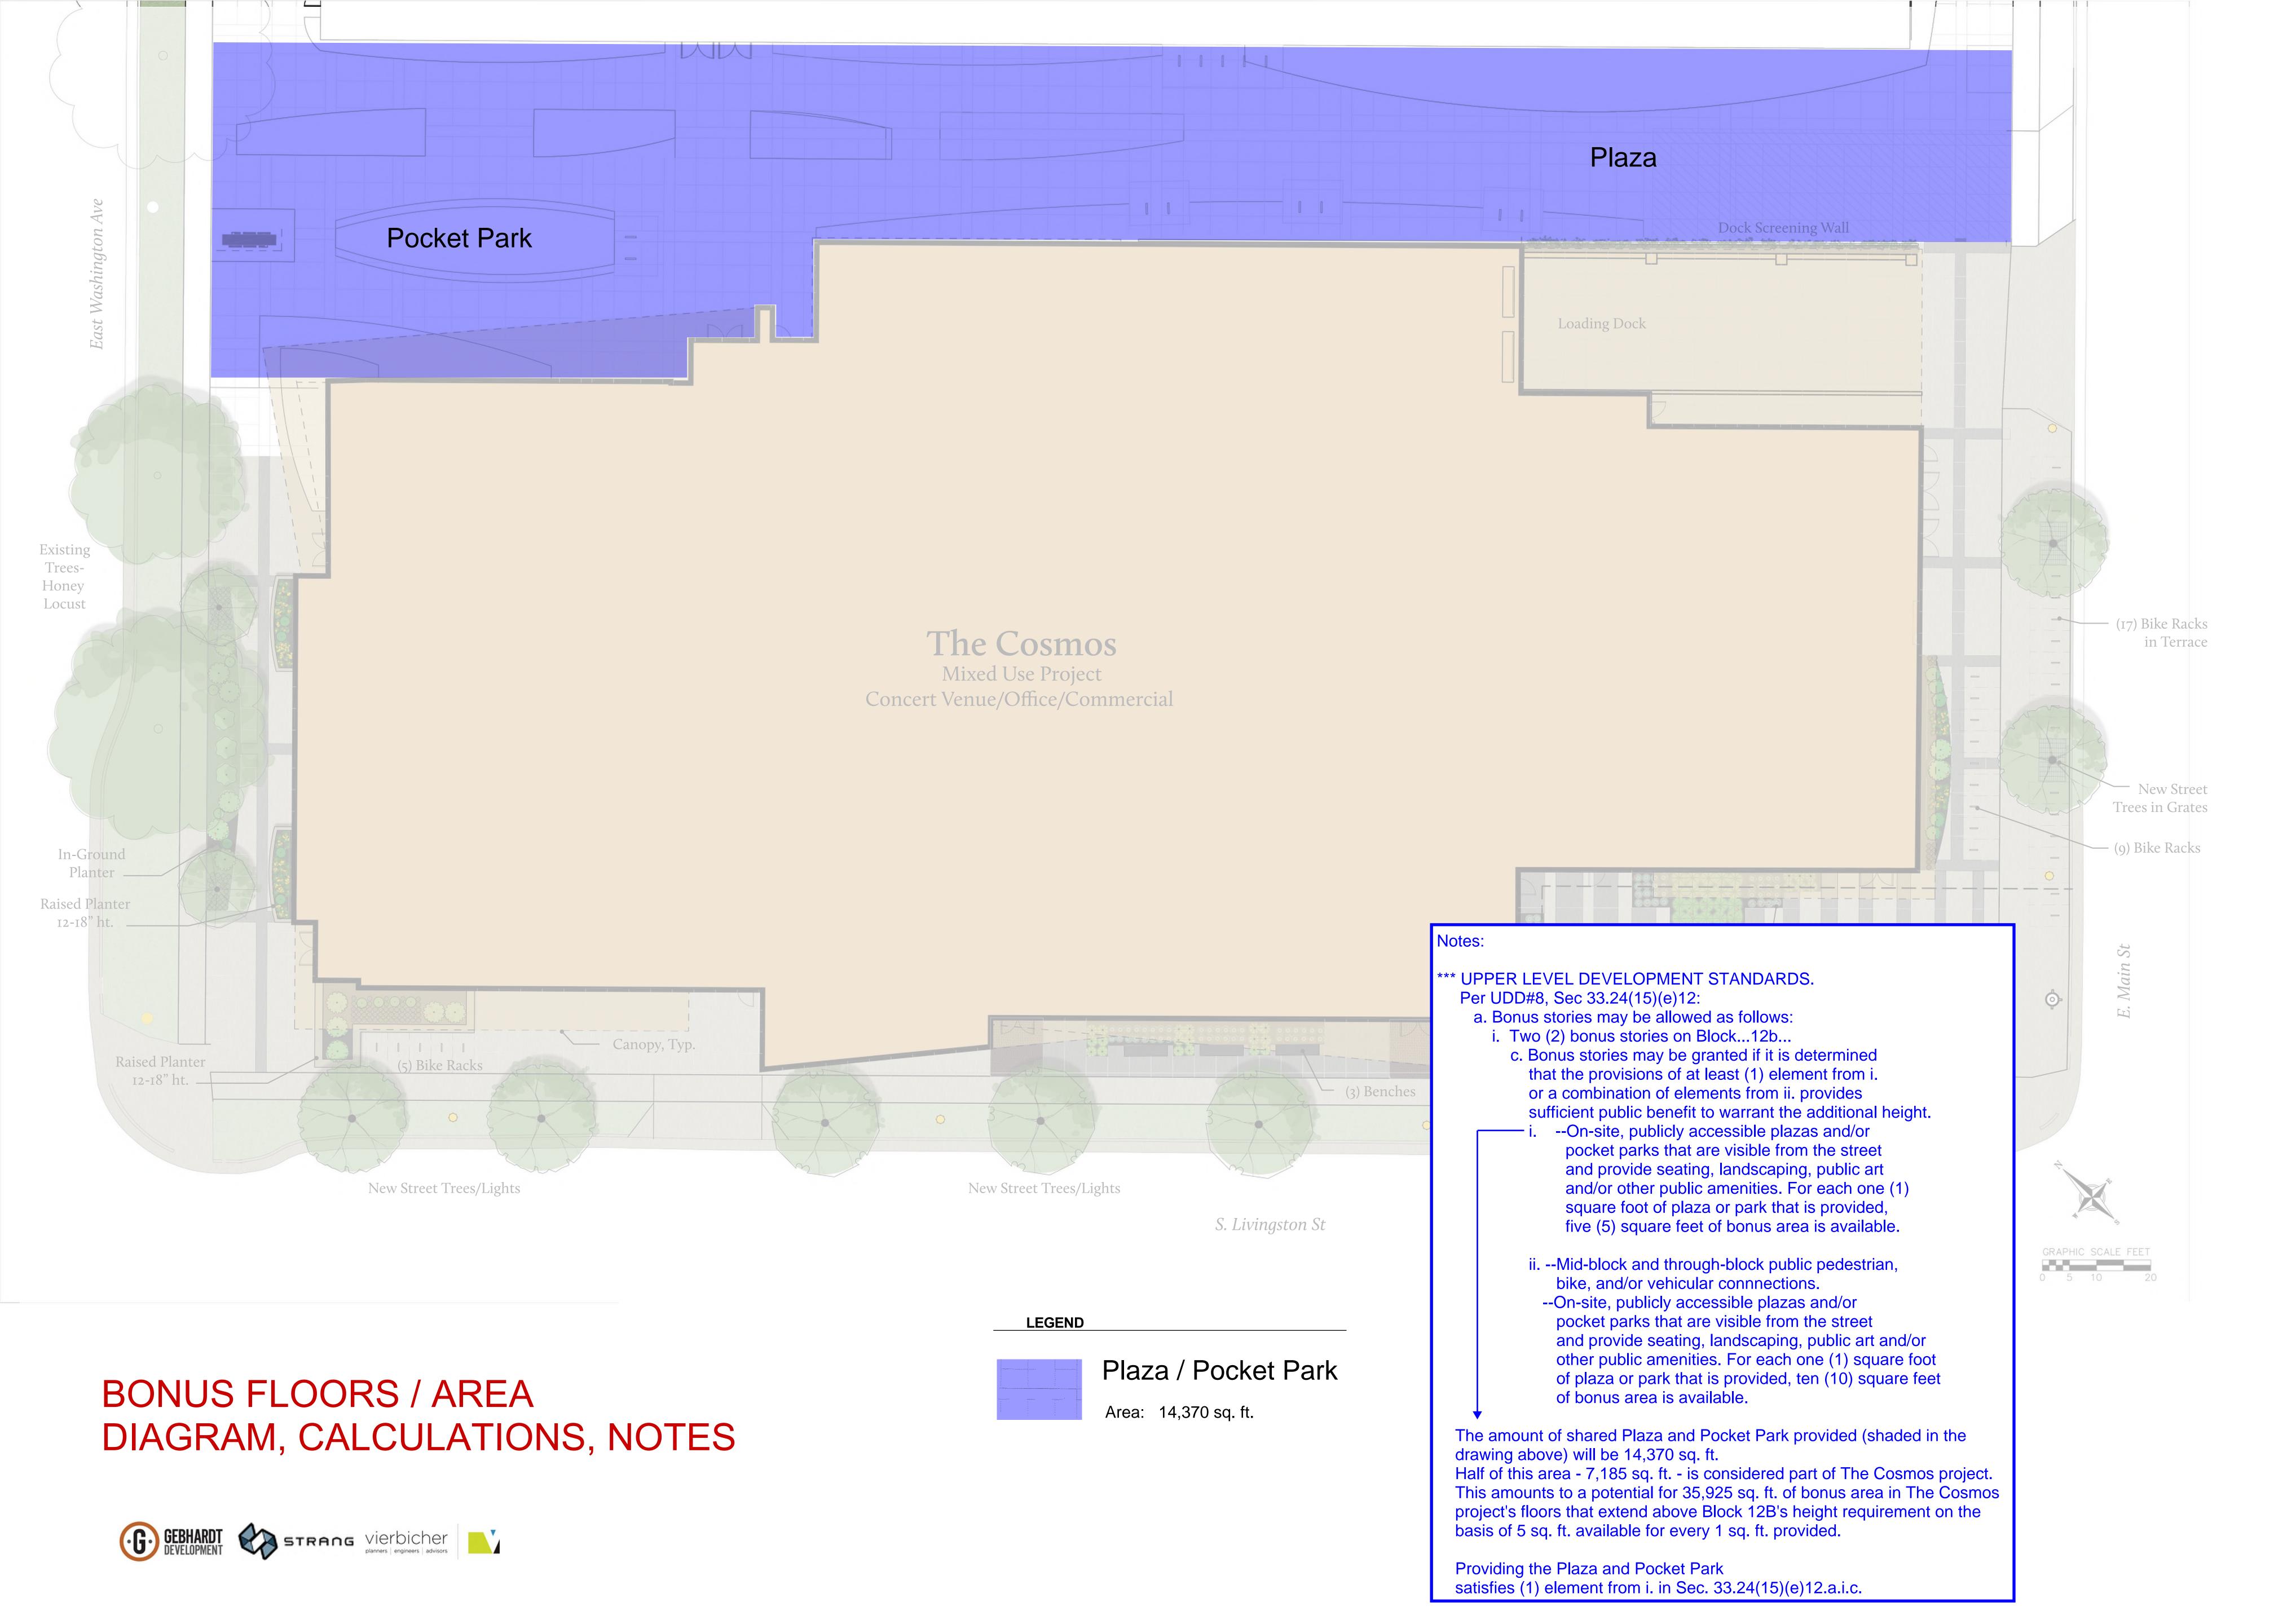

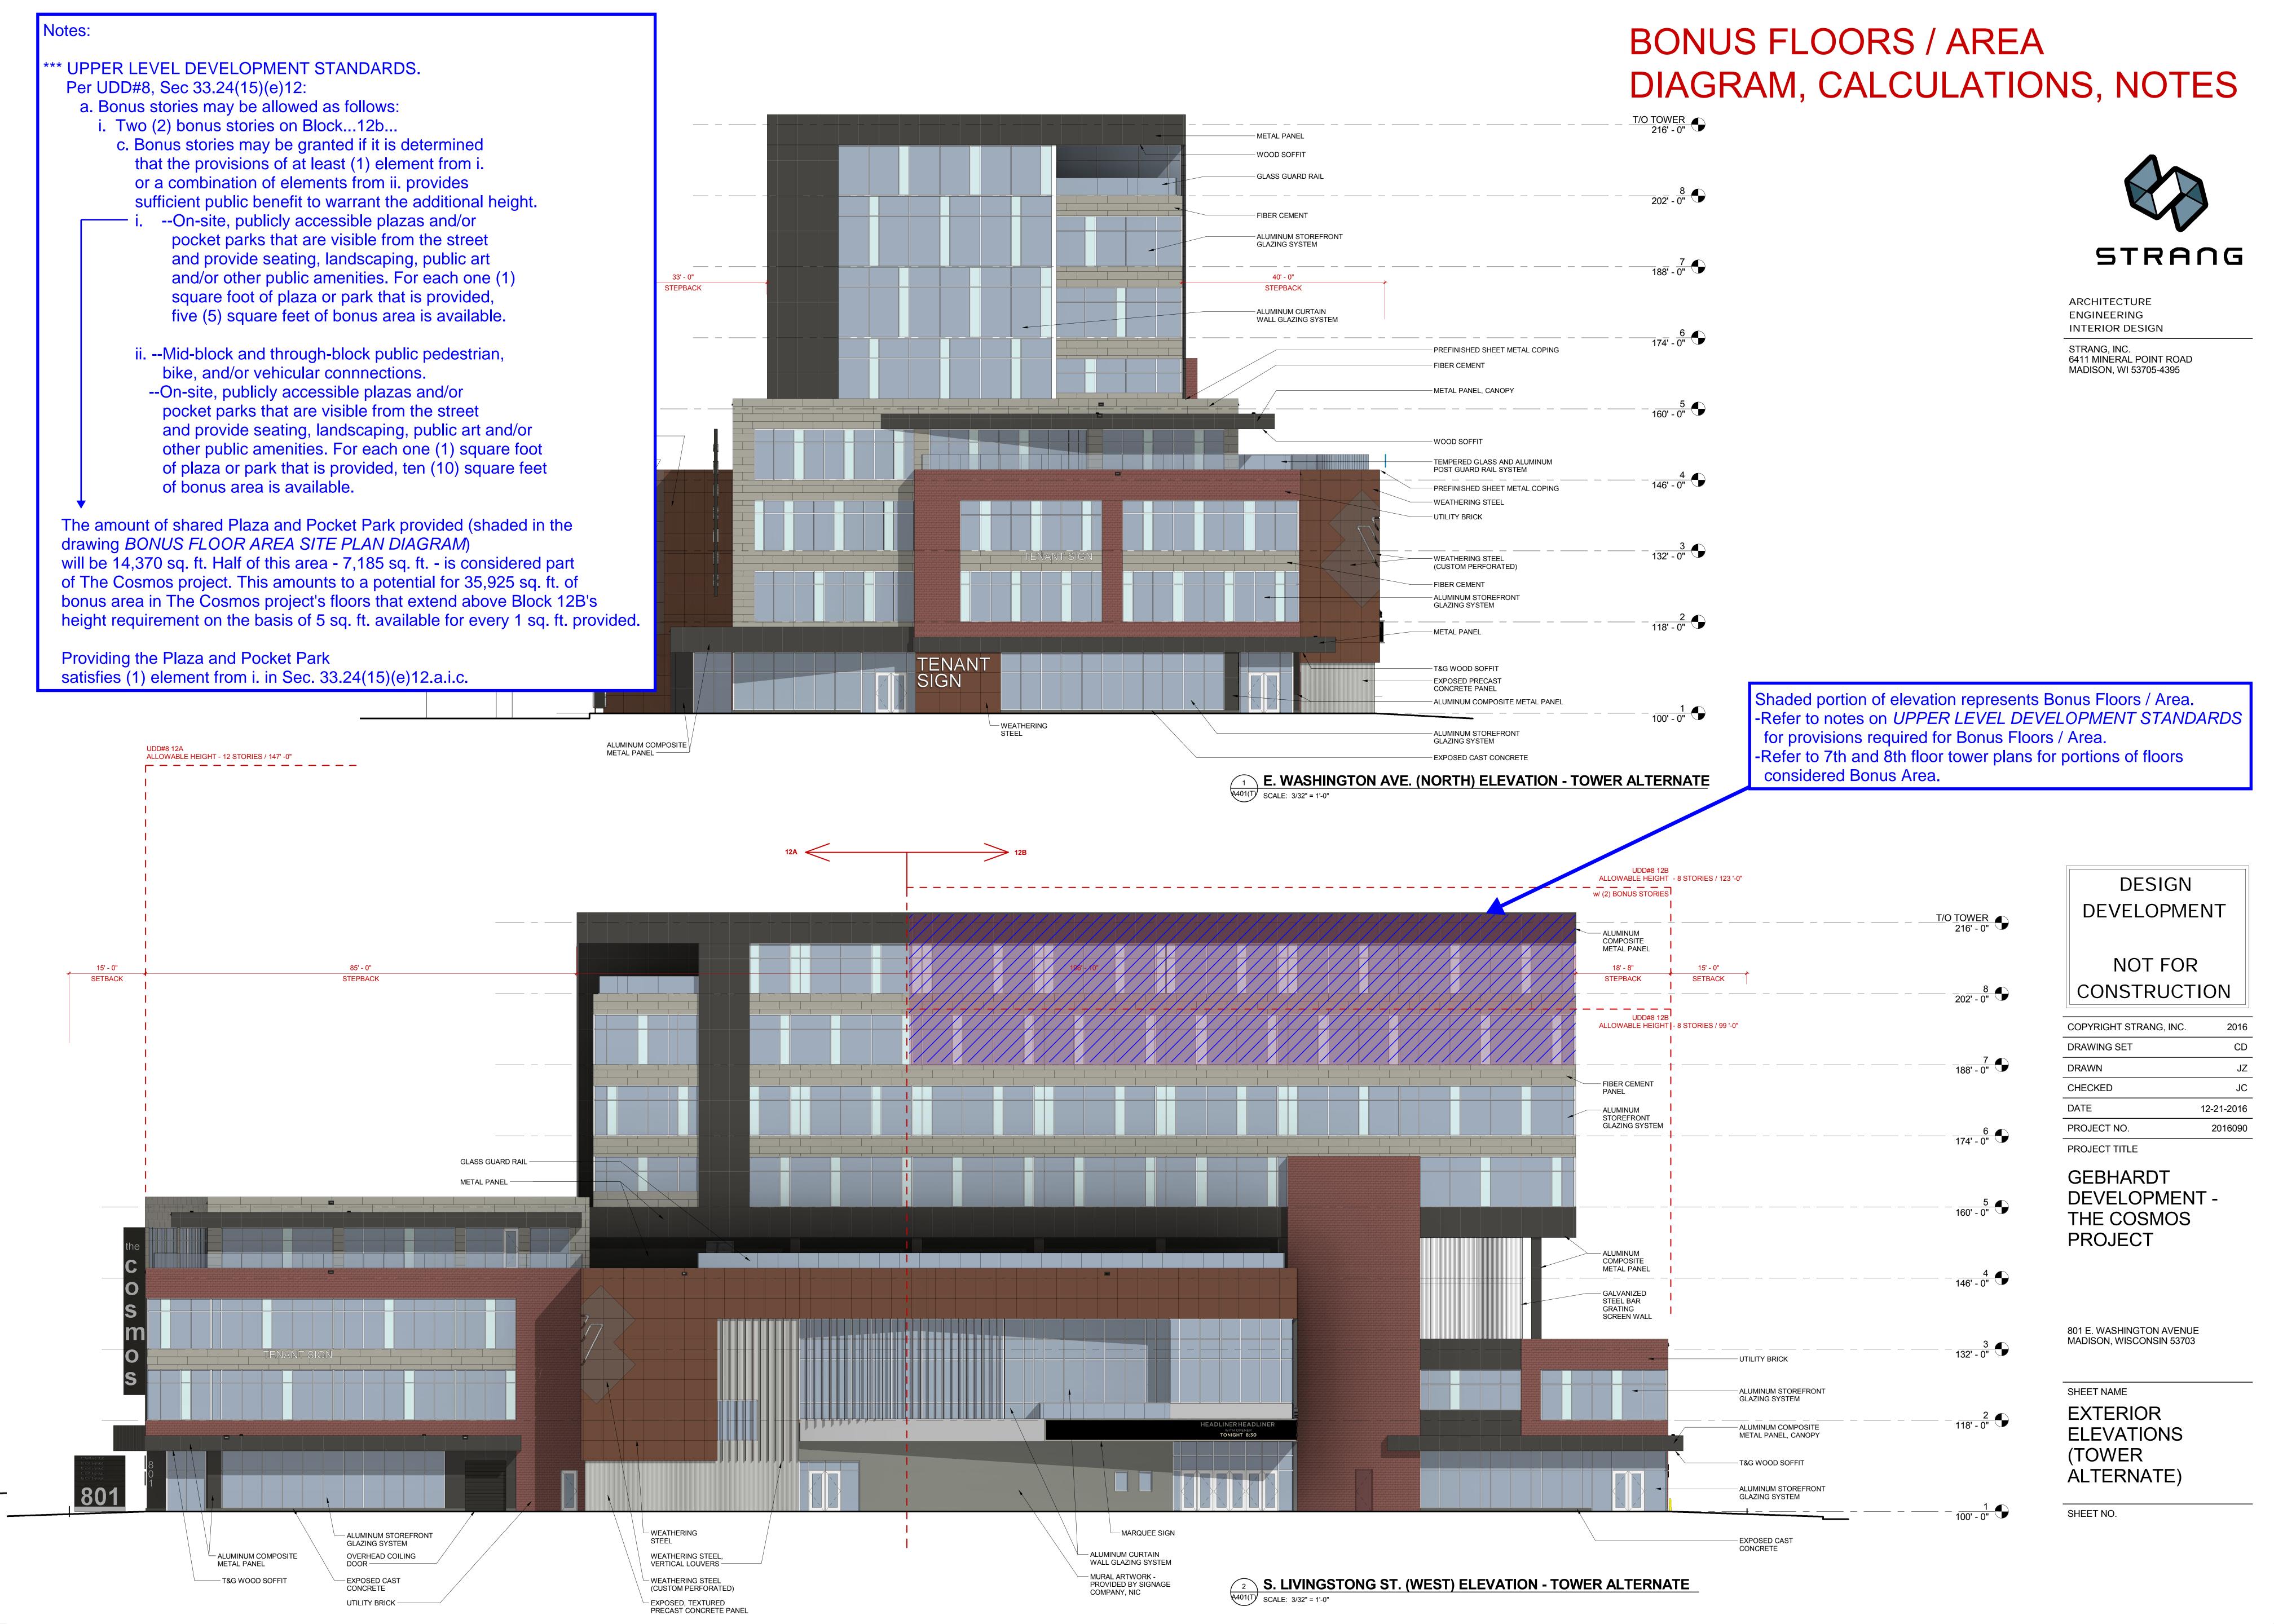

Notes:

- *** UPPER LEVEL DEVELOPMENT STANDARDS. Per UDD#8, Sec 33.24(15)(e)12:
 - a. Bonus stories may be allowed as follows:
 - i. Two (2) bonus stories on Block...12b...
 - c. Bonus stories may be granted if it is determined that the provisions of at least (1) element from i. or a combination of elements from ii. provides sufficient public benefit to warrant the additional height.
 - i. --On-site, publicly accessible plazas and/or pocket parks that are visible from the street and provide seating, landscaping, public art and/or other public amenities. For each one (1) square foot of plaza or park that is provided, five (5) square feet of bonus area is available.

The amount of shared Plaza and Pocket Park provided (shaded in the drawing BONUS FLOOR AREA SITE PLAN DIAGRAM) will be 14,370 sq. ft. Half of this area - 7,185 sq. ft. - is considered part of The Cosmos project. This amounts to a potential for 35,925 sq. ft. of bonus area in The Cosmos project's floors that extend above Block 12B's height requirement on the basis of 5 sq. ft. available for every 1 sq. ft. provided.

Providing the Plaza and Pocket Park satisfies (1) element from i. in Sec. 33.24(15)(e)12.a.i.c.

See the bonus area being requested in the dashed/shaded area on the floor plans shown on this page.

LEGEND AND CALCULATIONS




Bonus Floor / Area

Bonus Area per Floor
7th Floor: 10,050 sq. ft.
8th Floor: 10,050 sq. ft.


Total: 20,100 sq. ft.

Allowed: 35,925 sq. ft

BONUS FLOORS / AREA DIAGRAM, CALCULATIONS, NOTES

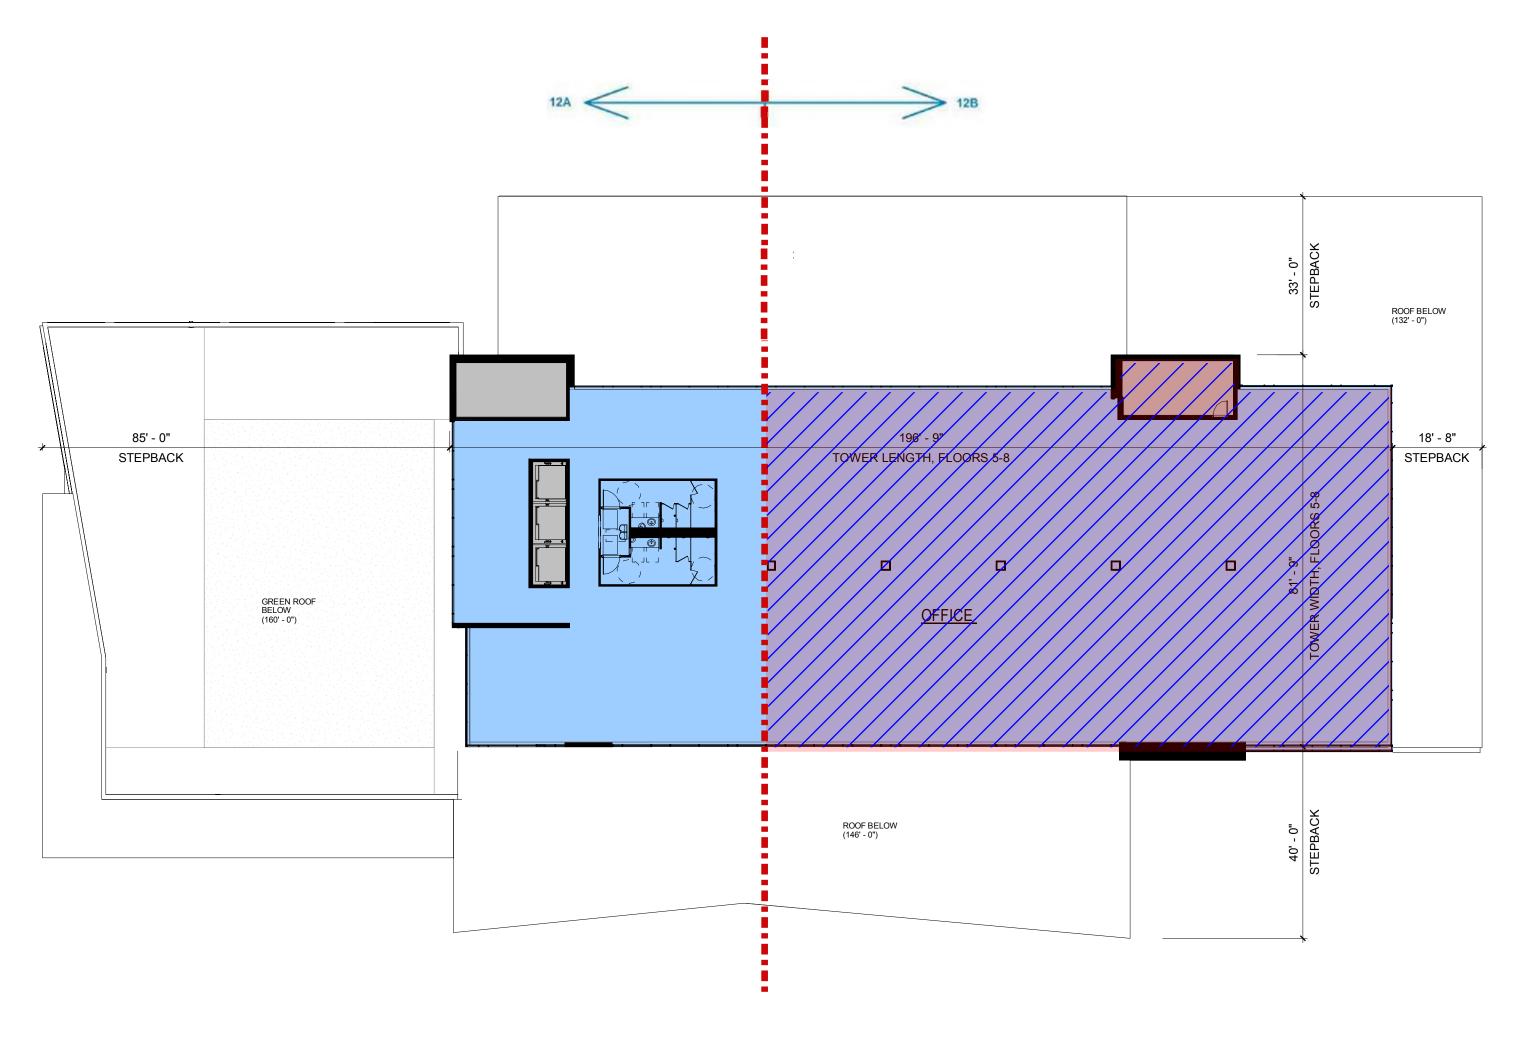



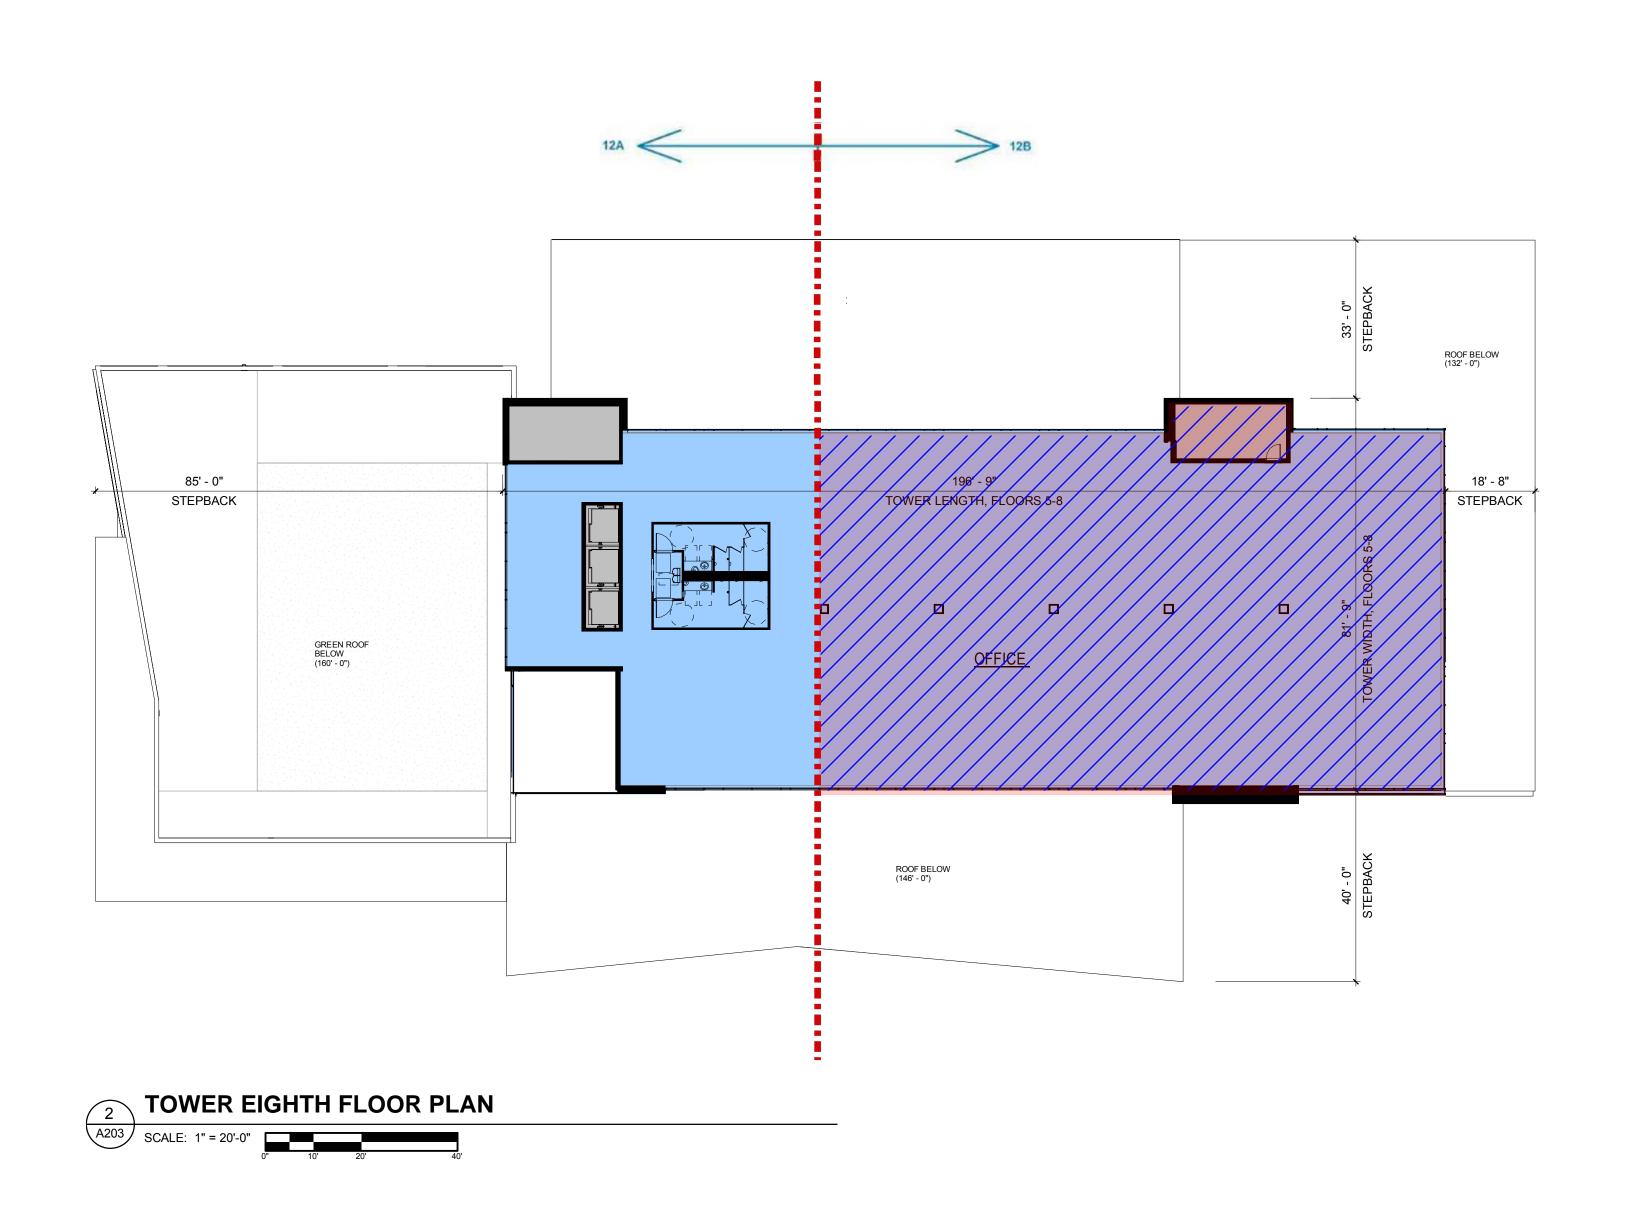

DESIGN DEVELOPMENT NOT FOR

STRANG

ARCHITECTURE ENGINEERING

STRANG, INC.

INTERIOR DESIGN

6411 MINERAL POINT ROAD

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DATE	
PROJECT NO.	2016090

CONSTRUCTION

PROJECT TITLE

GEBHARDT
DEVELOPMENT THE COSMOS
PROJECT

801 E. WASHINGTON AVENUE MADISON, WISCONSIN 53703

SHEET NAME

BONUS STORY DIAGRAM


SHEET NO.

4204



ARCHITECTURE ENGINEERING INTERIOR DESIGN

STRANG, INC. 6411 MINERAL POINT ROAD MADISON, WI 53705-4395

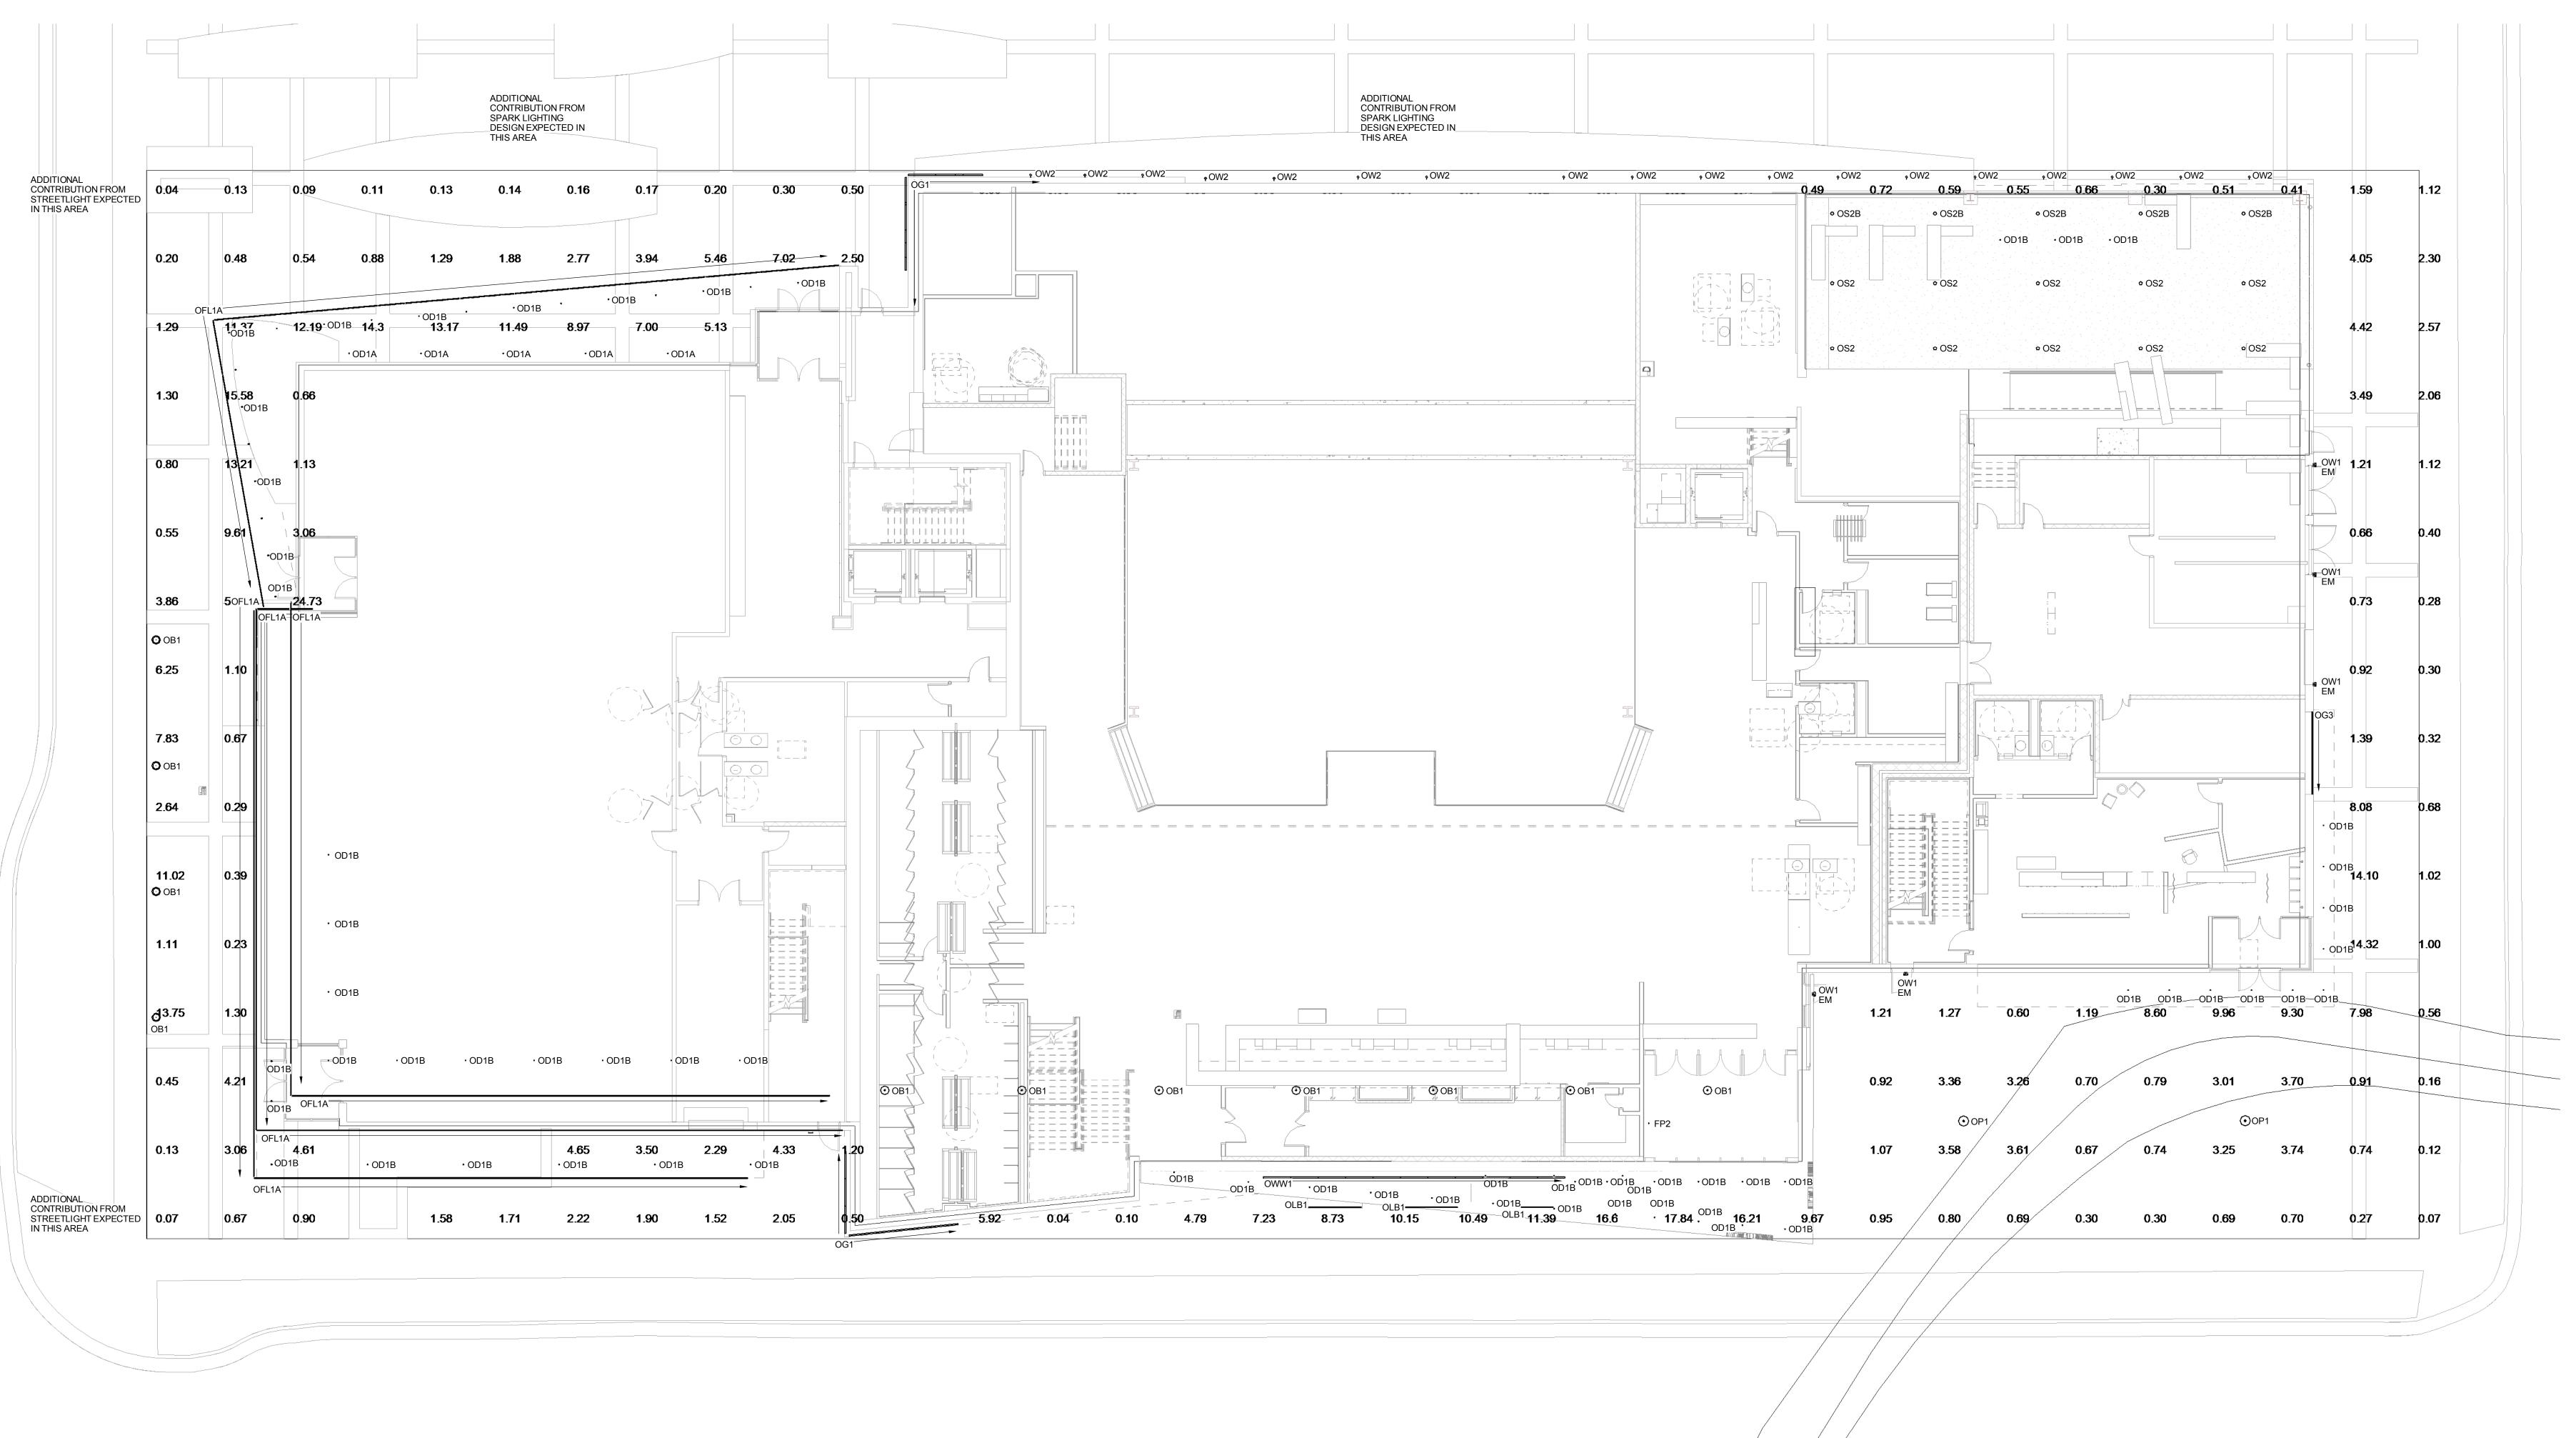

SITE LIGHTING PLAN

SCALE: 1" = 10'-0"

DESIGN DEVELOPMENT

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CHECKED ML/JL

DATE 12-21-2016

PROJECT NO. 2016090

GEBHARDT DEVELOPMENT

DEVELOPMENT -THE COSMOS PROJECT

801 E. WASHINGTON AVENUE MADISON, WISCONSIN 53703


SHEET NAME

ELECTRICAL SI


ELECTRICAL SITE LIGHTING PLAN

SHEET NO.

E201

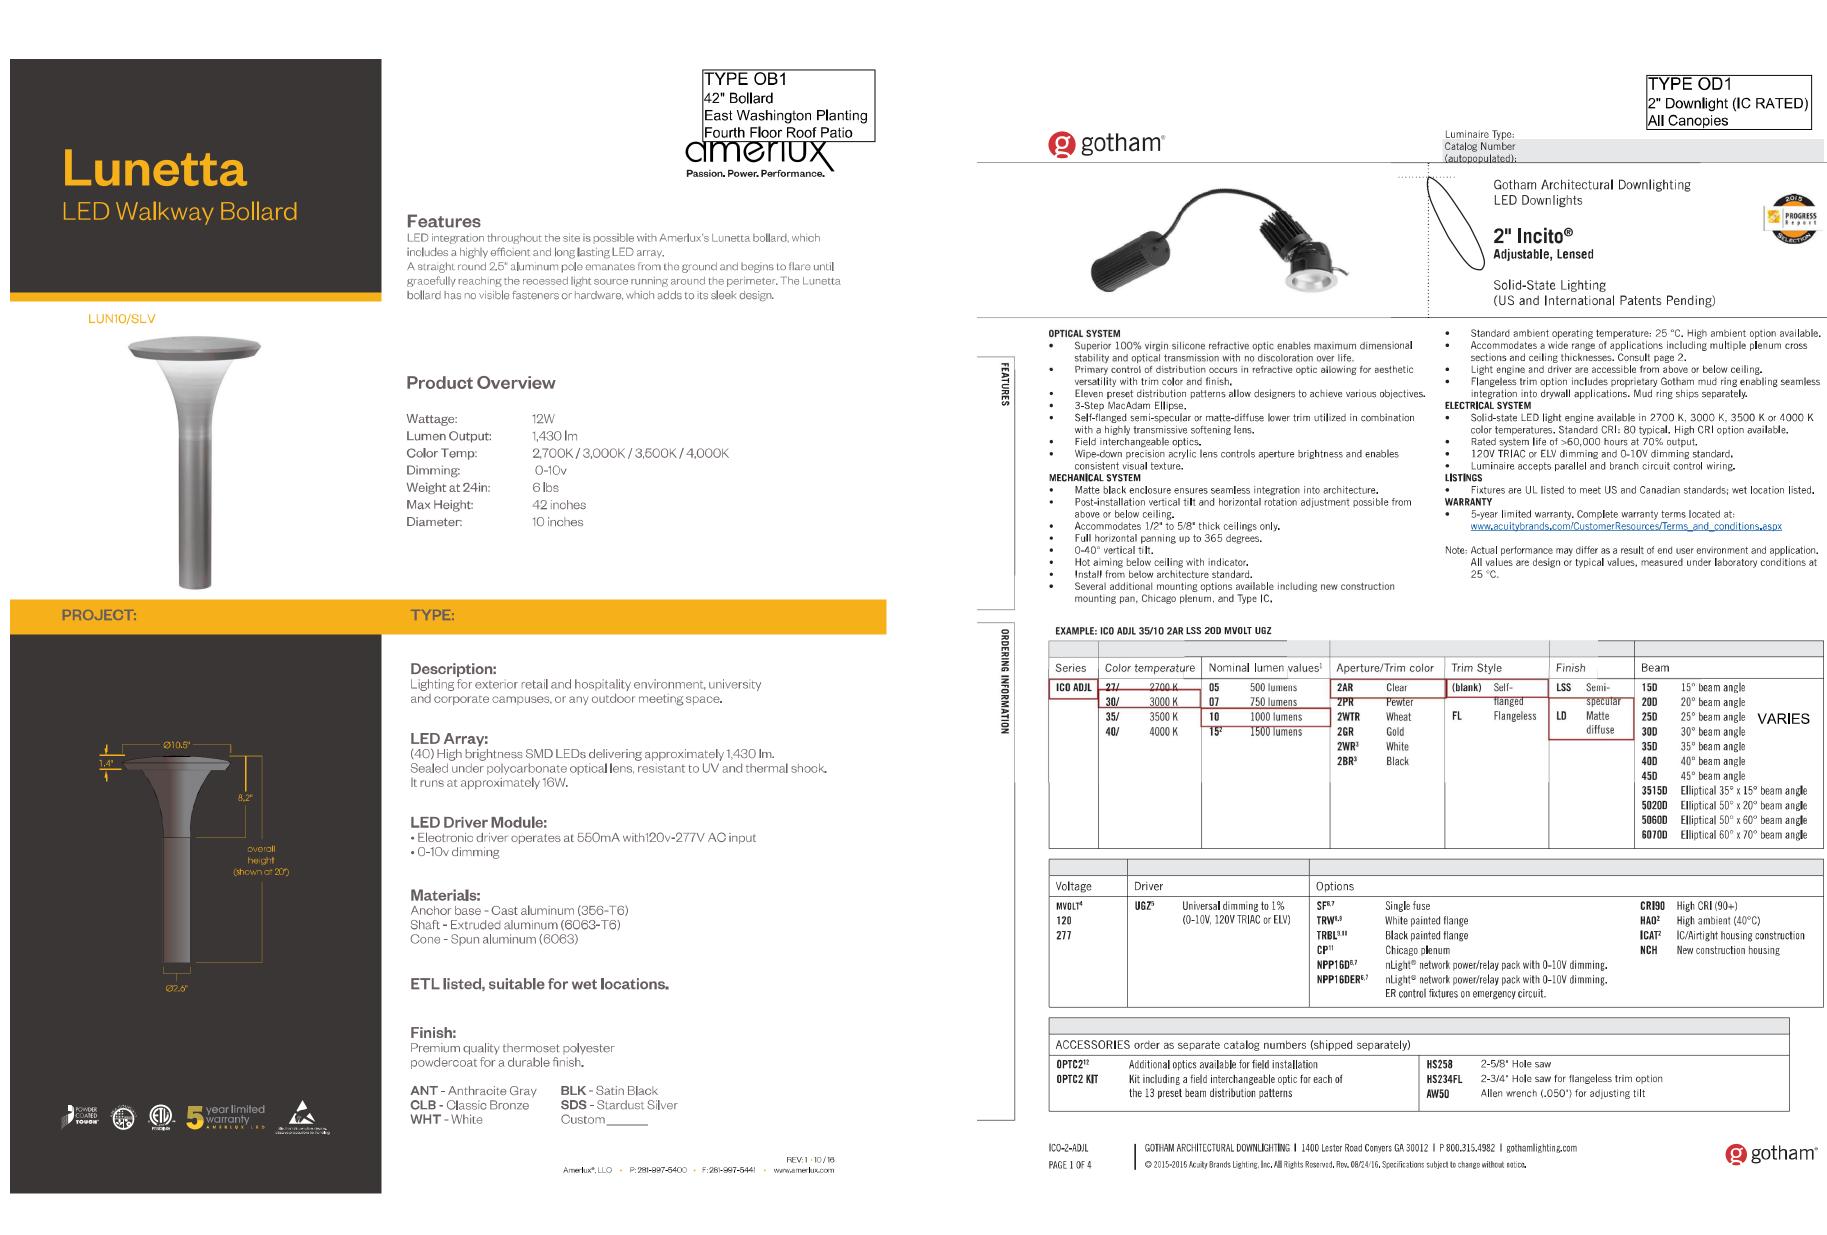

TYPE OD1 TYPE OG1

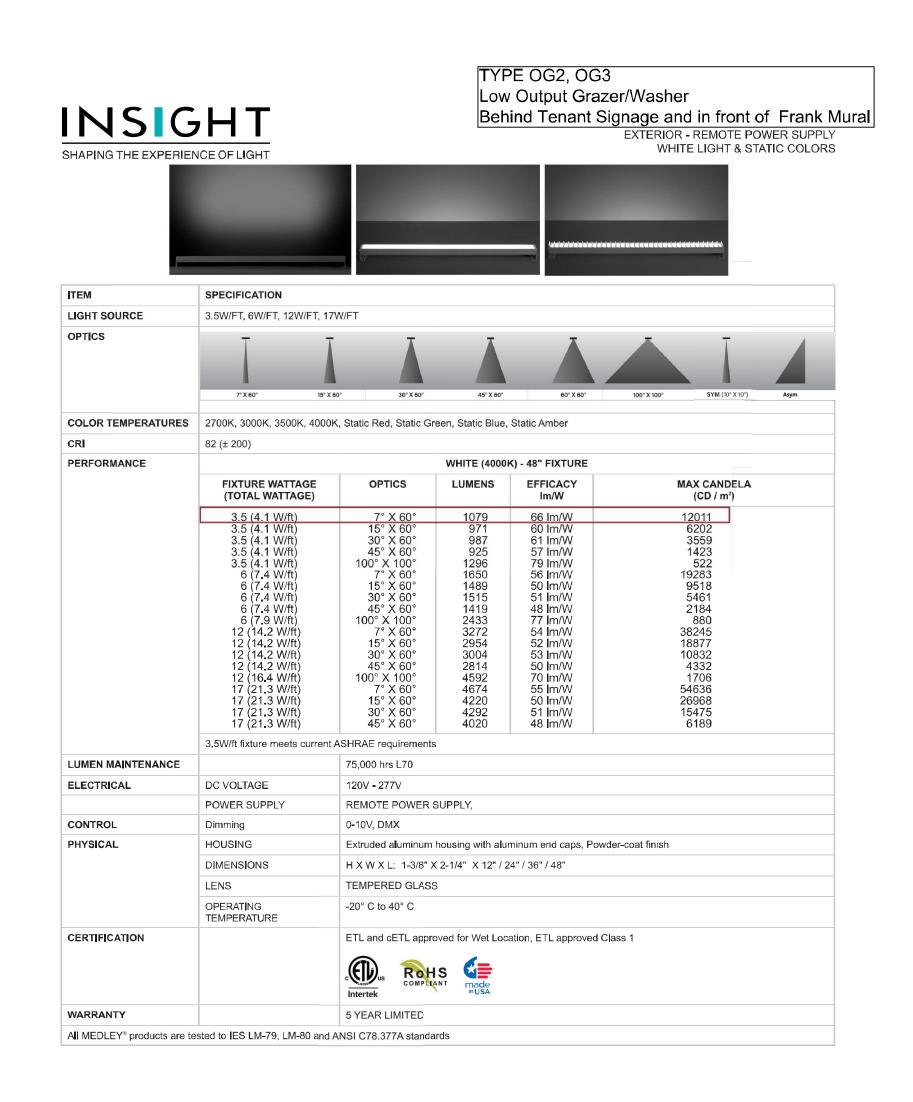



TYPE OB1

TYPE OG2, OG3



TYPE OLB1

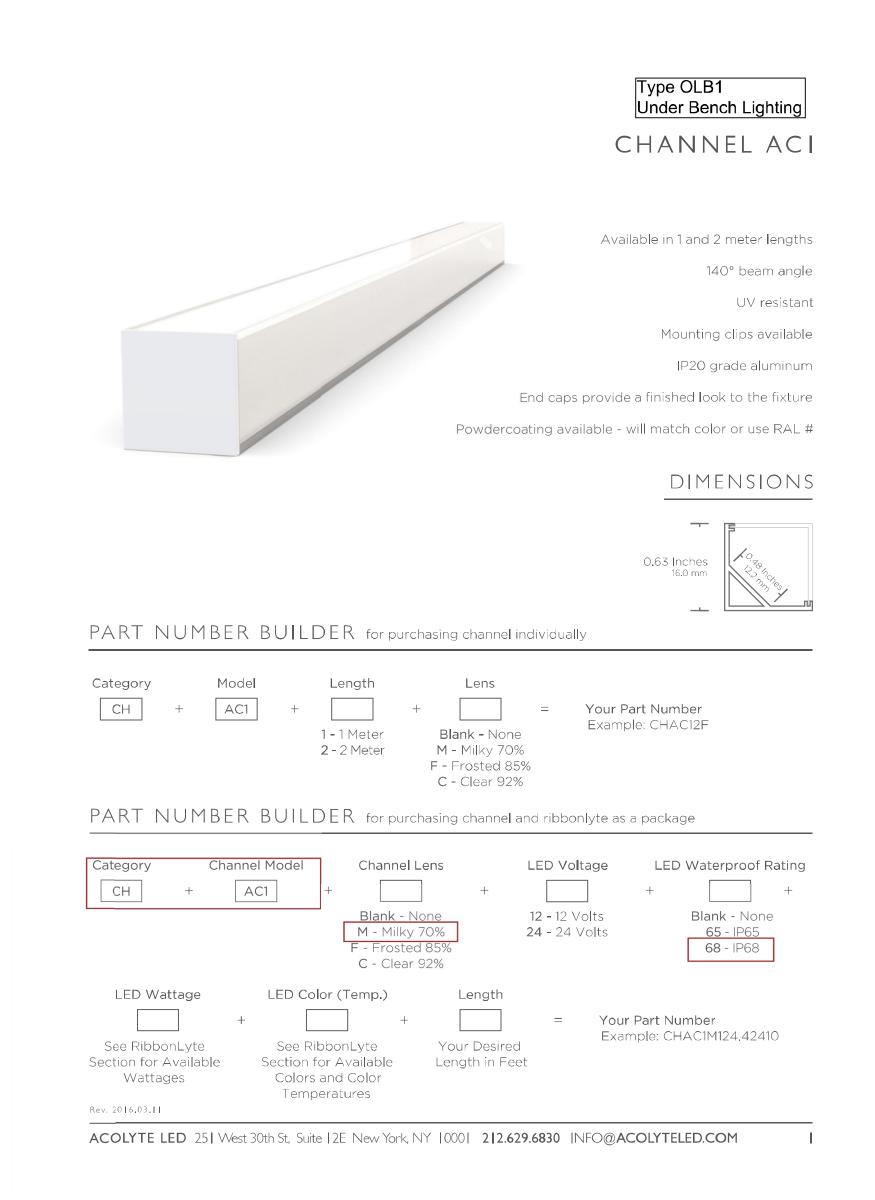

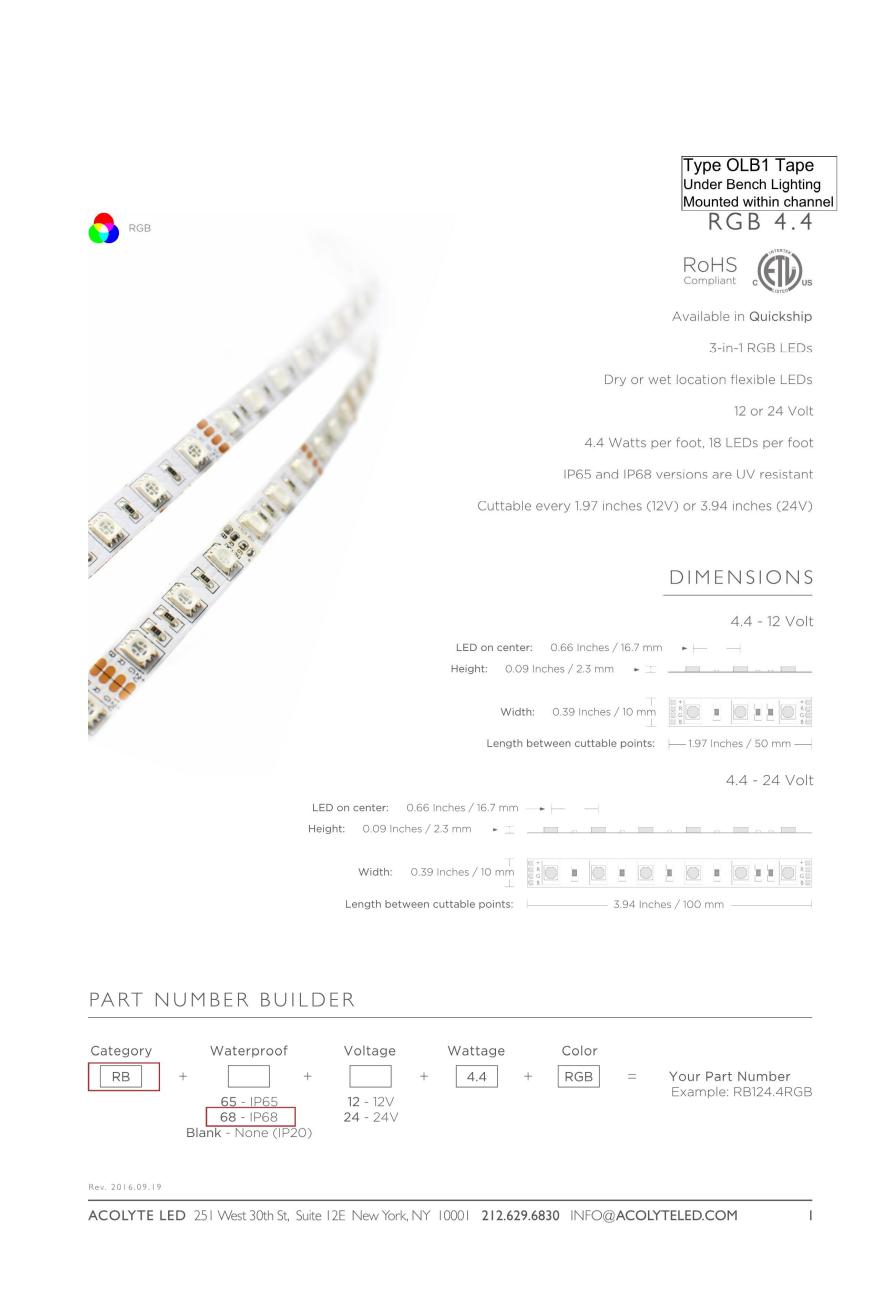

TYPE OG1

FMS MOUNT

RGB TRI-CHROMATIC, RGB DISCREET, RGBW DISCREET, RGBW QUAD-CHROMATIC, RGBWWA, RGB+W

RGB COLOR CHANGING - 48" FIXTURE

Aluminum extrusion with cast aluminum end caps, powder-coated finish

32 LM/W

Meets 3G ANSI C136.31 Vibration standard for bridge applications, IK07 Impact Rating

EFFICACY MAX CANDELA

INSIGHT

COLORS

OPTICS

PERFORMANCE

LUMEN MAINTENANCE

ELECTRICAL

PHYSICAL

CERTIFICATION

1 gotham

SHAPING THE EXPERIENCE OF LIGHT

SPECIFICATION

17W RGB - Discreet, 17W RGBW - Discreet

17W RGBW Quad-Chromatic

FIXTURE WATTAGE

17 (17.6W/FT)

75,000 hrs L70

AC LINE VOLTAGE

POWER SUPPLY

DMX READY

DIMENSIONS

All MEDLEY® products are tested to IES LM-79, LM-80 and ANSI C78.377A standards

HOUSING

LENS

(TOTAL WATTAGE)

75,000 hrs L70

120V OR 277V

Tempered glass

5 YEAR LIMITED

OPERATING TEMPERATURE -20° C to 50° C

Integral to the luminaire, constant voltage

H X W X L: 3" X 2-5/8 X 12", 24" / 36" / 48"

ETL & cETL approved for wet locations, IP 67

High Output RGB Grazer

Backlight for Punched Metal Panels

EXTERIOR - INTEGRAL POWER SUPPLY

TYPE OLB1 TAPE



ARCHITECTURE ENGINEERING INTERIOR DESIGN


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DATE	12-21-2016
PROJECT NO.	2016090
PROJECT TITLE	

GEBHARDT DEVELOPMENT -THE COSMOS **PROJECT**

801 E. WASHINGTON AVENUE MADISON, WISCONSIN 53703

SHEET NAME LIGHTING CUTS

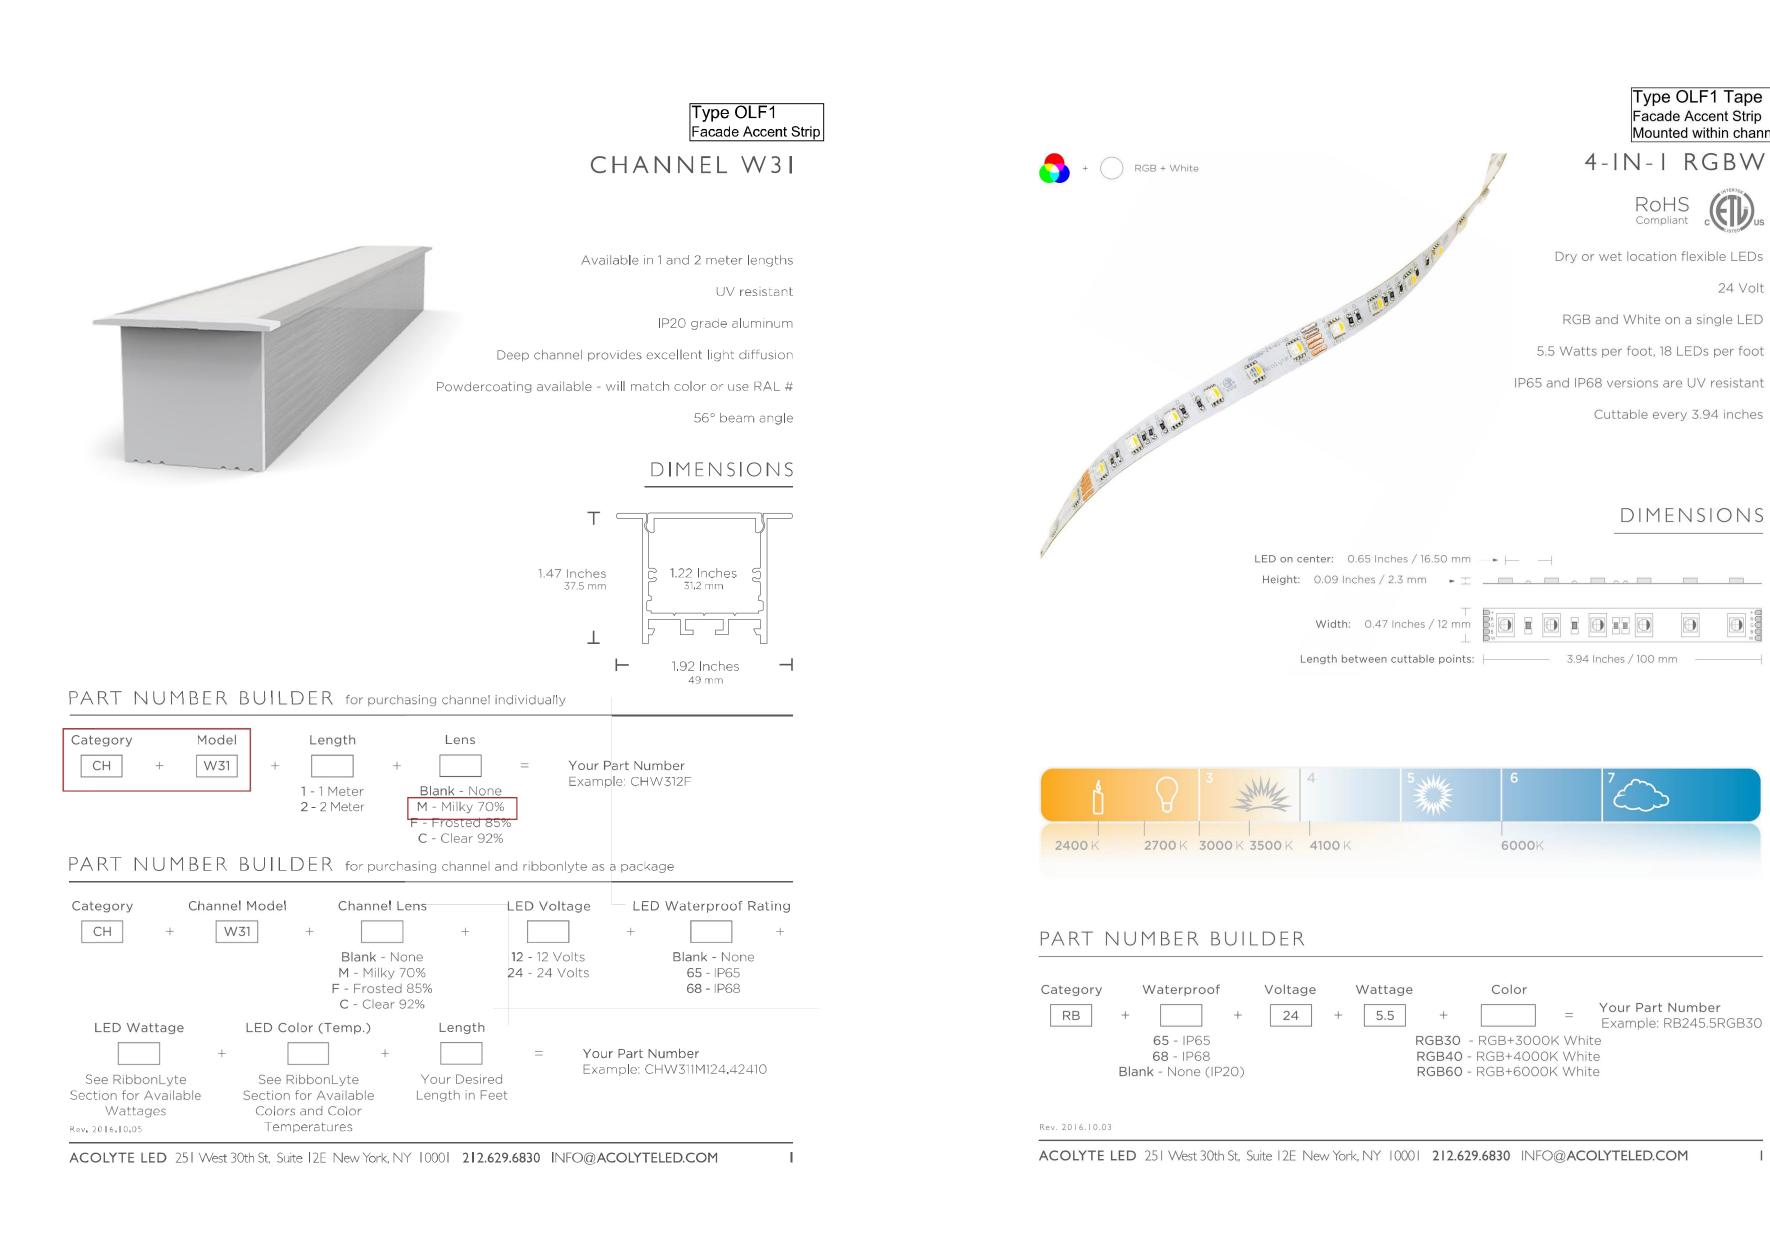

TYPE OLF1

TYPE OS2





ARCHITECTURE **ENGINEERING** INTERIOR DESIGN

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PROJECT TITLE	


GEBHARDT DEVELOPMENT -THE COSMOS **PROJECT**


801 E. WASHINGTON AVENUE MADISON, WISCONSIN 53703

SHEET NAME LIGHTING CUTS





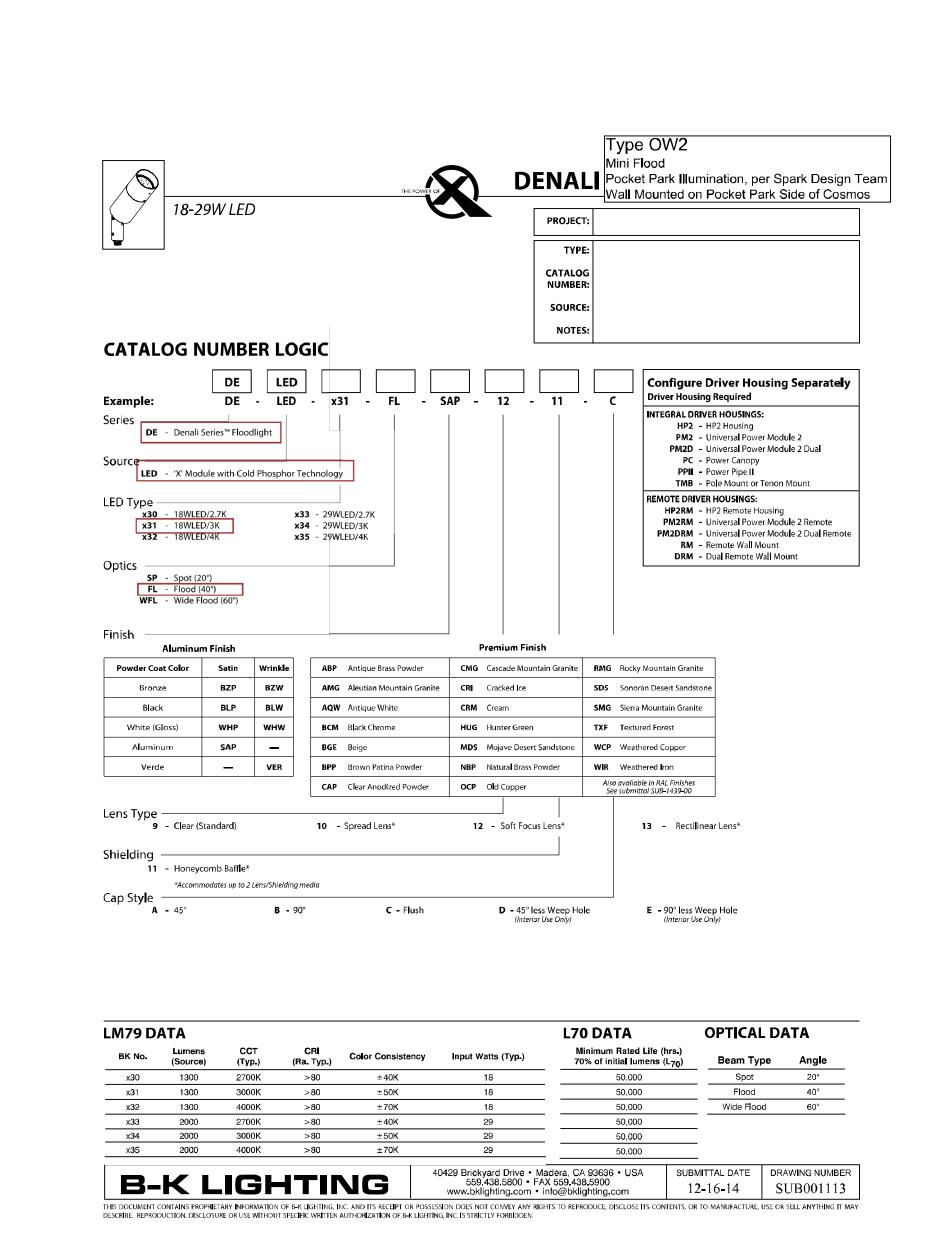

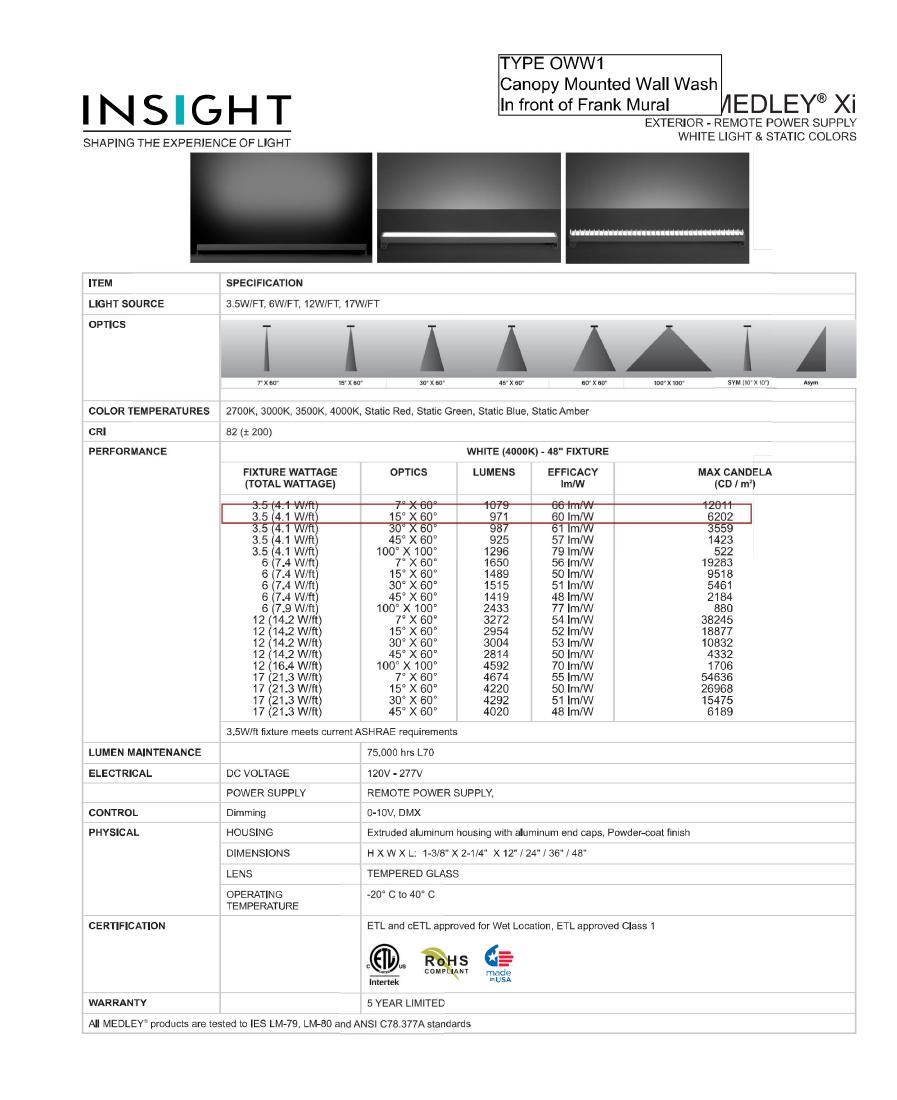

Insight Lighting www.insightlighting.com October 4, 2016 4:13 PM

TYPE OW2 TYPE OWW1 TYPE OW1

Type OLF1 Tape Facade Accent Strip

4-IN-I RGBW

Dry or wet location flexible LEDs

RGB and White on a single LED

Cuttable every 3.94 inches

DIMENSIONS

Your Part Number

Example: RB245.5RGB30

5.5 Watts per foot, 18 LEDs per foot

IP65 and IP68 versions are UV resistant

Rohs Compliant Compliant


24 Volt





ARCHITECTURE ENGINEERING INTERIOR DESIGN

STRANG, INC. 6411 MINERAL POINT ROAD MADISON, WI 53705-4395

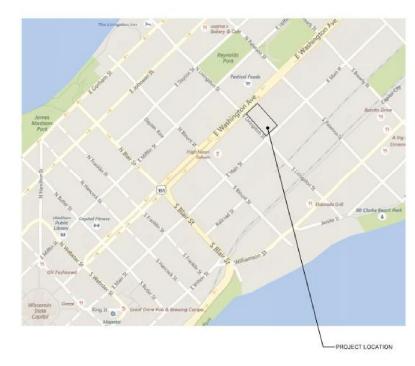


THE COSMOS PROJECT



PROJECT TITLE

GEBHARDT DEVELOPMENT -THE COSMOS PROJECT

E. WASHINGTON AVENUE MADISON, WISCONSIN 53703

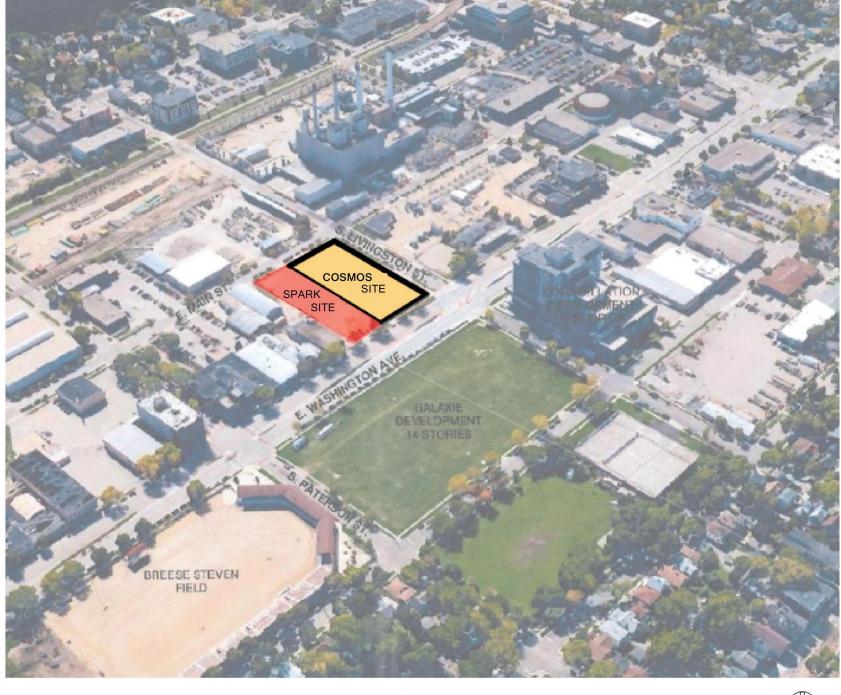

SITE LOCATOR
SCALE: NTS
















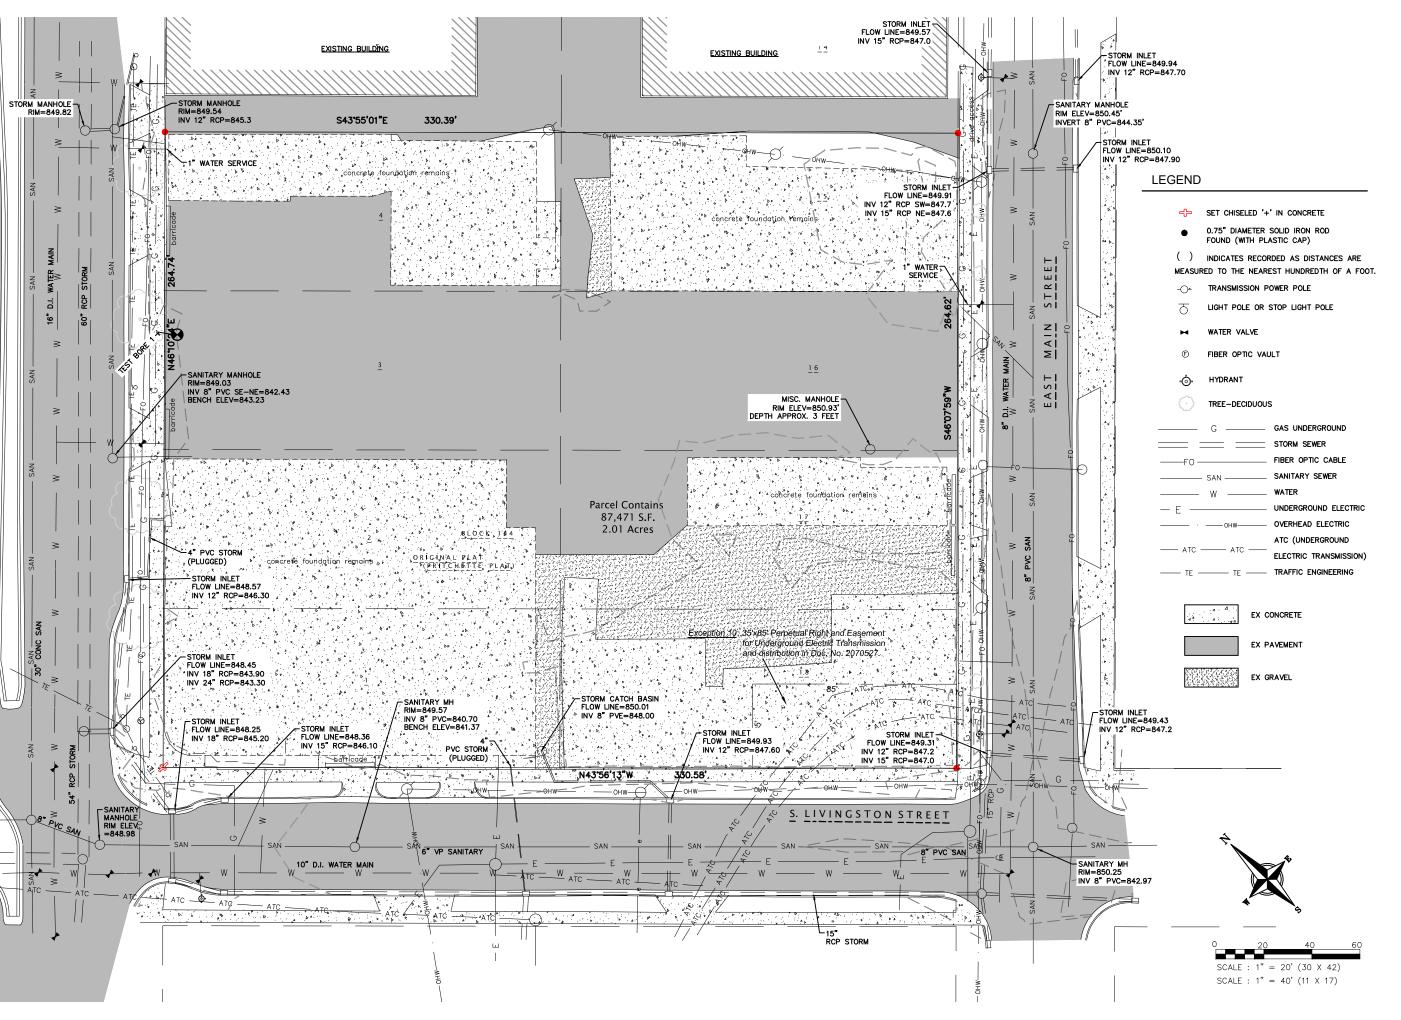



eppstein uhen : architects

milwaukee 3 3 3 East Chicago Street Milwaukee, Wisconsin 53202 telephone 414.271.5350 madison 309 West Johnson Street, Suite 202 Madison, Wisconsin 5 3 7 0 3 telephone 608.442.5350



6411 Mineral Point Road Madison, WI 53705 (608) 276 - 9200



330 West Lakeside Street Madison, WI 53715 608 . 358 . 6344



818 N Meadowbrook Ln Waunakee, WI 53597 (608) 849-9378

PROJECT INFORMATION

COSMOS -THE SPARK PROJECTS

800 E WASHINGTON AVE MADISON, WI





ISSUANCE AND REVISIONS

UDC Submittal (Revised)

DATE DESCRIPTION

SHEET INFORMATION

PROGRESS DOCUMENTS NOT FOR CONSTRUCTION These documents reflect progress and intent and may


subject to change, including additional detail. These e not final construction documents and should not be sed for final bidding or construction-related purposes.

 PROJECT MANAGER
 RJ

 PROJECT NUMBER
 1249

 DATE
 12/21/16

EXISTING CONDITIONS

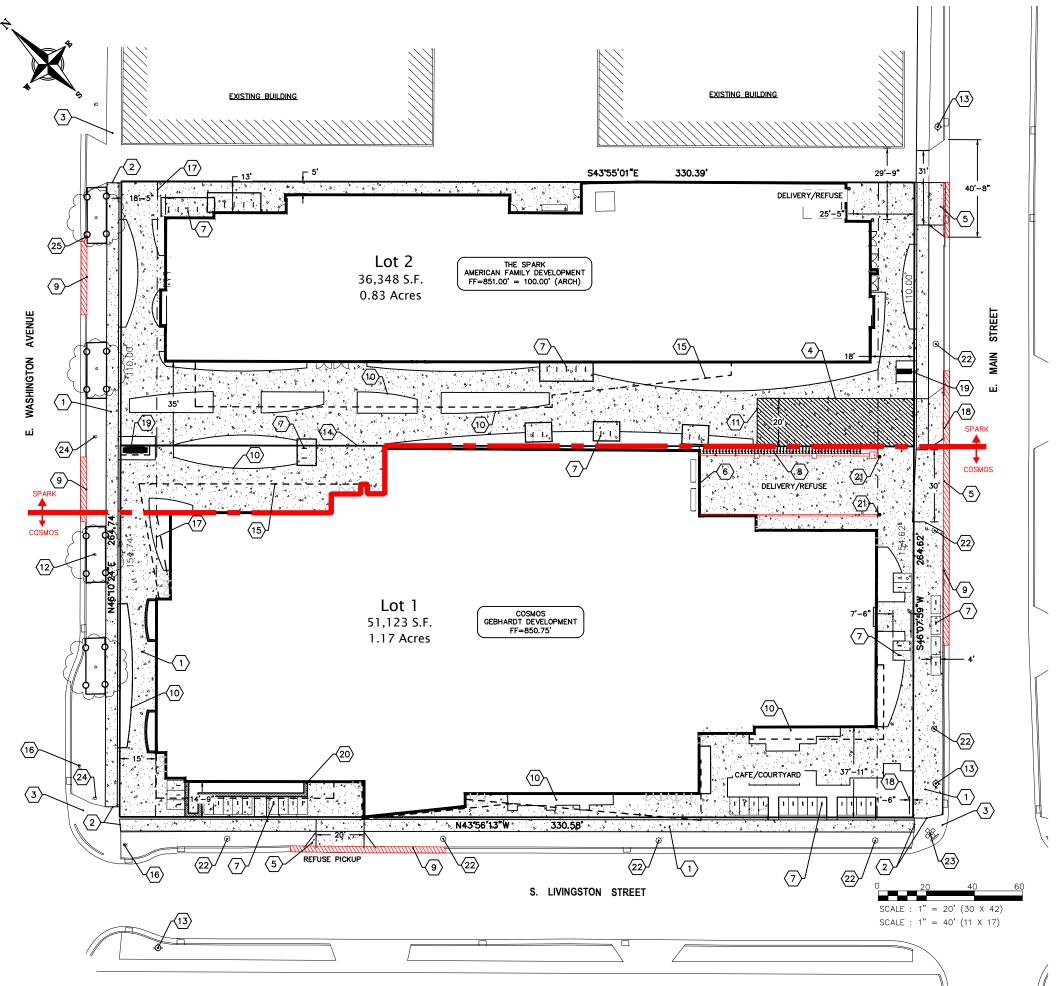

PLAN KEY

- 1 CONCRETE SIDEWALK, TYP.
- 2 MATCH EXISTING SIDEWALK, TYP.
- 3 EXISTING SIDEWALK TO REMAIN, TYP.
- 4 SIDEWALK TO BE 7" THICK IN FIRELANE SECTION
- NEW DRIVEWAY APPROACH SHALL BE IN ACCORDANCE WITH CITY STANDARDS
- 6 LOADING DOCK
- 7 BICYCLE RACK (58 TOTAL STALLS), TYP.
- igg(8) VERTICAL BICYCLE RACK (50 TOTAL STALLS), TYP.
- EXISTING DRIVEWAY TO BE ABANDONED 9 IN ACCORDANCE WITH CITY STANDARDS W/ CURB REPLACED & TERRACE RESTORED
- LANDSCAPE AREA, TYP.
 SEE LANDSCAPE PLANS
- 11 FIRE LANE
- 12 EX TREE, TYP.
- (13) EXISTING FIRE HYDRANT
- 14 PROPOSED LOT LINE
- $\langle 15 \rangle$ CANOPY/UPPER FLOOR OVERHANG, TYP.
- (16) EXISTING STOP LIGHT
- 17 15' BUILDING SETBACK
- ROLL CURB TO BE PROVIDED FOR FIRE 18 LANE ENTRANCE
- (19) MONUMENT SIGN
- LANDSCAPE PLANTER, SEE LANDSCAPE
- 20 PLAN
- 21 BOLLARD
- 22 PEDESTRIAN LIGHT (10' HIGH POLE)
- 23 STREET LIGHT (30' HIGH POLE)
- 24 EXISTING STREET LIGHT
- 25 TREE PROTECTION, TYP.

PAVEMENT KEY



SITE INFORMATION

CONCRETE

SITE ADDRESS: 800 EAST WASHINGTON AVENUE

SITE ACREAGE TOTAL:

LOT 1: 51,123 SQ. FT. (1.17 ACRES) LOT 2: 36,348 SQ. FT. (0.83 ACRES)

LOT 1: 43,454 SQ. FT. (85% IMPERVIOUS, INCLUDES VEGETATED ROOF)

LOT 2: 31,822 SQ. FT. (88% IMPERVIOUS)

NUMBER OF BIKE PARKING STALLS: LOT 1: 226 STALLS (58 TRADITIONAL, 50 VERTICAL, 60 INTERIOR, 8 IN RIGHT—OF—WAY, &

50 SHARED IN PLAZA AREA) 43 STALLS



eppstein uhen : architects

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PROJECT INFORMATION

COSMOS -THE SPARK **PROJECTS**

800 E WASHINGTON AVE MADISON, WI





ISSUANCE AND REVISIONS

UDC Submittal (Revised)


DATE DESCRIPTION

SHEET INFORMATION

PROGRESS DOCUMENTS NOT FOR CONSTRUCTION

PROJECT MANAGER PROJECT NUMBER 1249 12/21/16 DATE

SITE PLAN

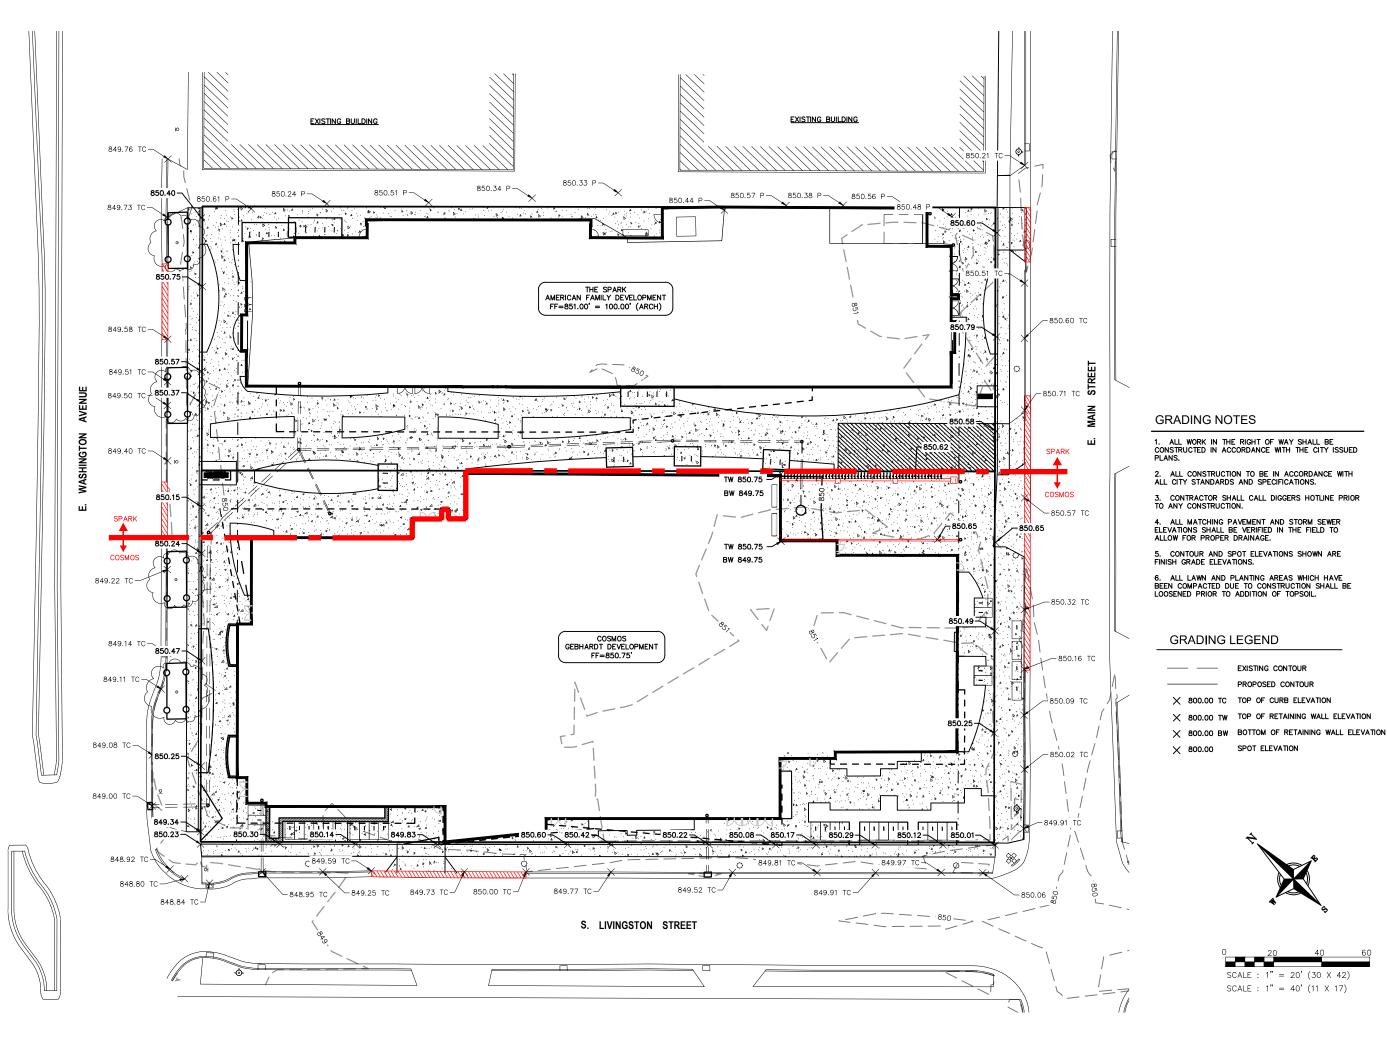



eppstein uhen : architects

milwaukee 3 3 3 East Chicago Street Milwaukee, Wisconsin S3202 telephone 414, 271, 5300 madison 30 9 West Johnson Street, Suite 202 Madison, Wisconsin 53703 telephone 680, 442, 5300



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PROJECT INFORMATION

COSMOS -THE SPARK **PROJECTS**

800 E WASHINGTON AVE MADISON, WI





ISSUANCE AND REVISIONS

EXISTING CONTOUR

PROPOSED CONTOUR

SPOT ELEVATION

SCALE : $1" = 20' (30 \times 42)$

SCALE : $1" = 40' (11 \times 17)$

UDC Submittal (Revised)


DATE DESCRIPTION

SHEET INFORMATION



PROJECT MANAGER 1249 PROJECT NUMBER 12/21/16 DATE

GRADING PLAN

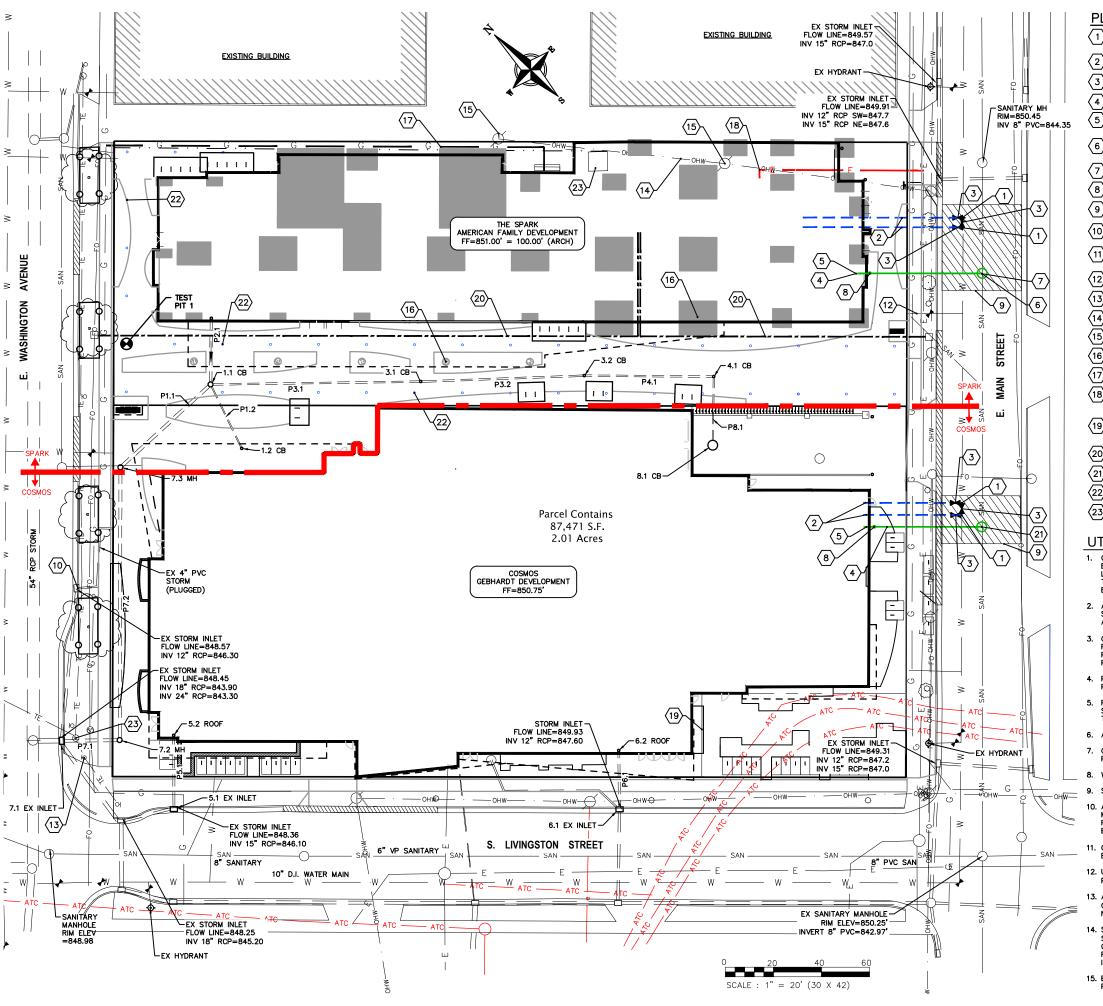

PLAN KEY

- CONNECT TO EXISTING WATER MAIN WITH 8"X8"X8" CUT-IN TEE. COORDINATE INSTALLATION WITH MADISON WATER UTILITY
- $\langle 2 \rangle$ 8" WATER SERVICE
- 3 8" VALVE
- 4 8" SANITARY LATERAL @ 0.52% MIN. SLOPE
- (5) 8" SANITARY INV=844.50'. EXTEND 5 FEET INTO BUILDING
- SANITARY MANHOLE PER CITY REQUIREMENTS, RIM=850.45, INVERT=844.13
- 7 RAINWATER HOLDING TANK
- (8) SEE PLUMBING PLANS FOR CLEAN OUT LOCATION
- 9 UTILITY PATCH PER CITY REQUIREMENTS
- $\langle \overline{10} \rangle$ connect to existing storm sewer inlet per city standards
- CONNECT TO ROOF DRAIN. COORDINATE WORK WITH PLUMBING (11) CONNECT TO
- $\langle 12 \rangle$ EXISTING 1" WATER SERVICE TO BE ABANDONED
- (13) EXISTING LIGHT POLE
- (14) EXISTING OVERHEAD ELECTRICAL TO BE RELOCATED
- (15) EXISTING POWER POLE TO BE REMOVED
- (16) FOOTING CAP OR FOUNDATIONS
- (17) GAS SERVICE, COORDINATE LOCATION WITH MG&E
- (18) ELECTRIC SERVICE, COORDINATE LOCATION WITH MG&E
- EXCEPTION 10: 35'X85' PERPETUAL RIGHT AND EASEMENT FOR 19 UNDERGROUND ELECTRIC TRANSMISSION AND DISTRIBUTION IN DOC. NO.
- (20) TELECOM 4" FIBER/COPPER CONDUIT, COORDINATE LOCATION WITH AT&T
- 21 SANITARY MANHOLE, RIM=850.53, INVERT=843.63
- (22) GEO-EXCHANGE WELL, TYP
- (23) INSTALL STORM UNDER TRAFFIC ENGINEERING VAULT

UTILITY NOTES

- 1. CONTRACTOR SHALL CALL DIGGERS HOTLINE PRIOR TO ANY CONSTRUCTION. ALL EXISTING UTILITIES SHOWN ON THE PLAN ARE APPROXIMATE AND WERE FIELD LOCATED FROM GROUND MARKING OR BASED OFF OF CITY UTILITY RECORDS. THE LOCATIONS ARE SHOWN FOR INFORMATIONAL PURPOSES ONLY AND SHOULD BE FIELD VERIFIED PRIOR TO CONSTRUCTION.
- ALL SITE UTILITY WORK SHALL BE DONE IN ACCORDANCE WITH THE CITY STANDARD SPECIFICATIONS FOR PUBLIC WORKS CONSTRUCTION, LATEST
- CONTRACTOR SHALL OBTAIN ALL NECESSARY PLUGGING/CONNECTION PERMITS FROM THE CITY PRIOR TO ANY UTILITY WORK. CONTRACTOR TO NOTIFY THE PUBLIC WORKS DEPARTMENT A MINIMUM OF 48 HOURS BEFORE CONNECTING TO
- 4. PRIOR TO CONSTRUCTION, CONTRACTOR SHALL OBTAIN A STREET OPENING PERMIT FOR ANY WORK TO BE DONE WITHIN THE RIGHT-OF-WAY.
- RESTORATION OF PAVEMENT, CURB & GUTTER, AND SIDEWALK WITHIN THE STREET RIGHT OF WAY IS CONSIDERED INCIDENTAL AND SHALL BE INCLUDED IN THE COST OF THE UNDERGROUND IMPROVEMENTS.
- 6. ALL STORM SEWER PIPE TO BE SDR-35 PVC OR SCHEDULE 40 PVC AS NOTED.
- CONTRACTOR SHALL CONFIRM CONNECTION ELEVATION GRADES OF ALL PIPES
- 8. WATER MAIN SHALL BE DUCTILE IRON, CLASS 52.
- SANITARY SEWER SERVICES SHALL BE SDR-35 PVC.
- 10. ANY PERSON WHO INSTALLS A NONCONDUCTIVE WATER OR SEWER LATERAL MUST ALSO INSTALL A LOCATION WIRE OR OTHER EQUALLY EFFECTIVE MEANS FOR MARKING THE LOCATION OF THE LATERAL. METHOD SHALL BE APPROVED
- 11. CONTRACTOR TO COORDINATE NEW, RELOCATED AND/OR ABANDONED GAS, ELECTRIC, TELEPHONE, AND CABLE WITH APPROPRIATE UTILITY COMPANIES.
- 12. UTILITIES SERVING PROPOSED BUILDINGS SHALL BE STUBBED INTO THE PROPOSED BUILDING(S) A MIN. OF 5' AND STAKED.
- 13. ALL WATER MAIN PIPE AND FITTINGS SHALL BE INSTALLED TO A MIN. DEPTH OF COVER OF 6.5'. AFTER REGRADING, EXISTING WATER MAIN PIPE WHICH DOES NOT MEET THIS REQUIREMENT SHALL BE INSULATED.
- 14. STORM SEWERS WHICH CROSS AN ACTIVE SEWER OR WATER MAIN OR LATERAL SHALL HAVE A MINIMUM CLEAR VERTICAL CLEARANCE OF THREE (3) FEET.
 CROSSINGS WITH LESSER VERTICAL CLEARANCE SHALL BE PROTECTED FROM
 FROST DAMAGE BY PLACEMENT OF 2-INCH THICK POLYSTYRENE BOARD
- 15. BUILDING PLUMBER SHALL VERIFY SIZE, SLOPE, AND EXACT LOCATION OF PROPOSED SANITARY LATERALS AND WATER SERVICES PRIOR TO INSTALLATION.



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PROJECT INFORMATION

COSMOS -THE SPARK **PROJECTS**

800 E WASHINGTON AVE MADISON, WI





ISSUANCE AND REVISIONS

UDC Submittal (Revised)

DATE DESCRIPTION

SHEET INFORMATION

PROGRESS DOCUMENTS NOT FOR CONSTRUCTION

PROJECT NUMBER

UTILITY PLAN

12/21/16

		STRU	CTURE TABLE		
STRUCTURE NAME	SIZE	TOP OF CASTING	PIPES IN	PIPES OUT	CASTING
1.1 CB	4' DIA. CB	850.48	P3.1, 8" INV IN =845.46 P2.1, 12" INV IN =844.88 P1.2, 6" INV IN =845.63	P1.1, 15" INV OUT =844.88	NEENAH R-2050
1.2 CB	12" DIA YARD DRAIN	850.57		P1.2, 6" INV OUT =845.92	12" GRATE
2.1 ROOF	CONNECT TO INTERIOR ROOF DRAIN	851.00		P2.1, 12" INV OUT =845.03	
3.1 CB	12" DIA YARD DRAIN	850.26	P3.2, 8" INV IN =845.92	P3.1, 8" INV OUT =845.92	12" GRATE
3.2 CB	12" DIA YARD DRAIN	850.26	P4.1, 8" INV IN =846.27	P3.2, 8" INV OUT =846.27	12" GRATE
4.1 CB	12" DIA YARD DRAIN	850.44	P8.1, 6" INV IN =846.55	P4.1, 8" INV OUT =846.55	12" GRATE
5.1 EX INLET	CONNECT TO EX INLET	847.38	P5.1, 10" INV IN =846.50		
5.2 ROOF	CONNECT TO INTERIOR ROOF DRAIN	850.75		P5.1, 10" INV OUT =846.80	
6.1 EX INLET	CONNECT TO EX INLET	848.58	P6.1, 10" INV IN =847.70		
6.2 ROOF	CONNECT TO INTERIOR ROOF DRAIN	850.75		P6.1, 10" INV OUT =847.82	
7.1 EX INLET	CONNECT TO EX INLET	849.16	P7.1, 15" INV IN =843.90		
7.2 MH	4' DIA. CB	849.87	P7.2, 15" INV IN =844.03	P7.1, 15" INV OUT =844.03	NEENAH R-1550
7.3 MH	4' DIA. CB	850.28	P1.1, 15" INV IN =844.62	P7.2, 15" INV OUT =844.62	NEENAH R-1550
8.1 CB	3' DIA. CB	849.88		P8.1, 6" INV OUT =846.84	NEENAH R-2050

			PIP	E TABLE			
NAME	SIZE	LENGTH	SLOPE	MATERIAL	START INVERT ELEVATION	END INVERT ELEVATION	
P1.1	15"	52'	0.52%	ADS N12	844.88'	844.62'	
P1.2	6"	30'	0.98%	ADS N12	845.92'	845.63'	
P2.1	12"	28'	0.53%	ADS N12	845.03'	844.88'	
P3.1	8"	88'	0.52%	ADS N12	845.92'	845.46'	
P3.2	8"	69'	0.52%	ADS N12	846.27'	845.92'	SPARK
P4.1	8"	54'	0.52%	ADS N12	846.55'	846.27	<u> </u>
P5.1	10"	31'	0.98%	ADS N12	846.80'	846.50'	+
P6.1	10"	25'	0.50%	ADS N12	847.82'	847.70'	COSMOS
P7.1	15"	25'	0.52%	ADS N12	844.03'	843.90'	
P7.2	15"	114'	0.52%	ADS N12	844.62'	844.03'	
P8.1	6"	29'	1.00%	ADS N12	846.84'	846.55'	



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madison 30.9 West Johnson Street, Suite 202
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telephone 608, 442, 530



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PROJECT INFORMATION

COSMOS -THE SPARK **PROJECTS**

800 E WASHINGTON AVE MADISON, WI





ISSUANCE AND REVISIONS

UDC Submittal (Revised)


DATE DESCRIPTION

SHEET INFORMATION

PROGRESS DOCUMENTS NOT FOR CONSTRUCTION

PROJECT MANAGER	R
PROJECT NUMBER	1249
DATE	12/21/16

UTILITY PLAN

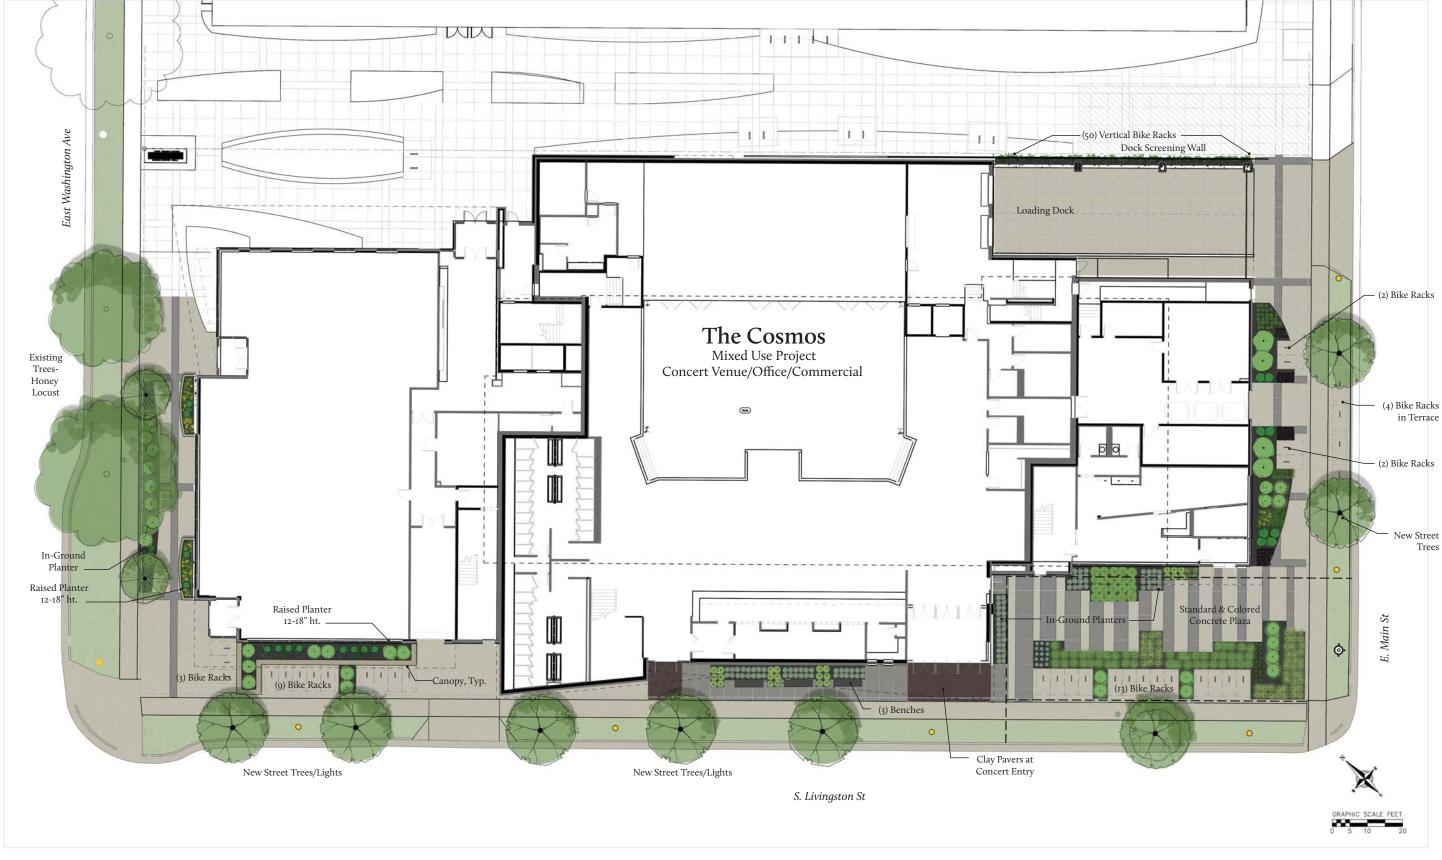

SITE PLAN

Urban Design Commission 12.21.2016


















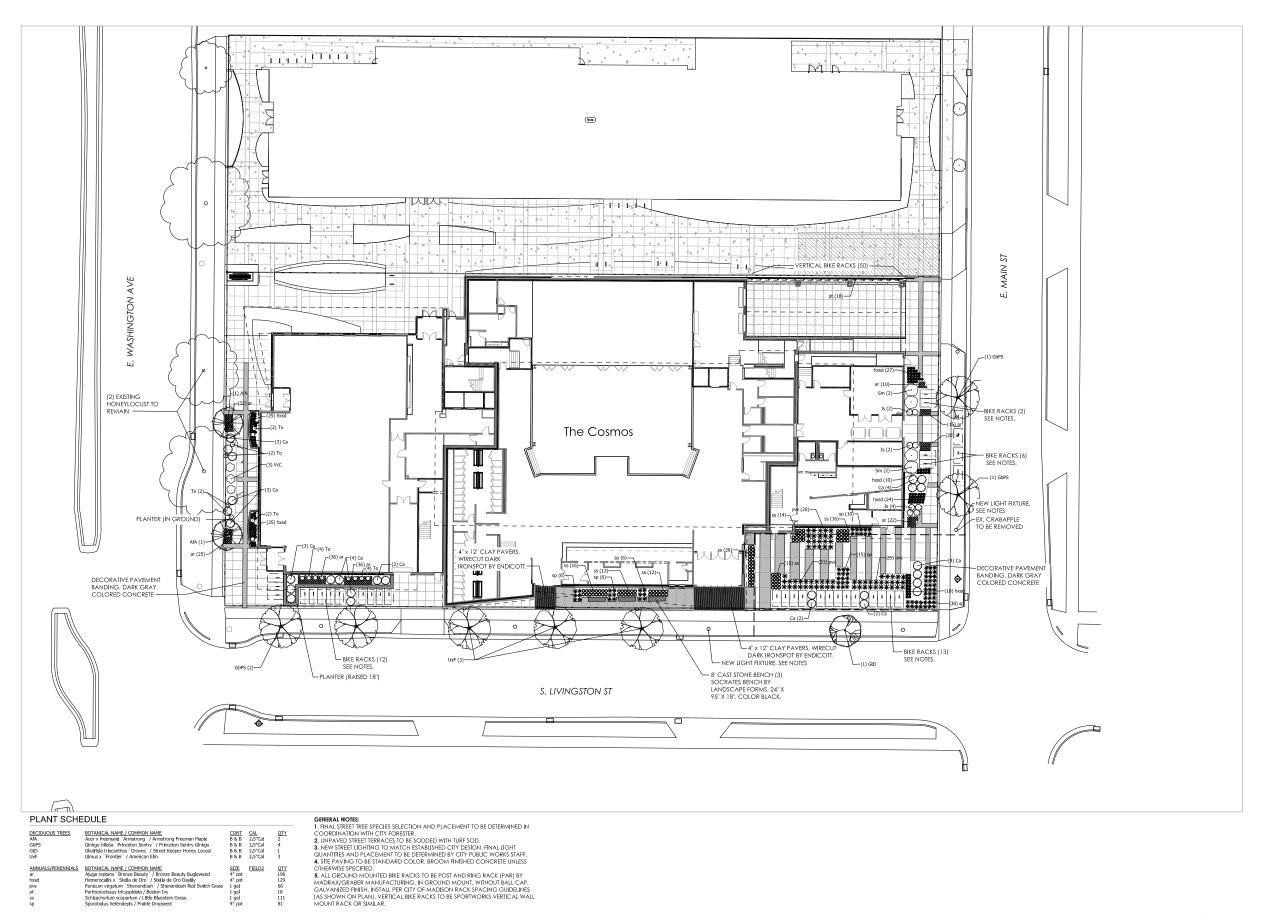

BOTANICAL NAME / COMMON NAME
Acer x freemanii 'Armstrong' / Armstrong Freeman Maple
Ginkgo biloba 'Princeton Sentry' / Princeton Sentry Ginkgo
Gledfisla trlacanthos 'Draves' / Street Keeper Honey Locust
Ulmus x 'Frontier' / American Elm

BOTANICAL NAME / COMMON NAME
Ajuga replans 'Bronze Beauty' / Bronze Beauty Bugleweed
Hemerocalis 'S 'Stella de Or 'O Stella de Or Daylily
Panicum virgatum' Shenandoah ', Shenandoah Red Switch Grass
Parthenoclassus Hickupsidah / Boston Iny
Schlachyrlum scoparlum / Little Bluestem Grass
Sporobolus heterolegis / Parille Tropspeed

Cotoneaster apiculatus / Cranberry Cotoneaster Syringa meyeri `Palibin` / Dwarf Korean Lilac Viburnum carlesii `Compactum` / Korean Spice Viburnum

SIZE FIELD2 4" pot 4" pot 1 gal 1 gal 1 gal 4" pot

SIZE FIELD2 3 gal 5 gal 3 gal

 SIZE
 FIELD2
 QTY

 3 gal
 8

 5 gal
 16

DECIDUOUS TREES

EVERGREEN SHRUBS





ARCHITECTURE ENGINEERING INTERIOR DESIGN

STRANG, INC. 6411 MINERAL POINT ROAD MADISON, WI 53705-4395

UDC Submittal (Revised)

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PROJECT NO.	2016090

PROJECT TITLE

GEBHARDT **DEVELOPMENT -**THE COSMOS PROJECT

801 E. WASHINGTON AVENUE MADISON, WISCONSIN 53703

SHEET NAME

LANDSCAPE PLAN





SHEET NO.


L101





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TN PN 1 FIRST FLOOR PLAN SCALE: 1" = 40' 0' 10' 20' 40'

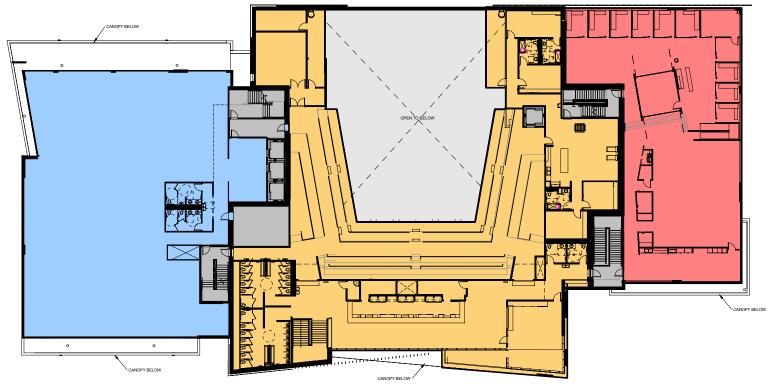

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801 E. WASHINGTON AVENUE MADISON, WISCONSIN 53703

SHEET NAME

LEGEND

<u>RETAI</u>L


OFFICE

MUSIC VENUE

SHARED SPACES (EXIT STAIRS, MECHANICAL SPACES) FLOOR PLANS

SHEET NO.


A201

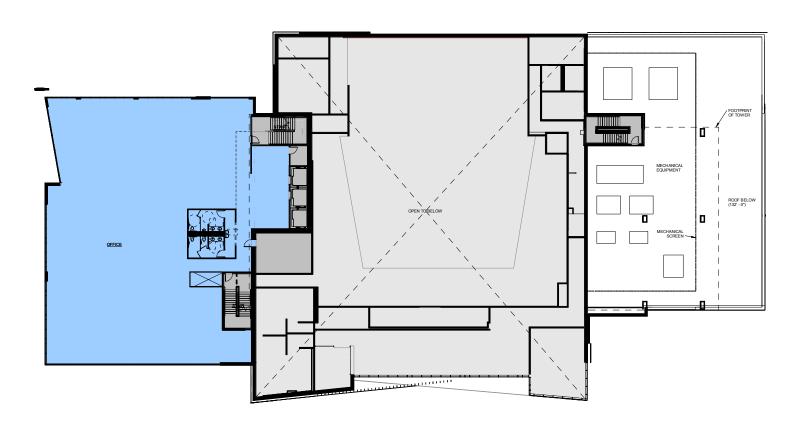



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THIRD FLOOR PLAN
SCALE: 1" = 40' 0'

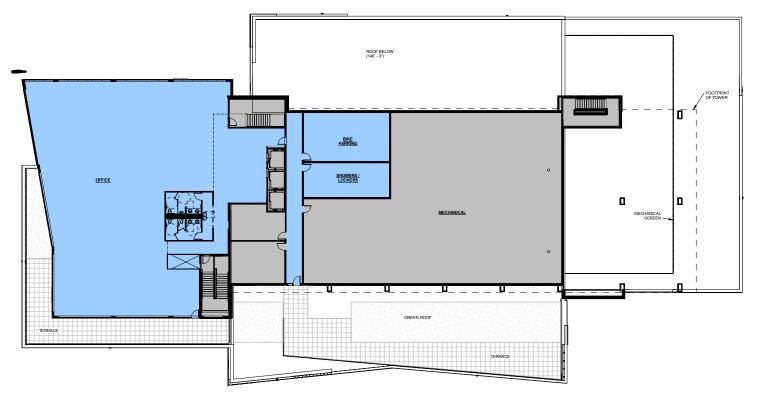

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PROJECT TITLE

LEGEND

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OFFICE

MUSIC VENUE

SHARED SPACES (EXIT STAIRS, MECHANICAL SPACES)

GEBHARDT DEVELOPMENT -THE COSMOS PROJECT

801 E. WASHINGTON AVENUE MADISON, WISCONSIN 53703

SHEET NAME


FLOOR PLANS

SHEET NO.

A202

FOURTH FLOOR PLAN

SCALE: 1" = 40' 0' 10'

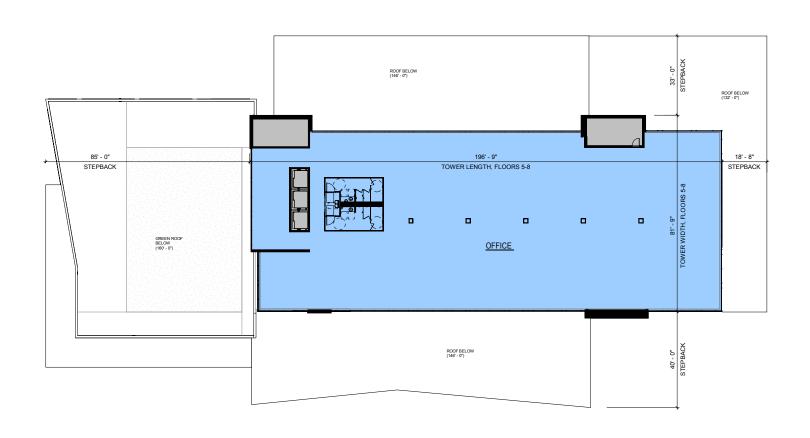




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5, 6, 7



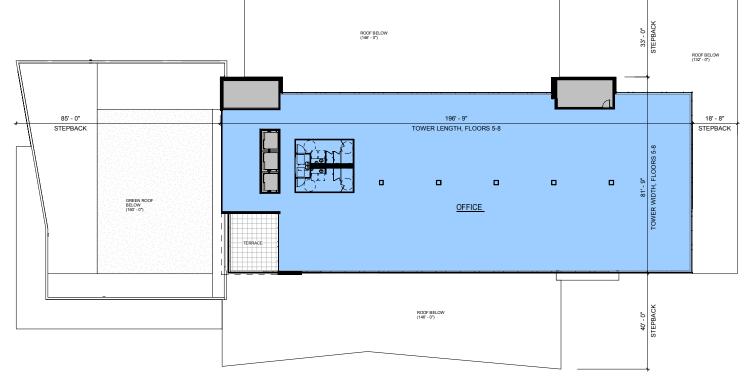

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801 E. WASHINGTON AVENUE MADISON, WISCONSIN 53703

SHEET NAME

LEGEND

<u>RETAI</u>L

OFFICE

MUSIC VENUE

SHARED SPACES (EXIT STAIRS, MECHANICAL SPACES)

FLOOR PLANS

SHEET NO.

A203

TN PN 6 TOWER FLOOR PLAN - 8









VIEW FROM N. LIVINGSTON / E. WASHINGTON AVE. (LOOKING SOUTH)





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12-21-20
201609

PROJECT NO.
PROJECT TITLE

GEBHARDT DEVELOPMENT -THE COSMOS PROJECT

MADISON, WISCONSIN 537

SHEET NAME
EXTERIOR
VIEWS

A901



VIEW FROM S. LIVINGSTON (LOOKING NORTH)





STRANG, INC. 6411 MINERAL POINT ROAD MADISON, WI 53705-4395

 DATE
 12-21-2016


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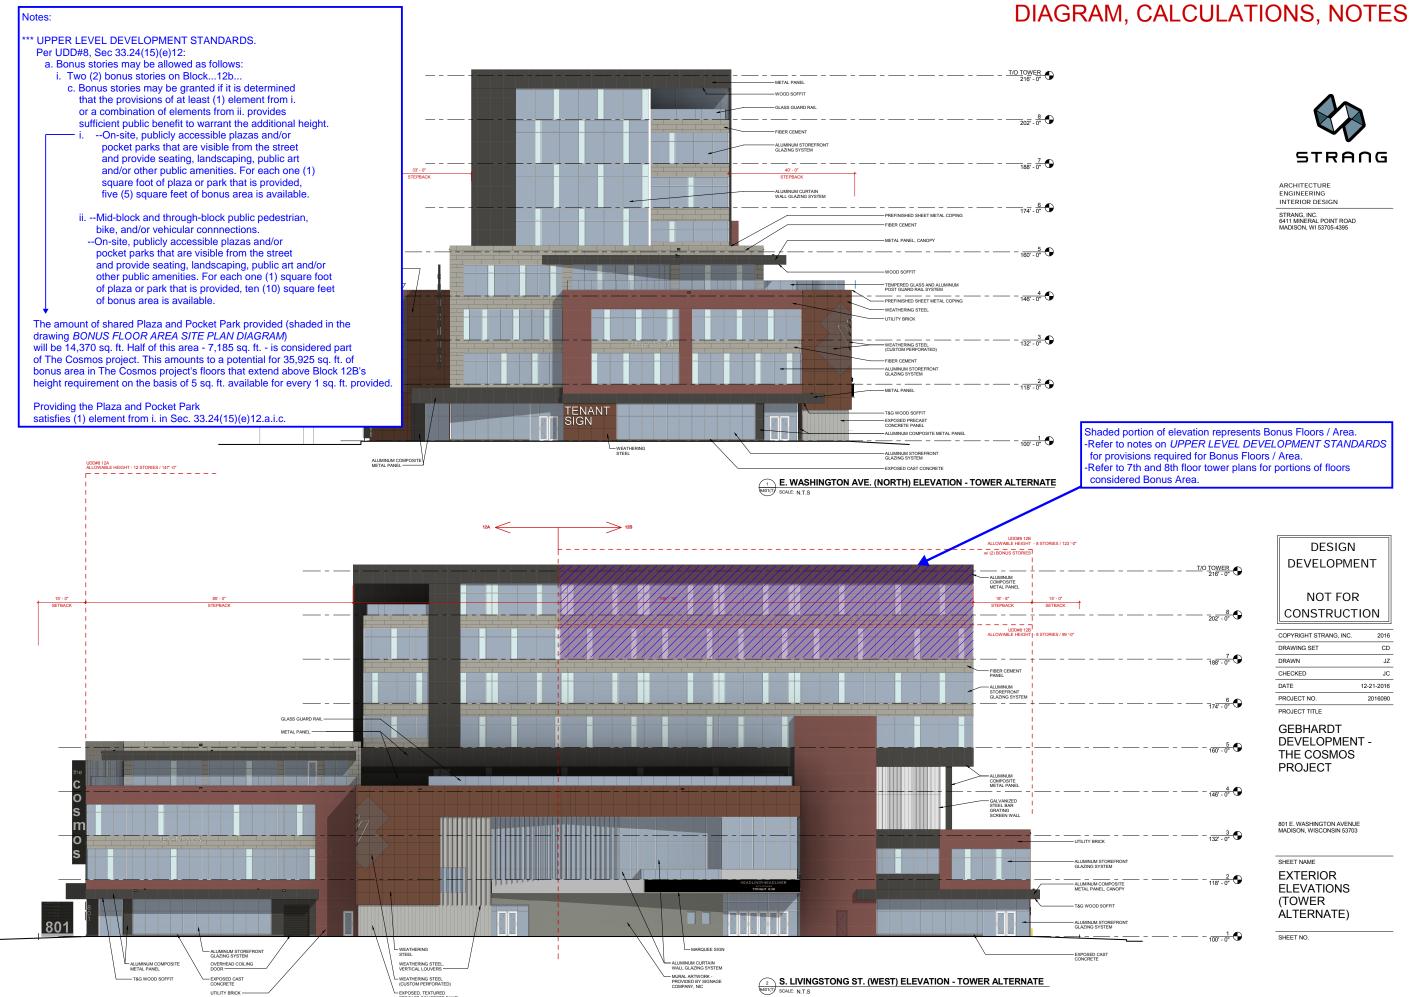
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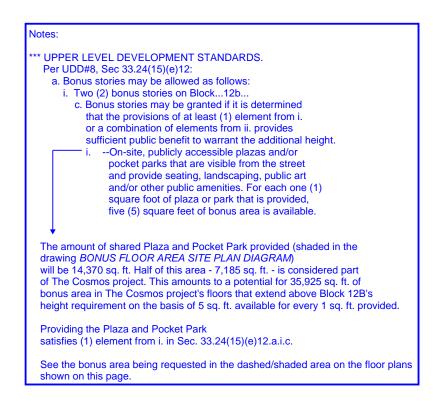
MADISON, WISCONSIN 5370


SHEET NAME
EXTERIOR
VIEWS





BONUS FLOORS / AREA DIAGRAM, CALCULATIONS, NOTES

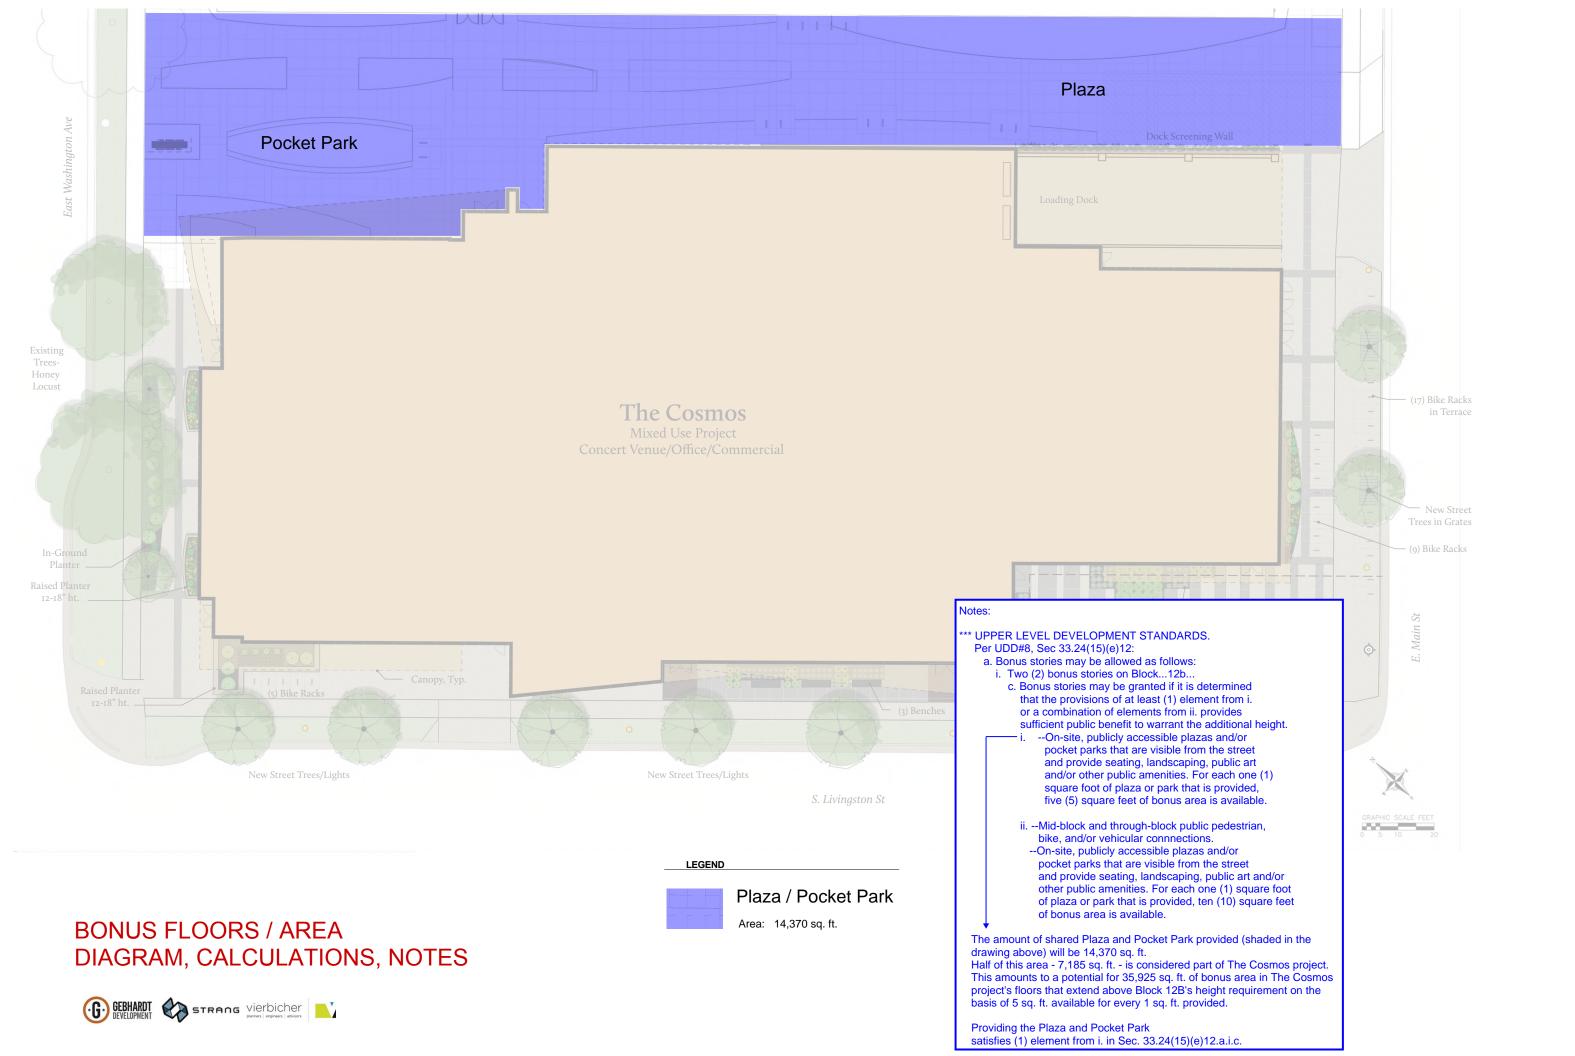

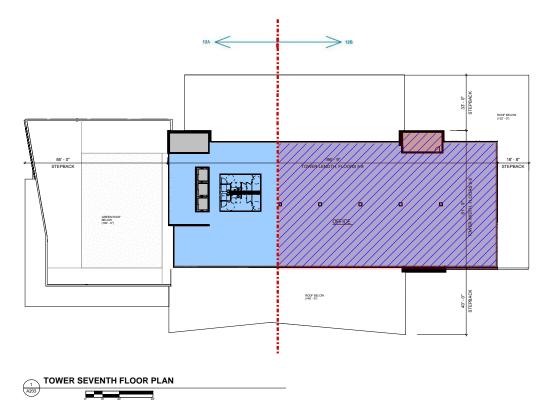

ARCHITECTURE ENGINEERING INTERIOR DESIGN STRANG, INC. 6411 MINERAL POINT ROAD MADISON, WI 53705-4395

LEGEND AND CALCULATIONS




Bonus Floor / Area

Bonus Area per Floor
7th Floor: 10,050 sq. ft.
8th Floor: 10,050 sq. ft.

Total: 20,100 sq. ft.

Allowed: 35,925 sq. ft

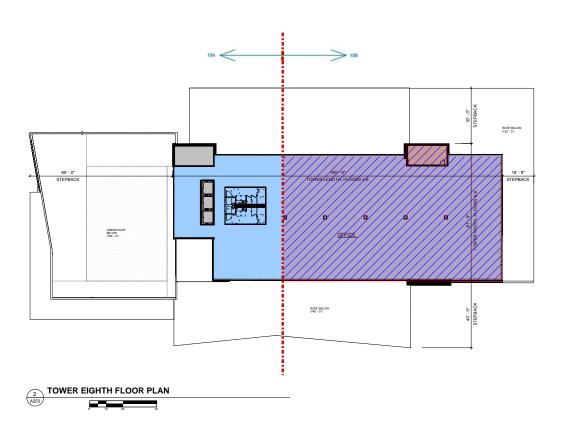

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SHEET NAME


BONUS STORY DIAGRAM

SHEET NO.

A204



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SITE LIGHTING PLAN
SCALE: 1" = 30'
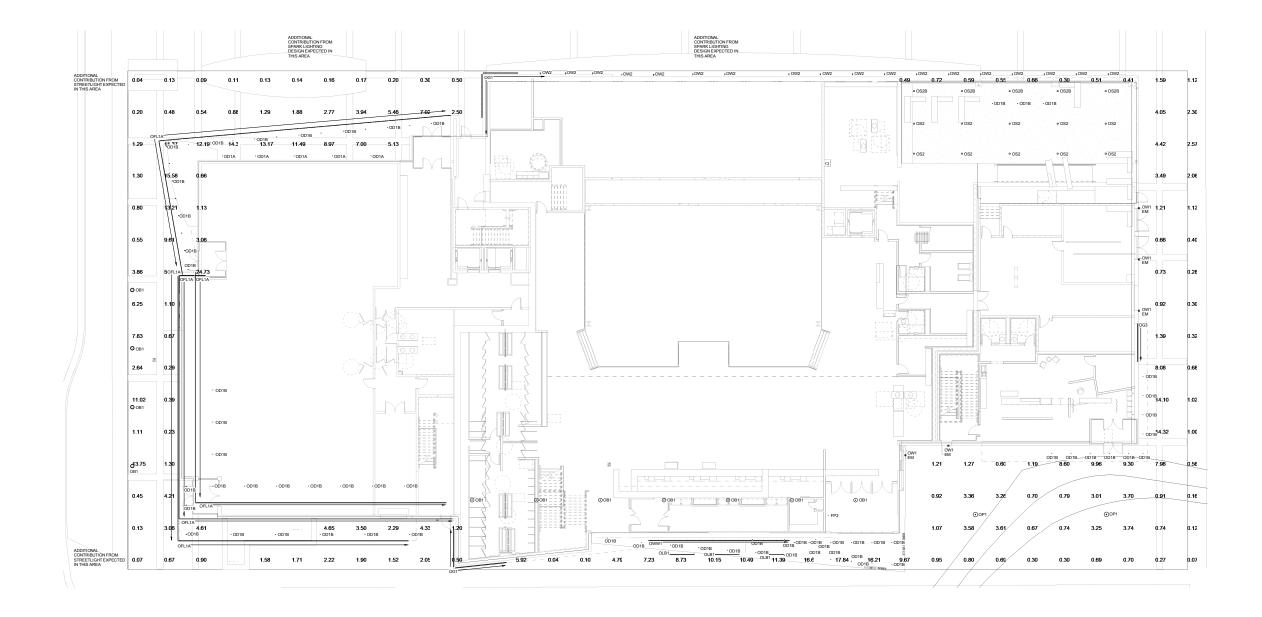
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SHEET NAME


ELECTRICAL SITE LIGHTING PLAN

SHEET NO.

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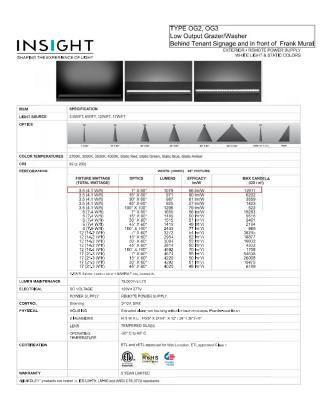


hsight Lighting www.insightighting.com August 16, 2016 11:24 AM


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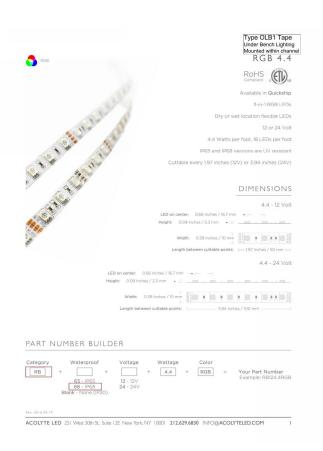
TYPE OG2, OG3

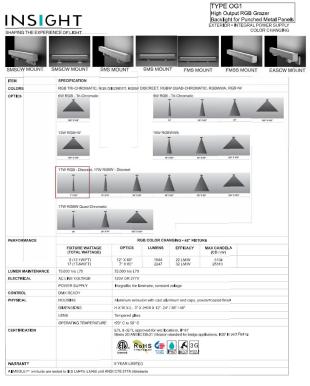







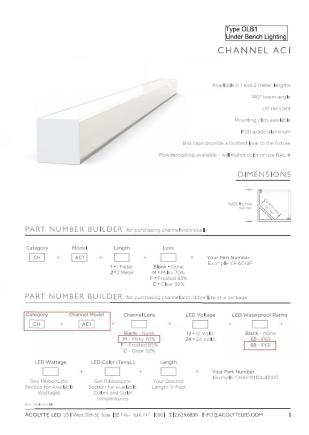

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PROJECT TITLE

GEBHARDT DEVELOPMENT -THE COSMOS **PROJECT**

801 E. WASHINGTON AVENUE MADISON, WISCONSIN 53703

SHEET NAME LIGHTING CUTS

SHEET NO.

E301

TYPE OLB1 **TYPE OLB1 TAPE**

TYPE OG1