



Site Aerial E. Washington Ave. Madison, WI







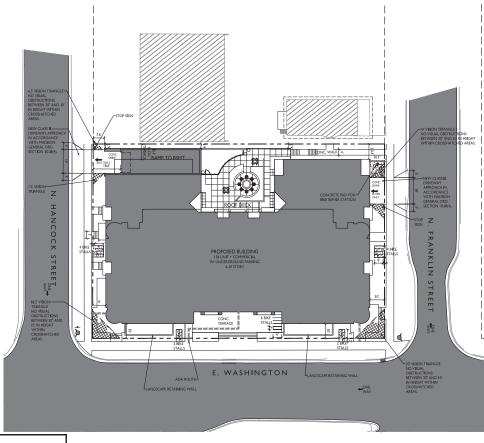

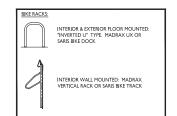

SHEET INDEX SITE G-1.1 G-1.3 G-1.4 G-1.5	SITE PLAN FIRE DEPARTMENT ACCESS LOT COVERAGE USABLE OPEN SPACE
C-0.1 C-1.0 C-2.0 C-3.0 C-4.0	NOTES AND LEGENDS EXISTING CONDITIONS DEMOLITION PLAN GRADING PLAN UTILITY PLAN
L-1.0 L-1.1	LANDSCAPE PLAN LANDSCAPE SCHEDULES
AGCHTECTURAL A1.F2 A1.F2 A1.F3	LANGERGALOW SCHEDULES LANDERGALOW PARKING LEVEL 1 HER TALOOR FLAN SECOND - STAFF LOOR FLAN SECOND - STAFF
A-3.12 A-3.13 A-3.14 A-3.15	HBGHT ILLUSTRATION 2 HBGHT ILLUSTRATION 3 SHADOW STUDY BUILDING SETBACK DIAGRAM
A-3.16	8 STORY ILLUSTRATION

GENERAL NOTES:

I. THE APPLICANT SHALL REPLACE ALL SIDEWALK AND CURB AND GUTTER THAT ABUTS THE PROPERTY THAT IS DAMAGED BY THE CONSTRUCTION, OR ANY SDEWALK AND CURB AND GUTTER WHICH THE CUTF RENDERE DETERMINES NEEDS TO BE REPLACED BECAUSE IT IS NOT AT DESTRABLE GRADE, RECADUSE OF WHETHER THE CONDITION BUSTED FROM TO BE GENOMING CONSTRUCTION.

2. ALL WORK IN THE PUBLIC RIGHT OF WAY SHALL BE PERFORMED BY A CITY-LICENSED CONTRACTOR.

3. ALL DAMAGE TO THE PAVEMENT ON CITY STREETS, AND ADJACENT TO THIS DEVELOPMENT SHALL BE RESTORED IN ACCORDANCE WITH THE CITY OF MADISON'S PAVEMENT PATCHING CRITERIA.

4. ALL PROPOSED STREET TIRE REMOVALS WITHIN THE BIGHT OF WAY SHALL BE REVEWED BY CITY FORESTIVE BROKE THE PLAN COMMISSION NEETING. STREET BEER REPOVALS REQUEST AFFORM, AND A TIERE REMOVALE STREET BROTE BY CITY FORESTIVE. ANY STREET THE REMOVALS REQUESTED AFFOR THE DEPOCHMENT OF ALL AND PROPOSED OF THE REMOVAL SEQUESTED AFFORM THE BOARD OF RUBLE WORKS AND CITY FORESTIX WILL BEQUEE A HIMMAND OF A ZEMOUS AND ALL STREET WILL BEQUEE A HIMMAND OF A ZEMOUS AND ALL STREET WILL BE AND A STREET WILL BE A STREET WILL BE AND A STREET WILL BE A STREET WI

S. AS GERNED BY THE RECTION 107.11 OF CITY OF MADRION STANDARD
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SECRETARION SECRETARION SECRETARION SECRETARION
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TO EXCAMATION. CITY OF MADRION CITY FRESCHORE, 1984, LAUGHS
TREE MIDITECTION SECRETARION CAN BE FOUND ON THE FOLLOWING
WHETHER THEST, PHYSICAL SECRETARION CAN BE FOUND ON THE FOLLOWING.

4 CONTRACTOR SHALL TAKE PREGAUTIONS DURING CONSTRUCTION TO NOT DISTURBER, SCALE OF DEPARTS HER BELLD OF ANY STREET THE CONTRACTOR. SHALL DISTURBER CAPITAL OF ORAT STREET THE CONTRACTOR SHALL DISTURBER CONTRACTOR. SHALL DISTURBER CONTRACTOR OF THE STREET THE SEAD CHEST OF THE STREET THE STREET THE STREET THE STREET THE STREET THE STREET STREET AND AT STREET THE STREET THE STREET STREET AND AT STREET THE STREET STREET AND AT STREET THE STREET AND AT STREET THE STREET S

7. SECTION 107.13(G) OF CITY OF MADBON STANDARD SECRICATIONS FOR PUBLIC WORKS CONSTRUCTION ADDRESSES SOL COMPACTION NEAR STREET. THESE AND SHALL BE LIQUIMED BY CONTRACTION THE STORAGE OF PHANKED VIRICLES. CONSTRUCTION EQUIPMENT, BULBRING MATERIALS, SERVIS EXCAVATED SHOULD KEN DIMENSOL OF SHORAGE SOLOR ADDRESSES OF SH

8. ON THE PROJECT, STREET TREE PROTECTION ZODE FEMALES. IS SEQUILED. THE FEMALES SHE REFECTED BEFORE THE DEPONLITION, GRADING OR CONSTRUCTION SEGINS. THE FEMALE SHALL INCLUDE THE ENTIRE WITHOUT OF THE STREET SHALL INCLUDE THE ENTIRE WITHOUT OF THE STREET SHALL INCLUDE THE ENTIRE WITHOUT OF THE OUTDISE DECO. OF THE TIER TRUININ, DO NOT SEMOVE THE FEMALES AND, DUTY OF DELIVERIES OR EQUIPMENT ACCESS TRACQUEST HERE PROTECTIONS OF THE PROTECTION STORY.

9. STREET TREE PRUNING SHALL BE COORDINATED WITH MADISON FORESTRY AT A MINIMUM OF TWO WEEKS PRIOR TO THE STRAT OF CONSTRUCTION FOR THIS PROJECT. ALL PRUNING SHALL FOLLOW THE AMERICAN NATIONAL STANDARDS INSTITUTE (ANS) A300 - PART I STANDARDS FOR PRUNING.

IO. THE PUBLIC RIGHT-OF-WAY IS THE SOLE JURISDICTION OF THE CITY OF MADBON AND IS SUBJECT TO CHANGE AT ANY TIME. NO ITEMS SHOWN ON THIS STEP AND IN THE RIGHT-OF-WAY ARE FERMANENT AND MAY NEED TO BE REMOVED AT THE APPLICANTS EXPENSE UPON NOTIFICATION BY THE CITY.

Knothe bruce

ISSUED Reissued for Land Use - June 10, 2020

PROJECT TITLE
THE
CONTINENTAL


414 E Washington Ave
SHEET TITLE
Site Plan

SHEET NUMBER

C-1.1

1972

Knothe & Bruce Architects, LLC

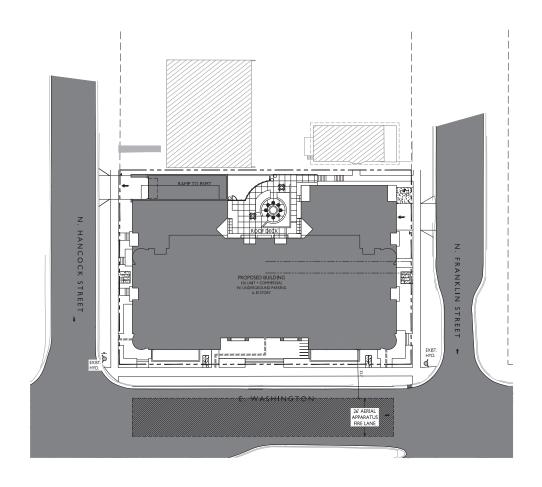










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PROJECT TITLE
THE
CONTINENTAL

414 E Washington Ave
SHEET TITLE
Fire Department
Access Plan

SHEET NUMBER

C-1.3



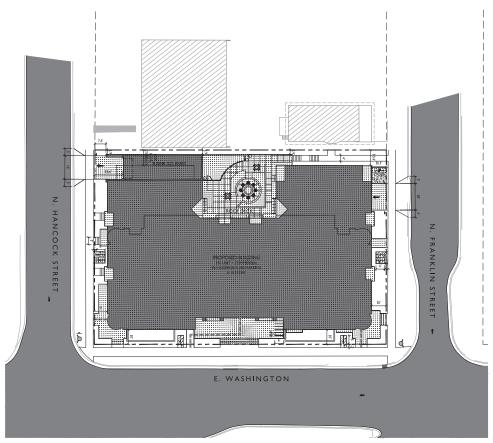

414 E Washington Ave SHEET TITLE Lot Coverage


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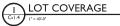
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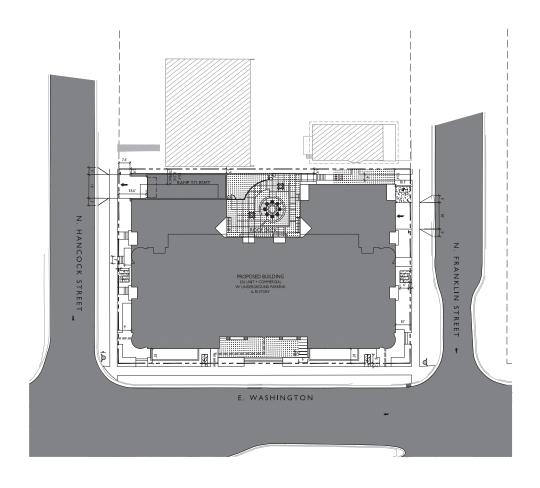
SHEET NUMBER

PROJECT NO. 1972







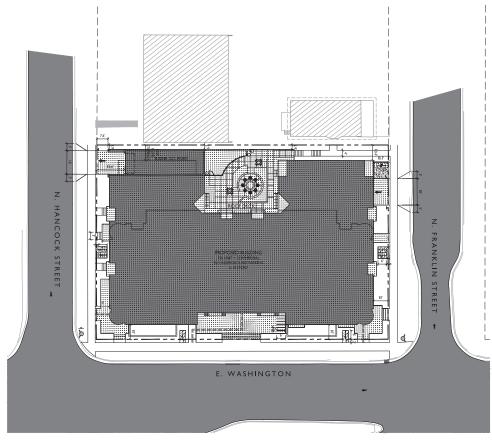



USABLE OPEN SPACE

ZONING: UNX

REQUIRED OPEN SPACE: 10 S.F. / BEDROOM

BEDROOMS: 196

10 S.K. 198 = 1,940 S.F. OPEN SPACE REQUIRED

OPEN SPACE PROVIDED:

BALCONIES: 40 S.F. K. 156 S.F. = 9,360 S.F.

ROOF DECKSTERRACE 436 S.F.

SURFACE 436 S.F.

TOTAL 16,167 S.F.

ISSUED Reissued for Land Use - June 10, 2020

PROJECT TITLE
THE
CONTINENTAL

414 E Washington Ave
SHEET TITLE
Usable Open
Space

SHEET NUMBER

PROJECT NO. 19



INSTALL A 50'L X 20'W X 1.5'D TRACKING PAD AT THE SITE ENTRANCE. THE TRACKING PAD SHALL BE MAINTAINED/REPAIRED AS NECESSARY TO ACCOMMODATE CONSTRUCTION.

- THE CONTRACTOR IS REQUIRED TO MAKE EROSION CONTROL INSPECTIONS AT THE END OF EACH WEEK AND WHEN 0.5 INCHES OF RAIN FALLS WITHIN 24 HOURS. INSPECTION REPORTS SHALL BE PREPARED AND FILED AS REQUIRED BY THE DNR. ALL MAINTENANCE/REPAIR WILL FOLLOW AN INSPECTION WITHIN 24 HOURS.
- UTILITY STRUCTURE RIM AND TOP OF CURB ELEVATIONS ON PLANS ARE APPROXIMATE. UTILITY STRUCTURES SHALL BE SET TO FINAL ELEVATIONS AFTER THE CURB & GUTTER AND BASE COURSE HAVE BEEN INSTALLED.
- THE CONTRACTOR IS RESPONSIBLE FOR ANY DAMAGE CAUSED DURING CONSTRUCTION TO PUBLIC PROPERTY, PRIVATE PROPERTY OR UTILITIES.
- THE CONTRACTOR SHALL SUBMIT SHOP DRAWINGS FOR REVIEW BY THE ENGINEER, PRIOR TO PLACING AN ORDER OF ANY SUCH ITEM.
- EXISTING TOPOGRAPHIC INFORMATION IS BASED ON FIELD OBSERVATIONS AND/OR PLAN OF RECORD DRAWNIGS. CONTRACTOR SHALL VERIFY TOPOGRAPHIC INFORMATION PRIOR TO STARTING CONSTRUCTION.
- CONTRACTOR SHALL FIELD VERFY LOCATION OF EXISTING SANTARY SWARE, STORM SEVER AND MATER MAN PROFIT TO CONTRIBUTION TO BESIDE PROPER CLARACE OF THE UTILITIES, CONTRACTOR MIGHT TAKE ALL INCESSARY PRECAUTIONS TO PROTECT THE RESISTING UTILITIES DURING CONSTRUCTION. ANY DAMAGE TO THE EXISTING UTILITIES AND ANY REPARTS NEEDED AS A RESULT OF THE DAMAGE SHALL BE AT THE EXPENSE OF THE CONTRINCTOR REGARDLESS OF THE LOCATION MARKED IN THE FIELD OR SHOWN ON THE
- THE LOCATIONS OF EXISTING UTILITY INSTALLATIONS AS SHOWN ON THE PLAN ARE APPROXIMATE. THERE MAY BE OTHER UTILITY INSTALLATIONS WITHIN THE PROJECT AREA THAT ARE NOT SHOWN. CONTRACTOR SHALL BE RESPONSIBLE FOR CONTACTING DIGGER HOTLINE AND LOCATING ALL EXISTING UTILITIES AND ENSURE PROPER CLEARANCE OF NE UTILITIES.
- SEE DETAIL SHEETS FOR EROSION CONTROL NOTES AND CONSTRUCTION SEQUENCE.
- 10. THE CONTRACTOR SHALL REMOVE ANY SEDIMENT TRACKED ONTO ADJACENT ROADS BY MEANS OF STREET SWEEPING (NOT FLUSHING) AT A MINIMUM OF THE END OF EACH WORK DAY OR MORE AS NEEDED.
- RIGHT OF WAY (ROW) AND PROPERTY LINES ARE APPROXIMATE. CONTRACTOR SHALL BE RESPONSIBLE FOR PROTECTING ENSITING PROPERTY CORNET MONUMENTATION. ANY MONUMENTS DISTURBED BY CONTRACTOR SHALL BE REPLACED AT THE CONTRACTORS EXPENSE.
- 12. CONTRACTOR SHALL COORDINATE WITH DRY UTILITY COMPANY'S REGARDING ANY POTENTIAL CONFLICTS AND COORDINATE RELOCATIONS AS MAY BE REQUIRED. CONTRACTOR SHALL ALSO COORDINATE THE PROPOSED INSTALLATION OF NEW FACILITIES
- 13. INSTALL WATER MAIN AT ADEQUATE DEPTH (MIN 6.5' OF COVER) TO AVOID CONFLICT WITH PROPOSED SANITARY SEWER AND STORM SEWER PER DNR STANDARDS EXCEPT WHERE NOTED ON THE PLANS. MAINTAIN MINIMUM 1.5' CLEAR SEPARATION IF WATER CROSSES
- SANITARY MANHOLES WITH SEWER MAIN CONNECTIONS GREATER THAN 2' ABOVE THE LOWEST INVERT SHALL BE CONSTRUCTED WITH AN EXTERNAL DROP. MANHOLES WITH SEWER LATERAL CONNECTIONS GREATER THAT 2' ABOVE THE LOWEST INVERT SHALL BE CONSTRUCTED WITH AN INTERNAL DROP.
- INSTALL 1 SHEET OF 4'x8'x4" HIGH DENSITY STYROFOAM INSULATION AT ALL LOCATIONS WHERE STORM SEWER CROSSES WATER MAIN OR WATER LATERALS.
- 16. DIMENSIONS RELATING TO CURB ARE TO FACE OF CURB.
- CONTOURS ARE SHOWN FOR PURPOSES OF INDICATING ROUGH GRADING. FINAL GRADES SHALL BE ESTABLISHED ON PAVED SURFACES BY USING SPOT GRADES ONLY.
- 18. CROSS-SLOPE OF SIDEWALKS SHALL BE 2% UNLESS OTHERWISE NOTED
- LONGITUDINAL GRADE OF SIDEWALK RAMPS SHALL NOT EXCEED 8.33% (1:12) AND SHALL BE IN ACCORDANCE WITH ADA REQUIREMENTS.
- LONGITUDINAL GRADE OF SIDEWALK SHALL NOT EXCEED 5.0% OR THE ADJACENT STREET GRADE WHICHEVER IS GREATER.
- 21. ACCESSIBLE ROUTES SHALL BE 5% MAX LONGITUDINAL SLOPE AND 2% MAX CROSS SLOPE. ACCESSIBLE LOADING AREAS OR LANDINGS SHALL BE 2% MAX SLOPE IN ANY DIRECTION. RAMPS SHALL BE 8.3% MAX SLOPE.
- 22. ADJUST ALL EXISTING MANHOLE AND VALVE RIMS TO FINAL GRADE.

- CONCRETE SIDEWALK TO BE 5" THICK, CONSTRUCTED ON A BASE OF 4" COMPACTED SAND OR CRUSHED STONE.
- CONCRETE FOR DRIVEWAYS AND SIDEWALK AT DRIVEWAY ENTRANCES SHALL BE 7" THICK, CONSTRUCTED ON A BASE OF 5" COMPACTED SAND OR CRUSHED STONE.
- 3. CURB FACE HEIGHT ON SITE SHALL BE 6 INCHES.
- CONTRACTOR TO OBTAIN ANY NECESSARY UTILITY CONNECTION, DEMOLITION, DRIVEWAY CONNECTION, RIGHT-OF-WAY AND EXCAVATION PERMITS PRIOR TO CONSTRUCTION.
- CONTOURS ARE SHOWN FOR PURPOSES OF INDICATING ROUGH GRADING. FINAL GRADE SHALL BE ESTABLISHED ON PAVED SURFACES BY USING SPOT GRADES ONLY.
- ANY SIDEWALK AND CURB & QUITER ABUITING THE PROPERTY SHALL BE REPLACED IF IT IS DAHAGED DURING CONSTRUCTION OR IF THE CITY ENGINEERING DEPARTMENT DETERMINES THAT IT IS NOT AT A DESTRABLE GRADE, REGARDLESS OF WHETHER THE CONDITION EXISTED PRIOR TO BEGINNING CONSTRUCTION.

UTILITY NOTES:

- SANITARY & STORM SEWER LENGTHS SHOWN ARE FROM CENTER OF STRUCTURE TO CENTER OF STRUCTURE. STORM SEWER END SECTIONS ARE INCLUDED IN THE LENGTH AND SLOPE OF THE PIPE.
- 2. CONTRACTOR SHALL INVESTIGATE ALL UTILITY CROSSINGS PRIOR TO CONSTRUCTION AND NOTIFY ENGINEER OF ANY CONFLICTS.
- CONTRACTOR SHALL BE RESPONSIBLE FOR ADJUSTING ALL UTILITY STRUCTURES (MANHOLE RIMS, WATER VALVES, AND CURB STOPS), IF NECESSARY.
- CONTRACTOR SHALL OBTAIN ANY NECESSARY WORK IN RIGHT-OF WAY, EXCAVATION, UTILITY CONNECTION, PLUGGING, ABANDONMENT, AND DRIVEWAY CONNECTION PERMITS PRIOR TO CONSTRUCTION.
- FOR ALL SEWER AND WATER MAIN CROSSINGS: PROVIDE MINIMUM 18" SEPARATION WHEN WATER MAIN CROSSES BELOW SEWER AND MINIMUM 6" SEPARATION WHEN WATER MAIN CROSSES ABOVE SEWER.
- IF DEWATERING OPERATIONS EXCEED 70 GALLONS PER MINUTE OF PUMPING CAPACITY, A DEWATERING WELL PERMIT SHALL BE OBTAINED FROM THE DEPARTMENT PRIOR TO STARTING ANY DEWATERING ACTIVITIES.
- A COPY OF THE APPROVED UTILITY PLANS, SPECIFICATIONS AND PLUMBING PERMIT APPROVAL LETTER SHALL BE ON-STIE DURING CONSTRUCTION AND OPEN TO INSPECTION BY AUTHORIZED REPRESENTATIVES OF THE DEPARTMENT OF SAFETY AND PROFESSIONAL SERVICES AND OTHER LOCAL INSPECTOR.
- 8. STORM BUILDING SEWER PIPE SHALL CONFORM TO ONE OF THE STANDARDS LISTED IN TABLE 384.30-6 OF
- 9. PRIVATE WATER SERVICES AND PRIVATE WATER MAINS SHALL CONFORM TO ONE OF THE STANDARDS LISTED IN TABLE 384.30-7 OF SPS 384.30(4)(d).
- 10. PRIVATE SANITARY SEWER AND LATERALS SHALL BE POLYVINYL CHLORIDE (PVC) ASTM D3034 SDR 35 APPROVED EQUAL MATERIAL THAT CONFORMS TO ONE OF THE STANDARDS LISTED IN TABLE 384.30-3 OF SPS 384.30(2)(c).
- 11. A MEANS TO LOCATE BURED UNDERGROUND EXTERIOR NON METALLIC SEWERS/MAINS AND WATER SERVICES/MAINS MUST BE PROVIDED WITH TRACER WIRE OR OTHER METHODS IN ORDER TO BE LOCATED PER SPS 382:10(11)(n) AND SPS 382:40(6)(k).
- 12. EXTERIOR WATER SUPPLY PIPING SETBACKS AND CROSSINGS SHALL BE IN ACCORDANCE WITH SPS
- NO PERSON MAY ENGAGE IN PLUMBING WORK IN THE STATE UNLESS LICENSED TO DO SO BY THE DEPARTMENT OF SAFETY AND PROFESSIONAL SERVICES PER S.145.06.
- 14. SITE CONTRACTOR SHALL LEAVE SANITARY AND WATER LATERALS FIVE (5) FEET SHORT (HORIZONTALLY) FROM THE BUILDING. BUILDING PLUMBER SHALL VERIFY SIZE, LOCATION, AND INVERT ELEVATION OF PROPOSED SANITARY AND WATER LATERALS.
- 15. CONTRACTOR SHALL FIELD VERIFY THE SIZE, TYPE, LOCATION, AND ELEVATION OF EXISTING UTILITIES PRIOR TO INSTALLING ANY ON—SITE UTILITIES OR STRUCTURES. CONTACT ENGINEER PRIOR TO INSTALLATION IF DISCREPANCY EXISTS WITHIN THESE PLANS.
- 16. PROPOSED LITILITY SERVICE LINES SHOWN ARE APPROXIMATE. COORDINATE THE EXACT LOCATIONS WITH THE PROPOSED UTILITY SERVICE LINES SHOWN ARE AFFORMANCE. COORDINATE THE EAST LOCATIONS WITH PLUMBING DRAWNIGS. COORDINATE THE LOCATIONS WITH THE PLUMBING CONTRACTOR AND/OR OWNER'S CONSTRUCTION REPRESENTATIVE PRIOR TO INSTALLATION OF ANY NEW UTILITIES.
- 17. CONTRACTOR SHALL BE RESPONSIBLE FOR COORDINATING THE RELOCATION OF ANY UTILITIES ENCOUNTERED AND REPLACEMENT OF ANY UTILITIES DAMAGED WITHIN INFLUENCE ZONE OF NEW CONSTRUCTION. CONTACT ENGINEER IF THE EXISTING UTILITIES VARY APPRECIABLY FROM THE PLANS.
- 18. ALL WATER MAIN AND SERVICES SHALL BE INSTALLED AT A MINIMUM DEPTH OF 6.5' FROM TOP OF FINISHED GROUND ELEVATION TO TOP OF MAIN.
- 19. IT IS THE CONTRACTOR'S RESPONSIBILITY TO VERIFY THAT THE EXISTING VALVES WILL HOLD THE PRESSURE TEST PRIOR TO CONNECTION. THE CITY IS NOT RESPONSIBLE FOR ANY COSTS INCURRED DUE TO THE CONTRACTOR NOT VERIFYING THAT THE EXISTING VALVE WILL HOLD THE PRESSURE TEST PRIOR TO CONNECTION. IF A NEW VALVE IS REQUIRED, THE APPLICANT WILL BE REQUIRED TO INSTALL ONE AT THEIR EXPENSE, AT THE POINT OF CONNECTION.
- 20. CLEAN OUT ALL EXISTING AND PROPOSED STORM INLETS AND CATCH BASINS AT THE COMPLETION OF CONSTRUCTION.

DEMOLITION/EROSION CONTROL NOTES:

- CONTRACTOR SHALL KEEP ALL CITY STREETS FREE AND CLEAR OF CONSTRUCTION RELATED DIRT/DUST/DEBRIS.
- COORDINATE EXISTING UTILITY REMOVAL/ABANDONMENT WITH LOCAL AUTHORITIES AND UTILITY COMPANIES HAVING JURISDICTION.
- 3. ALL SANGUTING SHALL BE FULL DEPTH TO PROVIDE A CLEAN EDGE TO MATCH NEW CONSTRUCTION. MATCH EXISTING ELEVATIONS AT FORMS OF CONNECTION FOR NEW AND LESTING PACKENT, CUBB. SIGNEMAKS, ETC. ALL SANGUT LOCATIONS SHOWN ARE APPROXIMATE AND MAY BE FIELD ADJUSTED TO ACCOMMODATE. CONDITIONS, JOINTS, MATERIAL TYPE, ETC. REVIEW MINIMUM. AMOUNT NECESSARY FOR INSTALLATION OF
- CONTRACTOR SHALL PROVIDE AND SHALL BE RESPONSIBLE FOR ANY NECESSARY TRAFFIC CONTROL SIGNAGE AND SAFETY MEASURES DURING DEMOLITION AND CONSTRUCTION OPERATIONS WITHIN OR NEAR THE PUBLIC ROADWAY.
- COORDINATE TREE REMOVAL WITH LANDSCAPE ARCHITECT. ALL TREES TO BE REMOVED SHALL BE REMOVED IN THEIR ENTIRETY AND STUMPS SHALL BE GROUND TO 12" BELOW PROPOSED SUBGRADE. IF APPLICABLE, PROVIDE TREE PROTECTION FENCING PRIOR TO CONSTRUCTION OPERATIONS. MAINTAIN THROUGHOUT CONSTRUCTION.
- ALL LIGHT POLES TO BE REMOVED FROM PRIVATE PROPERTY SHALL BE REMOVED IN THEIR ENTIRETY, INCLUDING BASE AND ALL APPURTENANCES. COORDINATE ABANDONMENT OF ELECTRICAL LINES WITH ELECTRICAL ENGINEER AND OWNER PRIOR TO DEMOLITION.
- 8. CONTRACTOR SHALL OBTAIN ANY NECESSARY DEMOLITION AND UTILITY PLUGGING PERMITS.
- 9. THE LOCATION OF EXISTING UNDERGROUND UTILITIES AS SHOWN ON THE PLANS HAS BEEN DETERMINED FROM THE BEST AVAILABLE INFORMATION AND IS GIVEN FOR THE CONVENIENCE OF THE CONTRACTOR. THE OWNER AND THE ENORMER DO NOT ASSUME RESPONSIBILITY IN THE EVENT THAT DURING CONSTRUCTION, UTILITIES OTHER THAN THOSE SHOWN MAY BE ENCOUNTERED, AND THAT THE ACTUAL LOCATION OF THOSE WHICH ARE SHOWN MAY BE DIFFERENT FROM THE LOCATION AS SHOWN ON THE PLANS.
- ANY DAMAGE TO THE CITY PAVEMENT, INCLUDING DAMAGE RESULTING FROM CURB REPLACEMENT, WILL REQUIRE RESTORATION IN ACCORDANCE WITH THE CITY ENGINEERING PATCHING CRITERIA.

SURVEY LEGEND

- @ BENCHMARK
- x FOUND CHISELED "X"
- ⊗ FOUND 2" ø IRON PIPE
- ▲ FOUND P.K. NAIL
- FOUND 1 1/4" Ø IRON ROD ● FOUND 3/4" ø IRON ROD
- SFT NAII

TOPOGRAPHIC SYMBOL LEGEND

- EXISTING BOLLARD
- EXISTING MAILBOXES
- **"EXISTING MONITORING WELL**
- EXISTING POST
- * EXISTING SIGN EXISTING PARKING METER
- EXISTING CURB INLET
- EXISTING ROOF DRAIN
- EXISTING STORM MANHOLE
- EXISTING STORM MANHOLE RECTANGULAR
- & EXISTING SANITARY CLEANOUT
- T EXISTING FIRE HYDRANT EXISTING WATER MAIN VALVE
- EXISTING CURB STOP
- EXISTING WATER MANHOLE
- M EXISTING GAS VALVE
- EXISTING GAS METER
- EXISTING DOWN GUY
- EXISTING ELECTRIC RECTANGULAR MANHOLE

 EXISTING ELECTRIC METER
- # EXISTING LIGHT POLE EXISTING UTILITY POLE
- M EXISTING TV PEDESTAL
- EXISTING TELEPHONE PEDESTAL
- **Θ** EXISTING UNIDENTIFIED MANHOLE EXISTING SHRUB
- O EXISTING DECIDUOUS TREE

TOPOGRAPHIC LINEWORK LEGEND

- " EXISTING FIBER OPTIC LINE EXISTING WOOD FENCE EXISTING GAS LINE
- « EXISTING UNDERGROUND ELECTRIC LINE - ON - ON - EXISTING OVERHEAD GENERAL UTILITIES
- sr sr EXISTING STORM SEWER - sru - sru - EXISTING 12" STORM SEWER LINE
- ST 8 ST 8 EXISTING 15" STORM SEWER LINE
- EXISTING WATER SERVICE
- EXISTING 6" WATER MAIN
- 820 EXISTING MAJOR CONTOUR --- 818 --- EXISTING MINOR CONTOUR

TOPOGRAPHIC HATCHING LEGEND DETECTABLE WARNING PAVER

- CONCRETE PAVEMENT OR CONCRETE SIDEWALK ASPHALT PAVEMENT
 - CONRETE WALL

— −820 — EXISTING MAJOR CONTOURS EXISTING MINOR CONTOURS 820 - PROPOSED MAJOR CONTOURS 2.92% PROPOSED SLOPE ARROWS ф-1048.61 EXISTING SPOT ELEVATIONS

GRADING LEGEND

1048.61 PROPOSED SPOT ELEVATIONS ٥ INLET PROTECTION — SILT FENCE

- - DISTURBED LIMITS \Longrightarrow DRAINAGE DIRECTION EROSION MAT CLASS 1, TYPE A

TRACKING PAD

PROPOSED UTILITY LEGEND WATER SERVICE LATERAL PIPE SANITARY SEWER LATERAL PIPE — ø — ø — GAS MAIN

> ABBREVIATIONS STMH — STORM MANHOLE FI = FIELD INLET CI = CURB INLET CB = CATCH BASIN EW = ENDWALL SMH = SANITARY MANHOL

- or - or - ELECTRIC SERVICE

DEMOLITION PLAN LEGEND



X UTILITY STRUCTURE REMOVAL *- UTILITY LINE REMOVAL

SITE PLAN LEGEND PROPERTY BOUNDARY CURB AND GUTTER (REVERSE CURB HATCHED) PROPOSED CONCRETE PROPOSED SIGN

PROPOSED LIGHT POLE

PROPOSED ADA DETECTABLE WARNING FIELD

PROPOSED BOLLARD

ABBREVIATIONS

gton Avenue Legends ∞ŏ Votes Cont he # # AS SHOWN

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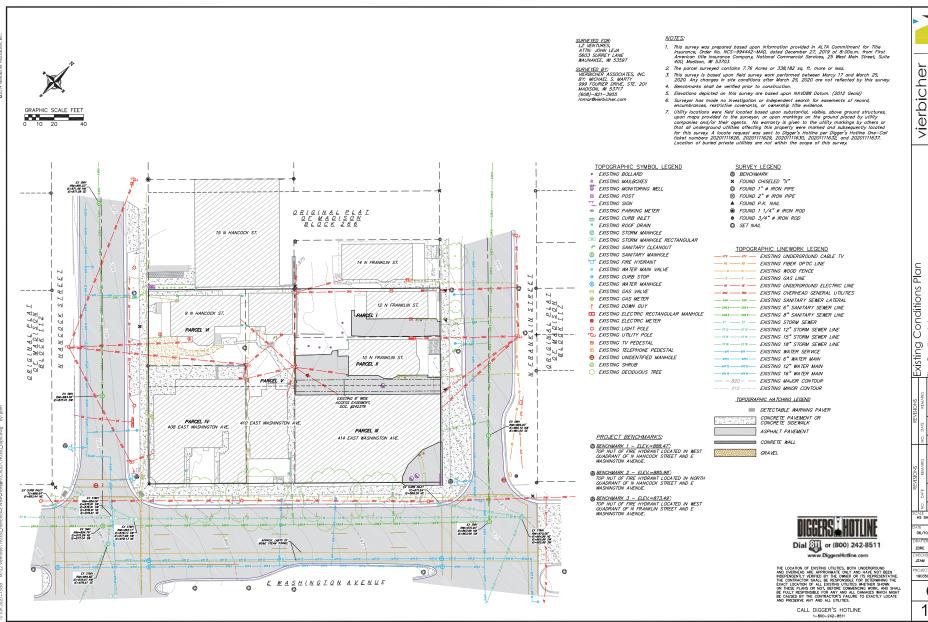
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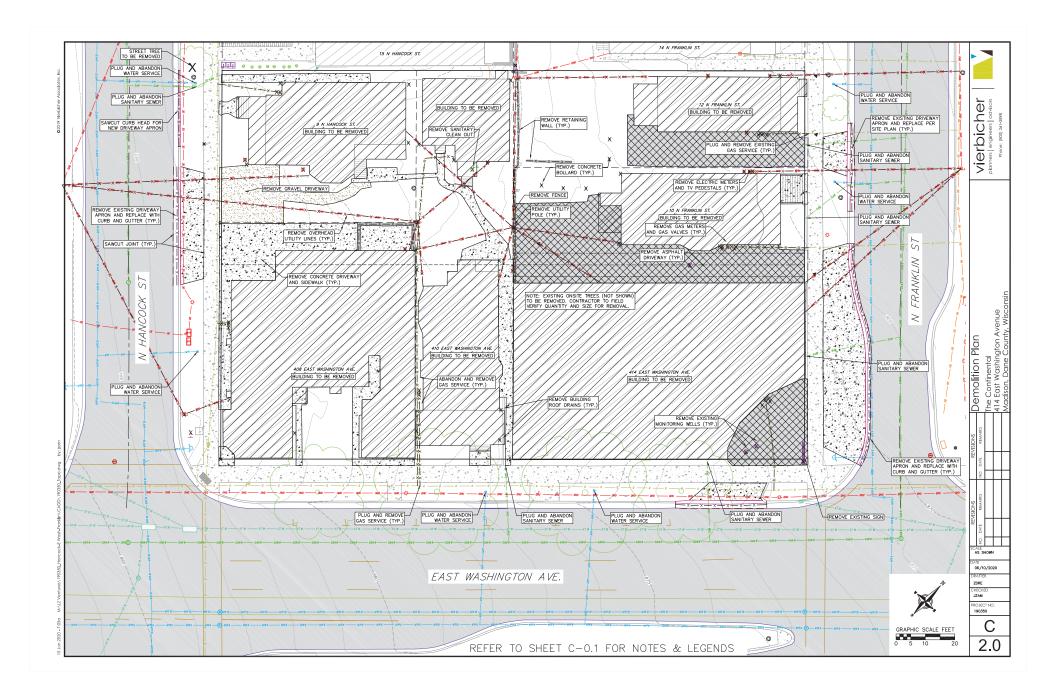



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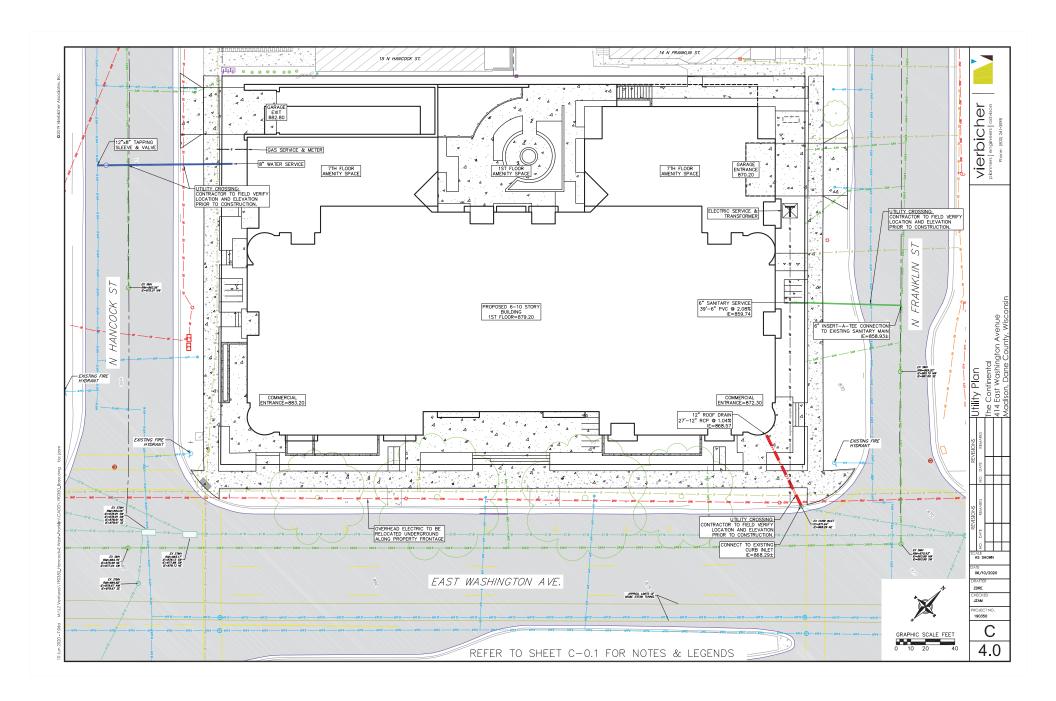
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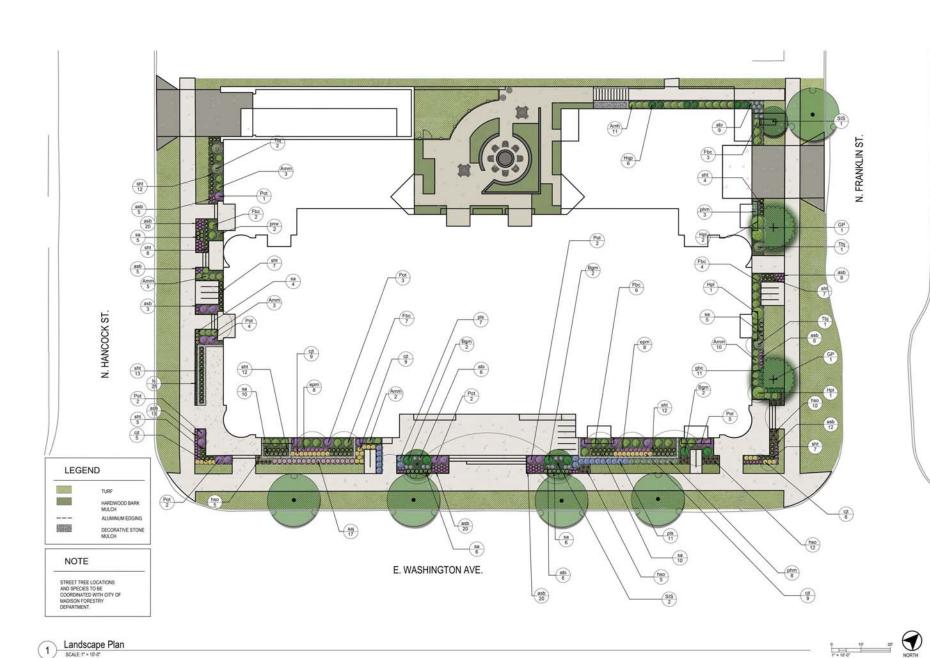
OJECT NO. 190350

С 1.0







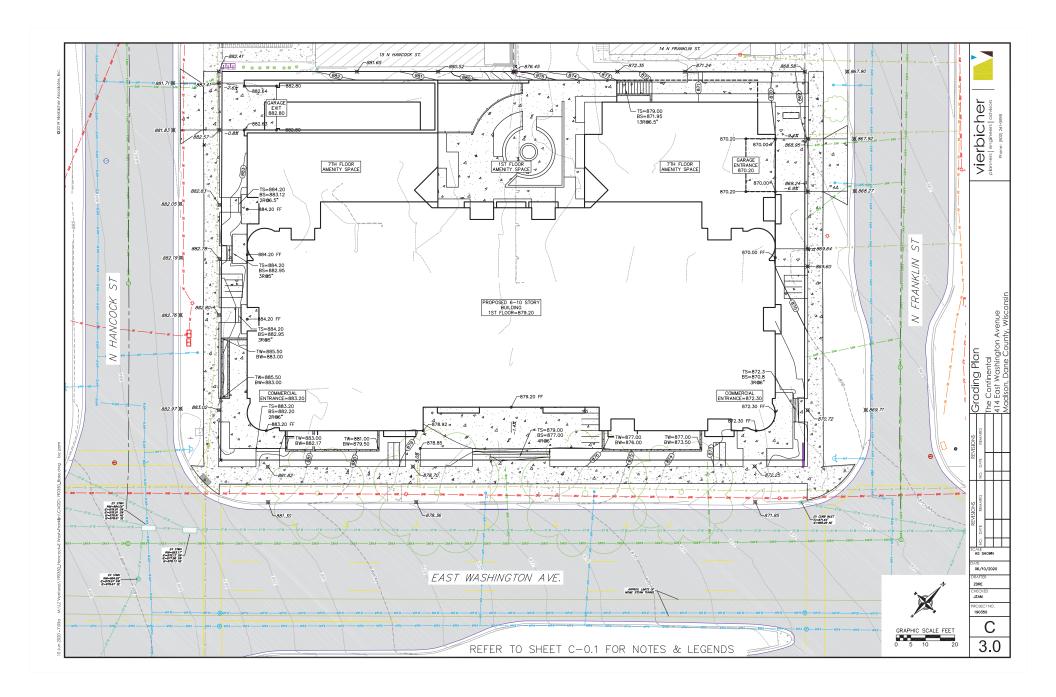

Knothe = bruce
ARCHITECTS
Place: 760 University Art. To 201
Place To 1540
Place To 1540
Place To 1540

ISSUED lesued for Land Use Submittel -April 1, 2020

PROJECT TITLE
THE
CONTINENTAL

414 E Washington Ave

Landscape Plan

SHEET NUMBER

1 - 1.0

PROJECT NO. 1972

PLANT SCHEDULE

DECIDUOUS TREES	CODE	BOTANICAL / COMMON NAME	CONT	SIZE	<u>QTY</u>
(+)	GP	Ginkgo biloba 'Princeton Sentry' / Princeton Sentry Ginkgo	B & B	2.5°Cal	2
ORNAMENTAL TREES	CODE	BOTANICAL / COMMON NAME	CONT	SIZE	QTY
(•)	SIS	Syringa reticulata 'Ivory Silk' / Ivory Silk Japanese Tree Lilac	B & B	1.5°Cal	3
DECIDUOUS SHRUBS	CODE	BOTANICAL / COMMON NAME	SIZE	SIZE	QTY
\odot	Amh	Aronia melanocarpa 'Low Scape Hedger' / Low Scape Hedger Chokeberry	3 gal	18" HT (MIN.)	11
\odot	Amm	Aronia melanocarpa 'UCONNAM165' TM / Low Scape Mound Chokeberry	3 gal	12" HT (MIN.)	23
(Fbc	Fothergilla gardenii 'Beaver Creek' / Dwarf Witchalder	3 gal	18" HT. (MIN.)	25
⊙ ⊕ ⊙	Hpl	Hydrangea paniculata "Little Quick Fire" / Little Quick Fire Hydrangea	3 gal	18" HT (MIN.)	4
	Нар	Hydrangea quercifolia 'Pee Wee' / Pee Wee Oakleaf Hydrangea	3 gal	18" HT (MIN.)	6
\odot	Pot	Physocarpus opulifolius 'Tiny Wine' / Tiny Wine Ninebark	3 gal	18" HT (MIN.)	21
EVERGREEN SHRUBS	CODE	BOTANICAL / COMMON NAME	SIZE	SIZE	QTY
\odot	Bgm	Buxus x 'Green Mound' / Green Mound Boxwood	5 gal	18" HT (MIN.)	6
0	Tbj	Thuja occidentalis 'Bail John' / Technito Arborvitae	B & B	4' HT. (MIN.)	4
HERBACEOUS PERENNIALS	CODE	BOTANICAL / COMMON NAME	SIZE	SIZE	QTY
\odot	asb	Allium tanguticum 'Summer Beauty' / Summer Beauty Allium	1 gal		115
(abi	Amsonia tabernaemontana 'Blue Ice' / Blue Ice Blue Star	1 gal		21
铁	cjt	Coreopsis x 'Jethro Tull' / Jethro Tull Tickseed	1 gal		38
\odot	epm	Echinacea x "Pixie Meadowbrite" / Pixie Meadowbrite Purple Coneflower	1 gal		16
₩	gbc	Geranium x cantabrigiense 'Biokovo Carmina' / Carmine Biokovo Geranium	1 gal		11
•	hso	Hemerocallis x `Stella de Oro` / Stella de Oro Daylily	1 gal		32
+	ls	Liriope spicata / Creeping Lily Turf	3 1/4"		21
•	pls	Perovskia atriplicifolia 'Little Spire' TM / Little Spire Russian Sage	1 gal		18
\oplus	saj	Sedum x 'Autumn Joy' / Autumn Joy Sedum	1 gal		17
ORNAMENTAL GRASSES	CODE	BOTANICAL / COMMON NAME	SIZE	SIZE	QTY
()	phm	Panicum virgatum 'Heavy Metal' / Blue Switch Grass	1 gal		11
*	pnw	Panicum virgatum "North Wind" / Northwind Switch Grass	1 gal		2
•	sa	Sesleria autumnalis / Autumn Moor Grass	1 gal		46
0	sht	Sporobolus heterolepis "Tara" / Prairie Dropseed	5 gal		87

Plant Schedule

Landscape Worksheet






ISSUED Issued for Land Use Submittal — April 1, 2020

PROJECT TITLE THE CONTINENTAL

414 E Washington Ave
SHEET TITLE
Plant Schedule and Landscape Worksheet

SHEET NUMBER

PROJECT NO. | 972

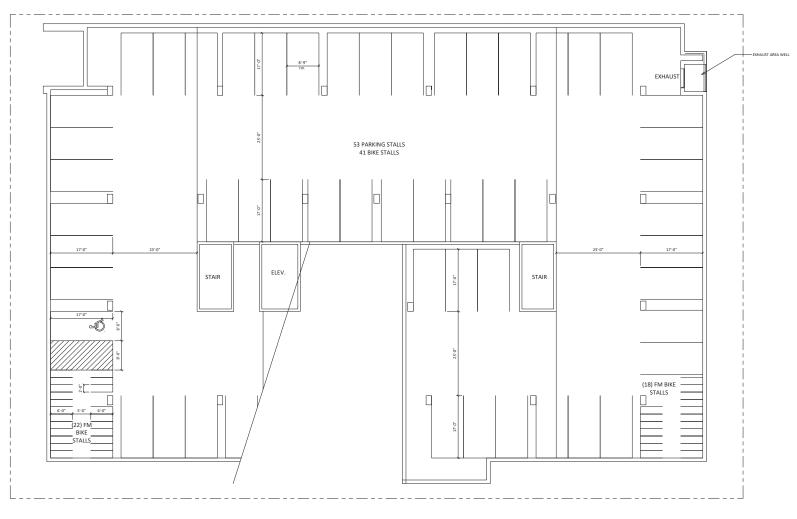

UNDERGROUND PARKING LEVEL 2



ISSUED Reissued for Land Use - June 10, 2020


PROJECT TITLE THE CONTINENTAL

414 E Washington Ave

SHEET TITLE UNDERGROUND PARKING LEVEL

2

SHEET NUMBER

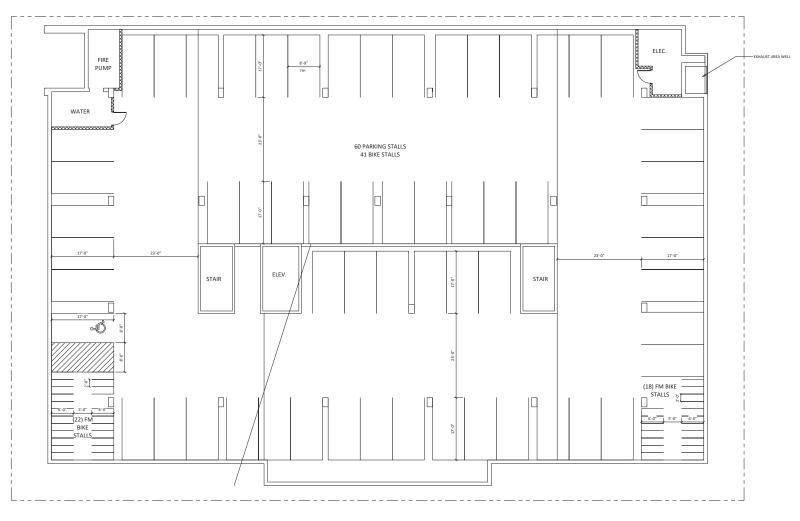

UNDERGROUND PARKING LEVEL 1

KEY PLAN

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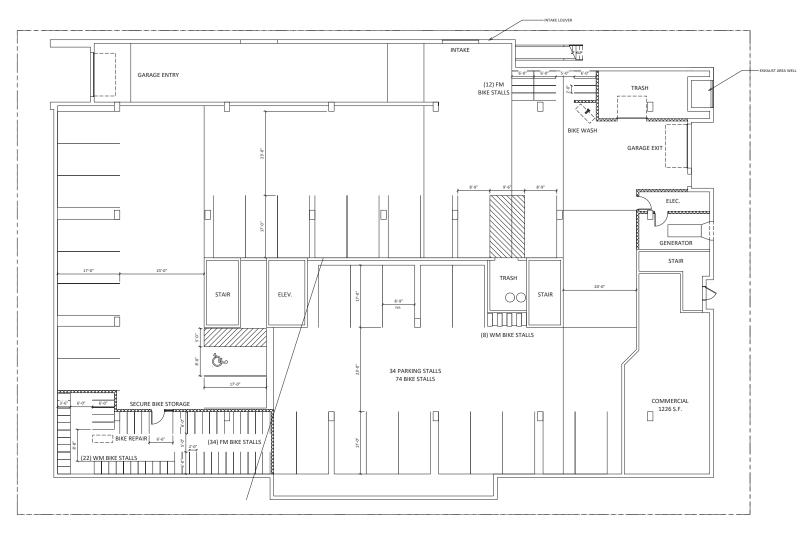
PROJECT TITLE THE CONTINENTAL

414 E Washington Ave

SHEET TITLE UNDERGROUND PARKING LEVEL

1

SHEET NUMBER



FRANKLIN ST. LEVEL FLOOR PLAN



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PROJECT TITLE THE

CONTINENTAL

414 E Washington Ave

FRANKLIN ST. LEVEL FLOOR PLAN

SHEET NUMBER

PROJECT NUMBER 1972



knothelbrace.com 808.208.2080 7601 University Ave. + Suite 201 + Middleton, W1 53561 KEY PLAN

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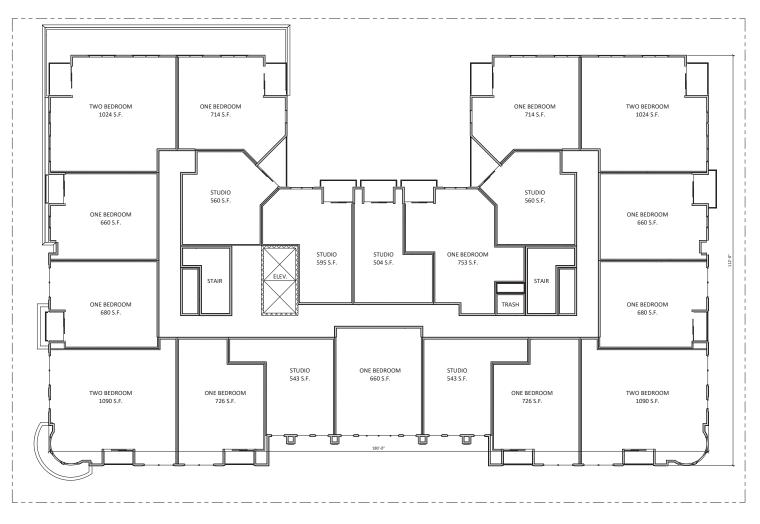
PROJECT TITLE

THE CONTINENTAL

414 E Washington Ave

SHEET TITLE FIRST FLOOR PLAN

SHEET NUMBER



SECOND THROUGH SIXTH FLOOR PLAN



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PROJECT TITLE


THE CONTINENTAL

414 E Washington Ave

SHEET TITLE SECOND FLOOR

SHEET NUMBER

PLAN

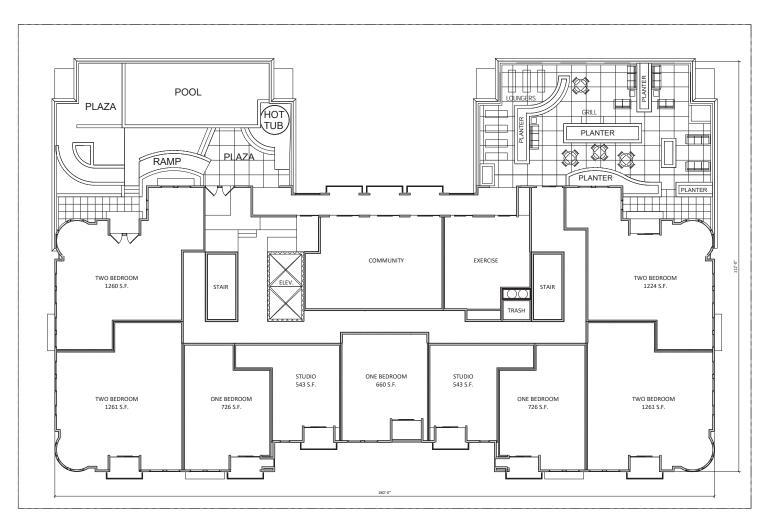

SEVENTH FLOOR PLAN

1/8" = 1"-0"



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PROJECT TITLE THE


CONTINENTAL

414 E Washington Ave

SHEET TITLE

SEVENTH FLOOR PLAN

SHEET NUMBER

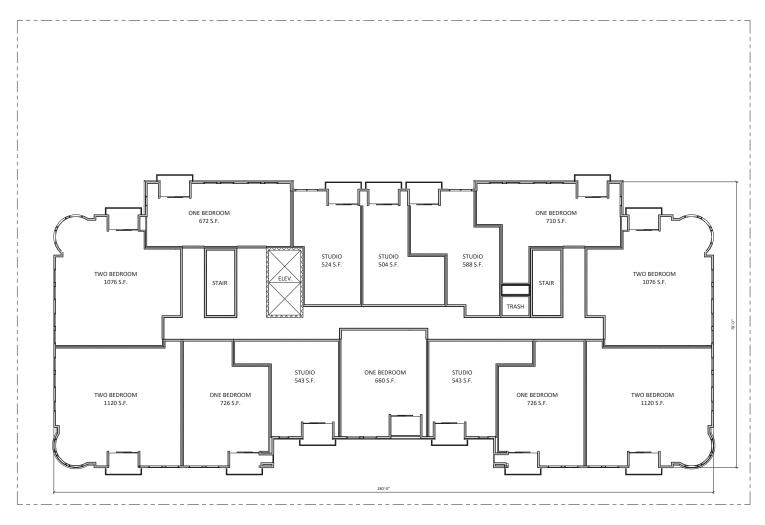

EIGHTH FLOOR PLAN



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PROJECT TITLE

THE CONTINENTAL

414 E Washington Ave

SHEET TITLE EIGHTH FLOOR PLAN

SHEET NUMBER



NINTH FLOOR PLAN

1/8" = 1"-0"



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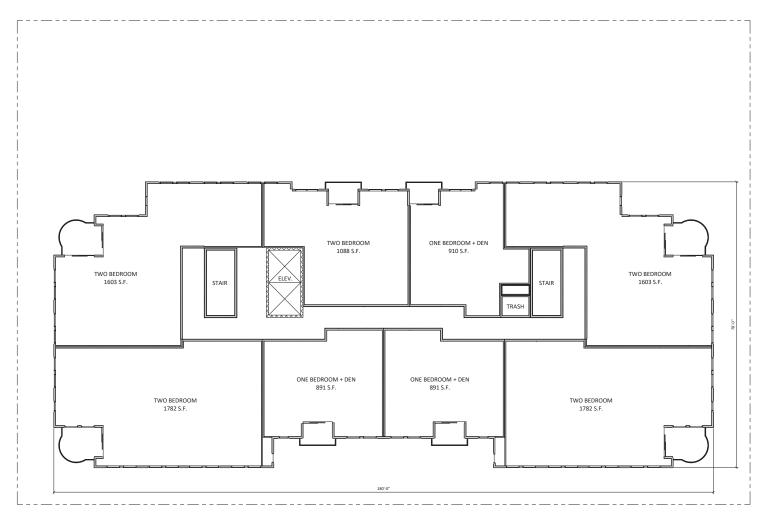
PROJECT TITLE

THE CONTINENTAL

414 E Washington Ave

SHEET TITLE NINTH FLOOR PLAN

SHEET NUMBER



1 TENTH FLOOR PLAN
1/8" = 1'-0"



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PROJECT TITLE

THE CONTINENTAL

414 E Washington Ave


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TENTH FLOOR

TENTH FLOOR PLAN

SHEET NUMBER

A-1.10

PROJECT NUMBER 1972

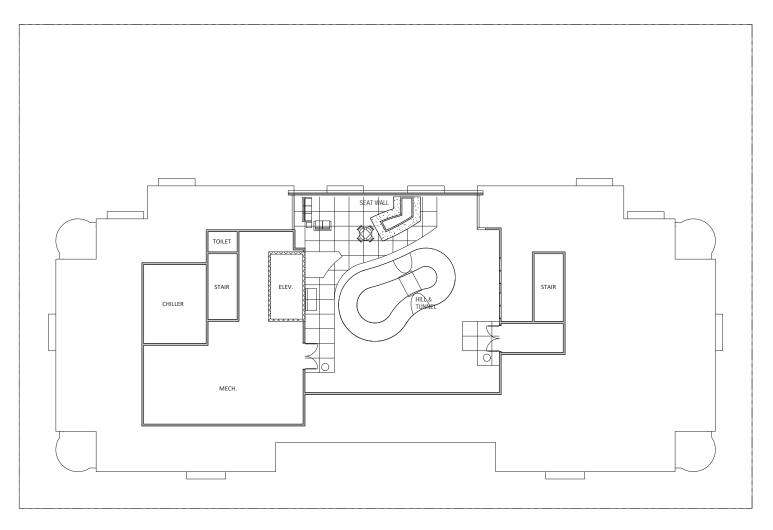

MECHANICAL PENTHOUSE FLOOR PLAN




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PROJECT TITLE THE CONTINENTAL

414 E Washington

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SHEET TITLE
MECHANICAL PENTHOUSE FLOOR PLAN

SHEET NUMBER

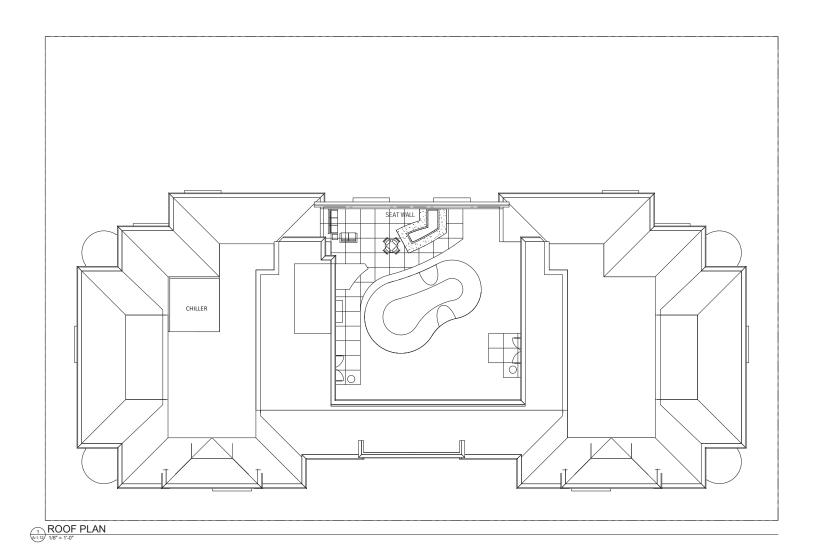

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PROJECT TITLE
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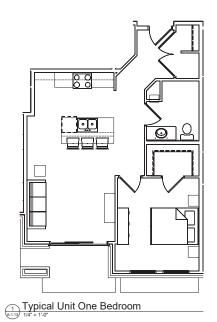
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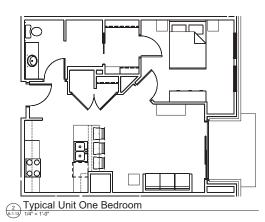
414 E Washington


Ave
SHEET TITLE
ROOF PLAN


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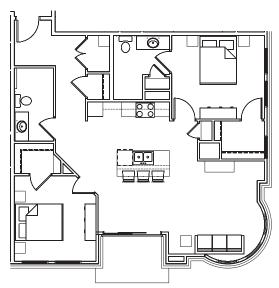
A-1.12







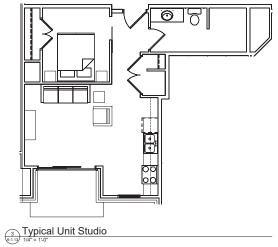

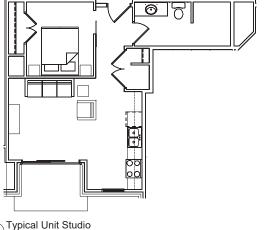

Typical Unit Two Bedroom

PROJECT TITLE

KEY PLAN

THE CONTINENTAL

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414 E Washington Ave

SHEET TITLE
Typical Unit

Type

SHEET NUMBER





ISSUED

PROJECT TITLE THE CONTINENTAL

EXTERIOR MATERIAL SCHEDULE 414 E Washington MANUFACTURER Ave SUMMIT FAWN SMOOTH SHEET TITLE

CLOUD CERAN KANSAS GOLD **EXTERIOR ELEVATIONS**

SHEET NUMBER

A-2.1 PROJECT NUMBER 1972

Elevations - Exterior Material Schedule

FIBERGLASS OR ALUMINIUM BLACK

BUILDING ELEMENT

MASONRY - (#1)
- ARRISCRAFT RENAISSANCE STONE
OR CORDOVA STONE BUFF


STANDING SEAM METAL ROOF

METAL DOORS/FRAMES STONE SILLS & BANDS

SOFFITS & FASCIA RAILINGS

BRICK VENEER - (#1) BRICK VENEER - (#2)

WINDOWS STOREFRONT

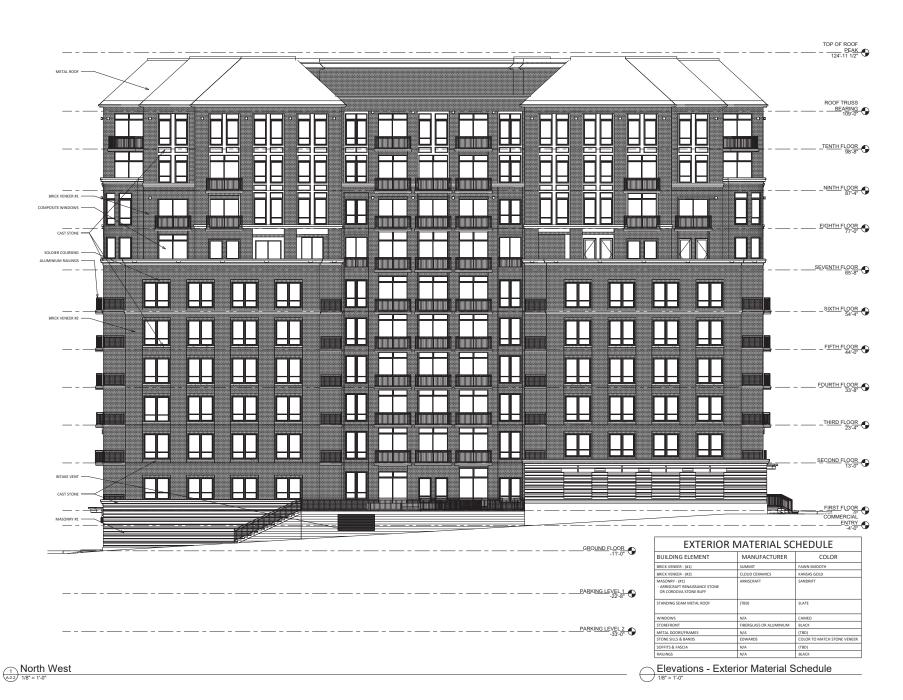

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PROJECT TITLE
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CONTINENTAL

414 E Washington Ave

SHEET TITLE
EXTERIOR
ELEVATIONS

SHEET NUMBER

A-2.2

PROJECT NUMBER 1972



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PROJECT TITLE THE

CONTINENTAL

414 E Washington Ave


SHEET TITLE
EXTERIOR
ELEVATIONS

SHEET NUMBER

A-2.3

PROJECT NUMBER 1972

St Knothe & Rouse Architects 11C

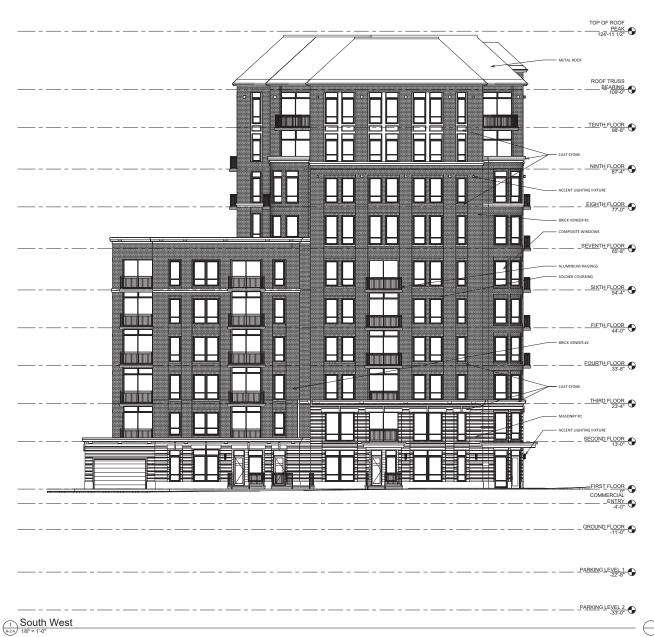



ISSUED

PROJECT TITLE

THE CONTINENTAL

414 E Washington Ave

SHEET TITLE
EXTERIOR
ELEVATIONS

SHEET NUMBER

PROJECT NUMBER 1972

Elevations - Exterior Material Schedule

EXTERIOR MATERIAL SCHEDULE

MANUFACTURER

COLOR

COLOR TO MATCH STONE VENEER

IUM BLACK

BUILDING ELEMENT

BRICK VENEER - (#1) BRICK VENEER - (#2)

WINDOWS

METAL DOORS/FRAMES

STONE SILLS & BANDS SOFFITS & FASCIA





ISSUED

PROJECT TITLE

THE

THE CONTINENTAL

414 E Washington Ave

EXTERIOR
ELEVATIONS COLORED

SHEET NUMBER

A-2.5
PROJECT NUMBER 1972

EXTERIOR MATERIAL SCHEDULE BUILDING ELEMENT MANUFACTURER COLOR BRICK VENEER - (#1) BRICK VENEER - (#2) MASONRY - (#1) - ARRISCRAFT RENAISSANCE STONE OR CORDOVA STONE BUFF TANDING SEAM METAL ROOF SLATE STOREFRONT FIBERGLASS OR ALU INIUM BLACK METAL DOORS/FRAMES STONE SILLS & BANDS SOFFITS & FASCIA N/A (TBD)

Elevations - Exterior Material Schedule

Colored - North East



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PROJECT TITLE
THE
CONTINENTAL

414 E Washington Ave

SHEET TITLE
EXTERIOR
ELEVATIONS COLORED

SHEET NUMBER

A-2.6





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PROJECT TITLE
THE
CONTINENTAL

414 E Washington Ave

EXTERIOR
ELEVATIONS COLORED

SHEET NUMBER

A-2.7

PROJECT NUMBER 1972





ISSUED

PROJECT TITLE

THE CONTINENTAL

414 E Washington Ave

EXTERIOR
ELEVATIONS COLORED

SHEET NUMBER

A-2.8

PROJECT NUMBER 1972

EXTERIOR MATERIAL SCHEDULE

BUILDING ELEMENT MANUFACTURER COLOR

BRICK VENEER - (87) SUMMIT FAWN SMICOTIN BRICK VENEER - (92) LOUID CERAMICS LANGAS GOLD

MASCHINF - (93) ABRICKATE STONE OR CHOUNTED FAWN SMICOTIN BRIFT - SANDRIEFT - SA


Elevations - Exterior Material Schedule

Colored - South West








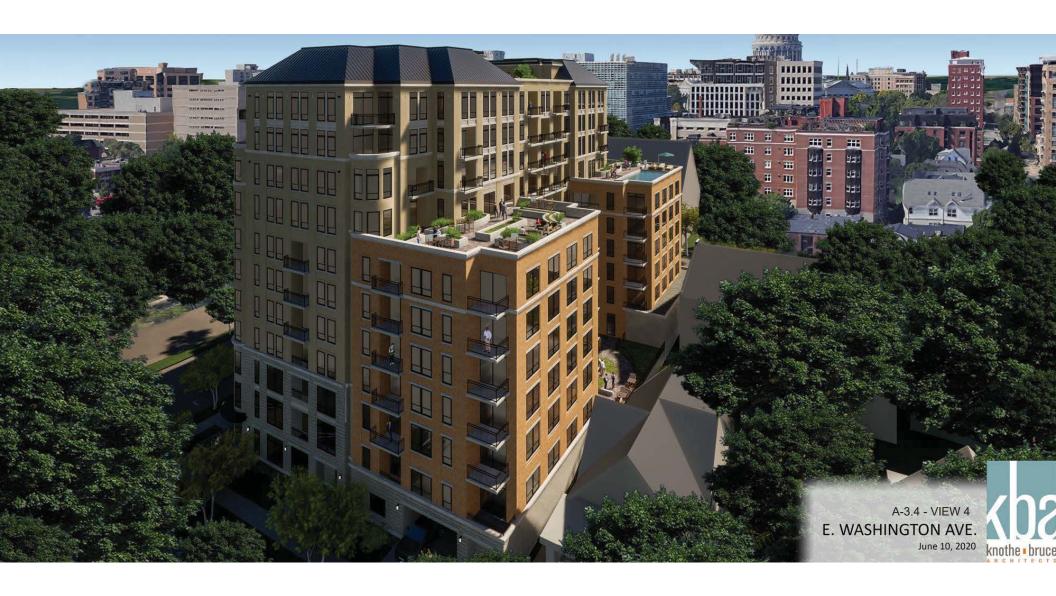







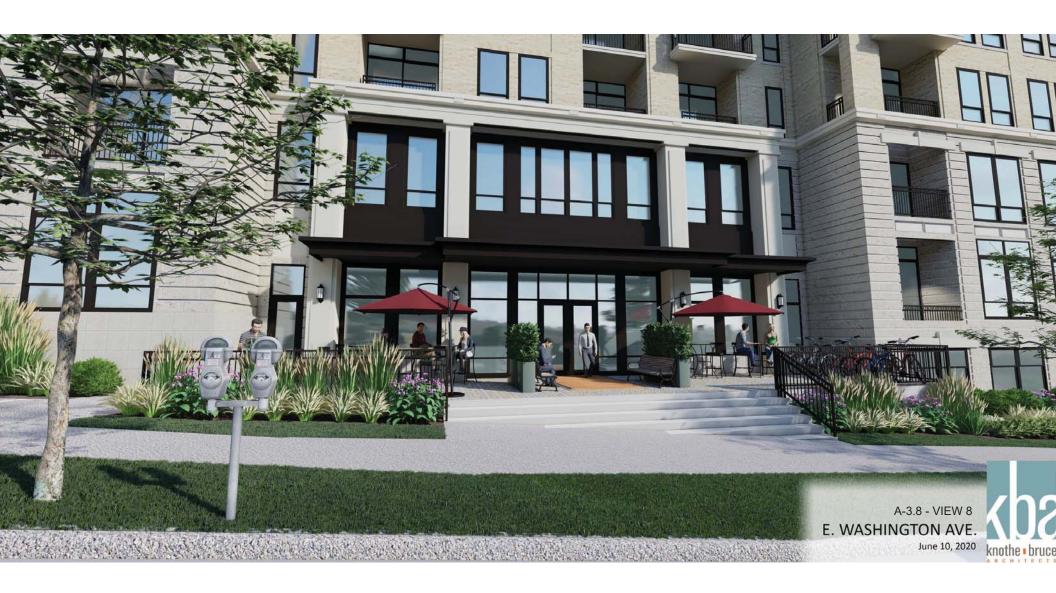











SPRING / FALL EQUINOX




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12:00 PM



SUMMER SOLSTICE



9:00 AM

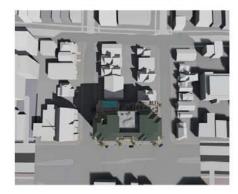


12:00 PM



WINTER SOLSTICE



9:00 AM

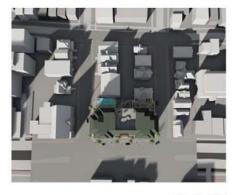

12:00 PM



3:00 PM

A-3.14 SHADOW STUDY





Non-Required Building Setback

Required Building Setback

A-3.15 - Building Setbacks E. Washington Ave. Madison, WI May 05, 2020







