# APPLICATION FOR URBAN DESIGN COMMISSION REVIEW AND APPROVAL


AGENDA ITEM #	
Project #	
13211	

DATE SUBMITTED: 03-29-06	Action Requested Informational Presentation X Initial Approval and/or Recommendation
UDC MEETING DATE: 04-05-06	Final Approval and/or Recommendation
PROJECT ADDRESS: 5702 Raymond	Road
ALDERMANIC DISTRICT: 20	
OWNER/DEVELOPER (Partners and/or Principals) A MLG Capital (Meadowood) LLC.	RCHITECT/DESIGNER/OR AGENT: The Redmond Company
	w228 N745 Westmound Dr.
attein.	Waukesha, WI 53186
CONTACT PERSON: Tammy Mauer  Address: <u>w228 N745 Westma</u> Waukesha, WI 531	
Phone: <u>262-896-3787</u> Fax: <u>262-549-1314</u> E-mail address: +mauer@ +heredmo	ond co. com
TYPE OF PROJECT:  (See Section A for:)  Planned Unit Development (PUD)  General Development Plan (GDP)  Specific Implementation Plan (SIP)  Planned Community Development (PCD)  General Development Plan (GDP)  Specific Implementation Plan (SIP)  Planned Residential Development (PRD)  New Construction or Exterior Remodeling in an U well as a fee)  School, Public Building or Space (Fee may be requ	Trban Design District * (A public hearing is required as
(See Section B for:)  New Construction or Exterior Remodeling in C4 D	District (Fee required)
(See Section C for:) R.P.S.M. Parking Variance (Fee required)	
(See Section D for:)  Comprehensive Design Review* (Fee required) Street Graphics Variance* (Fee required)	
Other	
*Public Hearing Required (Submission Deadline 3 Weeks F:\PLROOT\WORDP\PL\UDC\Miscellaneous\uddreviewapprovalFeb05.doc	in Advance of Meeting Date)

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53186		
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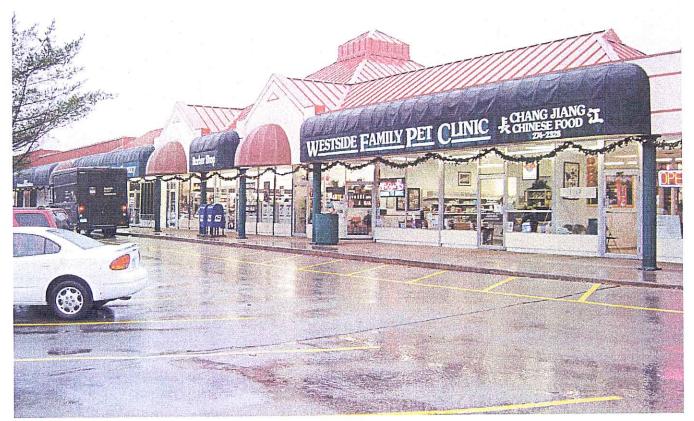
# Meadowood Shopping Center 5702 Raymond Road Madison, Wisconsin


# Locator Map




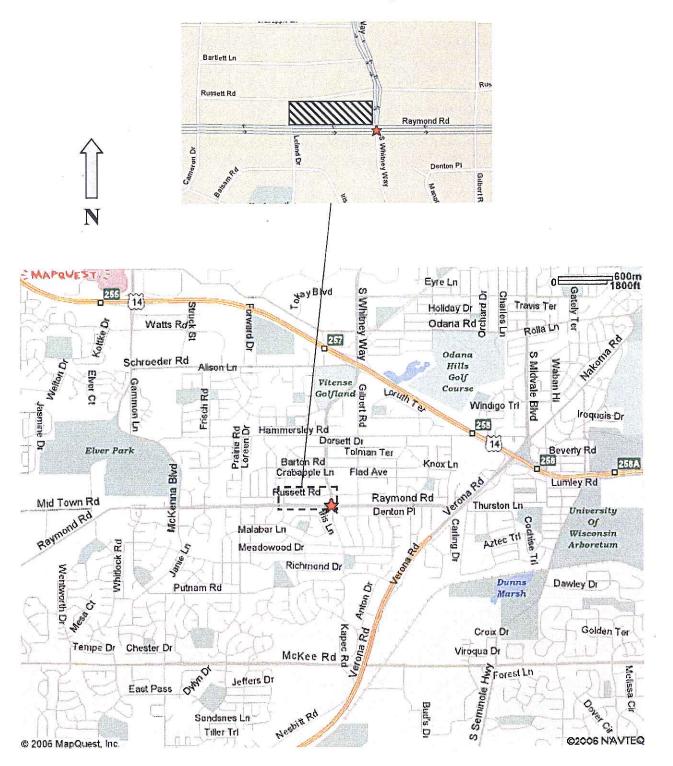






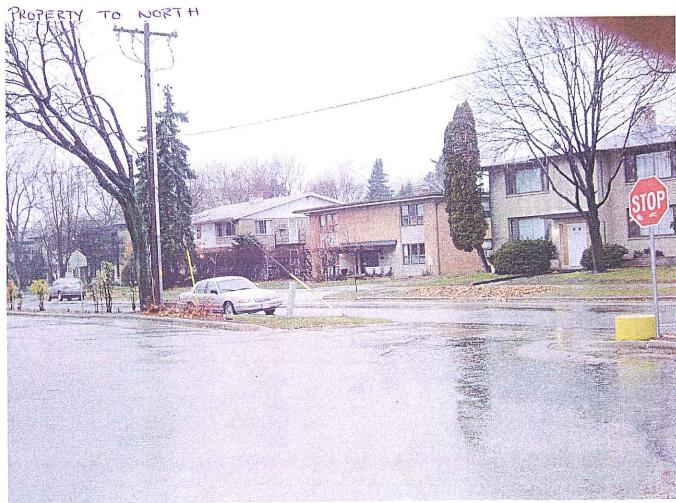


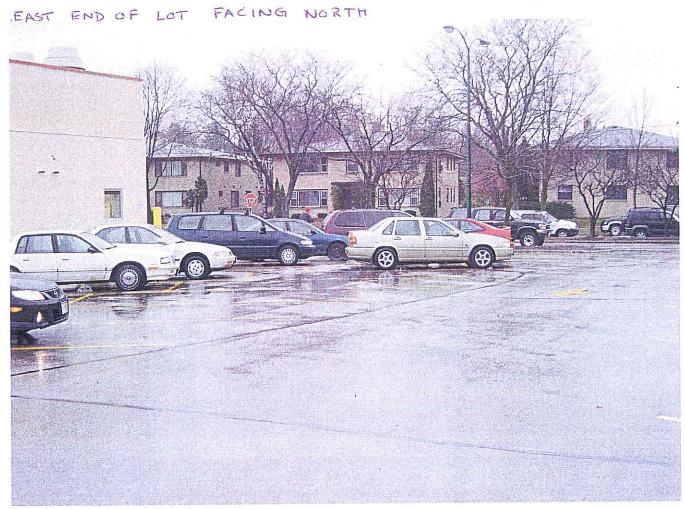


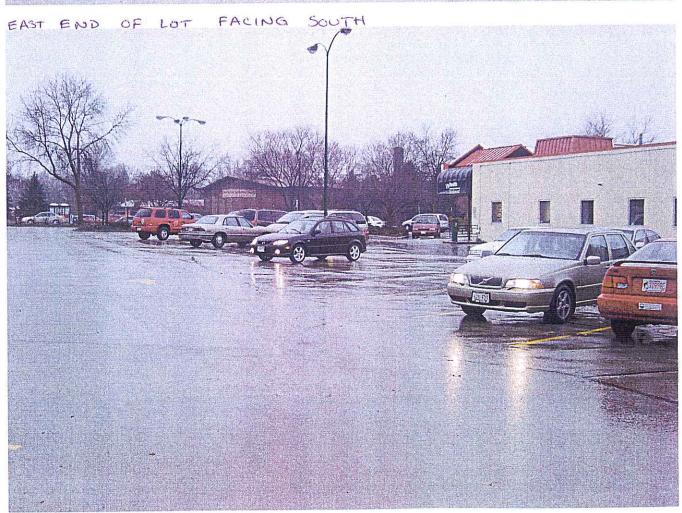


SOUTH ELEVATION OF TENANT FURTHEST WEST



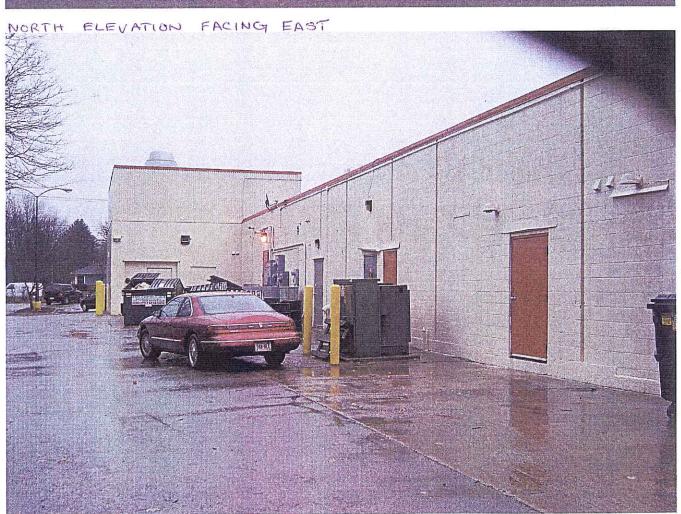

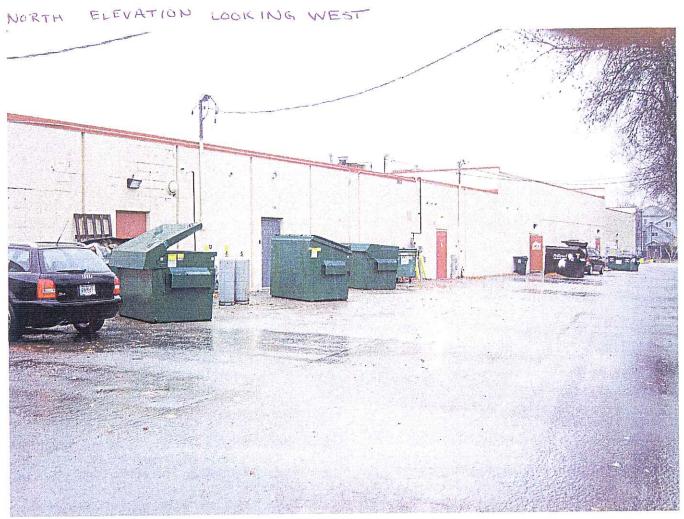

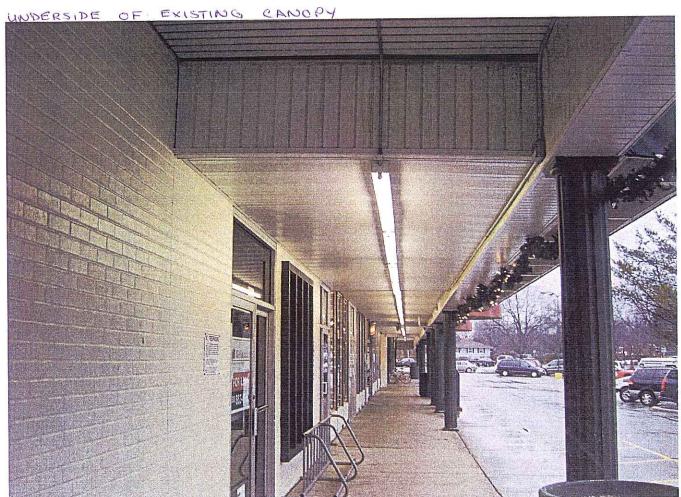

# Tualgreens PLAN COMMISSION SUBMITTAL

MEADOWOOD PLAZA
RAYMOND ROAD & WHITNEY WAY
MADISON, WISCONSIN

### SUBMITTAL DATES:


SUBMITTAL 1 03-22-06

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C4.1	DETAILS
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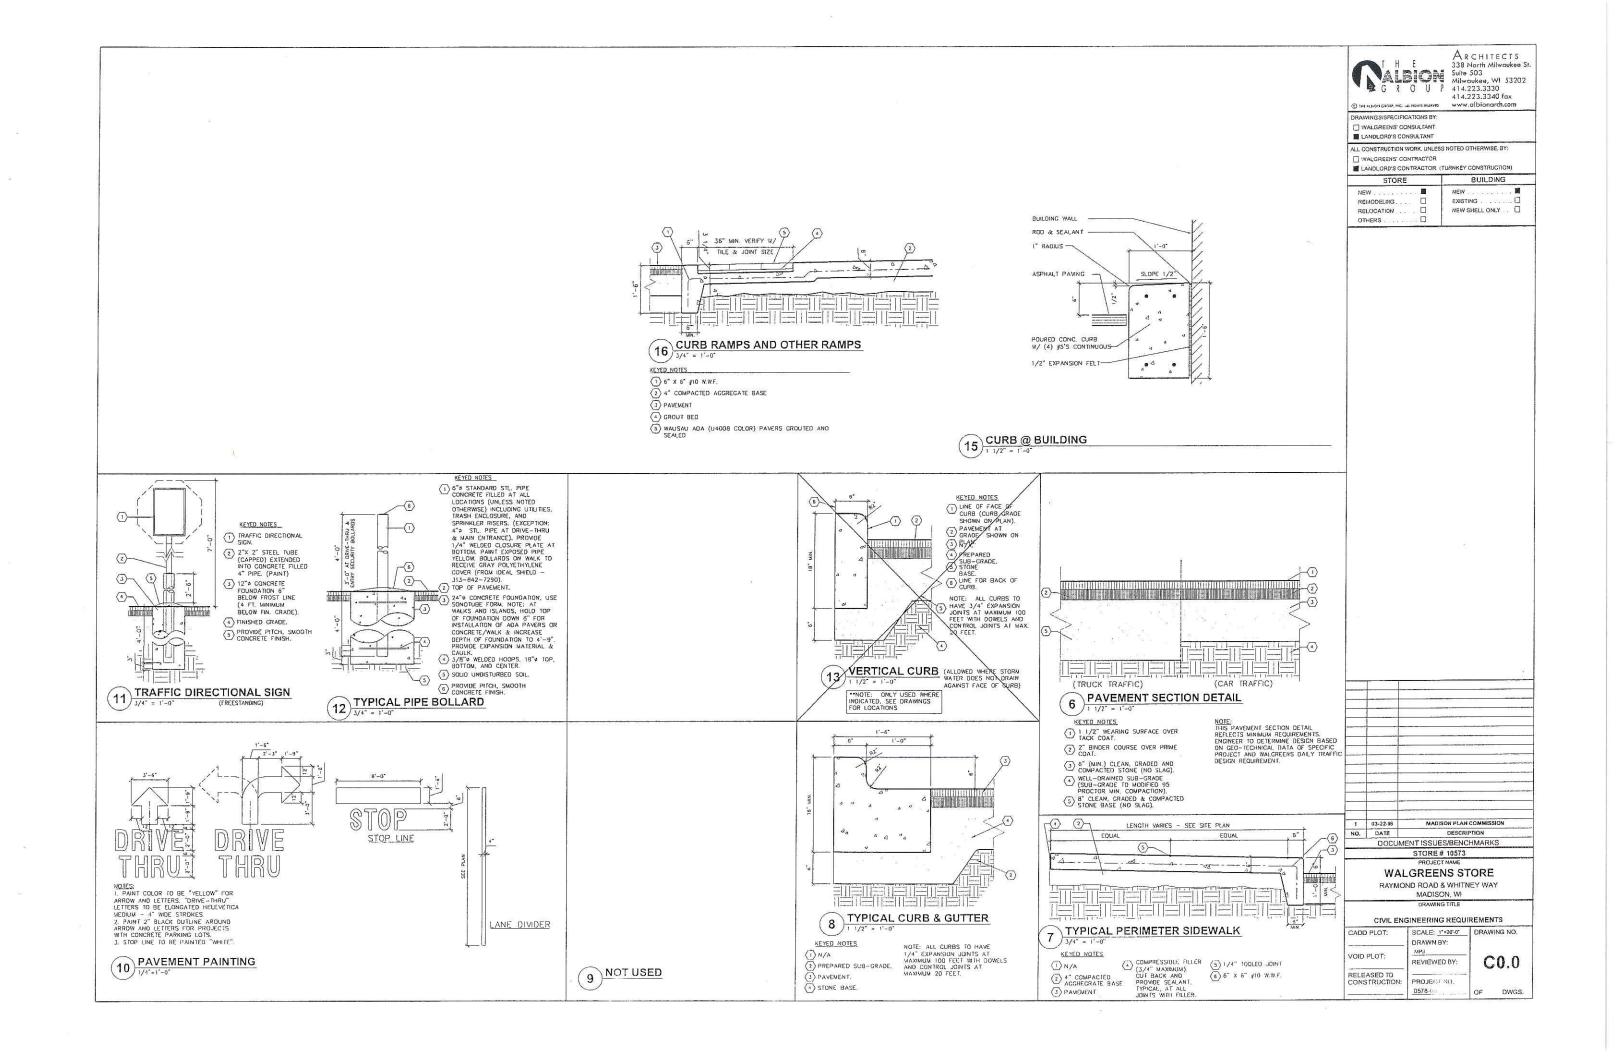


T H E G R O U P

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WALGRENS
MEADOWOOD FLAZA
RAYMOND ROAD & WHITNEY WAY
MADISON, WI
PROJECT NO., 0578-00

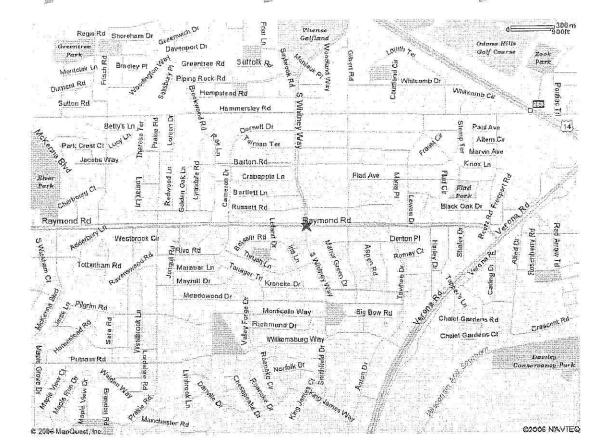

#### EXTERIOR SITE AND PARKING AREA

AN ACCESSIBLE ROUTE OR PATH FROM THE PERIMETER OF THE SITE SERVING SIDEWALKS, PUBLIC STREETS OR PUBLIC TRANSPORTATION MUST BE PROVIDED TO WALGREENS ACCESSIBLE STORE ENTRANCE.

PREFERRED LOCATION FOR ACCESSIBLE ROUTE SHALL CONCIDE WITH PEDESTRIAN ACCESS TO CORNER. DIHERWISE, LOCAL ARCHITECT TO DETERMINE BEST LOCATION TO CONFORM TO SLOPE ALLOWANCES DEFINED BY A.D.A. VERIFY COMPLIANCE WITH MORE STRINGENT LOCAL CODES.

AN ACCESSIBLE ROUTE WILL BE A MINIMUM 36" WIDE, 60" IS WALGREENS STANDARD.

AN ACCESSIBLE ROUTE MAY CROSS OPEN PAVEMENT OR FOLLOW A RAMP AS REQUIRED BY SITE—SPECIFIC CONDITIONS, THE RUNNING SLOPE OF AN ACCESSIBLE ROUTE ACROSSOPEN PAVEMENT MUST NOT EXCEED 12:0, WITH A CROSS SLOPE NOT EXCEEDING 1:50. SLOPES EXCEEDING 1:20, BUT LESS THAN 1:12, CONSTITUTE RAMPS AND MUST CONFORM TO THE REQUIREMENTS FOR RAMP DESIGN (HAMDRAILS, CURBS). LANDINGS, RISÉ AND RUN LIMITS) AS NOTED BELOW, NO RAMP SHALL HAVE A RUNNING SLOPE EXCEEDING 1:12, NOR HAVE A CROSS SLOPE EXCEEDING 1:50.

#### ACCESSIBLE SPACE REQUIREMENTS

PROVIDED 101 TO 150... 151 TO 200... 201 TO 300...

THE ADA REQUIRES ONE VAN ACCESSIBLE PARKING SPACE WITH 96" ACCESS AISLE FOR ONE IN EVERY EIGHT ACCESSIBLE SPACES, BUT NOT LESS THAN ONE.

#### ENTRANCE AREA DOORS

WALGREEN'S STANDARD ENTRANCE DOOR IS AN AUTOMATIC SLIDING DOOR SYSTEM DESIGNED TO COMPLY WITH ALL ACCESS CODES AND LAWS.

ENTRANCE DOORS AND ALL OTHER DOORS ALONG AN ACCESSIBLE ROUTE WILL HAVE A

THE EXTERIOR ENTRANCE AREA SHALL NOT HAVE IMPEDIMENTS TO ACCESSIBILITY SUCH AS CART BARRIERS OR "CART CORRALS".

PROTECTIVE SECURITY BOLLARDS, IF USED IN THE ENTRANCE AREA, SHALL BE SPACED A MINIMUM OF 36" CLEAR BETWEEN BOLLARDS.

THRESHOLDS AT AUTOMATIC DOORS SHALL NOT EXCEED 3/4" IN HEIGHT OR 1/2" FOR DIHER TYPES OF DOORS. ALL THRESHOLDS SHALL BE BEVELED WITH A SLOPE OF NO GREATER THAN 1:2.


#### VESTIBULES

IF THE STORE HAS A VESTIBULE. THE MINIMUM SPACE BETWEEN THE OUTER DOOR AND THE INNER DOOR SHOULD BE 48" PLUS THE WIDTH OF ANY DOOR SWINGING INTO THE SPACE.

#### REVOLVING DOORS

THE STORE HAS A REVOLVING DOOR AT THE ENTRANCE, IT MUST HAVE AN ADJACENT "ACCESSIBLE" DOOR. THE ADJACENT ACCESSIBLE DOOR MUST BE UNLOCKED AND USABLE WHEN THE REVOLVING DOOR IS UNLOCKED AND USABLE.


NO OBJECTS SHOULD PROTRUDE (EVEN TEMPORARILY) INTO THE MINIMUM CLEAR SPACE OF THE ACCESSIBLE ROUTES TO THE STORE ENTRANCE. THIS WOULD INCLUDE SHOPPING CARTS, SALES FIXTURES, VENDING MACHINES, DISPLAYS, OR OTHER BARRIERS.

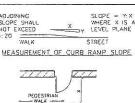

- SEE SIDE FLARE NOTE BELOW 3'-0" CURB\_RAMP

DOOR WITH A SLOPE OF 1:50 (2%)
MAXIMUM LEVEL SURFACE IS PREFERED.

SIDE FLARE NOTE: (SEE REFERENCE DIAGRAM ABOVE). SIDE FLARES SHALL HAVE A MAXIMUM SLOPE OF 1:10 (10%). WHERE "X" IS LESS THAN 48". SIDE FLARE SLOPE SHALL BE 1:12 (8.33%) MAXIMUM, WHERE "X" IS LESS THAN 36". WALGREENS PREFERS THE "IN-LINE" RAMP SHOWN BELOW.

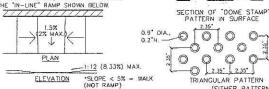

"IN-LINE" RAMP

A RAMP IS ANY SLOPE GREATER THAN 1:20 (52) AND SHALL HAVE A MAXIMUM SLOPE OF 1:12 (8.33%). THE MAXIMUM SLOPE OF RISE PER FOOT OF DISTANCE TRAVELED. ALL SLOPED AREAS OF THE RAMP ARE TO HAVE AN INTEGRAL RED COLOR.

REQUIRE HANDRAILS.

ANY RAMP WITH CREATER THAN A 6" RISE SHALL HAVE HANDRAILS ON BOTH SIDES AND CURBED EDGE PROTECTION ON BOTH SIDES. EDGE PROTECTION CONSISTS OF CURBS, WALLS, RAILINGS, OR PROJECTING SURFACES THAT PREVENT PEOPLE FROM SUPPING OFF THE RAMP, HANDRAIL DETAILS SHALL FOLLOW ACCESSIBLE GUIDELINES.

(EITHER PATTERN IS ACCEPTABLE) PLAN OF "DOME STAMP" PATTERN IN SURFACE

INTREGRALLY COLORED RED CONCRETE 7

WARNING SURFACE

1 0.9" DIA.

VARES PER MANUE

2.35" (TYP.)

SECTION OF "DOME STAMP"

235 235

TRIANGULAR PATTERN

2'-0" O.C. AND KEYWAYS TO PREVENT HEAVING OF

0

-0

-O O

0 0

RAMPS W/ ADJACENT SIDEWALK OR CONC. SURFACE.

NOTES: A CURB RAMP(S) MUST BE PROVIDED ALONG AN ACCESSIBLE PATH FROM THE PARKING LOT TO WALGREENS CURBED SIDEWALK.

A CURB RAMP(S) MUST ALSO BE PROVIDED IN THE PARKING LOT AT ALL INTERMEDIATE AND PERIMETER CURBS ALONG THE ACCESSIBLE ROUTE CONNECTING TO PUBLIC SIDEWALKS.

A RAMP IS ANY SLOPE GREATER THAN 1:20 (52) AND SHALL HAVE A MAXIMUM SLOPE OF 1:12 (8.33%). THE MAXIMUM SLOPE IS 1" OF RISE PER FOOT OF DISTANCE MAXIMUM SLOPE IS 1" OF RISE PER FOOT OF DISTANCE RAMPE OALL SLOPED AREAS OF THE RAMPA TO


THE CLEAR WIDTH OF ANY RAMP IS A MINIMUM OF 36".

THE CLEAR WIDTH OF ANY RAMP IS A MINIMUM OF 36".

CURB RAMPS HAVE A MAXIMUM RISE OF 6" AND DO NOT REQUIRE HANDRAILS.


CURB RAMPS HAVE A MAXIMUM RISE OF 6" AND DO NOT REQUIRE HANDRAILS.

ANY RAMP WITH OREATER THAN A 6" RISE SHALL HAVE PATTERN ETC.) ACCESSIBILITY GUIDINES BEFNED BY LOCAL ORDINANCE SHOULD SUPERSEDE. IN THE ABSENCE OF A DEFINITION, FOLLOW ADARG. VERIFY COMPETANCE WITH MORE STRINGENT LOCAL CODES.

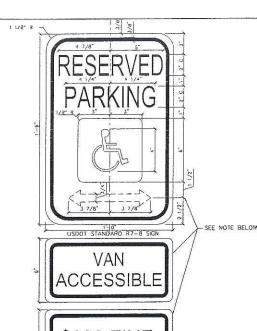

NOTE (R7-80 SIGN): THIS IS A STANDARD SIGN AND MAY BE ORDERED FROM ANY TRAFFIC SIGN SUPPLIER BY NUMBER. THE ARROW SHOULD BE OMITTED WHERE THERE IS ONLY ONE SPACE. THE ARROW MAY ALSO BE MADE TO POINT IN ONLY ONE DIRECTION. THE ARROW MAY ALSO BE REPLACED BY "TIME" SUCH AS 9 AM — 5 PM WHERE A PART-TIME RESTRICTION EXISTS. THE SIGN MUST BE SUPPLEMENTED WITH A "VAN ACCESSIBLE" SIGN AS APPLICABLE AND/OR AMOUNT OF THE FINE FOR ILLECALLY PARKING IN THE RESERVED SPACE(S) A MUNICIPALITY MAY IMPOSE. CONFIRM WITH LOCAL RECULATIONS.

2 ACCESSIBILITY SIGNAGE NOTE: ACCESSIBILITY SIGNAGE SHALL COMPLY WITH MINNESOTA COMMERCIAL BUILDING CODE & DOT CLAST TOUST

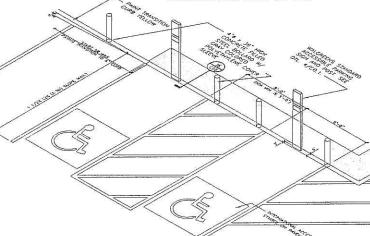

(1) (3)-**(1)** (5) \* <del>|</del> ====== <del>|</del> • | 1'-6" 3- 1-0- 3-

FRONT VIEW

& OF PARKING STALL

KEYED NOTES

PRE-FABRICATED WELDED CAP
W/ STAINLESS STEEL SCREWS. (2) STANDARD USDOT R7-8 SIGN (BOTH SIDES) (3) 2"x12"x3/16" STEEL TUBE WITH CONCRETE).

(+) SUPPLEMENTAL SIGNS, "VAN ACCESSIBLE" AND/OR \$-FINE AS APPLICABLE. (CHECK WITH LOCAL MUNICIPALITY FOR SIGNAGE REQUIREMENTS).

(5) FINISHED GRADE.

6 18"# CONCRETE FOUNDATION BELOW FROST LINE (4'-0" MINIMUM)

(7) 3/8" WELDED HOOPS OR SIMILAR @ TOP, BOTTOM & CENTER (B) HOLD CONCRETE FOUNDATION DOWN 6" AT SIDEWALKS ONLY POUR SIDEWALK OR INSTALL ADA PAVERS OVER TOP,

ACCESSIBLE PARKING SIGN AND POST (FREESTANDING)

SIDE MEW

STANDARD ACCESSIBLE DIMENSIONING

A U.S. DEPARTMENT OF TRANSPORTATION R7-8 (RESERVED A U.S. DEPARTMENT OF HAMPOURTHING KT-0 (RESERVED PARKING) AND SUPPEKENTAL SIGNS AS NOTED ABOVE MUST BE MOUNTED ON A PERMANENT POST NO LOWER THAN FOUR FEET FROM THE PARKENT. THE POST MUST BE MOUNTED IN THE CENTER OF THE 8 FOOT MOE ACCESSIBLE PARKING SPACE. NO MORE THAN 5 FEET TROM THE FRONT OF THE PARKING SPACE. SEE ILLUSTRATION ABOVE.

FEET WIDE AND HAVE A 98" MINMUM ACCESS AISLE FOR VANS OR 60" ACCESS AISLE FOR CARS ADJACENT TO THE SPACE. THE ACCESS AISLE MAY BE ON EITHER THE DRIVER'S SIDE OR THE PASSENGER'S SIDE OF THE ACCESSIBLE SPACE. THIS APPLIES 10 45, 60, AND 90PARKING.

ACCESSIBLE PARKING SPACES ARE TO BE LOCATED AS CLOSE TO THE STORE ENTRANCE AS POSSIBLE AND SHALL BE IDENTIFIED WITH A SIGN.

ACCESSIBLE PARKING SPACES AND ACCESS AISLES SHALL BE LEVEL WITH A SLOPE OF 1 1/2Z (2Z MAXIMUM)(EXAMPLE, 1.92 INCHES MAX VERTICAL IN 8 FEET HORIZONTAL) OR 1:50 IN ALL DIRECTIONS, THIS INCLUDES BOTH "RUNNING SLOPES" AND "CROSS SLOPES."

EACH PARKING SPACE ACCESS AISLE MUST CONNECT TO A COMMON LEVEL WITH AN ACCESSIBIL WOUTE, LE, EACH ACCESS AISLE NEXT TO A PARKING SPACE MUST HAVE A CURB RAMP AT THE WALGREENS STORE/FRONT SIDEWALK OR BLEND TO A LEVEL WALKWAY LEADING TO THE WALGREENS ENTRANCE.

3

ACCESSIBLE PARKING - SIZE AND MARKINGS

ACCESSIBLE PARKING ACCESS AISLES SHALL BE PART OF AN ACCESSIBLE ROUTE TO THE STORE ENTRANCE. THE ACCESS AISLE SHALL BE DESIGNATED WITH HIGH QUALITY YELLOW DIAGONAL SURFACE PAINT STRIPING.

ADA ALLOWS TWO PARKING SPACES TO SHARE AN ACCESS AISLE.

NO. DATE DESCRIPTION DOCUMENT ISSUES/BENCHMARKS STORE # 10573

ARCHITECTS

338 North Milwaukee S

Suite 503 Milwaukee, WI 414.223.3330

414,223,3340 fax

BUILDING

NEW . . . . . . . . . . . . . .

NEW SHELL ONLY

EXISTING .

ALBION

DRAWINGS/SPECIFICATIONS BY

☐ WALGREENS' CONSULTANT ILANDLORD'S CONSULTANT

☐ WALGREENS' CONTRACTOR

STORE

REMODELING . RELOCATION .

OTHERS

ALL CONSTRUCTION WORK, UNLESS NOTED OTHERWISE, BY


■ LANDLORD'S CONTRACTOR (TURNKEY CONSTRUCTION)


#### WALGREENS STORE


RAYMOND ROAD & WHITNEY WAY MADISON, WI

#### A.D.A. ACCESSIBLE PARKING DATA

CADD PLOT: SCALE: AS NOTED DRAWING NO. DRAWN BY: OID PLOT: C0.1 REVIEWED BY: RELEASED TO CONSTRUCTION 0578-00

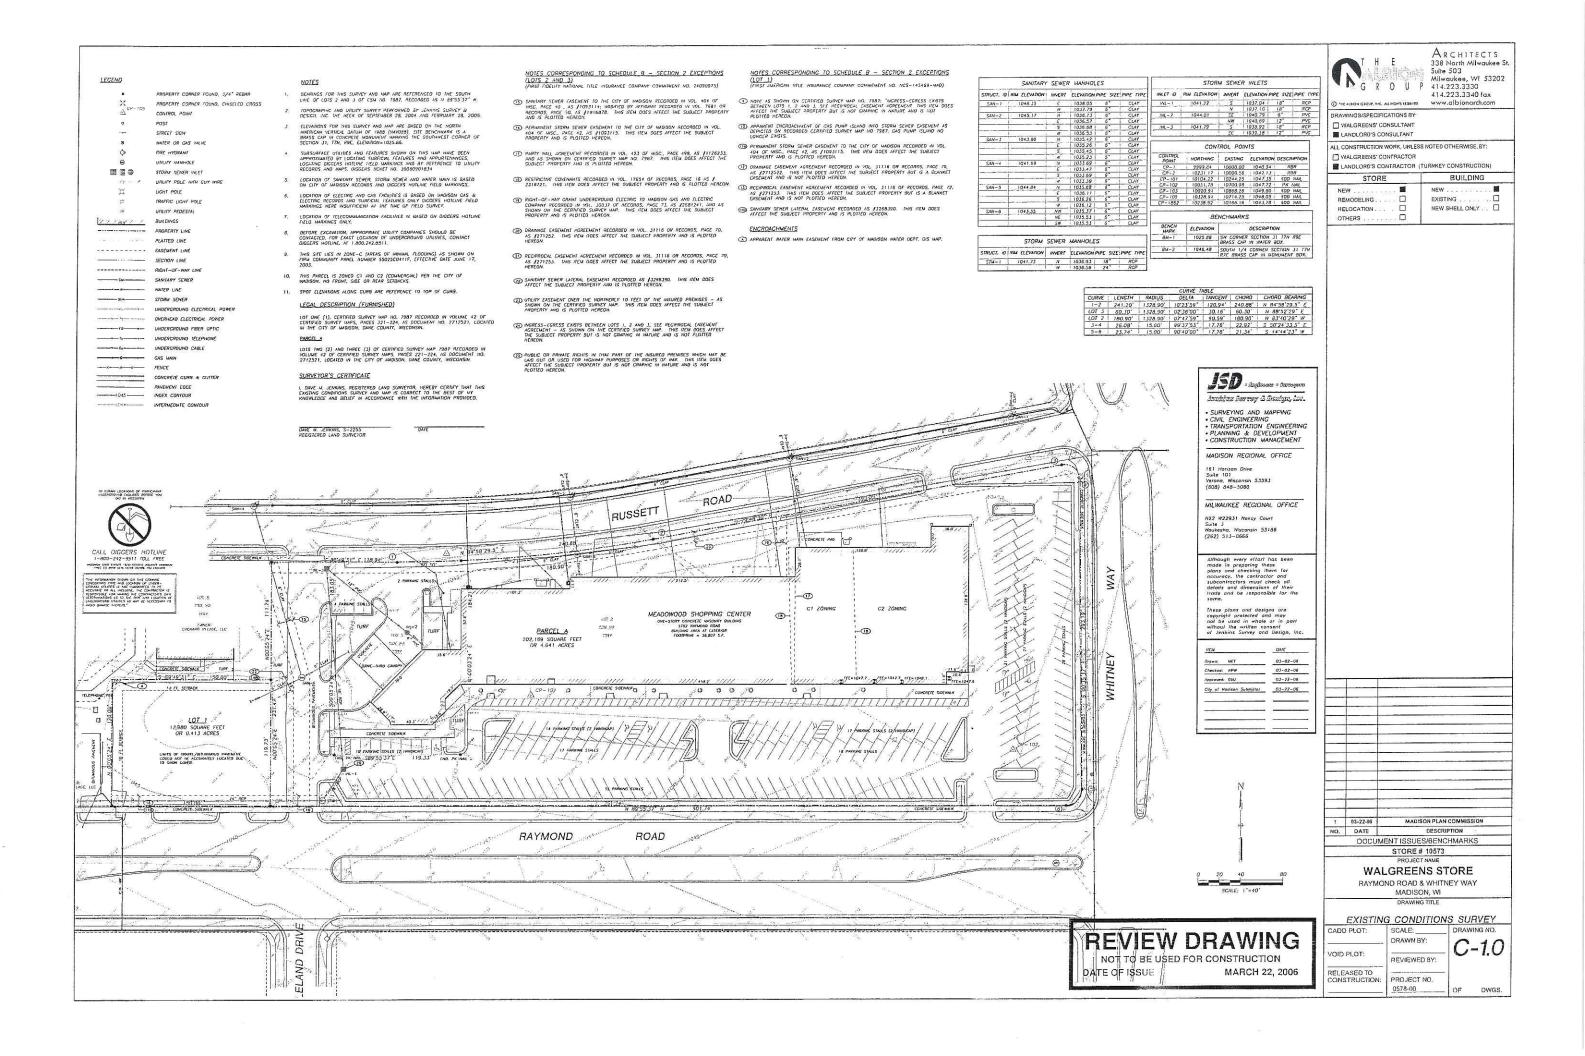

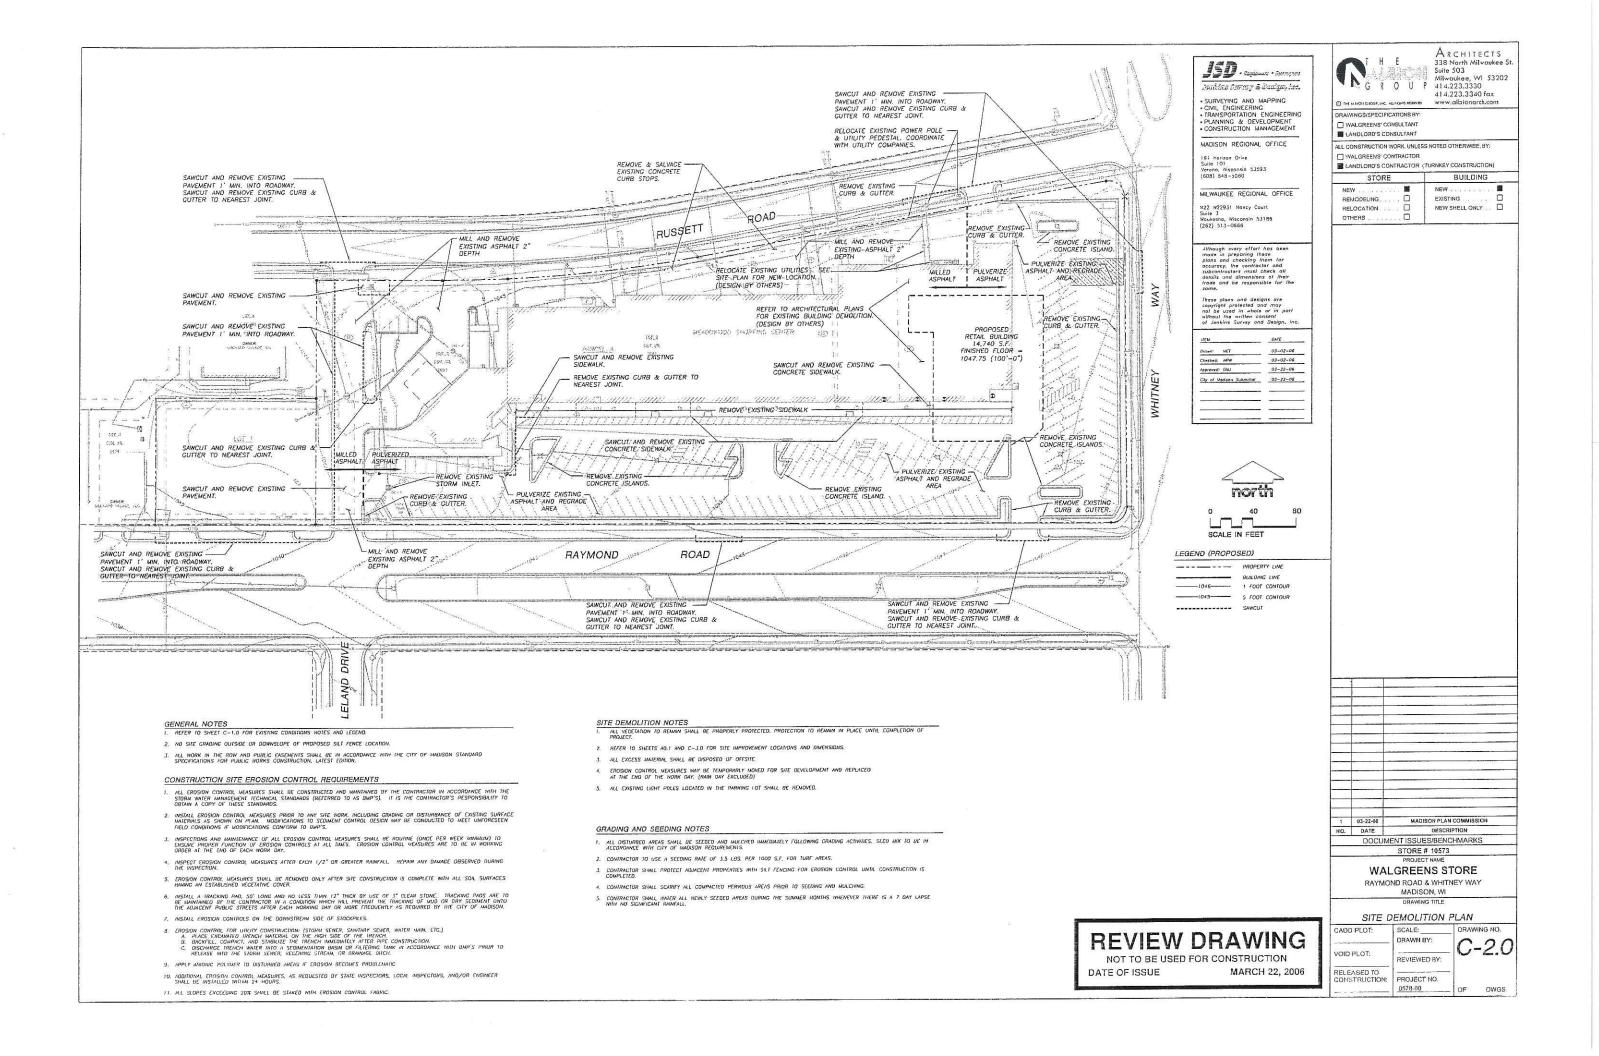

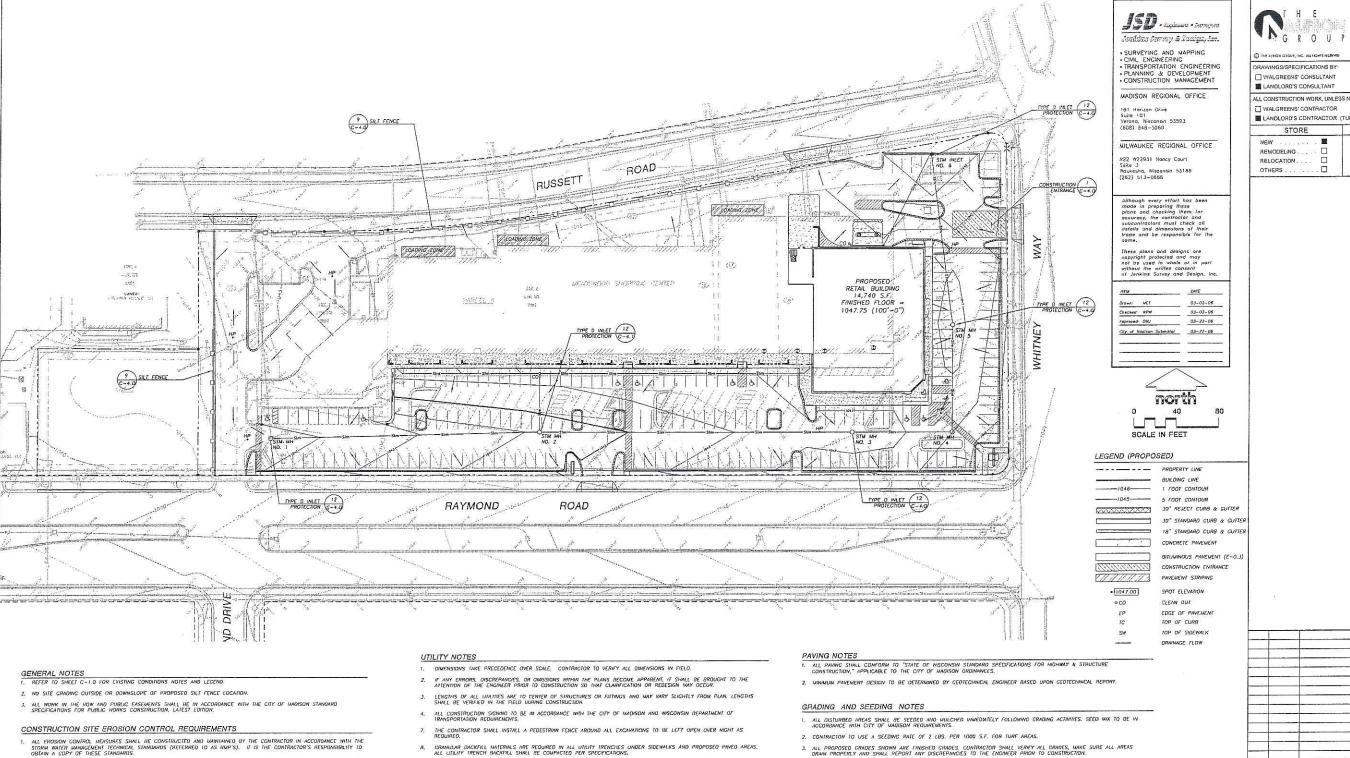

- INSTALL EROSION CONTROL MEASURES PRIOR TO ANY SHE WORK, INCLUDING GRADING OR DISTURBANCE OF EXISTING SURFACE MATERIALS AS SHOWN ON PLAN. MODIFICATIONS TO SEDMENT CONTROL DESIGN MAY BE COMDUCTED TO MEET UNFORESEEN FIELD CONDITIONS IF MODIFICATIONS COMPRIANT OF BURNEY.
- J. INSPECTIONS AND MAINTENANCE OF ALL EROSION CONTROL MEASURES SIMLL BE ROUTINE (ONCE PER WEEK MINIMUM) TO ENSURE PROPER FUNCTION OF EROSION CONTROLS AT ALL TIMES. EROSION CONTROL MEASURES ARE TO BE IN WORKING OFFICE AT THE END OF EACH WORK ON.
- INSPECT EROSION CONTROL MÉASURES AFTER EACH 1/2" OR GREATER RAINEALL. REPAIR ANY DAMAGE OBSERVED DURING THE INSPECTION.
- EROSION CONTROL MEASURES SHALL BE REMOVED ONLY AFTER SITE CONSTRUCTION IS COMPLETE WITH ALL SOIL SURFACES HAVING AN ESTABLISHED VEGETATIVE COVER.
- 6. INSTALL A TRACKING PAD, 50° LONG AND NO LESS THAN 12° THICK BY USE OF 3° CLEAR STONE. TRACKING PADS ARE IL BE MAINTAINED BY THE CONTRACTOR IN A CONDITION WHICH WILL PREVENT THE TRACKING OF MUD OR DRY SEDWENT ONTO THE ADJACENT PUBLIC STREETS AFTER EACH WORKING DAY OR MORE FREQUENTLY AS REQUIRED BY THE OFF OR MOSFON.
- 7. INSTALL EROSION CONTROLS ON THE DOWNSTREAM SIDE OF STOCKPILES.
- 8. EROSION CONTROL FOR UDLITY CONSTRUCTION (STORM SEWER, SAMILARY SEWER, WATER MAIN, ETC.).
  A. PLACE EXCHAILD TRENCH MATERIAL ON THE HIGH SIDE OF THE TRENCH.
  D. DACPULL, COUPACT, AND STABLEZ THE TRENCH MANDUATELY THE PIPE CONSTRUCTION.
  C. DISCHARGE TRENCH WATER WITO A SCOMEWIATION BASIN OF FRITRING THANK IN ACCORDANCE WITH BMP'S PRIOR TO RELEASE WITH THE STORM SEWER, RECEIVED STREAM, OR FORMANDE, WITCH.
- 4. APPLY ANIONIC POLYMER TO DISTURBED AREAS IF EROSION DECOMES PROBLEMATIC
- 10. ADDITIONAL EROSION CONTROL MEASURES, AS HEQUESTED BY STATE INSPECTORS, LOCAL INSPECTORS, AND/OR ENGINEER SHALL BE INSTALLED WITHIN 24 HOURS.
- 11. ALL SLOPES EXCEEDING 20% SHALL BE STAKED WITH EROSION CONTROL FABRIC,

- NESTGRATION OF THE EXISTING ROADWAY RICHT-OF-WAYS ARE CONSIDERED INCIDENTAL AND SHOULD BE PART OF THE COST OF THE UNDERGROUND IMPROVEMENTS AND SHOULD WILLIOE CURB & GUTTER, SIDEWALK, TOPSOIL, FERTILIZER, SEEDING
- 10. THE PROPOSED IMPROVEMENTS MUST BE CONSTRUCTED IN ACCORDANCE WITH ENGINEERING PLANS DESIGNED TO MEET ORDINANCES AND REQUIREMENTS OF THE MUNICIPALITY AND WISCONSIN DOT, DCOMM, AND DNR.
- 11. PRIDIT TO CONSTRUCTION, THE CONTRACTOR IS RESPONSIBLE FOR:

   EXAMINING ALL SITE CONDITIONS RELATIVE TO THE CONDITIONS INDICATED ON THE ENGINEERING BRAWINGS, ANY DISCREPANCES ARE OF IN REPORTED TO THE STANT OF CONSTRUCTION OF CONSTRUC

- 13. THE PRIME CONTRACTOR IS RESPONSIBLE FOR COORDINATING ALL CONSTRUCTION WITH OTHER CONTRACTORS INVOLVED WITH THE CONSTRUCTION OF THE PROPOSED DEVLOPMENT AND FOR HEPORTING ANY ERRORS OR DISCREPANCIES BETWEEN THESE FLANS AND PLANS PROPARED SY OTHERS.
- 14. ANY SABILARY SCHER, SAMBARY SCHER LATERALS, WALEHMAN, WATER SERVICES, STORM SEHER, OR OTHER UTILITIES, WHICH ARE DAMAGED BY THE COMPRACIONS, SHALL BE REPAIRED TO THE OWNER'S SABSFACTION AND AT THE CONTRACTOR'S EXPENSE.
- 16. CONTRACTOR SHOLL NOTIFY CITY OF MADISON PUBLIC STORKS A MINIMUM OF 48 HOURS BEFORE CONNECTING TO PUBLIC

- CONTRACTOR SHALL PROTECT ADJACENT PROPERTIES WITH SILT FENCING FOR EROSION CONTROL UNTIL CONSTRUCTION IS COMPLETED.
- 5. CONTRACTOR SHALL SCARIFY ALL COMPACTED PERVIOUS AREAS PRIOR TO SEEDING AND MULCHING
- 6. CONTRACTOR SHALL WATER ALL NEWLY SEEDED AREAS DURING THE SUMMER MONTHS WHENEVER THERE IS A 7 DAY LAPSE WITH NO SIGNIFICANT RAINFALL.

# **REVIEW DRAWING**

NOT TO BE USED FOR CONSTRUCTION DATE OF ISSUE MARCH 22, 2006

ARCHITECTS 338 North Milwaukee St. Suite 503 Milwaukee, WI 53202 414.223.3330 414.223.3340 fax

ALL CONSTRUCTION WORK, UNLESS NOTED OTHERWISE, BY:

LANDLORD'S CONTRACTOR (TURNKEY CONSTRUCTION)


STORE	BUILDING
NEW REMODELING DELOCATION DOTHERS	EXISTING


# MADISON PLAN COMMISSION NO. DATE DESCRIPTION DOCUMENT ISSUES/BENCHMARKS STORE # 10573


## WALGREENS STORE


RAYMOND ROAD & WHITNEY WAY

CADD PLOT:	SCALE: DRAWN BY:	_ DRAWING NO.
VOID PLOT:	REVIEWED BY:	C-3.0
RELEASED TO CONSTRUCTION.	PROJECT NO. 0578-00	OF DWGS.

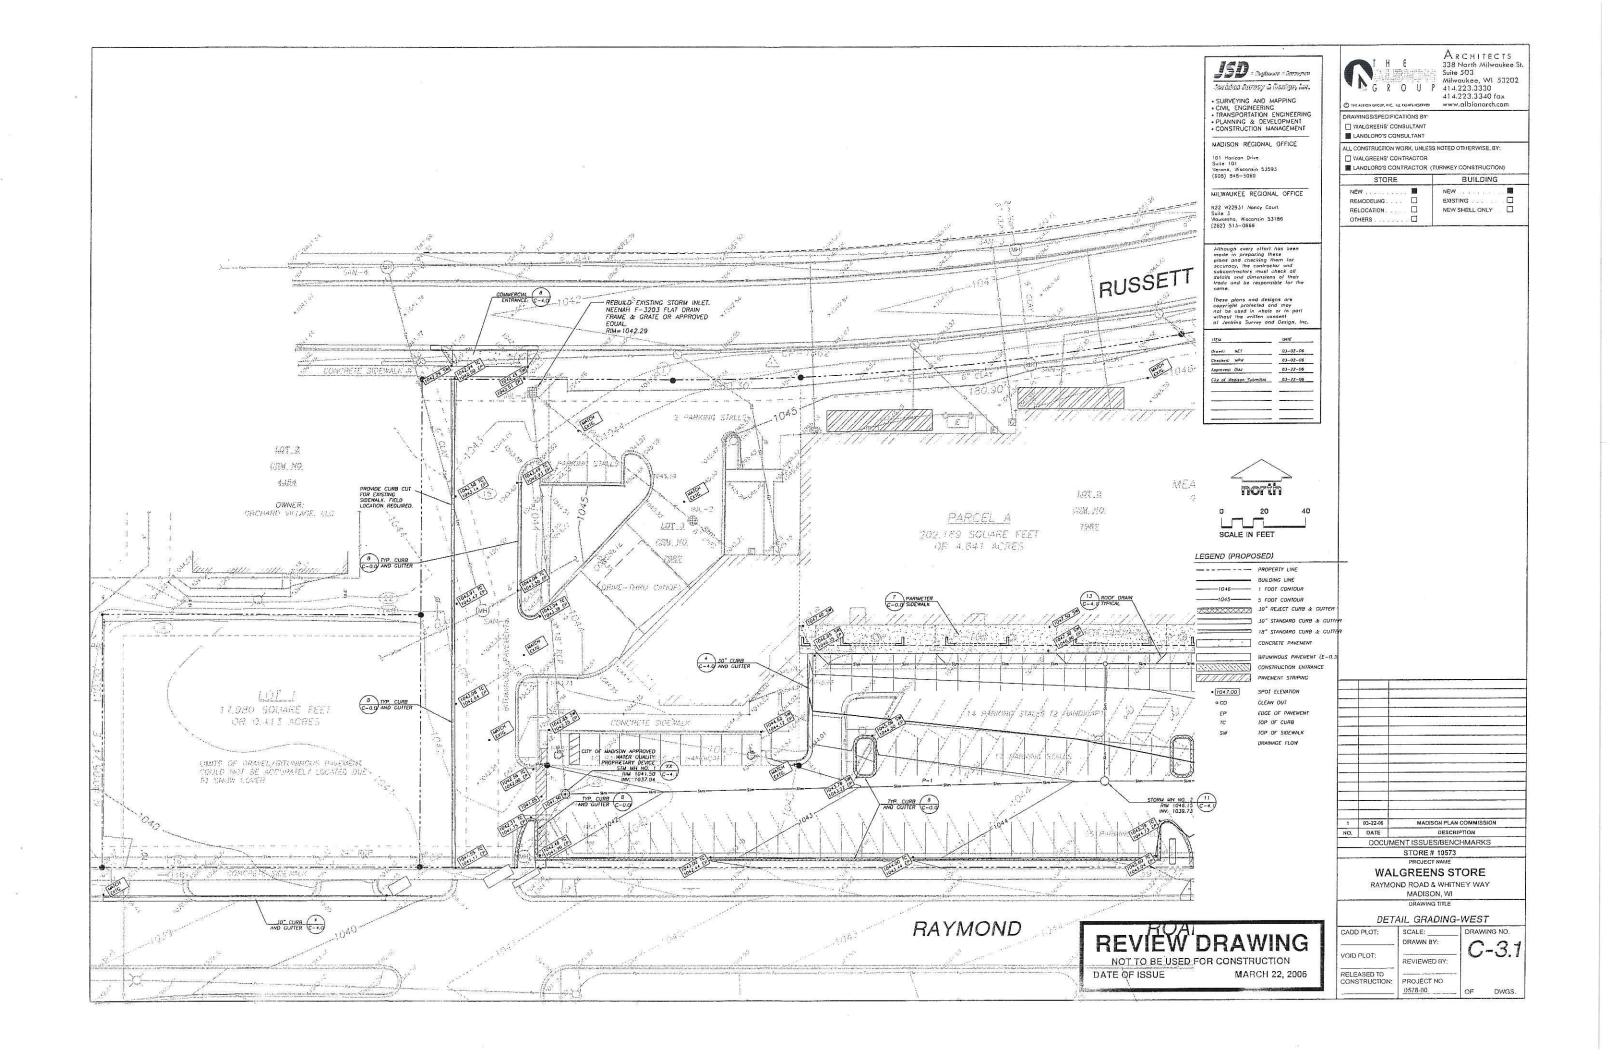

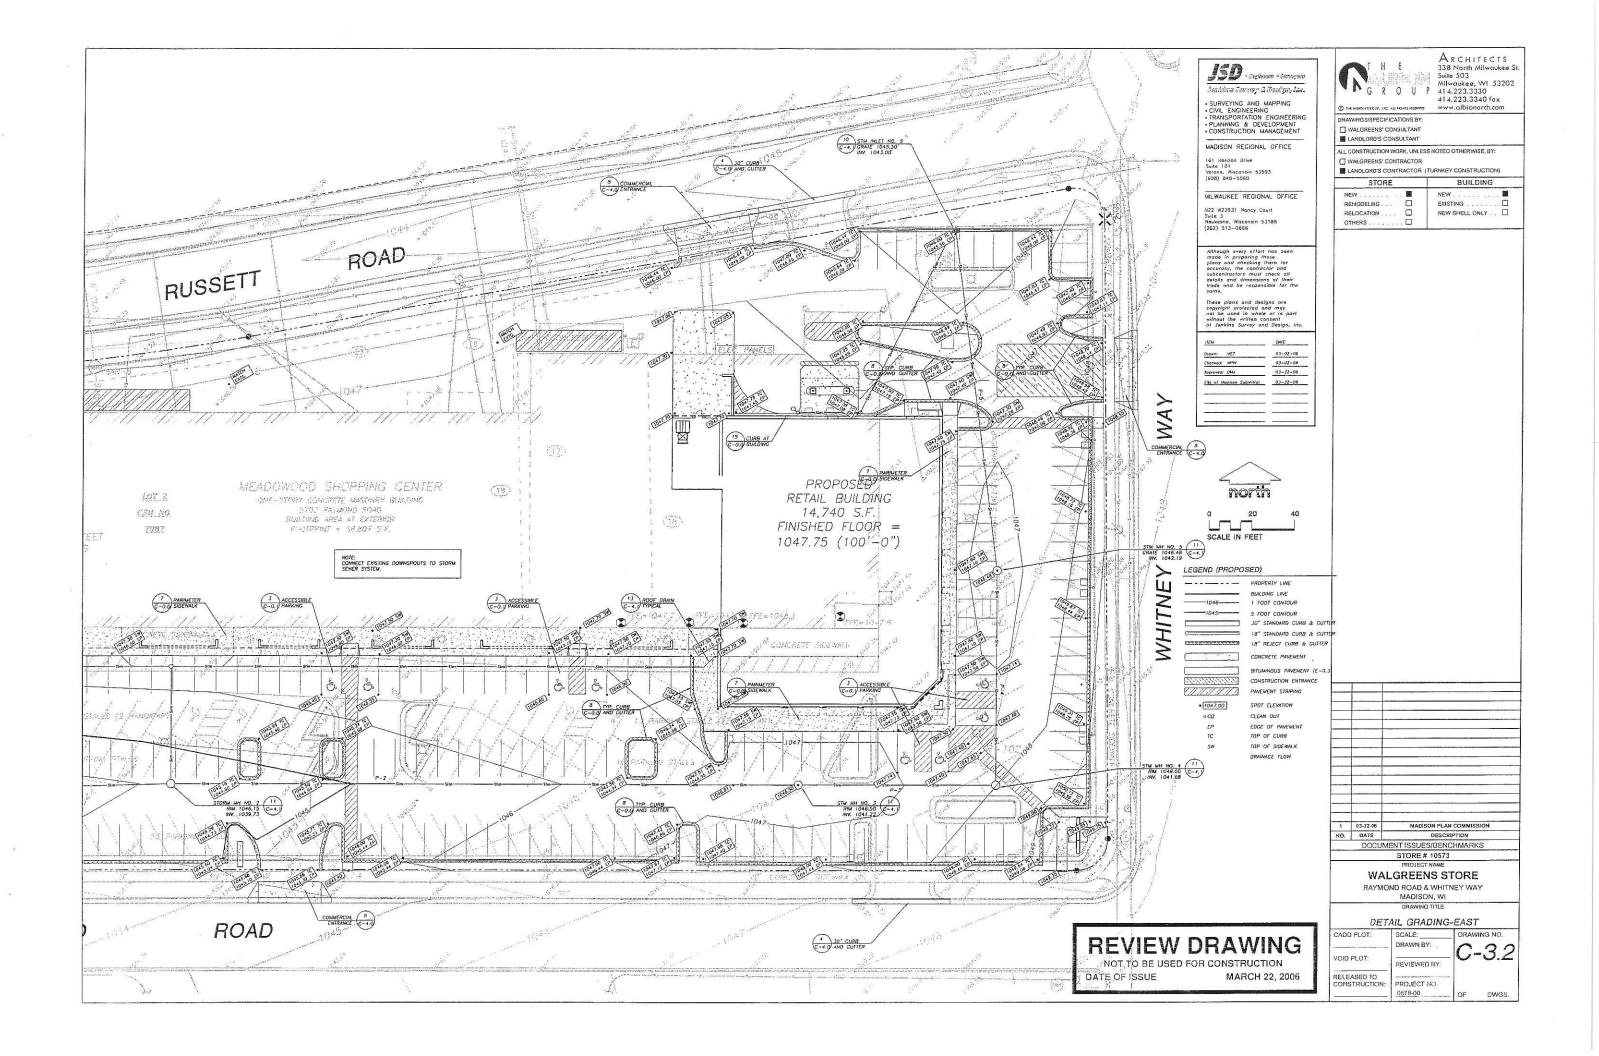

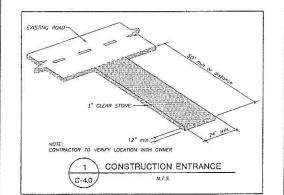

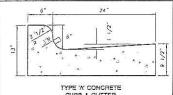



GENERAL NOTES: LATERAL CONTRACTION JOINTS SHALL BE PLACED AT INTERVALS OF NOT MORE THAN 15' NOR LESS THAN 6' IN LENGTH. THE JOINTS SHALL BE A MINIMUM OF J." IN DEPTH


EXPANSION JOINTS SHALL BE PLACED TRANSVERSLY AT RADIUS POINTS OF UNIVERS OF RADIUS 200' OR LESS, AND AT ANGLE POINTS, OR AS DIRECTED BY THE ENCHARGE. THE EXPANSION JOINT SHALL BE A ONE PIECE ASPIRITE MATERIAL WARNING THE SAME DIMENSIONS AS CURB & CUTTER AT THAT STATION AND BE 1/2" TIMEX.

IN ALL CASES, CONCRETE CURB & GUTTER SHALL BE PLACED ON THOROUGHLY COMPACTED CRUSHED STONE

4 30" STANDARD CURB & GUTTER C-4.0 N.T.S.

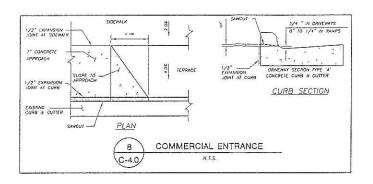

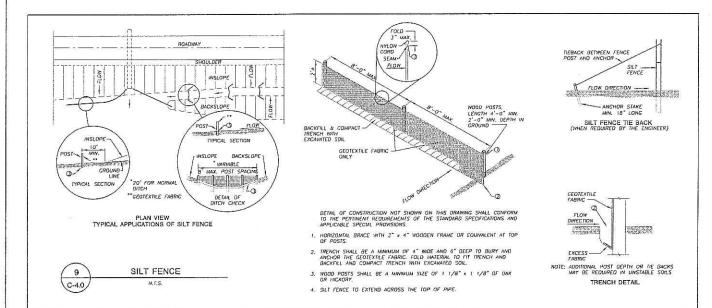

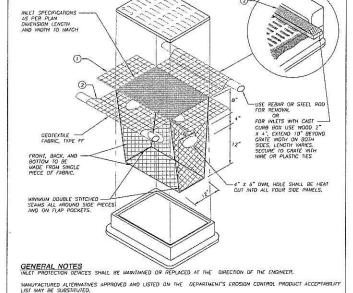

WHEN REMOVING OR MAINTAINING INLET PROTECTION. CARE SHALL BE TAKEN SO THAT THE SEDIMENT TRAPPED ON THE GEOTEXTILE FABRIC DOES NOT FALL INTO THE MILET, MAY MATERIAL FALLING INTO THE MILET SHALL BE REMOVED IMMEDIATELY.

(2) FLAP POCKETS SHALL BE LARGE ENOUGH TO ACCEPT WOOD 2X4.

C-4.0

TRIM EXCESS FABRIC IN THE FLOW LINE TO WITHIN 3" OF THE GRATE.

① FHISHED SIZE, WCLUDING FLAP POCKETS WHERE REQUIRED, SHALL EXTEND A MINIMUM OF 10° AROUND THE PERIMETER TO FACULTATE MAINTENANCE OR REMOVAL.

INSTALLATION NOTES
DO NOT INSTALL ORLET PROTECTION TYPE D IN INLETS SHALLOWER THAN 30", MEASURED FROM THE BOTTOM OF THE
MINET TO THE ORD OF THE GRATE.

THE INSTALLED BAG SMALL HAVE A MINIMUM SIDE CLEARANCE. DETWEEN THE UNLET WALLS AND THE BAG, MEASURED AT THE BOTTOM OF THE OVERFLOW HOLES, OF 3". WHERE NECESSARY THE CONTRACTOR SHALL CINCH THE BAG, USING MASTEL 2PT IES, TO AGNEVE THE 3" CLEARANCE. THE NES SHALL BE PLACED AT A MAXIMUM OF 4" FROM THE BOTTOM OF THE BOT. 12 INLET PROTECTION, TYPE D N.T.S.

*JSD : taylasses : taxosyne*e isaldau Survey & Design, i.e.

- SURVEYING AND MAPPING
  CIVIL ENGINEERING
  TRANSPORTATION ENGINEERING
  PLANNING & DEVELOPMENT
  CONSTRUCTION MANAGEMENT

MADISON REGIONAL OFFICE

161 Horizon Orive Suite 101 Verona, Wisconsin 53593 (608) 848-5060

MILWAUKEE REGIONAL OFFICE

N22 W22931 Nancy Court Suite 3 Waukesha, Wisconsin 53186 (262) 513-0666

Although every effort has been made in preparing these plans and checking them for accuracy, the contractor and subcontractors must check all details and dimensions of their lade and be responsible for the same.

Drawn:	HET	0.1-02-06
Checked:	WPW	03-02-06
Approved:	DW	03-22-06
City of We	saison Submittal	03-22-06

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338 North Milwaukee St.
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RAWINGS/SPECIFICATIONS BY

T WALGREENS' CONSULTANT ■ LANDLORD'S CONSULTANT

ALL CONSTRUCTION WORK, UNLESS NOTED OTHERWISE, BY: ☐ WALGREENS' CONTRACTOR

LANDLORD'S CONTRACTOR (TURNKEY CONSTRUCTION)

STORE	BUILDING
ELOCATION .	NEW EXISTING

IN COURSE CONTINUE OF PARTICIPAL TON



**REVIEW DRAWING** 

NOT TO BE USED FOR CONSTRUCTION MARCH 22, 2006 DATE OF ISSUE

DETAILS DRAWING NO. CADD PLOT: SCALE: DRAWN BY: C - 4.0VOID PLOT: REVIEWED BY: RELEASED TO CONSTRUCTION: PROJECT NO. 0578-00 DWGS.


DOCUMENT ISSUES/BENCHMARKS STORE # 10573 WALGREENS STORE


RAYMOND ROAD & WHITNEY WAY MADISON WI


MADISON PLAN COMMISSION

1 03-22-06

NO. DATE

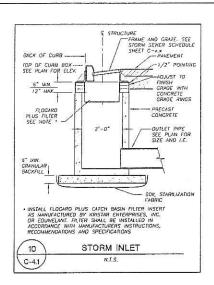

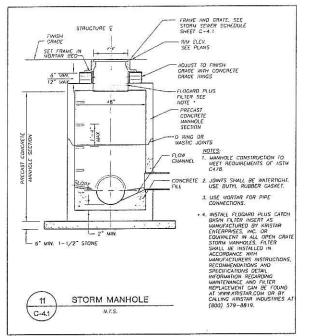

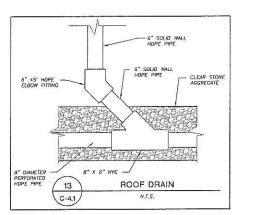

LABEL	INVERT ELEV. (FT)	RIM ELEV. (FT)	DEPTH (FT)	STRUCTURE DESCRIPTION	FRAME/ GRATE
MH NO. 1	1037.04	1041.50		* WATER QUALITY PROPR	IETARY DEVICE - SEE DETAIL SPECIFICATIONS
MH NO. 2	1039.73	1046.15	6.42	4' DIA. MANHOLE	R-1550A MANHOLE FRAME - TYPE D GRATE
MH NO. 3	1041.22	1046.50	5.28	4' DIA. MANHOLE	R-1550A MANHOLE FRAME - TYPE D GRATE
MH NO. 4	1041.68	1048.00	6.32	4' DIA. MANHOLE	R-1550A MANHOLE FRAME - SOLID LID NON-ROCKING
MH NO. 5	1042.19	1046.48	4.29	4' DIA. MANHOLE	R-1550A MANHOLE FRAME - TYPE D GRATE
NLET NO. 6	1043.00	1045.50	2.50	2'x 3'INLET BOX	R-3067, CURB INLET FRAME, GRATE, CURB BOX - TYPE R GRAT

4 4 9 0 0 0 0 0 0 0 0 0 0 0 0 0 0 0 0 0		PROPOSED STORM SEWER PIPE SO		E SCHEDULE			
PIPE LABEL	FROM	то	LENGTH (FT)	INVERT ELEVATION (FT)	DISCHARGE ELEVATION (FT)	SLOPE (%)	PIPE SIZE & TYPE
P-1	MH NO. 1	MH NO. 2	254.63	1039.73	1037.69	0.80%	18"HDPE
P-2	MH NO. 2	MH NO. 3	297.05	1041.22	1039.73	0.50%	18"HDPE
P-3	MH NO. 3	MH NO. 4	92.70	1041.68	1041.22	0.50%	18"HDPE
P-4	MH NO. 4	MH NO. 5	101.82	1042.19	1041.68	0.50%	18"HDPE
P - 5	MH NO. 5	INLET NO. 6	162.28	1043.00	1042.19	0,50%	15"HDPE



ISD : inglasses : innergree isaldas Suresy i Beriga, izc.

SURVEYING AND MAPPING
CIVIL ENGINEERING
TRANSPORTATION ENGINEERING
PLANNING & DEVELOPMENT
CONSTRUCTION MANAGEMENT

MADISON REGIONAL OFFICE

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	03-02-06
Checked: MPW	03-02-06
Approved: OW	03-22-06
City of Modison Submittal	03-22-06
City of Modison Submittal	03-22-

ARCHITECTS G R O U P 414.223.3330

O PA AISON GROUP, PC. AIL FORT SEASON

WWW.allbionarch.com

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BUILDING	
IG □	
	HELL ONLY

**REVIEW DRAWING** 

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17.00		
1	03-22-06	MADISON PLAN COMMISSION
NO.	DATE	DESCRIPTION
	DOCU	MENT ISSUES/BENCHMARKS
	S75	STORE # 10573
		PROJECT NAME
	VAL	AL GREENS STORE

RAYMOND ROAD & WHITNEY WAY MADISON, WI DETAILS

DRAWING NO.

DWGS.

SCALE:

DRAWN BY:

REVIEWED BY:

PROJECT NO. 0578-00

CADD PLOT:

VOID PLOT:

RELEASED TO CONSTRUCTION:

