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	NJH	JMS
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04.08.24 UDC Submittal 04.29.24 UDC Submittal



 \blacksquare Project Info. — 24025 — LIGHTHOUSE CHRISTIAN SCHOOL ADDITION

6402 SCHROEDER ROAD MADISON, WI 53711


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EXISTING ROOF


45'-0"ADDITION


SLOPE JOISTS 1/4" PER FOOT


PARTIAL ROOF PLAN


SCALE: 1/8"=1'-0" (30x42)

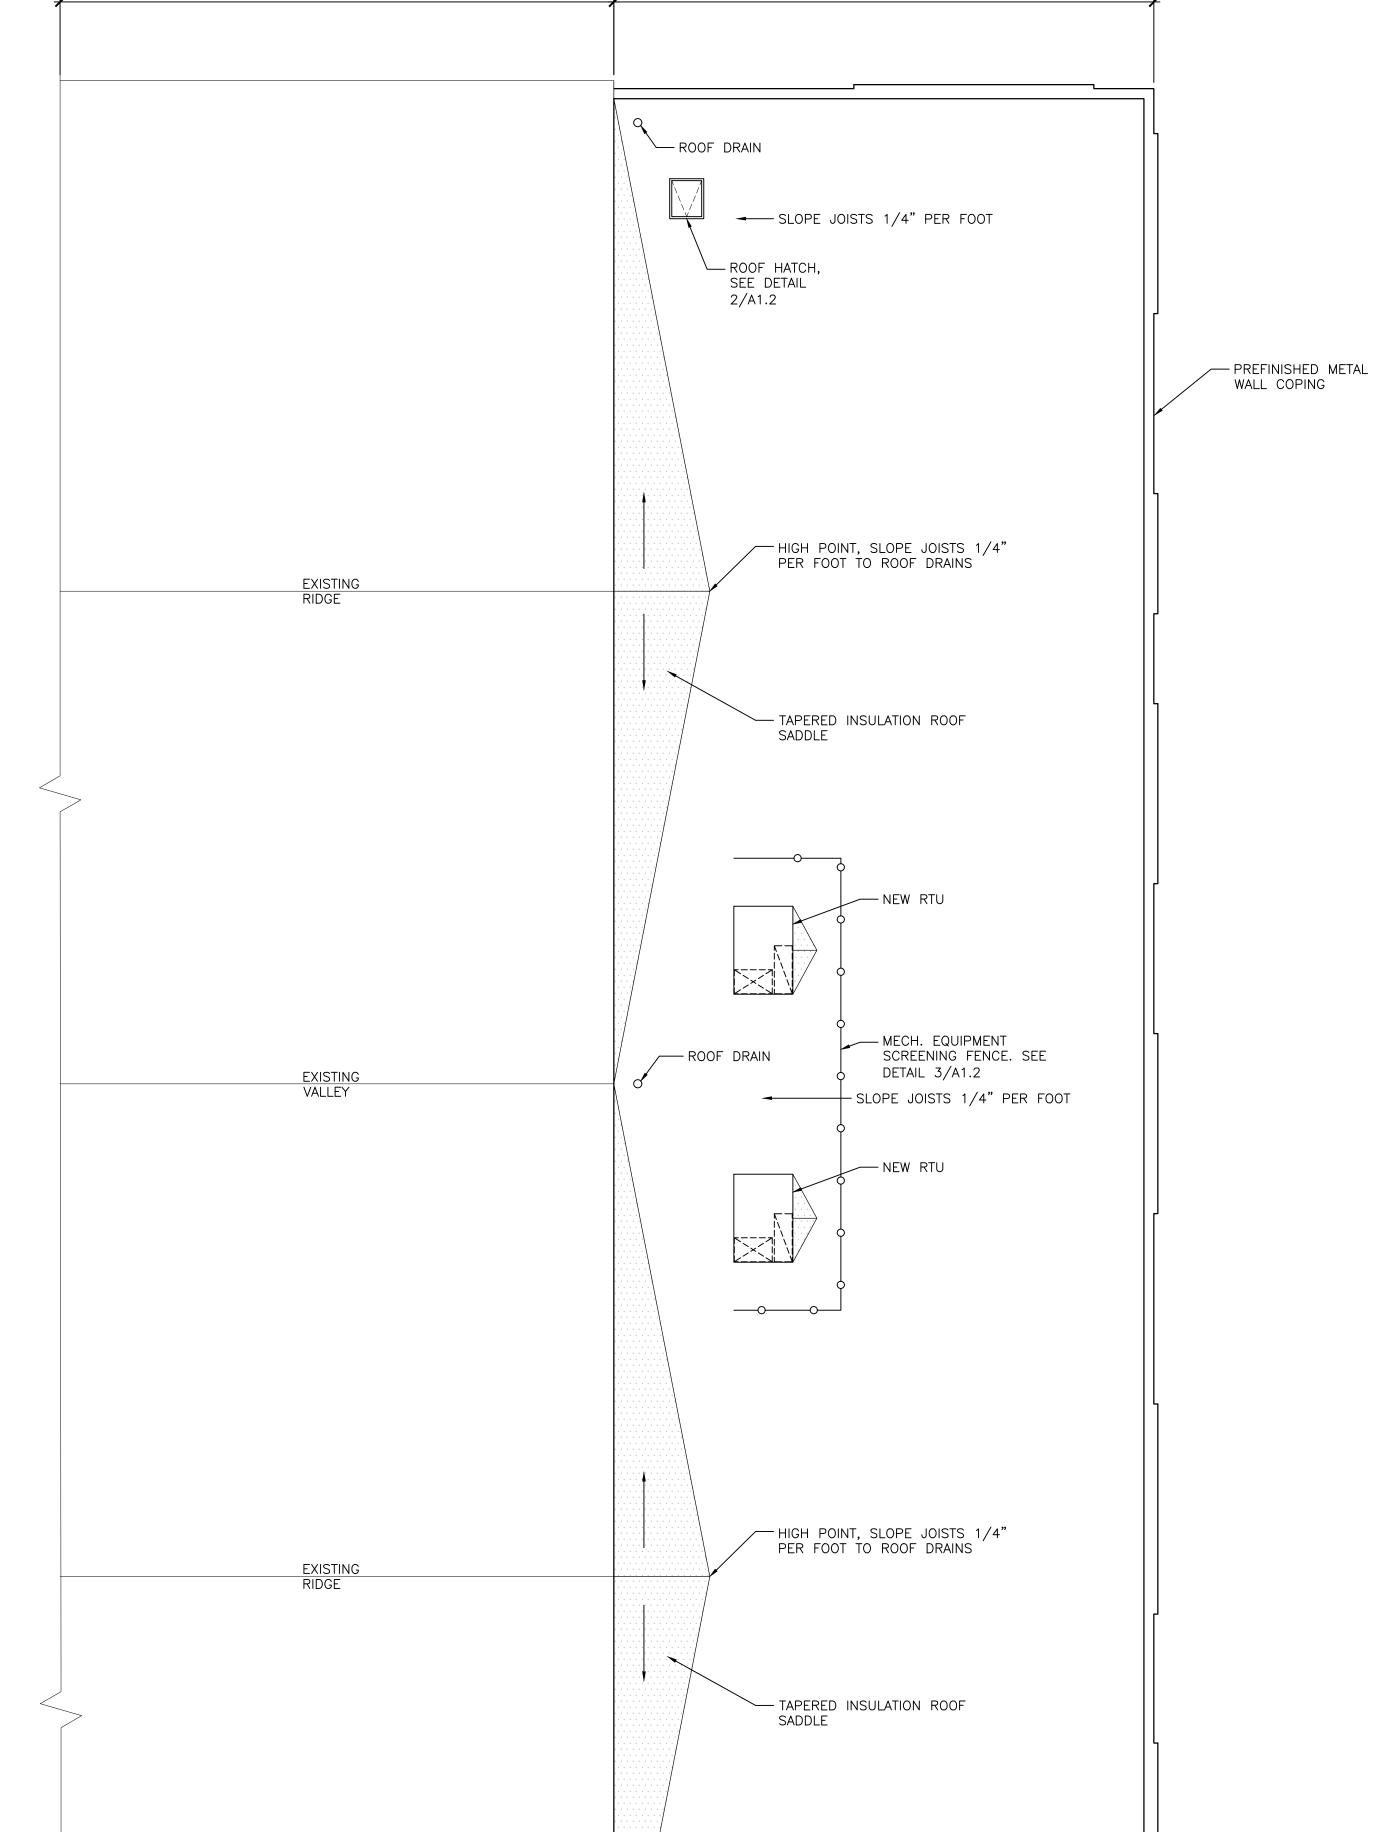
POOF DRAIN

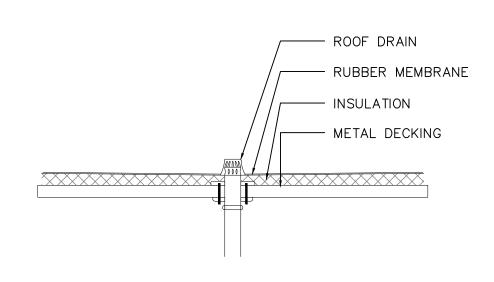

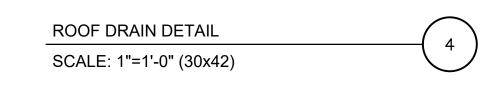

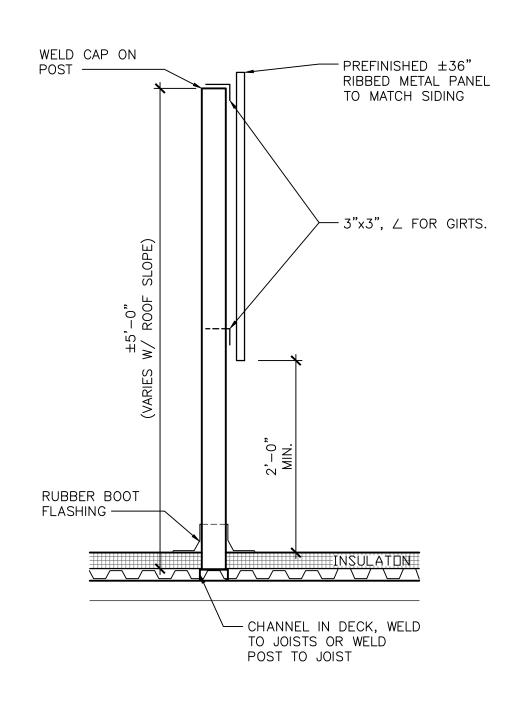

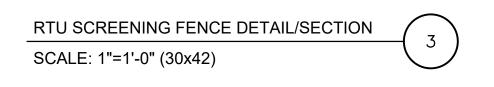

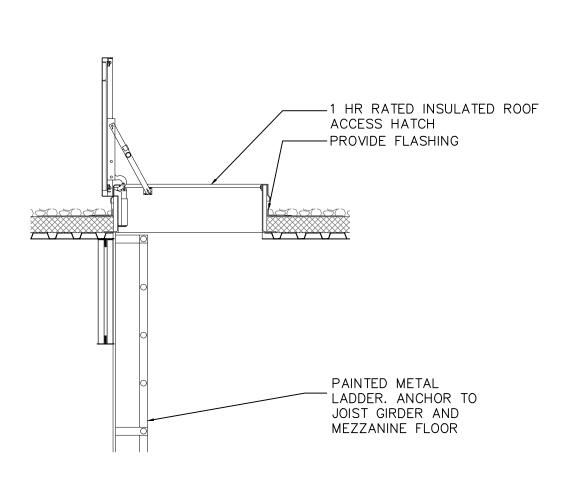

ROOF HATCH/LADDER DETAIL SCALE: 1/2"=1'-0" (30x42)



Architect 259 South Street, Suite A WAUKESHA, WI 53186 p: 833-380-6180 Project Info. — 24025 —

LIGHTHOUSE CHRISTIAN SCHOOL

6402 SCHROEDER ROAD MADISON, WI 53711

Sheet Title ———

ADDITION

EXISTING GOOGLE STREET VIEW - OCT. 2023 SCALE: NTS

EXISTING WEST ELEVATION - SEE SHEET A2.1 FOR PROPOSED ELEVATIONS / SCALE: 1/8"=1'-0" (30x42)

EXISTING SOUTH ELEVATION - SEE SHEET A2.1 FOR PROPOSED ELEVATIONS SCALE: 1/8"=1'-0" (30x42)

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Sheet No. ——

EXISTING EAST ELEVATION - SEE SHEET A2.1 FOR PROPOSED ELEVATIONS

SCALE: 1/8"=1'-0" (30x42)

BIRD SAFE GLASS ORDINANCE

- PER 28.129(4)(a)2.
 FOR BUILDING FAÇADES WHERE THE FIRST SIXTY (60) FEET FROM GRADE ARE COMPRISED OF LESS
- THAN FIFTY PERCENT (50%) GLASS: a. AT LEAST EIGHTY-FIVE PERCENT (85%) OF THE GLASS ON GLASS AREAS FIFTY (50) SQUARE FEET OR OVER MUST BE TREATED; AND
- O. OF ALL GLASS AREAS OVER FIFTY (50) SQUARE FEET, ANY GLASS WITHIN FIFTEEN (15) FEET OF A BUILDING CORNER MUST BE TREATÉD.

BIRD SAFE GLASS CALCULATIONS

SOUTH ELEVATION AREA = 2,265 S.F. SOUTH ELEVATION WINDOW AREA = 327.5 S.F.

EAST ELEVATION AREA = 590 S.F. EAST ELEVATION WINDOW AREA = 51 S.F.

WEST ELEVATION AREA = 669 S.F.

WEST ELEVATION WINDOW AREA = 135 S.F.

WINDOW AREA LESS THAN 50% OF FACADE TYP. WINDOW AREA (SINGLE) = 13 S.F.TYP. WINDOW AREA (PAIR OF WINDOWS) = 25.5 S.F.

PROVIDING BIRD SAFE GLAZING AT SWC CLUSTER OF WINDOWS ON SOUTH AND WEST FACADE PER ORDINANCE

TYP. WINDOW AREA (3 SETS OF WINDOWS) = 38.2 S.F.

| ELEVATION KEYNOTES

- $\langle 1 \rangle$ METAL PANEL SIDING = PAC-CLAD HIGHLINE B2, COLOR- STONE WHITE
- 2 METAL PANEL SIDING = PAC-CLAD HIGHLINE S2, COLOR PACIFIC BLUE
- COMPOSITE SIDING = AZEK TIMBERTECH CLOSED JOINT SIDING, COLOR ENGLISH WALNUT.
- 4 ALUMINUM STOREFRONT, COLOR DARK BRONZE.
- 5 1" INSULATED, CLEAR, LOW-E GLAZING
- 6 1" INSULATED, CLEAR, LOW-E GLAZING W/ BIRD SAFE FILM/PATTERN
- 1" INSULATED ALUMINUM PANEL. VARIOUS COLORS TO MATCH PAC-CLAD // INTERSTATE BLUE, BONE WHITE, AND BERKSHIRE BLUE.
- $\langle 8 \rangle$ PRE-FINISHED METAL COPING. COLOR TO MATCH WALL (BELOW) COLOR.
- 9 INSULATED METAL EXIT DOOR. PAINT TO MATCH ADJACENT WALL COLOR.
- (10) EXISTING BUILDING NO CHANGE TO MATERIALS
- METAL PANEL RTU SCREENING = PAC-CLAD HIGHLINE MI, COLOR STONE WHITE






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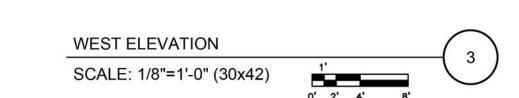
LIGHTHOUSE CHRISTIAN SCHOOL **ADDITION**


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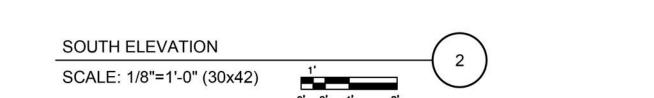
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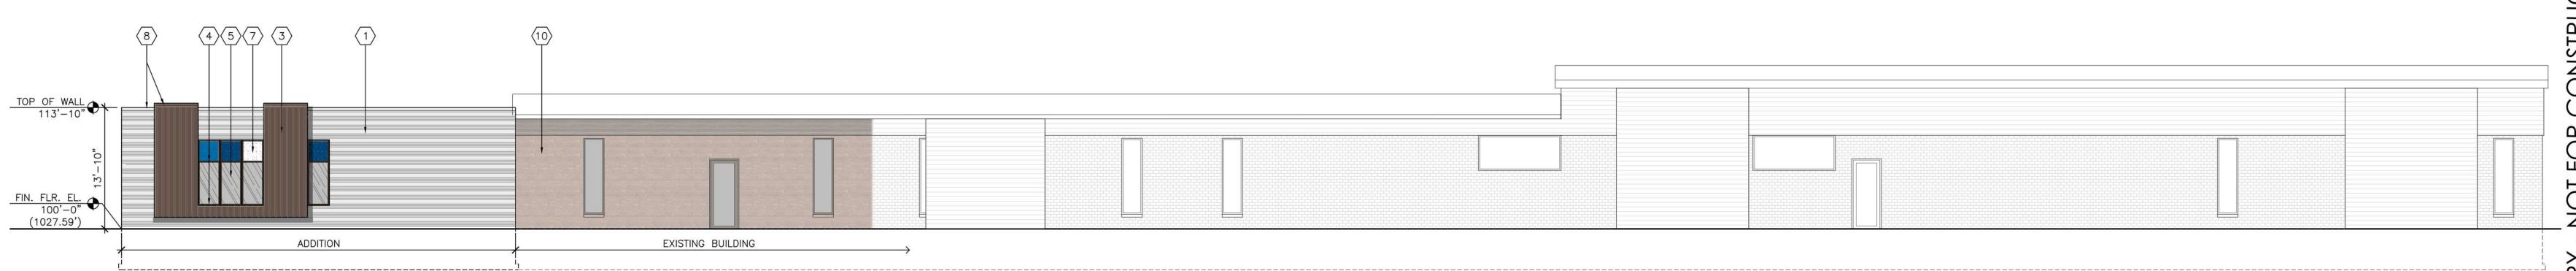








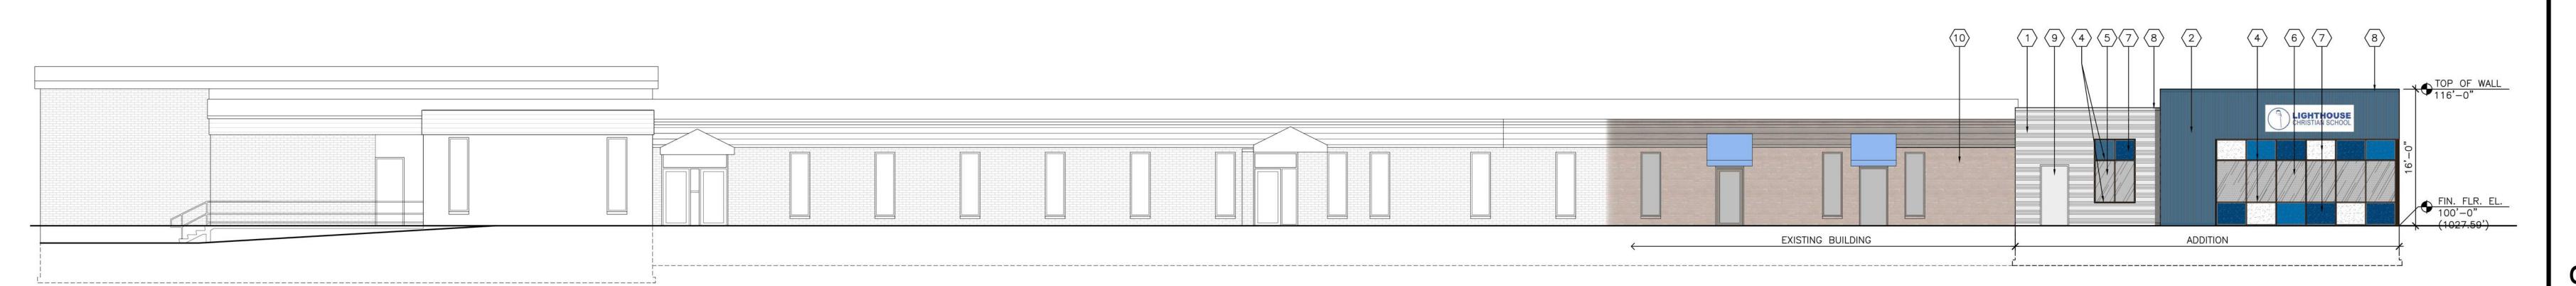

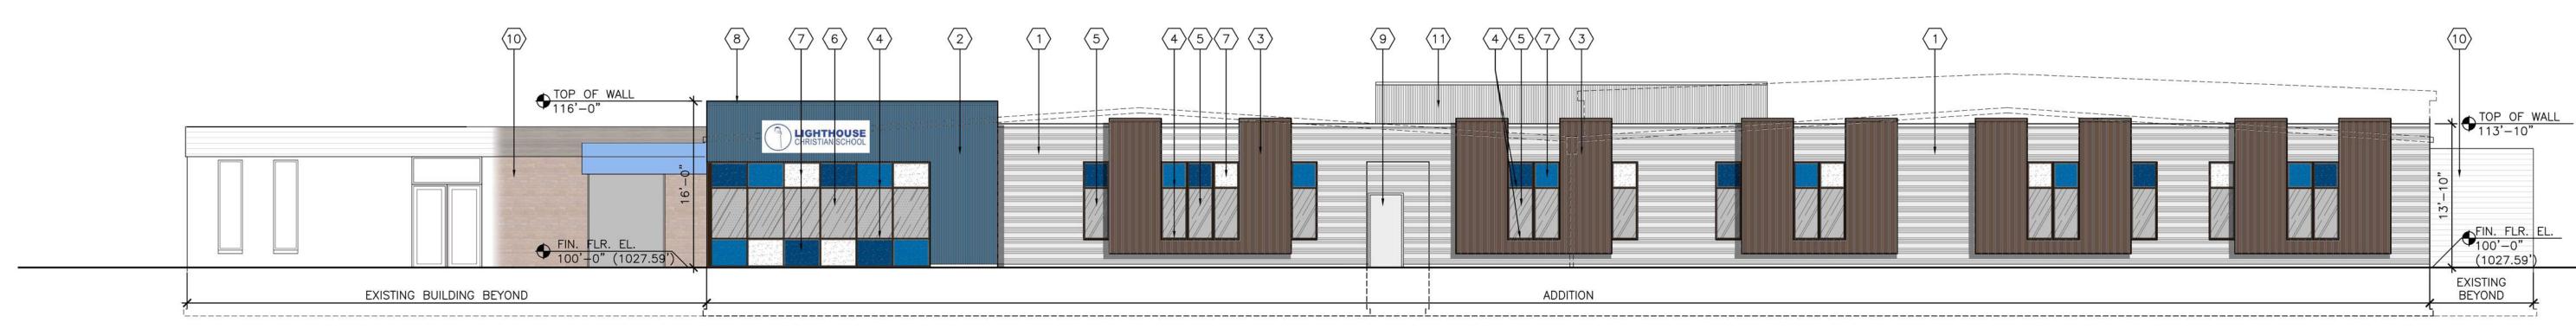

EAST ELEVATION SCALE: 1/8"=1'-0" (30x42)

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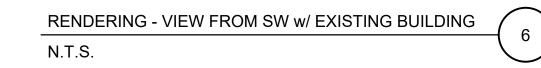
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-Sheet Title ----






RENDERING - VIEW FROM SE w/ EXISTING BUILDING N.T.S.



PERSPECTIVE RENDERING VIEW FROM SW N.T.S.

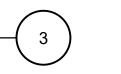







PERSPECTIVE RENDERING VIEW FROM SE



PERSPECTIVE RENDERING VIEW FROM SW - SCHROEDER AND LAURIE

N.T.S.



PERSPECTIVE RENDERING VIEW FROM SW N.T.S.

■Sheet No. ——

BONE WHITE

TIMBERTECH® CLADDING



STONE WHITE



INSULATED ALUMINUM WINDOW INFILL PANELS ELEVATION KEYNOTE 7

Vitro Architectural Glass

Product Data Sheet



Aesthetic Description

Solarban® 70 glass (formerly Solarban® 70XL glass) is a solar control, low-e glass that brilliantly combines the clear appearance of transparent, color-neutral glass with an exceptional combination of solar control and visible light transmittance (VLT), The world's first triple-silver, magnetron sputter vacuum

deposition (MSVD) coating, Solarban® 70 glass expands the design possibilities for buildings in two important ways. First, Solarban* 70 glass enables architects to incorporate vast areas of vision glass into their designs without a corresponding increase in cooling equipment capacity.

Second, architects can specify a clear aesthetic while achieving solar control performance that was once attainable only through the use of tinted glass and a solar control, low-e coating in an insulated glass unit (IGU).

Performance Options

When coupled with conventional clear glass in a one-inch IGU, Solarban* 70 glass achieves a Visible Light Transmittance (VLT of 64 percent and a Solar Heat Gain Coefficient (SHGC) of 0.27 to produce a Light to Solar Gain (LSG) ratio of 2.37, making it one of the industry's highest-performing glasses.

The clear aesthetic of Solarban® 70 glass also makes the product exceptionally versatile, offering architects an extensive array of performance and appearance options. For instance, for projects that require advanced solar control performance, Solarban" 70 glass can be coated on the second (#2) surface of nearly all of



Location: Dallas, TX | Product: Solarbon® 70XL Glass | Architect of Record: PageSoutherlandPage | Design Architect: Gromatzky Dupree & Associates | Glass Fabricator: Trulite Glass and Aluminum Solutions | Glazing Contractor: Haley-Green

Vitro Architectural Glass' (formerly PPG glass) wide range of tinted glasses to produce SHGCs as low as 0.19 and LSG ratios ranging from 1.68 to 2.15.

For more color and reflectivity choices, Solarban® 70 glass may be specified on the third (#3) surface of an IGU behind a tinted lite or in combination with Solarcool® reflective or Vistacool® subtly reflective color-enhanced glasses.



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1" - INSULATED, LOW-E GLAZING & BIRD GLAZING ELEVATION KEYNOTES 5 & 6




METAL PANEL SIDING = PAC-CLAD HIGHLINE S2, COLOR - PACIFIC BLUE **ELEVATION KEYNOTE 2**

15.356" NOMINAL







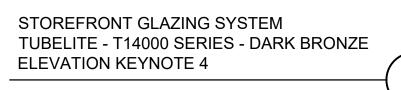


DARK BRONZE (DB)



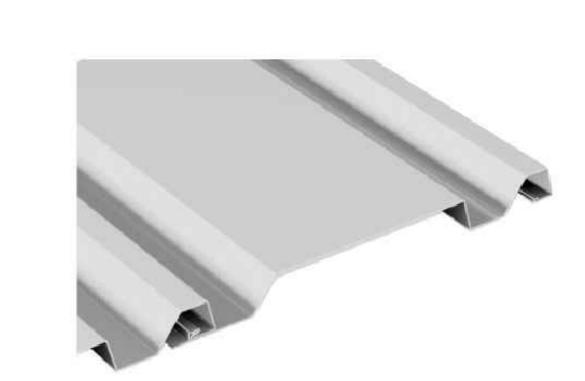

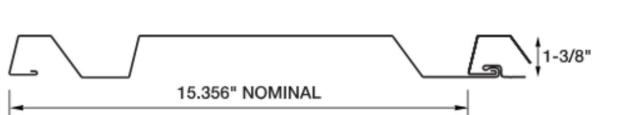

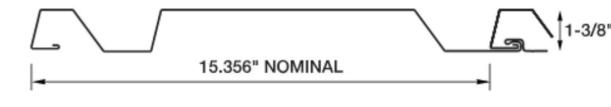

METAL PANEL SIDING = PAC-CLAD HIGHLINE B2, COLOR- STONE WHITE **ELEVATION KEYNOTE 1**

English Walnut

AZEK TIMBERTECH CLOSED JOINT SIDING

COLOR - ENGLISH WALNUT

ELEVATION KEYNOTE 3



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1-3/8"