

**APPLICATION FOR
URBAN DESIGN COMMISSION
REVIEW AND APPROVAL**

AGENDA ITEM # _____

Project # _____

51013

DATE SUBMITTED: 4/20/2011

Action Requested

Informational Presentation

Initial Approval and/or Recommendation

Final Approval and/or Recommendation

UDC MEETING DATE: 4/27/2011

PROJECT ADDRESS: 3550 ANDERSON STREET

ALDERMANIC DISTRICT: 17

OWNER/DEVELOPER (Partners and/or Principals)

MADISON AREA TECHNICAL COLLEGE

3550 ANDERSON STREET

MADISON, WI 53704

ARCHITECT/DESIGNER/OR AGENT:

STRANG, INC

PLUNKETT RAYSICH ARCHITECTS

6411 MINERAL POINT RD 11000 WEST PARK PLACE

MADISON, WI 53705 MILWAUKEE, WI 53224

CONTACT PERSON: LARRY BARTON

NICHOLAS KENT

Address: STRANG, INC
(SEE ABOVE)

PLUNKETT RAYSICH ARCHITECTS
(SEE ABOVE)

Phone: (608) 276-4200

(414) 359-3060 EXT 168

Fax: (608) 276-4204

(414) 359-3070

E-mail address: BARTON@STRANG-INC.COM NKENT@PRARCH.COM

TYPE OF PROJECT:

(See Section A for:)

- Planned Unit Development (PUD)
- General Development Plan (GDP)
- Specific Implementation Plan (SIP)
- Planned Community Development (PCD)
- General Development Plan (GDP)
- Specific Implementation Plan (SIP)
- Planned Residential Development (PRD)
- New Construction or Exterior Remodeling in an Urban Design District * (A public hearing is required as well as a fee)
- School, Public Building or Space (Fee may be required)
- New Construction or Addition to or Remodeling of a Retail, Hotel or Motel Building Exceeding 40,000 Sq. Ft.
- Planned Commercial Site

(See Section B for:)

- New Construction or Exterior Remodeling in C4 District (Fee required)

(See Section C for:)

- R.P.S.M. Parking Variance (Fee required)

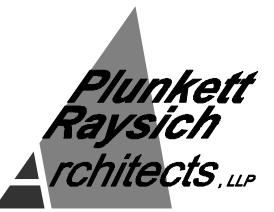
(See Section D for:)

- Comprehensive Design Review* (Fee required)
- Street Graphics Variance* (Fee required)
- Other _____

*Public Hearing Required (Submission Deadline 3 Weeks in Advance of Meeting Date)

Where fees are required (as noted above) they apply with the first submittal for either initial or final approval of a project.



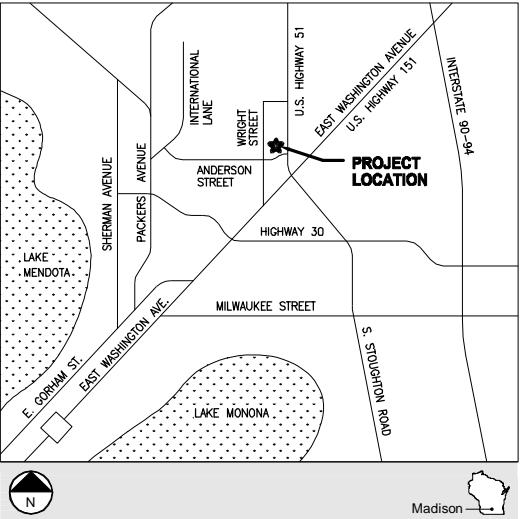


TRUAX CAMPUS GATEWAY & STUDENT ACHIEVEMENT CENTER • INGENUITY CENTER & TRANSPORTATION AND ADVANCED SUSTAINABLE MANUFACTURING CENTER (TASMC)



MADISON COLLEGE
3550 Anderson St., Madison, WI 54704

Site Location Map



Design Team:

Architectural Design
PLUNKETT RAYSICH ARCHITECTS, LLP
STRANG, INC.

Construction Manager
J.H. FINDORFF & SON, INC.

Structural Design
KJWW ENGINEERING CONSULTANTS
ARNOLD & O'SHERIDAN

Utility/Infrastructure/Civil Engineering
JSD PROFESSIONAL SERVICES

Site Civil & Landscape Design
SAA DESIGN GROUP

Plumbing Design
KJWW ENGINEERING CONSULTANTS
STRANG, INC.

Mechanical Design
KJWW ENGINEERING CONSULTANTS
PEARSON ENGINEERING / STRANG, INC.

Electrical Design
KJWW ENGINEERING CONSULTANTS
STRANG, INC.

Project Information

Publication Date:
04-20-2011

Drawing Set:
Urban Design Commission - Initial Approval and Recommendation

Owner Project Number:
TBD

Architect Project Number:
PRA no: 10112-02 Strang no: 2010080

Project Image



Sheet Index

GENERAL

T001 COVER SHEET

CIVIL / SITE / LANDSCAPE

F-101 FIRE ACCESS PLAN

C-101 OVERALL SITE PLAN

LP-101 SITE LAYOUT PLAN

LP-201 SITE LAYOUT PLAN

LP-202 SITE LAYOUT PLAN

LP-203 SITE LAYOUT PLAN

LP-301 GATEWAY SITE GRADING PLAN

LP-302 GATEWAY SITE GRADING PLAN

LP-303 GATEWAY SITE GRADING PLAN

LP-401 LANDSCAPE PLAN

LP-402 LANDSCAPE PLAN

LP-410 SITE LAYOUT PLAN

LP-411 SITE LAYOUT PLAN

LP-420 LANDSCAPE PLANT SCHEDULE

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LP-503 DETAILS

LP-504 DETAILS

LP-505 DETAILS

LP-506 DETAILS

LP-507 DETAILS

LP-508 DETAILS

LP-602 SITE LAYOUT PLAN

ARCHITECTURAL

A200 OVERALL FIRST FLOOR PLAN

A210 OVERALL SECOND FLOOR PLAN

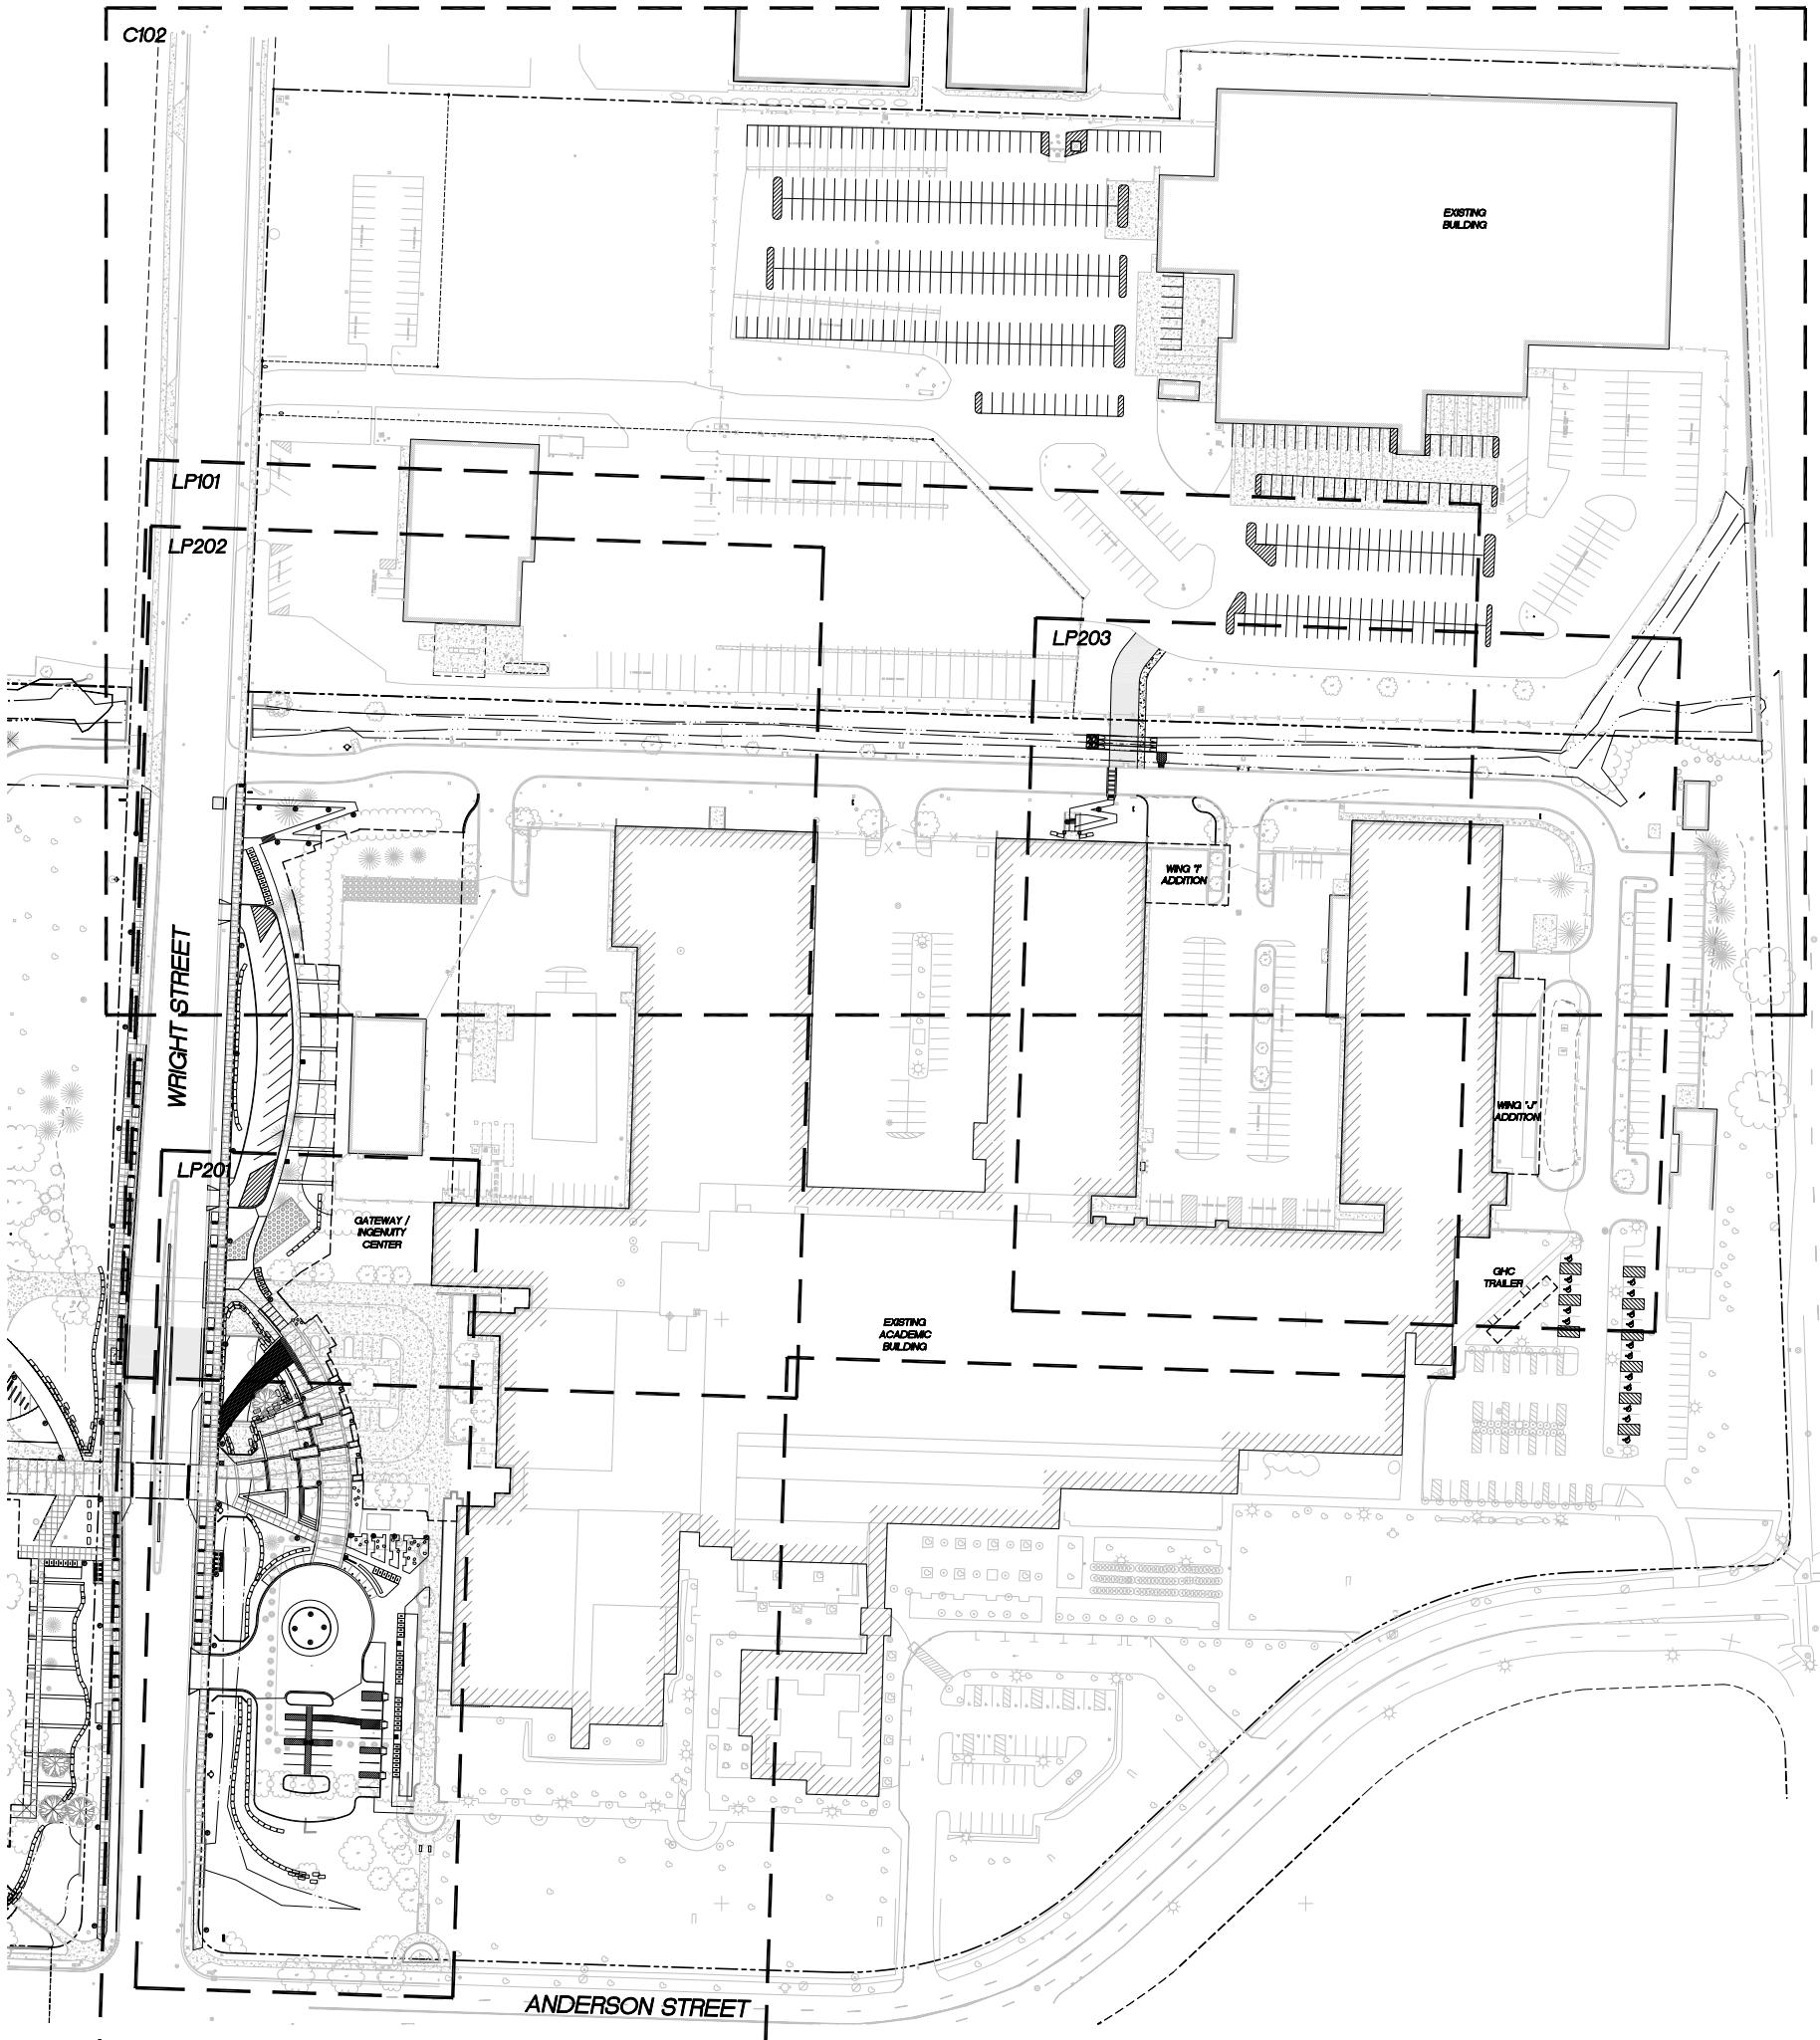
A220 OVERALL THIRD FLOOR PLAN

A400 BUILDING RENDERED ELEVATIONS

A401 BUILDING RENDERED ELEVATIONS

A402 BUILDING ELEVATIONS

A403 BUILDING ELEVATIONS



LEGEND (PROPOSED)

- PROPERTY LINE
- STORM SEWER
- WATERS EDGE AT TIME OF SURVEY
- WETLAND DELINEATION
- CONCRETE CURB & GUTTER
- ASPHALT PAVEMENT
- SIDEWALK PAVEMENT

PARKING LOT PLAN SITE INFORMATION

SITE ADDRESS: - WRIGHT STREET
SITE ACRESAGE: XXX ACRES
NUMBER OF BUILT STORIES (ABOVE GRADE): N/A
BUILDING HEIGHT: N/A
TYPE OF CONSTRUCTION: N/A
TOTAL SQUARE FOOTAGE OF BUILDING: N/A

USE OF PROPERTY: STORAGE AND PARKING LOT
GROSS SQUARE FEET OF OFFICE: N/A
OFFICE CAPACITY: N/A

EXISTING PARKING STALLS:

CAR = 347	SEMI-TRAILER = 31	ACCESSIBLE = 60
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TOTAL EXISTING STALLS = 438

REMOVED PARKING STALLS:

CAR = 30	SEMI-TRAILER = 31	ACCESSIBLE = 14
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TOTAL REMOVED STALLS = 75

NEW PARKING STALLS:

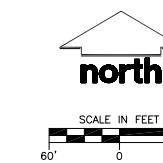
CAR = 392	ACCESSIBLE = 32
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TOTAL NEW STALLS = 424

FINAL POST DEVELOPMENT STALL COUNTS:

CAR = 709	ACCESSIBLE = 78
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TOTAL STALLS = 787



Project Title
Truax Additions

City of Madison,
Wisconsin

Issued For: Approval
Issue Date: 04/06/2011
Strang Project No. 2010080
MC Project No. -
Bid Pkg No. B11-009

Revision Date

GENERAL NOTES

- REFER TO THE EXISTING CONDITIONS SURVEY FOR EXISTING CONDITIONS NOTES AND LEGENDS. FIELD WORK FOR THE EXISTING CONDITIONS SURVEY PERFORMED BY JSO PROFESSIONAL SERVICES, INC. IN 2001, DECEMBER, 2010 AND JANUARY 2011.
- ALL WORK IN THE ROW AND ALL PUBLIC IMPROVEMENTS SHALL BE IN ACCORDANCE WITH THE CITY OF MADISON STANDARD SPECIFICATIONS FOR PUBLIC WORKS CONSTRUCTION.
- JSO SHALL BE HELD HARMLESS AND DOES NOT WARRANT ANY DEVIATIONS BY THE OWNER/CONTRACTOR FROM THE APPROVED CONSTRUCTION PLANS THAT MAY RESULT IN DISCIPLINARY ACTIONS BY ANY OR ALL REGULATORY AGENCIES.
- DRAWING FOR REVIEW - NOT FOR CONSTRUCTION UNLESS OTHERWISE NOTED IN THE TITLE BLOCK.

SITE PLAN NOTES

- ALL DIMENSIONS TO FACE OF CURB UNLESS OTHERWISE NOTED.
- ALL RADII TO FACE OF CURB UNLESS OTHERWISE NOTED.
- ALL CURB AND GUTTER IS 18" CURB AND GUTTER UNLESS OTHERWISE NOTED.
- USE 4" WIDE, HIGH VISIBILITY WHITE PAINT FOR STALL LINES PER MATC STANDARDS.
- MARK AND STRIPE ADA PARKING SPACES APPROPRIATELY.
- CONTRACTOR SHALL PROVIDE CONTROL JOINTS AND CONSTRUCTION JOINTS OF ONE-QUARTER CONCRETE THICKNESS IN SLAB ON GRADE AND SIDEWALKS AS FOLLOWS:
SLAB ON GRADE - MAXIMUM 10' ON CENTER
SIDEWALKS - MAXIMUM 8' ON CENTER
*UNLESS OTHERWISE NOTED ON THE SITE PLAN.
- CONTRACTOR SHALL PROVIDE EXPANSION JOINTS IN SLAB ON GRADE AND SIDEWALKS AS FOLLOWS:
SLAB ON GRADE - MAXIMUM 40' ON CENTER
SIDEWALKS - MAXIMUM 24' ON CENTER
*UNLESS OTHERWISE NOTED ON THE SITE PLAN.
- SIGNS TO MEET MANUAL ON UNIFORM TRAFFIC CONTROL AS TO COLOR, LETTERING AND DIMENSIONS AND SHALL BE INSTALLED AT A HEIGHT OF SEVEN FEET.
- PARKING LOT LIGHTING SHALL HAVE A "WINDOW" FINISH.
- VEHICLE BARRICADES, 8" ROUND STEEL PIPE FILLED WITH CONCRETE 36" ABOVE FINISHED SURFACE AND 3 FEET BELOW GRADE. PROVIDE BOLLARD COVER B101438 BY STONEWEAR FORCE PROTECTION.
- ADDITIONAL ADA STALLS ARE DEPICTED TO PROVIDE COMPLIANCE AND ACCESSIBILITY DURING CONSTRUCTION. FOLLOWING CONSTRUCTION, EXCESSIVE ADA STALLS MAY BE ELIMINATED.



STRANG

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ENGINEERING
INTERIOR DESIGN

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JSO Professional Services, Inc.

*Engineers * Surveyors * Planners

"BUILDING RELATIONSHIPS WITH A
COMMITMENT TO CLIENT SATISFACTION
THROUGH TRUST, QUALITY AND EXPERIENCE"

- CIVIL ENGINEERING
- SURVEYING & MAPPING
- CONSTRUCTION SERVICES
- WATER RESOURCES
- PLANNING & DEVELOPMENT
- TRANSPORTATION ENGINEERING
- STRUCTURAL ENGINEERING
- LANDSCAPE ARCHITECTURE

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KENOSHA | APPLETON
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**CITY OF MADISON
MAJOR ALTERATION
TO EXISTING
CONDITIONAL USE**
04-06-11

**DRAWING
OVERALL SITE PLAN**

Sheet Number

C-101



City of Madison, Wisconsin

Issued For:	Approval
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Strang Project No.	2010080
MC Project No.	-
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Revision Date



STRANG

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ENGINEERING

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JSD Professional Services, Inc.
Engineers • Surveyors • Planners

"BUILDING RELATIONSHIPS WITH A COMMITMENT TO CLIENT SATISFACTION, INTEGRITY, INNOVATION, AND EXPERIENCE"

CIVIL ENGINEERING
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TRANSPORTATION ENGINEERING
STRUCTURAL ENGINEERING
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KEISHISHA J. WAAKE
keishisha.waaake@waaake.com

**CITY OF MADISON
MAJOR ALTERATION
TO EXISTING
CONDITIONAL USE
04-06-11**

**DRAWING
NORTH PARKING
LOT PLAN**

Sheet Number

C-102

LEGEND (PROPOSED)

Stm	PROPERTY LINE
	STORM SEWER
	WATERS EDGE AT TIME OF :
	WETLAND DELINEATION
	CONCRETE CURB & GUTTER
	ASPHALT PAVEMENT
	SIDEWALK PAVEMENT

GENERAL NOTES

1. REFER TO THE EXISTING CONDITIONS SURVEY DATED XXXX
EXISTING CONDITIONS NOTES AND LEGENDS. FIELD WORK
EXISTING CONDITIONS SURVEY PERFORMED BY JSD PROFESSIONAL
SERVICES, INC. ON 2001, DECEMBER 10 AND JANUARY 2.
2. ALL WORK IN THE PUBLIC IMPROVEMENTS IS
ACCORDING WITH THE CITY OF MADISON STANDARD SPECIFICATIONS
FOR PUBLIC WORKS CONSTRUCTION.
3. EXISTING GRADE SPOT ELEVATIONS SHOWN FOR INFORMATION
PURPOSES. DURING CONSTRUCTION MATCH EXISTING GRADES
CONSTRUCTION LIMITS.
4. NO SITE GRADING OUTSIDE OF THE CONSTRUCTION LIMIT LINE.
5. THIS PROJECT HAS BEEN DESIGNED AND WILL BE CONSTRUCTED
COMPLIANCE WITH ALL OF THE WNDW INDUSTRIAL PERMIT AFFILIATED
ELIGIBILITY STANDARDS.
6. JSD SHALL BE HELD HARMLESS AND DOES NOT WARRANT
DEVIATIONS BY THE OWNER/CONTRACTOR FROM THE APPROVED
CONSTRUCTION PLANS THAT MAY RESULT IN DISCIPLINARY ACTION
BY ANY OR ALL REGULATORY AGENCIES.
7. DRAWING FOR REVIEW - NOT FOR CONSTRUCTION UNLESS
NOTED IN THE TITLE BLOCK.
8. REFER TO GEOTECHNICAL REPORT DATED JANUARY 18, 2011
PREPARED BY CGC, INC. FOR SITE SOILS INFORMATION.

SITE PLAN NOTES

1. ALL DIMENSIONS TO FACE OF CURB UNLESS OTHERWISE NOTED.
2. ALL RADII TO FACE OF CURB UNLESS OTHERWISE NOTED.
3. ALL CURB AND GUTTER IS 18" CURB AND GUTTER UNLESS OTHERWISE NOTED.
4. USE 4" WIDE, HIGH VISIBILITY WHITE PAINT FOR STALL LINES PER MAC STANDARDS.
5. MARK AND STRIPE ADA PARKING SPACES APPROPRIATELY.
6. ALL MARKINGS TO BE YELLOW OR WHITE PAINT PER MAC STANDARDS. HANDICAP SYMBOL TO BE BLUE PAINT.
7. CONTRACTOR SHALL PROVIDE CONTROL JOINTS AND CONSTRUCTION JOINTS OF ONE QUARTER CONCRETE THICKNESS IN SLAB ON GRADE AND SIDEWALKS AS FOLLOWS:
SLAB ON GRADE - MAXIMUM 10' ON CENTER
SIDEWALKS - MAXIMUM 8' ON CENTER
**UNLESS OTHERWISE NOTED ON THE SITE PLAN.
8. CONTRACTOR SHALL PROVIDE EXPANSION JOINTS IN SLAB ON GRADE SIDEWALKS AS FOLLOWS:
SLAB ON GRADE - MAXIMUM 40' ON CENTER
SIDEWALKS - MAXIMUM 24' ON CENTER
**UNLESS OTHERWISE NOTED ON THE SITE PLAN.
9. 6" MINIMUM DEPTH CONCRETE SLAB ON GRADE WITH #3 REBAR.
10. 30' HIGH, 6" DIAMETER CONCRETE BOLLARD PER MAC STANDARDS.
11. 2' X 4' TRUCKED DOME SECTIONS.

SITE PLAN NOTES CONTINUED

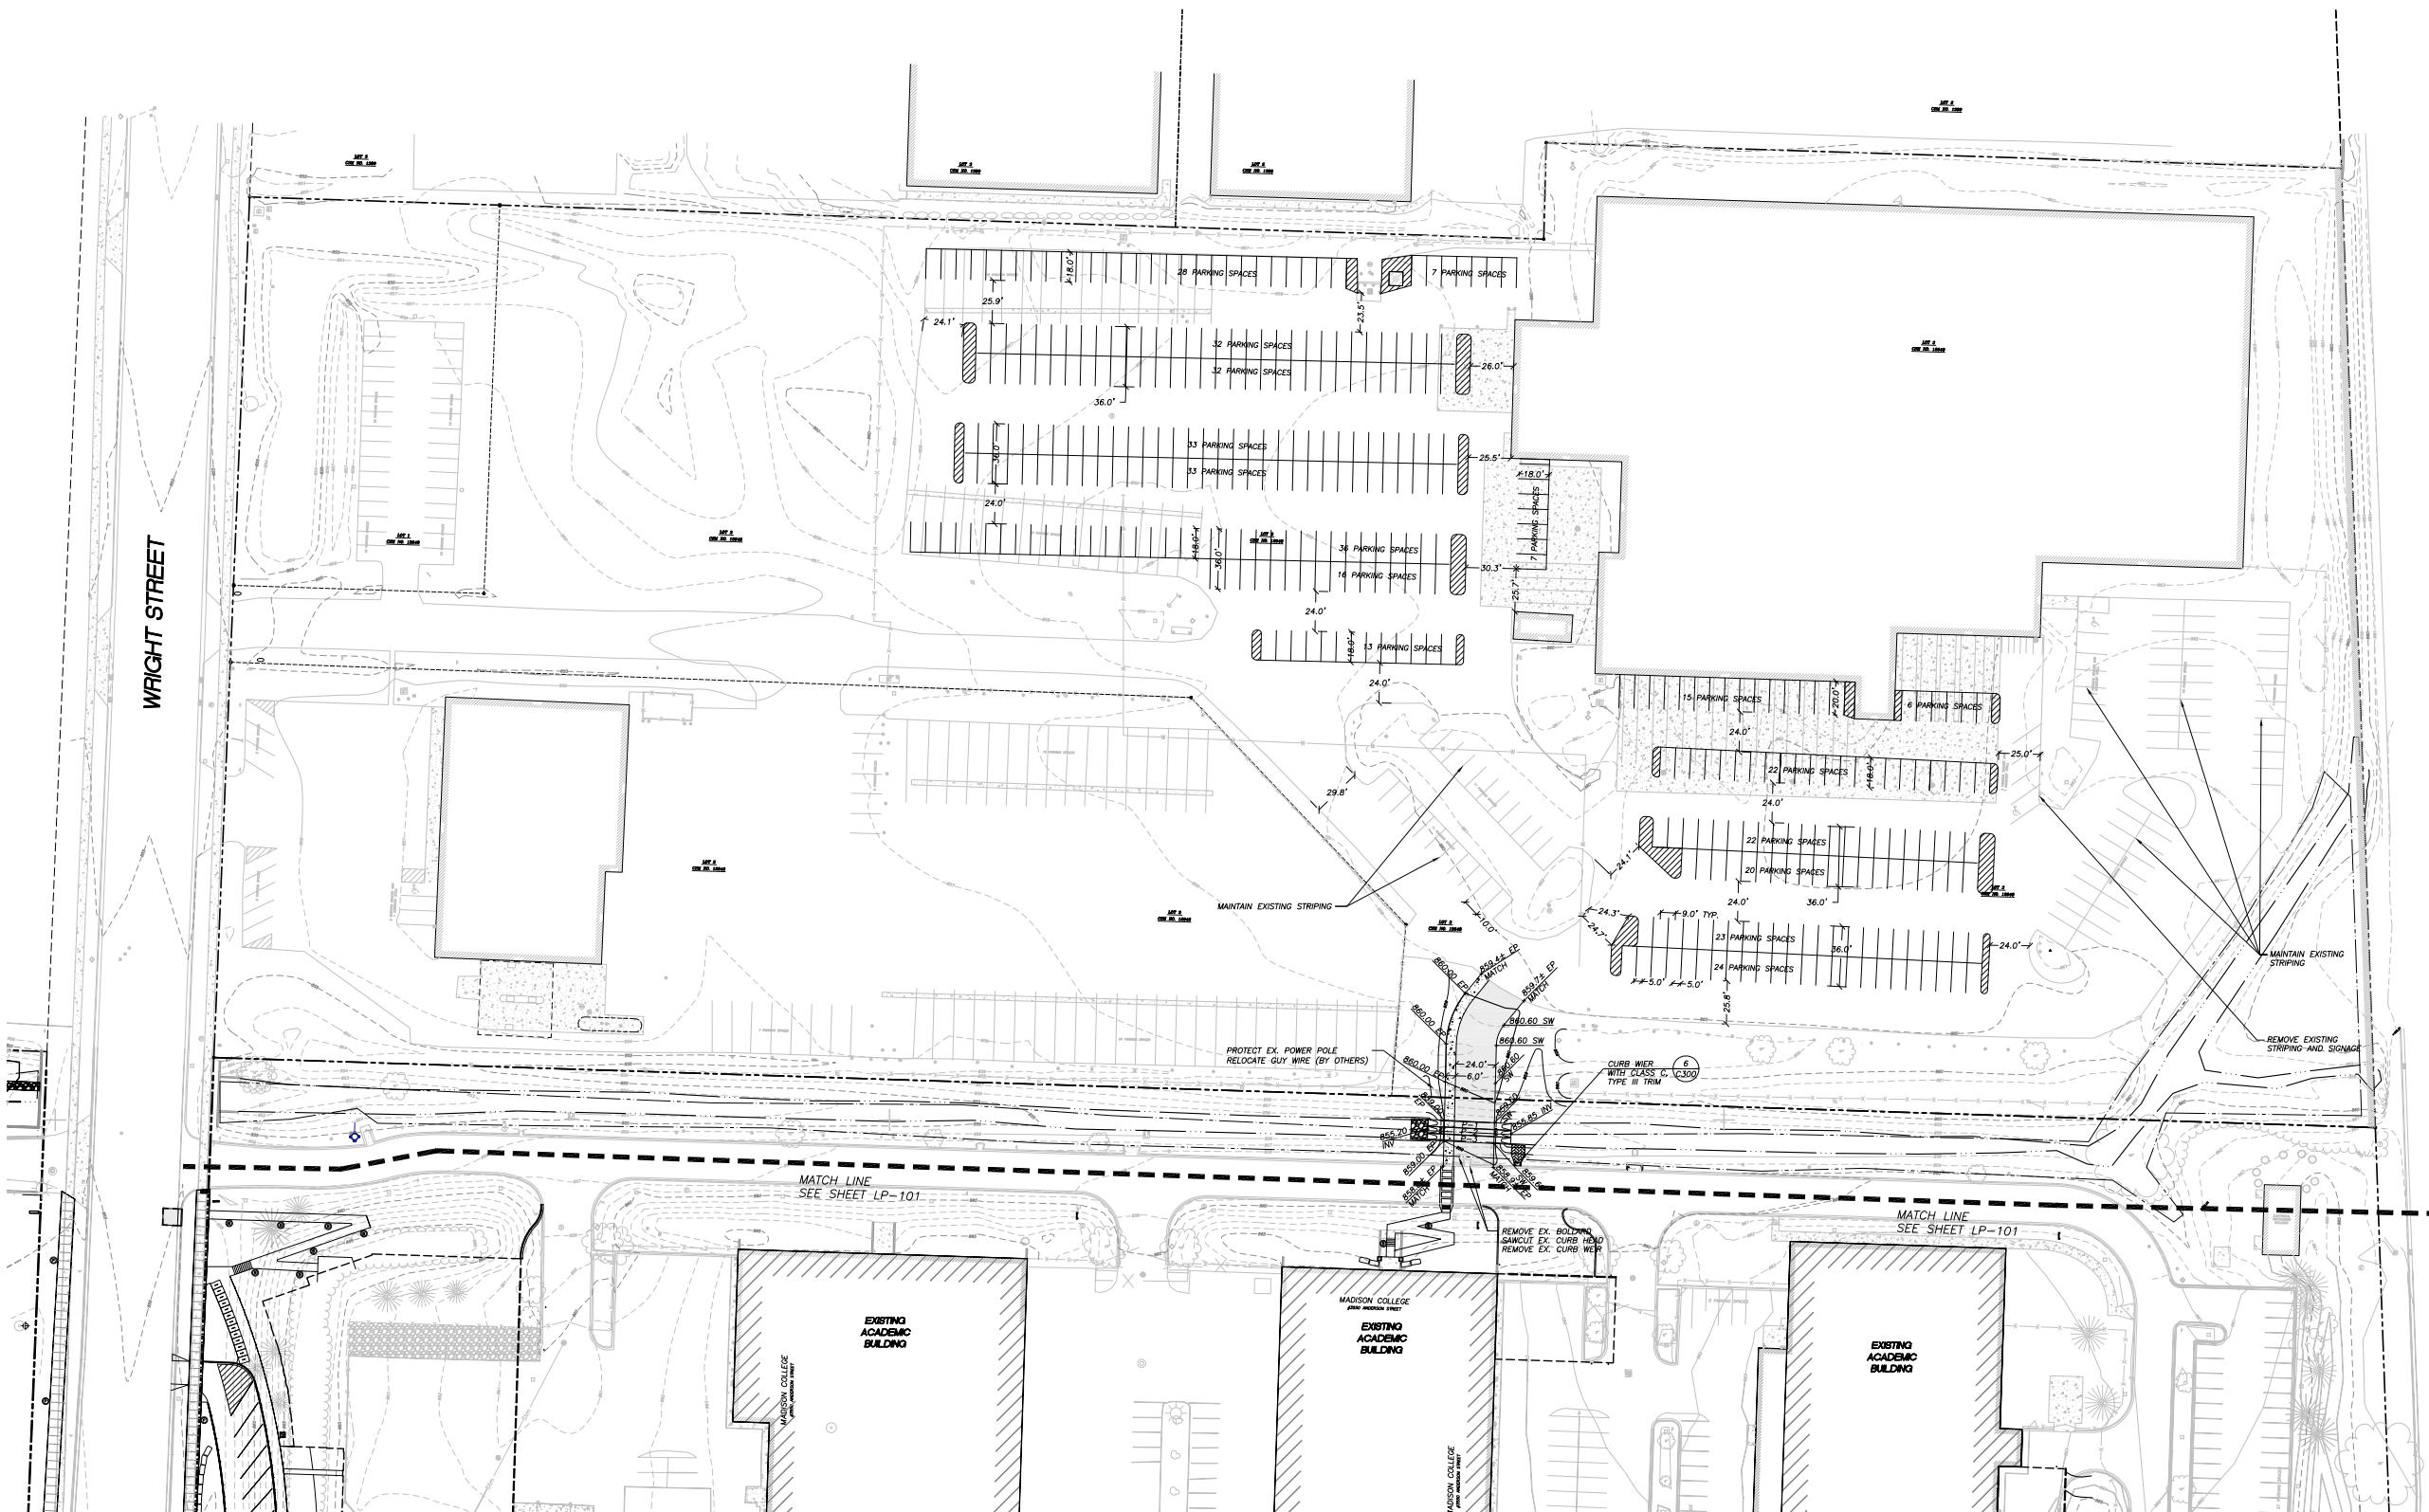
12. SIGNS TO MEET MANUAL ON UNIFORM TRAFFIC CONTROL AS TO COLOR, LETTERING AND DIMENSIONS AND SHALL BE INSTALLED AT A HEIGHT OF SEVEN FEET.
13. PARKING LOT LIGHTING SHALL BE FULLY-SHELDED LIGHT EMITTING DIODE (LED) LIGHT. SEE SITE ELECTRICAL PLANS.
14. CONCRETE PAVEMENT SHALL HAVE A "WINDOW" FINISH.
15. VEHICLE BARRICADES, 8" ROUND STEEL PIPE FILLED WITH CONCRETE 36" ABOVE FINISHED SURFACE AND 3 FEET BELOW GRADE. PROVIDE BOLLARD COVER b161438 BY STONEWEAR FORCE PROTECTION.

NOTES
DIMENSIONS TAKE PRECEDENCE OVER SCALE. CONTRACTOR TO VERIFY ALL DIMENSIONS IN FIELD.
IF ANY ERRORS, DISCREPANCIES, OR OMISSIONS WITHIN THE PLAN BECOME APPARENT, IT SHALL BE BROUGHT TO THE ATTENTION OF THE ENGINEER PRIOR TO CONSTRUCTION SO THAT CLARIFICATION OR REDESIGN MAY OCCUR.
LENGTHS OF ALL UTILITIES ARE TO CENTER OF STRUCTURES OR FITTINGS AND MAY VARY SLIGHTLY FROM PLAN LENGTH. SHALL BE VERIFIED IN THE FIELD DURING CONSTRUCTION.
CITY/SEWER MAIN IS PUBLICLY OWNED. DESIGN OF THE MAIN IS PROVIDED BY THE CITY OF MADISON. PER PROJECT NO. XXXX. INSTALLATION NOT IN CONTRACT.
ALL CONSTRUCTION SIGNING TO BE IN ACCORDANCE WITH THE CITY OF MADISON AND WISCONSIN DEPARTMENT OF TRANSPORTATION REQUIREMENTS.
THE CONTRACTOR SHALL INSTALL A PEDESTRIAN FENCE AROUND ALL EXCAVATIONS TO BE LEFT OPEN OVER NIGHT AS REQUIRED.
THE PROVIDED IMPROVEMENTS MUST BE CONSTRUCTED IN ACCORDANCE WITH ENGINEERING PLANS DESIGNED TO MEET ORDINANCES AND REQUIREMENTS OF THE MUNICIPALITY AND WISDOT, WDCOM, AND WNR.
PRIOR TO CONSTRUCTION, THE CONTRACTOR IS RESPONSIBLE FOR:

- EXAMINING ALL SITE CONDITIONS RELATIVE TO THE CONDITIONS INDICATED ON THE ENGINEERING DRAWINGS. ANY DISCREPANCIES ARE TO BE REPORTED TO THE ENGINEER AND RESOLVED PRIOR TO CONSTRUCTION.
- OBTAINING ALL PERMITS INCLUDING PERMIT COSTS, TAPE FEES, METER DEPOSITS, BONDS, AND ALL OTHER FEES REQUIRED FOR PROPOSED WORK TO OBTAIN OCCUPANCY.
- VERIFYING ELEVATIONS AND NOTIFYING OWNER OF ANY DISCREPANCY.
- WORKING PERIODICALLY UNTIL THE CONTRACTOR IS RESOLVED.
- NOTIFYING ALL UTILITIES PRIOR TO THE INSTALLATION OF ANY UNDERGROUND IMPROVEMENTS.
- NOTIFYING THE DESIGN ENGINEER AND MUNICIPALITY 48 HOURS PRIOR TO THE START OF CONSTRUCTION FOR A PRE-CONSTRUCTION INSPECTION.

THE CONTRACTOR IS RESPONSIBLE FOR PROVIDING THE ENGINEER WITH AS-BUILT CONDITIONS OF THE CONSTRUCTION IMPROVEMENTS IN ORDER THAT THE APPROPRIATE DRAWINGS CAN BE PREPARED, IF REQUIRED. AS CHANGES GO TO THE DRAWINGS OR ADDITIONAL ITEMS MUST BE REPORTED TO THE ENGINEER AS WORK PROGRESSES.

PROPOSED STORM SEWER PIPE SCHEDULE						
Pipe Label	From	To	Length (ft)	Invert Elevation (ft)	Discharge Elevation (ft)	Slope (%)
P-1	APRON ENDWALL	APRON ENDWALL	50	855.85	855.20	1.30
P-2	APRON ENDWALL	APRON ENDWALL	50	855.85	855.20	1.30
P-3	APRON ENDWALL	APRON ENDWALL	50	855.85	855.20	1.30





Project Title

City of Madison,
Wisconsin

Issued For:	Approval
Issue Date:	04/06/2011
SAA Project No.	2434
MC Project No.	-
Bid Pkg No.	B11-025

Revision	Date
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Conservation Design Forum
375 West First Street
Elmhurst, Illinois 60126
630.559.2000 Phone
630.559.2030 Fax

DRAWING

Sheet Number

F-101

NOTES:	
1. DO PARKING ALONG LENGTH OF FIRE LANE. SEE DETAIL FOR SIGNAGE INSTALLATION. APPROVED "FIRE LANE, NO PARKING" SIGNS PER IFC 503.3 SHALL BE PLACED A MAXIMUM OF 150' O.C. ON BOTH SIDES OF FIRE LANE ACCESS WAYS	
2. SEE DETAIL SHEETS FOR MOUNTABLE CURB DETAIL TO BE USED WITHIN FIRE LANE AREA	
3. AHB & SAC BUILDING WITHIN 500' OF REQUIRED FIRE HYDRANTS	
4. ALL HYDRANTS ARE MORE THAN 40' FROM BUILDINGS	
BUILDING	HYDRANT # (WITHIN 500')
AHB	HYD. #1, #2, #3, #4
SAC	HYD. #3, #4
IC	HYD. #4, #5, #6
	FIRE LANE - 20'-0" WIDTH
	FIRE APPARATUS LANE - 26'-0" WIDTH
	GRASS/PAVE PRODUCT SUPPORT LOADING MIN. 85K LBS.
	7" THICK CONCRETE TO SUPPORT LOADING MIN. 85K LBS.
	EXISTING TREES TO REMAIN, TYPICAL
	FIRE LANE SIGN, TYP SIGN SYMBOL NTS



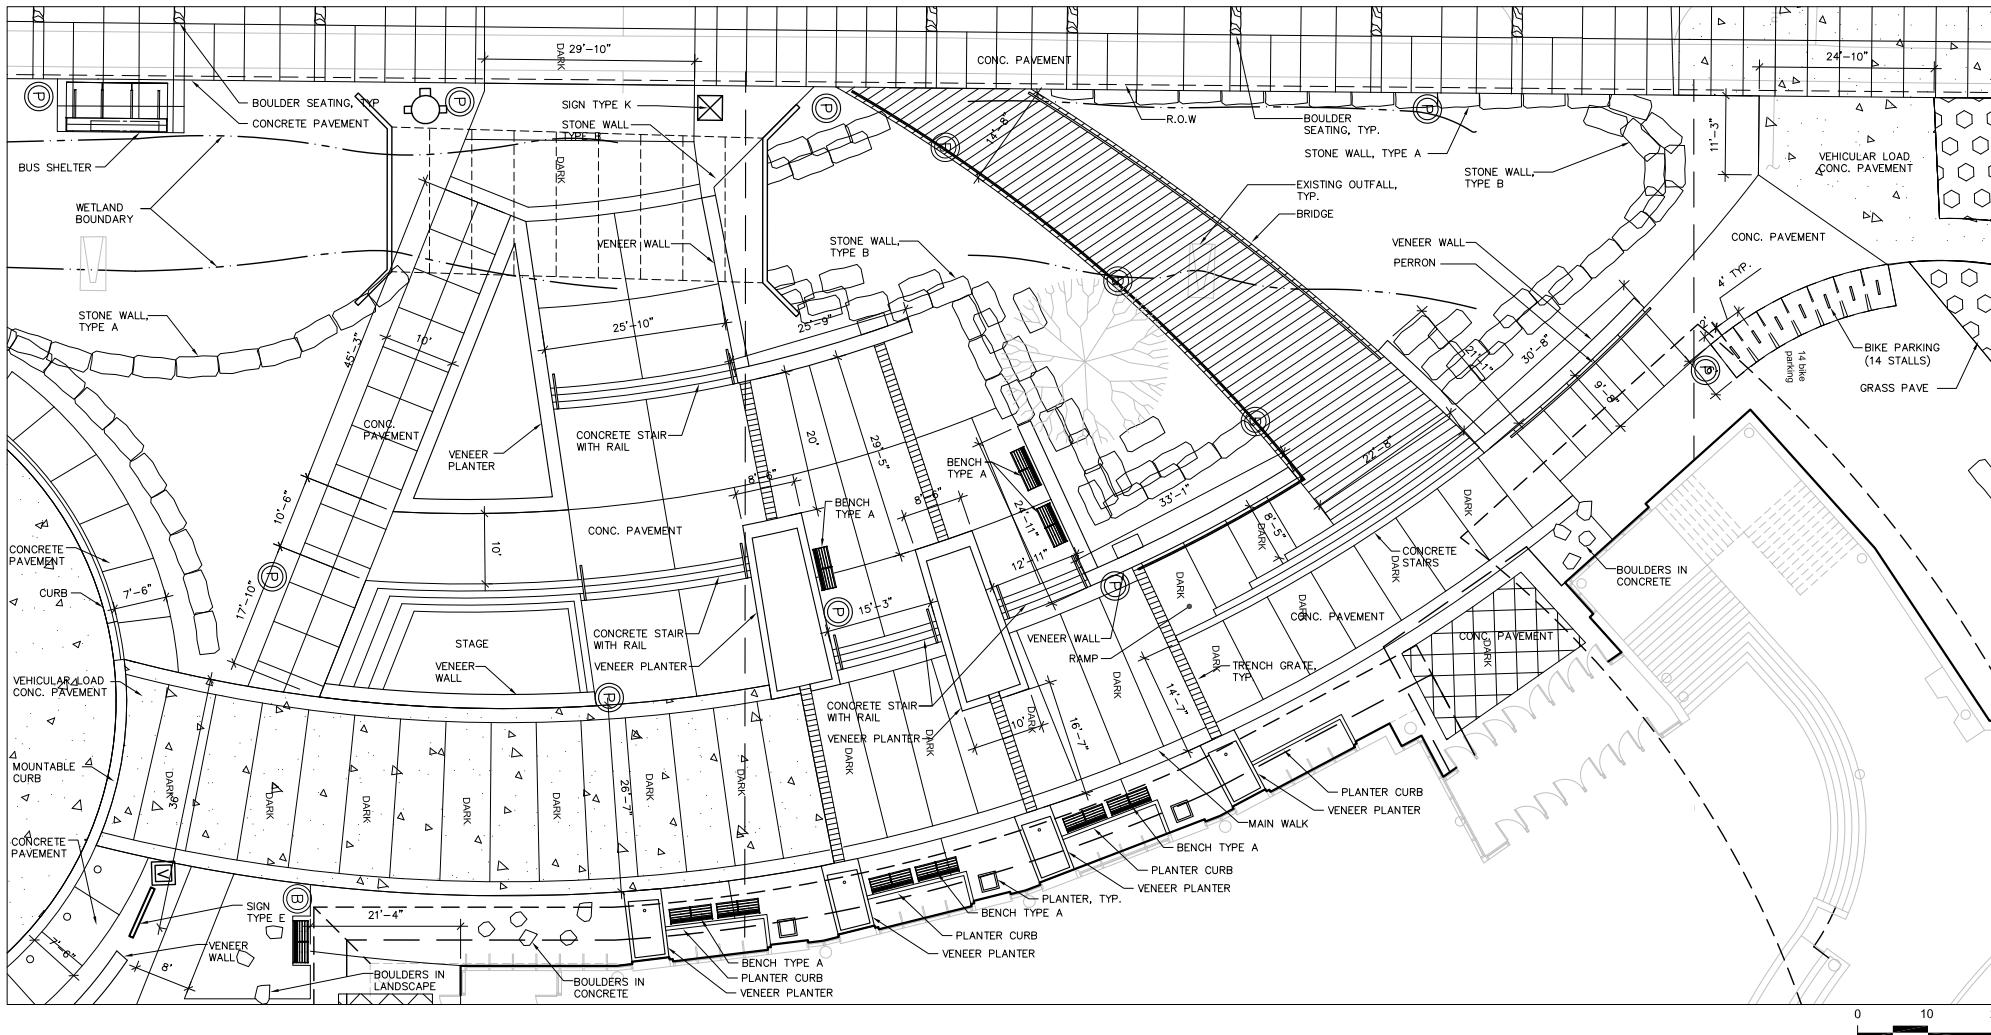
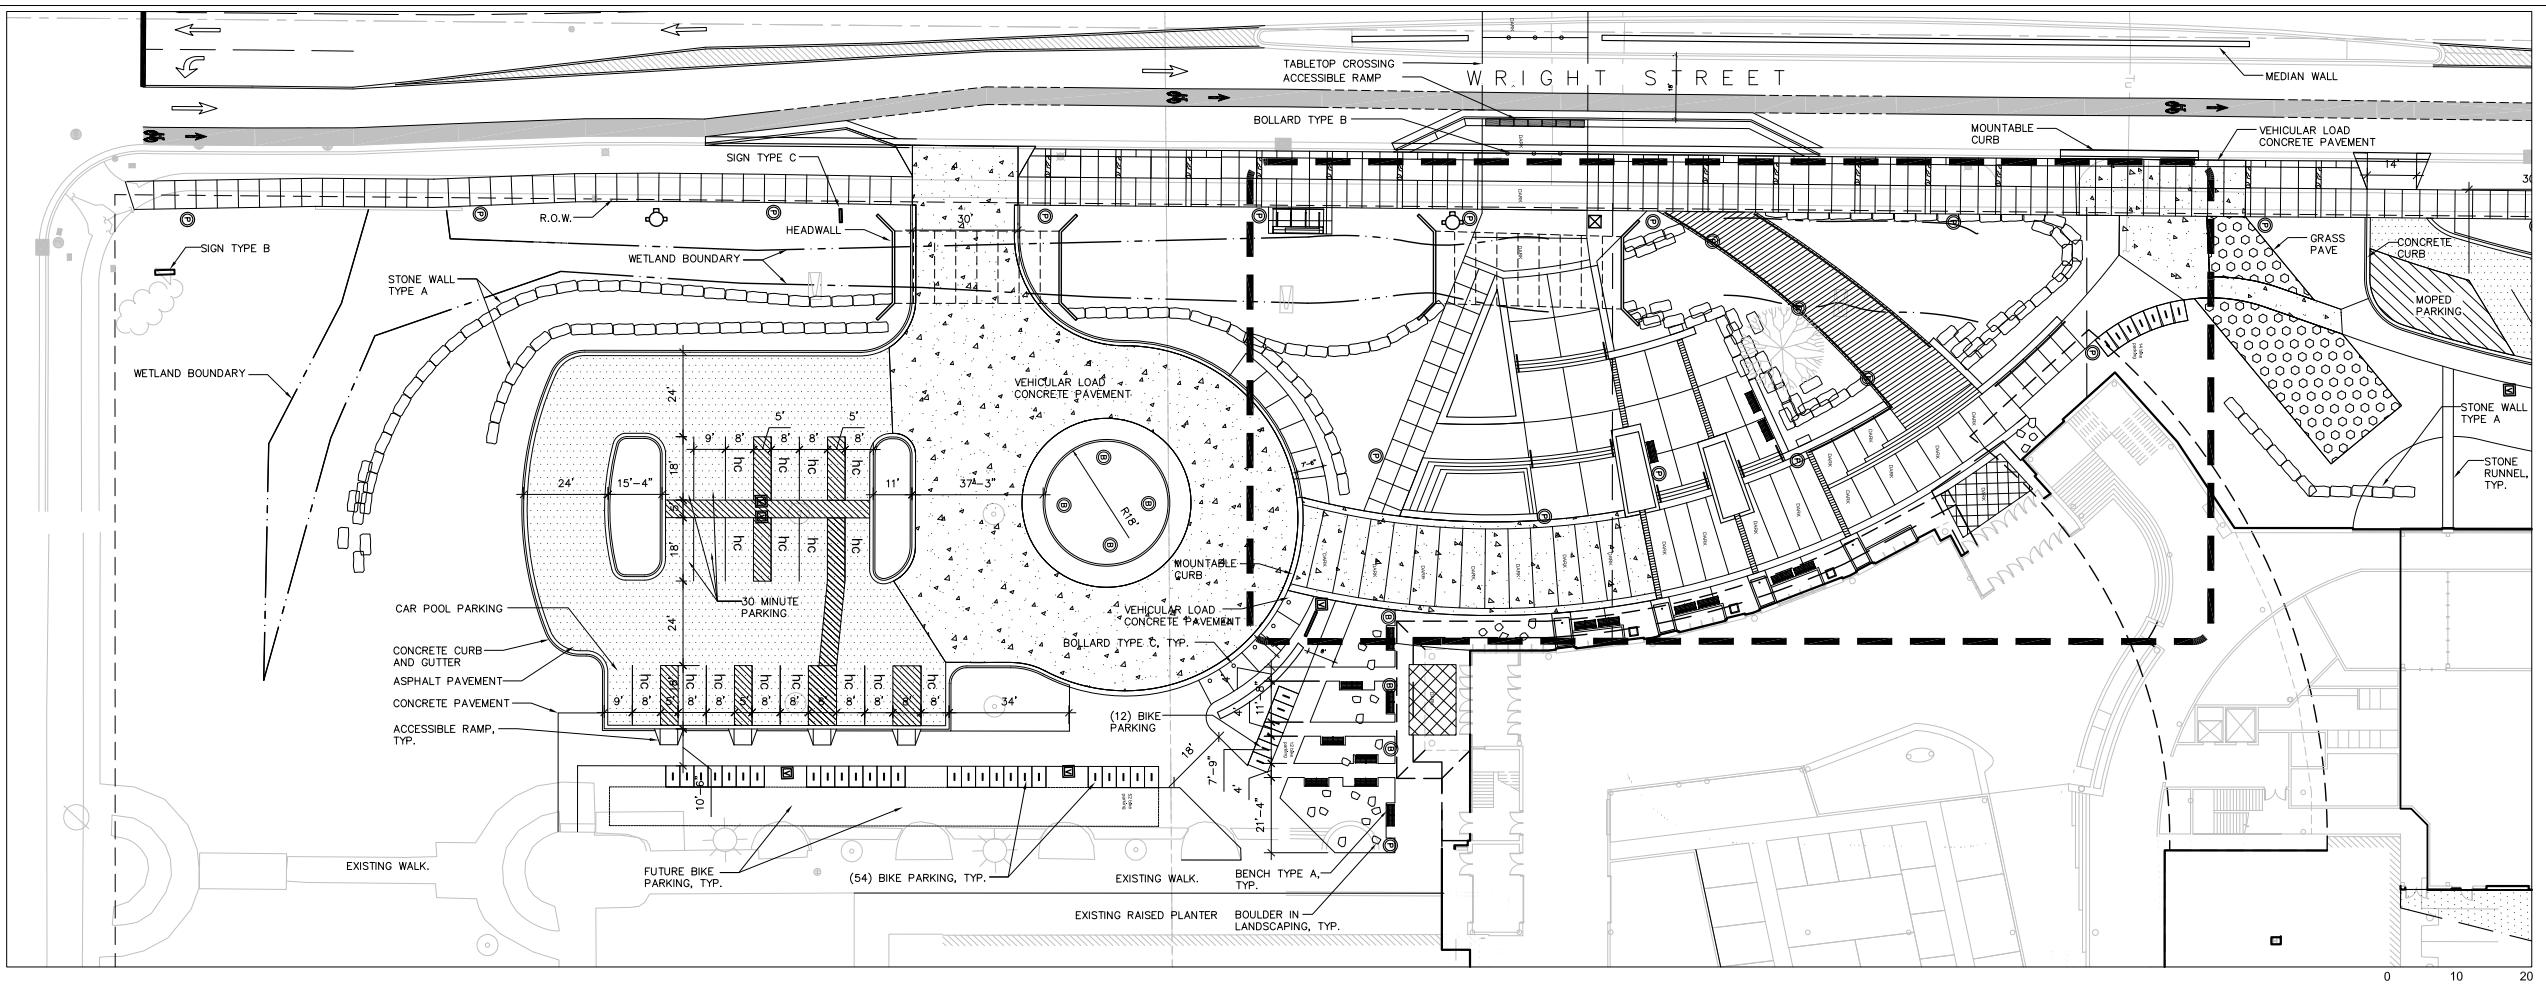
Project Title

Truax
Ingenuity Center

City of Madison, Wisconsin

Issued For:	Approval
Issue Date:	04/06/2011
SAA Project No.	2434
MC Project No.	-
Bid Pkg No.	B11-025

Revision	Date
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The logo for SAA Design Group, Inc. It features a stylized 'SAA' monogram in a bold, black, sans-serif font. To the right of the monogram is a blue graphic element consisting of a horizontal bar above a series of vertical bars of decreasing height. To the right of this graphic, the words 'DESIGN GROUP' are written in a smaller, black, sans-serif font.

www.360d4madison.com

Conservation Design Forum
375 West First Street
Elmhurst, Illinois 60126
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630.559.2020 Fax

DRAWING

Sheet Number

LP-201



Project Title

Truax Ingenuity Center

City of Madison, Wisconsin

Issued For:	Approval
Issue Date:	04/06/2011
SAA Project No.	2434
MC Project No.	-
Bid Pkg No.	B11-025

Revision	Date

SAA DESIGN GROUP

SAA Design Group, Inc.

717 John Nolen Drive
Madison, WI 53713
Ph. 608.255.0800
Fx. 608.255.7750
www.saa.com

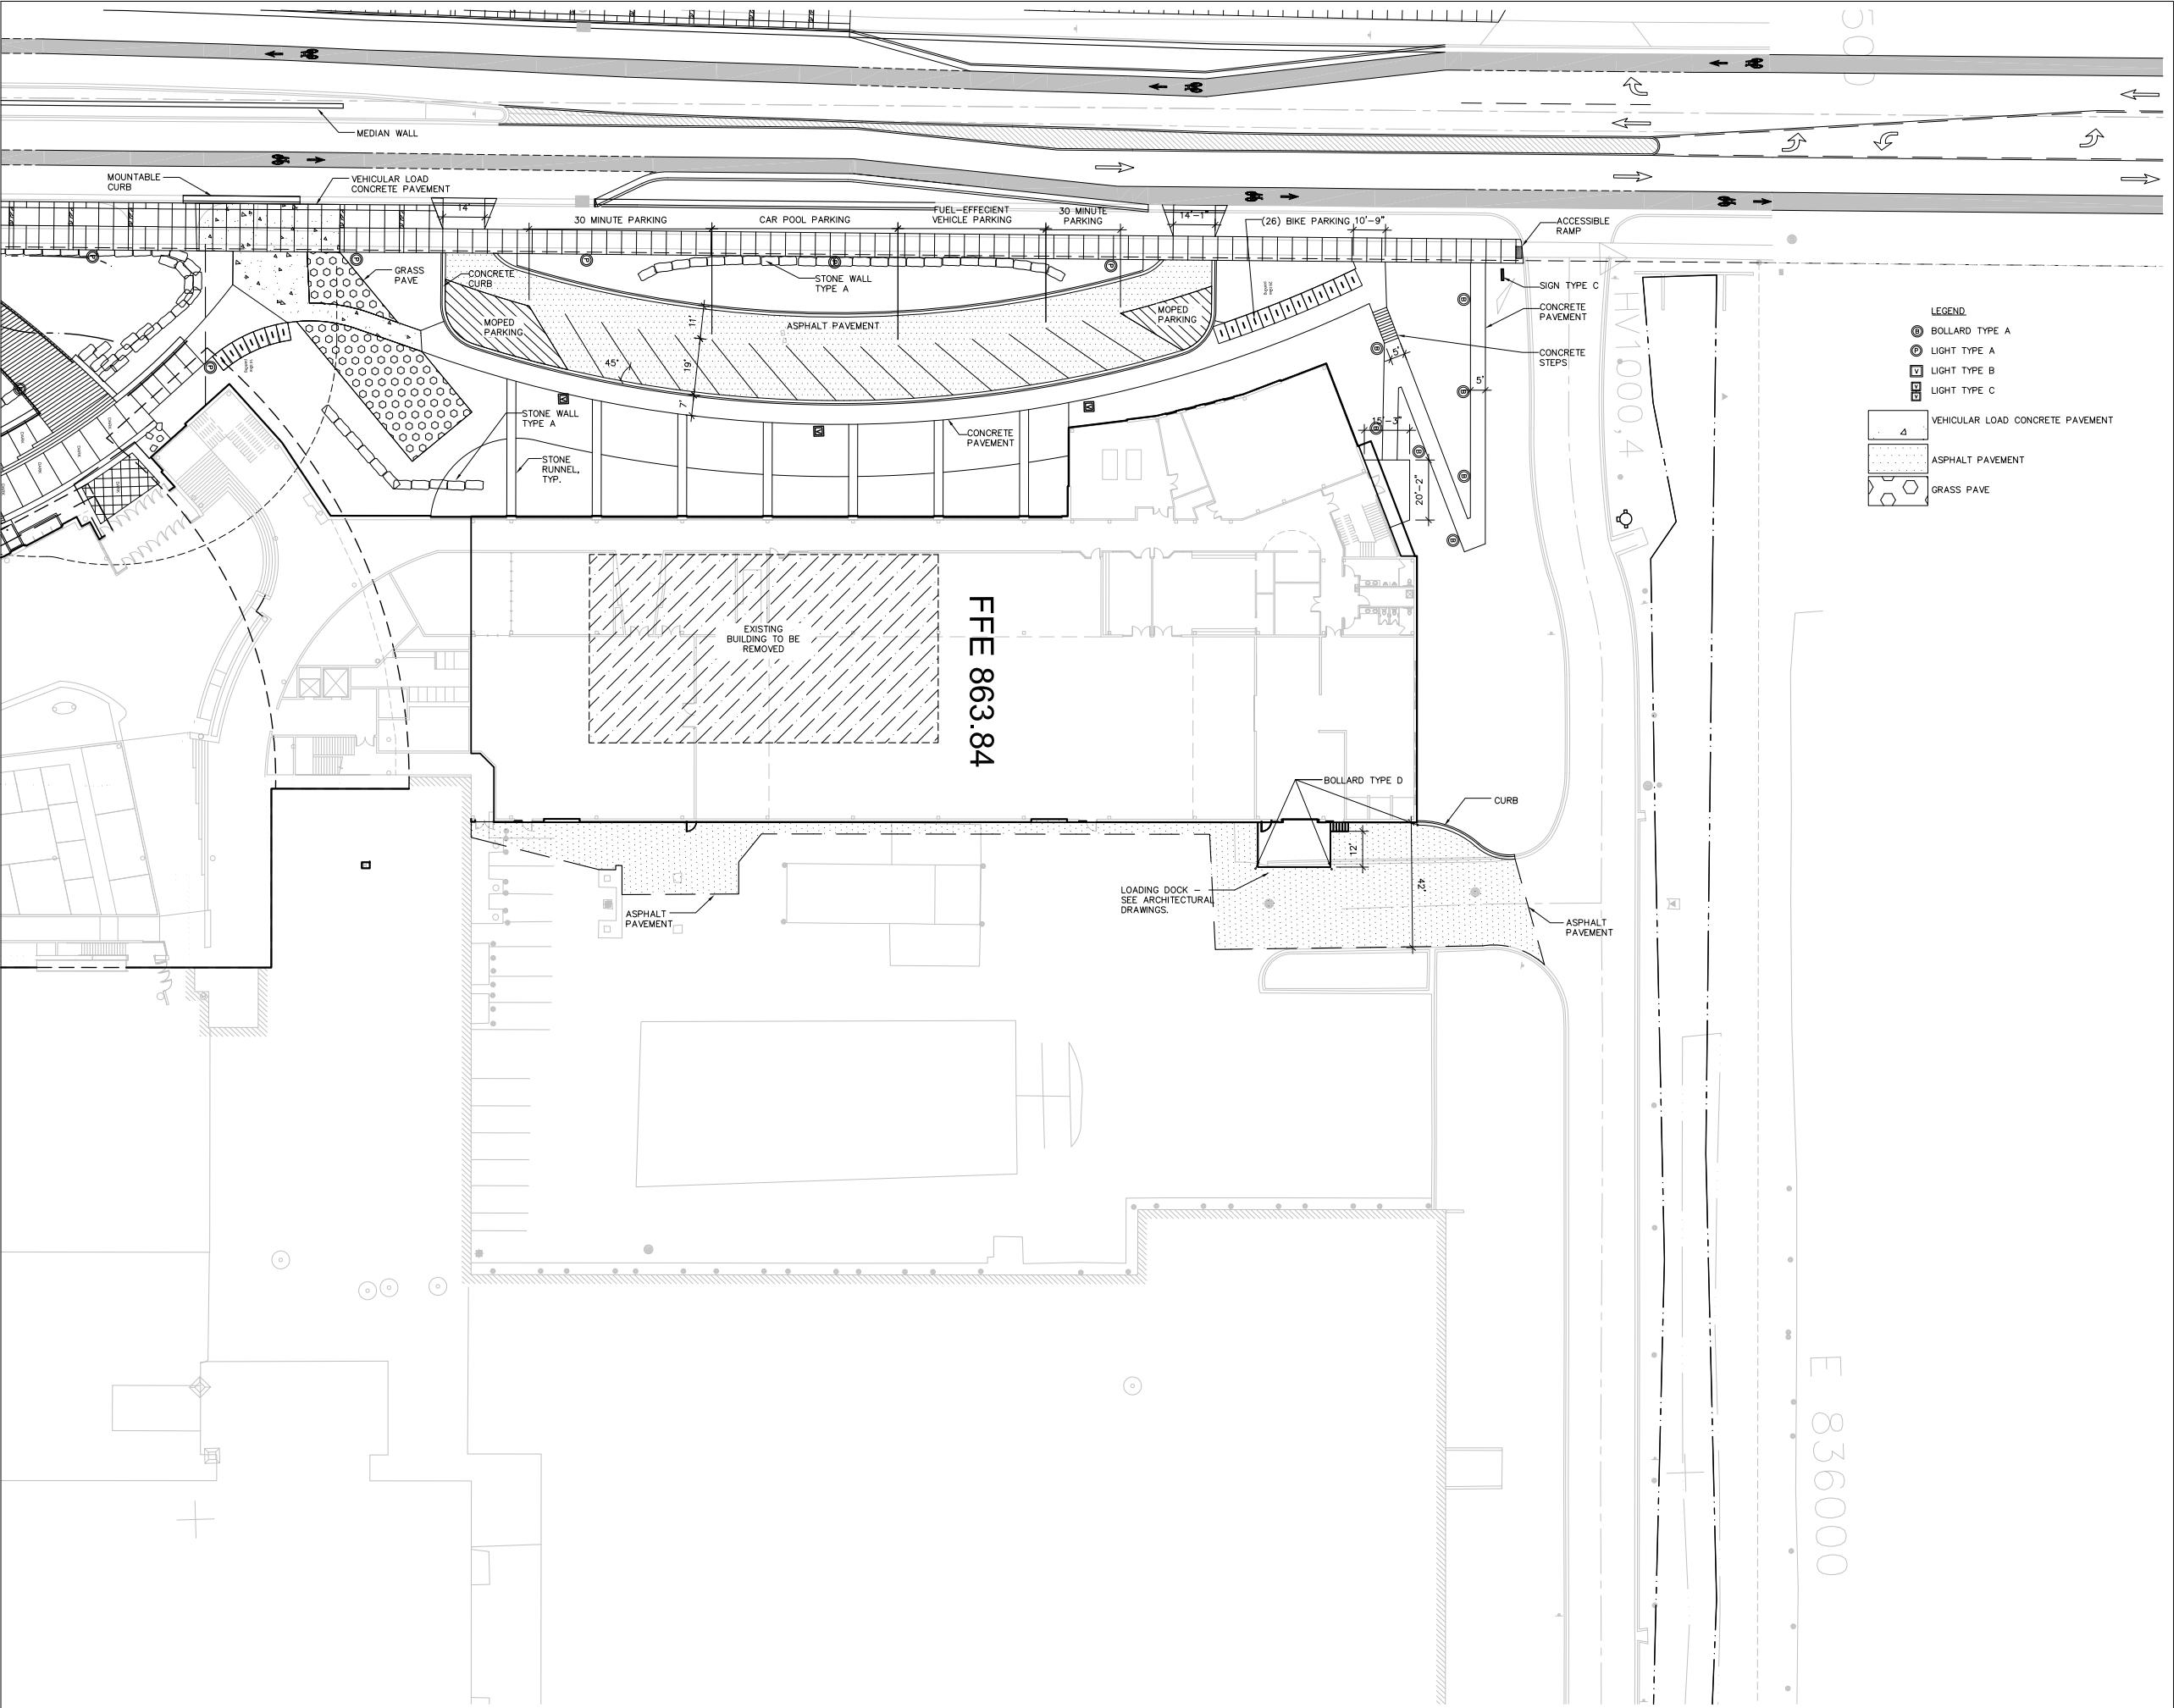
■ ■ ■
Conservation Design Forum
375 West First Street
Elmhurst, Illinois 60126
630.559.2000 Phone
630.559.2030 Fax

DRAWING

SITE LAYOUT PLAN

LP-202

Plotter: Apr 05, 2011 – 12:35pm
User: affiliations
File: P:\12400\2434-MATC.LS_MP\CAD\P-SP2.DWG
Layout: Block 2_Enlargement_rotate (2)
User: affiliations





Project Title

Truax Ingenuity Center

City of Madison, Wisconsin

Issued For:	Approval
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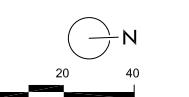


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10

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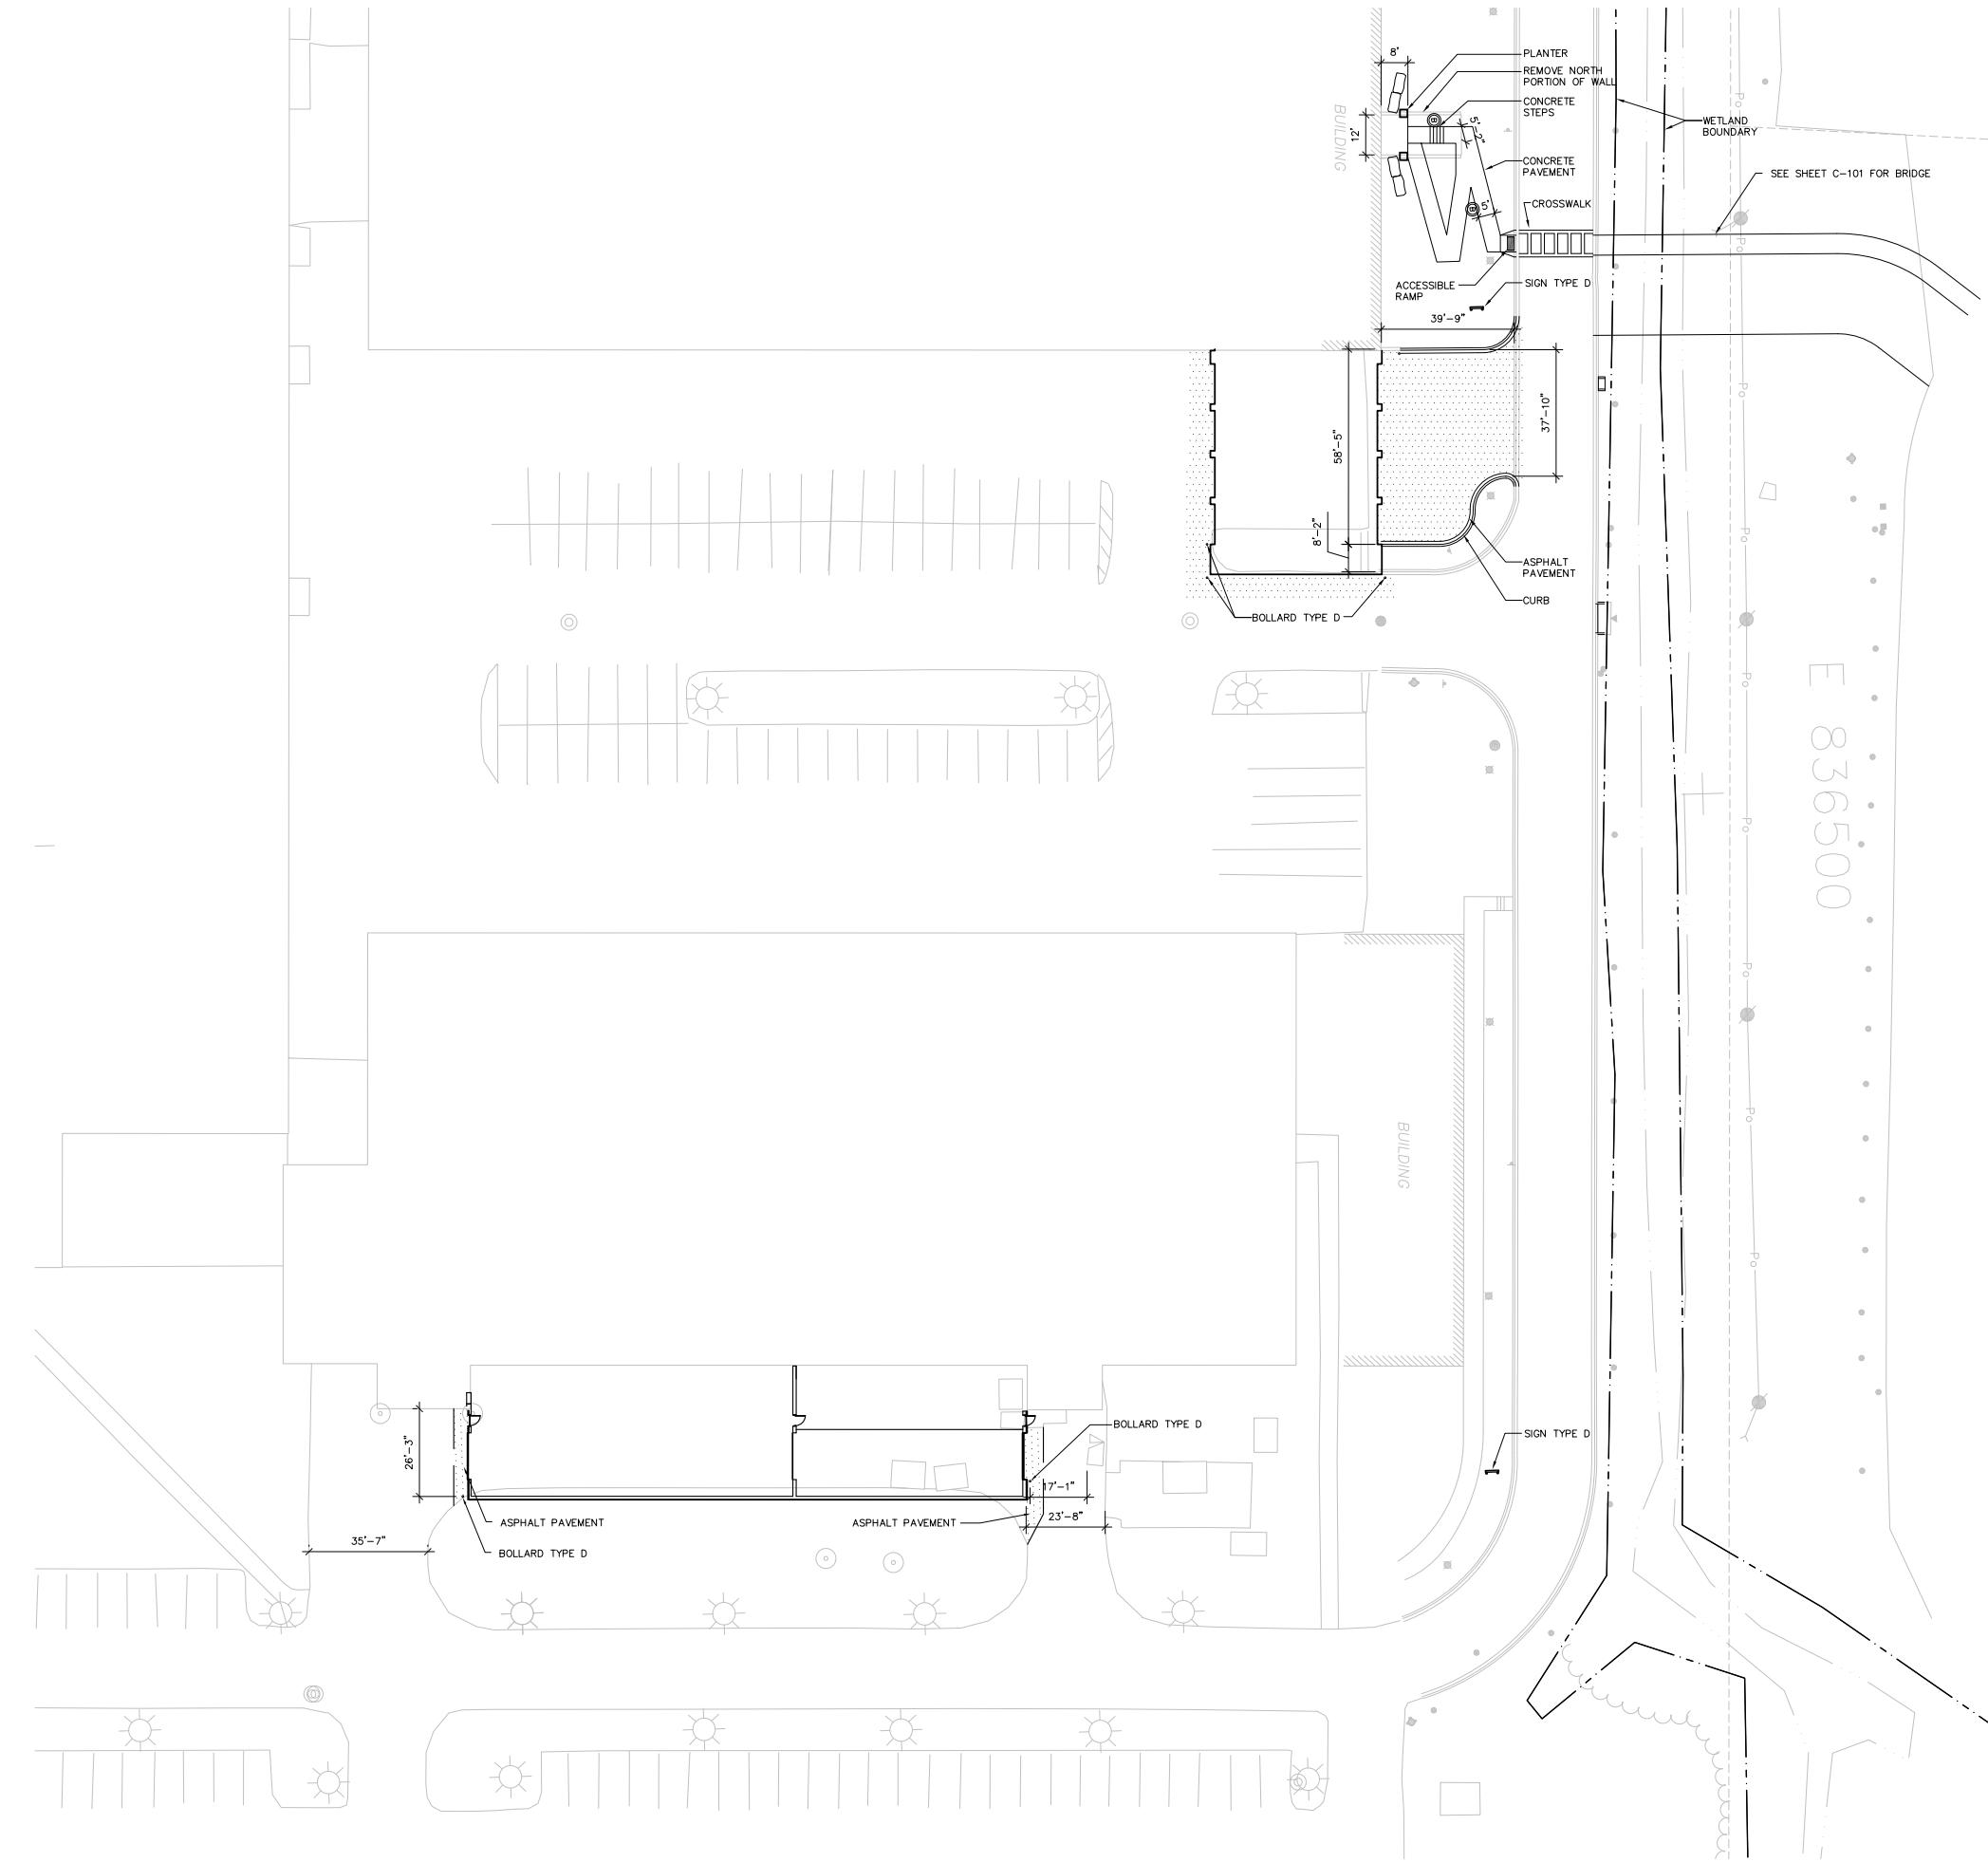
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Sheet Number

LP-203

Layout: Block 2 Enlargement rotate (3) User: awilliams Plotted: Apr 05, 2011 – 12:35pm
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Project Title

Truax
Ingenuity Center

City of Madison,
Wisconsin

Issued For: Approval

Issue Date: 04/06/2011

SAA Project No. 2434

MC Project No. -

Bid Pkg No. B11-025

Revision Date

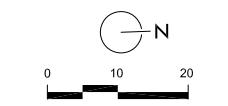
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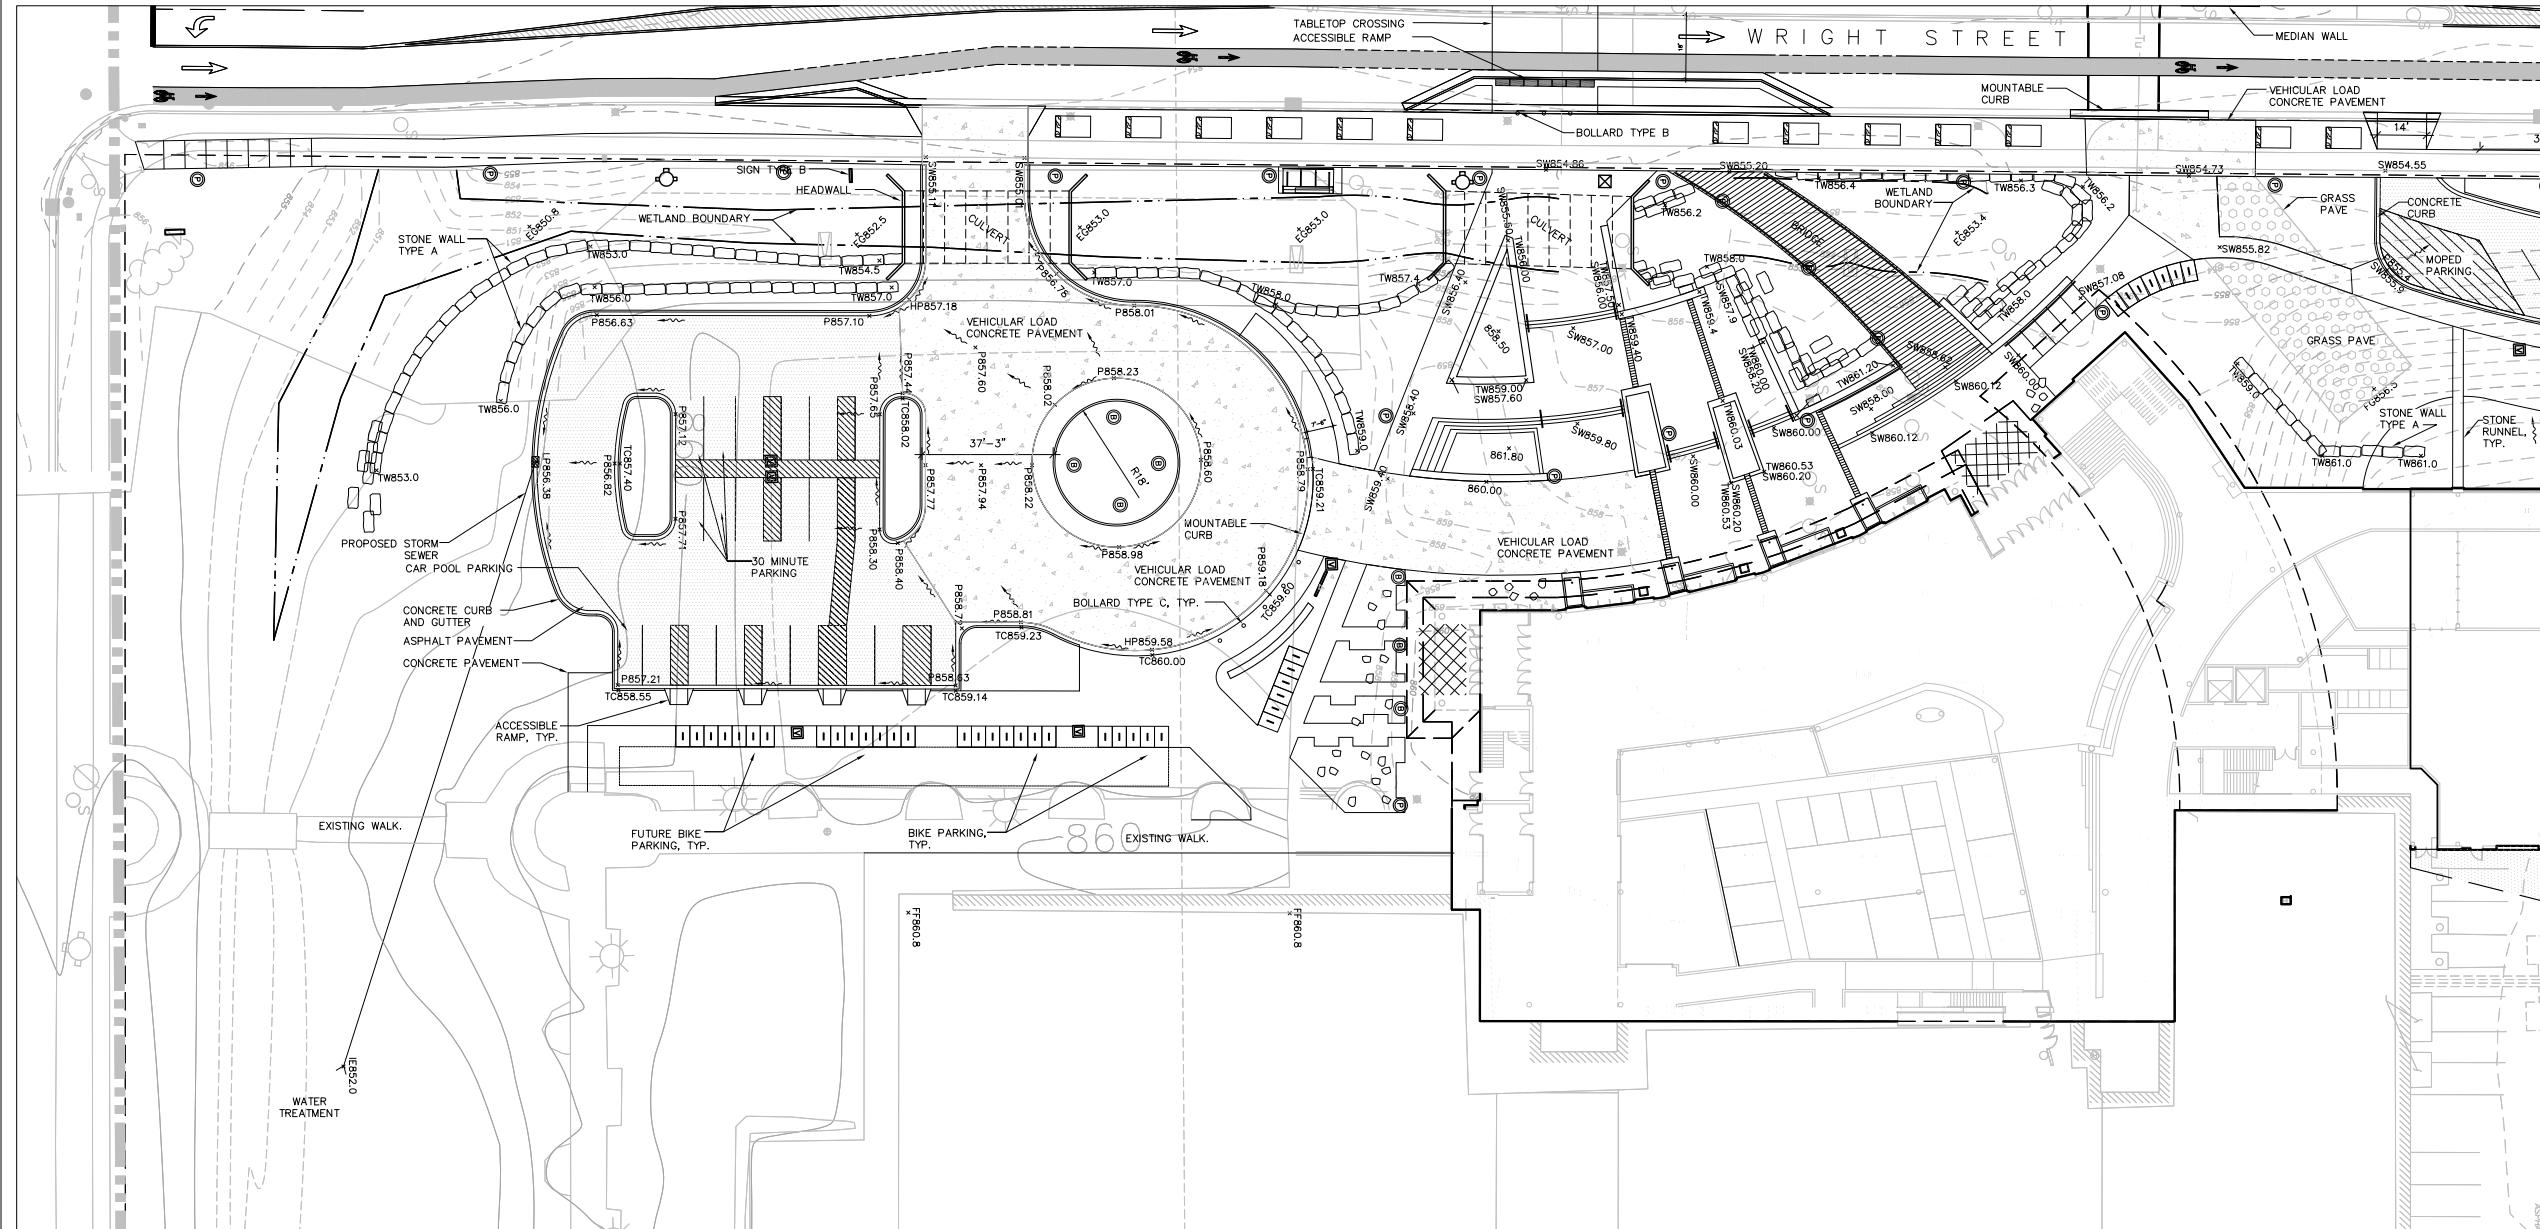
DRAWING

GATEWAY
SITE GRADING
PLAN



Sheet Number

LP-301



Project Title

 Truax
 Ingenuity Center

 City of Madison,
 Wisconsin

Issued For: Approval

Issue Date: 04/06/2011

SAA Project No. 2434

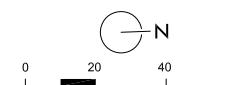
MC Project No. -

Bid Pkg No. B11-025

Revision Date

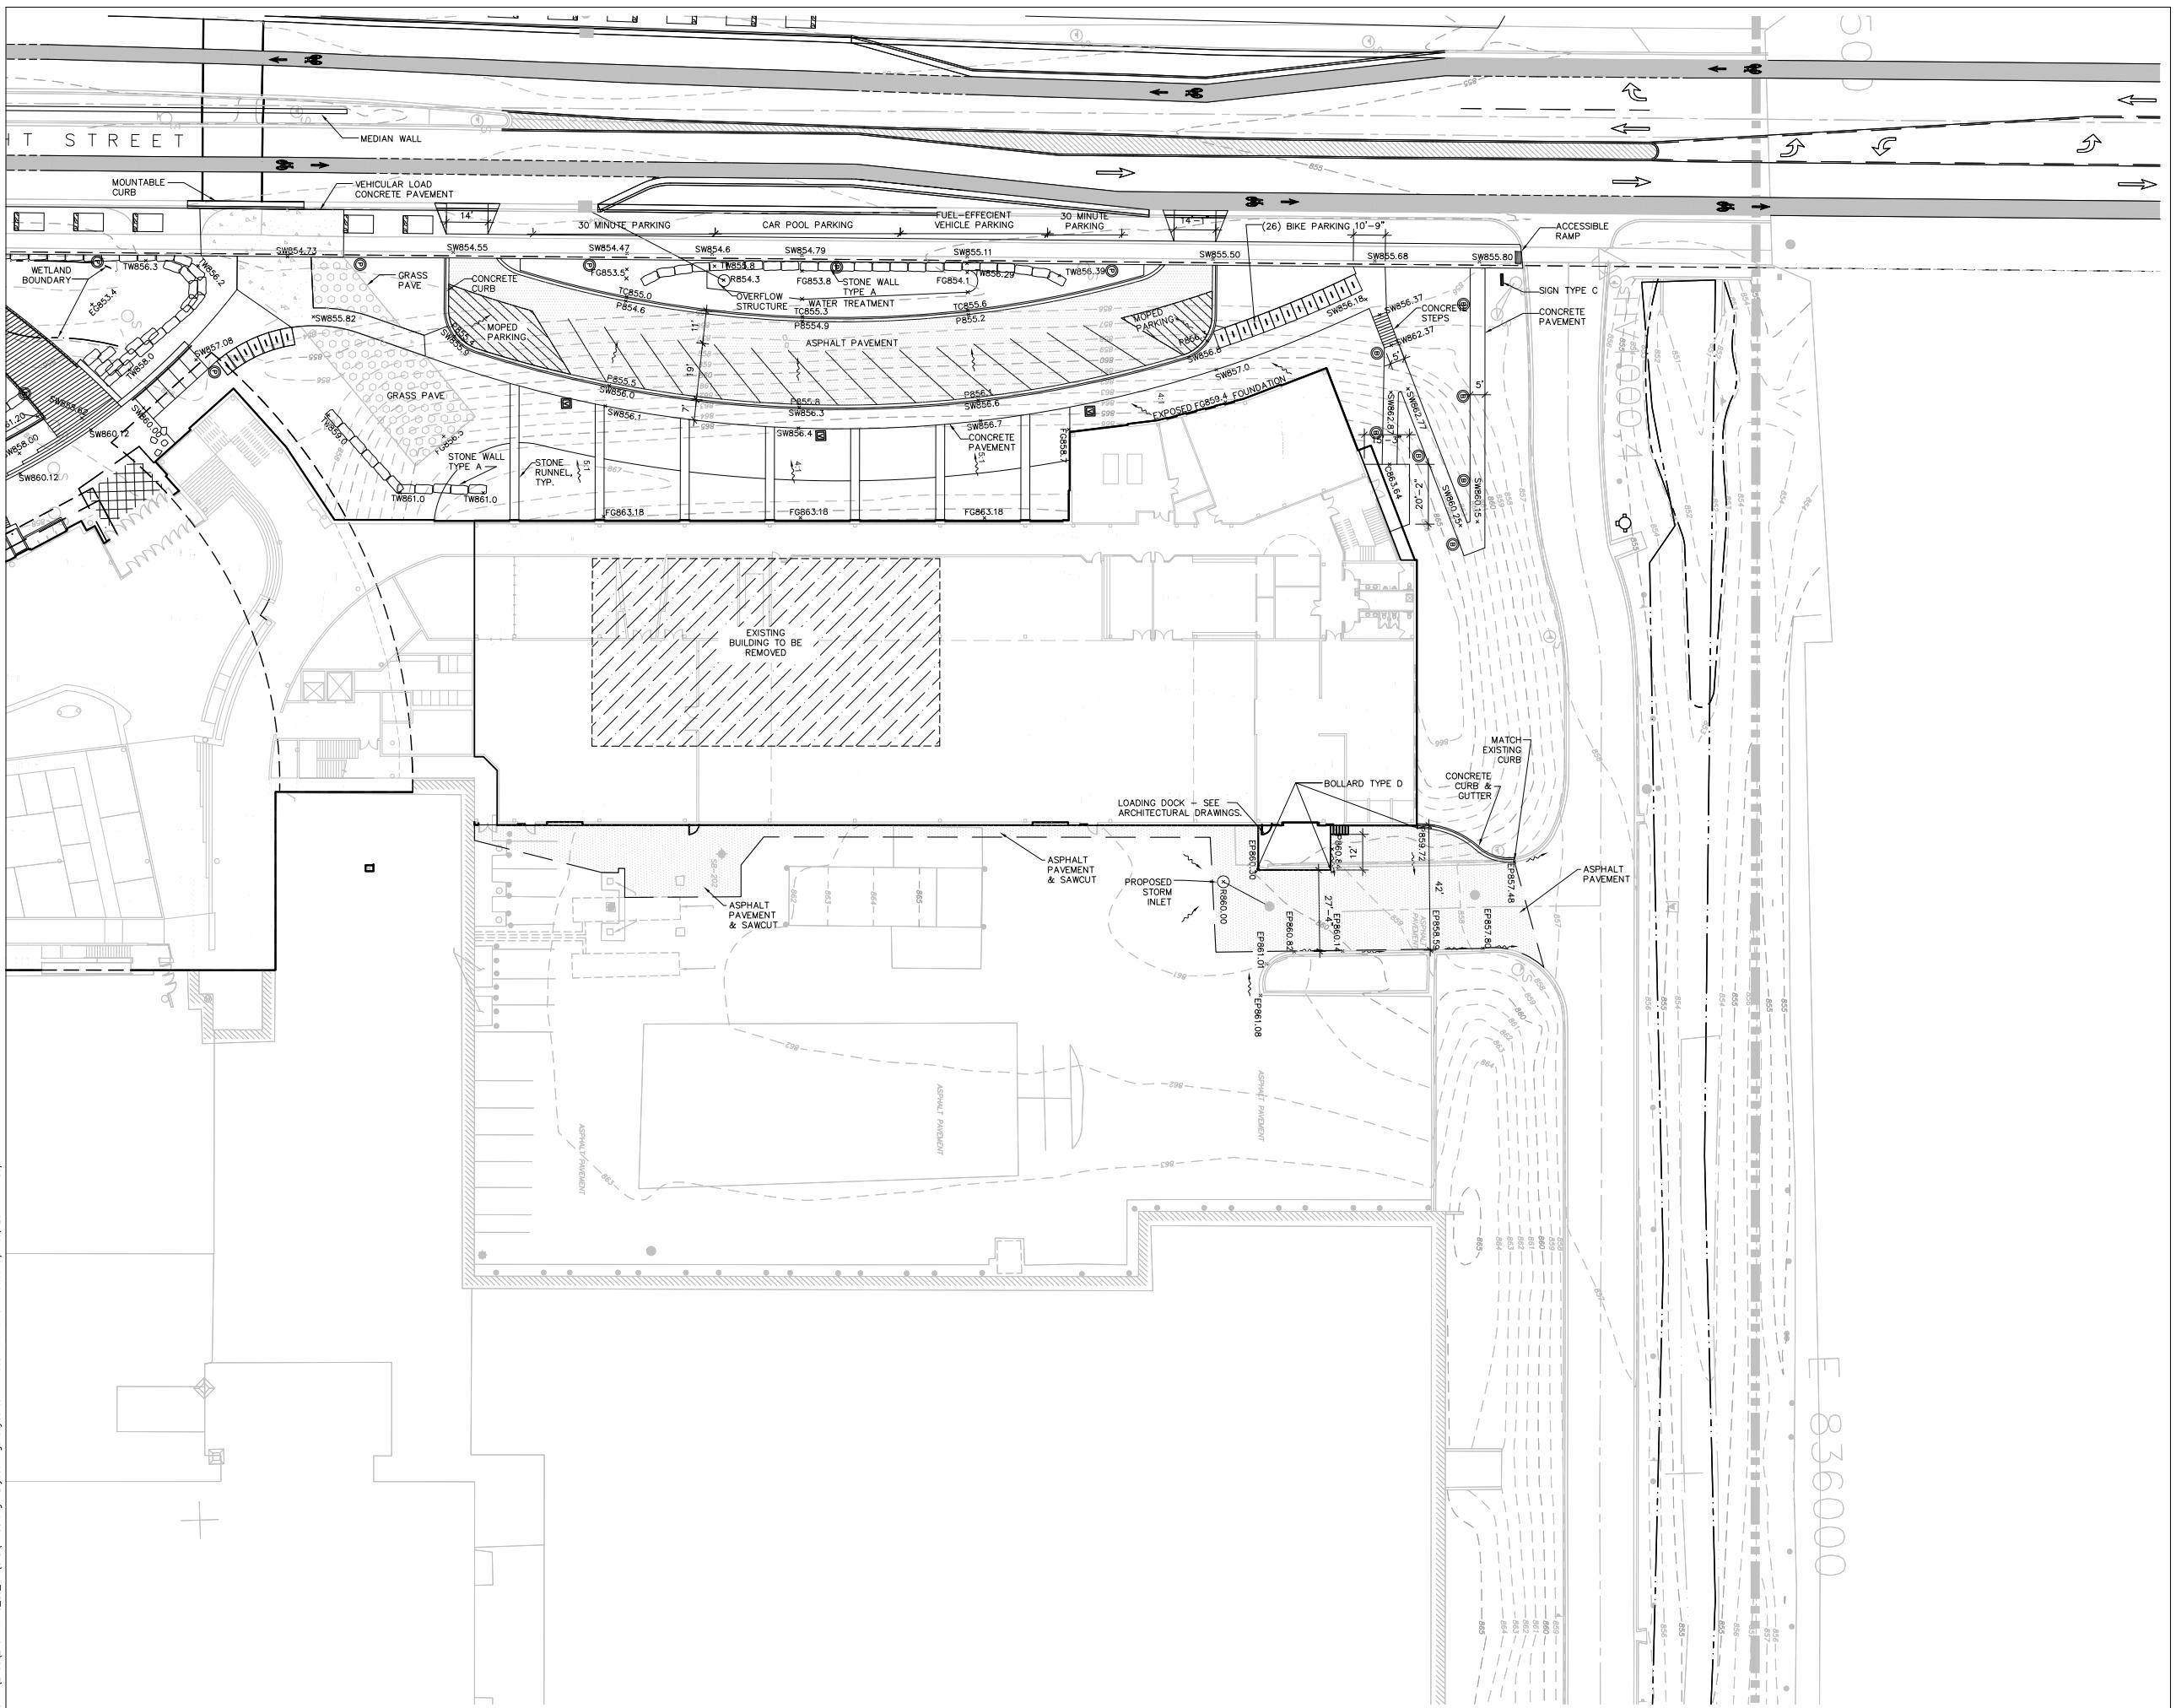

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 DRAWING
 GATEWAY
 SITE GRADING
 PLAN


Sheet Number

LP-302



Project Title
**Truax
Ingenuity Center**

City of Madison,
Wisconsin

Issued For: Approval
Issue Date: 04/06/2011
SAA Project No. 2434
MC Project No. -
Bid Pkg No. B11-025

Revision Date

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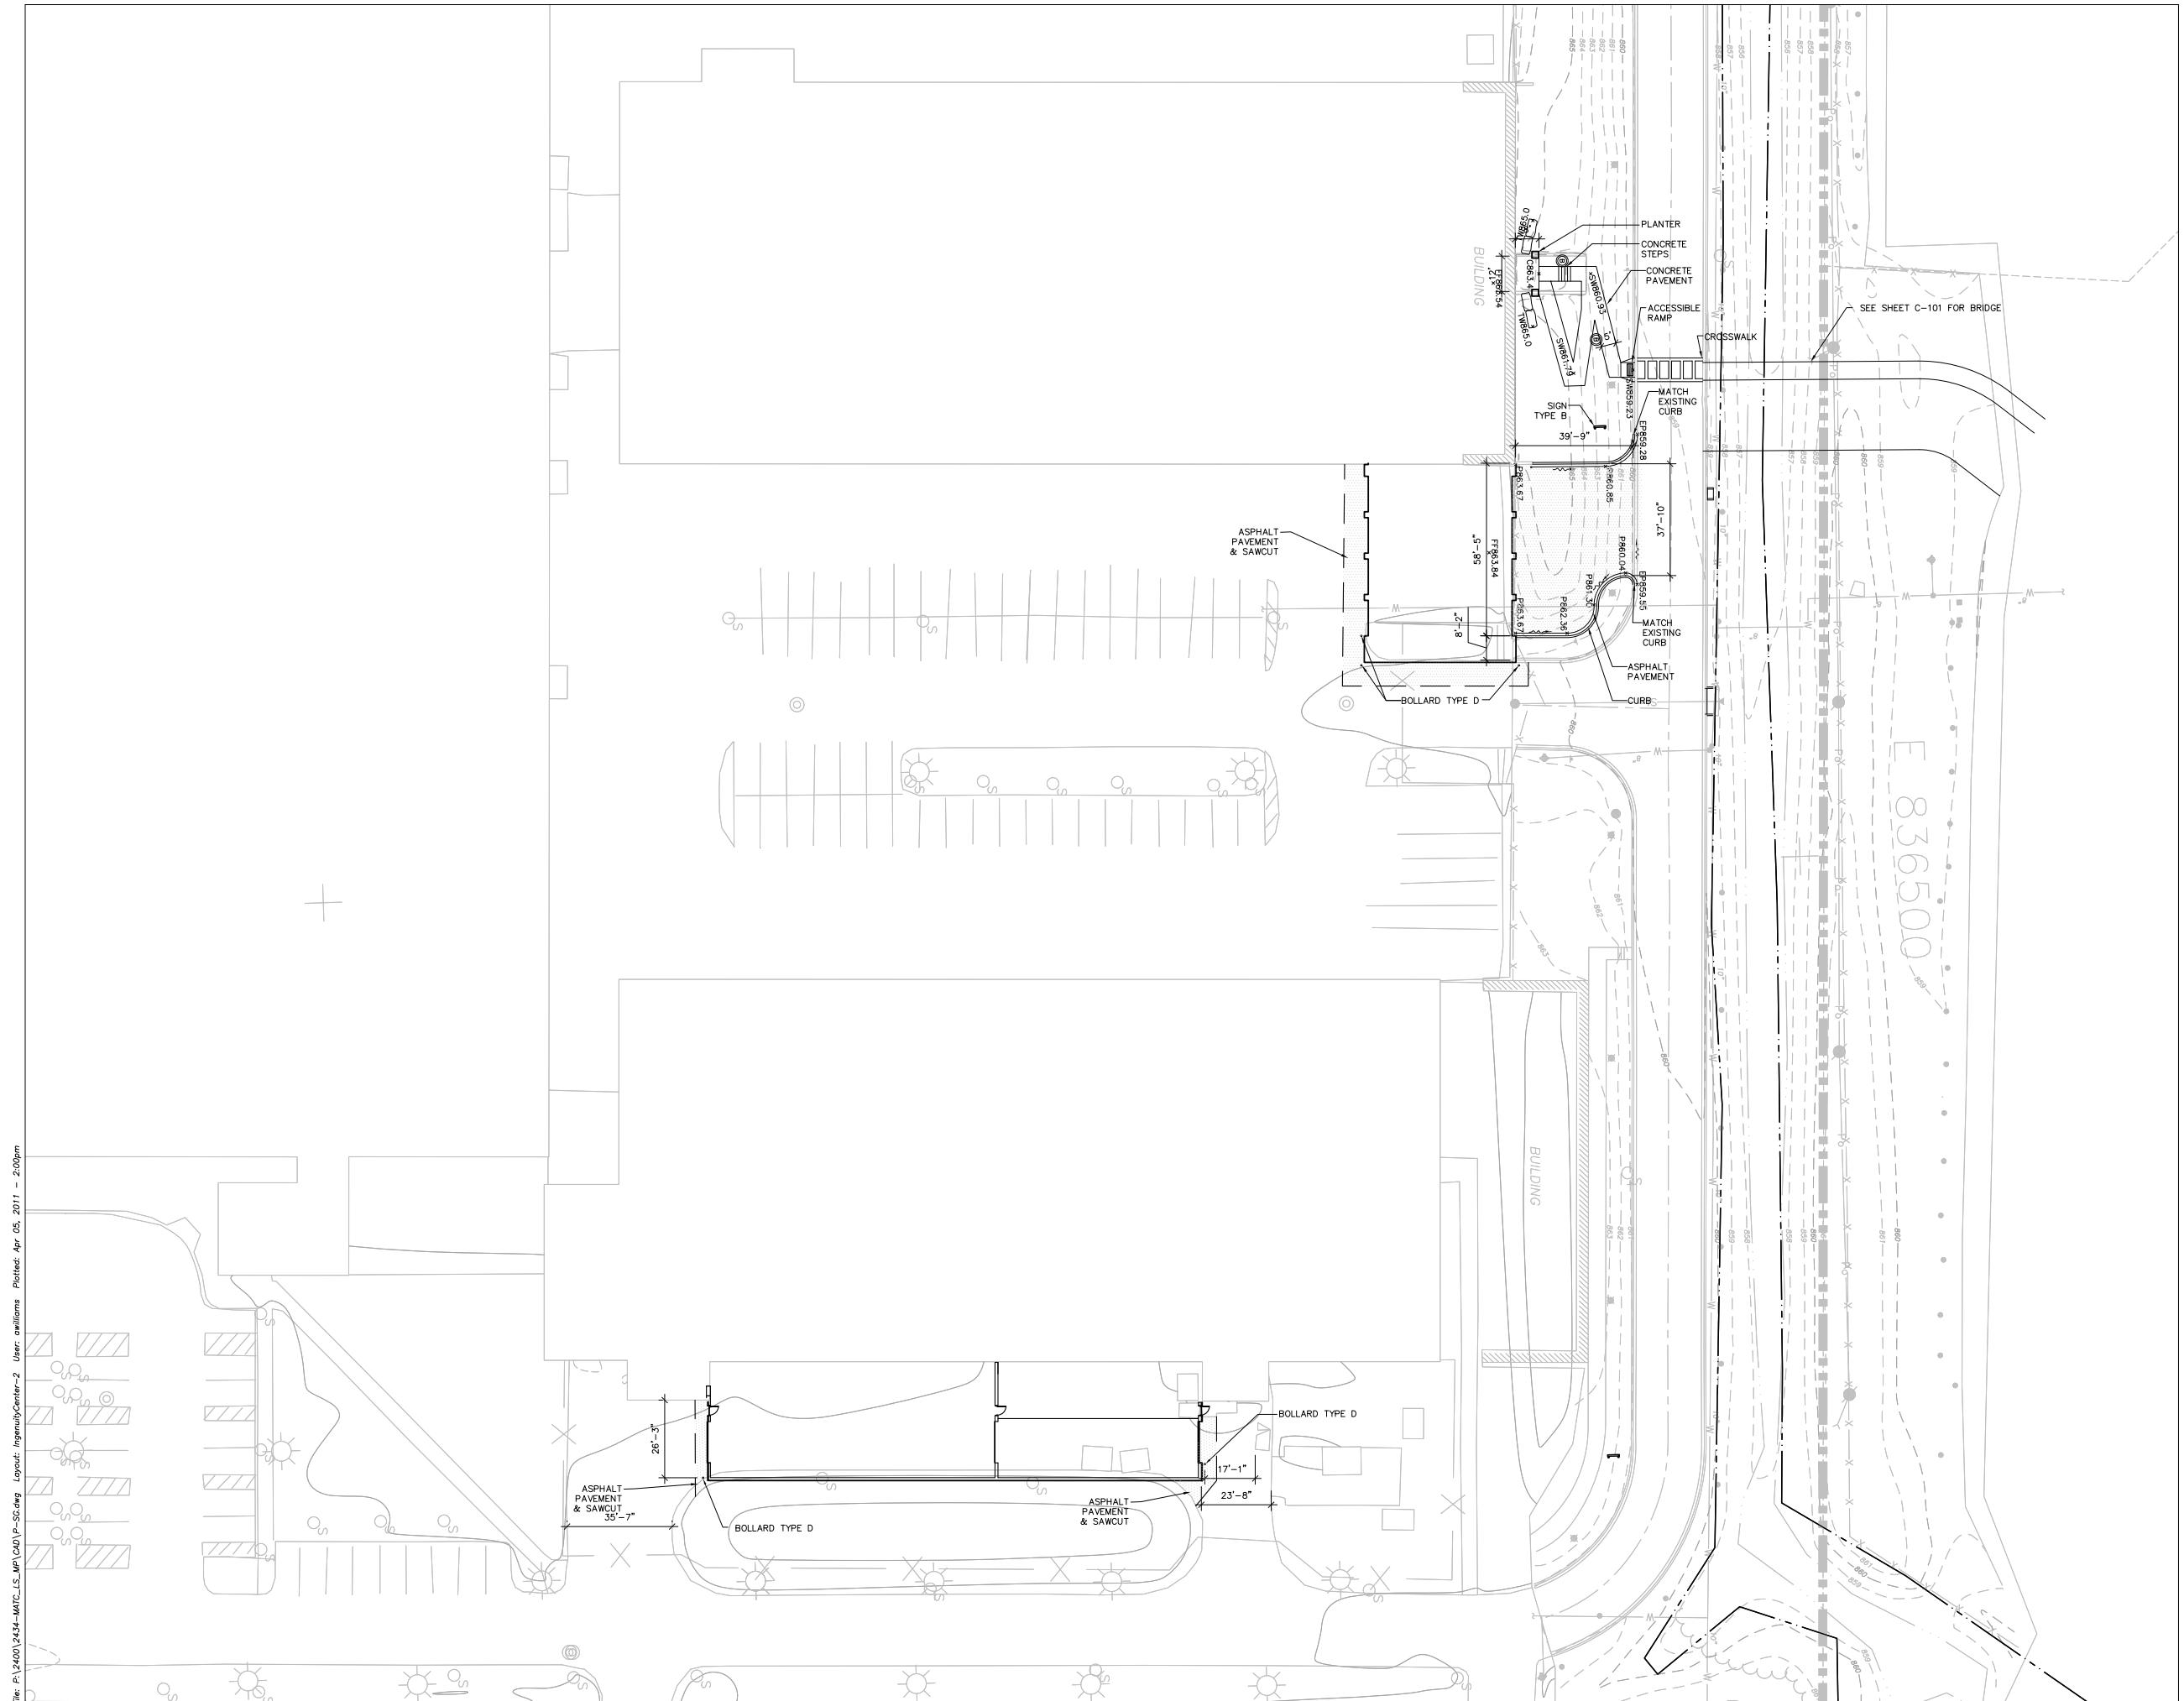


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Elmhurst, Illinois 60126
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DRAWING
GATEWAY
SITE GRADING
PLAN

0 20 40
N

Sheet Number
LP-303





Project Title

Truax Ingenuity Center

City of Madison, Wisconsin

Issued For:	Approval
Issue Date:	04/06/2011
SAA Project No.	2434
MC Project No.	-
Bid Pkg No.	B11-025

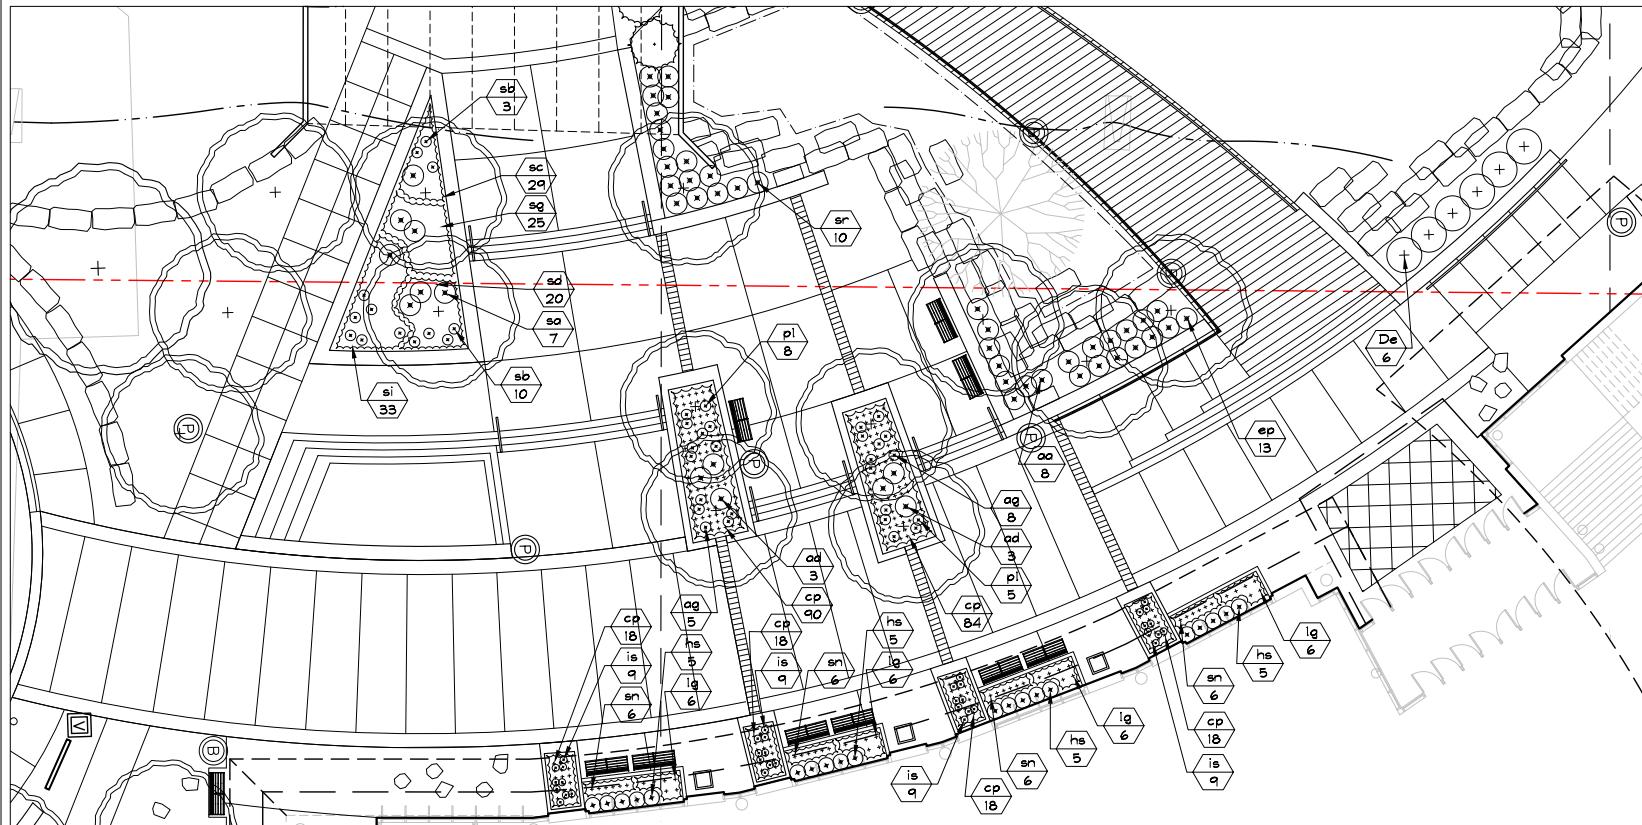
Revision	Date
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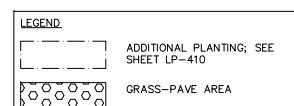
Conservation Design Forum
375 West First Street
Elmhurst, Illinois 60126
630.559.2000 Phone
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1 GATEWAY LANDSCAPE PLAN – SOUTH

SCALE: 1' = 20'-0"



LANDSCAPE POINTS – DROP OFF AND PARKING AREA					
NUMBER OF TREES REQUIRED:		TABULATION OF POINTS PROVIDED:			
NUMBER OF PARKING STALLS	21	REQUIRED CANOPY TREES	0 pts	2	0
LOADING AREAS	1	CANOPY TREES	35 pts	10	350
CANOPY TREES REQUIRED	2				
NUMBER OF LANDSCAPE POINTS REQUIRED:		TOTAL POINTS			350 pts
POINTS REQUIRED PER PARKING STALLS	103				
POINTS REQUIRED PER LOADING AREA	75				
TOTAL POINTS REQUIRED	178				



DRAWING

Sheet Number

LP-401

Project Title

 Truax
 Ingenuity Center

 City of Madison,
 Wisconsin

Issued For: Approval

Issue Date: 04/06/2011

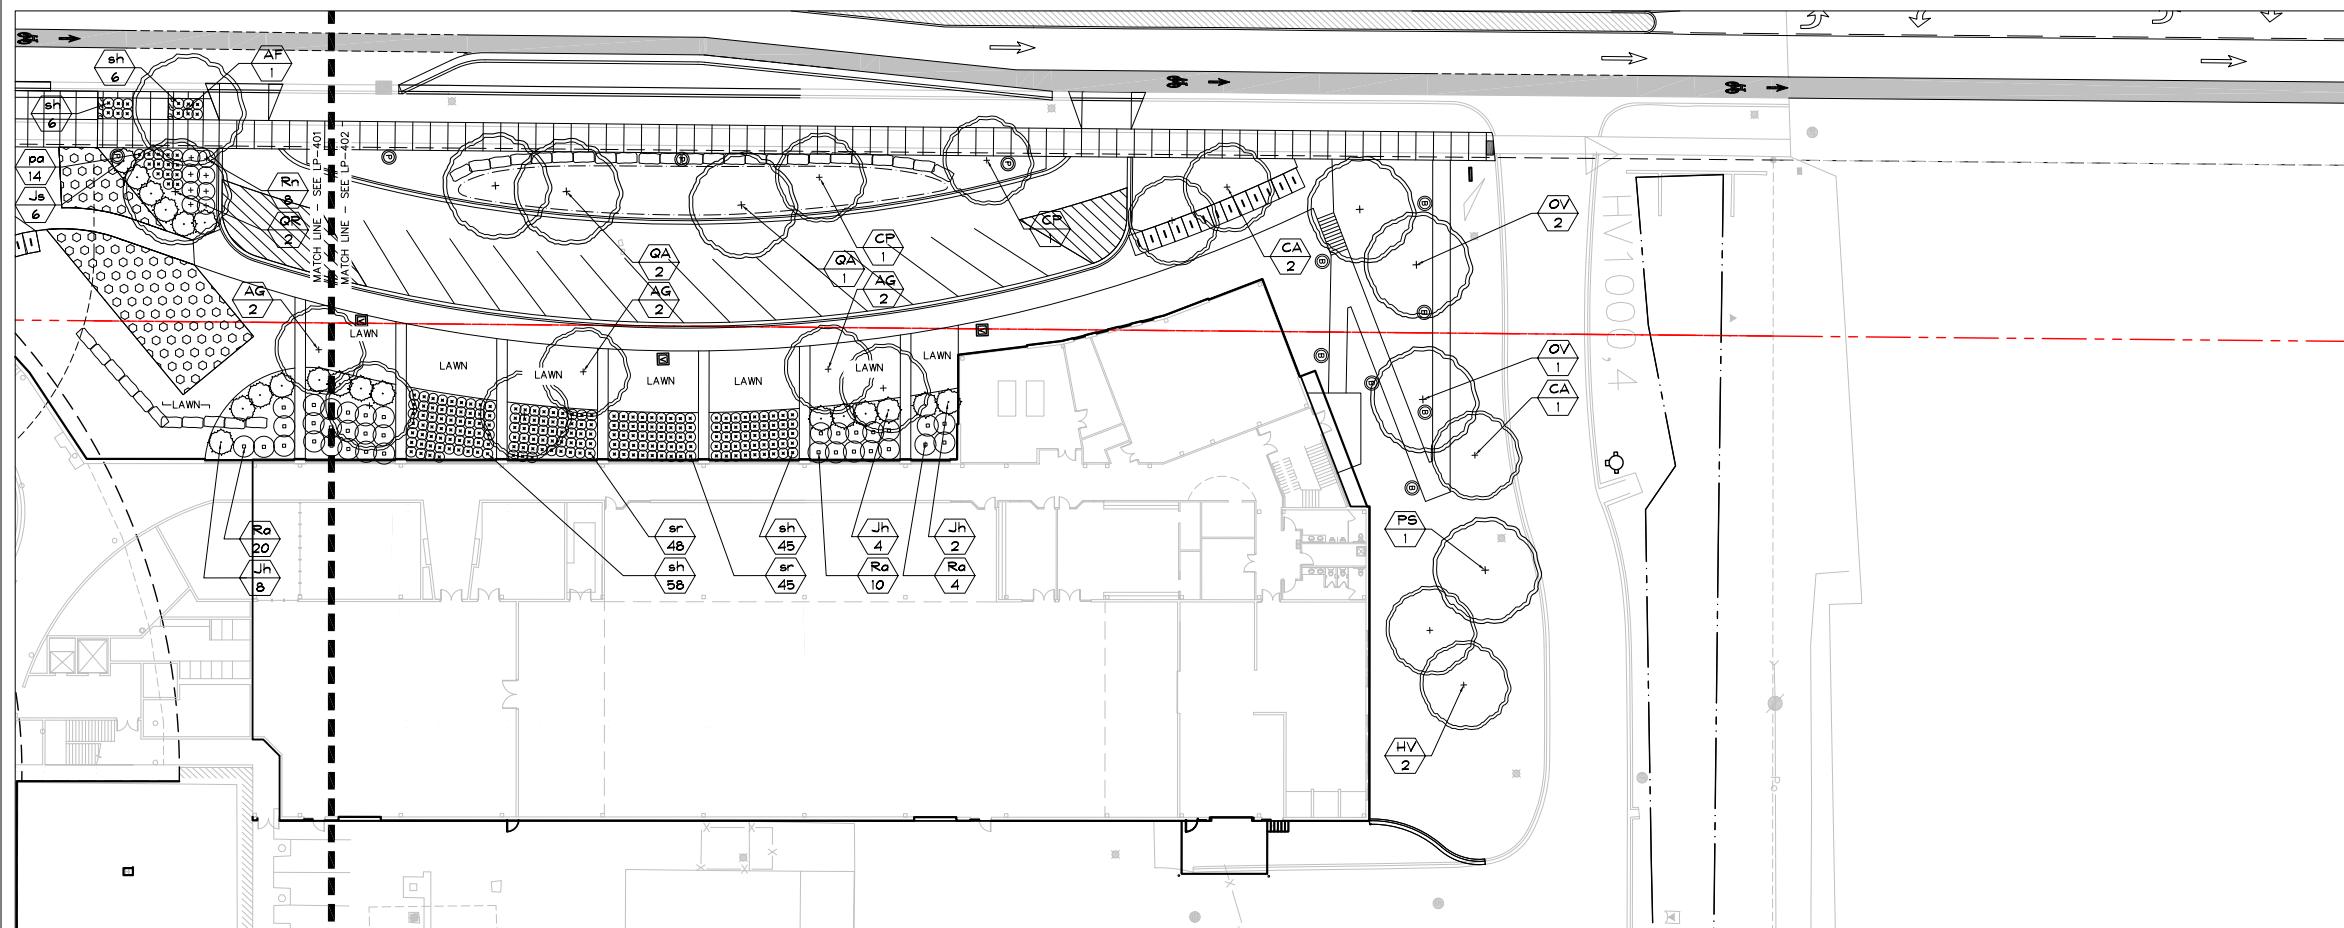
SAA Project No. 2434

MC Project No. -

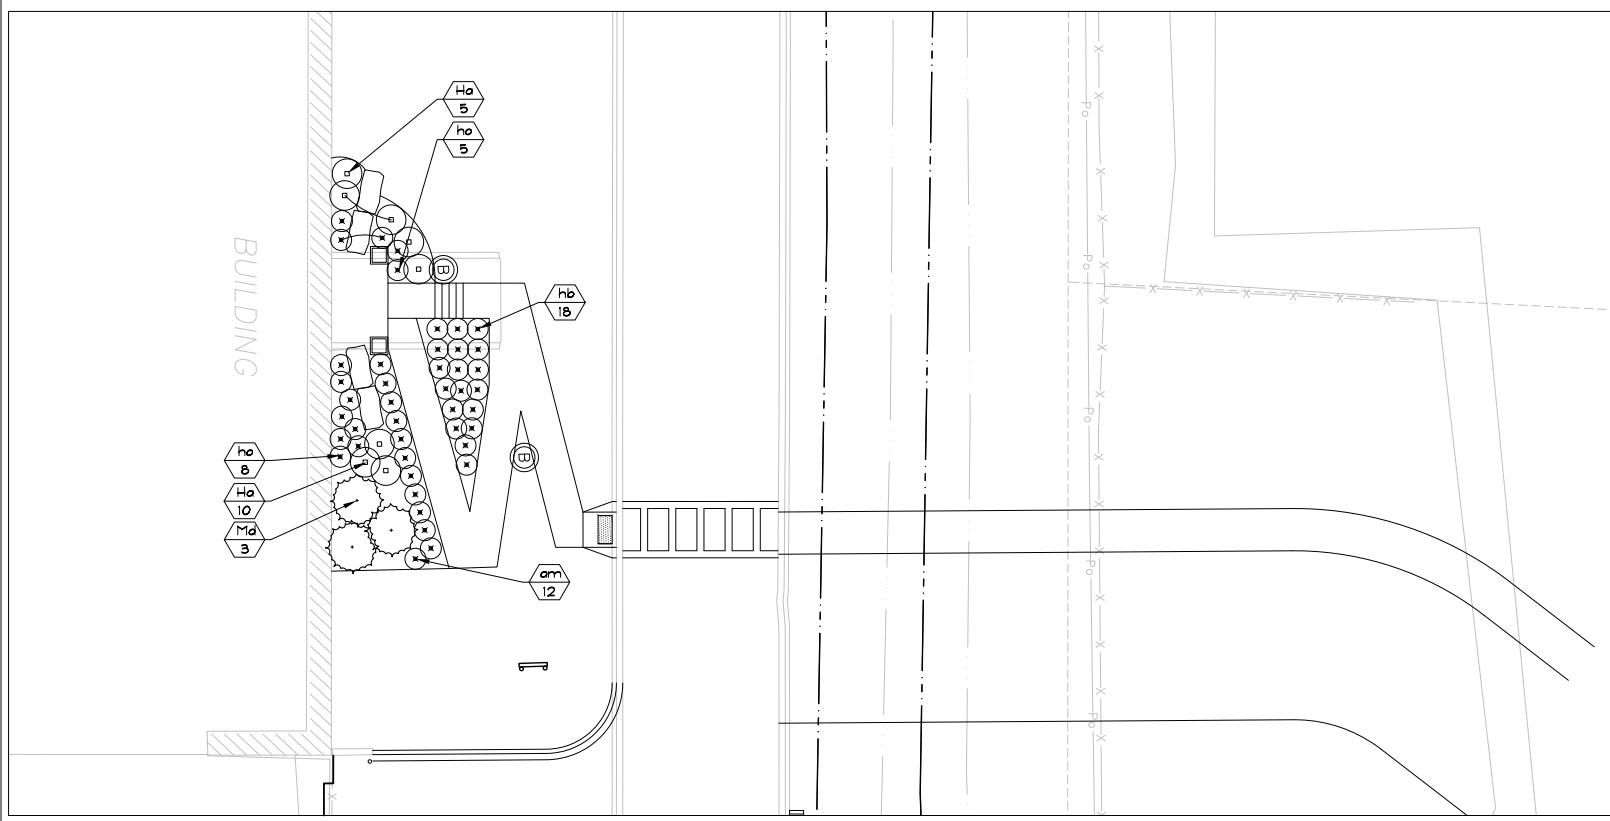
Bid Pkg No. B11-025

Revision Date


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 1 GATEWAY LANDSCAPE PLAN - NORTH
 (LP-401)

SCALE: 1'=20'-0"


 2 GATEWAY LANDSCAPE PLAN ENLARGEMENT - NORTH ENTRY AREA
 (LP-401)

LANDSCAPE POINTS - PARKING AREA

NUMBER OF TREES REQUIRED:

 NUMBER OF PARKING STALLS 16
 LOADING AREAS 1
 CANOPY TREES REQUIRED 1

TABULATION OF POINTS PROVIDED:

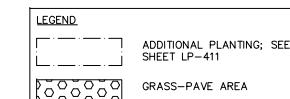
 REQUIRED CANOPY TREES 0 pts 1 0
 CANOPY TREES 35 pts 4 140
 ORNAMENTAL TREES 15 pts 5 75

NUMBER OF LANDSCAPE POINTS REQUIRED:

 POINTS REQUIRED PER PARKING STALLS 79
 POINTS REQUIRED PER LOADING AREA 75

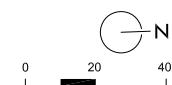
TOTAL POINTS 215 pts

TOTAL POINTS REQUIRED 154



DRAWING

LANDSCAPE PLAN



Sheet Number

LP-402

Project Title
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 City of Madison,
 Wisconsin

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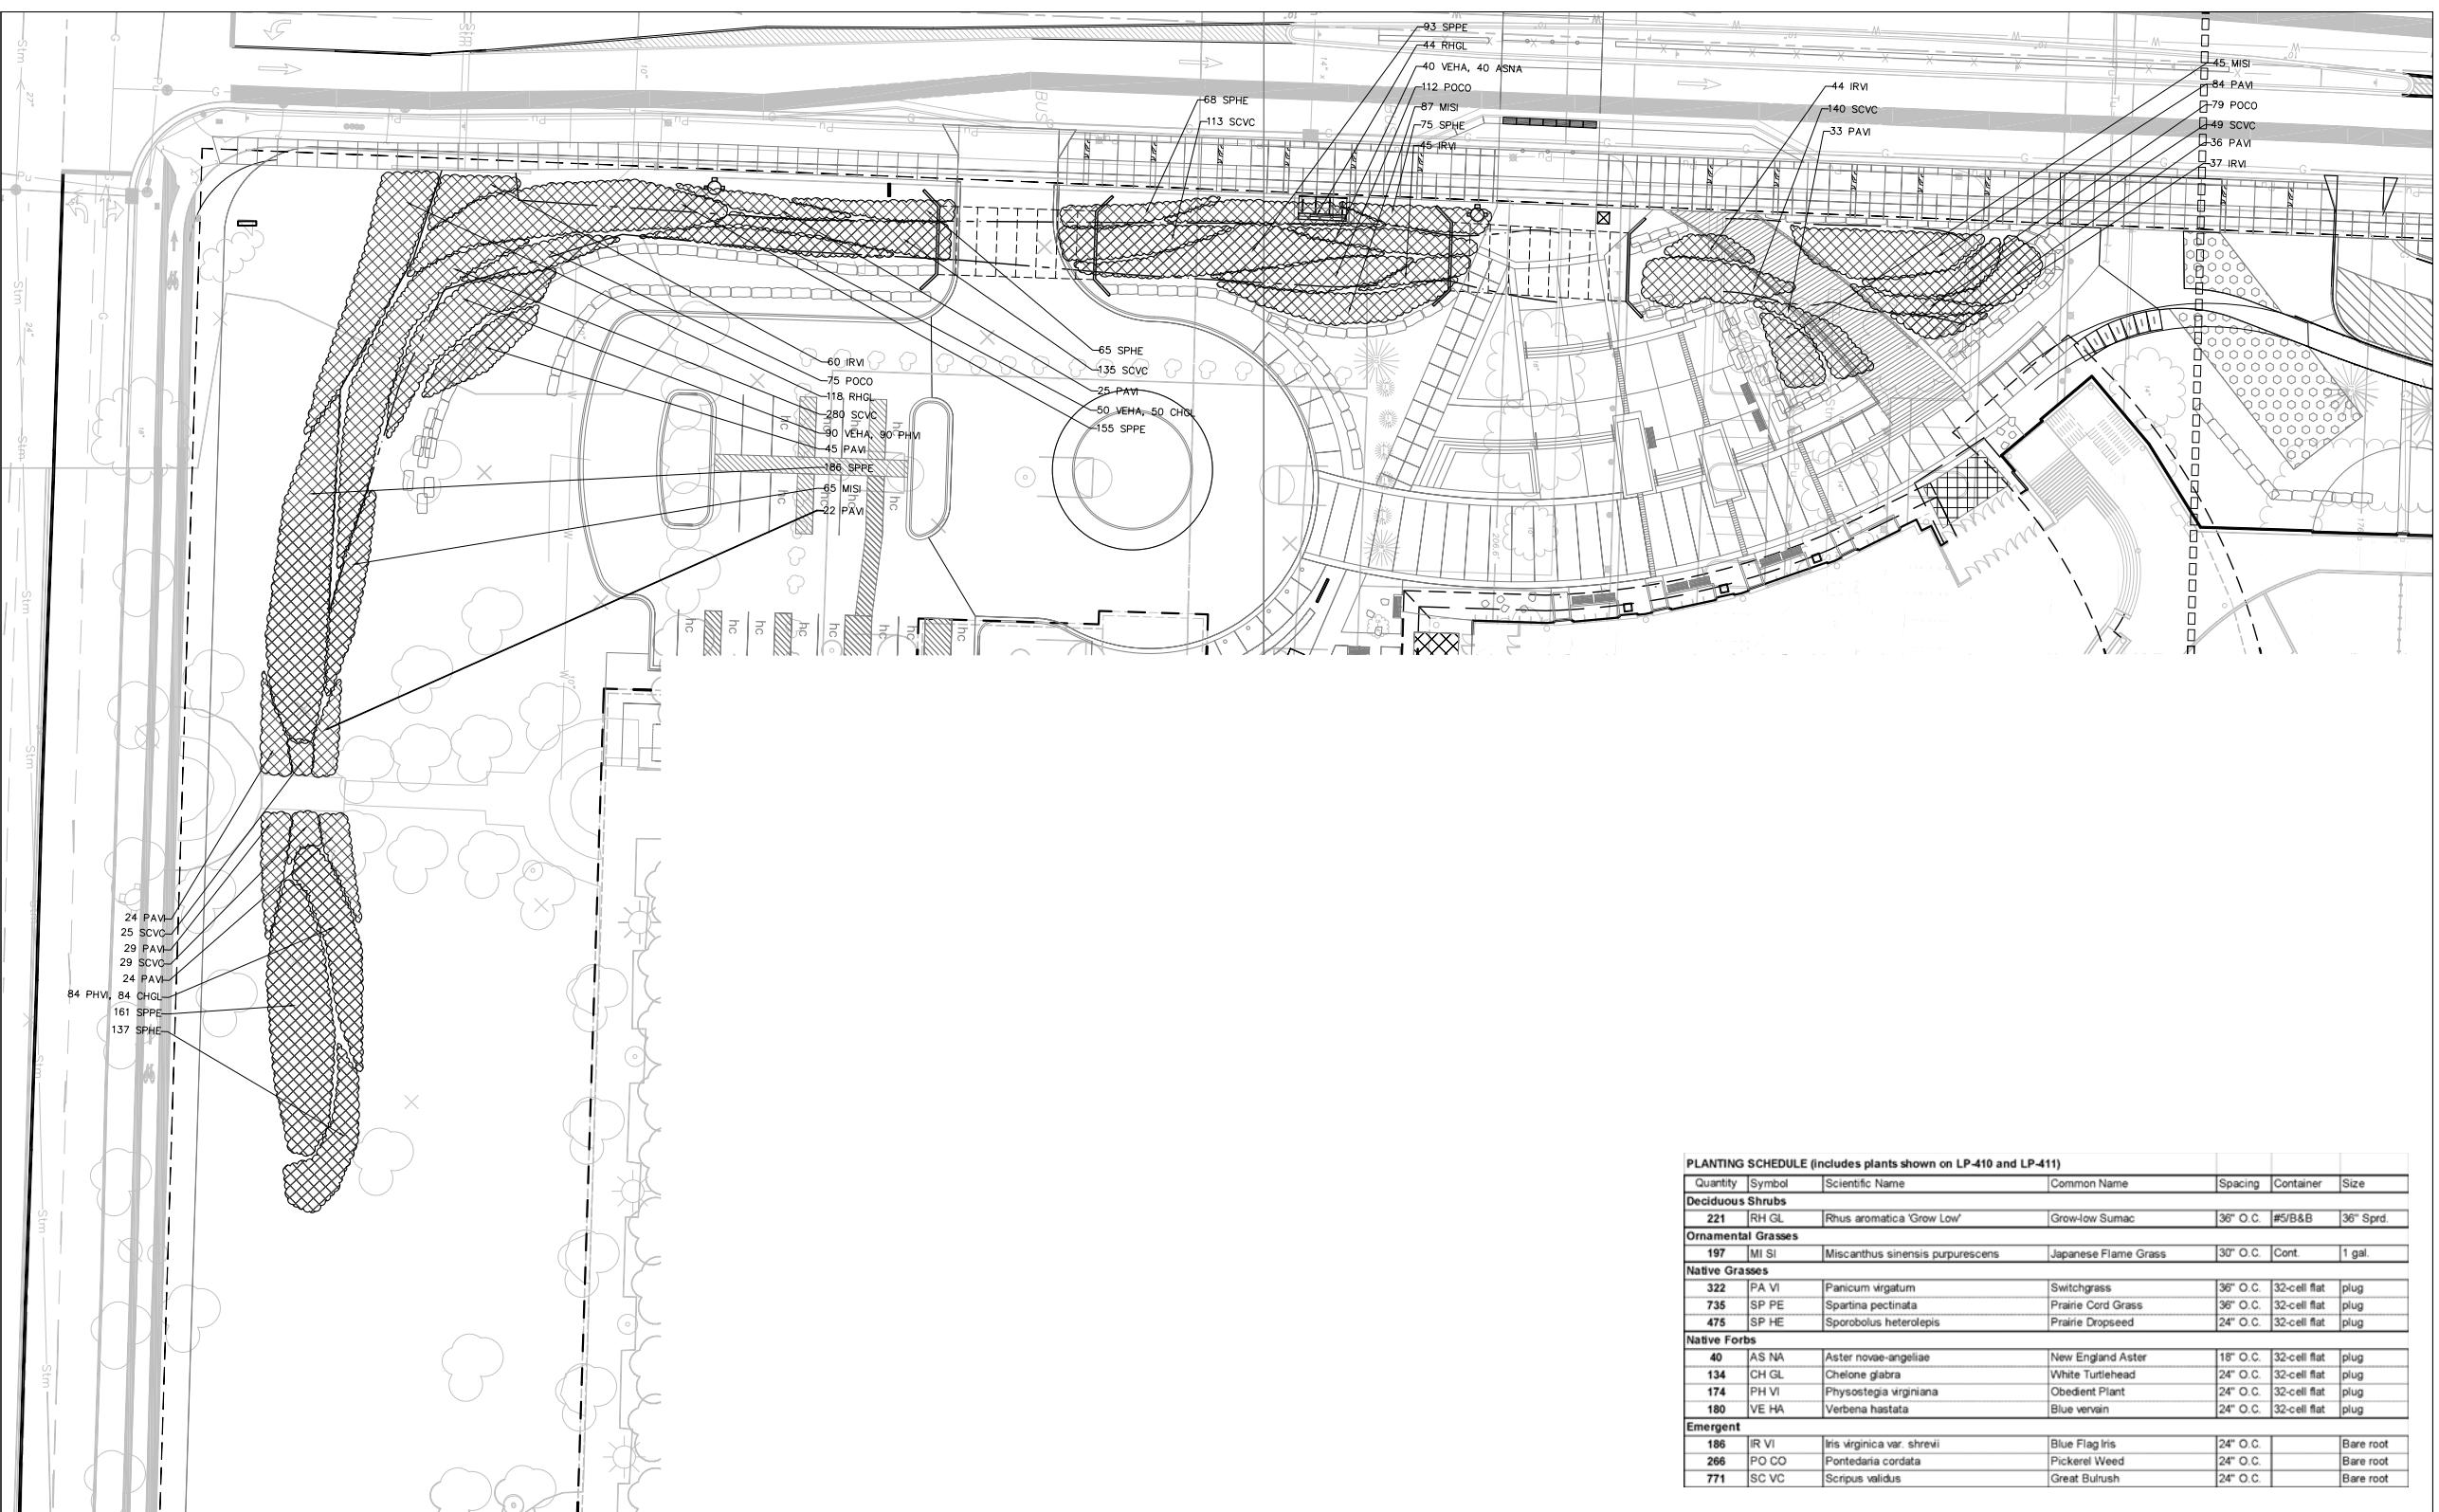

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 DRAWING
 SITE LAYOUT PLAN

 0 20 40


Sheet Number

LP-410


Project Title

Truax
Ingenuity Center
City of Madison,
 Wisconsin

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 Bid Pkg No. B11-025

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DRAWING

LANDSCAPE
PLANT SCHEDULE

Sheet Number

LP-420

LANDSCAPE PLANT LEGEND

Symbol	Botanical name	Common Name	Size	Root	Quantity	Comments
SHADE TREES						
AF	<i>Acer x freemanii</i> 'Morgan'	Morgan Freeman Maple	2.5" Cal.	B&B	—	
AM	<i>Acer miyabei</i> 'Morton'	State Street Maple	2.5" Cal.	B&B	—	
BN	<i>Betula nigra</i> 'Heritage'	Heritage River Birch	2.5" Cal.	B&B	—	
CJ	<i>Cercidiphyllum japonicum</i>	Katsura Tree	2.5" Cal.	B&B	—	
GD	<i>Gymnocladus dioicus</i>	Kentucky Coffeetree	2.5" Cal.	B&B	—	
GT	<i>Gleditsia triacanthos</i> 'Skymaster'	Skymaster Honeylocust	2.5" Cal.	B&B	—	
TD	<i>Taxodium distichum</i>	Bald Cypress	2.5" Cal.	B&B	—	
OV	<i>Ostrya virginiana</i>	Hop Hornbeam	2.5" Cal.	B&B	—	
PS	<i>Prunus serotina</i>	Black Cherry	2.5" Cal.	B&B	—	
QA	<i>Quercus alba</i>	Swamp White Oak	2.5" Cal.	B&B	—	
QR	<i>Quercus rubra</i>	Red Oak	2.5" Cal.	B&B	—	
ORNAMENTAL TREES						
AG	<i>Amelanchier x grandifolia</i> 'Autumn Brilliance'	Autumn Brilliance Serviceberry	1.5" Cal.	B&B	—	
AT	<i>Acer truncatum</i>	Purpleblow Maple	1.5" Cal.	B&B	—	
CA	<i>Cornus alternifolia</i>	Pagoda Dogwood	1.5" Cal.	B&B	—	
CC	<i>Cercis canadensis</i>	Redbud	1.5" Cal.	B&B	—	
CP	<i>Crataegus phoenicea</i>	Washington Hawthorne	1.5" Cal.	B&B	—	
CV	<i>Chionanthus virginicus</i>	White Fringe Tree	1.5" Cal.	B&B	—	
HV	<i>Hamamelis virginiana</i>	Common Witch Hazel	1.5" Cal.	B&B	—	
ML	<i>Magnolia x loebneri</i>	Loebner Magnolia	1.5" Cal.	B&B	—	
EVERGREEN TREES						
PA	<i>Picea abies</i>	Norway Spruce	8' Ht.	B&B	—	
PG	<i>Picea glauca</i> var. <i>densata</i>	Black Hills Spruce	8' Ht.	B&B	—	—
SHRUB TYPE A (> 8' ht.)						
Cm	<i>Cornus mas</i> 'Golden Glory'	Golden Glory Corneliancherry Dogwood	3'-5' Ht.	B&B	—	
Cr	<i>Cornus racemosa</i>	Gray Dogwood	3'-5' Ht.	B&B	—	
Cs	<i>Cornus sericea</i>	Redosier Dogwood	3'-5' Ht.	B&B	—	
Rt	<i>Rhus typhina</i> 'Laciniata'	Cutleaf Staghorn Sumac	3'-5' Ht.	B&B	—	—
SHRUB TYPE B (4'-8' ht.)						
Ca	<i>Clethra alnifolia</i> 'Hummingbird'	Hummingbird Clethra	5 Gal.	CG	—	
Cl	<i>Cotoneaster lucidus</i>	Hedge Cotoneaster	5 Gal.	CG	—	
Cf	<i>Calycanthus floridus</i>	Carolina Allspice	5 Gal.	CG	—	
Hp	<i>Hydrangea paniculata</i> 'Limelight'	Panicle Hydrangea	5 Gal.	CG	—	
Rr	<i>Rosa</i> 'Radsummer'	The Sunny Knock Out Rose	5 Gal.	CG	—	
Sp	<i>Salix purpurea</i> 'Nana'	Dwarf Arctic Blue Willow	5 Gal.	CG	—	
Vd	<i>Viburnum dentatum</i> 'Autumn Jazz'	Autumn Jazz Arrowwood Viburnum	5 Gal.	CG	—	
SHRUB TYPE C (< 4' ht.)						
Bg	<i>Buxus</i> 'Green Velvet'	Green Velvet Boxwood	3 Gal.	CG	—	
Ce	<i>Ceanothus americanus</i>	New Jersey Tea	3 Gal.	CG	—	
De	<i>Deutzia gracilis</i>	Slender Deutzia	3 Gal.	CG	—	
Di	<i>Dierama lonicera</i>	Dwarf Bush Honeysuckle	3 Gal.	CG	—	
Fg	<i>Fothergilla gardenii</i> 'Mt. Airy'	Mt. Airy Dwarf Fothergilla	3 Gal.	CG	—	
Ha	<i>Hydrangea arborescens</i> 'Annabelle'	Annabelle Hydrangea	3 Gal.	CG	—	
Ra	<i>Rhus aromatica</i> 'Gro-Low'	Gro-Low Fragrant Sumac	3 Gal.	CG	—	
Rn	<i>Rosa</i> 'Nearly Wild'	Nearly Wild Shrub Rose	3 Gal.	CG	—	
Vo	<i>Viburnum opulus</i> 'Nanum'	European Cranberrybush	3 Gal.	CG	—	
SHRUB TYPE D (Evergreen; 5'-8' Ht.)						
Tr	<i>Thuja occidentalis</i> 'Robusta'	Ware or Robusta Juniper	3 Gal.	CG	—	
SHRUB TYPE D (Evergreen; 2'-5' Ht.)						
Jb	<i>Juniperus squamata</i> 'Blue Star'	Blue Star Juniper	3 Gal.	CG	—	
Jh	<i>Juniperus horizontalis</i> 'Bar Harbor'	Bar Harbor Creeping Juniper	3 Gal.	CG	—	
Jp	<i>Juniperus</i> 'Pfitzeriana Compacta'	Compact Pfitzer Juniper	3 Gal.	CG	—	
Js	<i>Juniperus chinensis</i> 'Sea Green'	Sea Green Juniper	3 Gal.	CG	—	
Md	<i>Microbiota decussata</i>	Siberian Cypress	3 Gal.	CG	—	
Tm	<i>Taxus x media</i> 'Tauntonii'	Taunton Yew	3 Gal.	CG	—	

PERENNIALS/GRASSES/GROUNDCOVERS						
aa	<i>Astilbe x arendsi</i> 'White Gloria'	White Gloria Astilbe	1 Gal.	CG	—	
ac	<i>Aquilegia canadensis</i>	American Columbine	1 Gal.	CG	—	
ad	<i>Aster divaricatus</i>	White Wood Aster	1 Gal.	CG	—	
ag	<i>Allium</i> 'Globemaster'	Globemaster Onion	1 Gal.	CG	—	
am	<i>Alchemilla</i> spp.	Lady's Mantle	1 Gal.	CG	—	
ar	<i>Ajuga reptans</i>	Bugleweed	1 Gal.	CG	—	
ca	<i>Calamagrostis acutiflora</i> 'Karl Foerster'	Karl Foerster Feather Reed Grass	1 Gal.	CG	—	
cl	<i>Chasmanthium latifolium</i>	Northern Sea Oats	1 Gal.	CG	—	
cp	<i>Carex pennisylvanica</i>	Pennsylvania Sedge	1 Gal.	CG	—	
cs	<i>Coreopsis grandiflora</i> 'Sunray'	Sunray Tickseed	1 Gal.	CG	—	
ep	<i>Echinacea purpurea</i>	Purple Coneflower	1 Gal.	CG	—	
hb	<i>Hosta</i> 'Blue Angel'	Blue Angel Hosta	1 Gal.	CG	—	
ho	<i>Hosta</i> 'Royal Standard'	Royal Standard Hosta	1 Gal.	CG	—	
hh	<i>Hemerocallis</i> 'Happy Returns'	Happy Returns Daylily	1 Gal.	CG	—	
lg	<i>Lavandula intermedia</i> 'Grosso'	Grosso Lavender	1 Gal.	CG	—	
hs	<i>Helictotrichon sempervirens</i>	Blue Oat Grass	1 Gal.	CG	—	
hm	<i>Hemerocallis</i> 'Mini Stella'	Mini Stella Daylily	1 Gal.	CG	—	
is	<i>Iris siberica</i> 'Caesar's Brother'	Caesar's Brother Siberian Iris	1 Gal.	CG	—	
mf	<i>Monarda</i> 'Petite Delight'	Petite Delight Beebalm	1 Gal.	CG	—	
nf	<i>Nepeta x fassennii</i> 'Six Hills Giant'	Six Hills Giant Catmint	1 Gal.	CG	—	
pl	<i>Phlox subulata</i>	Creeping Phlox	1 Gal.	CG	—	
ps	<i>Panicum virgatum</i> 'Shenandoah'	Shenandoah Switch Grass	1 Gal.	CG	—	
pa	<i>Pervoskia atriplicifolia</i> 'Longin'	Longin Russian Sage	1 Gal.	CG	—	
pq	<i>Parthenocissus quinquefolia</i>	Star Showers Virginia Creeper	1 Gal.	CG	—	
rh	<i>Rudbeckia fulgida</i> var. <i>Sullivantii</i>	Goldstrum Black Eyed Susan	1 Gal.	CG	—	
sh	<i>Sporobolus heterolepis</i>	Prairie Dropseed	1 Gal.	CG	—	
sa	<i>Sedum</i> 'Autumn Joy'	Autumn Joy Sedum	1 Gal.	CG	—	
sb	<i>Sedum spectabile</i> 'Brilliant'	Brilliant Sedum	1 Gal.	CG	—	
sc	<i>Sedum caeruleum</i> 'Sunset Cloud'	Sunset Cloud Sedum	1 Gal.	CG	—	
sd	<i>Sedum divergens</i>	Cascade Stonecrop	1 Gal.	CG	—	
sg	<i>Sedum grisbachii</i>	Stoncrop	1 Gal.	CG	—	
si	<i>Sedum hybridum</i> 'Immergrunchen'	Immergrunchen Stonecrop	1 Gal.	CG	—	
sn	<i>Salvia nemerosa</i> 'May Night'	May Night Salvia	1 Gal.	CG	—	

Project Title

 Truax
 Ingenuity Center

 City of Madison,
 Wisconsin

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SAA Project No. 2434

MC Project No. -

Bid Pkg No. B11-025

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SAA DESIGN
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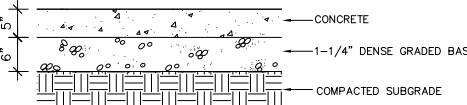
 DRAWING
 DETAILS

 0
 Sheet Number

LP-501

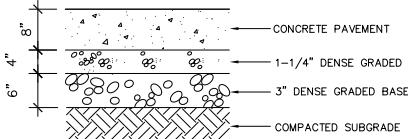
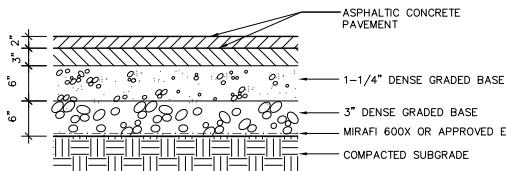
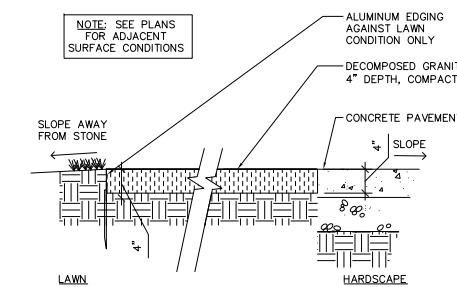
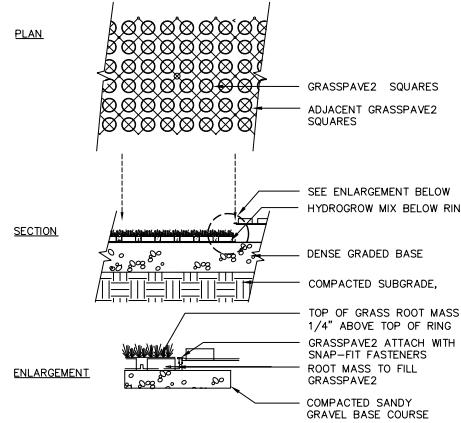
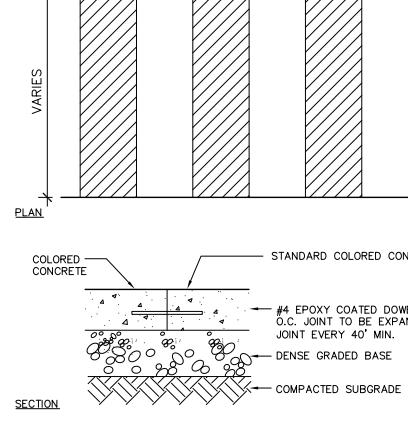
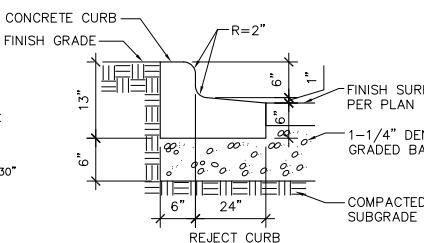
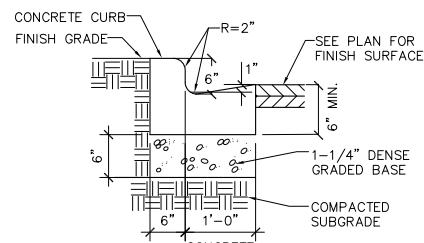
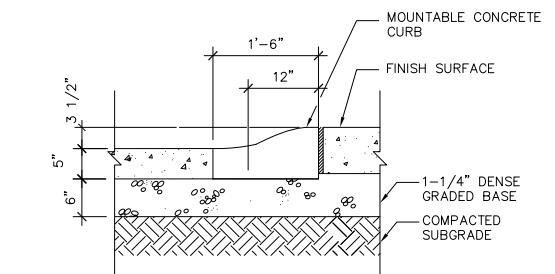
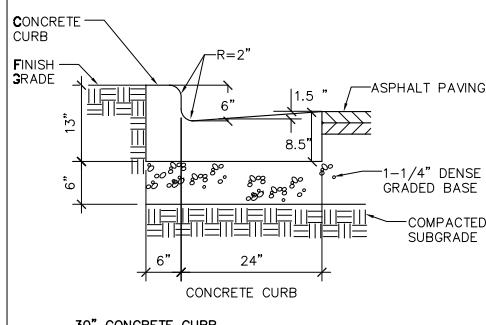
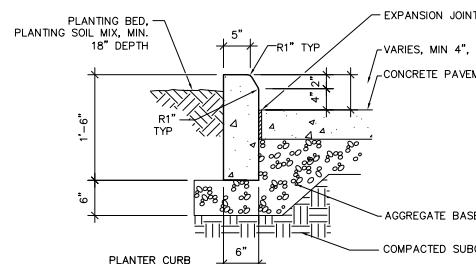
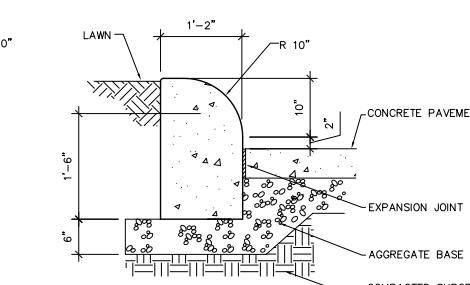
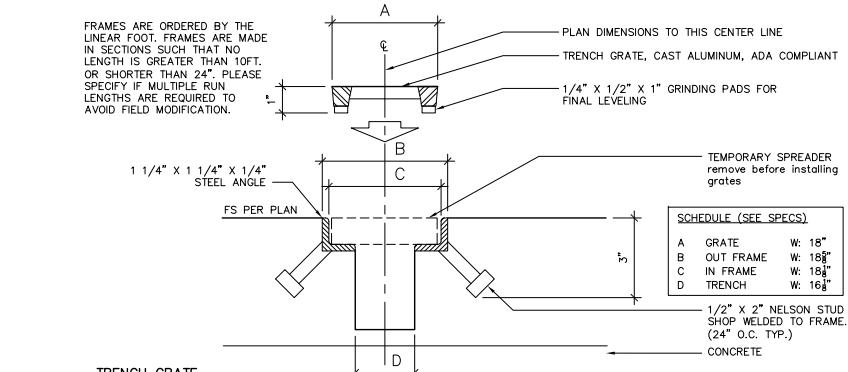
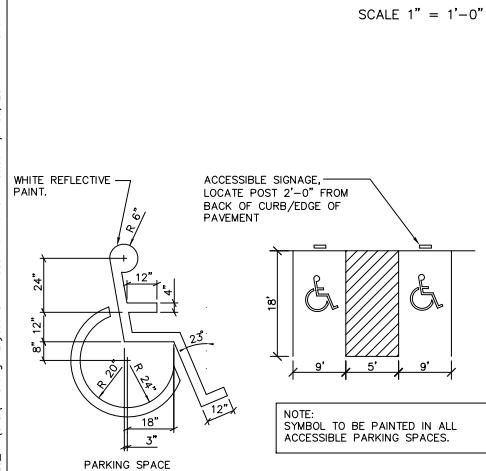
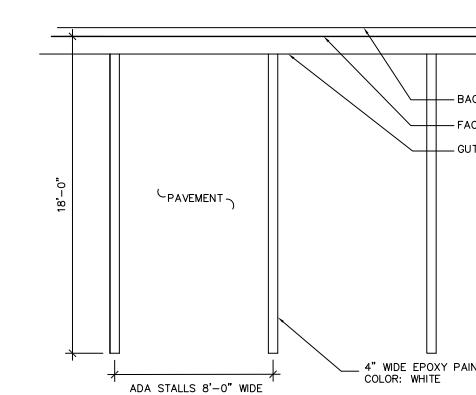
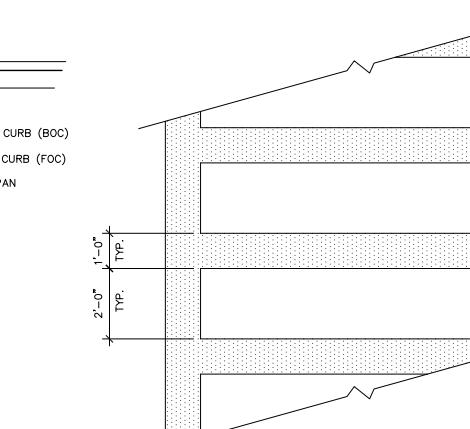
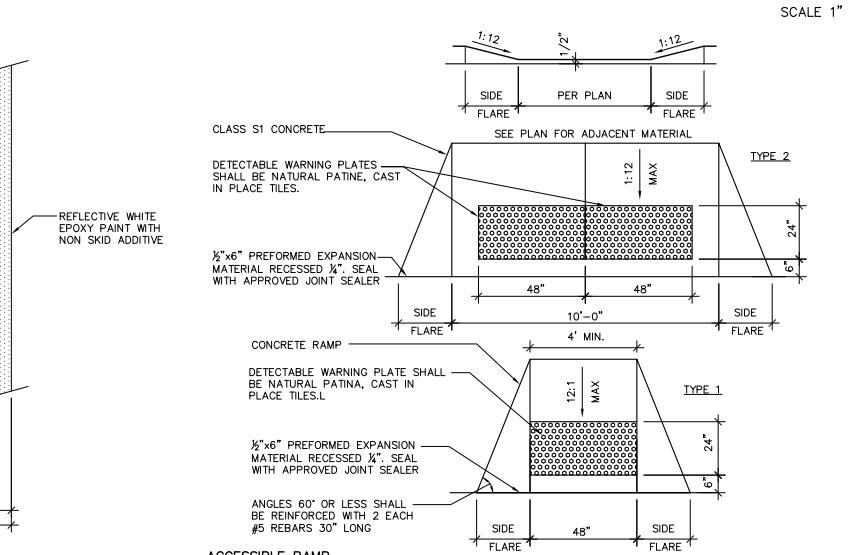
NOTES:

1. MEDIUM BROOM FINISH, PERPENDICULAR TO DIRECTION OF TRAVEL UNLESS OTHERWISE STATED.
2. PROVIDE EXPANSION JOINTS 30° ALL WAYS, MINIMUM 3. STANDARD COLOR CONCRETE UNLESS NOTED.


 CONCRETE PAVEMENT
 SCALE 1" = 1'-0"

NOTES:

1. LONGITUDINAL (EXPANSION) JOINTS SHALL HAVE 24" LONG #4 EPOXY COATED REBAR AT 39" O.C. AT A DEPTH OF 3 3/4" ± 1".
2. TRANSVERSE JOINTS SHALL HAVE 18" LONG, 1" DIA. EPOXY COATED, SMOOTH DOWEL BARS AT 72" O.C. AT 4" DEPTH.
3. STANDARD CONCRETE COLORED UNLESS NOTED.


 VEHICULAR LOAD CONCRETE
 SCALE 1" = 1'-0"

 ASPHALT PAVEMENT
 SCALE 1" = 1'-0"

 GRAVEL SURFACING
 SCALE 1" = 1'-0"

 GRASS PAVE
 SCALE 1" = 1'-0"

 MAIN WALK
 SCALE 1" = 1'-0"

 18" REJECT CURB
 SCALE 1" = 1'-0"

 18" CONCRETE CURB
 SCALE 1" = 1'-0"

 MOUNTABLE CURB
 SCALE 1" = 1'-0"

 30" CONCRETE CURB
 SCALE 1" = 1'-0"

 PLANTER CURB
 SCALE 1" = 1'-0"

 LAWN PANEL
 SCALE 1" = 1'-0"

 TRENCH GRATE
 SCALE 1" = 1'-0"

 ACCESSIBLE PARKING PAVEMENT MARKING
 SCALE 1" = 1'-0"

 PAVEMENT STRIPING
 SCALE 1" = 1'-0"

 CROSSWALK STRIPING
 SCALE 1" = 1'-0"

 ACCESSIBLE RAMP
 SCALE 1" = 1'-0"

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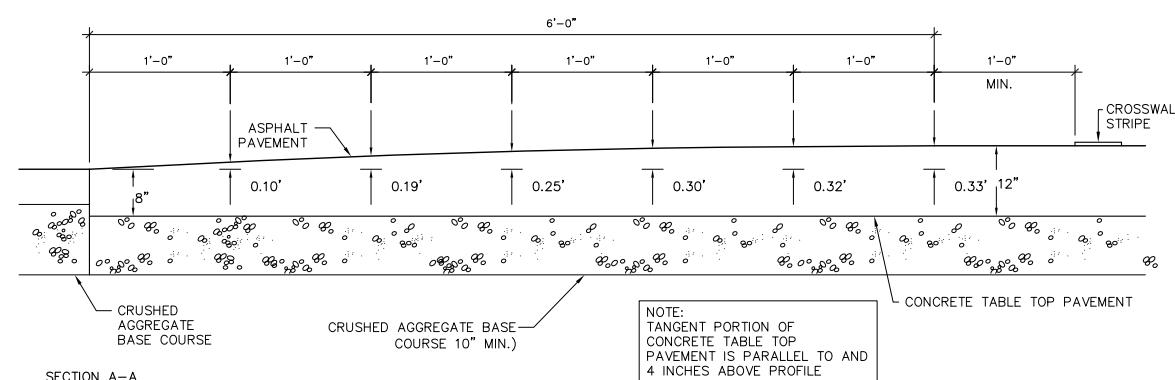
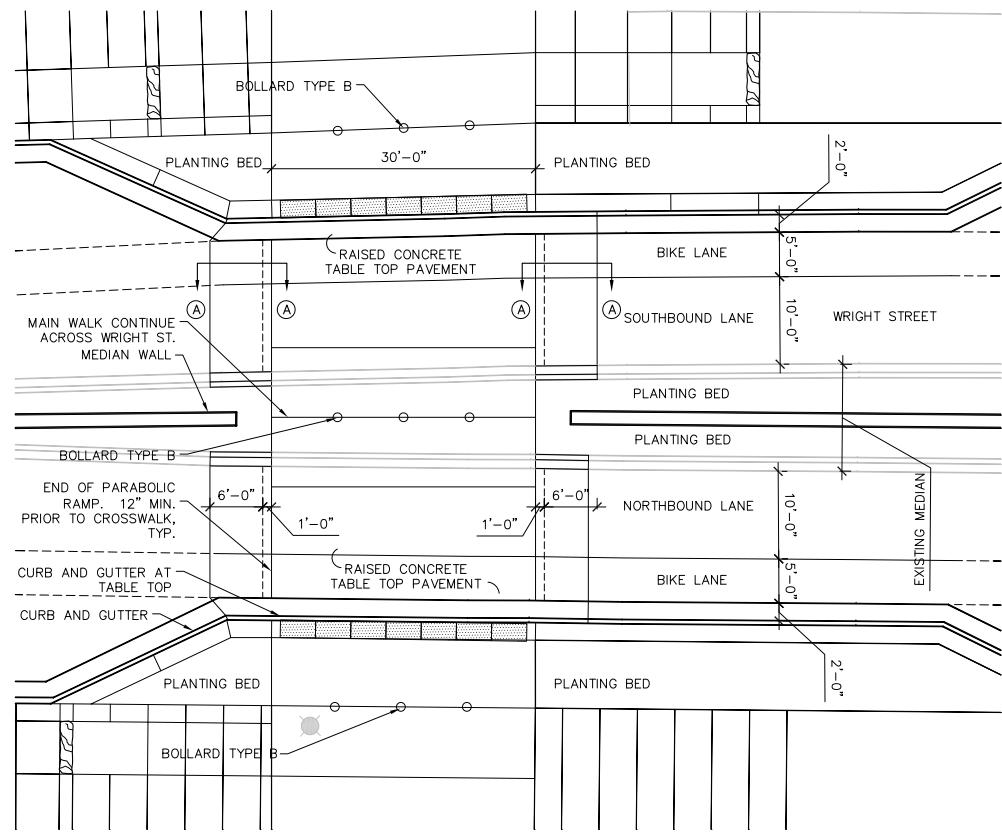
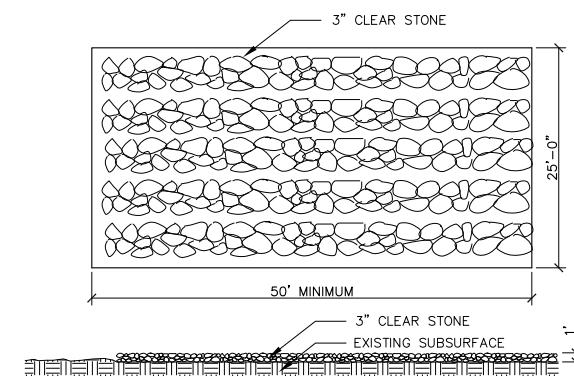
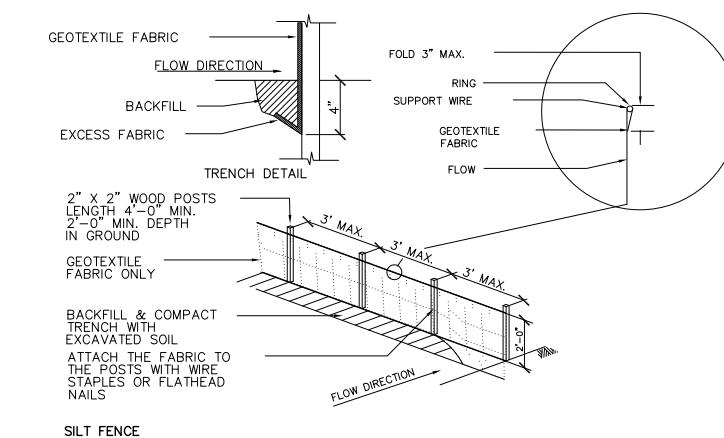
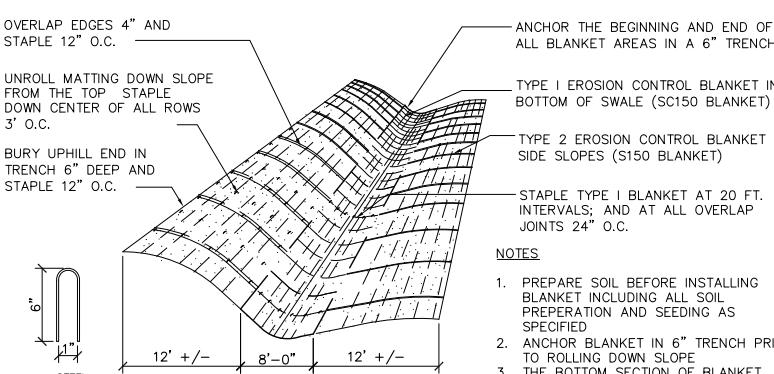
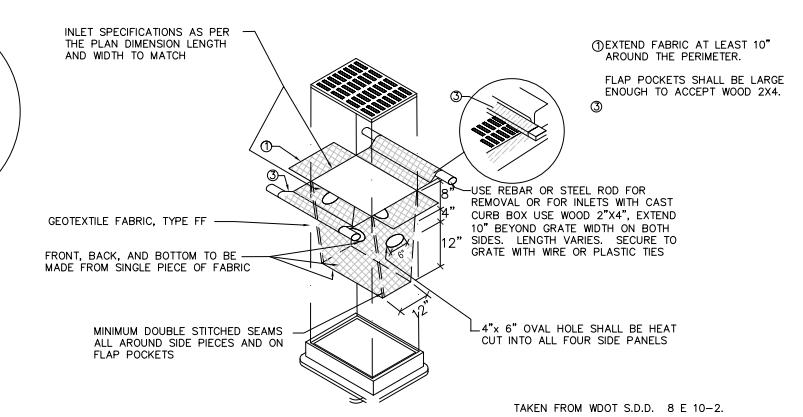

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TABLE TOP CROSSING



TRACKING PAD

NTS



DRAWING

DETAILS

Sheet Number

LP-502



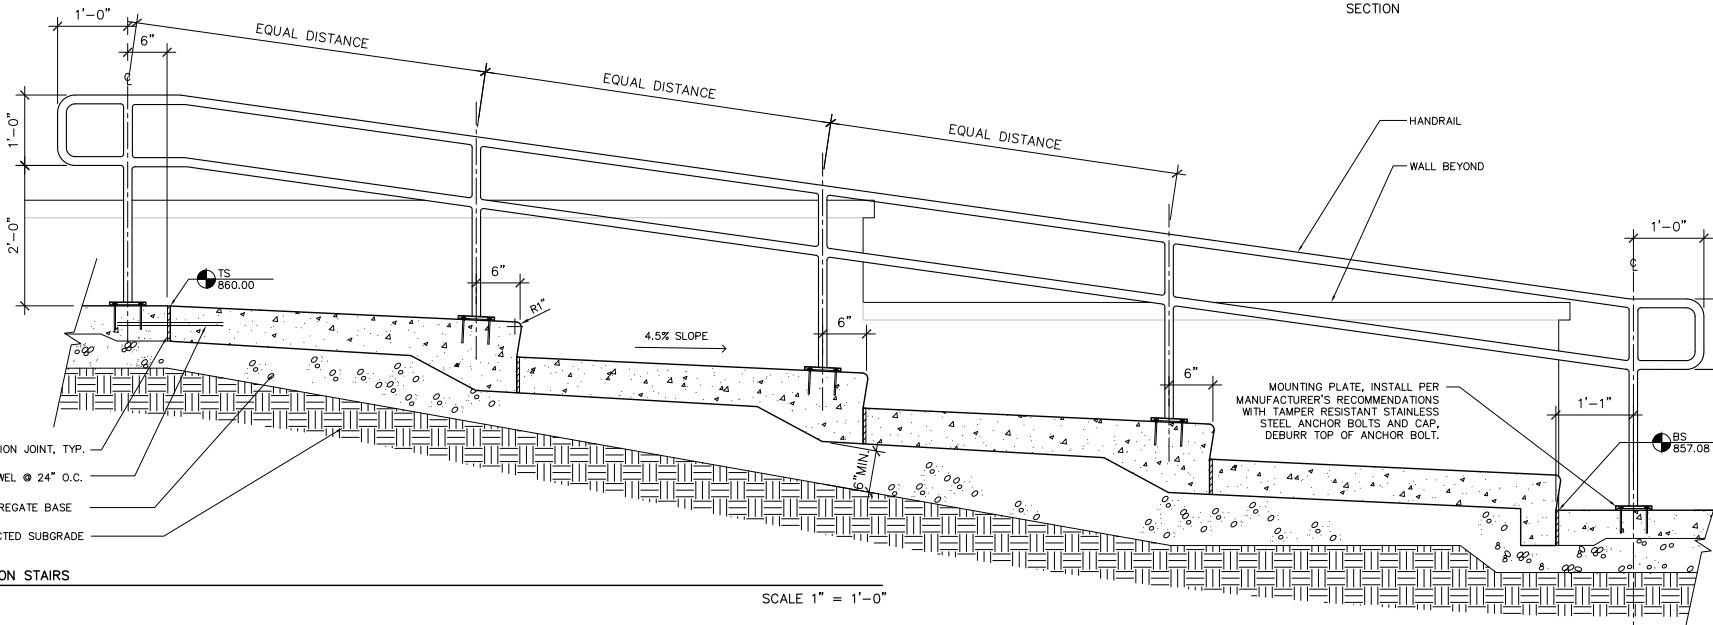
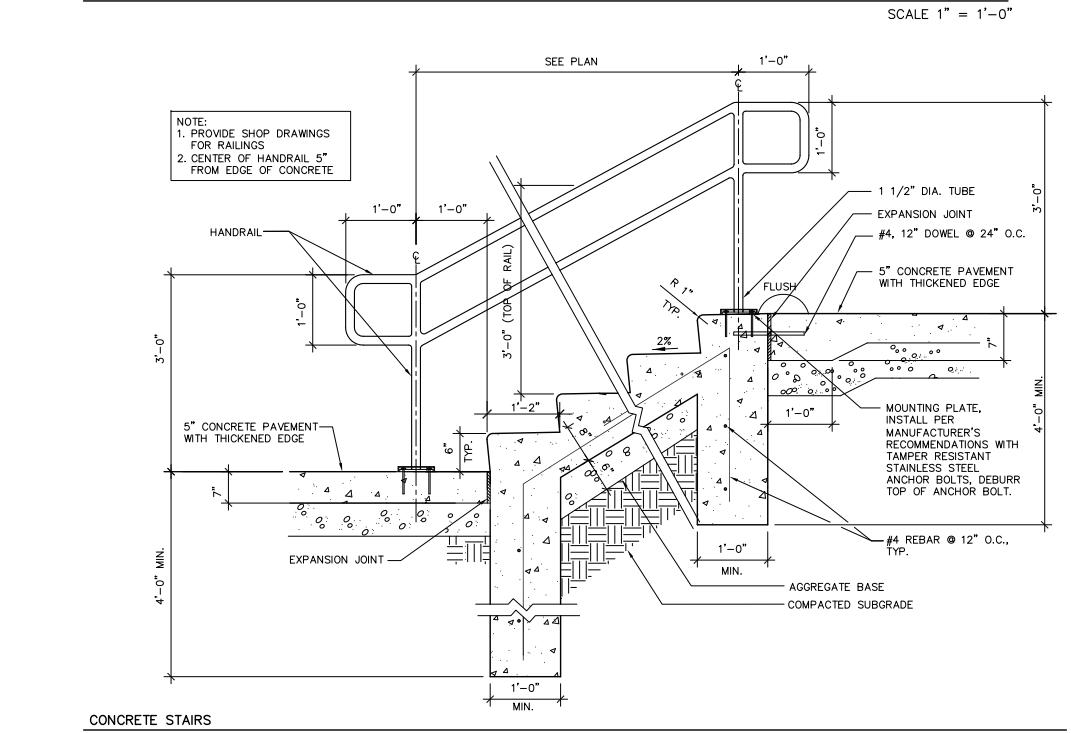
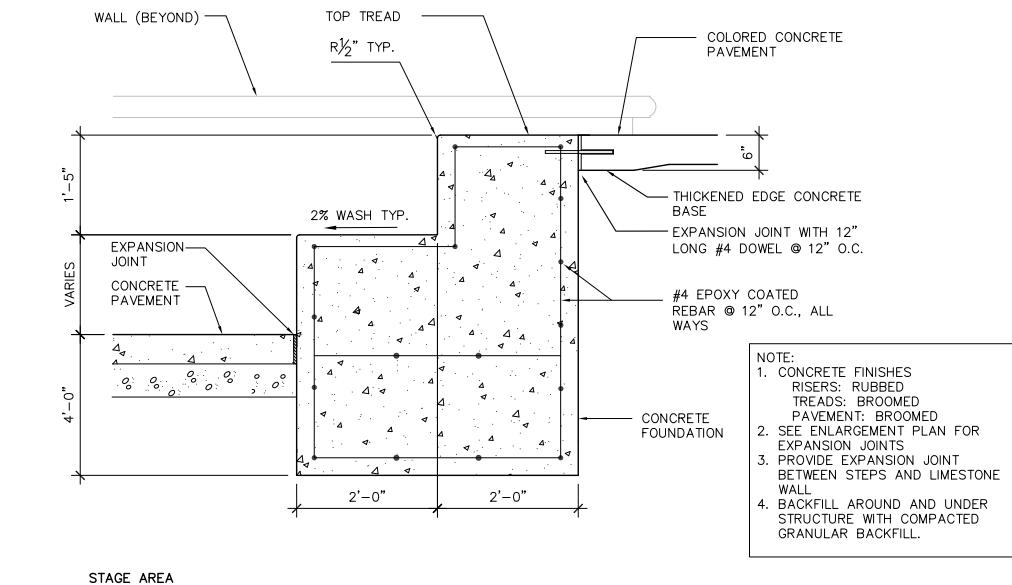
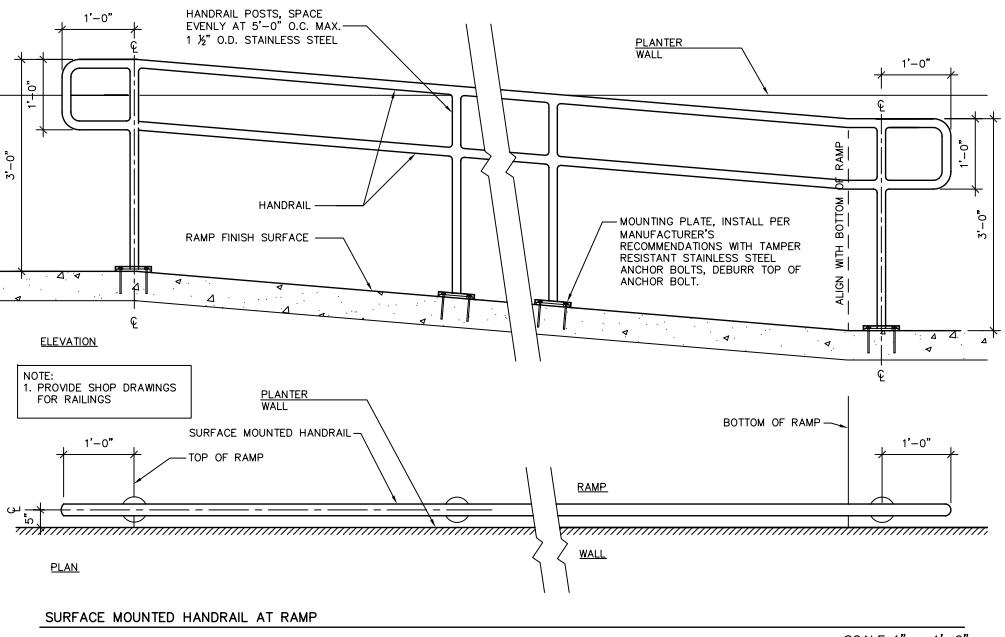
Project Title

Truax
Ingenuity Center

City of Madison, Wisconsin

Issued For:	Approval
Issue Date:	04/06/2011
SAA Project No.	2434
MC Project No.	-
Bid Pkg No.	B11-025

Revision Date



DRAWING

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LP-503



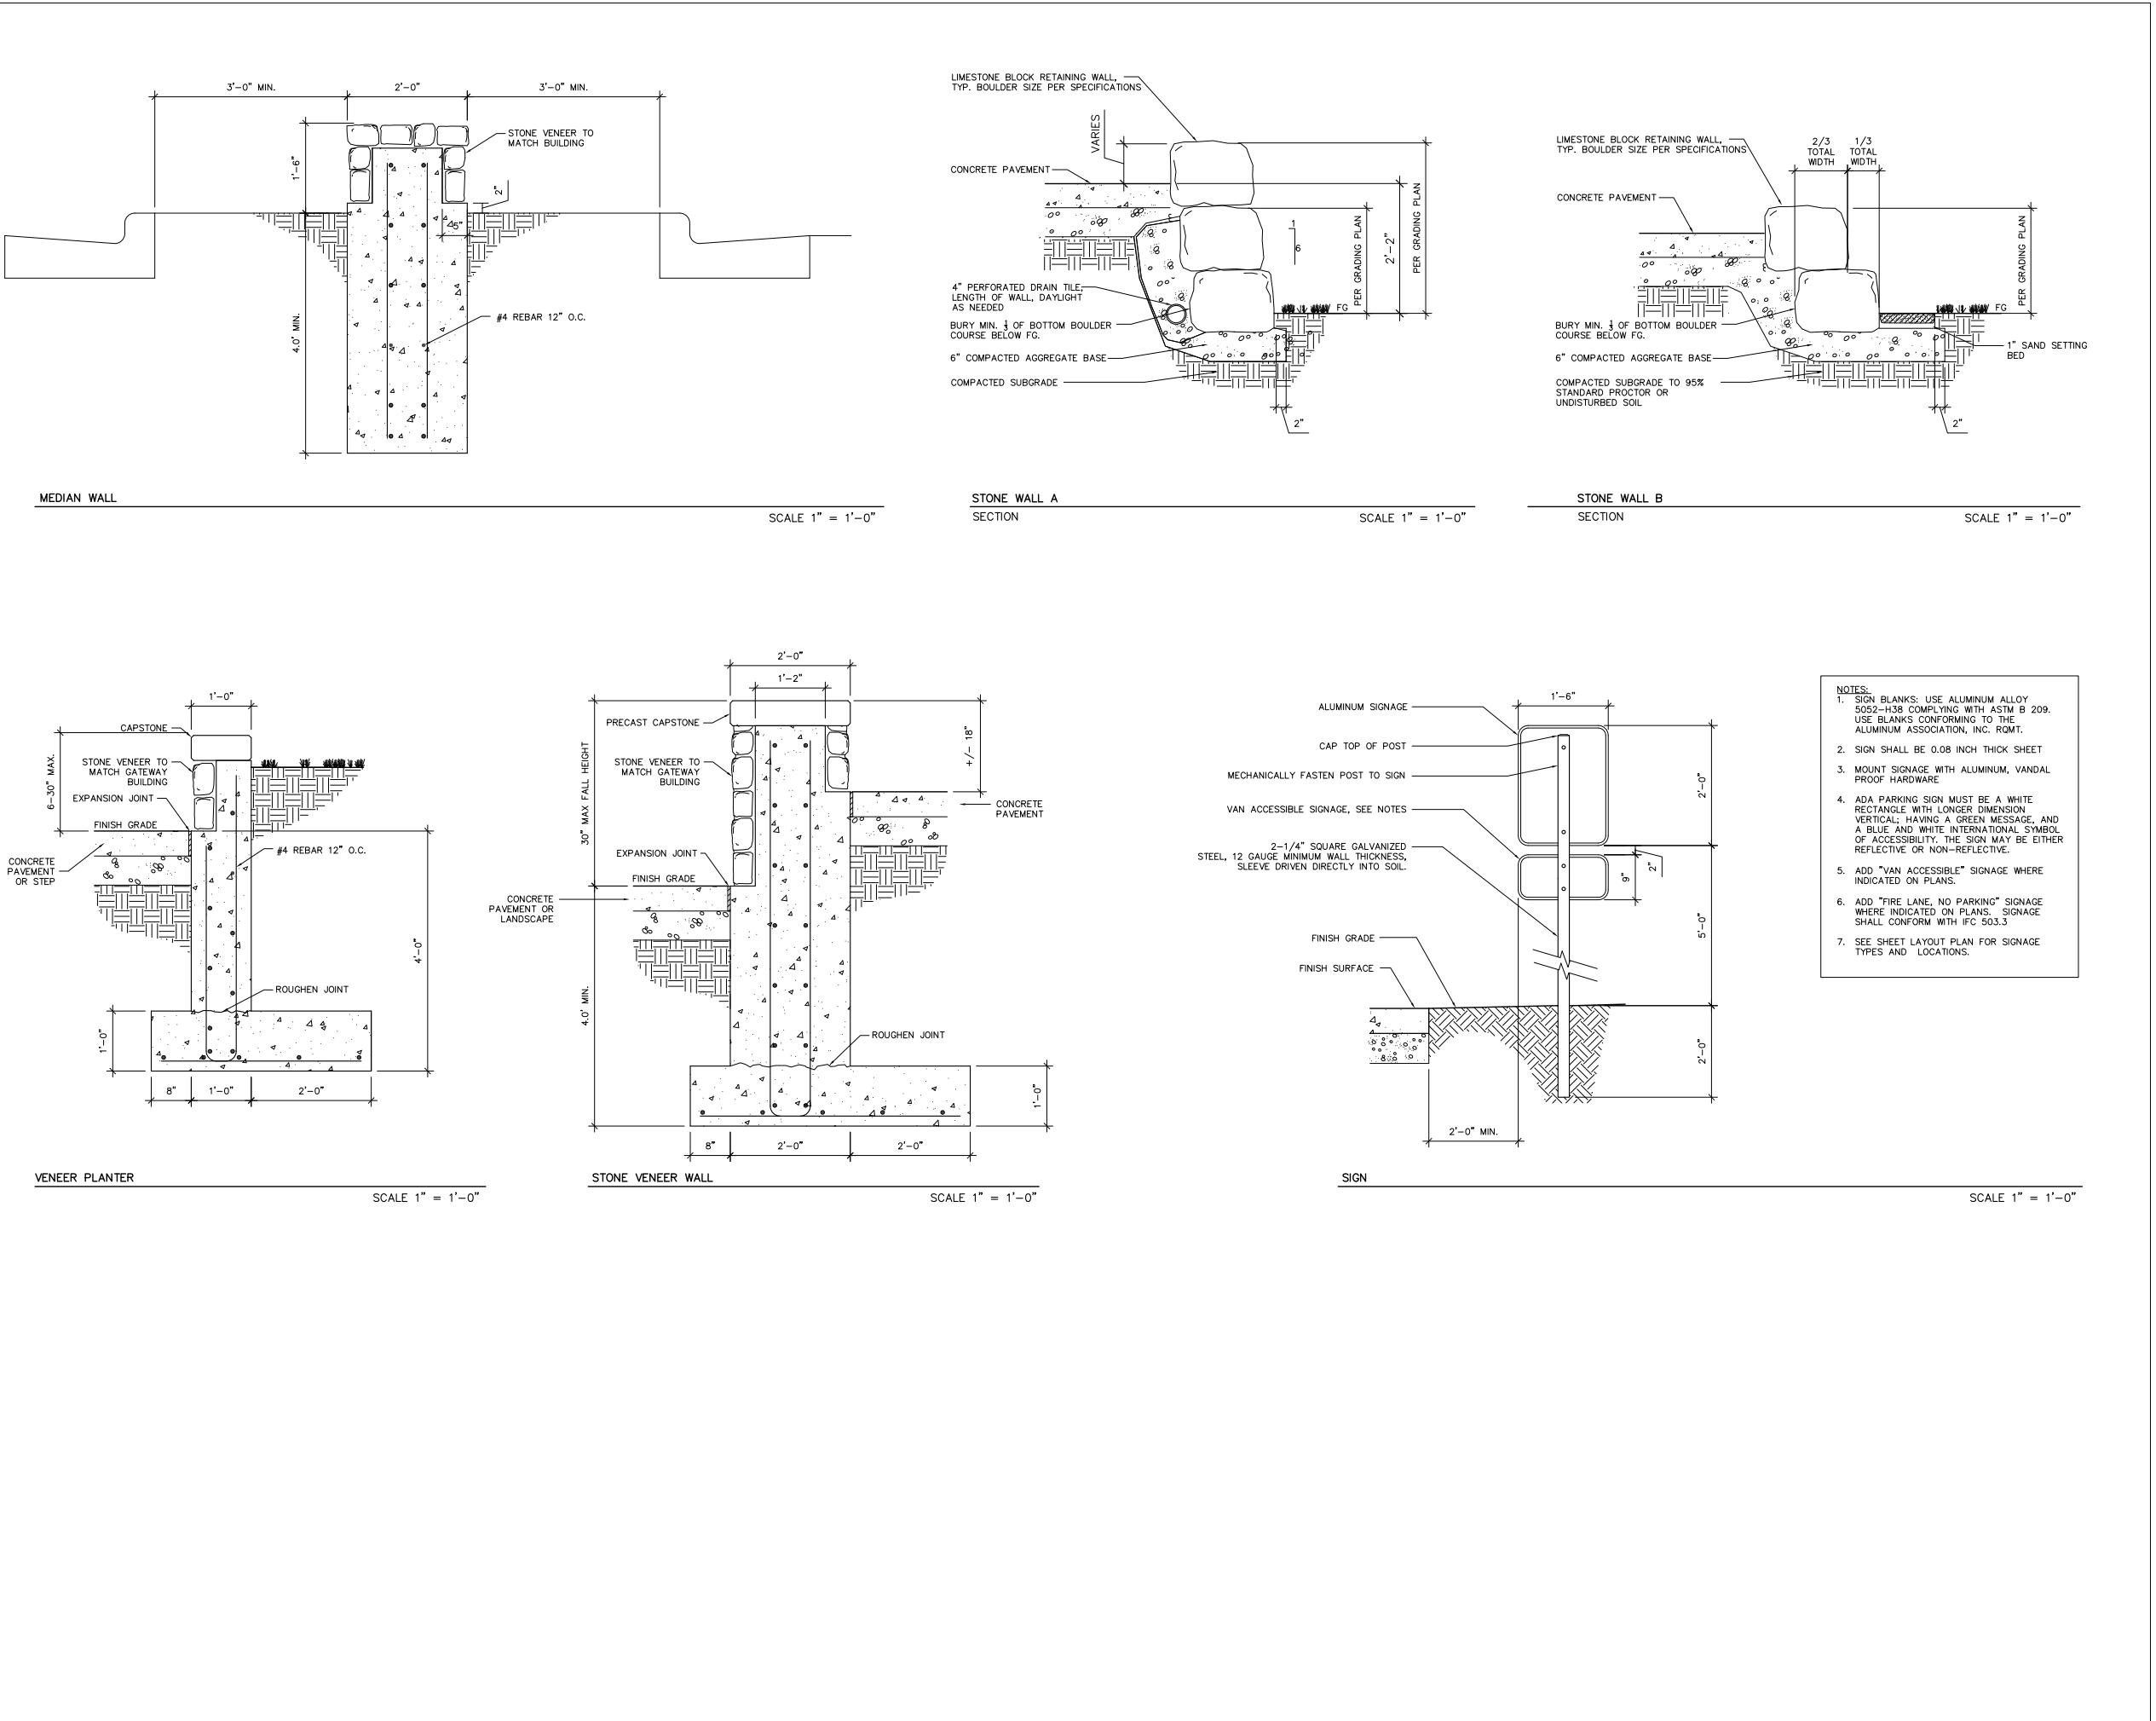
Project Title

Truax
Ingenuity Center

City of Madison, Wisconsin

Issued For:	Approval
Issue Date:	04/06/2011
SAA Project No.	2434
MC Project No.	-
Bid Pkg No.	B11-025

Revision Date



The logo for SAA Design Group. It features a large, stylized, blocky 'SAA' monogram in a dark blue font. To the right of the monogram, the words 'DESIGN GROUP' are stacked vertically in a smaller, sans-serif font. The 'D' in 'DESIGN' and the 'G' in 'GROUP' are capitalized and have a slightly different weight or style than the other letters.



DRAWING

LP-504

Project Title _____

Truax
Ingenuity Center
City of Madison,
Wisconsin

Issued For: Approval _____

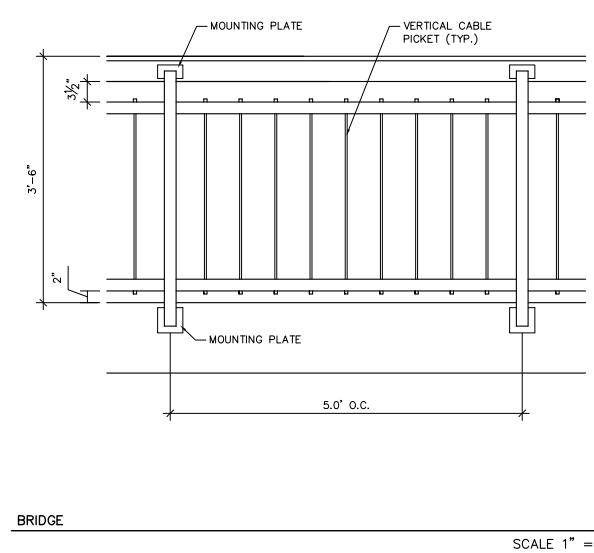
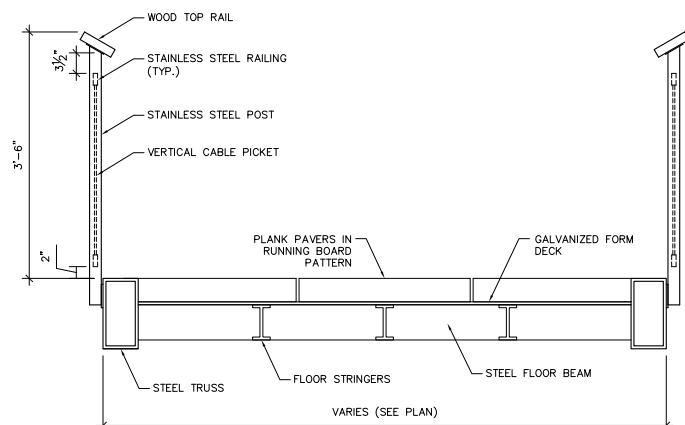
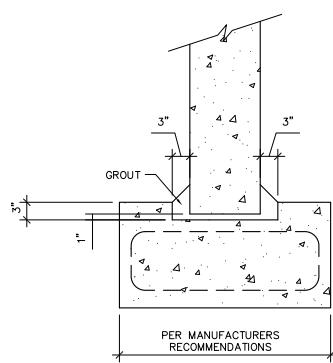
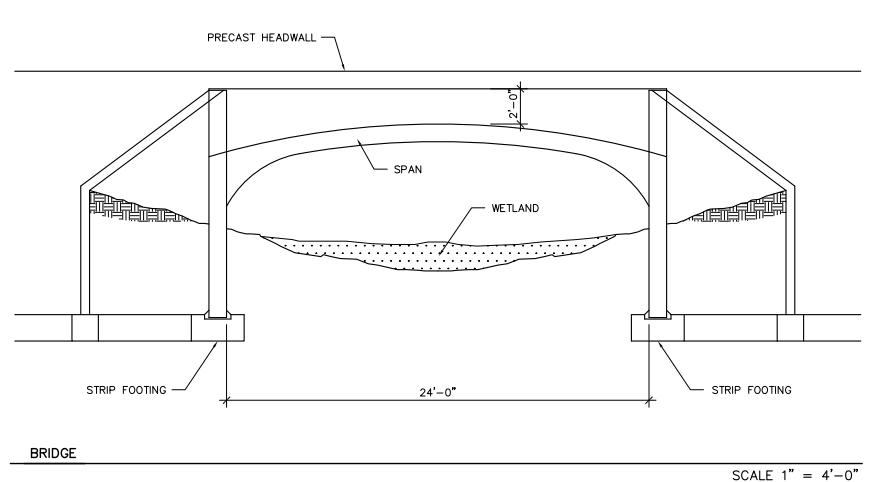
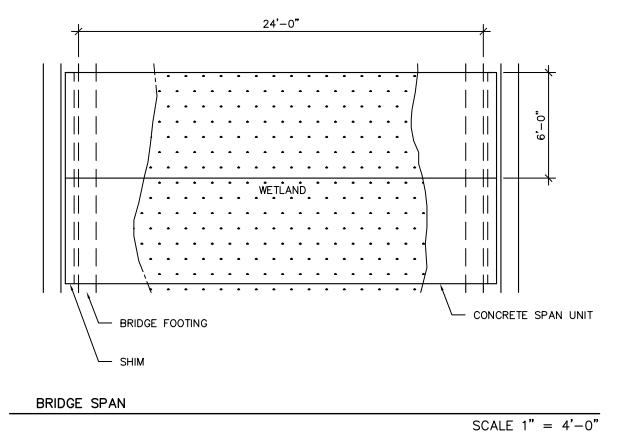
Issue Date: 04/06/2011

SAA Project No. 2434

MC Project No. -

Bid Pkg No. B11-025

Revision _____ Date _____


BRIDGE
 SCALE 1" = 1'-0"

STRIP FOOTING
 SCALE 1" = 1'-0"

BRIDGE
 SCALE 1" = 4'-0"

 DRAWING _____
 DETAILS _____

 0 _____
 Sheet Number _____

LP-505

Project Title

 Truax
 Ingenuity Center

 City of Madison,
 Wisconsin

Issued For: Approval

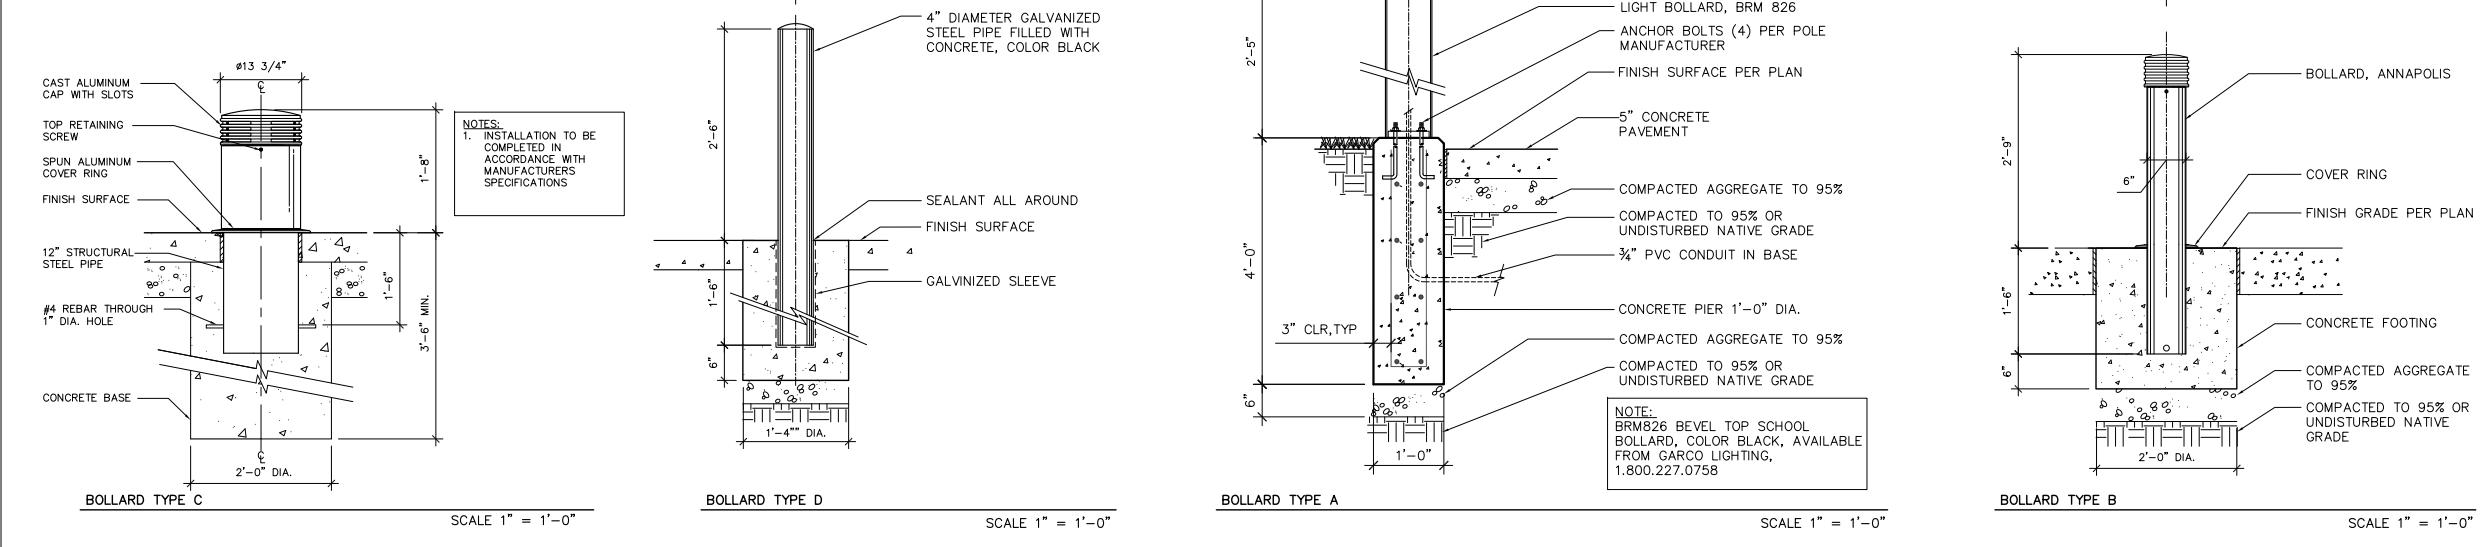
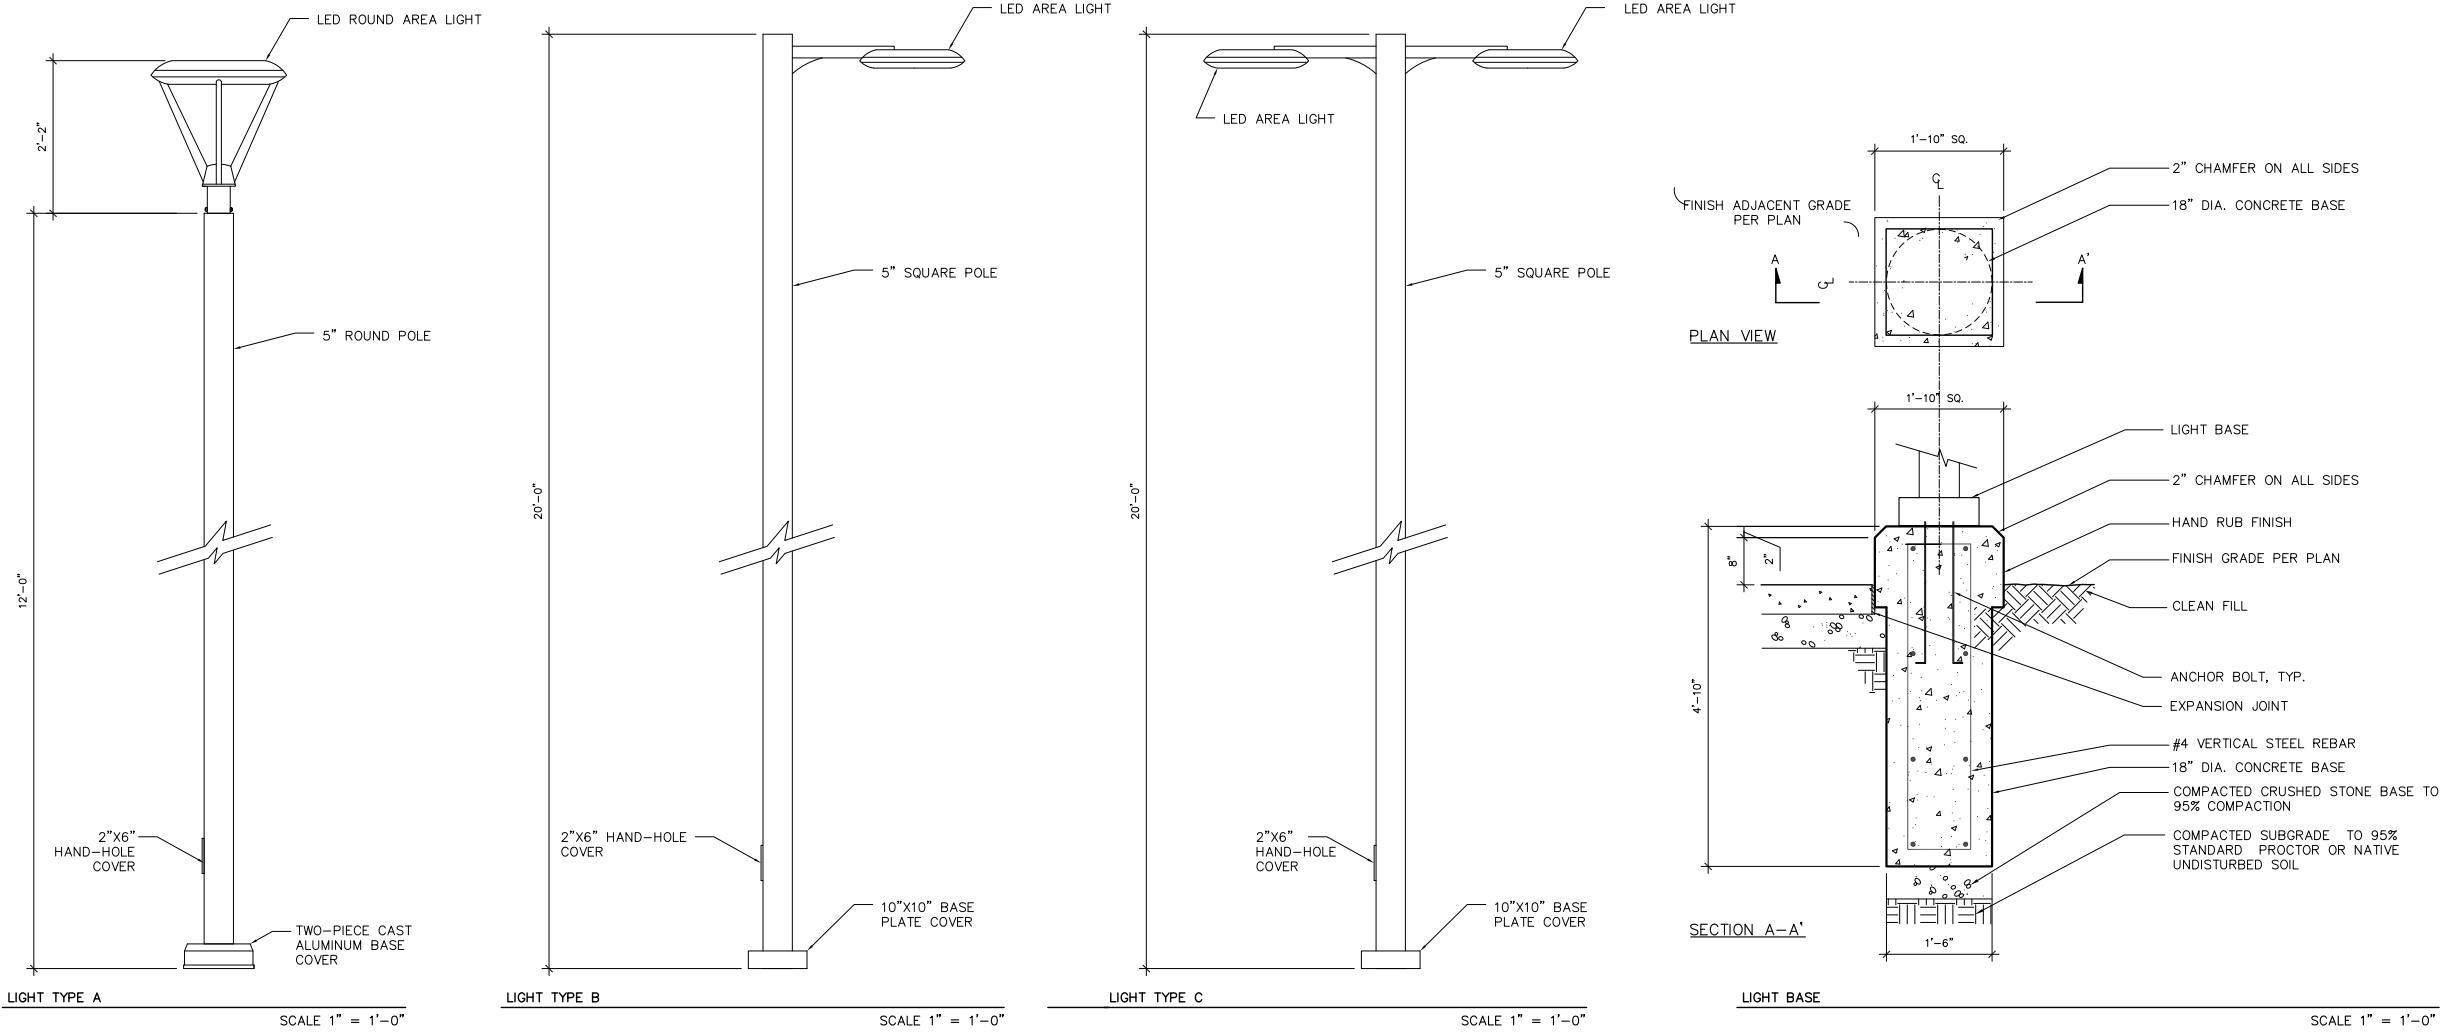
Issue Date: 04/06/2011

SAA Project No. 2434

MC Project No. -

Bid Pkg No. B11-025

Revision Date


SAA DESIGN GROUP
 SAA Design Group, Inc.
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 www.saa-madison.com


DRAWING DETAILS

 Sheet Number
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LP-506

Project Title

 Truax
 Ingenuity Center

 City of Madison,
 Wisconsin

Issued For: Approval

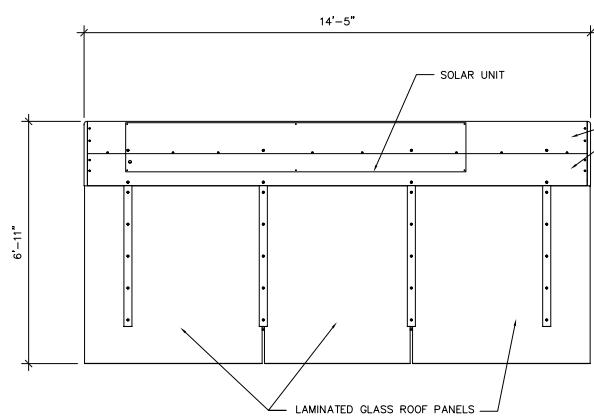
Issue Date: 04/06/2011

SAA Project No. 2434

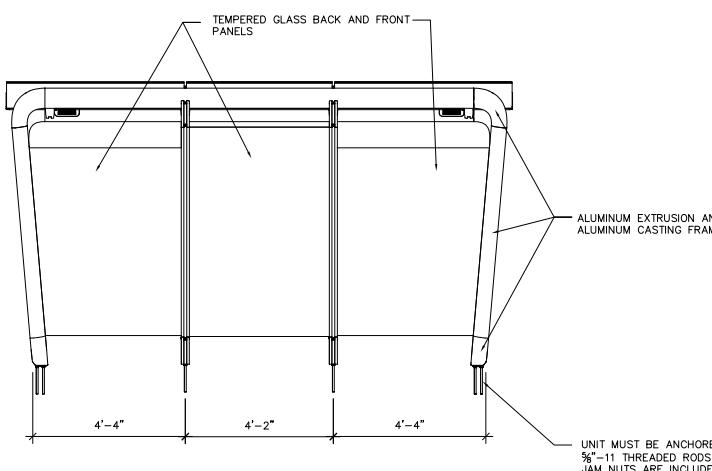
MC Project No. -

Bid Pkg No. B11-025

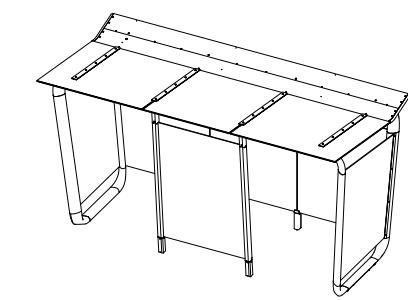
Revision Date


SAA DESIGN GROUP
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 www.saa-madison.com


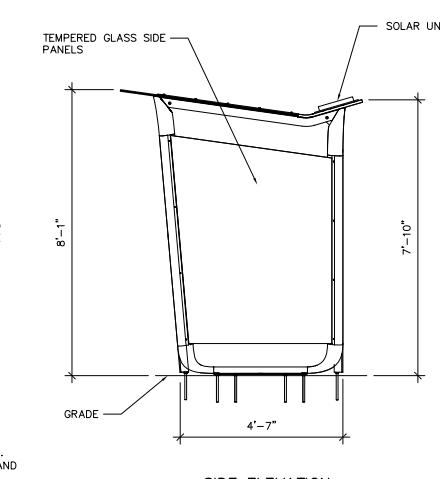
PLAN



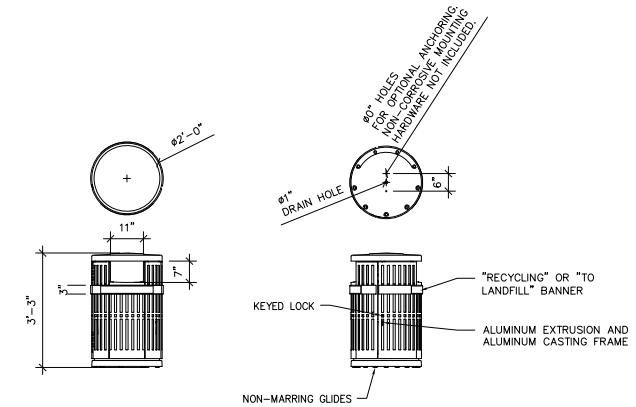
FRONT ELEVATION



ISOMETRIC

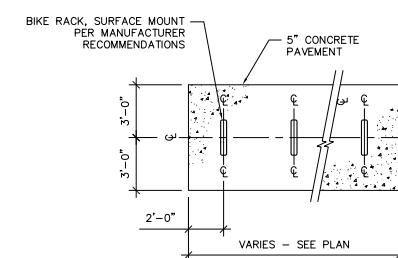


SIDE ELEVATION

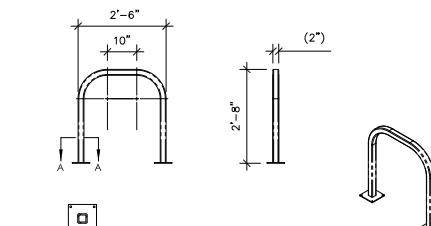


RECYCLING AND LITTER RECEPTACLE

SCALE 1" = 2'-0"



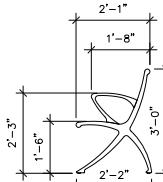
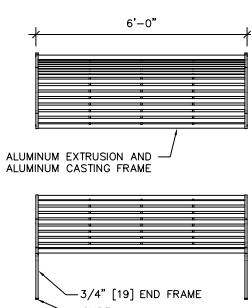
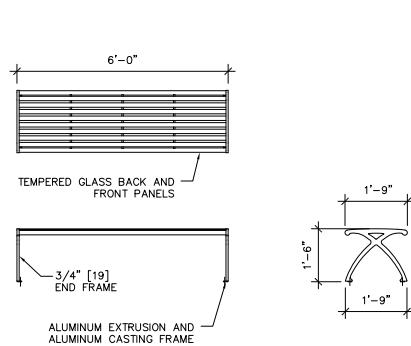
PLAN



SCALE 1" = 2'-0"

BUS SHELTER

SCALE 1" = 2'-0"



BENCHES

SCALE 1" = 2'-0"

BICYCLE PARKING

DRAWING

DETAILS

SCALE 1" = 2'-0"

PLANTER

0

Sheet Number

LP-507

Project Title

Truax
Ingenuity Center

 City of Madison,
 Wisconsin

Issued For: Approval

Issue Date: 04/06/2011

SAA Project No. 2434

MC Project No. -

Bid Pkg No. B11-025

Revision Date

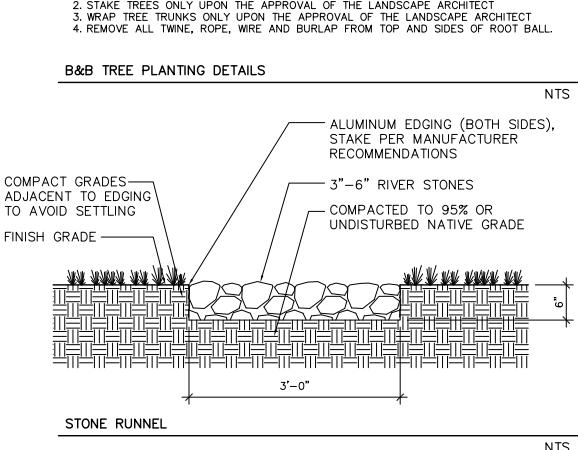
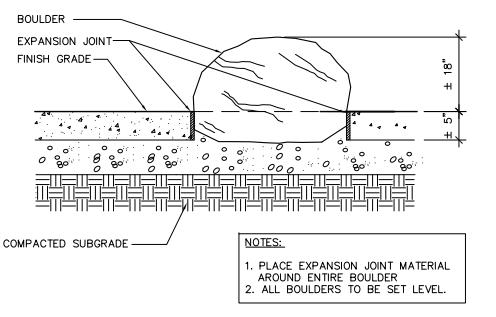
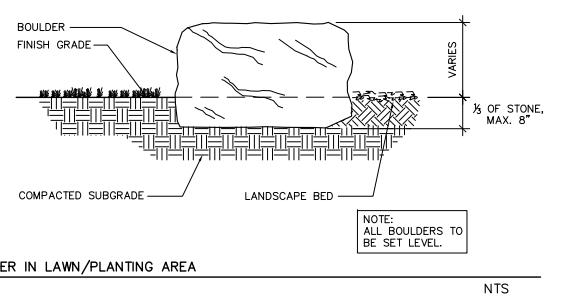
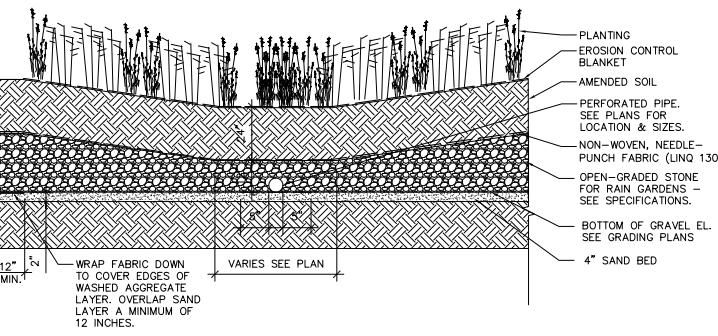
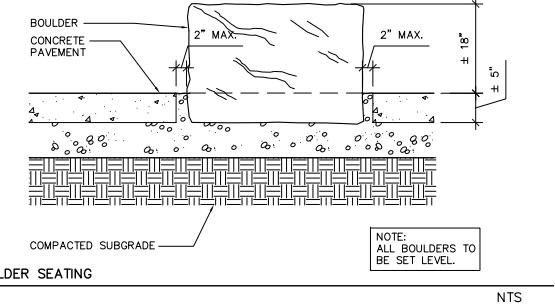
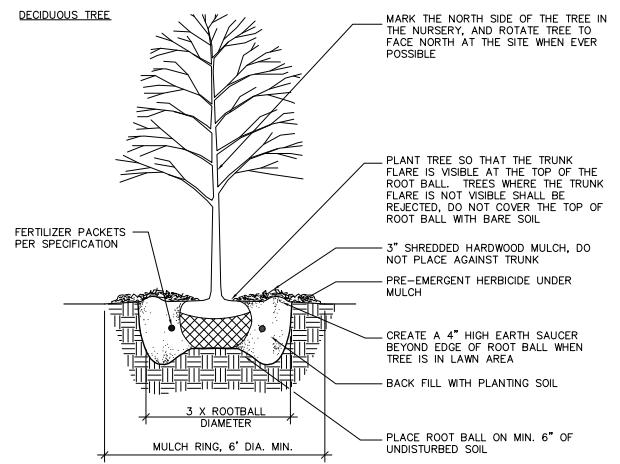
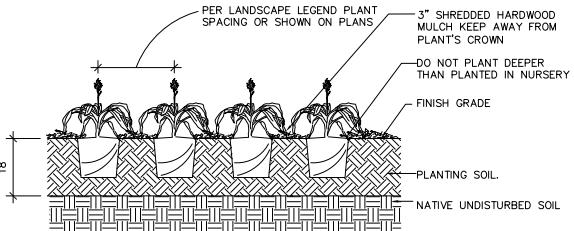
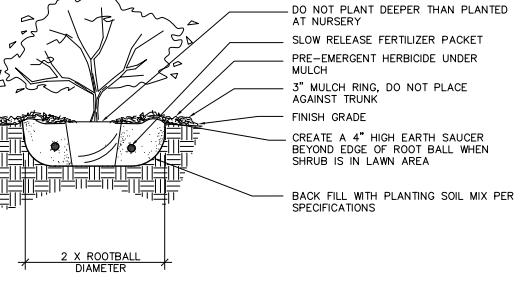
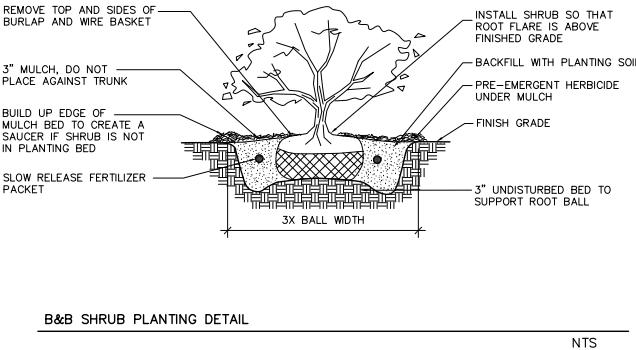
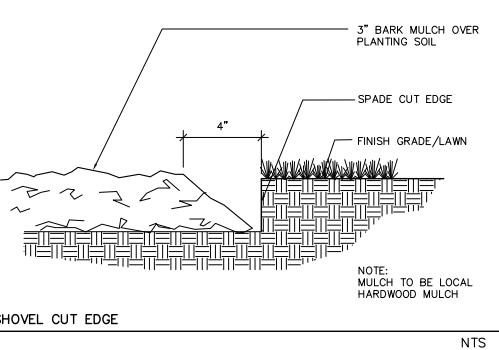
 SAA Design Group, Inc.
 717 Main North Drive
 Madison, WI 53713
 Ph. 608.255.0800
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 www.saa-madison.com


DRAWING

DETAILS

0

Sheet Number

LP-508


Project Title

Truax
Ingenuity CenterCity of Madison,
Wisconsin
 Issued For: Approval
 Issue Date: 04/06/2011
 SAA Project No. 2434
 MC Project No.
 Bid Pkg No. B11-025

 Revision Date


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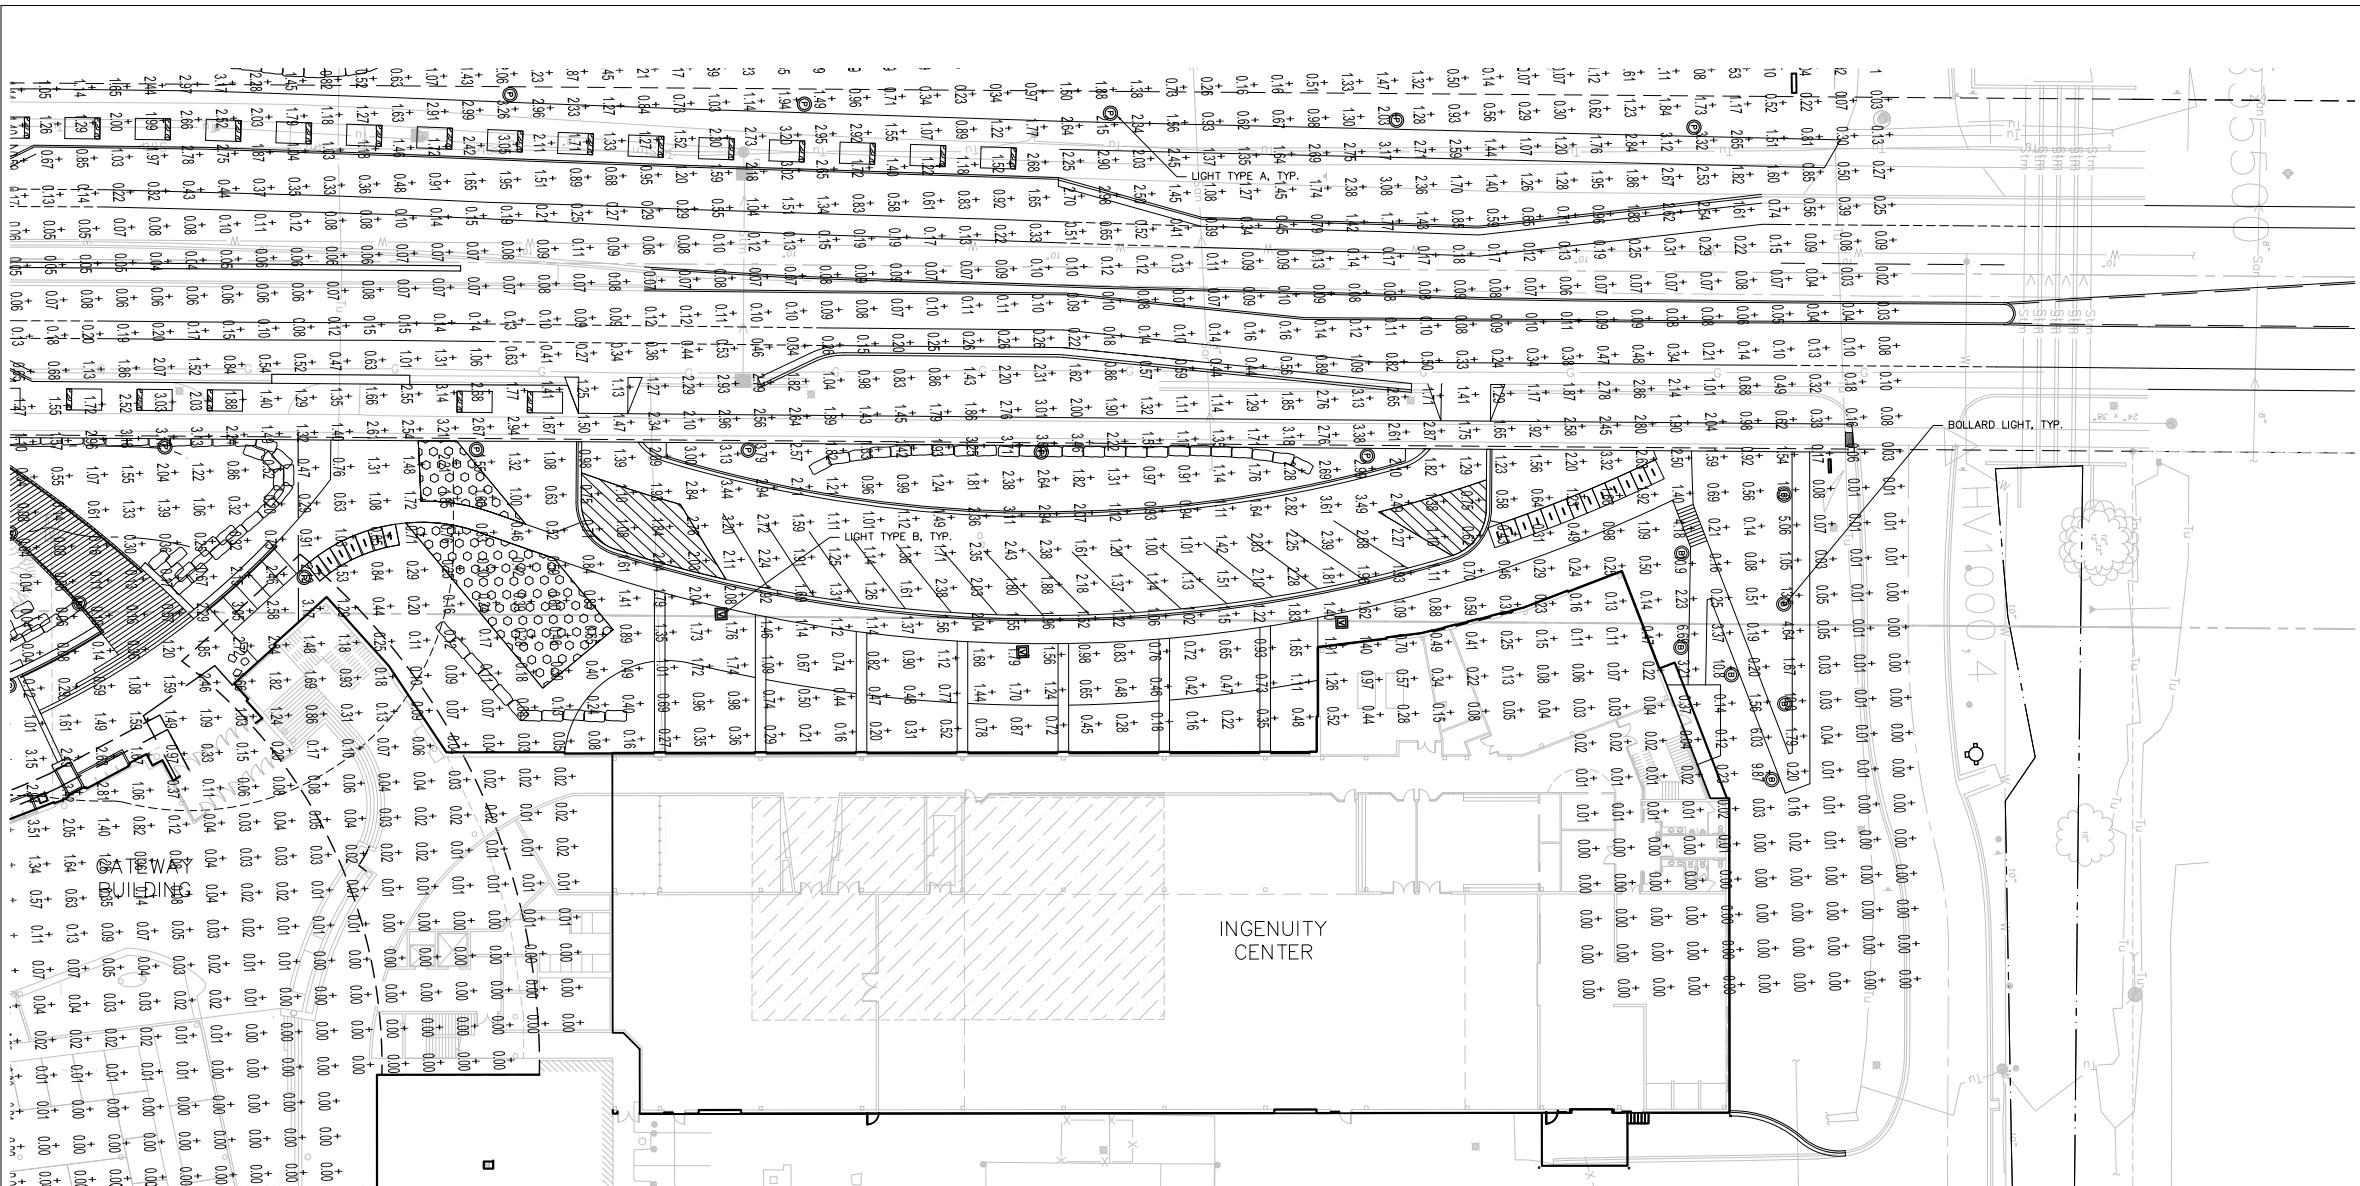

 CDI
 Conservation Design Forum
 375 West First Street
 Elmhurst, Illinois 60126
 630.559.2000 Phone
 630.559.2030 Fax
 www.cdfinc.com

File: F:\240\24-4-MATC_LSP\CDP-Photometrics.dwg Layout: INGENIUTY User: phammon Pictured: Apr 05, 2011 - 11:31am

 DRAWING
 SITE LAYOUT PLAN

 Sheet Number
 0 20 40

LP-602


 LEGEND
 BOLLARD LIGHT
 LIGHTED BOLLARD PER SPEC.
 LIGHT TYPE A
 PEDESTRIAN SCALE LIGHT PER SPEC.
 LIGHT TYPE B
 ROADWAY SCALE LIGHT PER SPEC.
 LIGHT TYPE C
 DOUBLE ROADWAY SCALE LIGHT PER SPEC.

 DXF file created by LitePro 2.029 on 4/4/2011 8:29:20 AM
 CALCULATION SUMMARY
 AREA NAME: DIMENSIONS: GRID / TYPE: # PTS SPAC GROUP: AVE: MAX: MIN: MAX/MIN: AVE/MIN:
 Redevelopment: 1522.63x1236.81ft Grade / H-H 4809 10.00 <> 0.81 13.72 0.00 N/A N/A

MATC LUMINAIRE SCHEDULE		LAMP	LUMENS	LLF	QTY
BOLLARD	(B)	Betaled, A Div (1) "620G-2M***-02-C-UL or BXBP*18C-U (350mA)	(18)	-1	0.90 X
A	(P)	Betaled, A Div (1) "820G-2M***-02-C-UL (350mA) CONFIGURED FROM A	(80)	-1	0.90 X
B	(V)	Betaled, A Div (1) "123M" ARE-EDG-3M***-12-C-UL BXAL1312C-UW (350mA)	(20)	-1	0.90 X
C	(X)	Betaled, A Div (2) "123M" ARE-EDG-3M***-12-C-UL BXAL1312C-UW (350mA)	(40)	-1	0.90 X

AREA SUMMARY SCHEDULE		LUMS / SQ FT	WATTS / SQ FT	QTY
Redevelopment	OUT	1522.63x1236.81ft	0.00	1

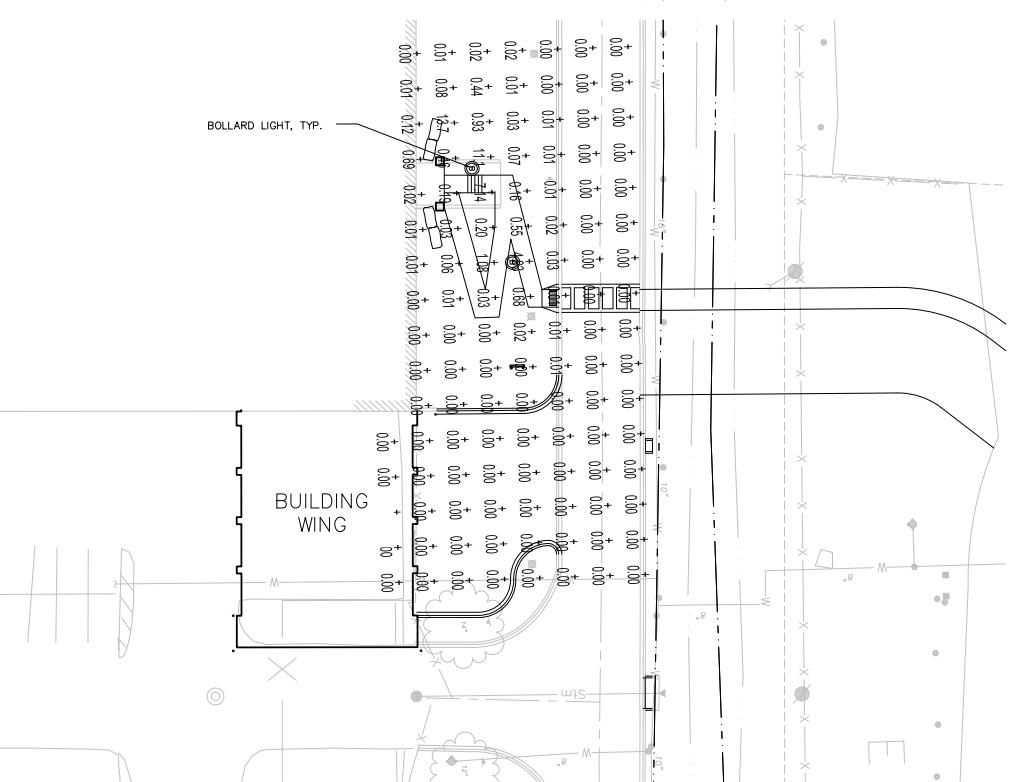


Photo Survey of Madison College North Parking Lot Striping



1. Looking north up Wright Street at shared entry.



2. Looking east into site from the shared access driveway intersection at Wright Street. The Penske property is to the right.



3. Looking east into the site from the end of the shared driveway. The Penske property is located to the right inside the fence.



4. Looking east into the site at the end of the driveway and the west building elevation.

Photo Survey of Madison College North Parking Lot Striping



5. Looking east at the west building elevation.



6. Looking south along STH 51 from the northeast corner of the lot.



7. Looking at the south property line along the shared lot line with The Penske property. Madison College in background.



8. Looking north at the west half of the south building elevation.

Photo Survey of Madison College North Parking Lot Striping



9. Looking northeast at the east half of the south building elevation.



10. Looking west at the south half of the east building elevation and northeast limits of the parking lot.



MADISON
AREA TECHNICAL
COLLEGE

Ingenuity Center
Transportation &
Advanced Sustainable
Manufacturing & Gateway

City of Madison,
Wisconsin

A
Issued For: UDC
Issue Date: 04/20/2011
PRA Project No. 10112-02
MC Project No.
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Revision Date



STRANG

ARCHITECTURE
ENGINEERING
INTERIOR DESIGN

STRANG, INC.
4121 GENERAL POINT ROAD
MADISON, WI 53718
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F: 608.278.8204

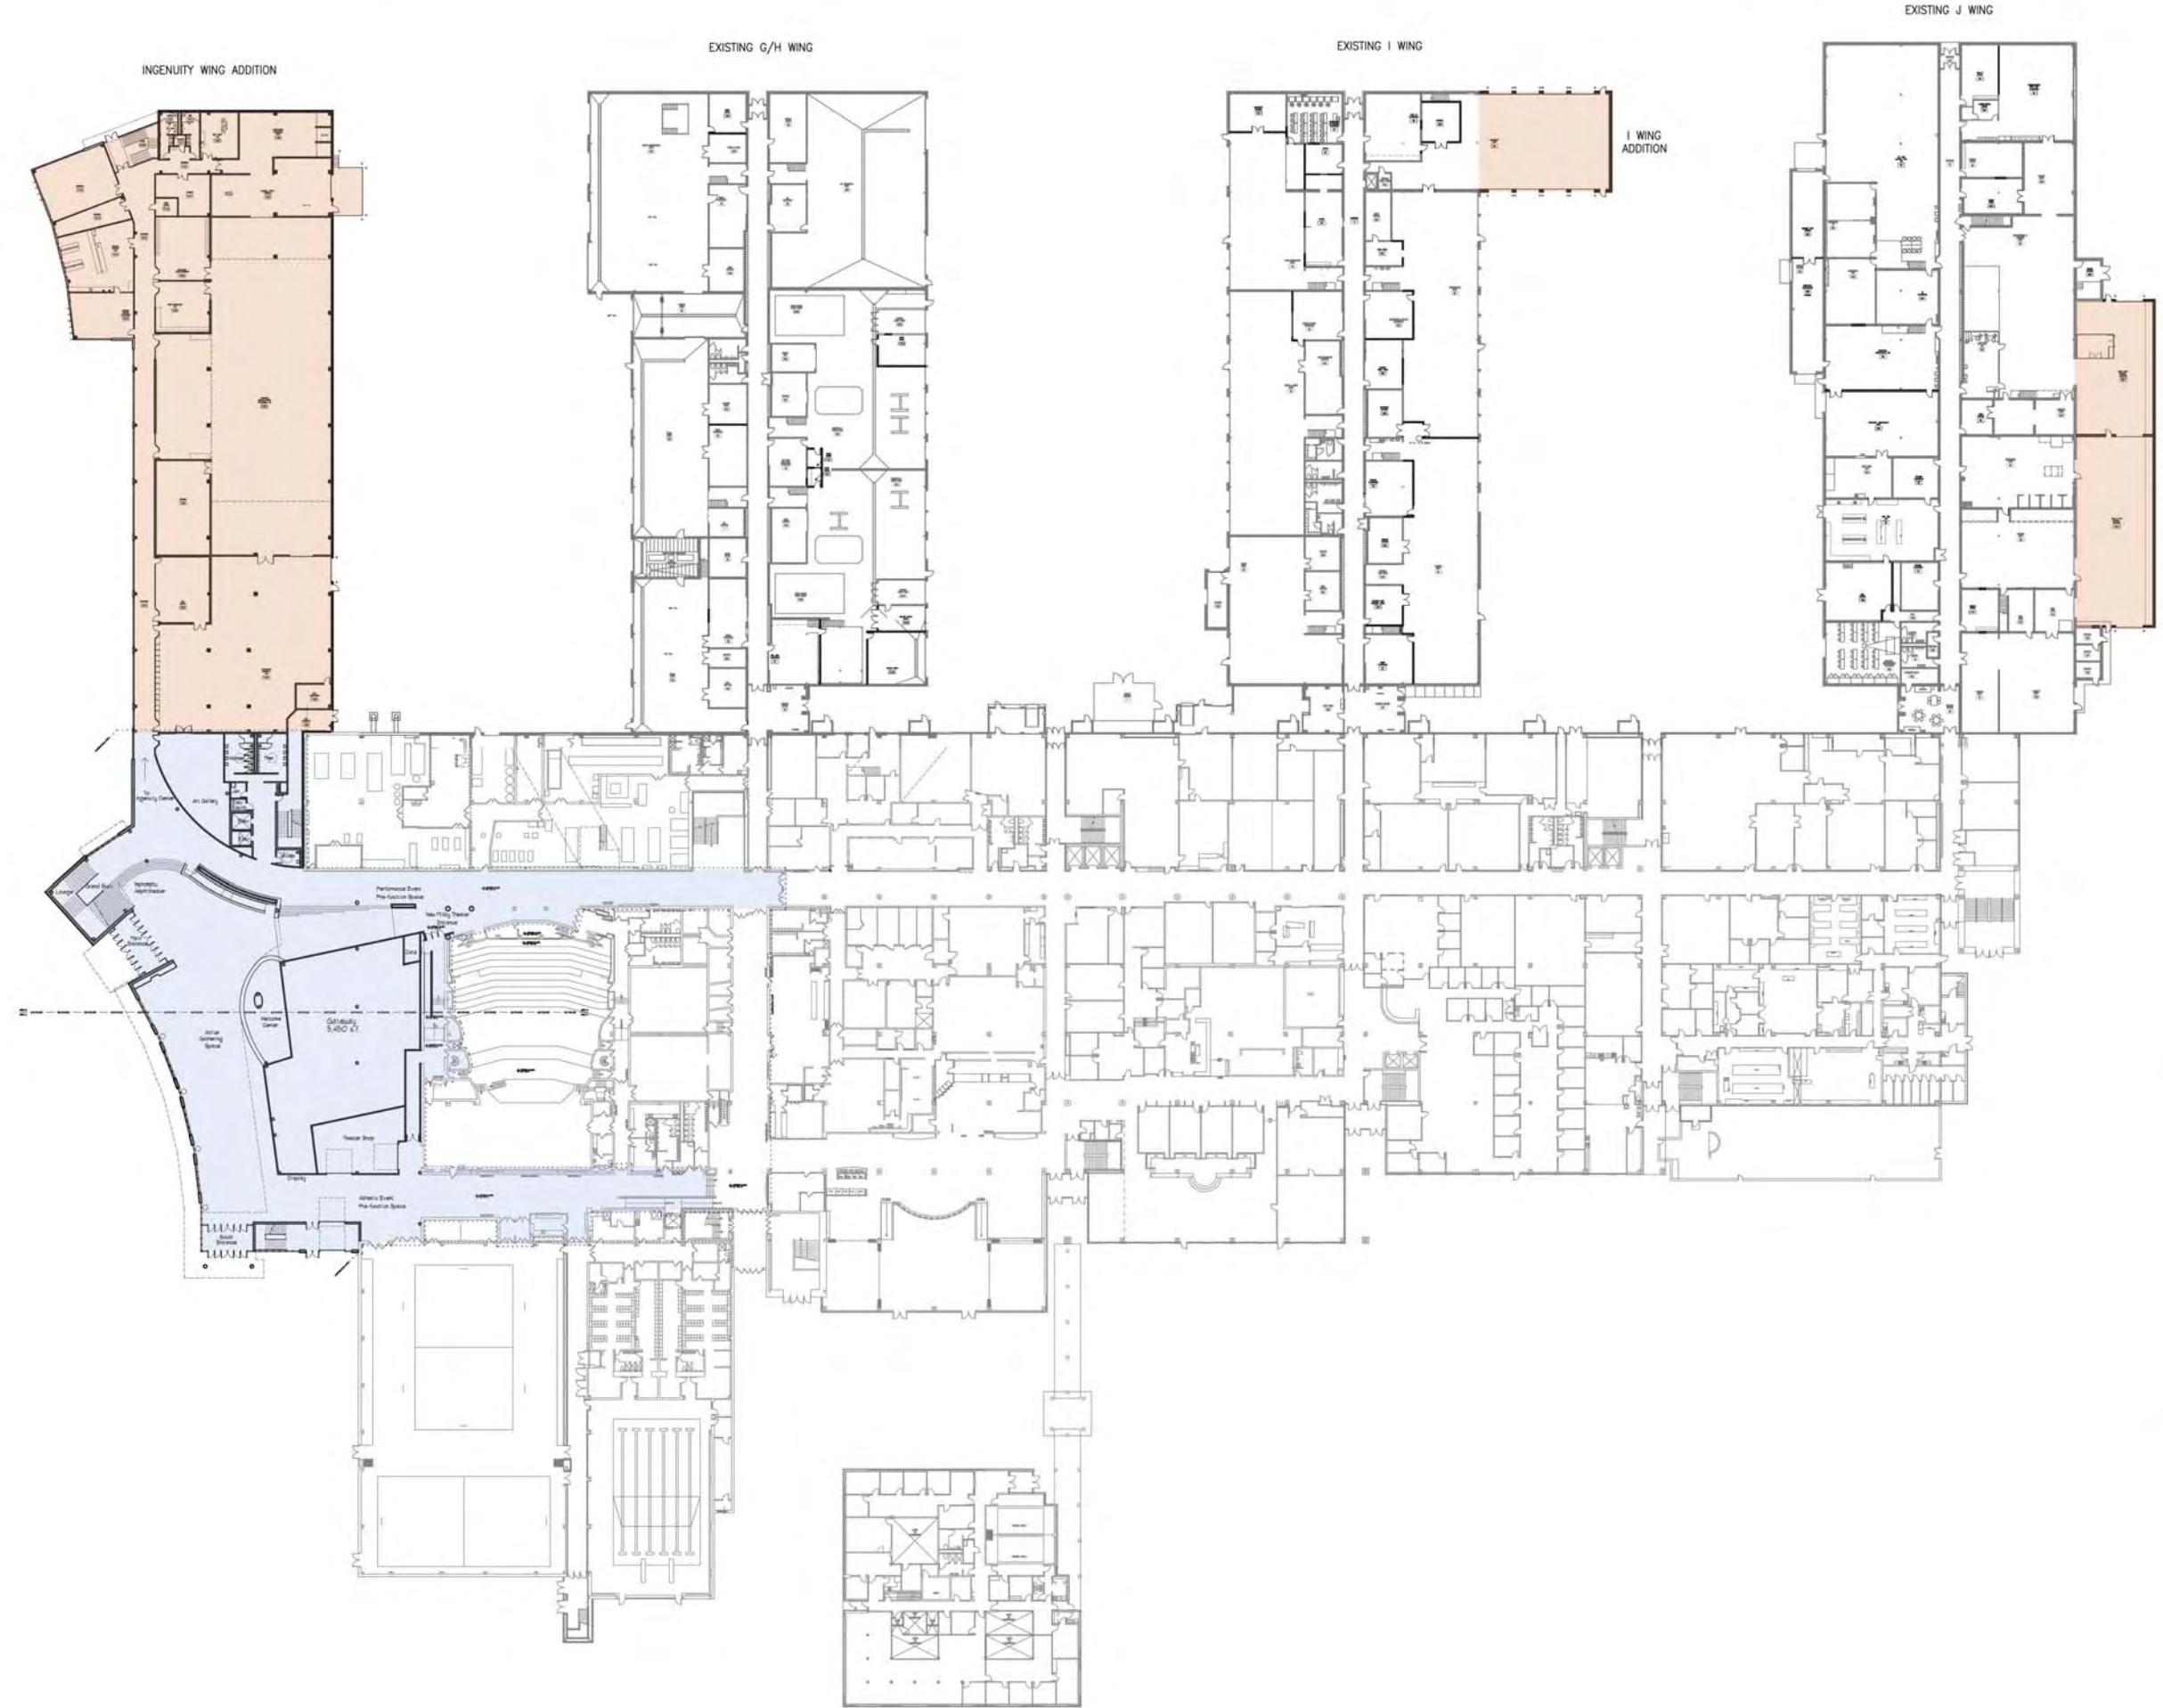
2310 Crossroads Dr. Ste 2000 • Madison WI 53718 • Tel 608.240.9900 • Fax 608.240.9900
Plunkett
Raysich
Architects, LLP

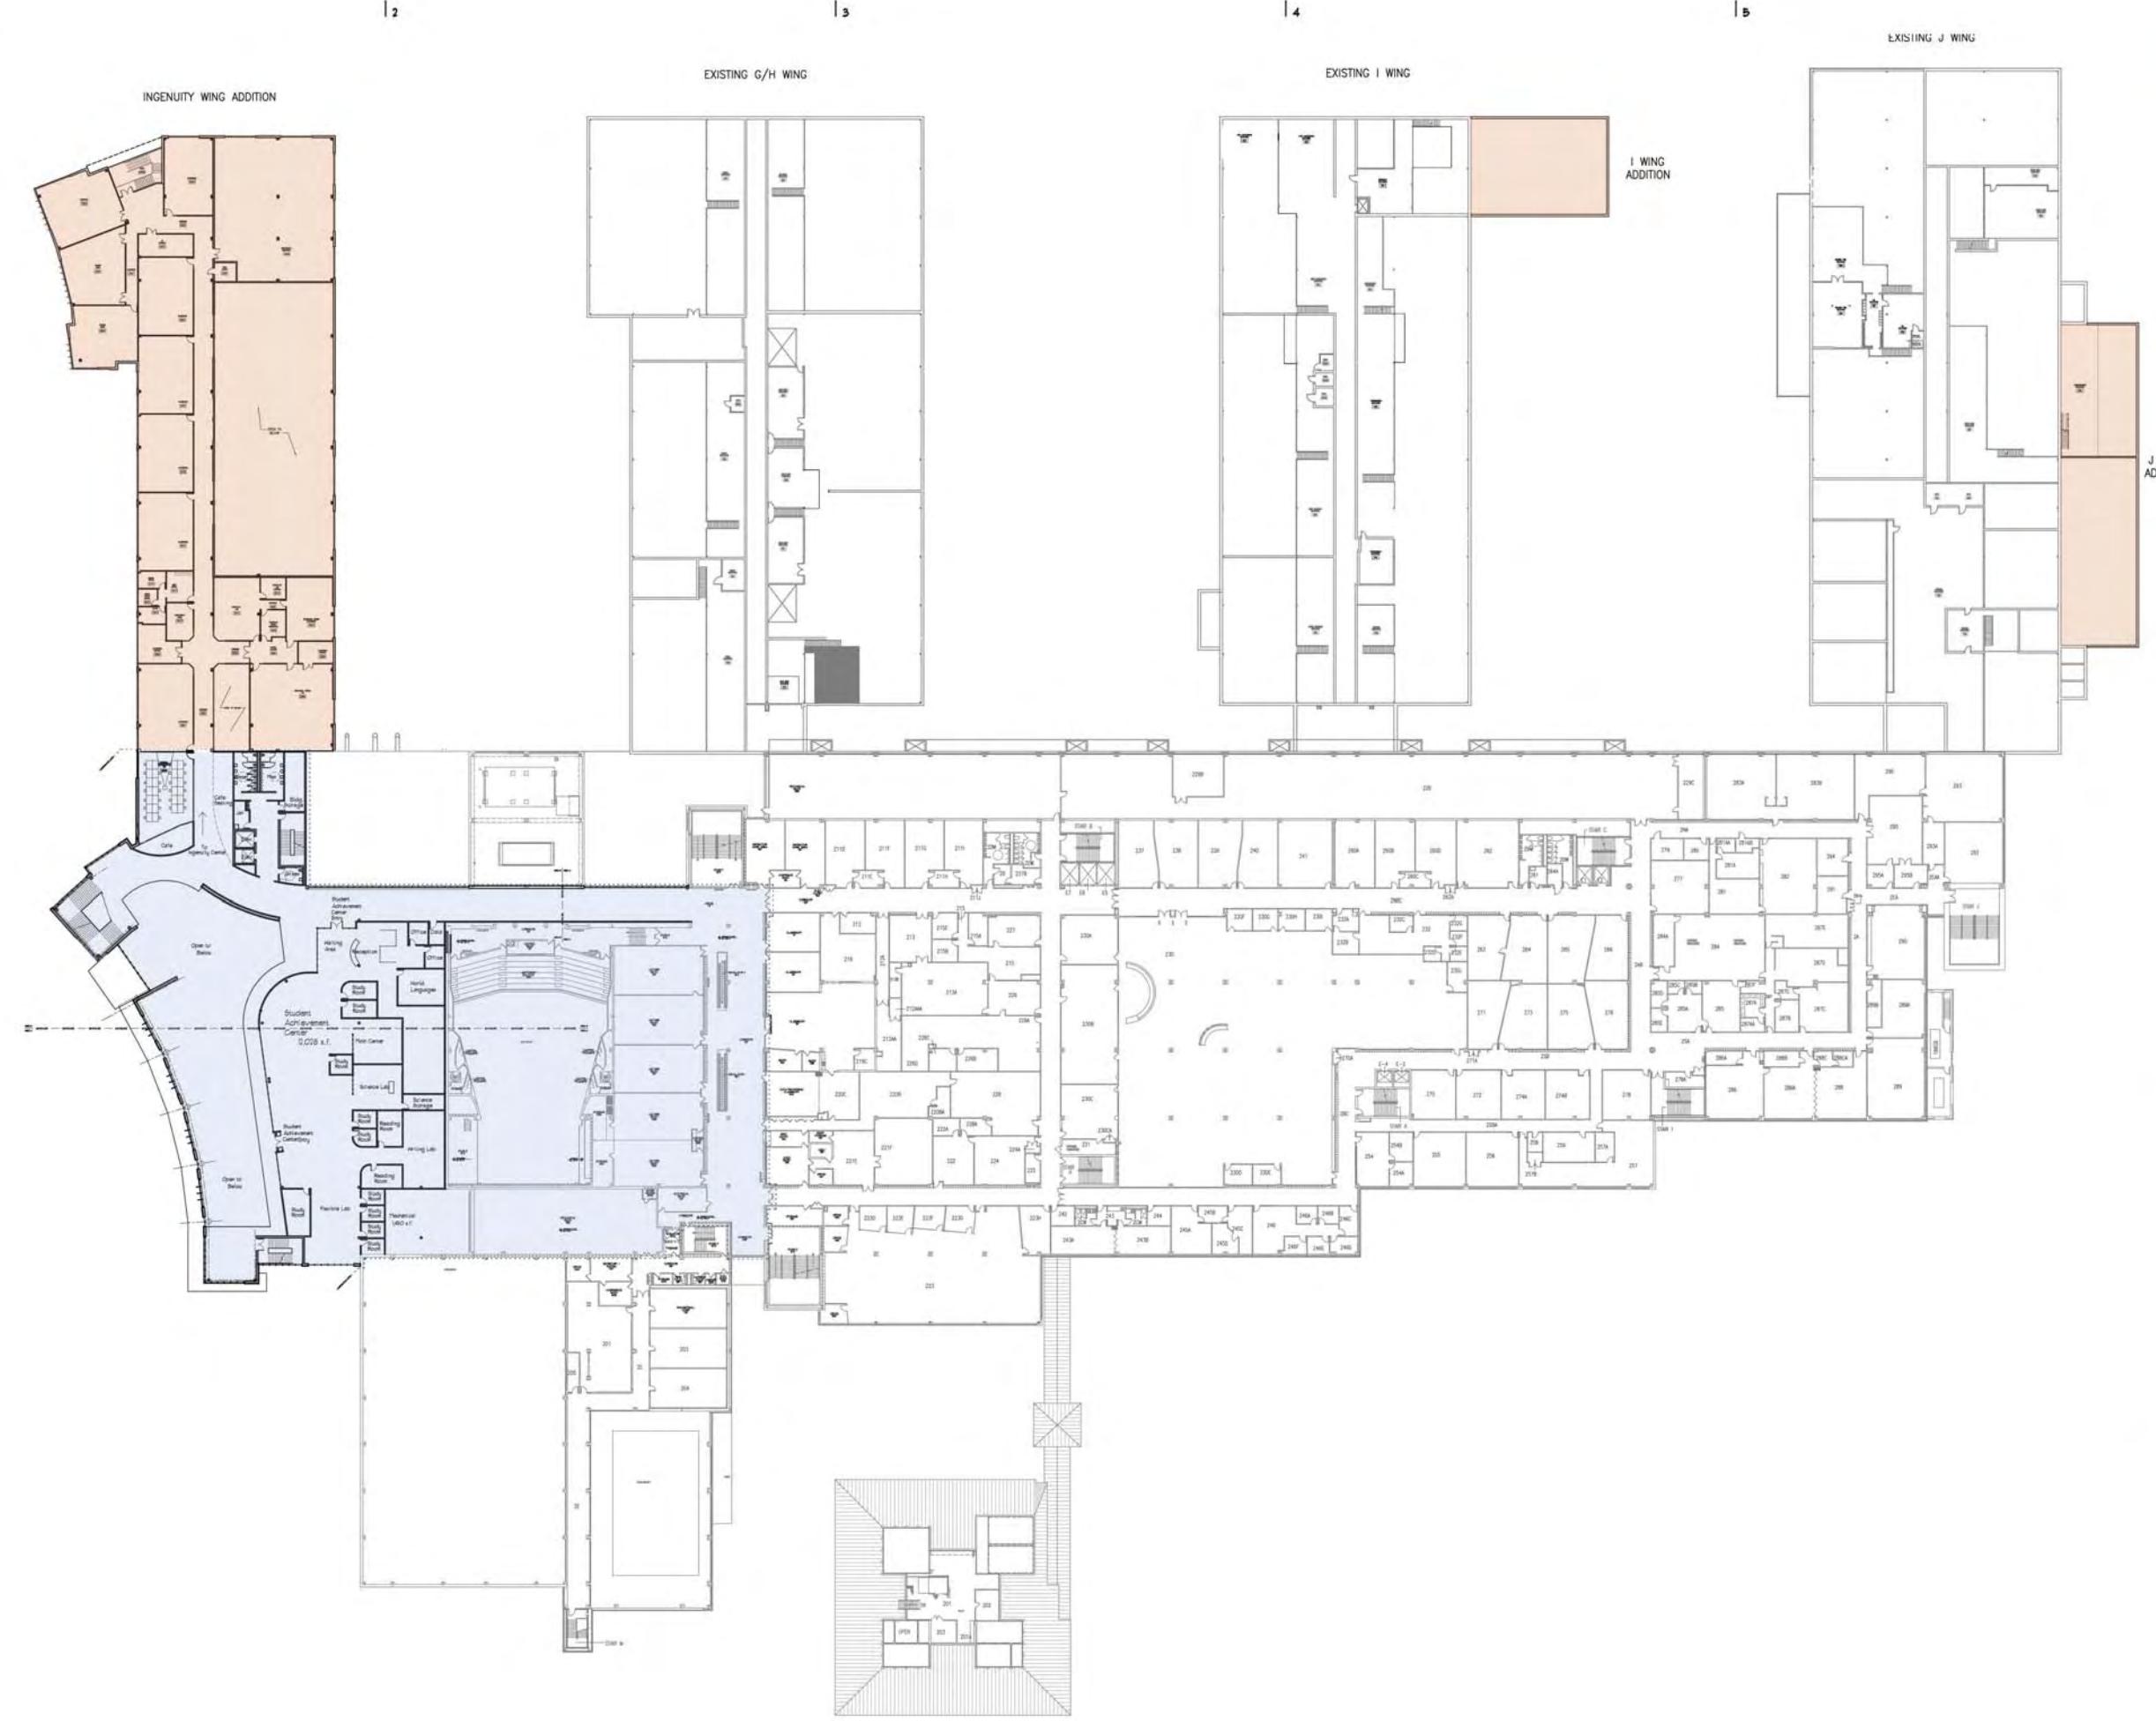
Inspired Results
Intelligent Designs

D
DRAWING
OVERALL FIRST FLOOR
PLAN

0 32' 64'
SCALE: NTS
Sheet Number

A200





Madison
Area Technical
College
Ingenuity Center
Transportation &
Advanced Sustainable
Manufacturing & Gateway

City of Madison,
Wisconsin

Issued For: UDC
Issue Date: 04/20/2011
PRA Project No. 10112-02
MC Project No. -
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Inspired Results

Intelligent Designs
Plunkett
Rayich
Architects, LP

D
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OVERALL SECOND
FLOOR PLAN
Sheet Number
N
0 32' 64'
SCALE: NTS

A210



Project Title
Truax
Gateway

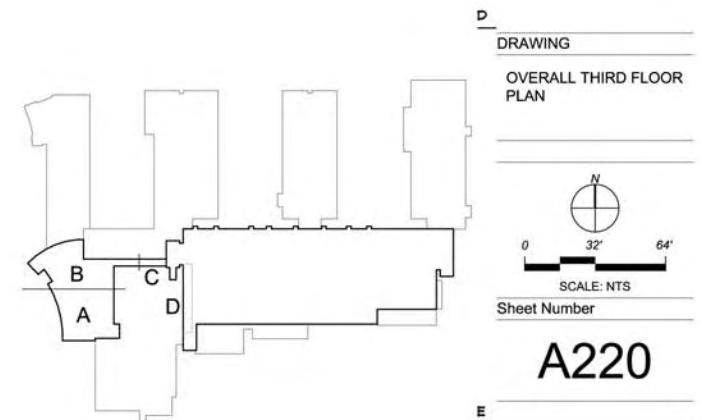
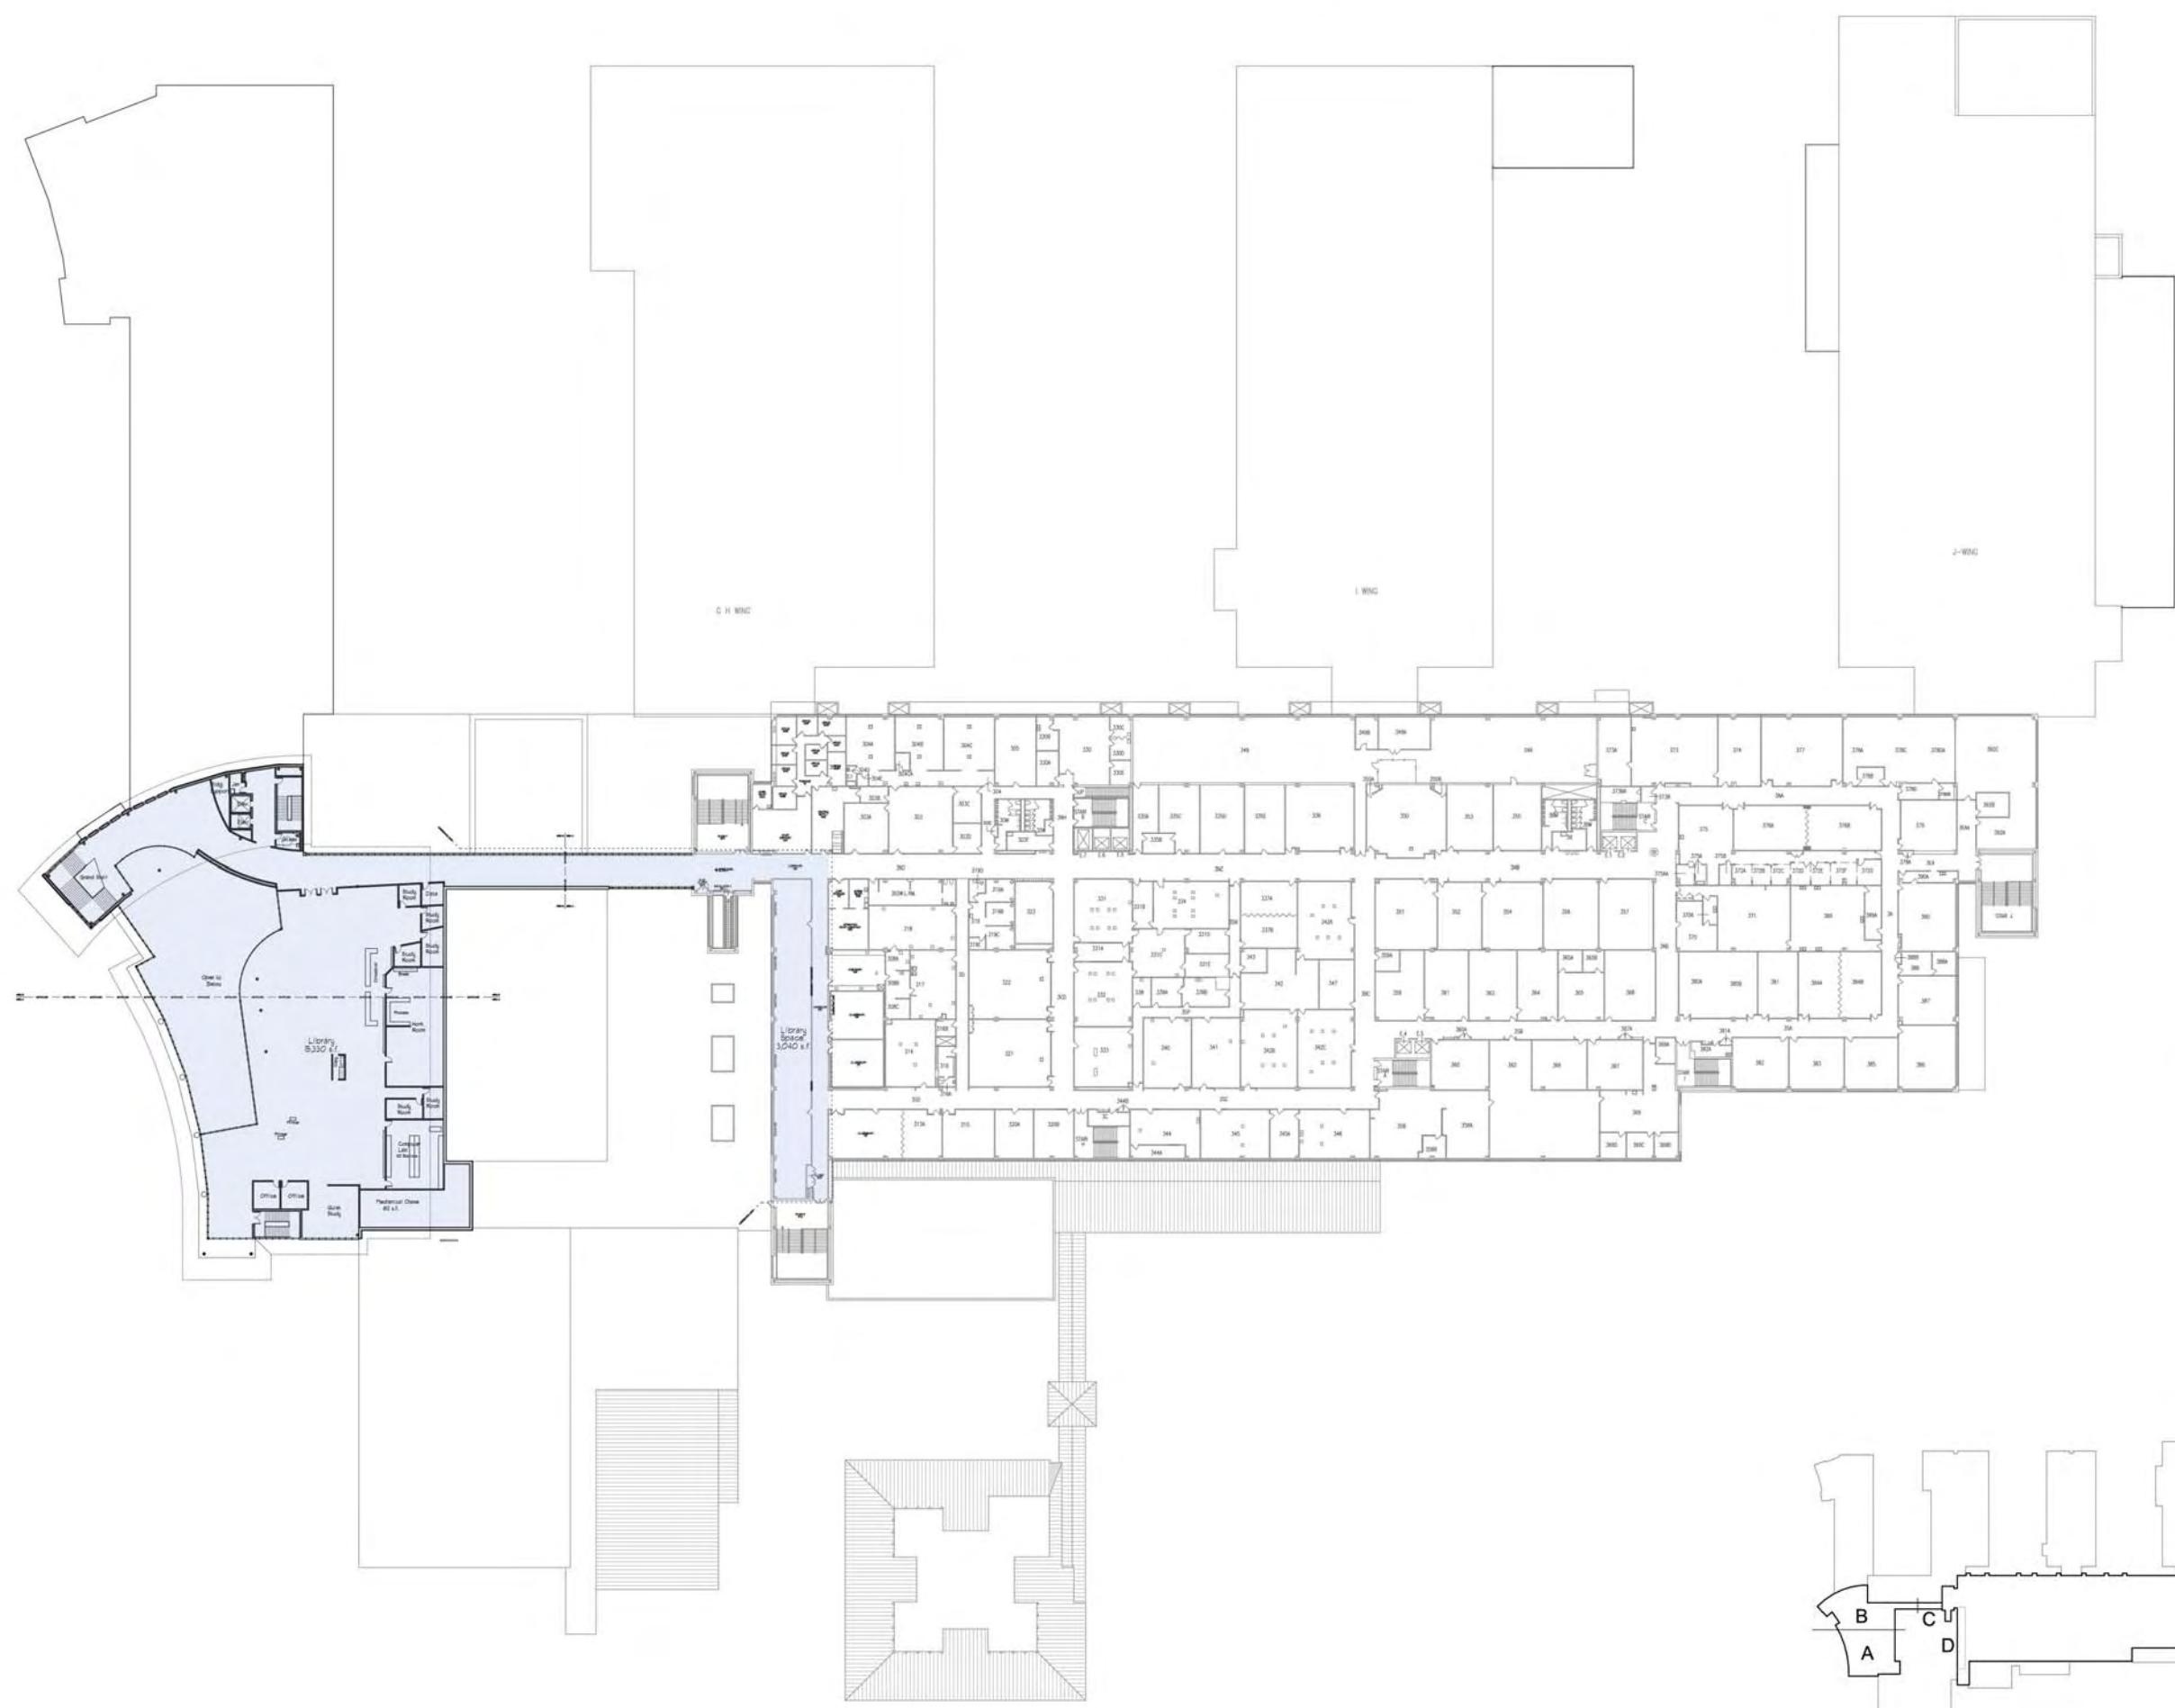
City of Madison,
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A
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MC Project No. -
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Revision Date

B

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City of Madison,
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A

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Issue Date: 04/20/2011

PRA Project No. 10112-02

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Bid Pkg No. B11-011

Revision Date

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Project Title
Truax
Gateway

City of Madison,
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A
Issued For: UDC
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C
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SHEET TITLE

D
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NTS
Sheet Number

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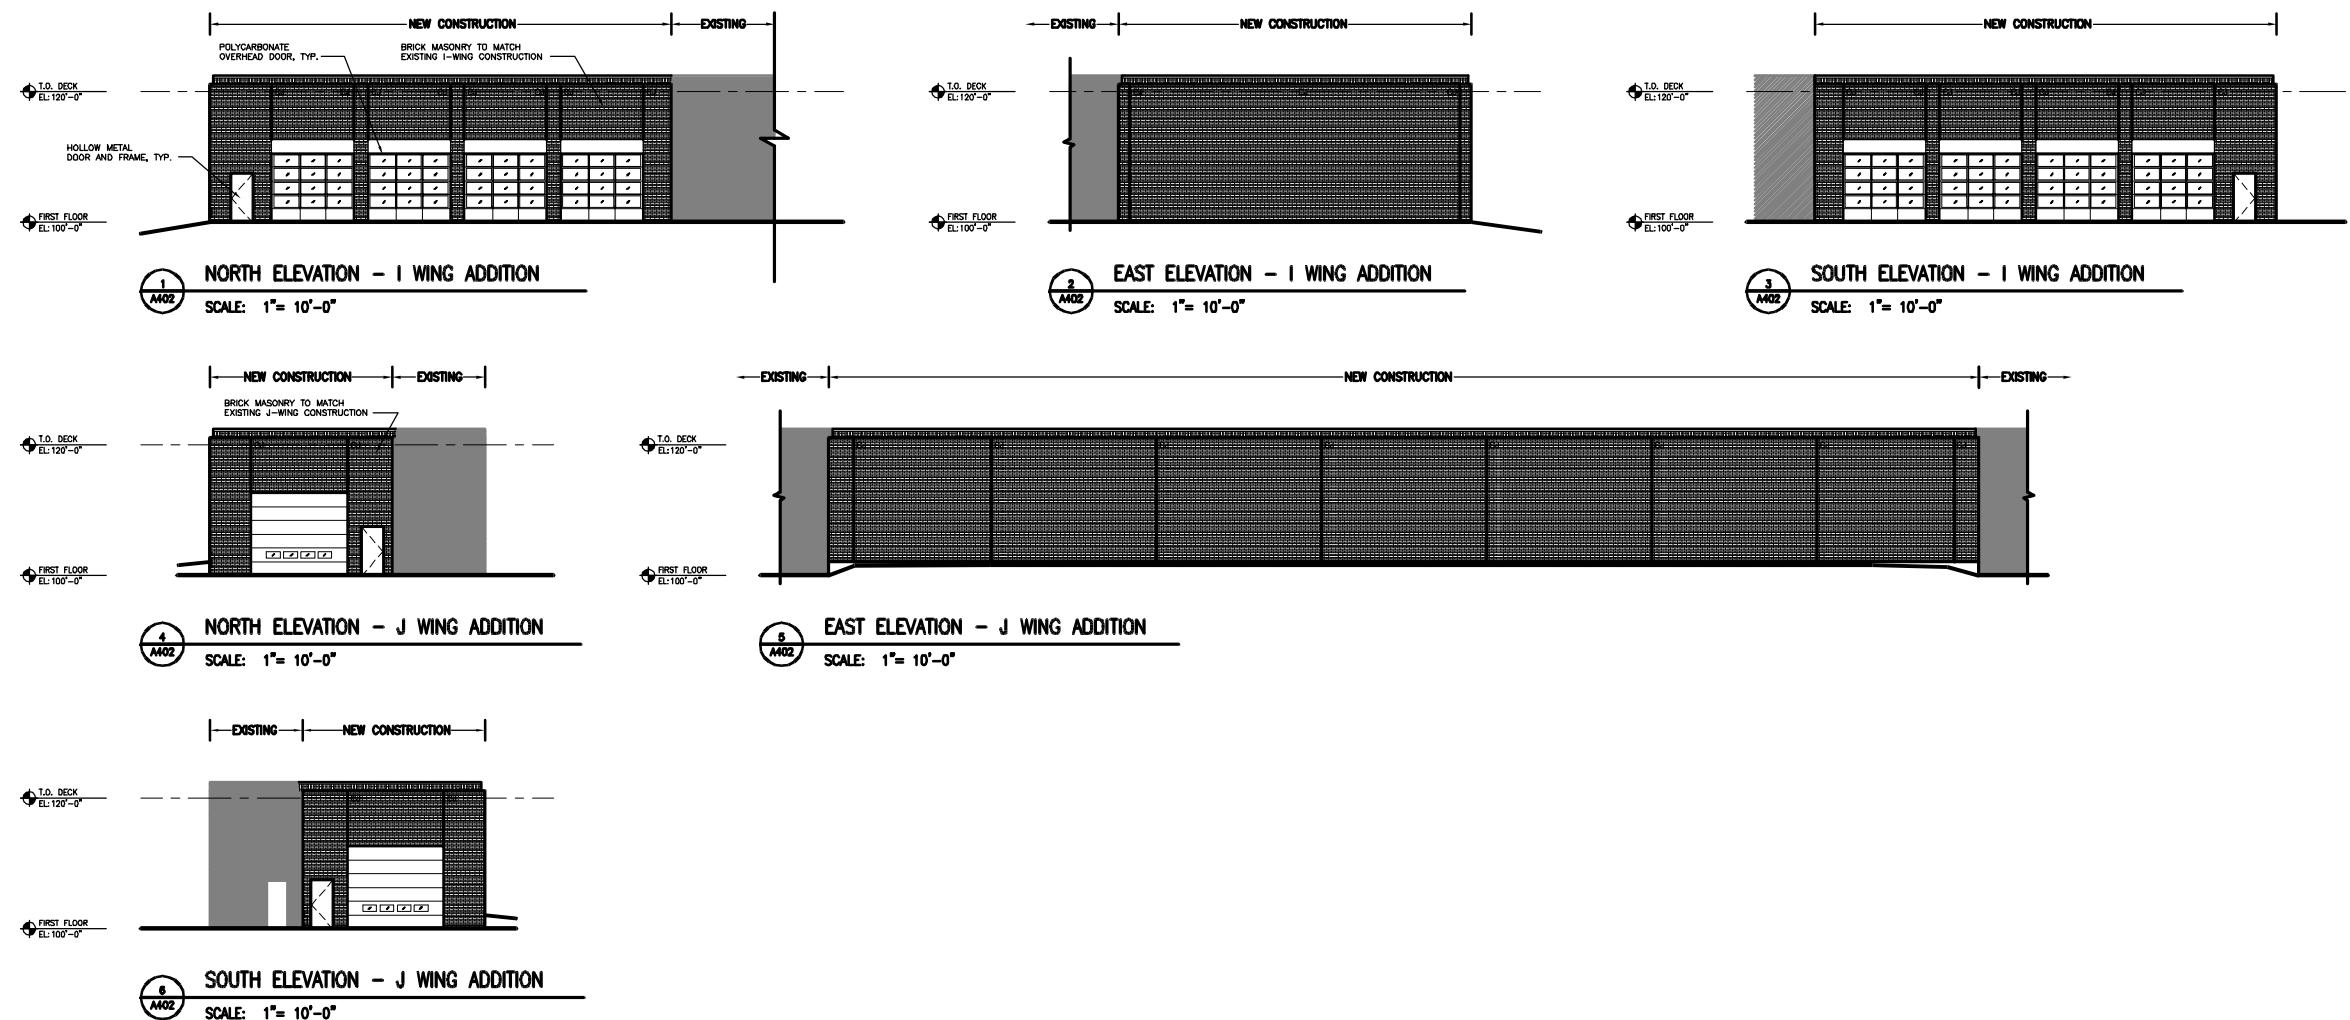


Project Title
Ingenuity Center
Transportation &
Advanced Sustainable
Manufacturing

3550 Anderson St
Madison, Wisconsin

Issued For: Approval
Issue Date: 04/06/2011
Strang Project No. 2010080
Owner Project No. -
Bid Pkg No. B11-009

Revision Date



STRANG

ARCHITECTURE
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INTERIOR DESIGN

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ISSUED FOR:
URBAN DESIGN
COMMISSION
INITIAL APPROVAL
04-20-2011

DRAWING
EXTERIOR ELEVATIONS -
I & J WINGS

Sheet Number

A403